



**ELEVATION AT SHEAR WALLS AND EXTERIOR WALLS (A)**

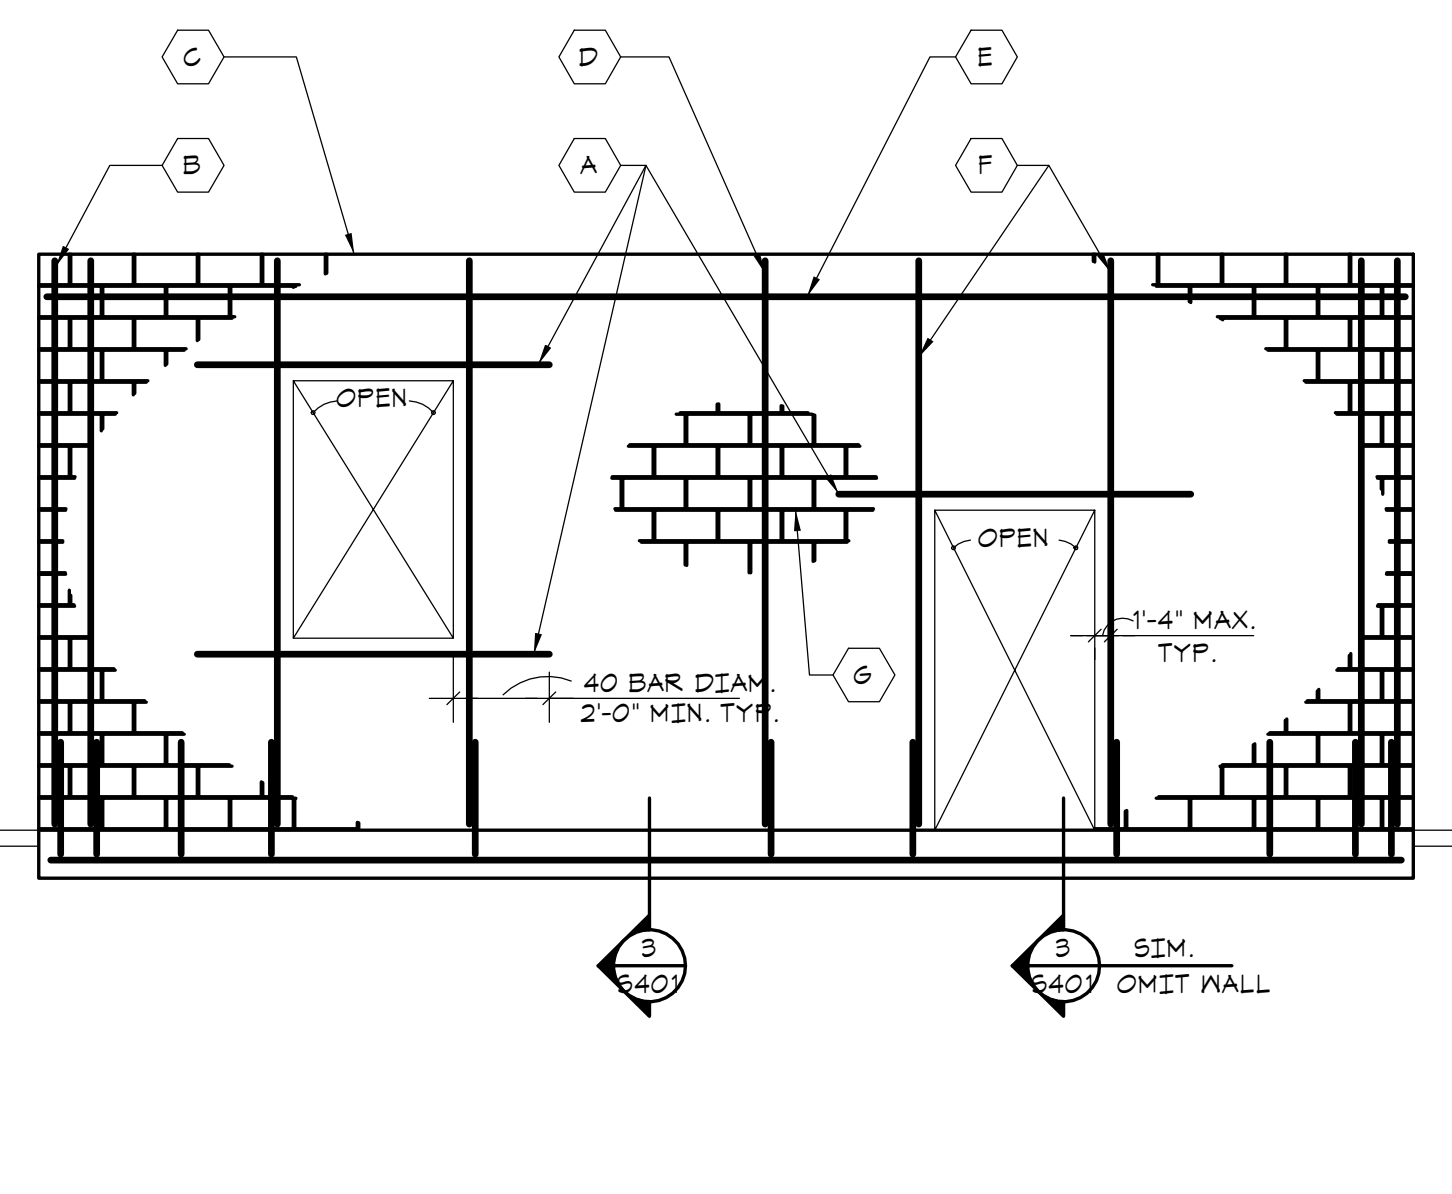


**ELEVATION AT PARTITION WALLS (B)**

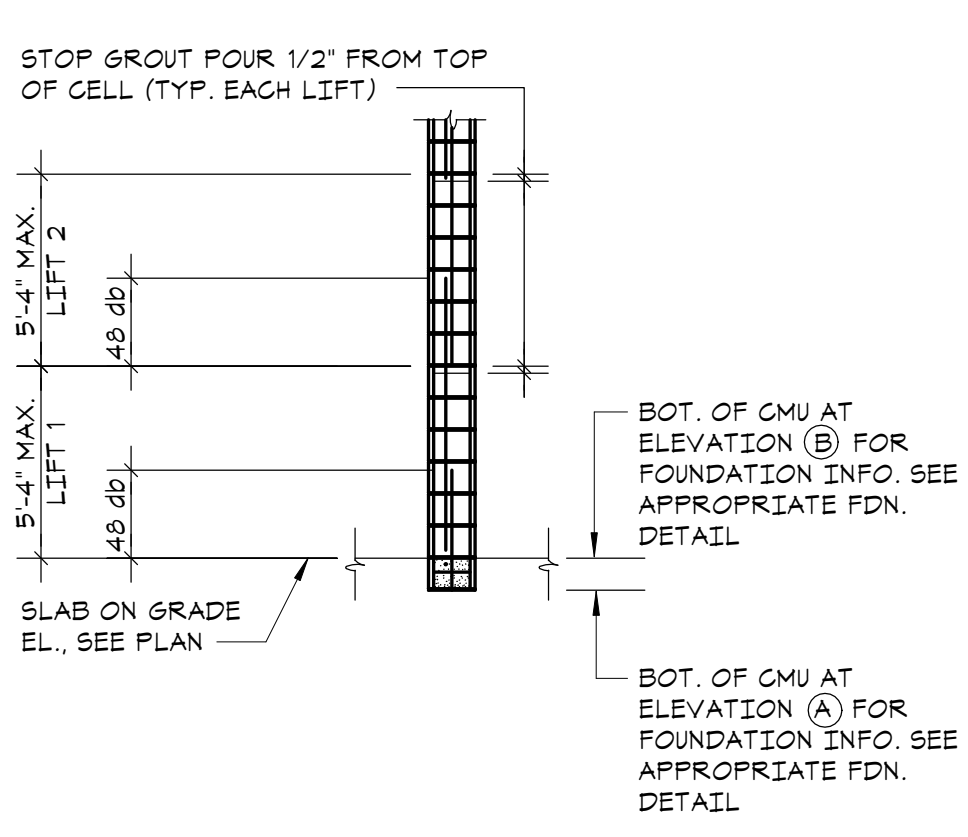


**SECTION - LOW LIFT WALL GROUTING DETAIL (C)**


**1 TYPICAL CONCRETE MASONRY WALL REINFORCEMENT DETAIL**  
NO SCALE

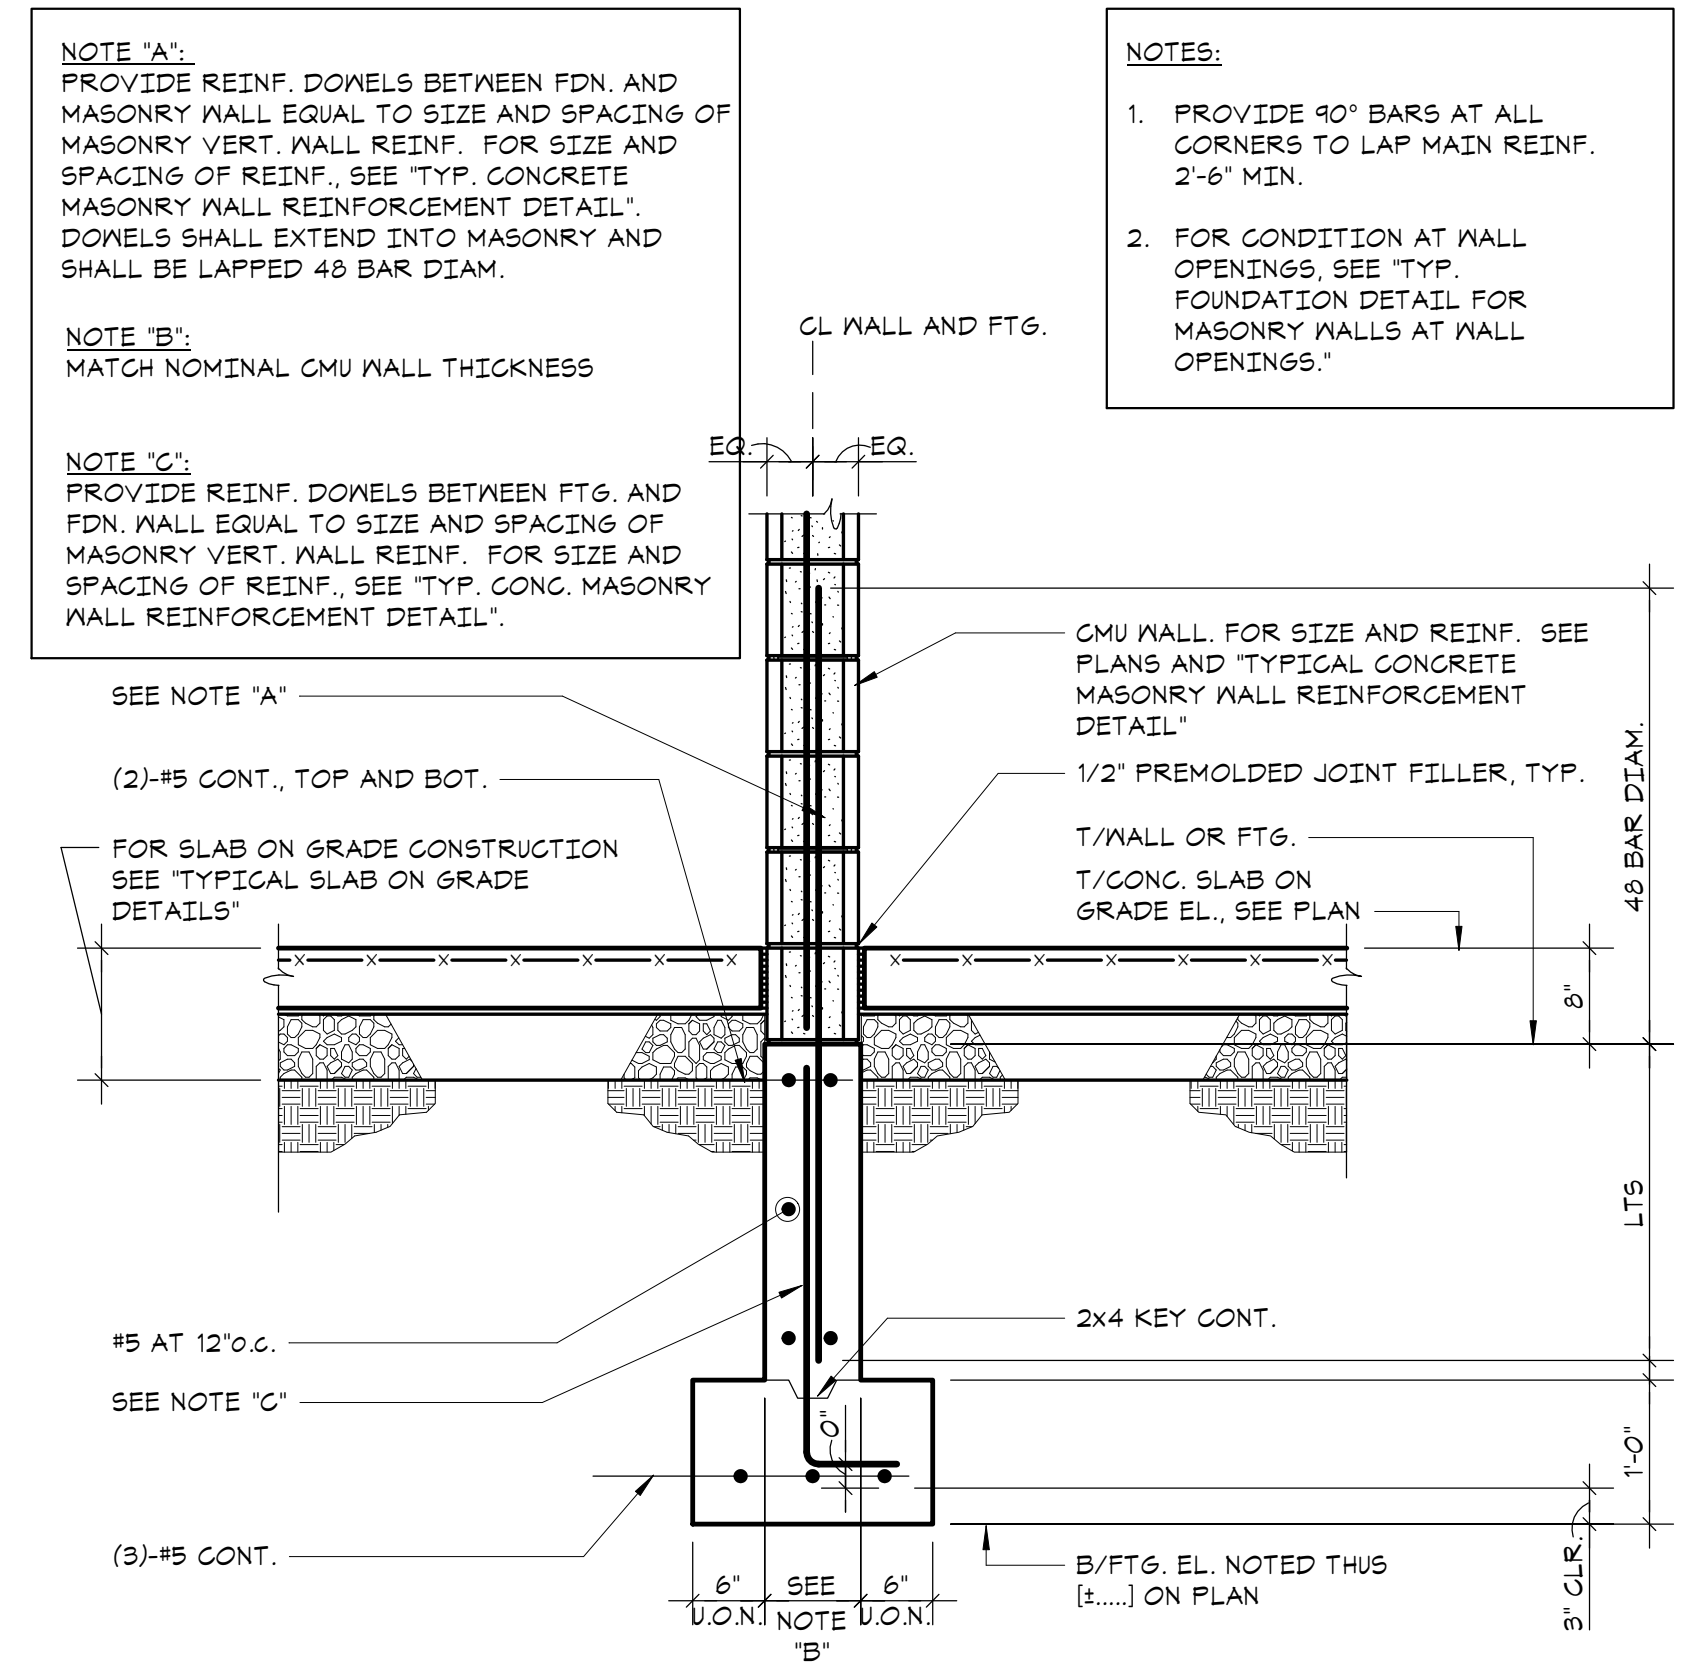


**2 TYPICAL FOUNDATION DETAIL FOR SHEAR WALLS/MASONRY WALLS**  
NO SCALE

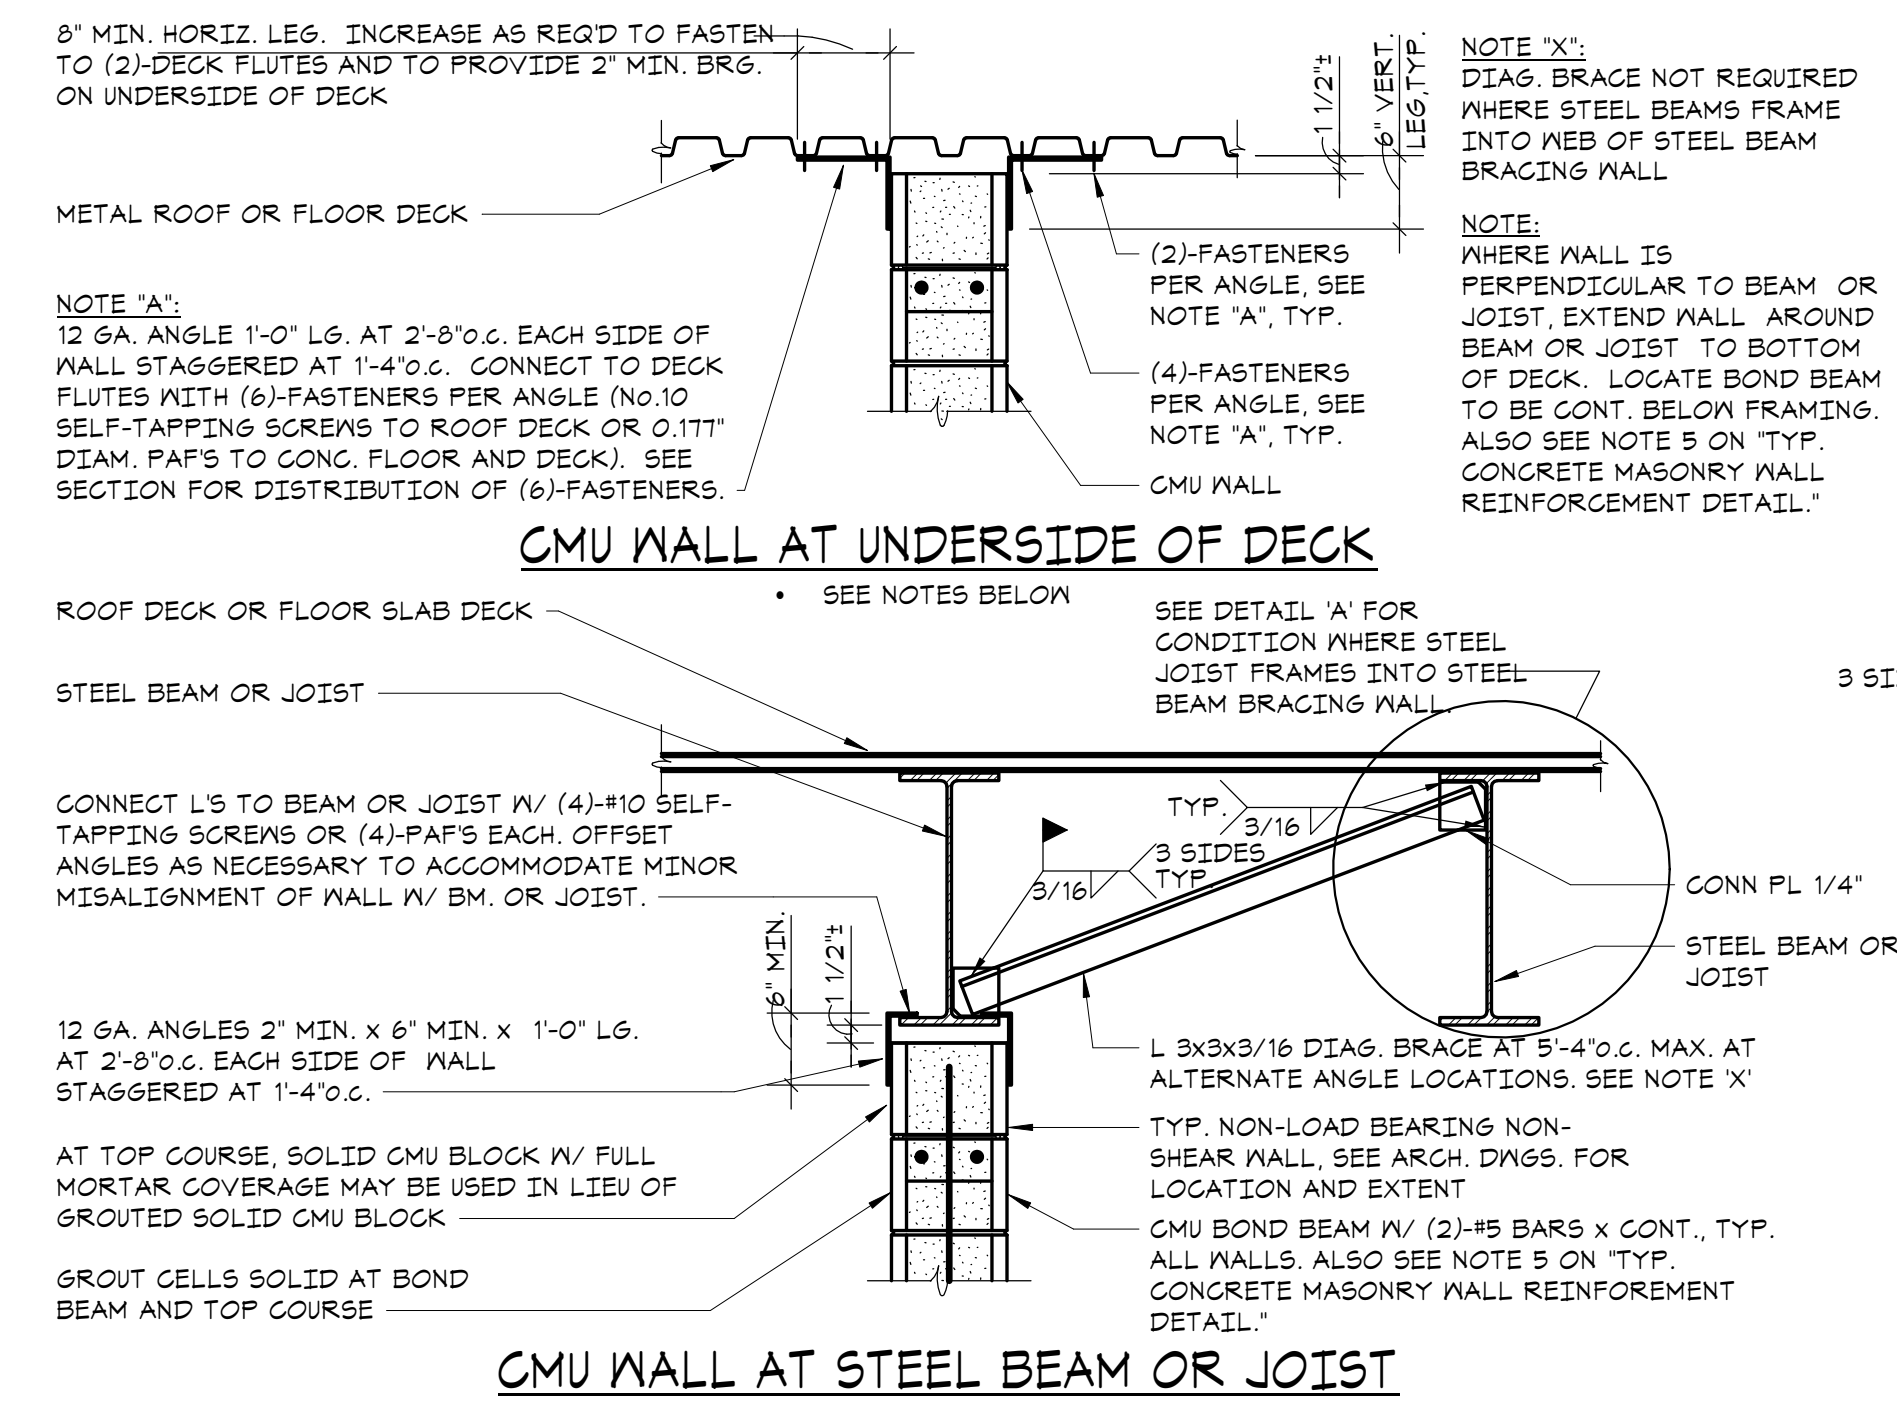

**5 TYPICAL BRACING DETAIL AT TOP OF PARTITION WALL**  
NO SCALE

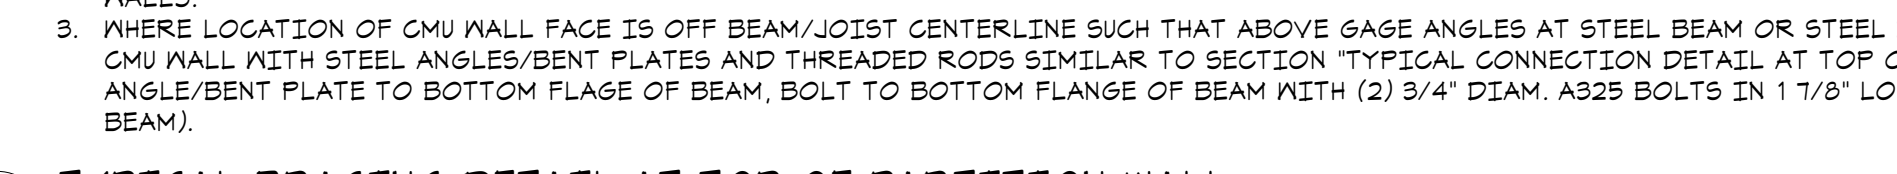

**3 TYPICAL PARTITION WALL SUPPORT DETAIL**  
NO SCALE

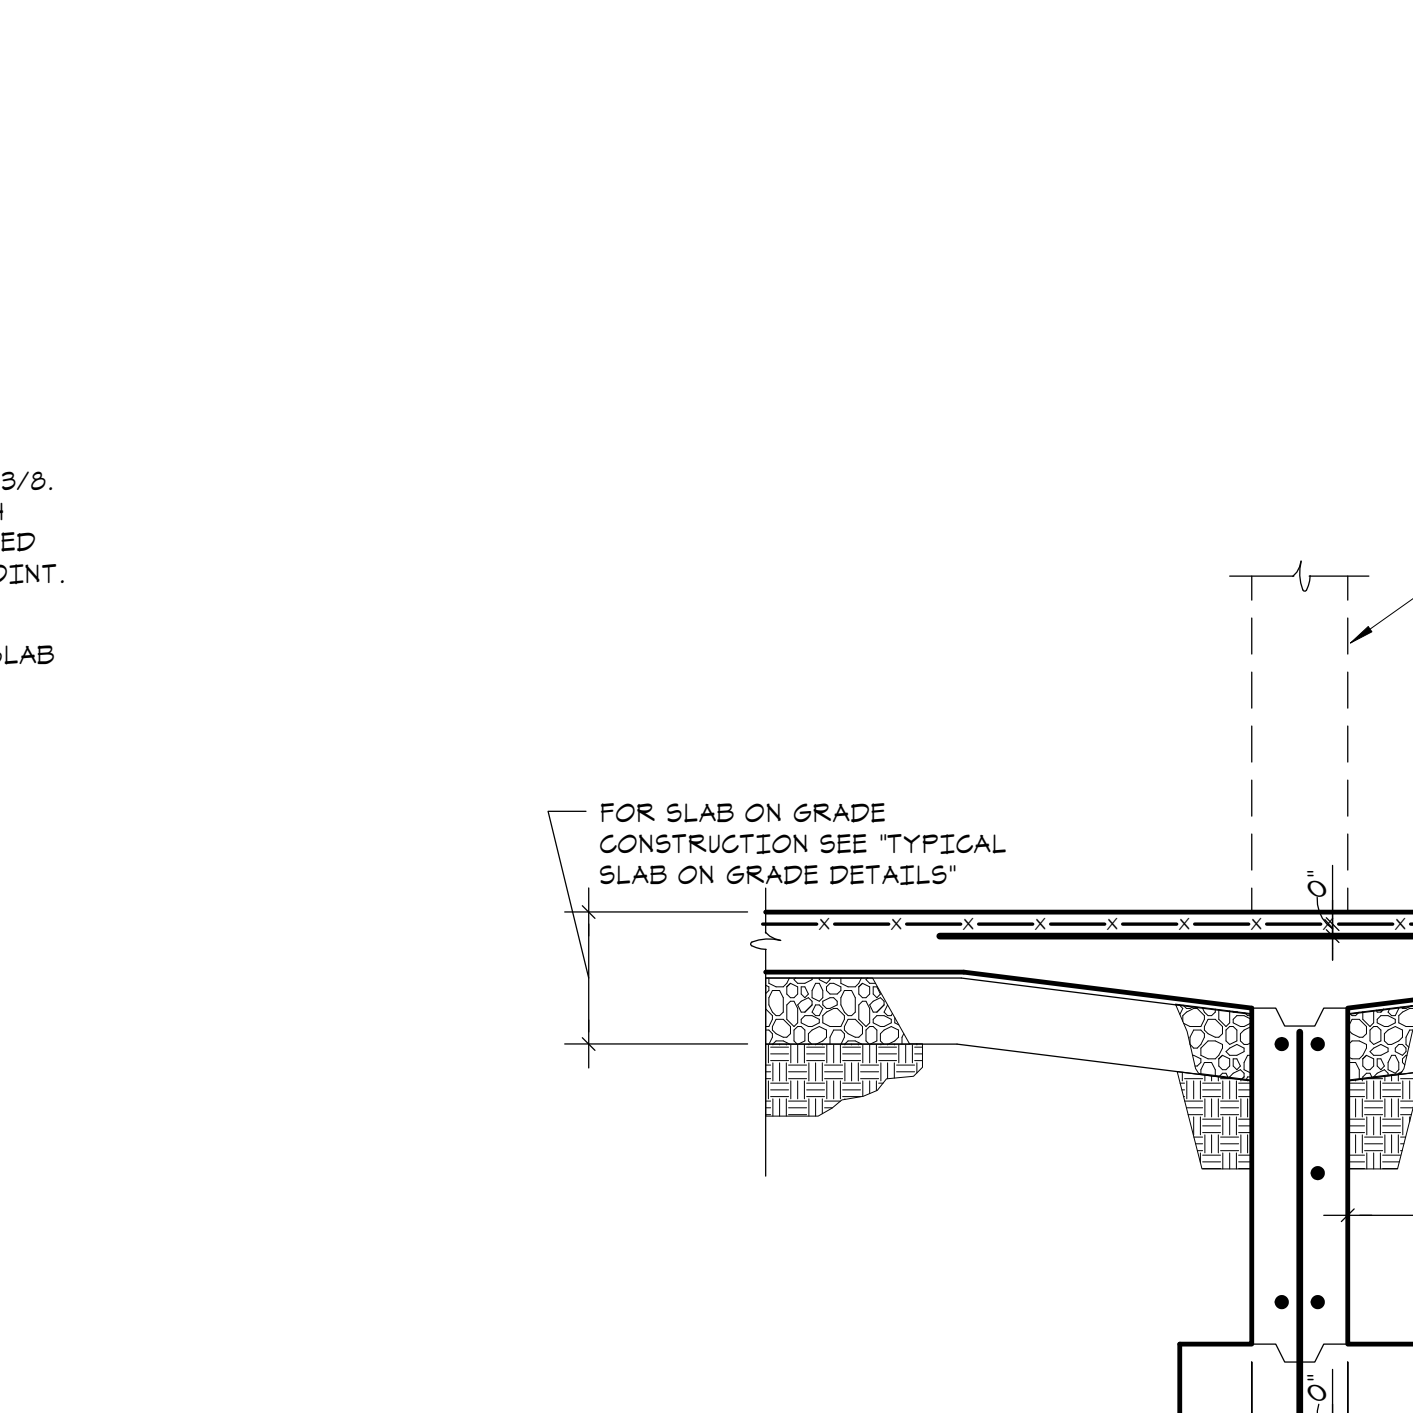




**6 TYPICAL FOUNDATION DETAIL FOR MASONRY WALLS AT WALL OPENINGS**  
NO SCALE




KEYNOTES	
(A)	(2)-#5 HORIZ. REINF. GROUTED SOLID IN BOND BEAM COURSE TYP. ABOVE AND BELOW ALL OPENINGS. FOR HORIZONTAL REINFORCING IN MASONRY LINTELS SEE 'TYPICAL MASONRY LINTEL IN NON-LOAD BEARING WALL DETAIL'.
(B)	VERT. FULL HEIGHT REINF. IN SOLID GROUT, TYP. AT WALL ENDS, CORNERS, AND EACH SIDE OF C.J.'S. SEE REINFORCEMENT SCHEDULE.
(C)	CMU WALL. FOR SIZE, SEE PLANS AND REINFORCEMENT SCHEDULE.
(D)	TYP. VERTICAL REINF. SEE REINFORCEMENT SCHEDULE (U.O.N. BY SECTION). FILL CELLS CONTAINING REINF. SOLID W/ GROUT.
(E)	(2)-#5 HORIZ. REINF. AT TOP OF WALL GROUTED SOLID IN BOND BEAM COURSE. PLACE REINF. ONE COURSE LOWER WHERE WALL ABUTS FLOOR ABOVE.
(F)	VERT. FULL HEIGHT REINF. IN SOLID GROUT, TYP. AT BOTH SIDES OF ALL WALL OPENINGS. SEE REINFORCEMENT SCHEDULE.
(G)	HORIZ. JOINT REINFORCING. SEE GENERAL NOTES.
(H)	PROVIDE REINFORCING DOVELS BETWEEN FDN. AND MASONRY WALL EQUAL TO SIZE AND SPACING OF MASONRY VERT. WALL REINFORCING (MAX. SPACING = 4'-0\"/>

REINFORCEMENT SCHEDULE			
MALL DESCRIPTION	MALL ELEVATION TYPE	MALL TYPE	VERTICAL REINFORCEMENT
8' CMU SHEAR WALLS, BRG. WALLS, FIRE WALLS AND EXTERIOR WALLS	A	D	#5 AT 24\"/>

NOTES:  
 1. FOR SHEAR WALL LOCATIONS AND EXTENT, SEE FRAMING AND FDN. PLANS.  
 2. FOR CMU WALL LOCATIONS AND EXTENT, SEE ARCH. DWGS.  
 3. SEE ARCH. DWGS. FOR LOCATIONS OF CONTROL JOINTS. DO NOT LOCATE CONTROL JOINTS WITHIN 52\"/>

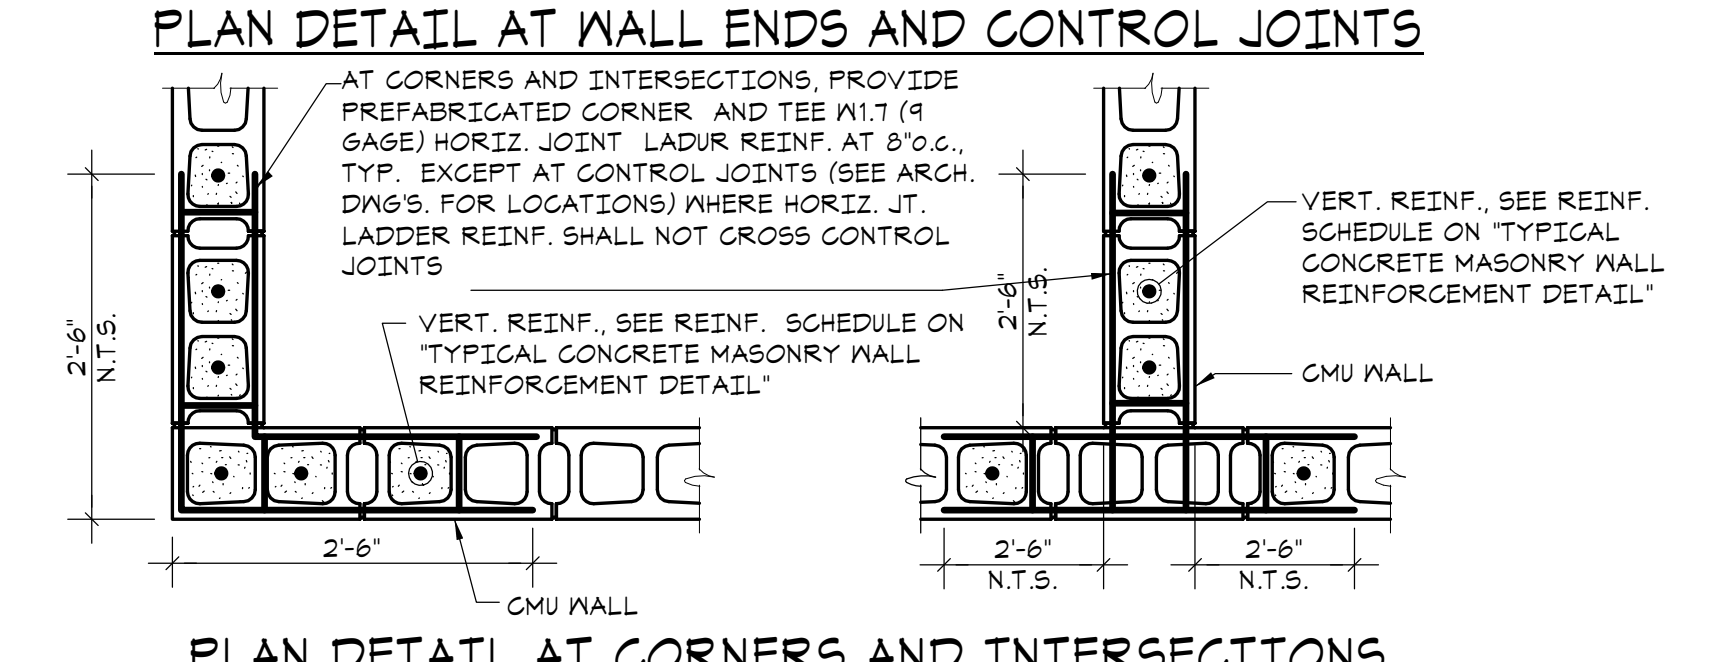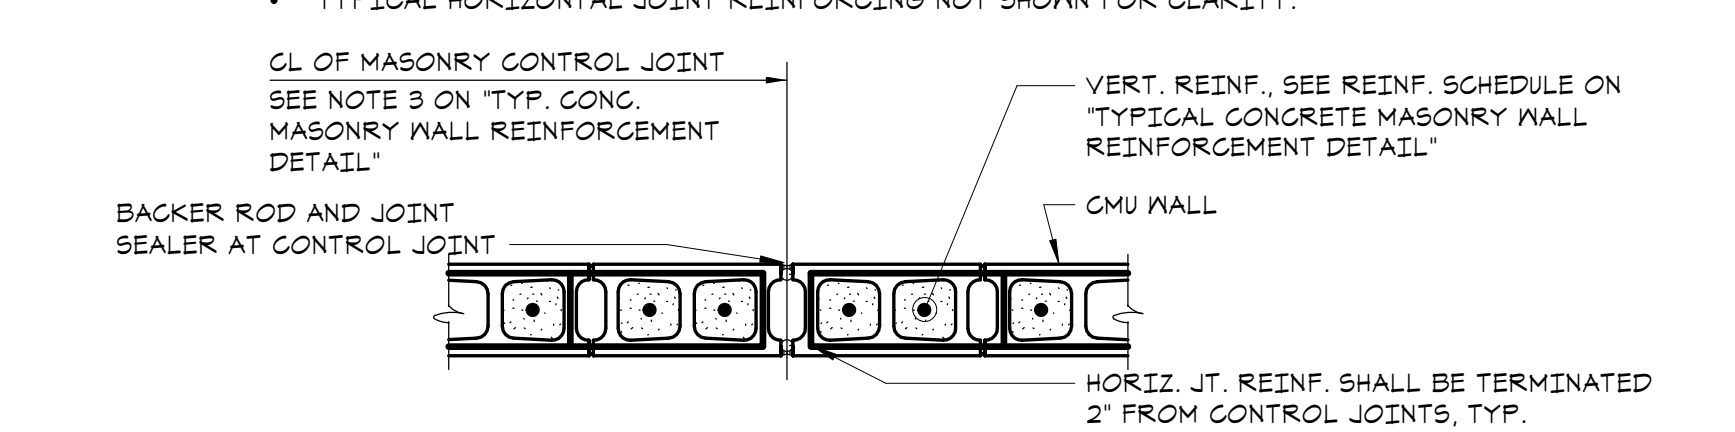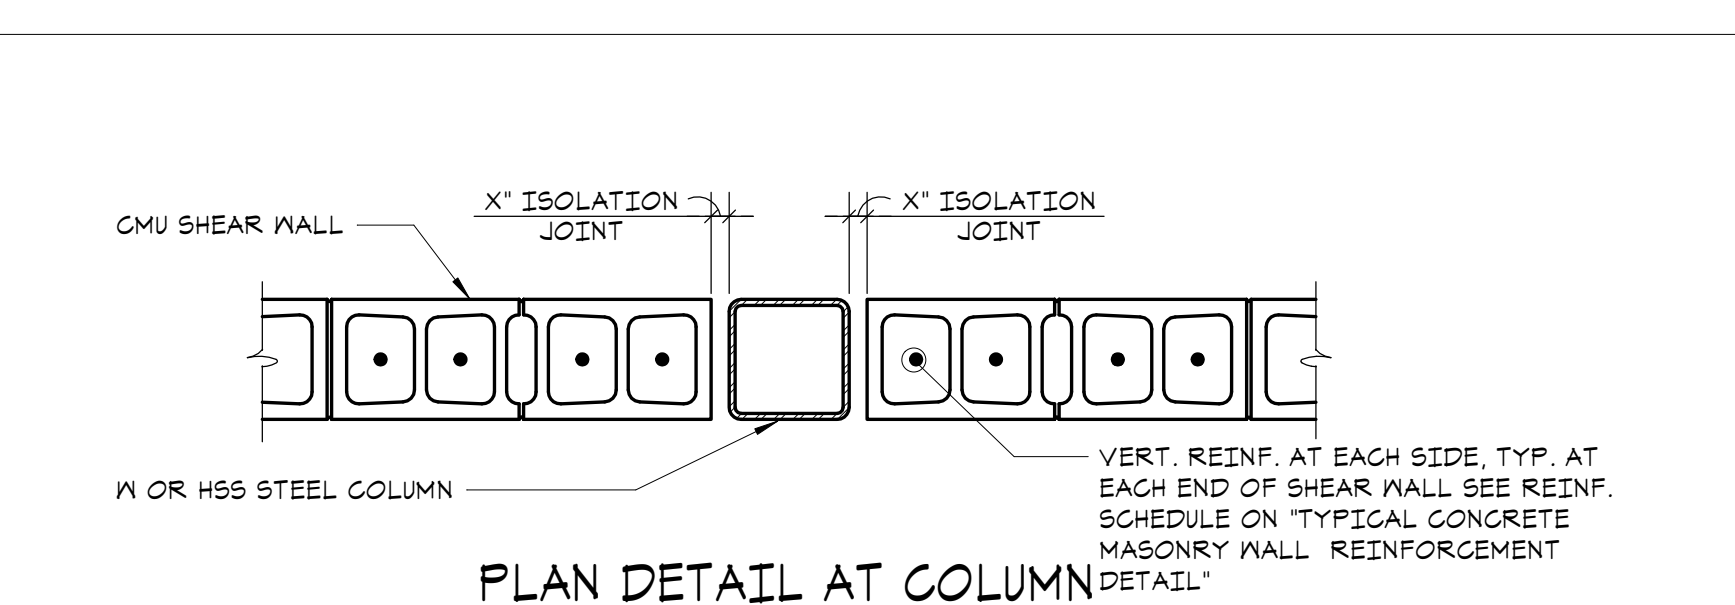

**4 TYPICAL MASONRY WALL PLAN DETAILS**  
NO SCALE

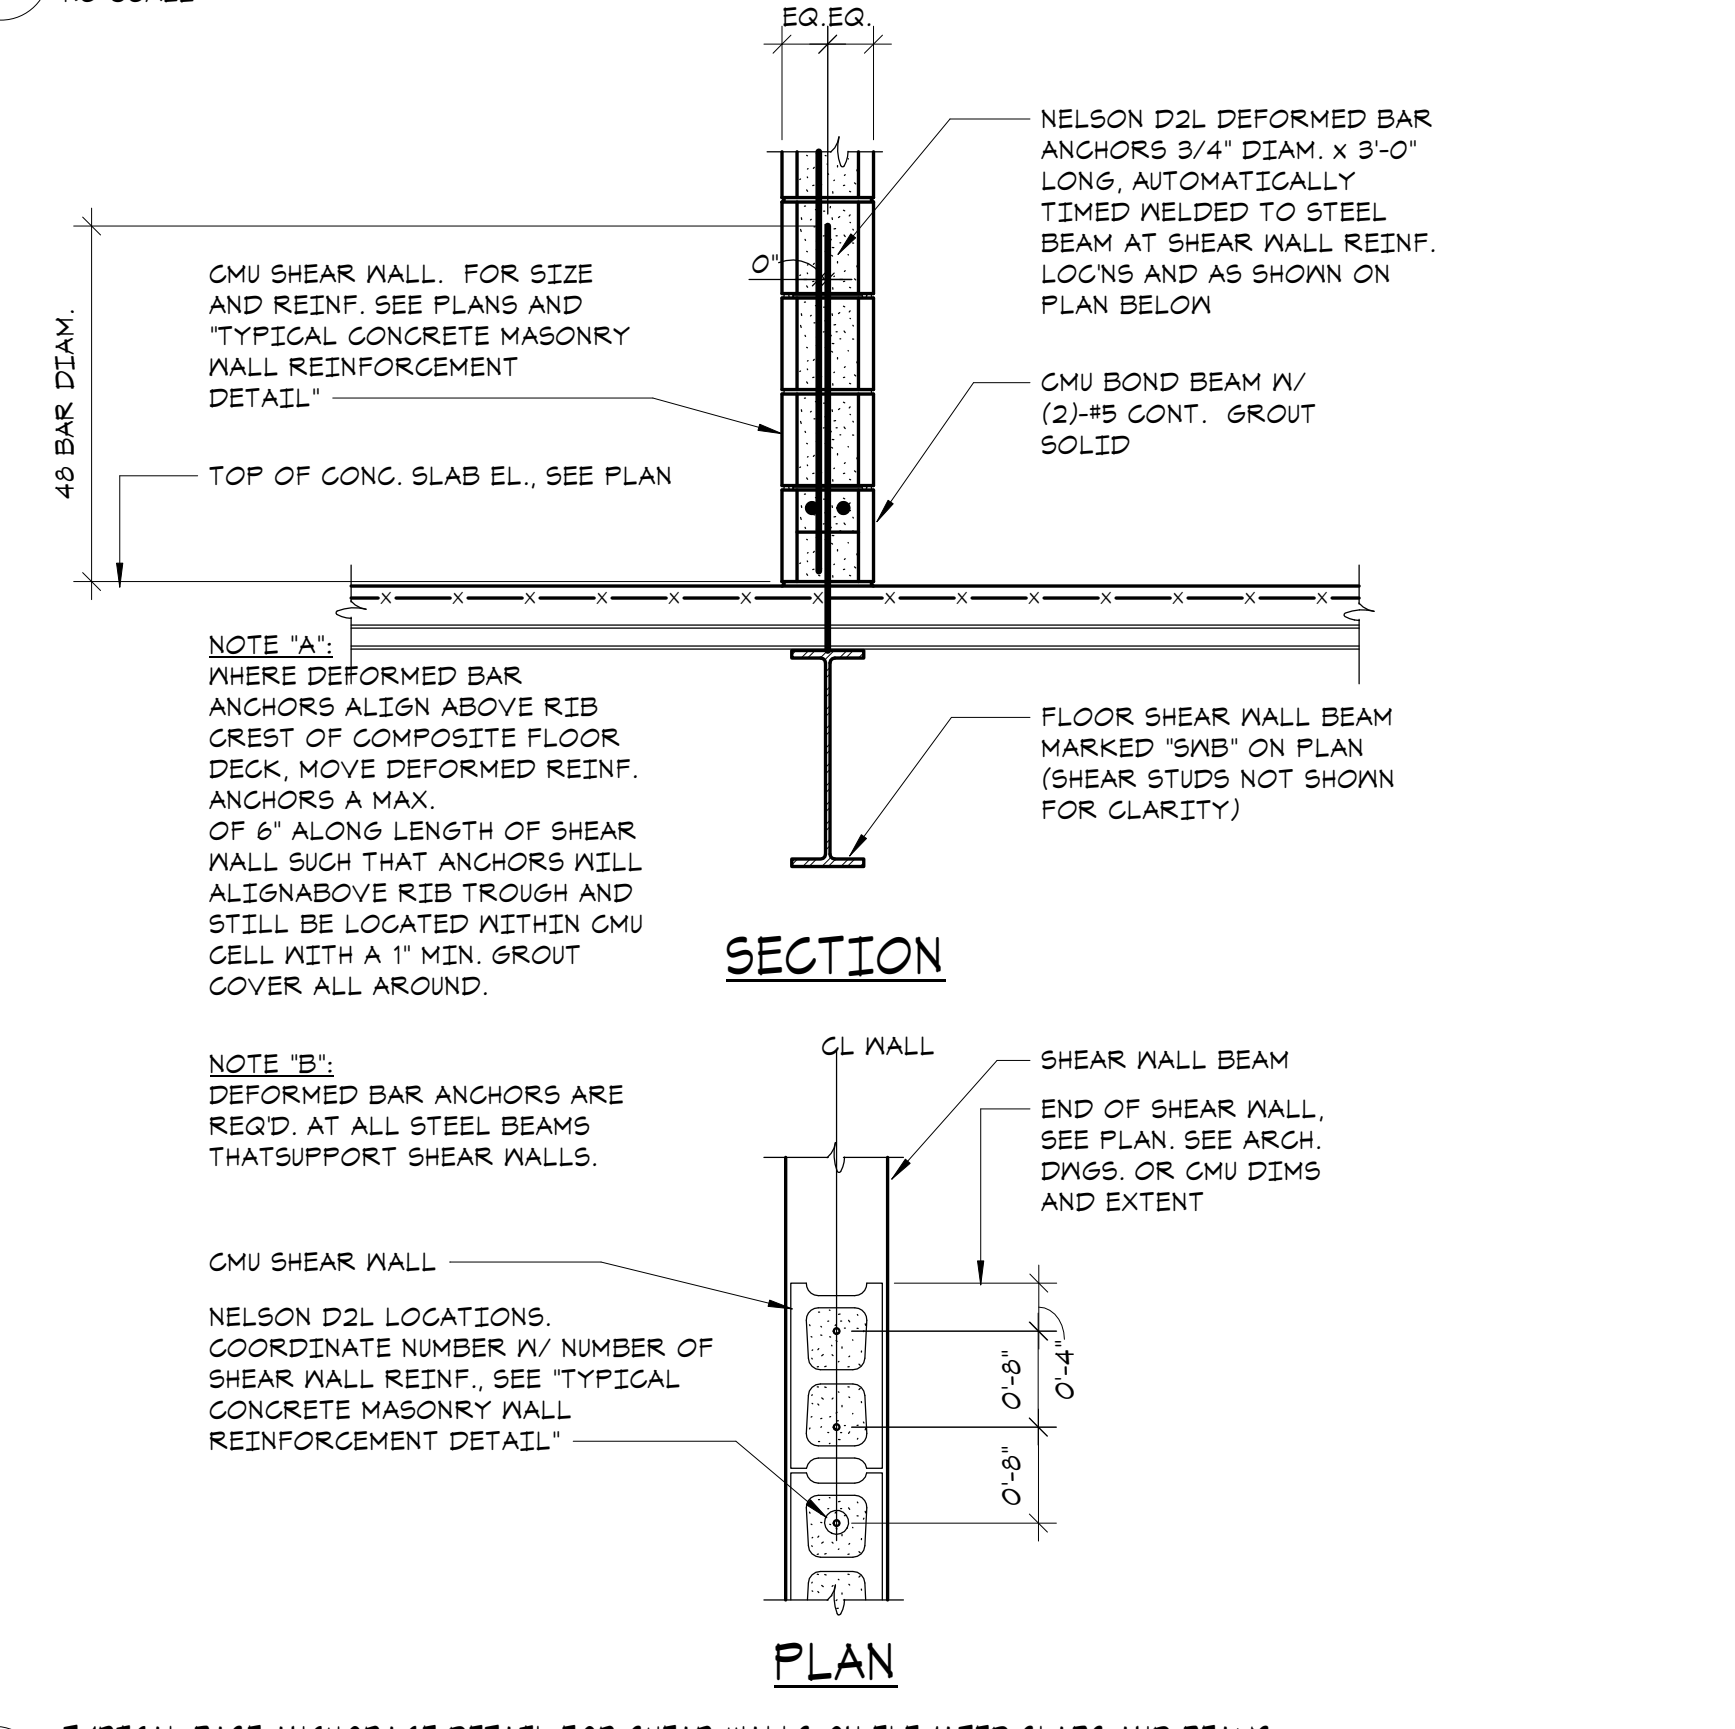

**7 TYPICAL BASE ANCHORAGE DETAIL FOR SHEAR WALLS ON ELEVATED SLABS AND BEAMS**  
NO SCALE



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NY SED PROJECT CONTROL NO.  
**66-23-00-01-0-346-001**

CONSTRUCTION DOCUMENTS

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**SCOPE OF WORK RELATED TO SECTIONS AND DETAILS:**  
 Work shown as "Typical Details" apply throughout the project as required. Work shown as "Sections" shall be considered to apply for the same and similar conditions in the building.



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PROFESSIONAL SEAL

4	11/01/21	ISSUE FOR BID
3	07/14/21	CONSTRUCTION DOCS - NYSED
2	12/15/20	DESIGN DEVELOPMENT
1	08/31/20	SCHEMATIC DESIGN

**MASONRY SCHEDULE AND TYPICAL DETAILS**

Job No. 20142.00 Date 10/30/2020  
 Scale AS NOTED Eng'n'r / Checked TM / JEM  
 Sheet Number

**S401**