

**NEW COMMUNITY SCHOOL 35 AT ST DENIS SITE**

YONKERS JOINT SCHOOL CONSTRUCTION BOARD

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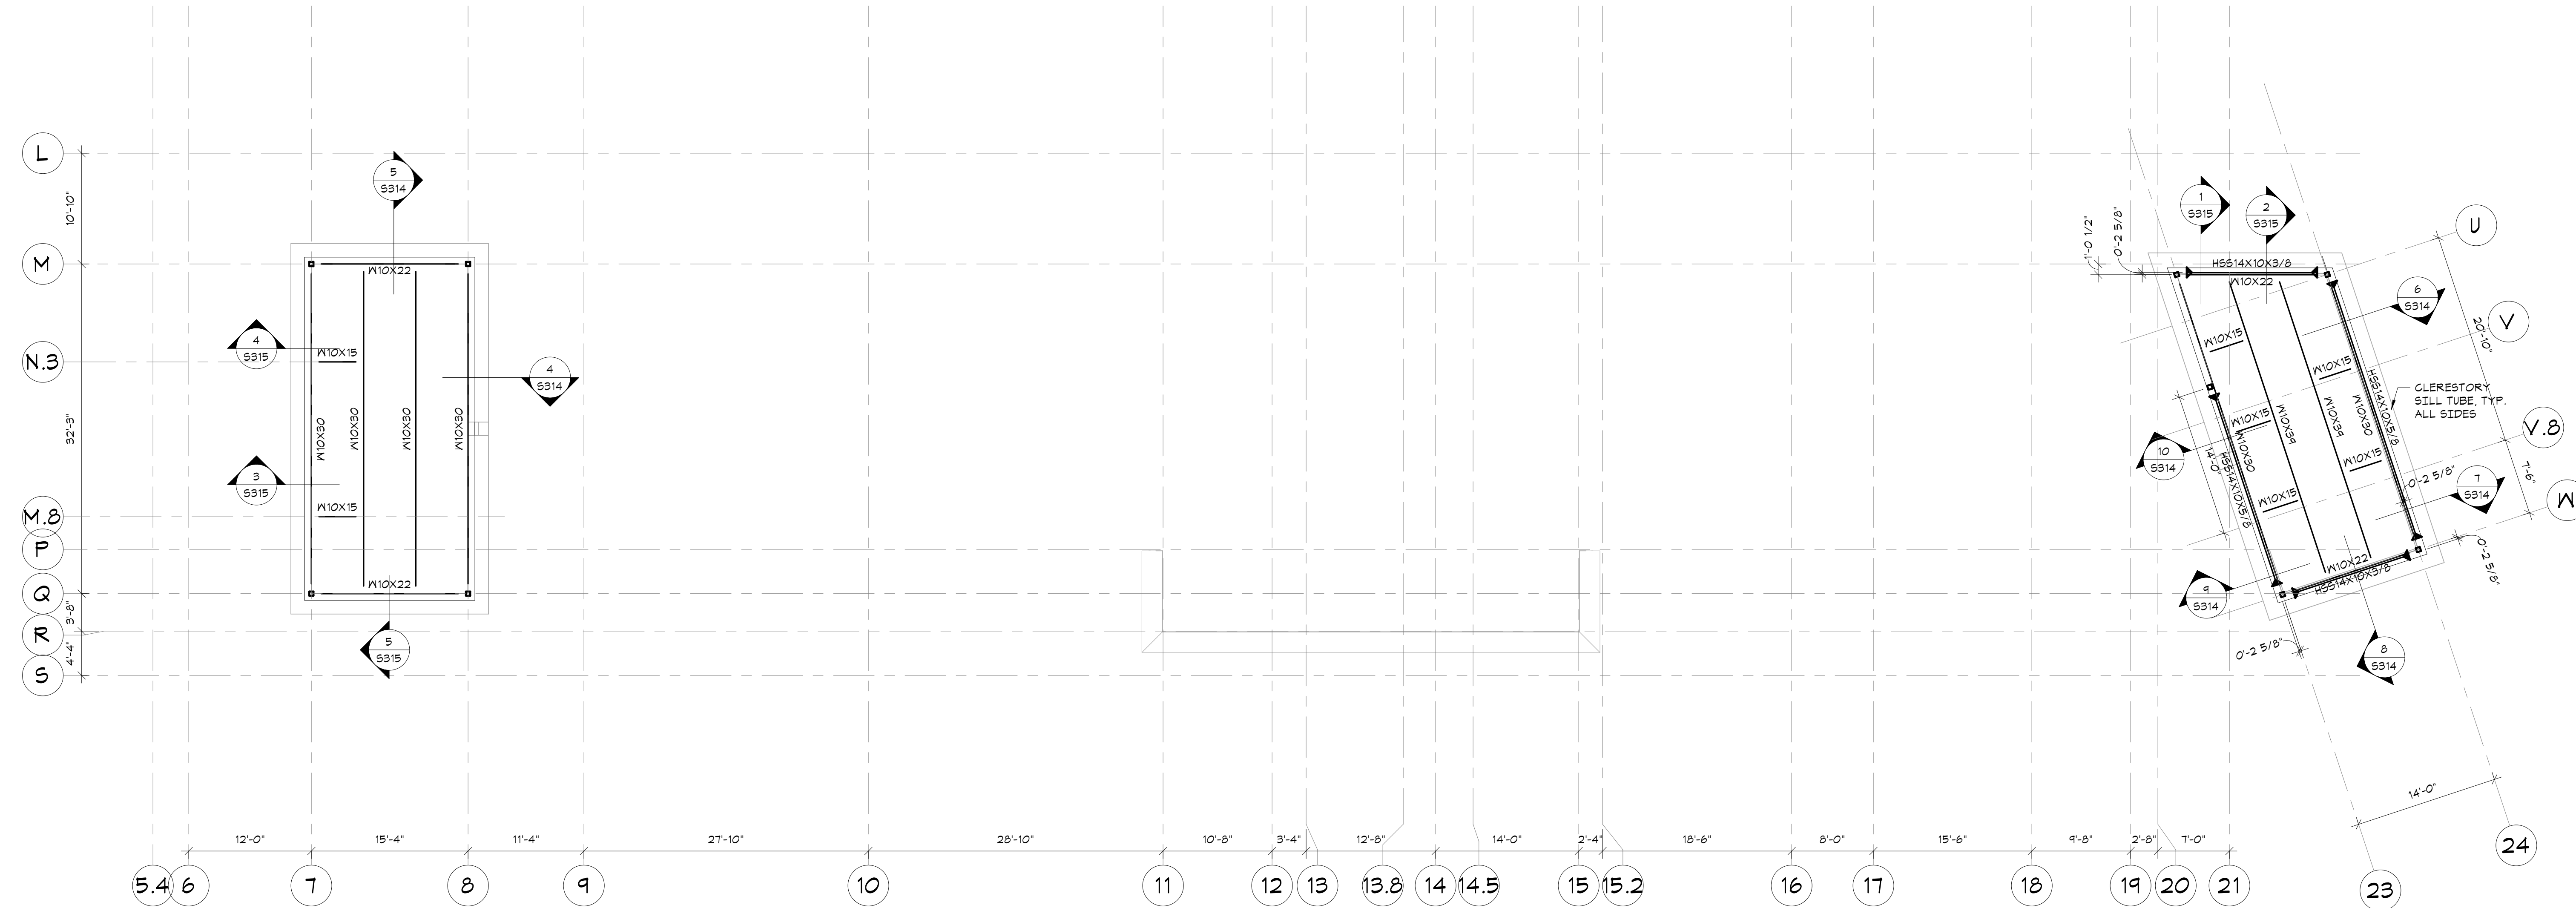
NY SED PROJECT CONTROL NO.

**66-23-00-01-0-346-001**

CONSTRUCTION DOCUMENTS

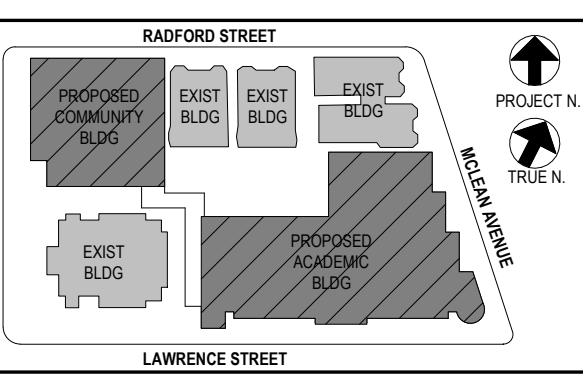
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**STAIR TOWER ROOF FRAMING PLAN**  
1/8"=1'-0"

- TOP OF STAIR A ROOF STEEL ELEVATION (UNDERSIDE OF DECK): 54'-0" UNLESS OTHERWISE NOTED THUS (V'-X'-XX") FROM ELEVATION 54'-0".
- TOP OF STAIR B ROOF STEEL ELEVATION (UNDERSIDE OF DECK): 52'-4" UNLESS OTHERWISE NOTED THUS (V'-X'-XX") FROM ELEVATION 52'-4".
- ROOF DECK CONSTRUCTION: METAL ROOF DECK. SEE GENERAL NOTES.
- STEEL FRAMING TO BE COATED WITH FIRE RESISTIVE MATERIAL. REFER TO PROJECT SPECIFICATIONS.
- ALL FRAMING SHALL BE EQUALLY SPACED BETWEEN COLUMN LINES, UNLESS OTHERWISE INDICATED.
- COORDINATE SIZE AND LOCATION OF ALL ROOF PENETRATIONS WITH ARCHITECTURAL, MECHANICAL, AND ELECTRICAL DRAWINGS. ALL ROOF PENETRATIONS SHALL BE REVIEWED BY THE ENGINEER PRIOR TO FABRICATION AND INSTALLATION OF PENETRATION FRAMING ELEMENTS. PROVIDE FRAMING AS INDICATED IN 'TYPICAL ROOF/FLOOR OPENING DETAIL'. DO NOT SCALE OPENINGS.
- MAXIMUM WEIGHT OF MECHANICAL UNITS, (INCLUDING WEIGHT OF CURB) USED IN THE DESIGN OF SUPPORTING MEMBERS ARE INDICATED ON THE PLANS. SEE MECHANICAL DRAWINGS FOR LOCATION OF MECHANICAL UNITS. FOR FRAMING INFORMATION, SEE 'TYPICAL ROOFTOP UNIT CURB DETAIL' AND GENERAL NOTES.
- SEE GENERAL NOTES FOR ADDITIONAL INFORMATION.



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Professional Seal

4	11/01/21	ISSUE FOR BID
3	07/14/21	CONSTRUCTION DOCS - NYSED
2	12/15/20	DESIGN DEVELOPMENT
1	08/31/20	SCHEMATIC DESIGN

No.	Date	Issue

Sheet Title

**STAIR ROOF FRAMING PLAN**

Job No.	20142.00	Date	10/30/2020
Scale	AS NOTED	Engr'n / Checked	TM / EM

Sheet Number

**S106**

