

NEW COMMUNITY SCHOOL 35 AT ST DENIS SITE

YONKERS JOINT SCHOOL CONSTRUCTION BOARD

121 McLean Avenue, Yonkers, NY 10705



385 MAIN STREET MOUNT KISCO, NEW YORK, 10549
P: 914.666.5900 KGDARCHITECTS.COM



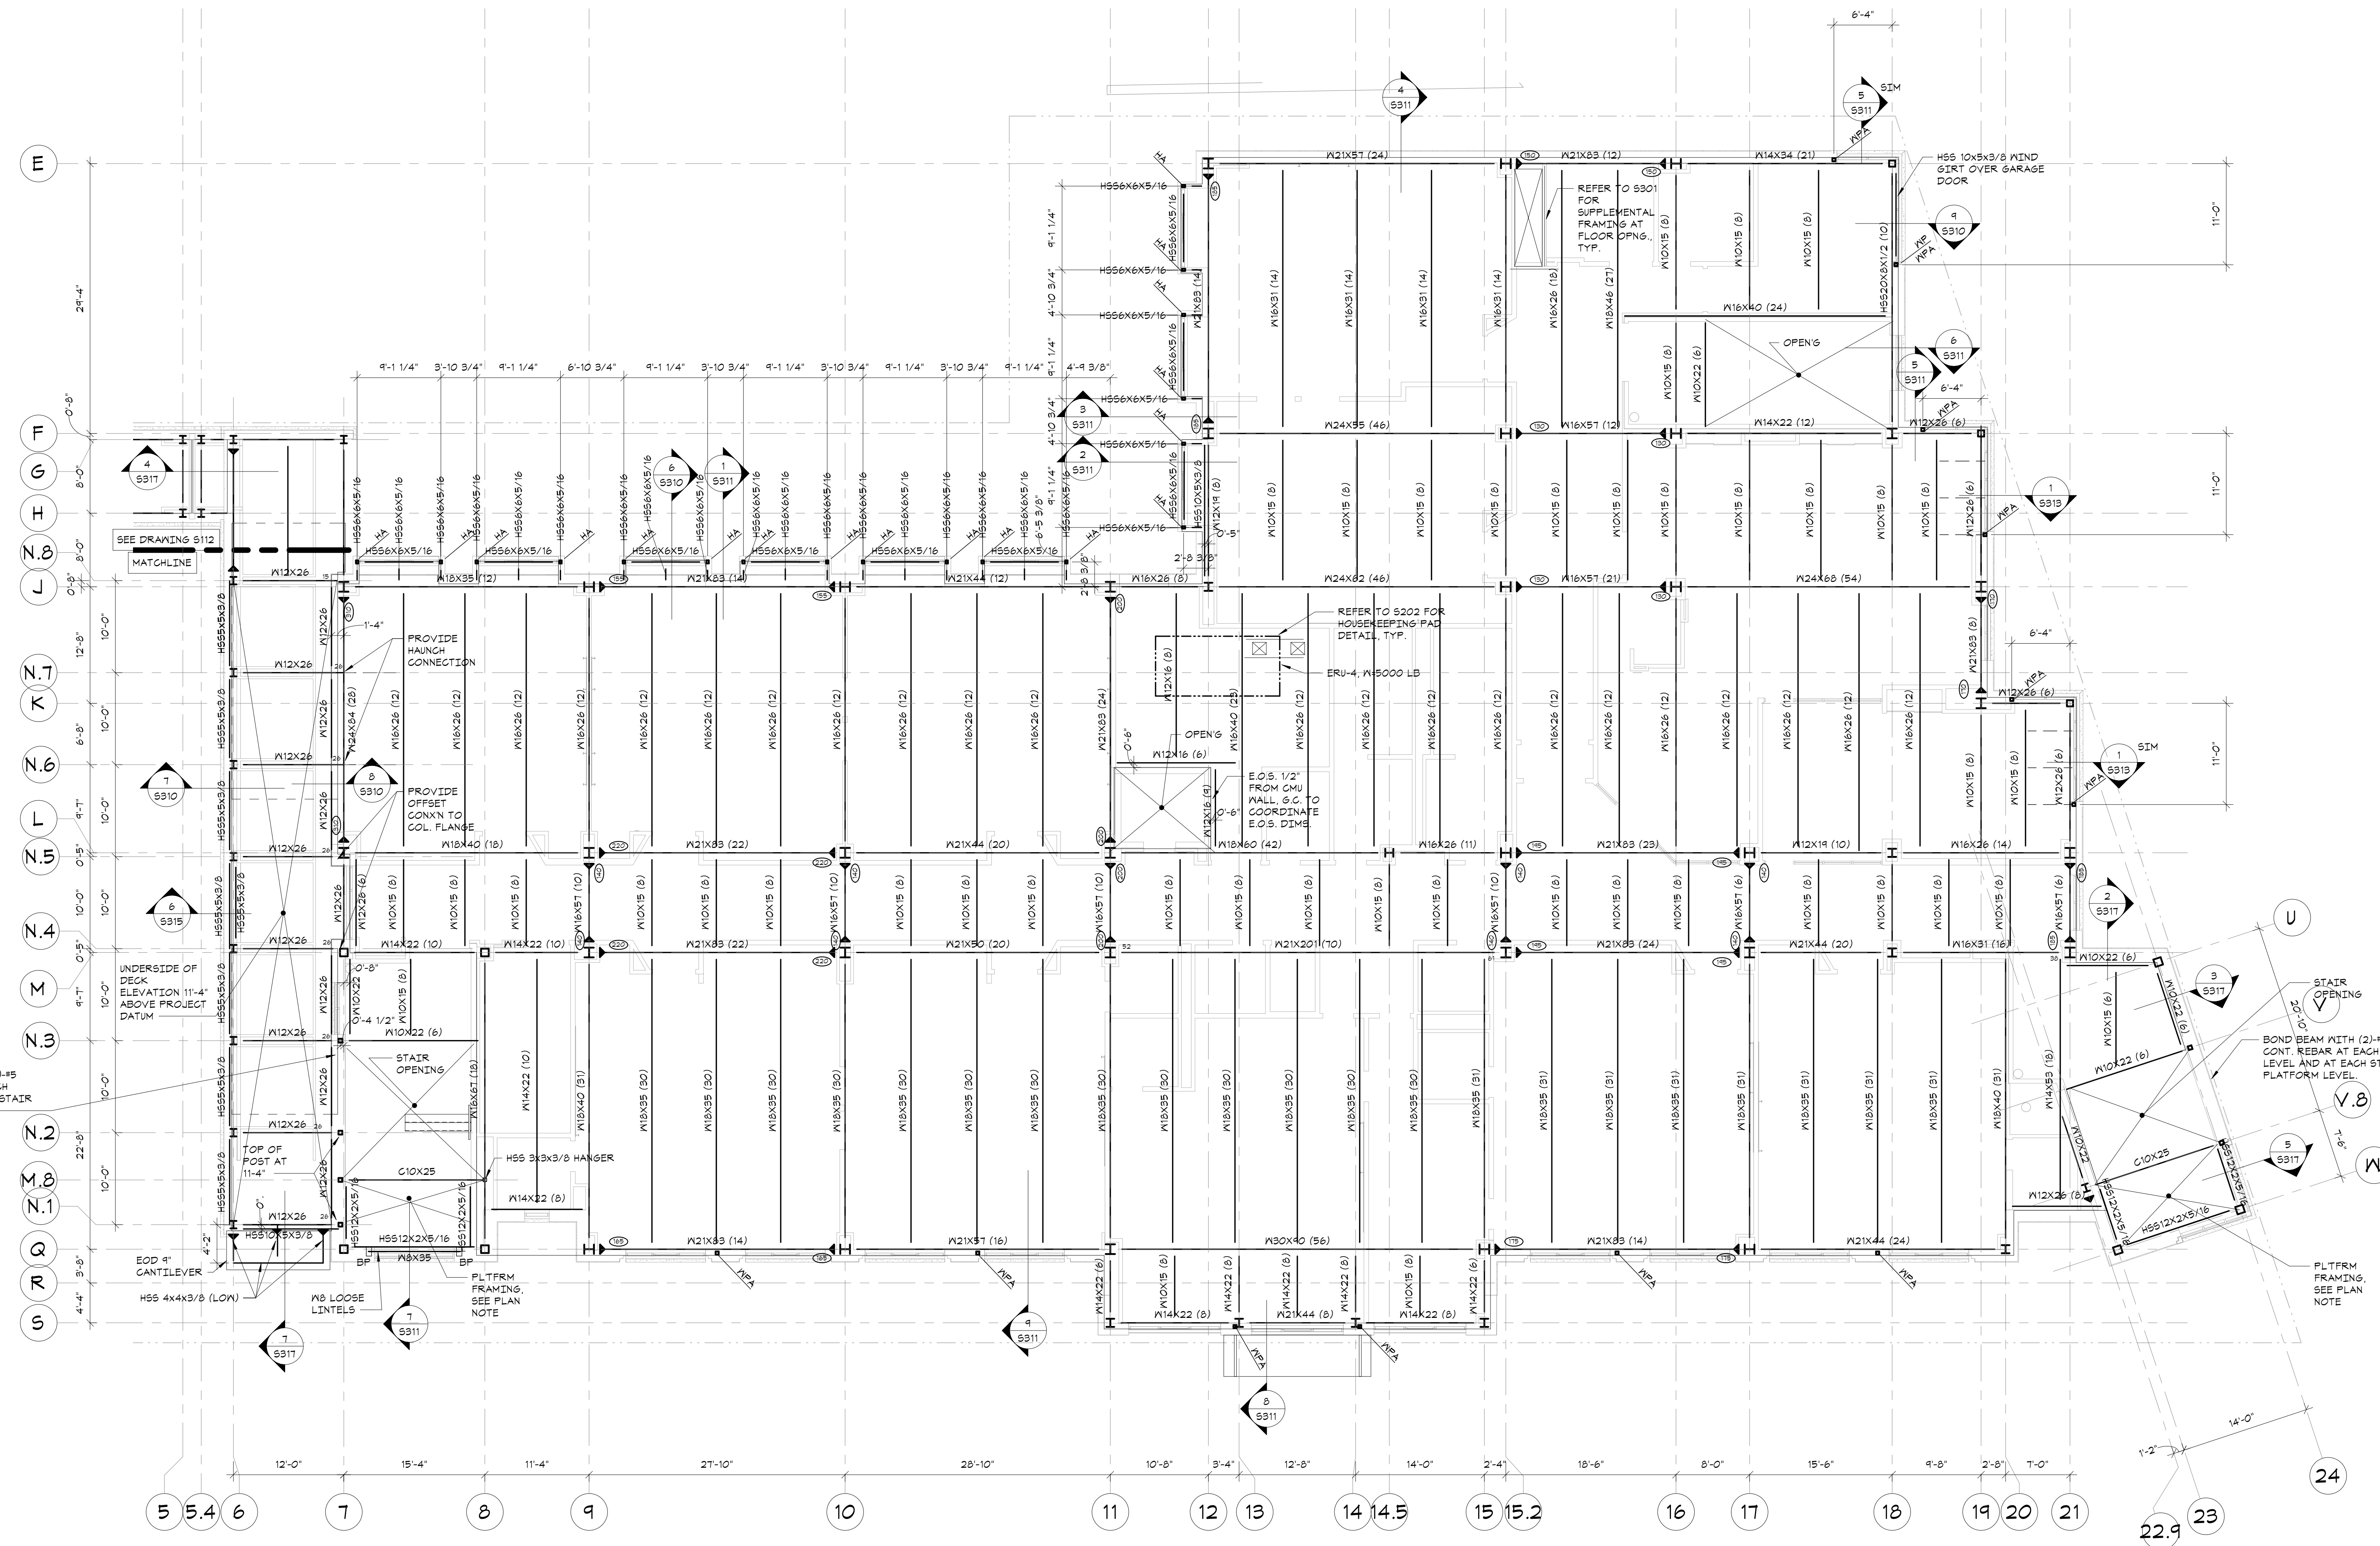
83 Wooster Heights Road | Suite 200
Lisle Farm Corporate Park | Danbury, CT 06810
(203) 490-4140 | www.dsleg.com

NY SED PROJECT CONTROL NO.
66-23-00-01-0-346-001

CONSTRUCTION DOCUMENTS

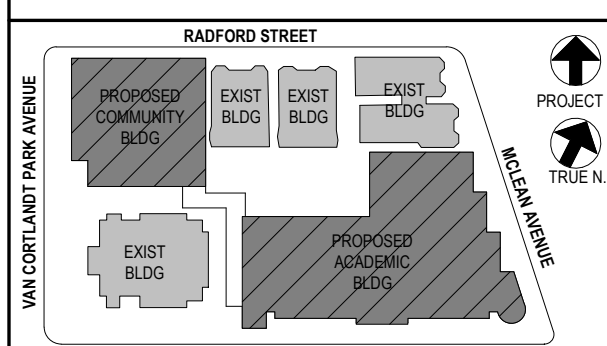
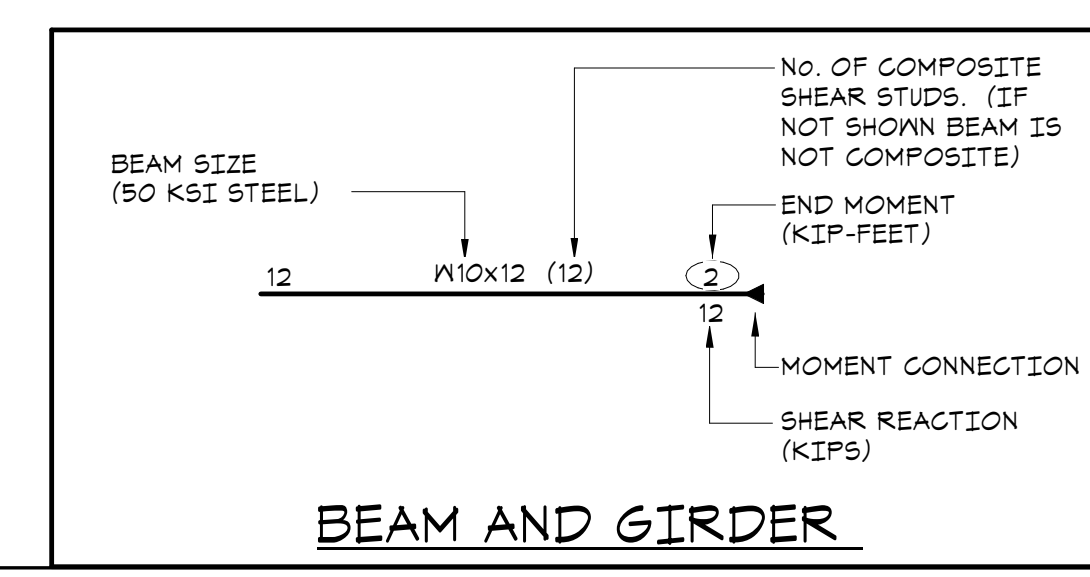
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SECOND FLOOR AND LINK ROOF FRAMING PLAN
1/8"=1'-0"

- TOP OF SECOND FLOOR ELEVATION: 19'-4" ABOVE DATUM.
- TOP OF STEEL (UNDERSIDE OF DECK) ELEVATION: 12'-10 1/2" UNLESS OTHERWISE NOTED THIS 1/2" X 1/2" FROM ELEVATION 12'-10 1/2".
- FLOOR CONSTRUCTION: 5 1/2" COMPOSITE CONCRETE SLAB = 3 1/2" NORMAL WEIGHT CONCRETE ON 2" COMPOSITE DECK REINFORCED WITH 5#X14@14" AND 4#5 AS PER TYPICAL COMPOSITE BEAM FLOOR CONSTRUCTION DETAIL AND GENERAL NOTES.
- ROOF CONSTRUCTION: METAL ROOF DECK. SEE GENERAL NOTES.
- PLATFORM FRAMING FOR STAIR A & B IS TO BE INSTALLED WITH STRUCTURAL STEEL. THE PLATFORM PROVIDES STABILITY FOR THE BUILDING COLUMNS.
- STEEL FRAMING TO BE COATED WITH FIRE RESISTIVE MATERIAL. REFER TO PROJECT SPECIFICATIONS.
- ALL FRAMING SHALL BE EQUALLY SPACED BETWEEN COLUMN LINES, UNLESS OTHERWISE INDICATED.
- COORDINATE SIZE AND LOCATION OF ALL FLOOR PENETRATIONS WITH ARCHITECTURAL, MECHANICAL, AND ELECTRICAL DRAWINGS. ALL FLOOR PENETRATIONS SHALL BE REVIEWED BY THE ENGINEER PRIOR TO FABRICATION AND INSTALLATION OF PENETRATION FRAMING ELEMENTS. PROVIDE FRAMING AS INDICATED IN TYPICAL ROOF/FLOOR OPENING DETAIL. DO NOT SCALE OPENINGS.
- 'HA' INDICATES H594X33/8 HANGERS ABOVE.
- 'WPA' INDICATES H55 4X4X3/8 WIND POST ABOVE.
- SLAB SHALL BE FULLY COMPOSITE BEFORE INSTALLING VENEER.
- SEE GENERAL NOTES FOR ADDITIONAL INFORMATION.



NOTE: ALL IDEAS, DESIGN ARRANGEMENTS AND PLANS INDICATED OR REPRESENTED BY THIS DRAWING ARE OWNED BY AND ARE THE PROPERTY OF KGD ARCHITECTS PC AND ARE NOT TO BE REPRODUCED OR USED FOR ANY OTHER PROJECT WITHOUT THE WRITTEN PERMISSION OF KGD ARCHITECTS PC.

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Professional Seal

4	11/01/21	ISSUE FOR BID
3	07/14/21	CONSTRUCTION DOCS - NYSED
2	12/15/20	DESIGN DEVELOPMENT
1	08/31/20	SCHEMATIC DESIGN

No.	Date	Issue

SECOND FLOOR AND LINK ROOF FRAMING PLAN

Job No. 20142.00 Date 10/30/2020

Scale AS NOTED Eng'n'r / Checked TM / EM

Sheet Number **S102**