

# <u>Addendum</u>

Mahopac Central School District Mahopac, New York

Reconstruction at Mahopac High School Mahopac Middle School Mahopac Falls School Bus Garage New Pump House

Tt Project No. 121111-19002

Cornell Business + Technology Park 10 Brown Road Ithaca, New York 14850 Tel. (607) 277-7100 Fax (607) 277-1410

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SED NO. 48-01-01-06-0-004-020 48-01-01-06-0-006-013 48-01-01-06-0-003-008

> 48-01-01-06-5-010-009 48-01-01-06-7-026-001

BID Addendum No. 4 to Drawings and Project Manual

March 1, 2021

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#### To: BIDDERS

This ADDENDUM forms a part of the BIDDING AND CONTRACT DOCUMENTS and modifies the following documents: Original DRAWINGS dated August 21, 2020. PROJECT MANUAL dated August 21, 2020, BID ADDENDUM NO. 1, dated February 12, 2021, BID ADDENDUM

NO. 2, dated February 16, 2021 and BID ADDENDUM NO. 3, dated February 22, 2021.

Acknowledge receipt of the ADDENDUM in the space provided on the FORM OF PROPOSAL

This ADDENDUM consists of (9) pages and the following:

#### ATTACHMENTS

PRE-BID REQUEST FOR INFORMATION QUESTIONS/ANSWERS

#### **NEW PROJECT MANUAL SECTIONS**

SECTION 01 12 00 – SUMMARY OF PROJECT - HS SITE LOGISTICS PLAN ATTACHMENT SECTION 01 12 00 – SUMMARY OF PROJECT - MS SITE LOGISTICS PLAN ATTACHMENT SECTION 26 08 00 – COMMISSIONING OF ELECTRICAL

#### NEW DRAWINGS (8-1/2 x 11)

AC01B Trench Drain - Section

#### **REISSUED DRAWINGS (30 x 42)**

AE132Second Floor Lighting PlanAE600SchedulesZC505Site Details

#### PROJECT MANUAL MODIFICATIONS

ITEM 4-C-1: Refer to SECTION 00 01 10 - TABLE OF CONTENTS – VOLUME 2

- 1. Division 26, <u>ADD</u> the following:
  - "26 08 00 Commissioning of Electrical"

#### ITEM 4-C-2: Refer to SECTION 01 08 00 - GENERAL COMMISSIONING REQUIREMENTS

- 1. Part 3, <u>ADD</u> the following:
  - "3.11 STANDARD AND CORE COMPLIANCE
    - A. Commissioning will be accomplished to comply with, and in accordance with the requirements of the following:
      - 1. New York State Energy Conservation Code (NYSECC)
  - 3.12 SYSTEMS TO BE COMMISSIONED
  - A. The following systems will be commissioned in this project. The Owner and the CxA reserves the right to amend this list at any time during the construction and acceptance process.
    - 1. HVAC Systems
    - 2. Direct Digital Control System
    - 3. Air Handling Systems
    - 4. Dedicated Outside Air System
    - 5. Direct Expansion Evaporators and associated Condensing Units
    - 6. Exhaust System and Fans
    - 7. Ducted Air Systems
    - 8. Roof Top Units
    - 9. Unit Ventilators
    - 10. Cabinet Unit Heaters
    - 11. Fan Coil Units
    - 12. Vehicle Exhaust System
    - 13. Make Up Air Units
    - 14. Variable Refrigerant Flow System
    - 15. Lighting Controls".

#### ITEM 4-C-3: Refer to SECTION 01 12 00 – SUMMARY OF PROJECT

1. <u>ADD</u> HS Site Logistic and MS Site Logistics attached to this addendum to end of section.

#### **PROJECT MANUAL MODIFICATIONS - ARCHITECTURAL**

ITEM 4-C-4: Refer to SECTION 08 56 53 – SLIDING SECURITY WINDOWS

- 1. Paragraph 2.2, F., 1., <u>AMEND</u> to read as follows:
  - "1. Type SCL: Clear laminated-glass security glazing:
    - a. Basis-of-Design Product: Subject to compliance with requirements, provide Laminated Technologies Inc.; SG5 by School Guard Glass, or comparable product.
    - b. Safety glazing required."

ITEM 4-C-5: Refer to SECTION 08 71 00 – DOOR HARDWARE

- 1. Paragraph 1.6, <u>ADD</u> the following:
  - "D. Fire Rated Hardware Coordination: For doors and openings that are fire rated and require specific hardware to maintain fire ratings when tested as a component of the rated opening, provide submittals for the specific hardware items that are required to maintain the fire ratings indicated."

ITEM 4-C-6: Refer to SECTION 08 88 00 – GLAZING

- 1. Paragraph 2.4, <u>ADD</u> the following:
  - "C. Laminated Glass: ASTM C1172. Use materials that have a proven record of no tendency to bubble, discolor, or lose physical and mechanical properties after fabrication and installation.
    - 1. Construction: Laminate glass with polyvinyl butyral interlayer to comply with interlayer manufacturer's written instructions.
    - 2. Interlayer Thickness: Provide thickness not less than 0.060 inch and as needed to comply with requirements.
    - 3. Interlayer Color: Translucent provide samples for selection.
    - 4. Appearance: Provide laminated glass without haze and with visual clarity and transparency indistinguishable from clear fully tempered float glass.
    - 5. Type HCL: Two plies of clear heat-strengthened float glass laminated.
      - a. Manufacturers: Subject to compliance with requirements, available manufacturers offering products that may be incorporated in the Work include, but are not limited to:
        - 1) AGC Glass Company North America, Inc.
        - 2) Guardian Glass, LLC.
        - 3) Vitro Architectural Glass.
      - b. Minimum Thickness of Each Ply: 3 mm.
      - c. Safety glazing required."

- 2. Paragraph 2.5, <u>ADD</u> the following:
  - "D. Fire-Protection-Rated Laminated Ceramic Glazing: Laminated glass made from two plies of clear, ceramic glass; complying with 16 CFR 1201, Category II.
    - 1. Type FPC: Fire-protection-rated laminated ceramic glazing.
      - a. Products: Subject to compliance with requirements, available products that may be incorporated in the Work include, but are not limited to:
        - 1) Safti First Fire Rated Glazing Solutions; Pyran Platinum L.
        - 2) Technical Glass Products; FireLite Plus.
      - b. Rating: As indicated on Drawings.
      - c. Thickness: 8-9 mm.
      - d. Safety glazing required."
- 3. Paragraph 2.6, B., 1., a., 1), <u>AMEND</u> to read as follows:
  - "1) Technical Glass Products, Pilkington Pyrostop (clear or translucent intumescent interlayer where indicated on drawings)."
- 4. Paragraph 2.6, B., 1., e., <u>AMEND</u> to read as follows:
  - "e. Refer to drawings for locations of clear vs. translucent intumescent interlayer."

#### PROJECT MANUAL MODIFICATIONS - LANDSCAPE

#### ITEM 4-C-7: Refer to SECTION 33 41 00 – STORM UTILITY DRAINAGE PIPING

- 1. Paragraph 2.11, A., 5., <u>AMEND</u> to read as follows:
  - "5. Basis of Design:
    - a. For 24" Clear Openings Similar to Frame "Model #V5626 and Grate "Type M3 ADA Grate" V5726-80 by East Jordan Iron Works, Inc.
    - b. For 30" Clear Openings Similar to Frame "Model #V5630 and Grate "Type M3 ADA Grate" V5630-80 by East Jordan Iron Works, Inc."
- 2. Paragraph 2.12, A., 1., <u>AMEND</u> to read as follows:
  - "... provide SC-740 and MC-3500 chamber system ..."
- 3. Paragraph 2.12, A., 2., <u>ADD</u> the following:
  - "a. Chamber dimensions and capacity:
    - 1) Small Chamber
      - a) Installed Size (L x W x H): 85.4" x 51.0" x 30.0"
      - b) Storage volume: 45.9 ft<sup>3</sup> (chamber alone)
      - c) Storage volume: 74.9 ft<sup>3</sup> (with 6" stone base)

- b. Chamber dimensions and capacity:
  - 1) Large Chamber
    - a) Installed Size (L x W x H): 86.0" x 77.0" x 45.0"
    - b) Storage volume:  $109.9 \text{ ft}^3$  (chamber alone)
    - c) Storage volume: 178.9 ft<sup>3</sup> (with 9" stone base)."
- 4. Paragraph 2.14, A., <u>ADD</u> the following:
  - "4. Outlet Structure Frame and Cover Basis of Design Clear round opening size: 32", Similar to Frame "Model #V1610-6 and Cover "V1610-4" by East Jordan Iron Works, Inc.

#### **DRAWING MODIFICATIONS - ARCHITECTURAL**

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1. Detail 5, STOR. 106D and SHOWER 106E Rooms, <u>ADD</u> the following note:

"ROOMS HAVE WALL TILE."

ITEM 4-C-9: Refer to DRAWING AA104

1. Doors L101-2, L101-2, L101-3 & L101-4, <u>AMEND</u> the plan to show 4" portions of Wall Type P13.3 between each of the doors in order to create 4 separate aluminum frame door openings instead of these 4 doors being contained within one frame unit.

ITEM 4-C-10: Refer to DRAWING AA600

1. Storefront Type S1, <u>AMEND</u> the glass type to read as follows:

Martin

2. Storefront Type S1, <u>ADD</u> the following note:

"SLIDING SECURITY WINDOW."

3. Storefront Type S14 and S1, <u>AMEND</u> the glass type to read as follows:

"FC AND HCL."

- 4. Storefront Type S5, <u>AMEND</u> the Door to Type G2 in the elevation with the door glazing hatched gray.
- 5. Door Schedule, <u>AMEND</u> Doors L101-1, L101-2, L101-3 & L101-4 to each have Frame Type F2.
- 6. Door Schedule, <u>AMEND</u> Doors L101-1, L101-2, L101-3 & L101-4 to each be Door Type G2.
- 7. Door Schedule, <u>AMEND</u> Doors 235-1, 238-1, 239-1, 242-1, 243-1 and 244-1 to each be Door Type G2.
- 8. Note which reads, "GRAY HATCHED GLASS AREAS ARE ACID ETCHED GLASS", <u>AMEND</u> to read as follows:

"GRAY HATCHED GLASS AREAS CONTAIN A TRANSLUCENT INTERLAYER BETWEEN GLASS PLIES. REFER TO GLAZING SPEC FOR ADDITIONAL INFORMATION."

# VITEM 4-C-11: Refer to DRAWING AA161

1. Detail 4, <u>ADD</u> Detail 17/AA750 keyed into the ceiling openings in rooms Science 234 and Physics 238. The detail applies to the entire perimeter of the ceiling openings. Lighting shown on electrical drawings will be surface mounted to the ceiling perimeter trim around the openings.

# DRAWING MODIFICATIONS - LANDSCAPE

ITEM 4-C-12: Refer to DRAWING AC100

1. Keynote #3 indicated in sheet grid locations J-6 and J-8, <u>AMEND</u> to read as follows:

"Keynote #19."

2. Keynote #26 in sheet grid locations H-10 and I-10, <u>AMEND</u> to read as follows:

"Keynote #19."

- 3. Keynote Notes, <u>ADD</u> the following:
  - "45. REINSTALL EXISTING CHAIN LINK FENCE SECTION TEMPORARILY REMOVED AND STORED, TO ALLOW WATER LINK INSTALLATION WHERE INDICATED." <u>ADD</u> LABEL TO SHEET GRID LOCATION J-16 REFERENCING SECTION OF TEMPORARY FENCE REMOVAL INDICATED AS KEYNOTE 26 ON SHEET AC100."
- ITEM 4-C-13: Refer to DRAWING AC120
- 1. Detail 1, <u>AMEND</u> "PROPOSED WATER TANK" to read as follows:

"FACILITY GROUND-MOUNTED, POTABLE-WATER STORAGE TANK".

2. Detail 1, <u>AMEND</u> "PROPOSED BUILDING" to read as follows:

"PUMP HOUSE".

- 3. <u>DELETE</u> Site Layout Keynote #29 in its entirety. <u>DELETE</u> Site keynote labels #29 from drawing indicated at sheet grid locations G-5 and G-11.
- 4. <u>DELETE</u> Site Layout Keynote #30 in its entirety. <u>DELETE</u> Site keynote labels #30 from drawing indicated at sheet grid locations F-5 and F-11.
- 5. Site Layout Keynote #25, <u>ADD</u> the following text:

"TREE HEIGHT TO BE 6-8 FOOT SPECIMEN TREE. SHRUBS TO BE 2-GALLON CONTAINER SIZE."

6. Site Layout Keynote #26, <u>ADD</u> the following text:

"SHRUBS TO BE 2-GALLON CONTAINER SIZE."

7. Site Layout Keynote #33, <u>ADD</u> the following text:

"NOTE: COMPLY WITH THE LIMITS OF DISTURBANCE / RESEEDING REQUIREMENTS INDICTED ON THE DRAWINGS. REFER TO THE SPECIFIED EARTHWORK REQUIREMENTS REGARDING TOPSOIL STRIPING AND MATERIAL STOCKPILING. THE 6" TOPSOIL FOR THE SEEDING AREAS WOULD APPLY ONLY TO THOSE AREAS CLEARED AND DISTURBED FOR DEMO AND IMPROVEMENTS."

8. Site Layout Keynote #32, <u>AMEND</u> detail reference to read as follows:

"Detail 4 / ZC506".

- 9. Keynotes, <u>ADD</u> the following:
  - "45. REINSTALL EXISTING CHAIN LINK FENCE SECTION TEMPORARILY REMOVED AND STORED, TO ALLOW WATER LINK INSTALLATION WHERE INDICATED." <u>ADD</u> LABEL TO SHEET GRID LOCATION J-16 REFERENCING SECTION OF TEMPORARY FENCE REMOVAL INDICATED AS KEYNOTE 26 ON SHEET AC100."
- ITEM 4-C-14: Refer to DRAWING AC121
- 1. Detail 3, <u>AMEND</u> "PROPOSED WATER TANK" to read as follows:

"FACILITY GROUND-MOUNTED, POTABLE-WATER STORAGE TANK".

- Detail 3, <u>AMEND</u> "PROPOSED BUILDING" to read as follows:
   "PUMP HOUSE".
- ITEM 4-C-15: Refer to DRAWING AC130
- Detail 1, <u>AMEND</u> "PROPOSED WATER TANK" to read as follows:
   "FACILITY GROUND-MOUNTED, POTABLE-WATER STORAGE TANK".
- Detail 1, <u>AMEND</u> "PROPOSED BUILDING" to read as follows:
   "PUMP HOUSE".
- ITEM 4-C-16: Refer to DRAWING AC131
- Detail 3, <u>AMEND</u> "PROPOSED WATER TANK" to read as follows:
   "FACILITY GROUND-MOUNTED, POTABLE-WATER STORAGE TANK".
- Detail 3, <u>AMEND</u> "PROPOSED BUILDING" to read as follows:
   "PUMP HOUSE".
- ITEM 4-C-17: Refer to DRAWING AC140
- Detail 1, <u>AMEND</u> "PROPOSED WATER TANK" to read as follows:
   "FACILITY GROUND-MOUNTED, POTABLE-WATER STORAGE TANK".

2. Detail 1, <u>AMEND</u> "PROPOSED BUILDING" to read as follows:

"PUMP HOUSE".

- ITEM 4-C-18: Refer to DRAWING AC141
- 1. Detail 3, <u>AMEND</u> "PROPOSED WATER TANK" to read as follows:

"FACILITY GROUND-MOUNTED, POTABLE-WATER STORAGE TANK".

2. Detail 3, <u>AMEND</u> "PROPOSED BUILDING" to read as follows:

"PUMP HOUSE".

#### ITEM 4-C-19: Refer to DRAWING BC120

- 1. Site Layout Keynote #29, <u>AMEND</u> to read as follows:
  - "29. 8-FT TALL BLACK VINYL CLAD CHAIN LINK FENCE AT PERIMETER OF SYNTHETIC TURF FIELD AND PERIMETER CURB. SEE DETAIL 7 / ZC503 AND DETAIL 5 AND 6 / ZC501."
- ITEM 4-C-20: Refer to DRAWING ZC501
- 1. Site Detail #2, <u>DELETE</u> in its entirety.
- 2. Site Detail #3, <u>DELETE</u> in its entirety.
- 3. Site Detail #6, <u>ADD</u> the following notes:
  - "a. NOTE #1: WHERE INSTALLATION OF BALLSTOPPER WITH COMBINED CHAIN-LINK FENCE AND CURB (HIGH SCHOOL) PER DETAIL #4, SHEET ZC506, IS REQUIRED, NO SEPARATE PERIMETER CURBING WILL APPLY, AND SYNTHETIC TURF NAILER WILL BE INSTALLED DIRECTLY TO THE SYSTEM FOUNDATION.
  - b. NOTE #2: WHERE INSTALLATION OF CHAIN-LINK FENCE ONLY (MIDDLE SCHOOL), PER DETAIL #2, SHEET ZC501, IS REQUIRED, NO SEPARATE PERIMETER CURBING WILL APPLY, WITH SYNTHETIC TURF NAILER INSTALLED DIRECTLY TO THE CHAIN LINK FENCE FOUNDATION. NOTE THAT SYNTHETIC TURF EDGE, PER THIS DETAIL, WILL THEREFORE CREATE A CONTINUOUS LENGTH OF CURB NAILER SURFACE WHEN COMBINED WITH CHAIN LINK FENCE FOUNDATIONS."
- ITEM 4-C-21: Refer to DRAWING ZC502
- 1. <u>DELETE</u> Site Detail #3 in its entirety and, <u>ADD</u> new Drawing AC01B attached to this addendum.

ITEM 4-C-22: Refer to DRAWING ZC505

1. <u>DELETE</u> drawing in its entirety and, <u>ADD</u> new drawing attached to this addendum.

#### **DRAWING MODIFICATIONS - MECHANICAL**

ITEM 4-C-23: Refer to DRAWING AM102

- 1. Note, 9, <u>AMEND</u> to read as follows:
  - "9. PROVIDE SEPARATE <sup>3</sup>/<sub>4</sub>" HWS, HWR TO EACH FTR IN ROOMS 111, 113, AND 115. FTR SHOULD BE PIPED IN PARALLEL AS OPPOSED TO IN SERIES."

#### **DRAWING MODIFICATIONS - ELECTRIC**

- ITEM 4-C-24: Refer to DRAWING AE132
- 1. <u>DELETE</u> drawing in its entirety and, <u>ADD</u> new drawing attached to this addendum.

ITEM 4-C-25: Refer to DRAWING AE600

1. <u>DELETE</u> drawing in its entirety and, <u>ADD</u> new drawing attached to this addendum.

## **END OF ADDENDUM**



## SUBMIT FORM BY EMAIL TO INE.Mahopac@tetratech.com

**Project No.:** 121111-19002

Date: 2/23/2021

**Project Name:** Reconstruction to Mahopac High School, Mahopac Middle School, Mahopac Falls School, Bus Garage, and New Pump House

Bidder Contact Person: Stephanie Weber
Bidder Company Name: Bertussi Contracting Inc
Bidder Phone: <sup>845-538-4234</sup>
Bidder Email Address: sweber@bertussis.com
Question Pertains to: Unit Heaters
Drawing Number:
Plan Area:
Room Number: Bus Garage
Drawing Detail Number:
Specification Section:

**Question: (Please be specific)** 

Who is responsible for providing the gas to the unit heaters in the bus garage? The HVAC or Plumbing contractor? Please advise.

**Review by Architect/Engineers:** 

**Responded By:** HR/TPG Date: 02-26-21

Please refer to Spec Section 01 12 00 1.9 CONTRACT 3 - MECHANICAL WORK CONTRACT
5 - i. Provide and install new unit heaters, piping controls
Spec Section 23 82 00 2.3 Gas Fired Unit Heaters

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## SUBMIT FORM BY EMAIL TO INE.Mahopac@tetratech.com

**Project No.:** 121111-19002

Date: 2/16/2021

**Project Name:** Reconstruction to Mahopac High School, Mahopac Middle School, Mahopac Falls School, Bus Garage, and New Pump House

Bidder Contact Person: Stephanie Weber	
Bidder Company Name: Bertussi Contracting Inc	
Bidder Phone: <sup>845-538-4234</sup>	
Bidder Email Address: sweber@bertussis.com	
Question Pertains to: Controls	
Drawing Number:	
Plan Area:	
Room Number:	
Drawing Detail Number:	
Specification Section:	

With regard to the RFI response on the HVAC Controls, I understand it is a Johnson Controls systems, but wanted to confirm that the controls portion is being carried/paid by the owner and not the HVAC Prime. The summary of work indicates controls are a State Contract (see attached.) Also under the HVAC summary of work it states controls is included in the HVAC contract for coordination and ancillary purposes only.

**Review by Architect/Engineers:** 

Responded By: HR/TPG Date: 02-26-21

Please refer to spec section 23 09 00 INSTRUMENTATION AND CONTROL FOR HVAC Also to refer to spec section 01 12 00 1.14 STATE CONTRACT - CONTROLS WORK

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- 13. Provide traffic control for deliveries, and equipment needed to perform the work of their own Prime Contract.
- 14. Provide protection of its own finished Work, after installation, until accepted by the Owner.
- 15. Provide fire caulking for any penetration related to the work for its own Prime Contract.
- 16. Provide final cleaning per Spec Section 01 77 00.
- 17. Provide any office and storage trailers required to complete the work of their own Prime Contract.
- 18. Provide for a thorough final cleaning of the site, building, and equipment provided under their Prime Contract immediately before the final inspection. Each Prime Contractor is responsible for cleaning and dust and debris generated from the work of their own Contract.
  - a. Maintain areas in a cleaned condition until the Owner occupies the space.
  - b. Personnel: Experienced workman or professional cleaners approved by the Construction Manager.

## 1.5 SUMMARY OF WORK

- A. The work will be constructed under multiple prime contracts. One set of contract documents is issued covering the multiple contracts. Each Prime Contract is defined as:
  - 1. CONTRACT 1 GC GENERAL CONSTRUCTION WORK
  - 2. CONTRACT 2 PC PLUMBING WORK
  - 3. CONTRACT 3 MC MECHANICAL WORK
  - 4. CONTRACT 4 EC ELECTRICAL WORK
  - 5. CONTRACT 5 AB HAZARDOUS MATERIALS WORK
  - 6. CONTRACT 6 CE CASEWORK AND LAB EQUIPMENT WORK
  - 7. CONTRACT 7 SW SITE CONSTRUCTION WORK
  - 8. STATE CONTRACT BUILDING CONTROLS (for coordination purposes)
- 1.6 WORK UNDER SEPARATE CONTRACTS
  - A. The project will be constructed under a multiple-prime contracting arrangement
  - B. One set of documents is issued covering all multiple prime contracts. Each prime contractor is to review ALL drawings and specifications for complete understanding and knowledge of the work.
  - C. The following Contract Documents are specifically included and defined as integral to each Prime Contract.
    - 1. Bidding Requirements
    - 2. Performance and Payment Bonds
    - 3. Conditions of the Contract, including
      - a. General Conditions & Supplementary Conditions
      - b. Insurance Requirements
      - c. NYS Prevailing Wage Rates.
  - D. Extent of Contract: Unless the Contract Documents contain a more specific description of the Work, names and terminology on Drawings and in Specification Sections determine which contract includes a specific element of Project.

- u. Connections below Science Casework counters (by Plumbing, Mechanical, and Electrical Contractors)
- v. Provide owner training / commissioning of equipment and controls
- 6. General Requirements, including but not limited to, additional items specifically indicated as the Work of this Contract.
- 7. Provide multiple shift work as needed to complete work as shown on milestone schedule. Schedule shows a significant amount of work to be performed second shift. *"Two Work Shifts" will be required to perform the scheduled work.*
- B. Section 23 09 00 Instrumentation and Control for HVAC, is included in the HVAC Contract but for coordination and ancillary work purposes only. Coordinate with the Controls Contractor during all demolition and new work. Provide ancillary controls work as stated. Extensive coordination between HVAC & Controls contractor will be required as portions of the existing building are brought on line with the new equipment. Both contractors will be responsible to ensure all systems remain active as necessary to provide adequate heat to various sections of the building and the owner must have control over both old and new systems during construction.
- C. The Work of the MECHANICAL Work Contract includes but is not limited to the Work that is specified in the Project Manual(s) and as shown on the drawings that form the contract plans. The Contractor is directed to examine all drawings since certain details and/or notes may appear anywhere therein that apply to his/her particular work. This prime contract is defined as, and includes, all Sections in the Divisions indicated by reference, and specific Sections noted:
  - 1. Division 0 Procurement and Contracting Requirement, all Sections.
  - 2. Division 1 General Requirements all Sections, including Temporary Facilities indicated
  - 3. Section 07 84 13, Through Penetration Firestop Systems, as required for the Work of this Contract
  - 4. Section 07 92 00, Joint Sealants, as required for the Work of this Contract
  - 5. Division 23 HVAC, all Sections.

## 1.10 CONTRACT 4 - ELECTRICAL WORK CONTRACT

- A. Work of this Contract includes, but is not limited to, the following descriptions:
  - 1. Includes Electrical Distribution Service, Lighting, CATV systems, Communications, Fire Alarm, Intercom Systems, Security Systems, Emergency Lighting, and other systems traditionally recognized as Electrical work. This includes but is not limited to, all work shown on the Electrical Drawings, and applicable information shown on all other Drawings, unless noted otherwise. It also includes administrative and coordination responsibilities.
    - a. Drawings:
      - 1) All "G" series Drawings (General)
      - 2) All "AG, BG series Drawings (Code Compliance)
      - 3) All "AE, BE, FE, GE, HE" series Drawings (Electrical)
      - 4) All (Architectural) drawings as required for coordination of penetration work
  - 2. Coordination:
    - a. Coordination with the work of all of the other contractors.
  - 3. Demolition:
    - a. Removal of items as shown and/or required.
    - b. Removal and disconnections of electrical devices in walls, ceilings and floors scheduled to be removed in the portion of the building to remain.



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Project No.: 121111-19002

Date: 2/17/21

**Project Name:** Reconstruction to Mahopac High School, Mahopac Middle School, Mahopac Falls School, Bus Garage, and New Pump House

<b>Ouestion Pertains to: See Bel</b>	
Question: (Please be specific)	
(	nedule (sheet AA600) from addendum #1, doors L101-1 through L101-4 (S3 PLEASE CONFIRM.
Panics, LCN closer, welded on hing	nardware be provided to maintain the tested Fire Rating. This includes Von I ges etc. This applies to S3?, S4. S5, and S6.
Alease confirm these deviations tro	n Hardware spec
3. The door schedule lists Glass Ty	n Hardware spec. pe FPC for doors 242, 243, & 244. However, this is NOT listed in the 08800
<ol> <li>The door schedule lists Glass Ty</li> <li>Glazing spec. PLEASE CLARIFY.</li> <li>Spec 085653 is for Sliding Security</li> </ol>	•
Glazing spec. PLEASE CLARIFY.	pe FPC for doors 242, 243, & 244. However, this is NOT listed in the 08800 ity Windows. We cannot find any on the drawings. Is window type S1 be of this type? If not, please advise.



# SUBMIT FORM BY EMAIL TO INE.Mahopac@tetratech.com


Project No.: 121111-19002

Date: 2/18/21

**Project Name:** Reconstruction to Mahopac High School, Mahopac Middle School, Mahopac Falls School, Bus Garage, and New Pump House


Bidder Contact Person: Frank Grange Bidder Company Name: Darlind Associates Bidder Phone: (845) 223-5115 Bidder Email Address: f.grange@casi-ny.cc	
Ouestion Pertains to: See Below (also se	e attachments)
Ouestion: (Please be specific)	~~~~~~~~~~~~~~~~~~~~~~~~~~~~~~~~~~~~~~~
Question from subcontractor bidder :	3
Doors #L101-1,2,3,4 (also reference attached)	}
Our Fire rated door/frame supplier can NOT do Also, they can NOT do the "Gun-Slot" glass in	o a bank of 4 doors with single frames between. a full "flush" door.
most important, we need to divide these into 4	ss Designer doors as we are using in the other elevations. Also and separate single door/frame units. These would be separated with either be. The steel and any structural calcs if needed would be By Others.
Please advise	3
<b>Review by Architect/Engineers:</b>	Responded By:Date:
additional information for these doors will be provided in bid addendum #4	Timothy Stevens 2/25/21
Submit requests not less than 5 working da	ays prior to the specified Bid Opening date and time. In the event that

Submit requests not less than 5 working days prior to the specified Bid Opening date and time. In the event that this question requires clarification or modification of the Bidding Documents, such written information can only be provided by formal Addendum, distributed to all plan holders.

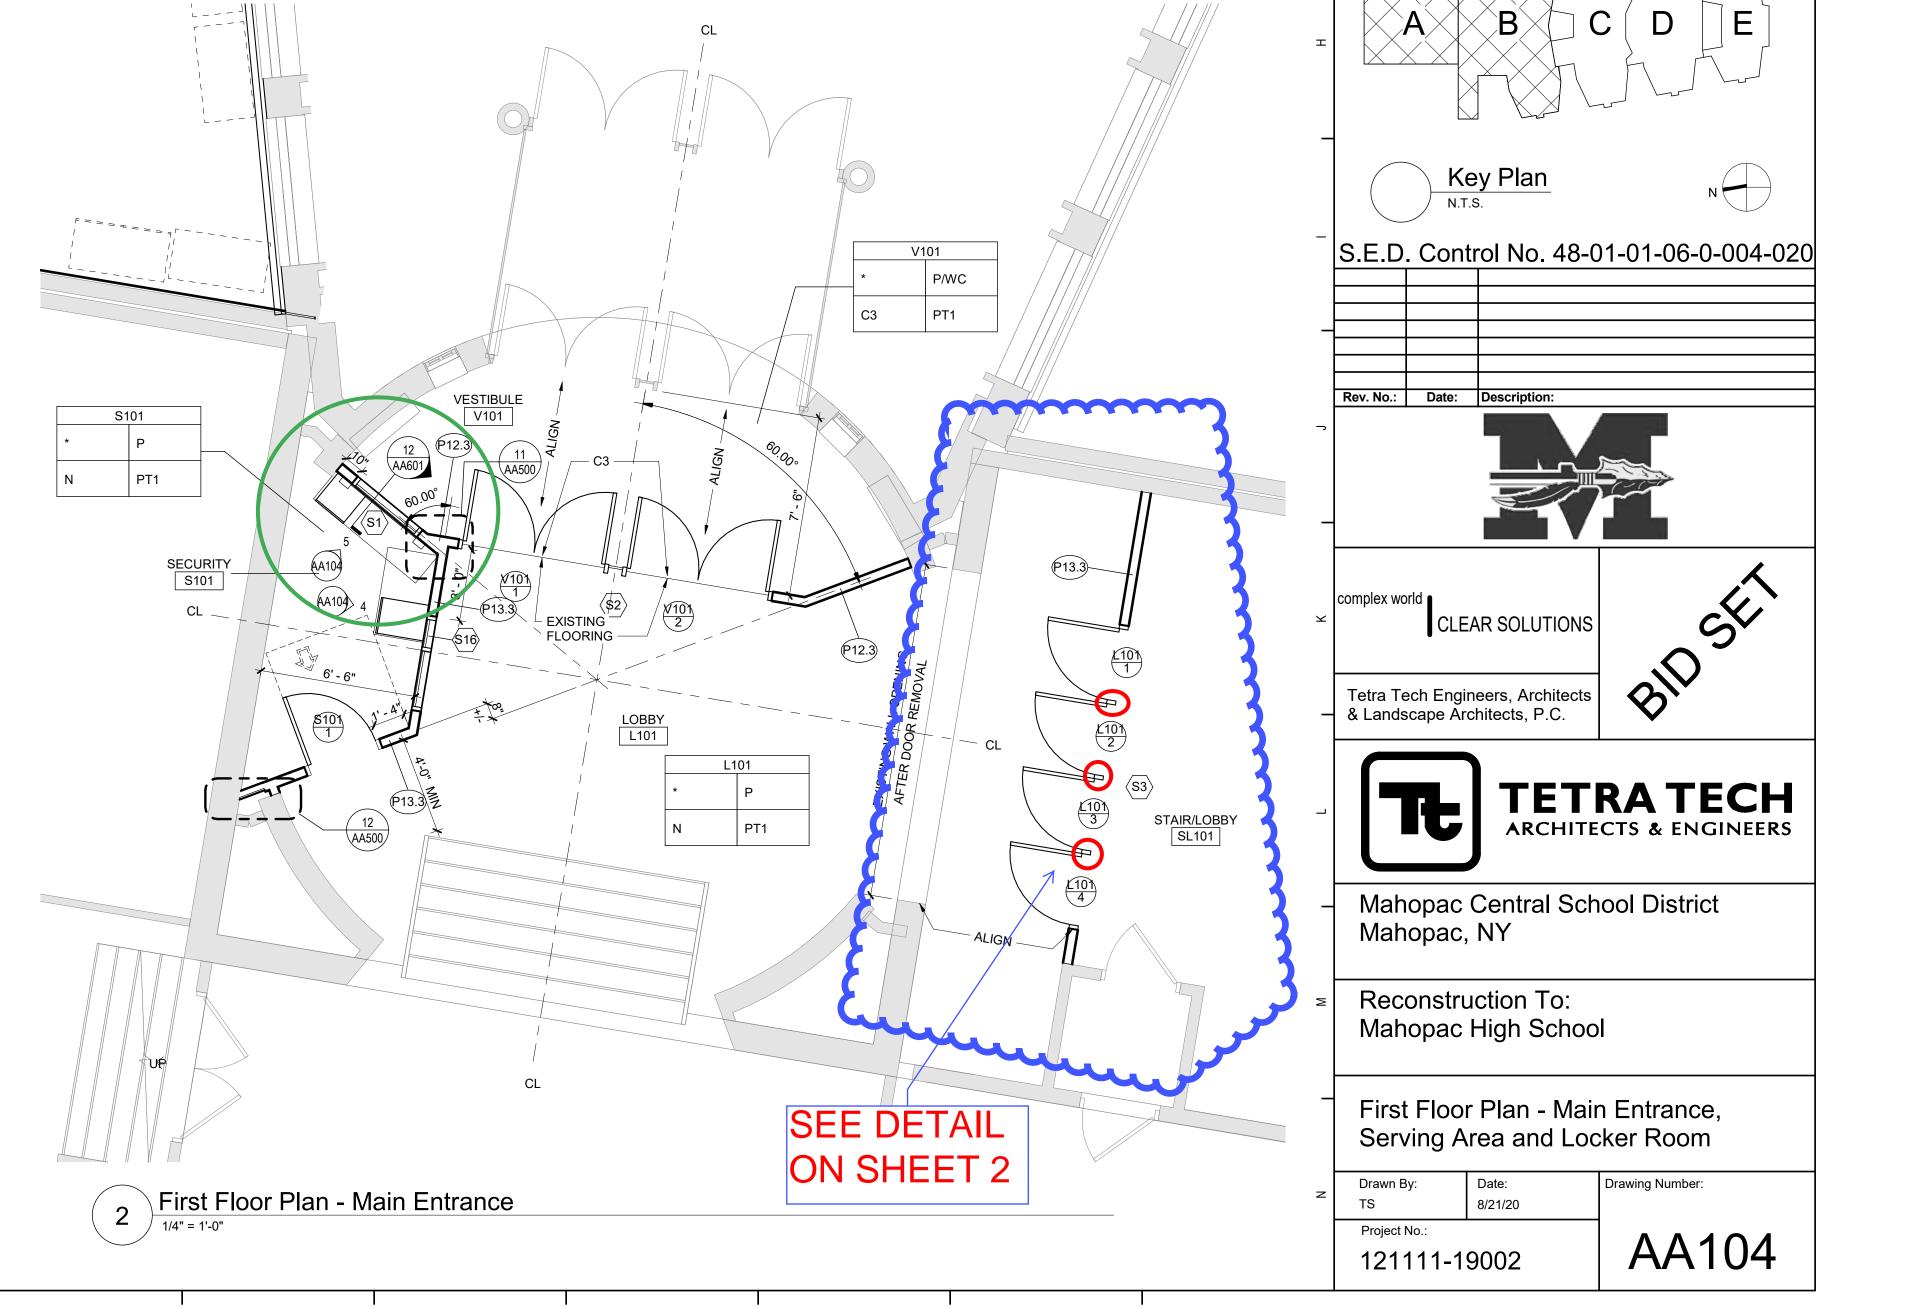





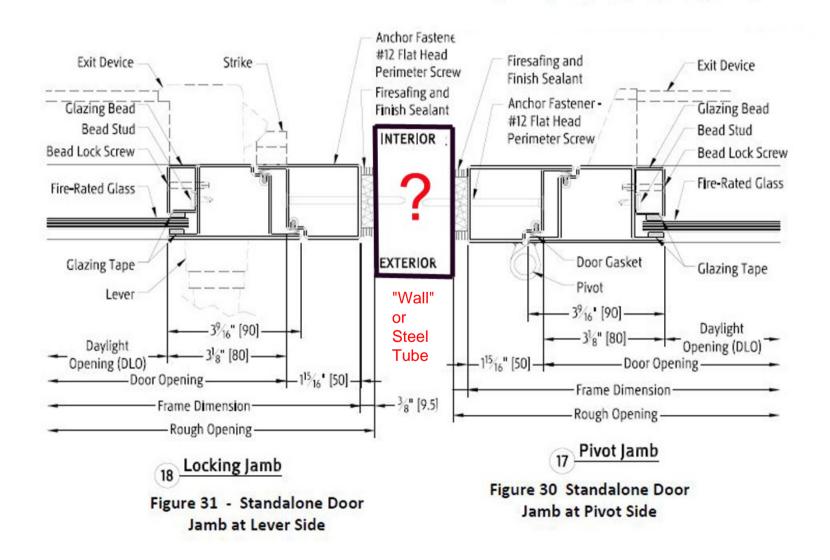



## SUBMIT FORM BY EMAIL TO INE.Mahopac@tetratech.com

Project No.: 121111-19002

Date: 02/19/2021

Project Name: Reconstruction to Mahopac High School, Mahopac Middle School, Mahopac Falls School, Bus Garage, and New Pump House

Bidder Contact Person: Mathew DeRosa Bidder Company Name: DeRosa Sports Construction Inc. Bidder Phone: 914-341-1506 Bidder Email Address: Matt@derosasports.com

**Ouestion Pertains to:** 

Drawing Number: AE-002 Plan Area: N/A **Room Number: Drawing Detail Number: Specification Section:** \_\_\_\_\_

**Question:** (Please be specific)

Please clarify if contract #7 SW is responsible for score board installation, foundations for scoreboard, or necessary electric to power the unit.

**Review by Architect/Engineers:** 

Responded By: HR/TPG Date: 02-26-2021

Spec Section 26 58 10 FOOTBALL/LACROSSE SCOREBOARD Contract 4 - Electrical Contract

\_\_\_\_\_



## SUBMIT FORM BY EMAIL TO INE.Mahopac@tetratech.com

Project No.: 121111-19002

Date: 02/19/2021

**Project Name:** Reconstruction to Mahopac High School, Mahopac Middle School, Mahopac Falls School, Bus Garage, and New Pump House

Bidder Contact Person: Mathew DeRosa Bidder Company Name: DeRosa Sports Construction Inc. Bidder Phone: 914-341-1506 Bidder Email Address: Matt@derosasports.com

**Question Pertains to:** 

Drawing Number: BE-001 Plan Area: Room Number: Drawing Detail Number: Specification Section:

**Question: (Please be specific)** 

Please clarify if contract #7 SW is responsible for light pole installation, light pole bases or any associated work for the lights.

Review by Architect/Engineers: Re

Responded By: <u>HR/TPG</u> Date: <u>02-28-2021</u>

Please refer to Specification Section 01 12 00 Contract 7 - Site Work 1.13 B 3. Division 3 – Concrete - all Sections. Please also to refer to Spec Section 03 48 10 issued in Addendum 002 02-16-2021



## SUBMIT FORM BY EMAIL TO INE.Mahopac@tetratech.com

Project No.: 121111-19002

Date: 02/19/2021

**Project Name:** Reconstruction to Mahopac High School, Mahopac Middle School, Mahopac Falls School, Bus Garage, and New Pump House

Bidder Contact Person: Mathew DeRosa Bidder Company Name: DeRosa Sports Construction Inc. Bidder Phone: 914-341-1506 Bidder Email Address: Matt@derosasports.com

**Question Pertains to:** 

Drawing Number: BE-001 Plan Area: Room Number: Drawing Detail Number: Specification Section:

Question: (Please be specific)

Please clarify if contract #7 SW is responsible for light pole installation, light pole bases or any associated work for the lights.

Review by Architect/Engineers:

Responded By: HR/TPG Date: 02-06-2021

Please refer to Specification Section 01 12 00 Contract 7 - Site Work 1.13 A.5.0 Electrical Contractor is responsible for Pre-cast Light Pole Bases and Light Poles.



## SUBMIT FORM BY EMAIL TO INE.Mahopac@tetratech.com

**Project No.:** 121111-19002

Date: 2-16-2021

**Project Name:** Reconstruction to Mahopac High School, Mahopac Middle School, Mahopac Falls School, Bus Garage, and New Pump House

\_\_\_\_\_

Bidder Contact Person:Chris FracassaBidder Company Name:Gianfia Corp.Bidder Phone:(914) 358-4601Bidder Email Address:cfracassa@gianfiacorp.com

Question Pertains to: Synthetic Turf

Drawing Number: AC120 & BC120 Plan Area: Room Number: N/A Drawing Detail Number: N/A Specification Section: 01 12 00

\_\_\_\_\_

Question: (Please be specific)

#1. Could the names of both the manufacturer and installer for the synthetic turf field be provided?

#2. Please verify with the manufacturer on whether or not the warranty for the synthetic turf field will be impacted due to the required field applied ballfield markings.

Review by Architect/Engineers:	Responded By: C Glaubitz	Date: 2/26/21
<ol> <li>The synthetic turf contract is being bid by state</li> <li>Noted, will be confirmed with Turf contractor.</li> </ol>	e contract and in process.	

-----



## SUBMIT FORM BY EMAIL TO INE.Mahopac@tetratech.com

**Project No.:** 121111-19002

Date: 2-16-2021

**Project Name:** Reconstruction to Mahopac High School, Mahopac Middle School, Mahopac Falls School, Bus Garage, and New Pump House

\_\_\_\_\_

Bidder Contact Person:Chris FracassaBidder Company Name:Gianfia Corp.Bidder Phone:(914) 358-4601Bidder Email Address:cfracassa@gianfiacorp.com

Question Pertains to: Synthetic Turf

Drawing Number: AC120 & BC120 Plan Area: Room Number: N/A Drawing Detail Number: N/A Specification Section: 01 12 00

\_\_\_\_\_

Question: (Please be specific)

#1. Could the names of both the manufacturer and installer for the synthetic turf field be provided?

#2. Please verify with the manufacturer on whether or not the warranty for the synthetic turf field will be impacted due to the required field applied ballfield markings.

Review by Architect/Engineers:	Responded By: C Glaubitz	Date: 2/26/21
<ol> <li>The synthetic turf contract is being bid by state</li> <li>Noted, will be confirmed with Turf contractor.</li> </ol>	e contract and in process.	

-----



## SUBMIT FORM BY EMAIL TO INE.Mahopac@tetratech.com

**Project No.:** 121111-19002

Date: 2-25-2021

**Project Name:** Reconstruction to Mahopac High School, Mahopac Middle School, Mahopac Falls School, Bus Garage, and New Pump House

Bidder Contact Person: Chris Fracassa

Bidder Company Name: Gianfia Corp. Bidder Phone: (914) 358-4601 Bidder Email Address: cfracassa@gianfiacorp.com

Question Pertains to: Trench Drain

Drawing Number: ZC502 Plan Area: N/A Room Number: N/A Drawing Detail Number: N/A Specification Section: 33 41 00 Page 7

Question: (Please be specific)

#1. Trench Drain detail 3 on drawing ZC502 notates 4,000 psi reinforced concrete without showing any reinforcement in detail. If reinforcement is required, please provide type, size, and spacing of reinforcement be specified.

\_\_\_\_\_

Review by Architect/Engineers:

Responded By: D.Bussmann Date: 03 / 01 / 2021

Refer to forthcoming Addendum #4.

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## SUBMIT FORM BY EMAIL TO INE.Mahopac@tetratech.com

**Project No.:** 121111-19002

Date: 2/24/21

**Project Name:** Reconstruction to Mahopac High School, Mahopac Middle School, Mahopac Falls School, Bus Garage, and New Pump House

Bidder Contact Person: Karen Panarella Bidder Company Name: Joe Lombardo Plumbing & Heating of Rockland Inc Bidder Phone: <sup>845-357-6537</sup> Bidder Email Address: karen@josephlombardo.com Question Pertains to: Water Tank & Foundation Drawing Number: AC140, Detail 2 on ZC504

Plan Area: N/A Room Number: N/A Drawing Detail Number: Specification Section: 221219 facility ground mounted potable water storage tank

**Question: (Please be specific)** 

please clarity which contractor is responsible for purchasing & installing the ground mounted potable water storage tank

**Review by Architect/Engineers:** 

Responded By: <u>HR/KC-TP</u>GDate: <u>02-24-21</u>

Please see Addendum 003 issued on 02-22-2021 Specification Section 22 12 19 Refer to Drawing AP600 Hydro-pneumatic Tank Schedule

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## SUBMIT FORM BY EMAIL TO INE.Mahopac@tetratech.com

**Project No.:** 121111-19002

Date:

Project Name: Reconstruction to Mahopac High School, Mahopac Middle School, Mahopac Falls School, Bus Garage, and New Pump House

Bidder Contact Person: Karen Panarella Bidder Company Name: Joe Lombardo Plumbing & Heating of Rockland Inc Bidder Phone: 845-357-6537 Bidder Email Address: karen@joseplombardo.com	
Question Pertains to:	
Drawing Number: AM102 Plan Area: Room Number: Drawing Detail Number: Detail #9 Specification Section:	
Question: (Please be specific)         As per drawing AM 102 Keynote #9 is duplicated.         One of the note #9 states for us to provide separate <sup>3</sup> /4" HWS & R lines to FTR in rooms 125,129 & 131. The indicated in note 9 appear on same drawing area C which has a note 6 telling us to just provide 2 separate co valves for existing FTR.         Note 9 appears on drawing area B, but the rooms don't match.         Please advise         Review by Architect/Engineers:         Responded By: DPM Date: 03/01/2021	

Refer to forthcoming Bid Addendum No. 4

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Submit requests not less than 5 working days prior to the specified Bid Opening date and time. In the event that this question requires clarification or modification of the Bidding Documents, such written information can only be provided by formal Addendum, distributed to all plan holders.

rooms



## SUBMIT FORM BY EMAIL TO INE.Mahopac@tetratech.com

Project No.: 121111-19002

Date: 2/23/2021

**Project Name:** Reconstruction to Mahopac High School, Mahopac Middle School, Mahopac Falls School, Bus Garage, and New Pump House

Bidder Contact Person: Michael Potthoff Bidder Company Name: McHugh Furnishings Bidder Phone: 631-533-5074 Bidder Email Address: mpotthoff@mchif.com

**Question Pertains to:** Mahopac High School- Science

Drawing Number: AA102 Plan Area: STEM and Science Labs Room Number: Rooms 111, 113, 115 and 234, 234A, 235, 238, 239, 242, 243, 244 Drawing Detail Number: #5 Epoxy Countertop Edge Specification Section: 123213 Manufactured Wood Veneer Faced Casework

## **Question: (Please be specific)**

1) Spec Section 123213- 2.3A. Please confirm lipped overlay with radius wood edges.- per spec

2) Spec Section 123213- 2.3B States White Maple, while 2.3F states Oak. Please confirm Maple. refer to addendum
3) Spec Section 123213-2.3D & 2.3E. 2.3D States continuous matching of adjacent drawer fronts with cabinets. 2.3E States grain direction as vertical on doors and horizontal on drawer fronts. Please clarify.
4) Spec Section 123213- 2.4L States solid surface window sills. We would like to supply Phenolic sills in the Science areas to match the epoxy tops. Please confirm this is an acceptable alternate.
5) Detail #5, Dwg AA102 shows bevel edge with radius corners. Please confirm this is required and is for all locations- including table tops.

<b>Review by Architect/Engineers:</b>	Responded By: <u>mhhunt</u> Date: <u>2-23-21</u>
1) response - Per spec	5) refer to all details doe areas of radius corners
2)response - Refer to addendum	
3) response - Per spec	
4) response- not all sills are solid surface, r	refer to all details for correct material
· · · · · ·	ays prior to the specified Bid Opening date and time. In the event that ification of the Bidding Documents, such written information can only uted to all plan holders.



## SUBMIT FORM BY EMAIL TO INE.Mahopac@tetratech.com

**Project No.:** 121111-19002

Date: 2/22/21

**Project Name:** Reconstruction to Mahopac High School, Mahopac Middle School, Mahopac Falls School, Bus Garage, and New Pump House

Bidder Contact Person: Carlos Flores Bidder Company Name: Mehl Electric Bidder Phone: 845 735 4004 Bidder Email Address: carlos@mehlnet.com

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**Question Pertains to:** HIGH SCHOOL

-

Drawing Number: AE600 Plan Area: Room Number: Drawing Detail Number: Specification Section:

Question: (Please be specific) 1. In reference to answer to RFI #14, are all panels listed on AE600 to be new to replace at

existing locations throughout the school. Gear vendors are having difficulty pricing, not knowing what is new and what is existing. please confirm all panels listed on this drawing are to be new to replace existing.

**Review by Architect/Engineers:** 

Responded By: CREGA Date: 2/23/21

CONFIRMED, PANELS LISTED ARE TO BE REPLACED.

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## SUBMIT FORM BY EMAIL TO INE.Mahopac@tetratech.com

**Project No.:** 121111-19002

Date: 2/22/21

**Project Name:** Reconstruction to Mahopac High School, Mahopac Middle School, Mahopac Falls School, Bus Garage, and New Pump House

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Bidder Contact Person: Carlos Flores Bidder Company Name: Mehl Electric Bidder Phone: 845 735 4004 Bidder Email Address: carlos@mehlnet.com

-

Question Pertains to: HIGH SCHOOL FIRE ALARM VENDOR

Drawing Number: AE200 Plan Area: Room Number: Drawing Detail Number: Specification Section:

**Question:** (Please be specific) 1. In response to your RFI answer that the FA system is a notifier system, this does not help us. The school should have a vendor that works with the district. Notifier is simply a manufacturer. We need to know who the Vendor is so we can reach out to them specifically and get a quote. Please provide that information.

**Review by Architect/Engineers:** 

Responded By: <u>CREGA</u> Date: <u>2/23/21</u>

Joe Lombardi of Doyle Security

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## SUBMIT FORM BY EMAIL TO INE.Mahopac@tetratech.com

Project No.: 121111-19002

Date: 2/23/21

Project Name: Reconstruction to Mahopac High School, Mahopac Middle School, Mahopac Falls School, Bus Garage, and New Pump House

**Bidder Contact Person: Carlos Flores** Bidder Company Name: Mehl Electric Bidder Phone: 845 735 4004 Bidder Email Address: carlos@mehlnet.com

**Question Pertains to: UG ELECTRIC REROUTING** 

Drawing Number: AE001 & AE002 Plan Area: **Room Number: Drawing Detail Number: Specification Section:** 

**Ouestion:** (Please be specific) 1. New Addendum 3 AE001&002 show that we are to relocate and existing underground circuit, can you provide size of conduit and wire so we know what we need to extend and size of pullbox to provide?

**Review by Architect/Engineers:** 

Responded By: \_\_\_\_\_ Date: \_\_\_\_\_

This will have to be verified in field.

-



## SUBMIT FORM BY EMAIL TO INE.Mahopac@tetratech.com

**Project No.:** 121111-19002

Date: 2/23/21

**Project Name:** Reconstruction to Mahopac High School, Mahopac Middle School, Mahopac Falls School, Bus Garage, and New Pump House

Addendum 3 states to provide new devices to existing panel. Please confirm we are only providing new devices at locations shown on latest addendum3 plans and connecting to an existing panel? now new panelrequired?

**Review by Architect/Engineers:** 

Responded By: CREGA Date: 2/24/21

1. Confirmed. Clocks and speakers on AE200-AE202 removed from scope.

2. Confirmed only new FA devices.

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## SUBMIT FORM BY EMAIL TO INE.Mahopac@tetratech.com

**Project No.:** 121111-19002

Date: 2/23/21

**Project Name:** Reconstruction to Mahopac High School, Mahopac Middle School, Mahopac Falls School, Bus Garage, and New Pump House

Question: (Please be specific) 1 CAN WE USE a substitute or do we have to use Daktronics for the scoreboard?

**Review by Architect/Engineers:** 

YES, IF SUBMITTED AS AN EQUAL.

-

## CREGA

2/24/21

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## SUBMIT FORM BY EMAIL TO INE.Mahopac@tetratech.com

**Project No.:** 121111-19002

Date: 2/24/21

**Project Name:** Reconstruction to Mahopac High School, Mahopac Middle School, Mahopac Falls School, Bus Garage, and New Pump House

Bidder Contact Person: Carlos Flores Bidder Company Name: Mehl Electric Bidder Phone: 845 735 4004 Bidder Email Address: carlos@mehlnet.com

**<u>Question Pertains to:</u>** Demolition/removal of pbc light fixtures

-

Drawing Number: AE050, Plan Area: Room Number: Drawing Detail Number: Specification Section:

<u>Question:</u> (Please be specific) 1 demolition notes A-G, where exactly does this scope take place on this floor plan, or can we ignore these notes?

## **Review by Architect/Engineers:**

# THESE ARE GENERAL NOTES FOR ANY OF THOSE CONDITIONS FOUND DURING CONSTRUCTION.

CREGA

2/26/21



# SUBMIT FORM BY EMAIL TO INE.Mahopac@tetratech.com

Project No.: 121111-19002

Date: 2/25/21

**Project Name:** Reconstruction to Mahopac High School, Mahopac Middle School, Mahopac Falls School, Bus Garage, and New Pump House

Bidder Contact Person: Carlos Flores Bidder Company Name: Mehl Electric Bidder Phone: 845 735 4004 Bidder Email Address: carlos@mehlnet.com

\_\_\_\_\_

**<u>Question Pertains to:</u>** Scoreboard

Drawing Number: AE002, Plan Area: Room Number: Drawing Detail Number: Specification Section:

-----

<u>Question:</u> (Please be specific) 1 Are there any borings or subsurface inspections to indicate water table and impact of rock where the scoreboard footings are to be placed?

2. where will the 2ea delay of game clocks be mounted to?

3. Verify dimensions of beams, footings and if rebar is required for directly embedding steel columns?

4. Verify distance between column, schedule states 5', but a 25' L board would generally require 15' spread?

## **Review by Architect/Engineers:**

- 1. THIS NEEDS TO BE VERIFIFED BY SITE CONTRACTOR.
- 2. GAME CLOCKS ARE NOT IN SCOPE.
- 3. MANFACTURER TO PRPOVIDE SHOP DRAWINGS FOR APPROVAL.
- 4. PER MANUFACTURER RECOMMENDATIONS.

CREGA 2/26/21

 Submit requests not less than 5 working days prior to the specified Bid Opening date and time. In the event that

 this requests not less than 5 working days prior to the specified Bid Opening date and time. In the event that

 this requests not less than 5 working days prior to the specified Bid Opening date and time. In the event that

 this requests not less than 5 working days prior to the Bidding Documents, such written informationaction

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 Project No. 121111-19002



# SUBMIT FORM BY EMAIL TO INE.Mahopac@tetratech.com

Project No.: 121111-19002

Date: 2/25/21

**Project Name:** Reconstruction to Mahopac High School, Mahopac Middle School, Mahopac Falls School, Bus Garage, and New Pump House

\_\_\_\_\_

Bidder Contact Person: Carlos Flores Bidder Company Name: Mehl Electric Bidder Phone: 845 735 4004 Bidder Email Address: carlos@mehlnet.com

**Question Pertains to: MDP1** 

Drawing Number: AE700 & AE600, Plan Area: Room Number: Drawing Detail Number: Specification Section:

<u>Question:</u> (Please be specific) 1 AE700 shows MDP1 having a subpanel SDP, how is panel SDP fed ? AE600 shows panel SDP to have the same rating and size as MDP1, what is the intent of panel SDP, or is this meant to be a surge protection device built into MDP1? please clarify?

**Review by Architect/Engineers:** 

NO WORK REQUIRED WITH SDP.

CREGA

2/26/21

Submit requests not less than 5 working days prior to the specified Bid Opening date and time. In the event that this new strong to example a strong to the Bidding Documents, such written information action of the Bidding Documents action of the Bidding Documents, such written information action of the Bidding Documents action



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**Project No.:** 121111-19002

Date: 2/25/21

**Project Name:** Reconstruction to Mahopac High School, Mahopac Middle School, Mahopac Falls School, Bus Garage, and New Pump House

Bidder Contact Person: Carlos Flores Bidder Company Name: Mehl Electric Bidder Phone: 845 735 4004 Bidder Email Address: carlos@mehlnet.com ------Question Pertains to: Lighting

Drawing Number: AE131 detail 3 Plan Area: Room Number: Drawing Detail Number: Specification Section:

-

<u>Question:</u> (Please be specific) 1 Drawing 3/AE131 shows fixtures with letter E, please confirm this are existing to remain , and no new type 9 fixture is required?

**Review by Architect/Engineers:** 

CONFIRMED THESE REMAIN.	ARE EXISTING T	O
	CREGA	2/26/21

-Sulfater function of the Bidding Documents, such written information of the Bidding Documents, such written



## SUBMIT FORM BY EMAIL TO INE.Mahopac@tetratech.com

**Project No.:** 121111-19002

Date: 2/25/21

**Project Name:** Reconstruction to Mahopac High School, Mahopac Middle School, Mahopac Falls School, Bus Garage, and New Pump House

<u>Question:</u> (Please be specific) 1 Can you provide panel schedules for each panel being replaced showing circuits (new/existing)?

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**Review by Architect/Engineers:** 

-

NO, EXISTING AND REPLACEMENT
CIRCUIT BREAKERS INDICATED IN
PANEL REPLACMENT SCHEDULE.

CREGA

2/26/21

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-Subhit Tankistschoy less than 5 working days privered the specified Bid Opening date and the severe that this presentation of the Bidding Documents, such written information action



### SUBMIT FORM BY EMAIL TO INE.Mahopac@tetratech.com

**Project No.:** 121111-19002

Date: 2/25/21

**Project Name:** Reconstruction to Mahopac High School, Mahopac Middle School, Mahopac Falls School, Bus Garage, and New Pump House

Bidder Contact Person: Carlos Flores Bidder Company Name: Mehl Electric Bidder Phone: 845 735 4004 Bidder Email Address: carlos@mehlnet.com

**<u>Question Pertains to:</u>** Kitchen Register Data Drops

Drawing Number: AE161 Plan Area: Room Number: Drawing Detail Number: Specification Section:

<u>Question: (Please be specific)</u> 1 New note added per addendum 3 states to provide (3) data drops for register and connect to rack 15, but no note 4 appears on plans nor are the registers shown, where are they located?

**Review by Architect/Engineers:** 

REFER TO DETAIL 2 AE161 FOR LOCATION OF REGISTERS.

CREGA

2/16/21

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-SulPatie Flow istschoy less than 5 working days privered the specified Bid Opening date and threat the severe that this presentation of the Bidding Documents, such written information action a



### SUBMIT FORM BY EMAIL TO INE.Mahopac@tetratech.com

**Project No.:** 121111-19002

Date: 2/25/21

**Project Name:** Reconstruction to Mahopac High School, Mahopac Middle School, Mahopac Falls School, Bus Garage, and New Pump House

Bidder Contact Person: Carlos Flores Bidder Company Name: Mehl Electric Bidder Phone: 845 735 4004 Bidder Email Address: carlos@mehlnet.com \_\_\_\_\_\_Question Pertains to: Security

Drawing Number: Plan Area: Room Number: Drawing Detail Number: Specification Section:

<u>Question:</u> (Please be specific) 1 Please confirm that security scope is by others, EC is only bringing power where shown on plans and providing stub ups where required?

#### **Review by Architect/Engineers:**

-

Please refer to specification section 01 12 00 1.10 1.10 CONTRACT 4 - ELECTRICAL WORK CONTRACT Please clarify Drawing / Detail

HR / TPG 02-26-2021

-Sulfater faquests that 5 working days prive to the specified Bid Opening date and threat the event that this presentation of the Bidding Documents, such written information action actio



### SUBMIT FORM BY EMAIL TO INE.Mahopac@tetratech.com

Project No.: 121111-19002

Date: 2/25/21

**Project Name:** Reconstruction to Mahopac High School, Mahopac Middle School, Mahopac Falls School, Bus Garage, and New Pump House

Bidder Contact Person: Carlos Flores Bidder Company Name: Mehl Electric Bidder Phone: 845 735 4004 Bidder Email Address: carlos@mehlnet.com

**Question Pertains to:** Security

Drawing Number: Plan Area: Room Number: Drawing Detail Number: Specification Section:

<u>Question: (Please be specific)</u> 1 Please confirm that security scope is by others, EC is only bringing power where shown on plans and providing stub ups where required?

#### **Review by Architect/Engineers:**

Please Refer to Spec Section 01 12 00 1.10CONTRACT 4 - ELECTRICAL WORK CONTRACT

A. Work of this Contract includes, but is not limited to, the following descriptions:

1. Includes Electrical Distribution Service, Lighting, CATV systems, Communications, Fire Alarm, Intercom Systems, Security Systems, Emergency Lighting, and other systems traditionally recognized as Electrical work. This includes but is not limited to, all work shown on the Electrical Drawings, and applicable information shown on all other Drawings, unless noted otherwise. It also includes administrative and coordination responsibilities

-Sulfitiel Flow visits that 5 working days priving the specified Bid Opening date and threat the seven that this presentation of the Bidding Documents, such written information action action



### SUBMIT FORM BY EMAIL TO INE.Mahopac@tetratech.com

**Project No.:** 121111-19002

Date: 2/18/2021

**Project Name:** Reconstruction to Mahopac High School, Mahopac Middle School, Mahopac Falls School, Bus Garage, and New Pump House

Bidder Contact Person: Chris Meyer Bidder Company Name: Meyer Contracting Corporation Bidder Phone: (845) 635-1416 Bidder Email Address: estimating@meyercontracting.com

**Question Pertains to:** 

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Drawing Number: AA130 Plan Area: Music Suite Room Number: 143A Drawing Detail Number: Specification Section:

\_\_\_\_\_

Question: (Please be specific)

Floor finish at room 143A calls for Terrazzo Type 1 Is this correct? There is no finish schedule for Band Room 143. Please provide.

Review by Architect/Engineers: Responded By: MHH Date: 02/23/	2021
FINISHES FOR 143A ARE PER ROOM FINISH BOX	$\frac{1}{2}$
THE ROOM FINISH BOX FOR BAND 143 IS LOCATED ON AA103, IN ROOM 143, UPPER RIGHT CORNER OF ROOM.	2
	$\mathcal{I}$

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### SUBMIT FORM BY EMAIL TO INE.Mahopac@tetratech.com

**Project No.:** 121111-19002

Date: 2/18/2021

**Project Name:** Reconstruction to Mahopac High School, Mahopac Middle School, Mahopac Falls School, Bus Garage, and New Pump House

Bidder Contact Person: Chris Meyer

Bidder Company Name: Meyer Contracting Corporation Bidder Phone: (845) 635-1416 Bidder Email Address: estimating@meyercontracting.com

**Question Pertains to:** 

Drawing Number: GS130 detail 2 Plan Area: Room Number: Drawing Detail Number: Specification Section:

\_\_\_\_\_

Question: (Please be specific)

Who is responsible for installing the Unistrut to support the HVAC equipment. GC or HVAC Contractor?

Please clarify Drawing there is no GS130 Please refer to spec section 23 05 29 HANGERS AND SUPPORTS FOR HVAC COMPONENTS; 01 12 00 1.9 CONTRACT 3 - MECHANICAL WORK CONTRACT ; 5.0; Provide support framing for HVAC equipment, ie mechanical equipment curbs.

\_\_\_\_\_

**Review by Architect/Engineers:** 

Responded By: <u>HR / TPG</u> Date: <u>02-28-2021</u>

\_\_\_\_\_



### SUBMIT FORM BY EMAIL TO INE.Mahopac@tetratech.com

**Project No.:** 121111-19002

Date: 2/18/2021

**Project Name:** Reconstruction to Mahopac High School, Mahopac Middle School, Mahopac Falls School, Bus Garage, and New Pump House

Bidder Contact Person: Chris Meyer Bidder Company Name: Meyer Contra	acting Corporation
Bidder Phone: (845) 635-1416 Bidder Email Address: estimating@me	eyercontracting.com
Question Pertains to:	
Drawing Number: GS130 detail 2 Plan Area: Room Number: Drawing Detail Number: Specification Section:	
Question: (Please be specific) Who is responsible for installing the U Please clarify Drawing there is no GS13	Unistrut to support the HVAC equipment. GC or HVAC Contractor 30 in the set
Review by Architect/Engineers:	Responded By: <u>HR / TPG</u> Date: <u>02-26-2021</u>

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### SUBMIT FORM BY EMAIL TO INE.Mahopac@tetratech.com

**Project No.:** 121111-19002

**Date:** February 25, 2021

**Project Name:** Reconstruction to Mahopac High School, Mahopac Middle School, Mahopac Falls School, Bus Garage, and New Pump House

<u>Juestion Pertains to:</u> Drawing Number:	ercontracting.com
Plan Area: Room Number: Drawing Detail Number: Specification Section: <sup>133419</sup>	
Juestion: (Please be specific)	
Please confirm hot dip galvanized finish per and end wall primary framing members, not	ed finish is significantly more expensive and when required, usually



### SUBMIT FORM BY EMAIL TO INE.Mahopac@tetratech.com

**Project No.:** 121111-19002

**Date:** 2/19/2021

**Project Name:** Reconstruction to Mahopac High School, Mahopac Middle School, Mahopac Falls School, Bus Garage, and New Pump House

Bidder Contact Person: Brendan Ford
Bidder Company Name: Nicky Diggs Excavation INC
Bidder Phone: 914-232-1878
Bidder Email Address: office@nickydiggs.com
Question Pertains to:
Drawing Number:
Plan Area:
Room Number:
Drawing Detail Number: 1/ZC500, 2/ZC500
Specification Section: 32 12 16
<u>Question: (Please be specific)</u> Please clarify if type 3 binder and 6f top course or superpave mix should be used for asphalt paving.

**Review by Architect/Engineers:** 

Responded By:D.Bussmann Date: 2 / 23 / 2021

See asphalt material requirements in paragraph 2.3.A. of the 32 12 16 Asphalt Paving specification.

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### SUBMIT FORM BY EMAIL TO INE.Mahopac@tetratech.com

Project No.: 121111-19002

Date: 02/11/2021

**Project Name:** Reconstruction to Mahopac High School, Mahopac Middle School, Mahopac Falls School, Bus Garage, and New Pump House

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Bidder Contact Person:CHRIS COLANDREABidder Company Name:NORTHBROOK CONTRACTING CORPBidder Phone:914-879-6099Bidder Email Address:NORTHBROOKCHRIS@YAHOO.COM

**Question Pertains to:** 

Drawing Number: AC-121 Plan Area: D Room Number: Drawing Detail Number: KEYNOTE # 14, 19 Specification Section:

# Question: (Please be specific)

KEYNOTE #14, #19 SHOWS A STRUCTURAL CONCRTE SLAB AND FOOTING AT THE NEW PROPOSED BUILDING. PLEASE CLARIFY IF THIS WORK IS UNDER SITE CONTRACTOR OR GENERAL CONSTRUCTION CONTRACT AND WHICH CONTRACTOR DOES WHAT. ALSO WHICH CONTRACT COVERS ALL WORK PERTAING TO THE WATER TANK.

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**Review by Architect/Engineers:** 

Responded By: HR/TPG Date: 02-28-21

Please refer to Spec Section 01 12 00 1.7;5 New Construction -c Contract 1 GENERAL CONSTRUCTION WORK The Site Work Contractor (Contract #7) shall be responsible for the construction of all exterior concrete pads. The Site Contractor (Contract #7) shall be responsible to prepare the area to sub-grade.

1.7;5 New Construction- d. Provide shoring and bracing and excavation for all work related to new building, and all excavation for other contractors related to new building. Limit of excavation shall be within five (5) feet of building foundation. Also Refer to Spec Section 01 12 00 1.13 Contract 7 SITE WORK CONSTRUCTION ; 5. New Construction Water Tank - Please refer to spec section 22 12 19



### SUBMIT FORM BY EMAIL TO INE.Mahopac@tetratech.com

**Project No.:** 121111-19002

Date: 2-16-21

**Project Name:** Reconstruction to Mahopac High School, Mahopac Middle School, Mahopac Falls School, Bus Garage, and New Pump House

Bidder Contact Person: Rick Recine
Bidder Company Name: Northbrook Bidder Phone: 914-734-5506
Bidder Email Address: rickr@northbrookcontracting.com
Question Pertains to: NCC RFI #1
Drawing Number: ZC506
Plan Area: Common site details
Room Number:
Drawing Detail Number: 1 & 2
Specification Section: 334100
~ 

**Question: (Please be specific)** 

Please provide casting manufacturer abd model number for these OCS's

**Review by Architect/Engineers:** 

Responded By: D.Bussmann Date: 03 / 01 / 2021

Refer to forthcoming Addendum #4. Specification 33 41 00 has been revised.

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RFI #006

### SUBMIT FORM BY EMAIL TO INE.Mahopac@tetratech.com

**Project No.:** 121111-19002

Date: 2/19/2021

**Project Name:** Reconstruction to Mahopac High School, Mahopac Middle School, Mahopac Falls School, Bus Garage, and New Pump House

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Bidder Contact Person: CHRIS COLANDREA Bidder Company Name: NORTHBROOK CONTRACTING CORP Bidder Phone: 914-879-6099 Bidder Email Address: NORTHBROOKCHRIS@YAHOO.COM

**Question Pertains to:** 

Drawing Number: AC-140 Plan Area: A Room Number: Drawing Detail Number: DETAIL 4 ON SHEET CZ-505 Specification Section: <sup>33 41 00 2.12</sup>

Question: (Please be specific)

DETAIL 4 ON SHEET CZ-505 SHOWS THE CHAMBER SYSTEMS TO BE A HEIGHT OF 45". WHEN REFERING TO THE SPEC SECTION, IT SPECIFIES THE CHAMBER TO BE A SC-740 BY STORM TECH. THIS MODEL IS ONLY 30" IN HEIGHT. PLEASE CLARIFY AS TO THE HEIGHT OF THE CHAMBER SYSTEM.

**Review by Architect/Engineers:** 

Responded By: D.Bussmann Date: 03 / 01 / 2021

Refer to forthcoming Addendum #4. Both 30" and 45" height models are being used on this project, and the specification has been updated to reflect both.

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### SUBMIT FORM BY EMAIL TO INE.Mahopac@tetratech.com

**Project No.:** 121111-19002

Date: 2/19/21

**Project Name:** Reconstruction to Mahopac High School, Mahopac Middle School, Mahopac Falls School, Bus Garage, and New Pump House

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Bidder Contact Person: CHRIS COLANDREA Bidder Company Name: NORTHBROOK CONTRACTING CORP Bidder Phone: 914-879-6099 Bidder Email Address: NORTHBROOKCHRIS@YAHOO.COM

**Question Pertains to:** 

Drawing Number: Plan Area: AC-140 Room Number: Drawing Detail Number: Specification Section: ON CZ-505

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Question: (Please be specific)

DRAWING # AC-140 SHOWS THE DRAINAGE CHAMBER SYSTEMS ON WEST SIDE. IT SCALES (1" = 30') TO BE APPOX. 155 LF LONG TO INCLUDE TIE IN PIPES. DETAIL SECTION ON CZ-505 STATES THE BASE LENGTH TO BE 110.22 LF THE SAME WITH THE EASTERN DRAINAGE CHAMBER SYSTEM. THE SCALE DOESN'T MATCH THE DETAIL SHOWN LENGTH. PLEASE CLARIFY ON WHICH DIMENSION TO USE FOR BIDDING.

**Review by Architect/Engineers:** 

Responded By: D. Bussmann Date: 03 / 01 / 2021

Refer to forthcoming Addendum #4. Storm chamber systems indicated on revised and reissued Site Detail Drawing ZC505 shall apply.

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### SUBMIT FORM BY EMAIL TO INE.Mahopac@tetratech.com

**Project No.:** 121111-19002

Date: 2.19.21 NCC RFI #8

**Project Name:** Reconstruction to Mahopac High School, Mahopac Middle School, Mahopac Falls School, Bus Garage, and New Pump House

Bidder Contact Person: Rick Bidder Company Name: Northbrook Bidder Phone: 914.734.5506 Bidder Email Address: rickr@northbrookcontracting.com

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**Question Pertains to:** 

Drawing Number: BC 110 & ZC500 Plan Area: Erosion Control Room Number: Drawing Detail Number:<sup>11</sup> Specification Section: 312500

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**Question: (Please be specific)** 

Dwg. BC110 note #9 says...minimum entrance pad to be 30' X 100', however detail 11 shows 30' x 50' Please provide correct dimensions

**Review by Architect/Engineers:** 

Responded By: D.Bussmann Date: 2/23/2021

As the stabilized construction entrance is discharging to a paved access drive roadway, the 100' length would apply per the Site Erosion and Sediment Control Note #9. Detail 11 on Sheet ZC500 indicates a minimum length of 50', with Note 2 also indicating "as required", so there is no contradiction. The 100' therefore will be required.

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### SUBMIT FORM BY EMAIL TO INE.Mahopac@tetratech.com

**Project No.:** 121111-19002

Date: 2.19.21 NCC RFI #009

**Project Name:** Reconstruction to Mahopac High School, Mahopac Middle School, Mahopac Falls School, Bus Garage, and New Pump House

Bidder Contact Person: Rick
Bidder Company Name: Northbrook
Bidder Phone: 914.734.5506
Bidder Email Address: rickr@northbrookcontracting.com
Question Pertains to:
Drawing Number: ZC500
Plan Area: Erosion Control
Room Number:
Drawing Detail Number: <sup>15</sup>
Specification Section: 312500-9, 2.11, A, B, C
Question: (Please be specific)
Dwg. ZC500 Detail shows a standard type orange fence with no stake dimensions and no top rail, however, spec section noted above says2x4 vertical posts and a 2x4 top rail. Please advise which method is required.

**Review by Architect/Engineers:** 

Responded By: D.Bussmann Date: 2/23/2021

2x4 vertical posts and 2x4 top rail only required on vegetation protection installation (Detail 15), not temporary construction fence (Detail 13). For temporary construction fence provide driven 72" U-Channel posts with cable between posts as noted in Detail.

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### SUBMIT FORM BY EMAIL TO INE.Mahopac@tetratech.com

**Project No.:** 121111-19002

Date: 2/22/2021

**Project Name:** Reconstruction to Mahopac High School, Mahopac Middle School, Mahopac Falls School, Bus Garage, and New Pump House

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Bidder Contact Person: CHRIS COLANDREA Bidder Company Name: NORTHBROOK CONTRACTING CORP Bidder Phone: 914-879-6099 Bidder Email Address: NORTHBROOKCHRIS@YAHOO.COM

**Question Pertains to:** 

Drawing Number: Plan Area: Room Nufther: Drawing Detail Number: Specification Section: 8 ON ZC502

Question: (Please be specific)

PLEASE SEE THE 12" DRAINAGE PIPE IN THE TURF FIELD AT BOTH THE NORTH AND SOUTH SIDES THAT SHOW "DRAIN STUB" PLEASE CLARIFY IF THERE IS A CLEAN OUT OR END CAP OR BOTH AT THESE (4) LOCATIONS.

**Review by Architect/Engineers:** 

Responded By: D.Bussmann Date: 2 / 23 / 2021

Drain stub locations indicated are the start of the run and only require an end cap.

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### SUBMIT FORM BY EMAIL TO INE.Mahopac@tetratech.com

**Project No.:** 121111-19002

Date: 2/22/2021

**Project Name:** Reconstruction to Mahopac High School, Mahopac Middle School, Mahopac Falls School, Bus Garage, and New Pump House

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Bidder Contact Person: CHRIS COLANDREA Bidder Company Name: NORTHBROOK CONTRACTING CORP Bidder Phone: 914-879-6099 Bidder Email Address: NORTHBROOKCHRIS@YAHOO.COM

**Question Pertains to:** 

Drawing Number: Plan Area: Room Number: Drawing Detail Number: Specification Section: 01 50 00 3.4 G

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**Question: (Please be specific)** 

The above spec section states that a temporary perimeter enclosure fence is to be installed prior the start of excavations. Please clarify if this part of the site contract and if so, where will the fence be installed and for how long?

**Review by Architect/Engineers:** 

**Responded By: HR/TPG Date: 02-28-2021** 

Please refer to Spec Section 01 12 00 ; 1.13 CONTRACT 7 – SITE WORK CONSTRUCTION 5. New Construction ; 1. Provide all site fencing and landscaping

Fencing Installation Locations to be Determined in the Site Logistics Plan - to be Distributed Fencing Duration ; for the length of the Construction Project ; Please see Project Milestone Schedule distributed in Addendum 001 02-12-2021

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### SUBMIT FORM BY EMAIL TO INE.Mahopac@tetratech.com

**Project No.:** 121111-19002

Date: 2/25/2021

**Project Name:** Reconstruction to Mahopac High School, Mahopac Middle School, Mahopac Falls School, Bus Garage, and New Pump House

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Bidder Contact Person: CHRIS COLANDREA Bidder Company Name: NORTHBROOK CONTRACTING CORP Bidder Phone: 914-879-6099 Bidder Email Address: NORTHBROOKCHRIS@YAHOO.COM

**Question Pertains to:** 

Drawing Number: Plan Area(C-120 Room Number: Drawing Detail Number: Specification Seettoon6 ON ZC-501,

Question: (Please be specific)

PLEASE CLARIFY WHAT THE WIDTH AND DEPTH OF THE PERIMETER CURB IS AROUND THE NEW TURF FIELD. AN RFI RESPONSE NOTED THAT THERE WILL BE ONLY ONE CURB WITH THE CLF AND BALL STOPPER NETTING INCORPORATED INTO IT. BUT THE FOOTBALL SAFETY NETTING DOES NOT APPLY. DOES THAT MEAN THERE IS NO FOOTBALL SAFETY NETTING AT ALL?

**Review by Architect/Engineers:** 

Responded By: D.Bussmann Date: 03 / 01 / 2021

Refer to Addendum #3 and forthcoming Addendum #4, regarding clarification of curbing / fencing / ballstopper netting requirements. Football safety netting is not in scope and references to the documents have been deleted.

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### SUBMIT FORM BY EMAIL TO INE.Mahopac@tetratech.com

**Project No.:** 121111-19002

Date:

**Project Name:** Reconstruction to Mahopac High School, Mahopac Middle School, Mahopac Falls School, Bus Garage, and New Pump House

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Bidder Contact Person: Joseph Piazza Bidder Company Name: Piazza Inc Bidder Phone: (914) 830-1344 Bidder Email Address: jd@piazzabrothers.com

**Question Pertains to:** 

Drawing Number: Plan Area: Room Number: Drawing Detail Number: Specification Section:

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Question: (Please be specific)

addendum #4.

Could you please direct me to the drawing or drawings that have the Sliding Security Window. I see a spec section for it but can't locate the drawing. I see elevation S1 located in the security office but that appears to be fixed.

Review by Architect/Engineers:	<b>Responded By:</b>	Date	:	
this will be addressed in bid	Timothy Ste	evens	2/26/21	

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### SUBMIT FORM BY EMAIL TO INE.Mahopac@tetratech.com

**Project No.:** 121111-19002

Date:

**Project Name:** Reconstruction to Mahopac High School, Mahopac Middle School, Mahopac Falls School, Bus Garage, and New Pump House

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Bidder Contact Person: Joseph Piazza Bidder Company Name: Piazza Inc Bidder Phone: (914) 830-1344 Bidder Email Address: jd@piazzabrothers.com

**Question Pertains to:** 

Drawing Number: AA600 Plan Area: Room Number: Drawing Detail Number: <sup>S2 & S5</sup> Specification Section: <sup>084600</sup> Fire Rated Door Assemblies

Question: (Please be specific)

Fire Rated Assemblies 084600: Doors shown at elevations S2 and S5(on AA600) are shown as Flush doors with narrow lites; manufactures listed in specification 084600 do not offer Flush doors. This occurs at doors #L101-1, L101-2, L101-3, L101-4, 235-1, 238-1, 239-1, 242-2, 243-1 and 244-1; please clarify how we should proceed.

Review by Architect/Engineers:		Date:	
these doors will be addressed in bid	Timothy Stevens	2/26/21	
addendum #4			

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### SUBMIT FORM BY EMAIL TO INE.Mahopac@tetratech.com

**Project No.:** 121111-19002

Date:

**Project Name:** Reconstruction to Mahopac High School, Mahopac Middle School, Mahopac Falls School, Bus Garage, and New Pump House

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Bidder Contact Person: Joseph Piazza Bidder Company Name: Piazza Inc Bidder Phone: (914) 830-1344 Bidder Email Address: jd@piazzabrothers.com

**Question Pertains to:** 

Drawing Number: AH Drawings Plan Area: Room Number: Drawing Detail Number: Specification Section:

Question: (Please be specific)

Are all walls that are dashed on the Asbestos drawings to be removed by asbestos contractors or only the ones indicated by the asbestos notes?

**Review by Architect/Engineers:** 

Responded By: TJT Date: 2.25.21

The dashed lines that represent the walls themselves are not indicative of any abatement scope. The dashed lines located adjacent to or around some walls which have corresponding abatement keynotes do indicate abatement scope.

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### SUBMIT FORM BY EMAIL TO INE.Mahopac@tetratech.com

**Project No.:** 121111-19002

Date:

**Project Name:** Reconstruction to Mahopac High School, Mahopac Middle School, Mahopac Falls School, Bus Garage, and New Pump House

Bidder Contact Person: Joseph Piazza Bidder Company Name: Piazza Inc Bidder Phone: (914) 830-1344 Bidder Email Address: jd@piazzabrothers.com Question Pertains to:

Drawing Number: Plan Area: AA100 Room Number: Drawing Detail Number: <sup>Demo</sup> Note 1B Specification Section:

Question: (Please be specific)

Currently demo note 1B is very vague. It is telling us to remove all wall finishes in it's entirety but does not tell us what the wall finish is. Could you please indicate which areas have ceramic wall tile to be removed?

Review by Architect/Engineers:	Responded By:	Date:

will be clarified in bid addendum #4

Timothy Stevens 2/26/21

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### SUBMIT FORM BY EMAIL TO INE.Mahopac@tetratech.com

**Project No.:** 121111-19002

Date:

**Project Name:** Reconstruction to Mahopac High School, Mahopac Middle School, Mahopac Falls School, Bus Garage, and New Pump House

Bidder Email Address:	pmaddox@richardscorp.com
Bidder Company Name: Bidder Phone:	
<b>Bidder Contact Person:</b>	PETER MADDOX

#### Pertains to:

Drawing Number: Plan Area: Room Number: Drawing Detail Number: Specification Section: 01 12 00 & 01-50-00

### ------<u>Question:</u>

#### (Please be specific)

1. Section 01 12 00 Summary of Project section 1.19A says a site logistics plan will be issued. I cannot find it in the documents or addenda. please clarify where this plan can be found.

2. Section 01 50 00, 3.3.E.4.a&b references "Item. #304.3 course". Please clarify what this is.

**Review by Architect/Engineers:** 

Responded By: <u>HR/TPG</u> Date: <u>02-28-21</u>

1. A Site Logistics Plan will be issued in an upcoming Addendum; it has not been issued at this time

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2. 01 50 00 , 3.3.E.4 a/b Item #304.3 course - Refers to "SUBBASE COURSE " for a general reference, please see NYS DOT section 304 - Sub-base Course

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### SUBMIT FORM BY EMAIL TO INE.Mahopac@tetratech.com

**Project No.:** 121111-19002

Date: 2-19-2021

**Project Name:** Reconstruction to Mahopac High School, Mahopac Middle School, Mahopac Falls School, Bus Garage, and New Pump House

Bidder Contact Person:	PETER MADDOX
Bidder Company Name:	RICHARDS CORPORATION
Bidder Phone:	860-583-9229
Bidder Email Address:	pmaddox@richardscorp.com
Question Pertains to: Drawing Number: Plan Area: Room Number: Drawing Detail Number: Specification Section:	03 48 10

#### **Question: (Please be specific)**

Which contractor is responsible to purchase the precast concrete lighting pole bases?

**Review by Architect/Engineers:** 

Responded By: <u>HR/TPG</u> Date: <u>02-28-21</u>

Please refer to Specification Section 01 12 00 Contract 7 - Site Work 1.13 B 3. Division 3 – Concrete - all Sections. Please also to refer to Spec Section 03 48 10 issued in Addendum 002 02-16-2021

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### SUBMIT FORM BY EMAIL TO INE.Mahopac@tetratech.com

**Project No.:** 121111-19002

Date: 2-19-2021

**Project Name:** Reconstruction to Mahopac High School, Mahopac Middle School, Mahopac Falls School, Bus Garage, and New Pump House

Bidder Contact Person: Bidder Company Name: Bidder Phone: Bidder Email Address:	PETER MADDOX RICHARDS CORPORATION 860-583-9229 pmaddox@richardscorp.com
<b>Question Pertains to:</b>	
Drawing Number: ZC504 Plan Area: Room Number: Drawing Detail Number: Specification Section:	
Question: (Please be spec	
1. Which contractor is resp	ponsible to place the concrete pad below the new water storage tank?
2. Which contractor is res the storage tank to the pu	ponsible for the 4" chlorinated water and 6" potable water lines from mp house?
<u>Review by Architect/Eng</u>	ineers: Responded By: <u>HR/TPG</u> Date: <u>02-28-21</u>
The Site Work Contractor ( (Contract #7) shall be respo 1.7;5 New Construction- d.	a 01 12 00 1.7;5 New Construction -c Contract 1 GENERAL CONSTRUCTION WORK Contract #7) shall be responsible for the construction of all exterior concrete pads. The Site Contractor insible to prepare the area to sub-grade. Provide shoring and bracing and excavation for all work related to new building, and all excavation for other contractors related to avation shall be within five (5) feet of building foundation.
2. See Division 22 - Plumbing	
	an 5 working days prior to the specified Bid Opening date and time. In the event that



### SUBMIT FORM BY EMAIL TO INE.Mahopac@tetratech.com

**Project No.:** 121111-19002

Date:

**Project Name:** Reconstruction to Mahopac High School, Mahopac Middle School, Mahopac Falls School, Bus Garage, and New Pump House

Bidder Contact Person: Bidder Company Name:	
Bidder Phone:	860-583-9229
Bidder Email Address:	jprincipi@richardscorp.com

**Question Pertains to:** 

Drawing Number: AC100 Plan Area: Room Number: Drawing Detail Number: Specification Section:

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#### Question: (Please be specific)

1. Please clarify the intent of the fence removal. The existing fence is being called out for removal, temporary relocation, and to be protected to remain.

**Review by Architect/Engineers:** 

Responded By: D.Bussmann Date: 2 / 23 / 2021

Refer to issued Addendum #3 for clarification of fence removal, temporary relocation, and fencing to remain.

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## SUBMIT FORM BY EMAIL TO INE.Mahopac@tetratech.com

**Project No.:** 121111-19002

Date: 2-22-2020

Bidder Contact Person: Bidder Company Name:	
Bidder Phone: Bidder Email Address:	860-583-9229 pmaddox@richardscorp.com
Question Pertains to:	
Drawing Number: AC100 Plan Area: Room Number: Drawing Detail Number:	
Specification Section: Question: (Please be spec	
Question: (Please be spec	
Question: (Please be spec	<u>cific)</u> nsible for the demolition of the existing pump house structure?

this question requires clarification or modification of the Bidding Documents, such written information can only be provided by formal Addendum, distributed to all plan holders.



### SUBMIT FORM BY EMAIL TO INE.Mahopac@tetratech.com

**Project No.:** 121111-19002

Date: 2-25-2020

**Project Name:** Reconstruction to Mahopac High School, Mahopac Middle School, Mahopac Falls School, Bus Garage, and New Pump House

Bidder Contact Person: Bidder Company Name: Bidder Phone: Bidder Email Address:	
Diuder Einan Auuress.	pmaddox@ricnardscorp.com

**Question Pertains to:** 

Drawing Number: Plan Area: Room Number: Drawing Detail Number: Specification Section: 31 20 00 appendix - geotechincal borings and maps

#### **Question: (Please be specific)**

1. The geotechnical report maps show an I-series of borings and a TS series of borings, MHS I-1 through I-6, MMS I-1 through I-4, and MHS TS-1 through TS-4. The boring logs were not provided for these holes. Please provide.

2. There was mention of possible rock being present in the site pre-bid meeting. The borings provided do not show any rock. Please clarify what volume and location of rock removal, if any, should be included in the base bid.

Review by Architect/Engineers:	Responded By: C Glaubitz Date: 3/1/21
Locations including "I" and "TS" indications are no locations. Rock removal is not anticipated.	ot borings. They indicate infiltration test and soil test

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### SUBMIT FORM BY EMAIL TO INE.Mahopac@tetratech.com

**Project No.:** 121111-19002

Date: 2-25-2020

**Project Name:** Reconstruction to Mahopac High School, Mahopac Middle School, Mahopac Falls School, Bus Garage, and New Pump House

<b>Bidder Contact Person:</b>	PETER MADDOX
<b>Bidder Company Name:</b>	RICHARDS CORPORATION
Bidder Phone:	860-583-9229
Bidder Email Address:	pmaddox@richardscorp.com

**Question Pertains to:** 

Drawing Number: Plan Area: Room Number: Drawing Detail Number: Specification Section: 01 12 00, 1.13, A.3.h & 31 20 00

#### **Question: (Please be specific)**

1. Please clarify if the existing soil layer identified as "organic silt sand" in boring MMS AB-20 represents "unsuitable fill".

2. If so, shall the site contractor include its removal and replacement in the base bid?

3. If so, please provide a quantity as 1 boring is not sufficient to determine a volume.

Review by Architect/Engineers:	Responded By: C Glaubitz	Date:	3/1/21
The soil in question has not been determined	to be unsuitable fill.		

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### SUBMIT FORM BY EMAIL TO INE.Mahopac@tetratech.com

**Project No.:** 121111-19002

Date: 2-25-2020

**Project Name:** Reconstruction to Mahopac High School, Mahopac Middle School, Mahopac Falls School, Bus Garage, and New Pump House

<b>Bidder Contact Person:</b>	PETER MADDOX
<b>Bidder Company Name:</b>	RICHARDS CORPORATION
Bidder Phone:	860-583-9229
Bidder Email Address:	pmaddox@richardscorp.com

**Question Pertains to:** 

Drawing Number: Plan Area: Room Number: Drawing Detail Number: Specification Section: 31 20 00, 2.1.D.1 and 2.1.E.1 and 2.1.F.1

#### Question: (Please be specific)

1. Detail 8/ZC504 calls for "structural fill" to backfill pipes below paved areas. Specification section 31 20 00,2.1.D.1 says "granular fill" is required below pavements and synthetic fields. Please clarify which material is required as these have different definitions.

2. Please confirm the onsite soils will not be allowed for filling to subgrade below the paved areas and synthetic fields. If not, please clarify which, "granular fill" or "structural fill" is required.

**Review by Architect/Engineers:** 

Responded By: D.Bussmann Date: 2/26/2021

Refer to specification 31 00 00 Earth Moving 3.18.B. section for soil fill requirements, including areas under walks, pavements and exterior slabs, under steps and ramps, under building slabs, and under synthetic turf fields. Regarding backfill for pipes below paved areas and synthetic turf, use structural fill up to the subbase layer, where granular fill (or as specified for synthetic turf) will apply.

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### SUBMIT FORM BY EMAIL TO INE.Mahopac@tetratech.com

**Project No.:** 121111-19002

**Date:** 2/25/21

**Project Name:** Reconstruction to Mahopac High School, Mahopac Middle School, Mahopac Falls School, Bus Garage, and New Pump House

Bidder Contact Person: Jim Sass III Bidder Company Name: J&J Sass Electric Inc. Bidder Phone: 845-331-8666 Bidder Email Address: jimsass3@jjsass.com
Question Pertains to:
Drawing Number: AE003 Plan Area: Room Number: Drawing Detail Number: Specification Section:
Question: (Please be specific) Please clarify the location of the MDP in the academy school so we know how far the feeder run is to panel PH-1. Also clarify where the (2) 2" spare conduits are going in that school. Please clarify the scale on the drawing as well.

**Review by Architect/Engineers:** 

Responded By: CREGA Date: 2/26/21

MDP AND CONDUITS AS INDICATED IN CORNER OF BUILDING AS SHOWN ON DRAWING. REFER TO SCALE PROVIDED ON DRAWING.

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### SUBMIT FORM BY EMAIL TO INE.Mahopac@tetratech.com

Project No.: 121111-19002

**Date:** February 25, 2021

**Project Name:** Reconstruction to Mahopac High School, Mahopac Middle School, Mahopac Falls School, Bus Garage, and New Pump House

Bidder Contact Person: Adam Horton Bidder Company Name: Turco Golf, Inc. Bidder Phone: Cell: 607-437-4672 Office: 845-357-9300 Bidder Email Address: ahorton@grasskeepers.net

**<u>Question Pertains to:</u>** Ref. Contract 7 SW - Site Construction Work

Drawing Number: Sheet ZC 504 Plan Area: N/A Room Number: N/A Drawing Detail Number: Detail 2 - Water Storage Tank & Detail 9 - Well Modification Specification Section:

#### **Question: (Please be specific)**

Please confirm which contract includes the proposed water storage tank installation and well modification shown on plan sheet ZC 504.

**Review by Architect/Engineers:** 

Responded By: <u>HR/TPG</u> Date: <u>02-26-21</u>

Please refer to Spec Section 22 12 19 Facility Ground-Mounted, Potable Water Storage Tanks Also see Spec Section 01 12 00 1.13 CONTRACT 7 – SITE WORK CONSTRUCTION 5/b & 5/f

Submit requests not less than 5 working days prior to the specified Bid Opening date and time. In the event that this question requires clarification or modification of the Bidding Documents, such written information can only be provided by formal Addendum, distributed to all plan holders.

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### SECTION 26 08 00 - COMMISSIONING OF ELECTRICAL

#### PART 1 - GENERAL

#### 1.1 RELATED DOCUMENTS

- A. Drawings and general provisions of the Contract, including General Conditions and other Division 01 Specification Sections, apply to this Section.
  - 1. See especially Section 01 08 00, "General Commissioning Requirements" for general commissioning process requirements and Commissioning Coordinator responsibilities.

#### 1.2 INCLUDED SYSTEMS AND EQUIPMENT

- A. The following is a list of the equipment and system test requirements included in this section:
  - 1. Interior Occupancy Lighting Controls
  - 2. Exterior Motion/Photo and Timeclock Controls

#### 1.3 DESCRIPTION

- A. This section specifies the example functional testing requirements for Division 23 systems and equipment. From these examples, the Commissioning Authority (CxA) shall develop step-by-step procedures to be executed by the Subs or the Commissioning Authority. The general functional testing process, requirements and test method definitions are described in Section 01 9113. The test requirements for each piece of equipment or system contain the following:
  - 1. The contractors responsible to execute the tests, under the direction of the CxA.
  - 2. A list of the integral components being tested.
  - 3. Prefunctional checklists associated with the components.
  - 4. Functions and modes to be tested.
  - 5. Required conditions of the test for each mode.
  - 6. Special procedures.
  - 7. Required methods of testing.
  - 8. Required monitoring.
  - 9. Acceptance criteria.

#### 1.4 MONITORING

- A. Monitoring is a method of testing as a stand-alone method or to augment manual testing.
- B. All points listed in the required monitoring section of the test requirements which are control system monitored points shall be trended by the controls contractor. Other points shall be monitored by the CxA using dataloggers. At the option of the CxA, some control system monitoring may be replaced with datalogger monitoring. At the CxA's request, the controls contractor shall trend up to 20% more points than listed herein at no extra charge.

- C. Hard copies of monitored data must be in columnar format with time down the left column and at least 5 columns of point values on the same page.
- D. Graphical output is desirable, and will be required for all output, if the system can produce it.

### PART 2 - PRODUCTS (Not Used)

### PART 3 - EXECUTION

#### 3.1 TESTING PREPARATION

- A. Certify that Lighting Control systems have been installed, calibrated, and started and are operating according to the Contract Documents.
- B. Testing Instrumentation: Install measuring instruments and logging devices to record test data as directed by the CxA.

#### 3.2 GENERAL TESTING REQUIREMENTS

A. The CxA in cooperation with the Electrical Contractor shall prepare detailed testing plans, procedures, and checklists for Lighting control systems.


#### 3.3 LIGHTING CONTROL SYSTEMS FUNCTIONAL TESTING PROCEDURES


- A. Parties Responsible to Execute Functional Test
  - 1. Controls contractor: operate the controls to activate the equipment if BAS controlled
  - 2. Electrical contractor or vendor: assist in testing sequences.
  - 3. CxA: to witness, direct and document testing.
- B. Integral Components or Related Equipment Being Tested
  - 1. Lighting Controls (Occupancy, Vacancy, Daylighting, Dimming, Timeclocks)
- C. Prerequisites The commissioning agent will spot-check misc. items and calibrations on the prefunctional checklists previously completed by the installer, prior to beginning functional testing
- D. Functions / Modes Required to be Tested, Test Methods and Seasonal Test Requirements
- E. The following testing requirements are in addition to and do not replace any testing requirements elsewhere in this Division.


Function / Mode	<u>Test Method</u> Manual and/or Monitoring
GENERAL	
All specified functions and features are set up, debugged and full operable	Verbal discus-
	sion of features
Power failure and battery backup and power-up restart functions	Demonstration
Occupant override functions and duration settings	Demonstration
SWITCHING FUNCTIONS	
Test the sequence of operation for all features and modes	Manual
Verify that off delays are set and functioning so that the change of light	Manual
fixture operation is judged non-bothersome to occupants	
Verify that the controls and sensors are not easily overridden or disabled	Visual inspec-
by unauthorized occupants	tion
Verify control strategies, schedules and setpoints to be reasonable and	Manual
appropriate	
	GENERAL         All specified functions and features are set up, debugged and full operable         Power failure and battery backup and power-up restart functions         Occupant override functions and duration settings         SWITCHING FUNCTIONS         Test the sequence of operation for all features and modes         Verify that off delays are set and functioning so that the change of light fixture operation is judged non-bothersome to occupants         Verify that the controls and sensors are not easily overridden or disabled by unauthorized occupants         Verify control strategies, schedules and setpoints to be reasonable and


- F. Special Procedures (other equipment to test with, etc.; reference to function ID)
  - 1. Daylight/photo sensors controls to be confirmed at multiple ambient light levels if necessary.
- G. Acceptance Criteria (referenced by function or mode ID)
  - 1. For the conditions, sequences and modes tested as shown above, the lighting controls, integral components and related equipment respond to changing conditions and parameters appropriately as expected, as specified and according to acceptable operating practice.
- H. Sampling Strategy for Identical Units
  - 1. A representative sample of units will be tested by the CxA.
  - 2. For identical units, test a minimum of three before sampling.


### END OF SECTION 26 08 00

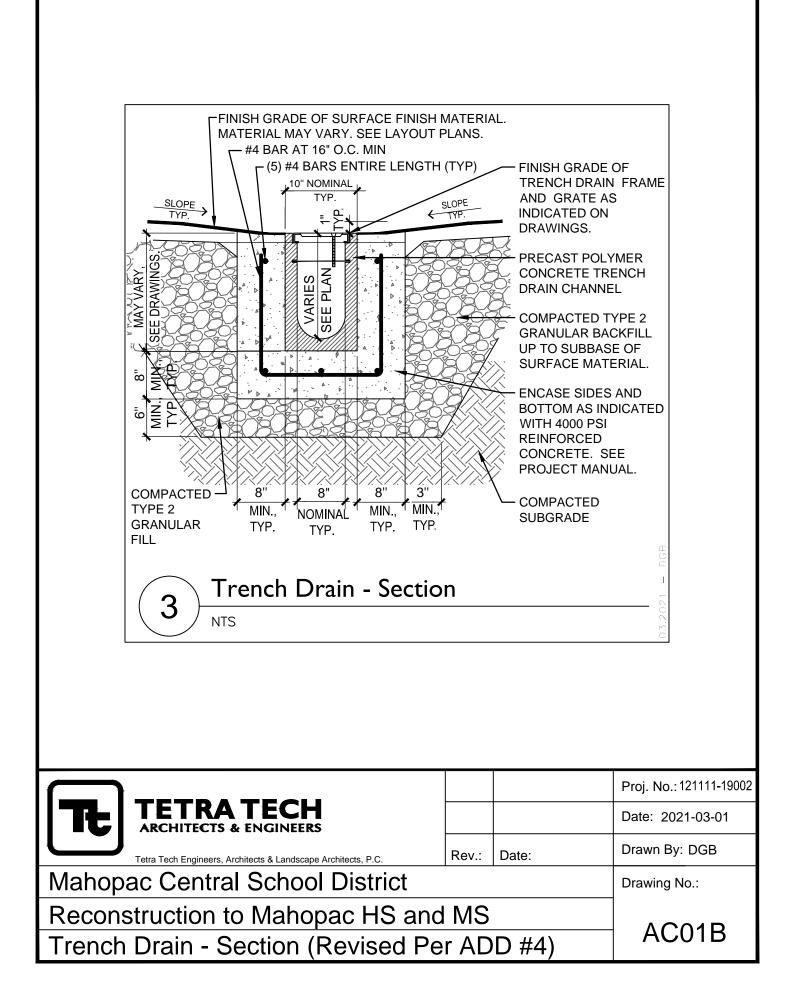

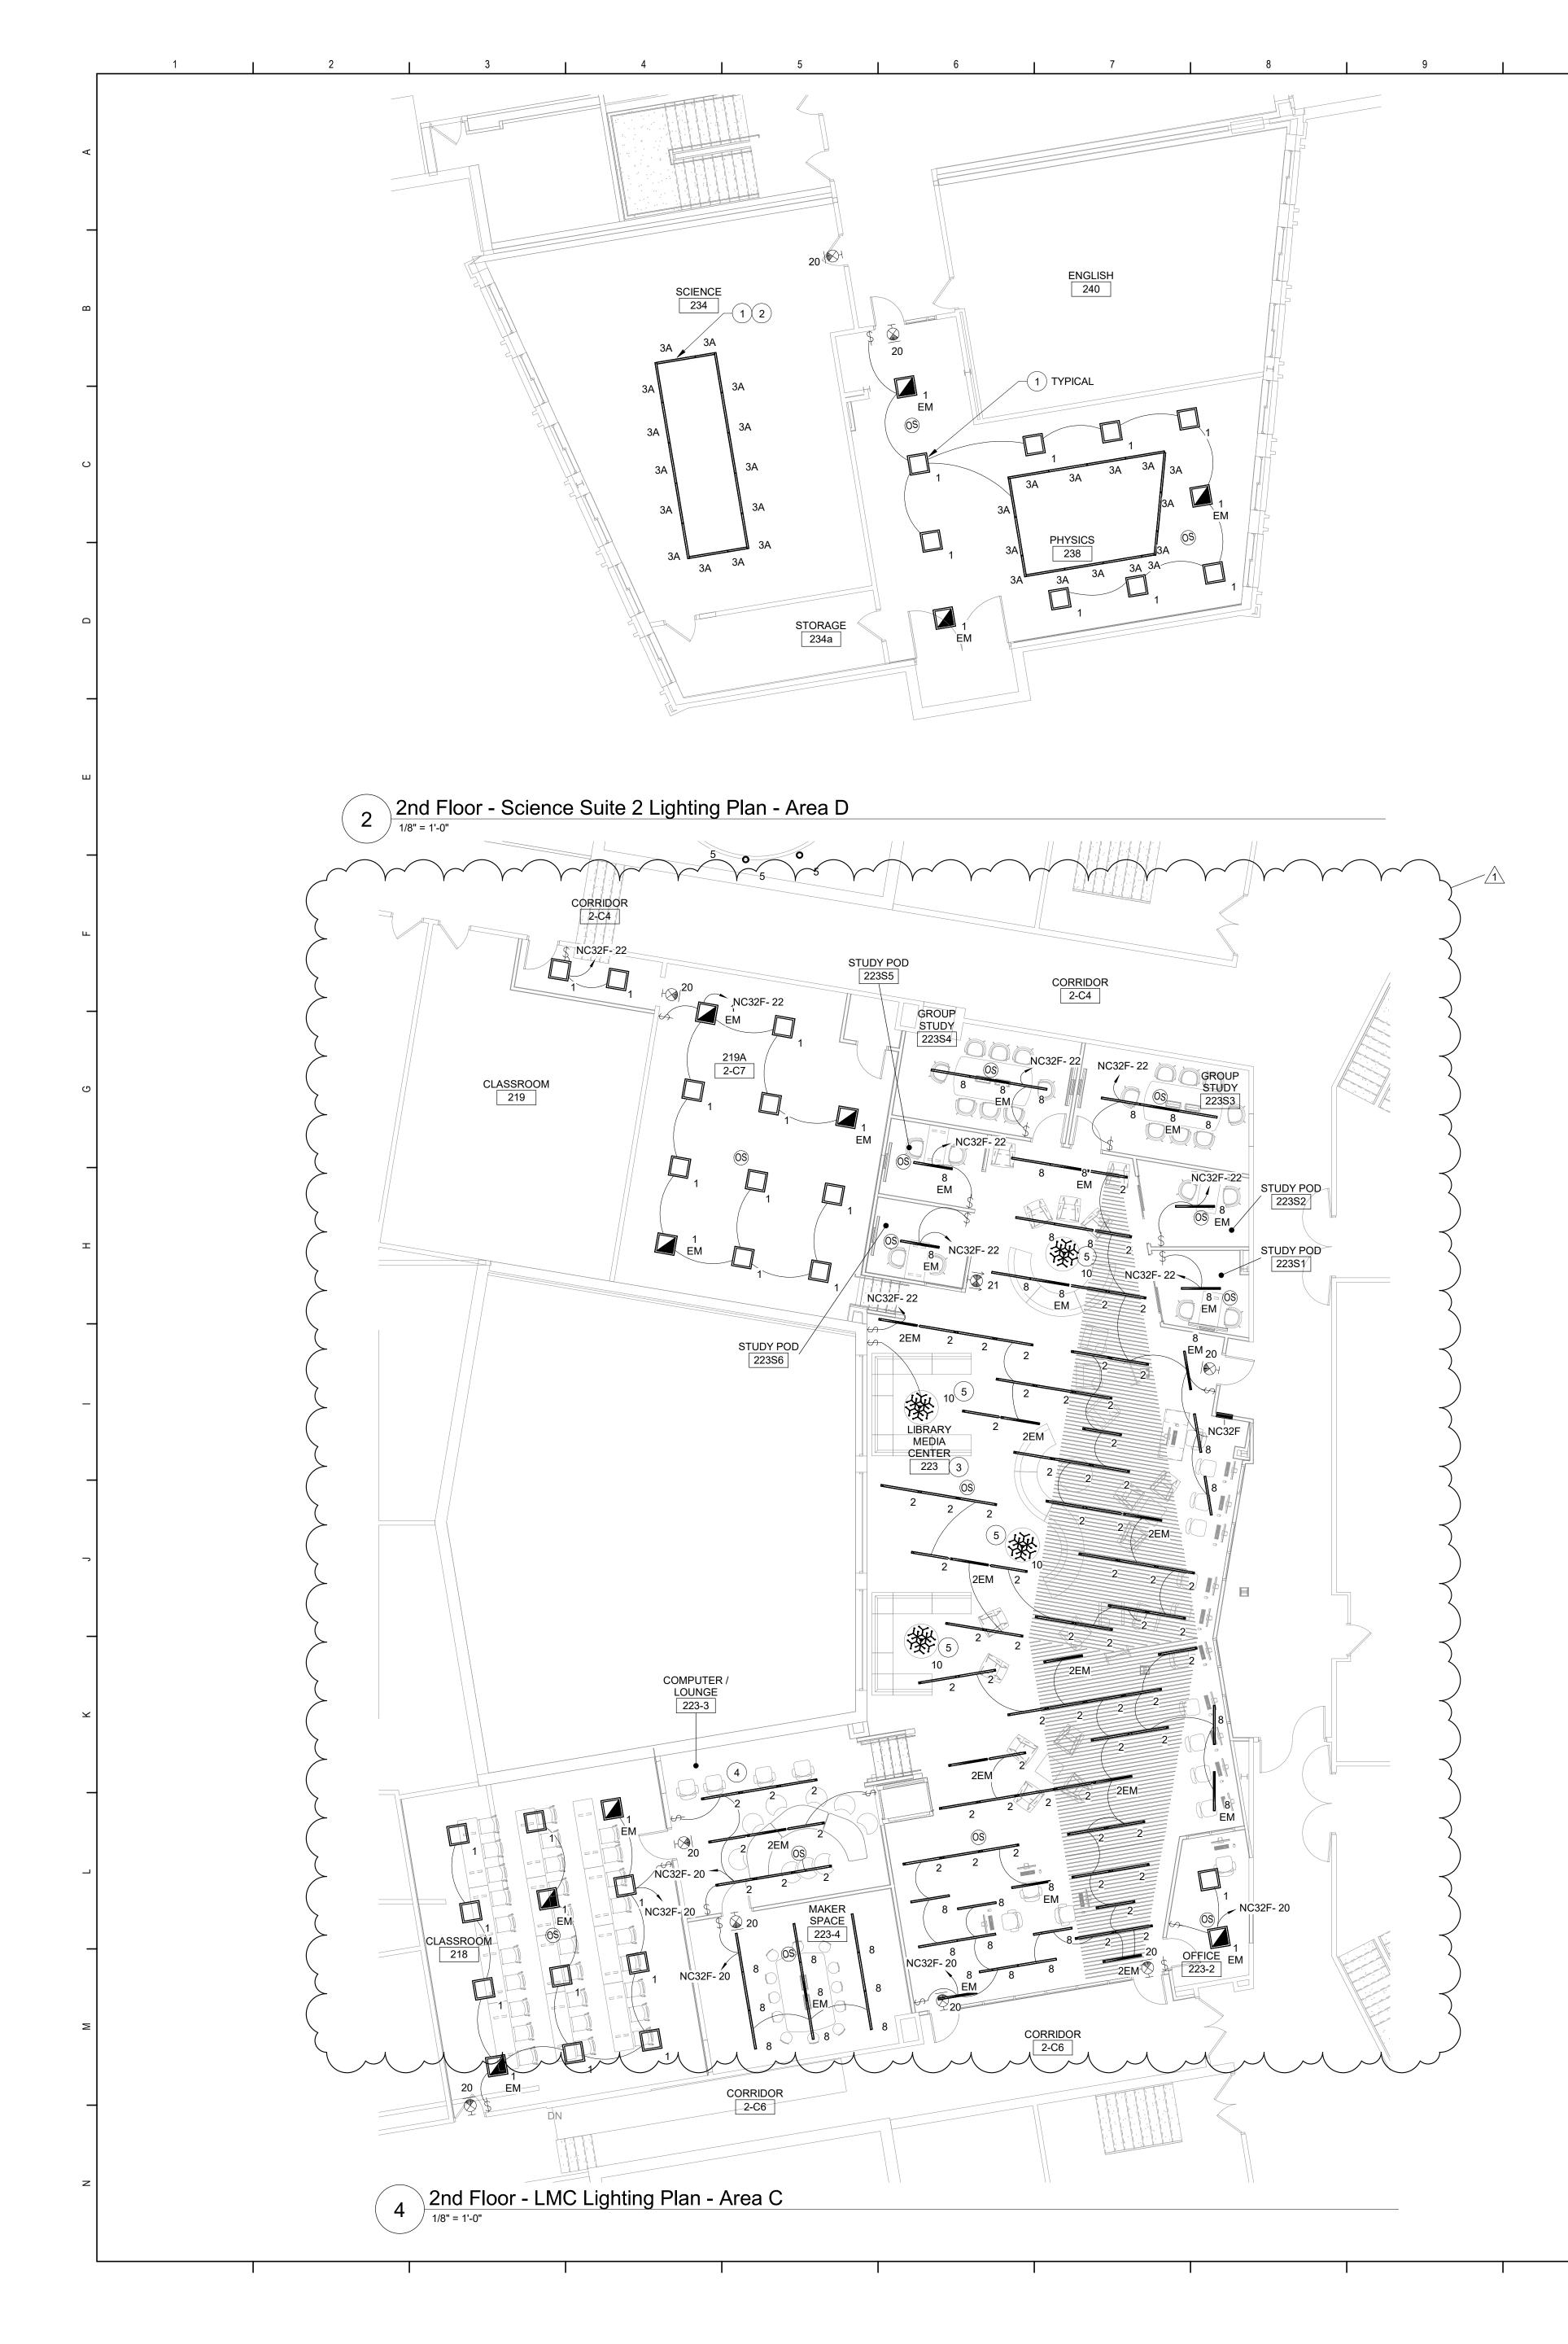


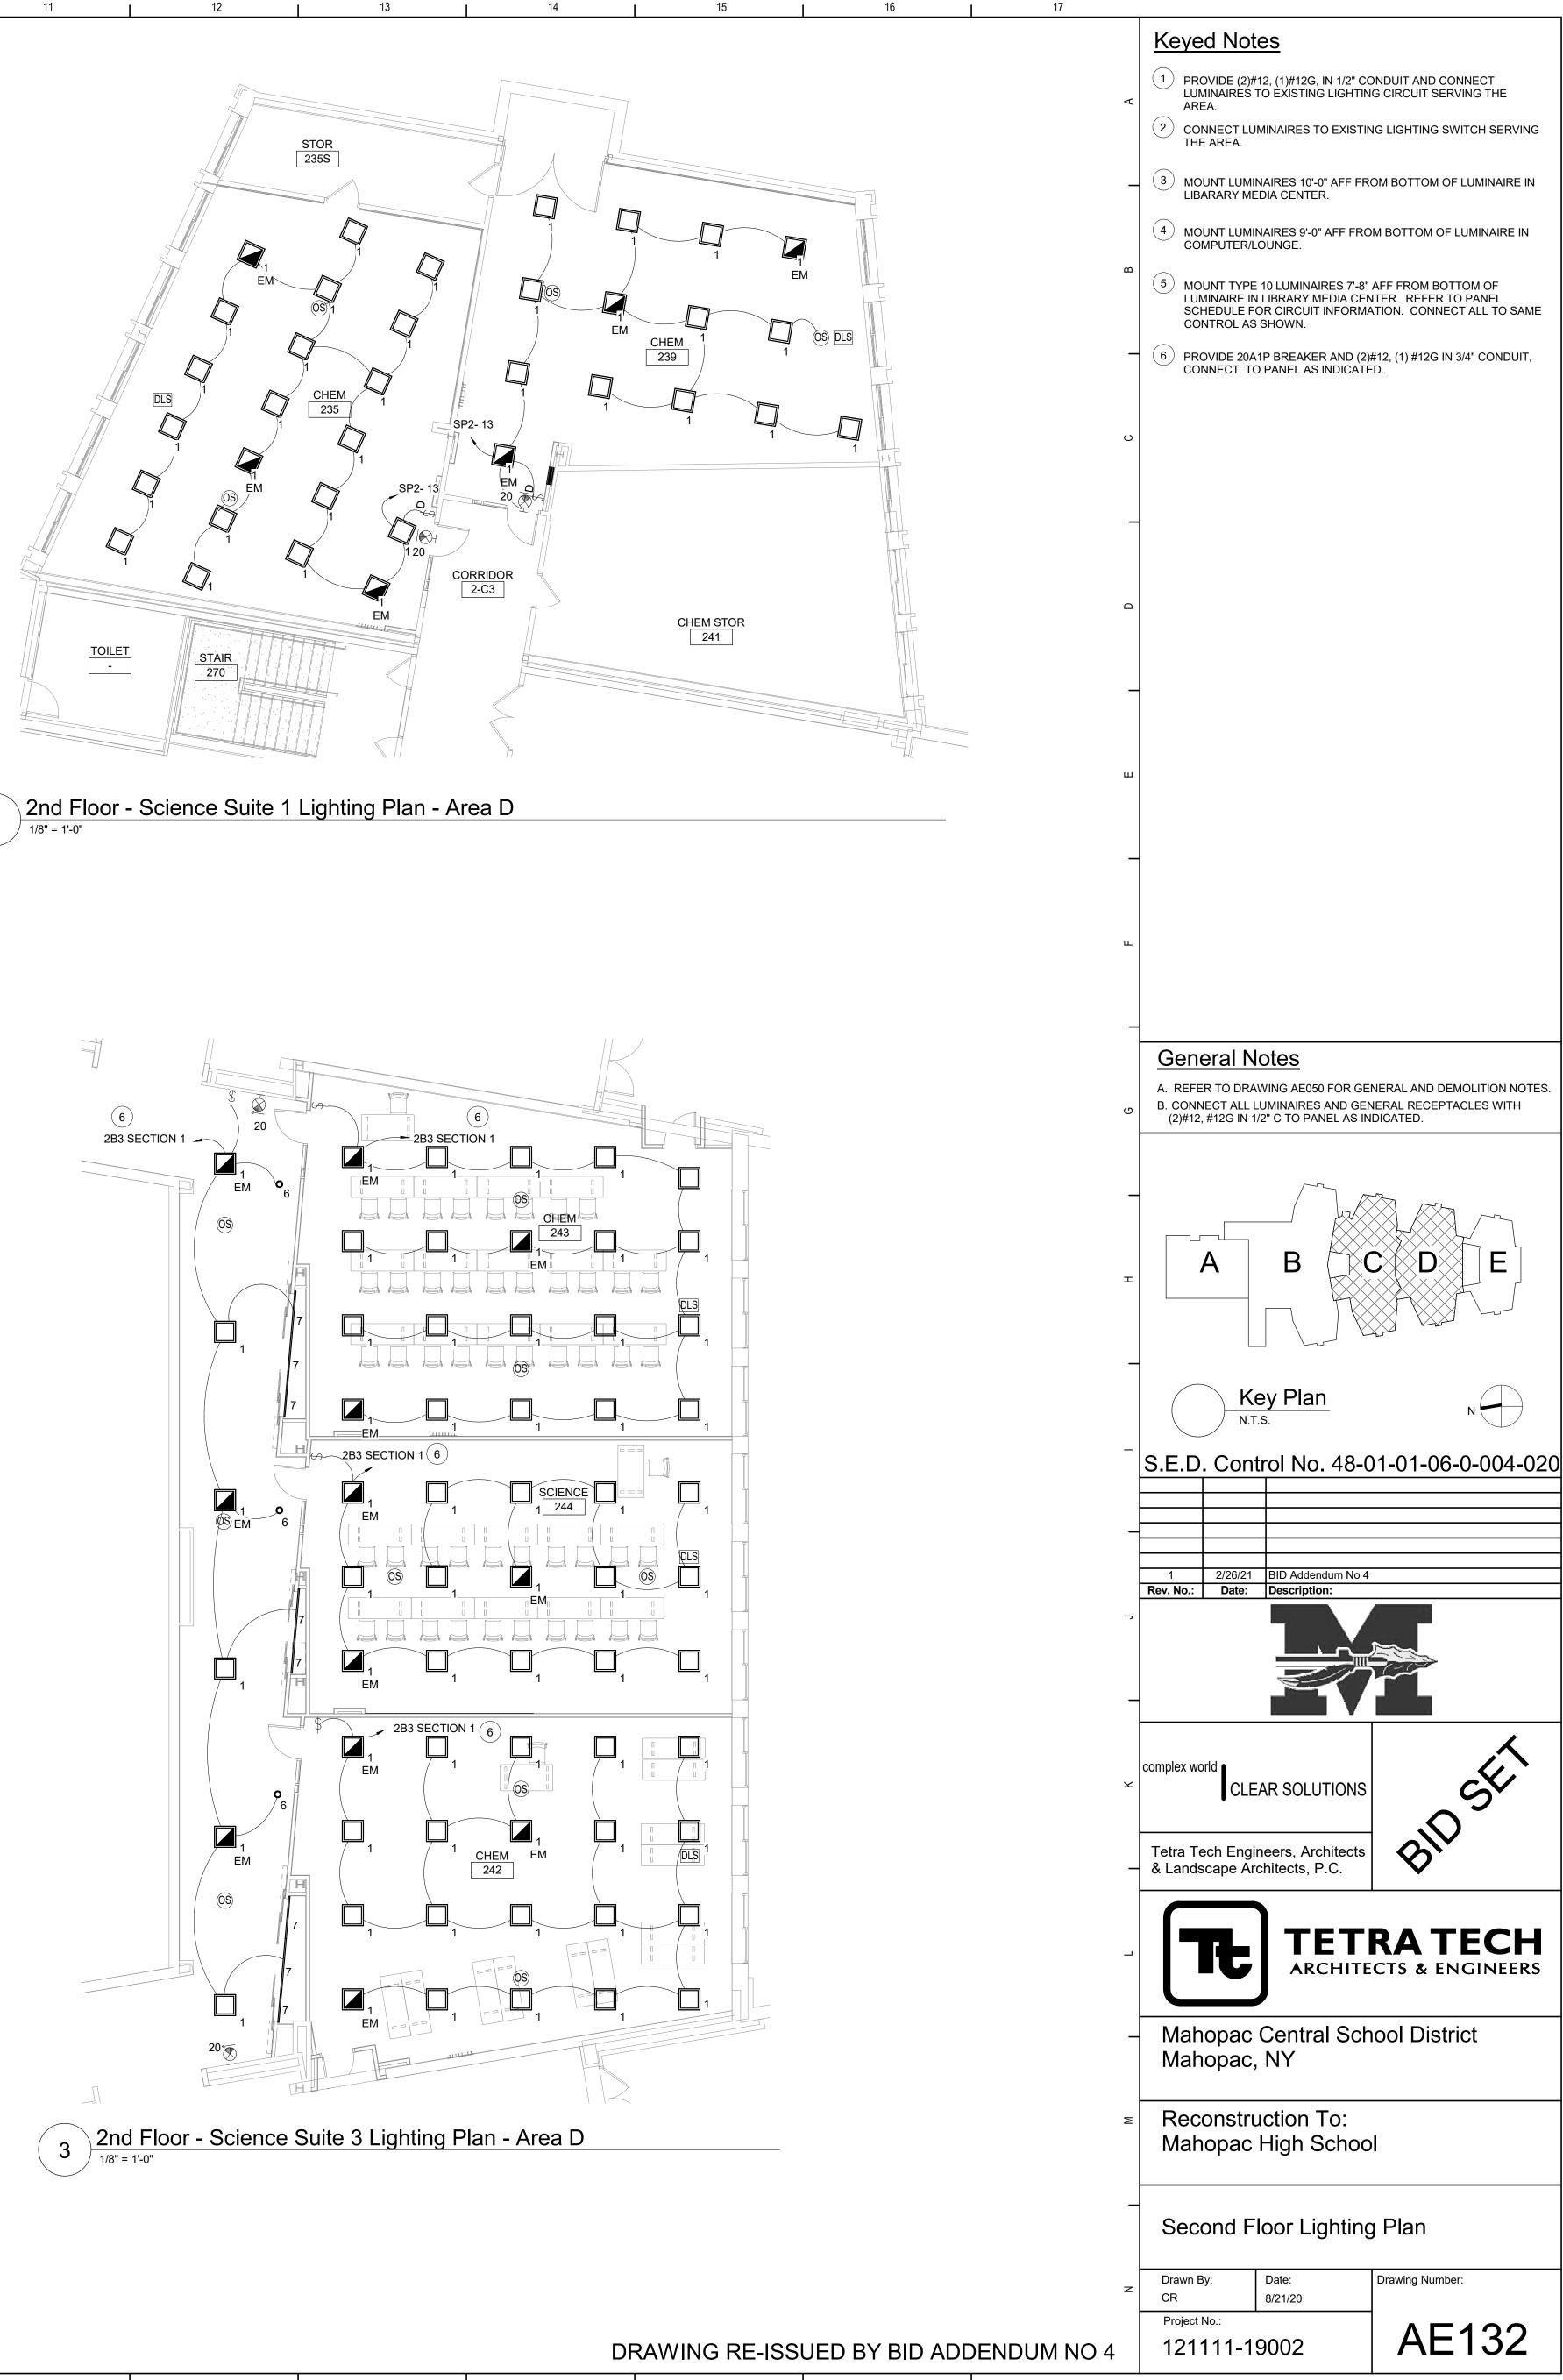


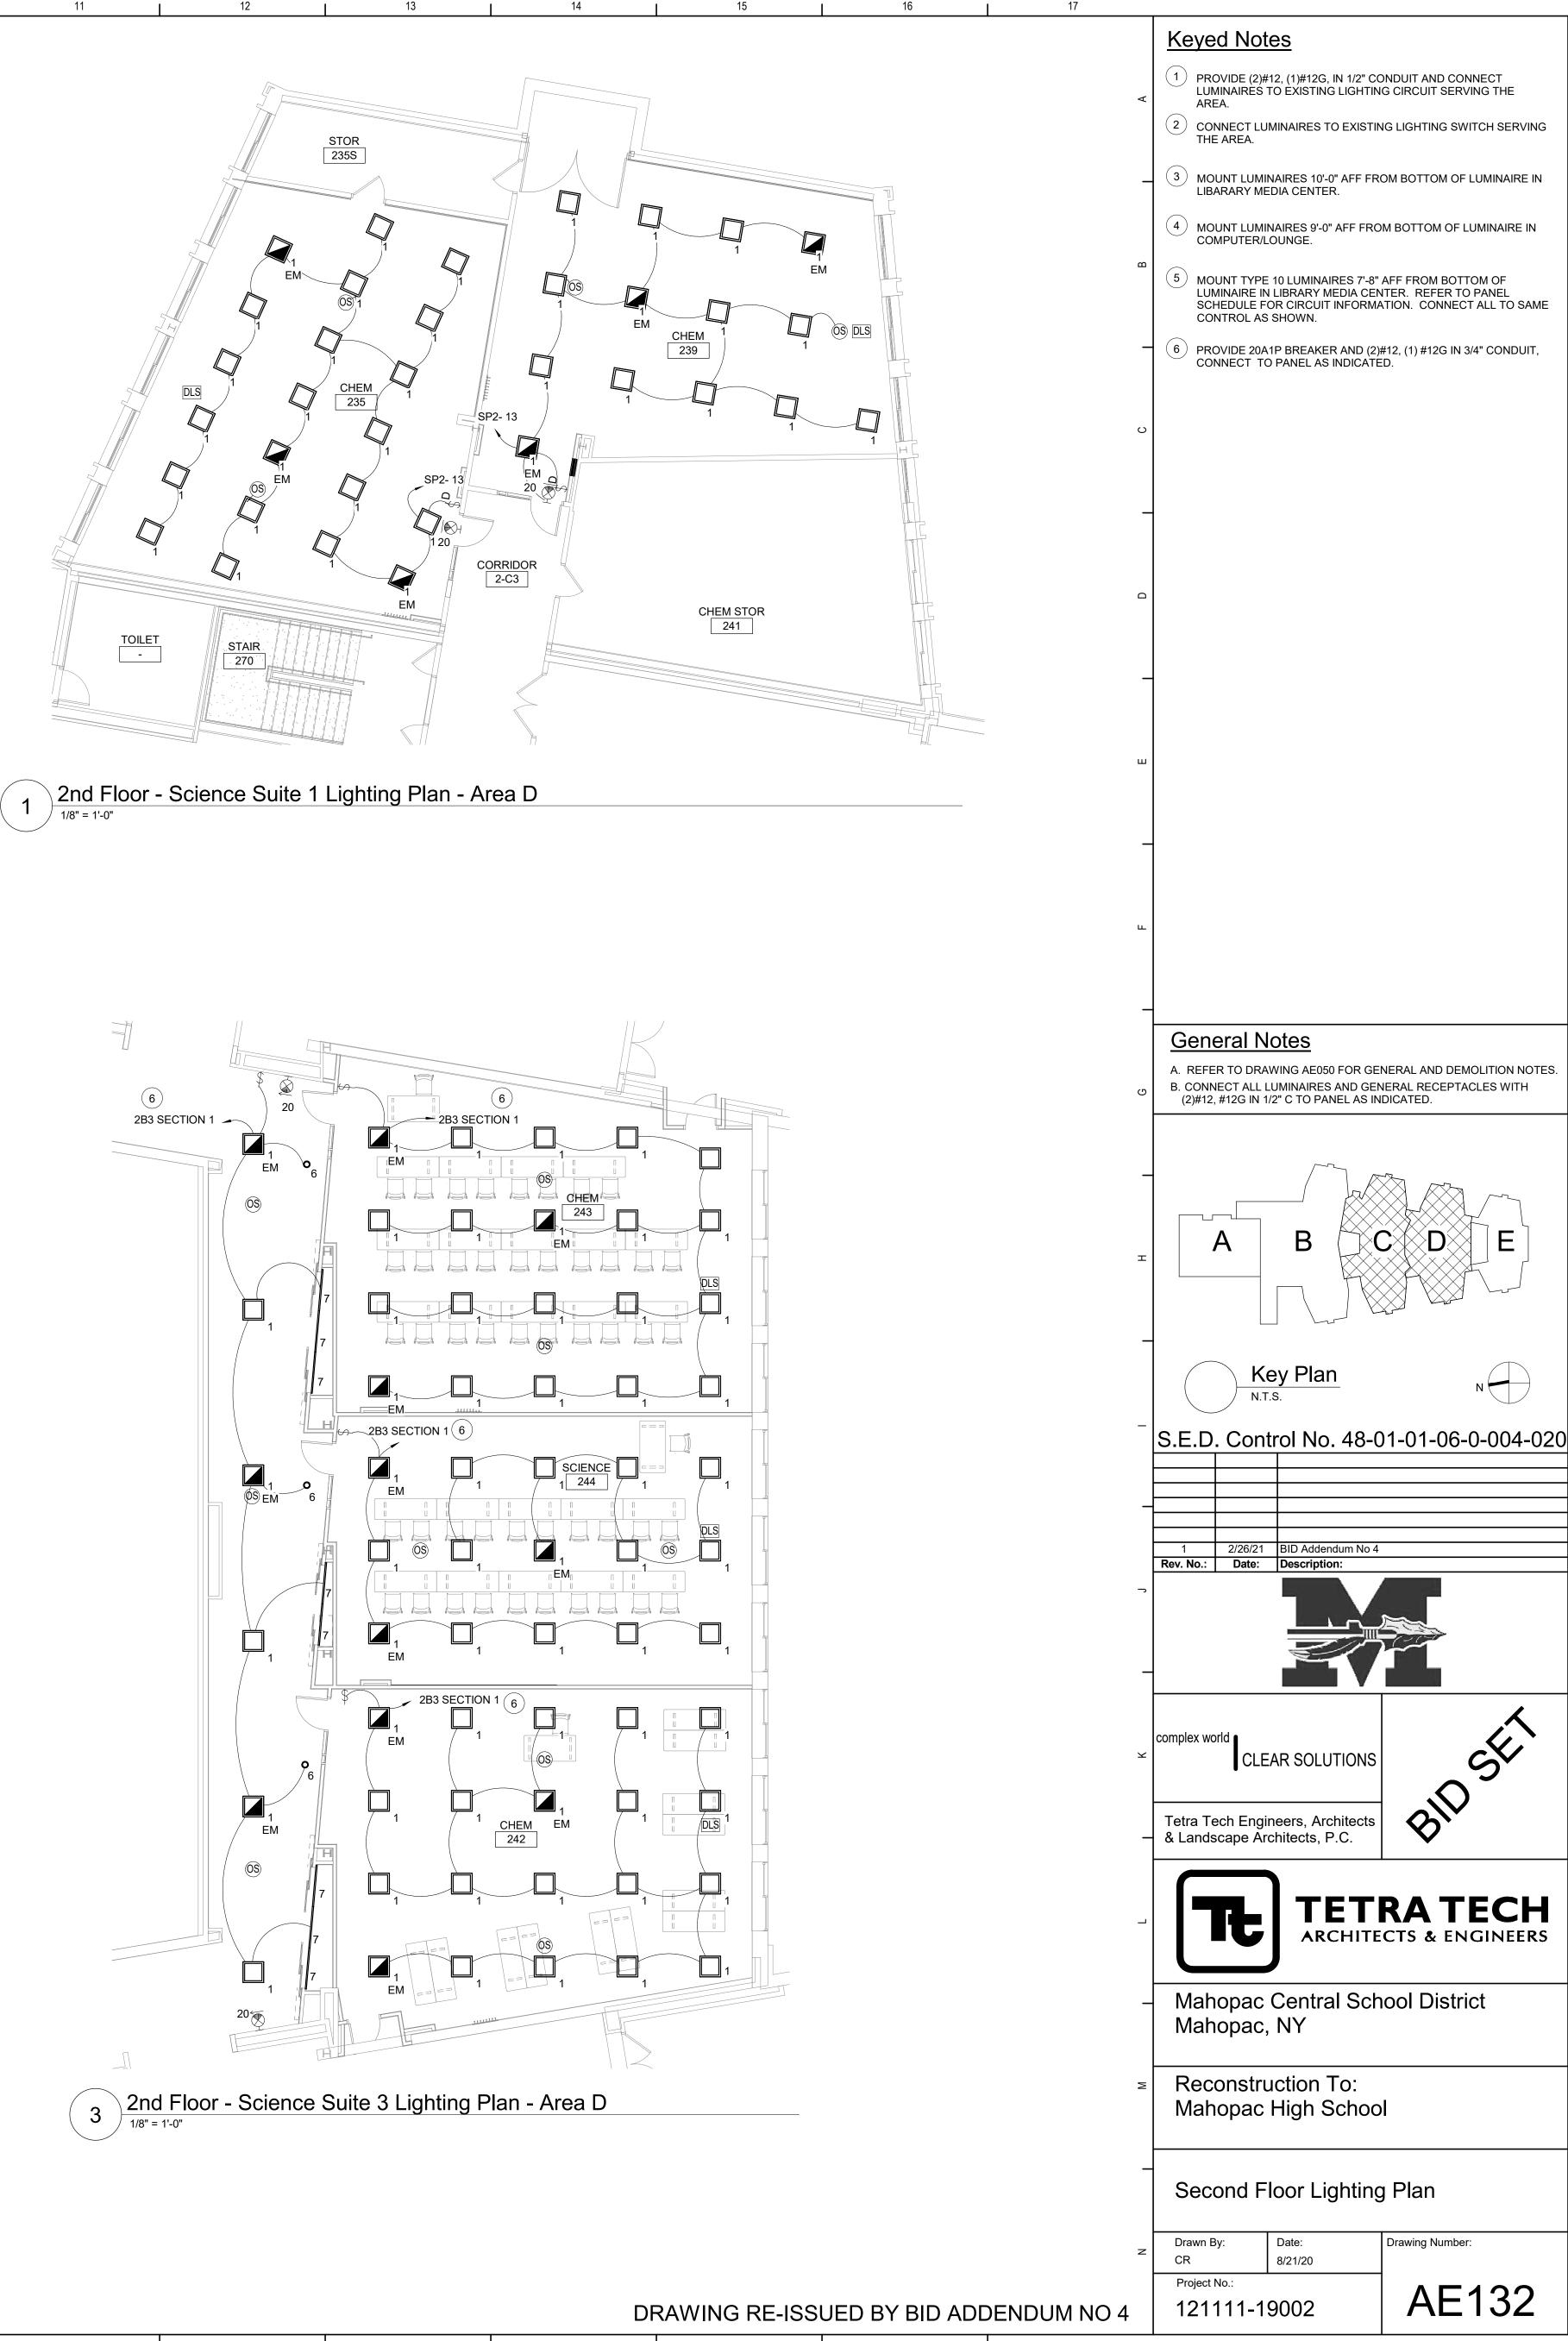

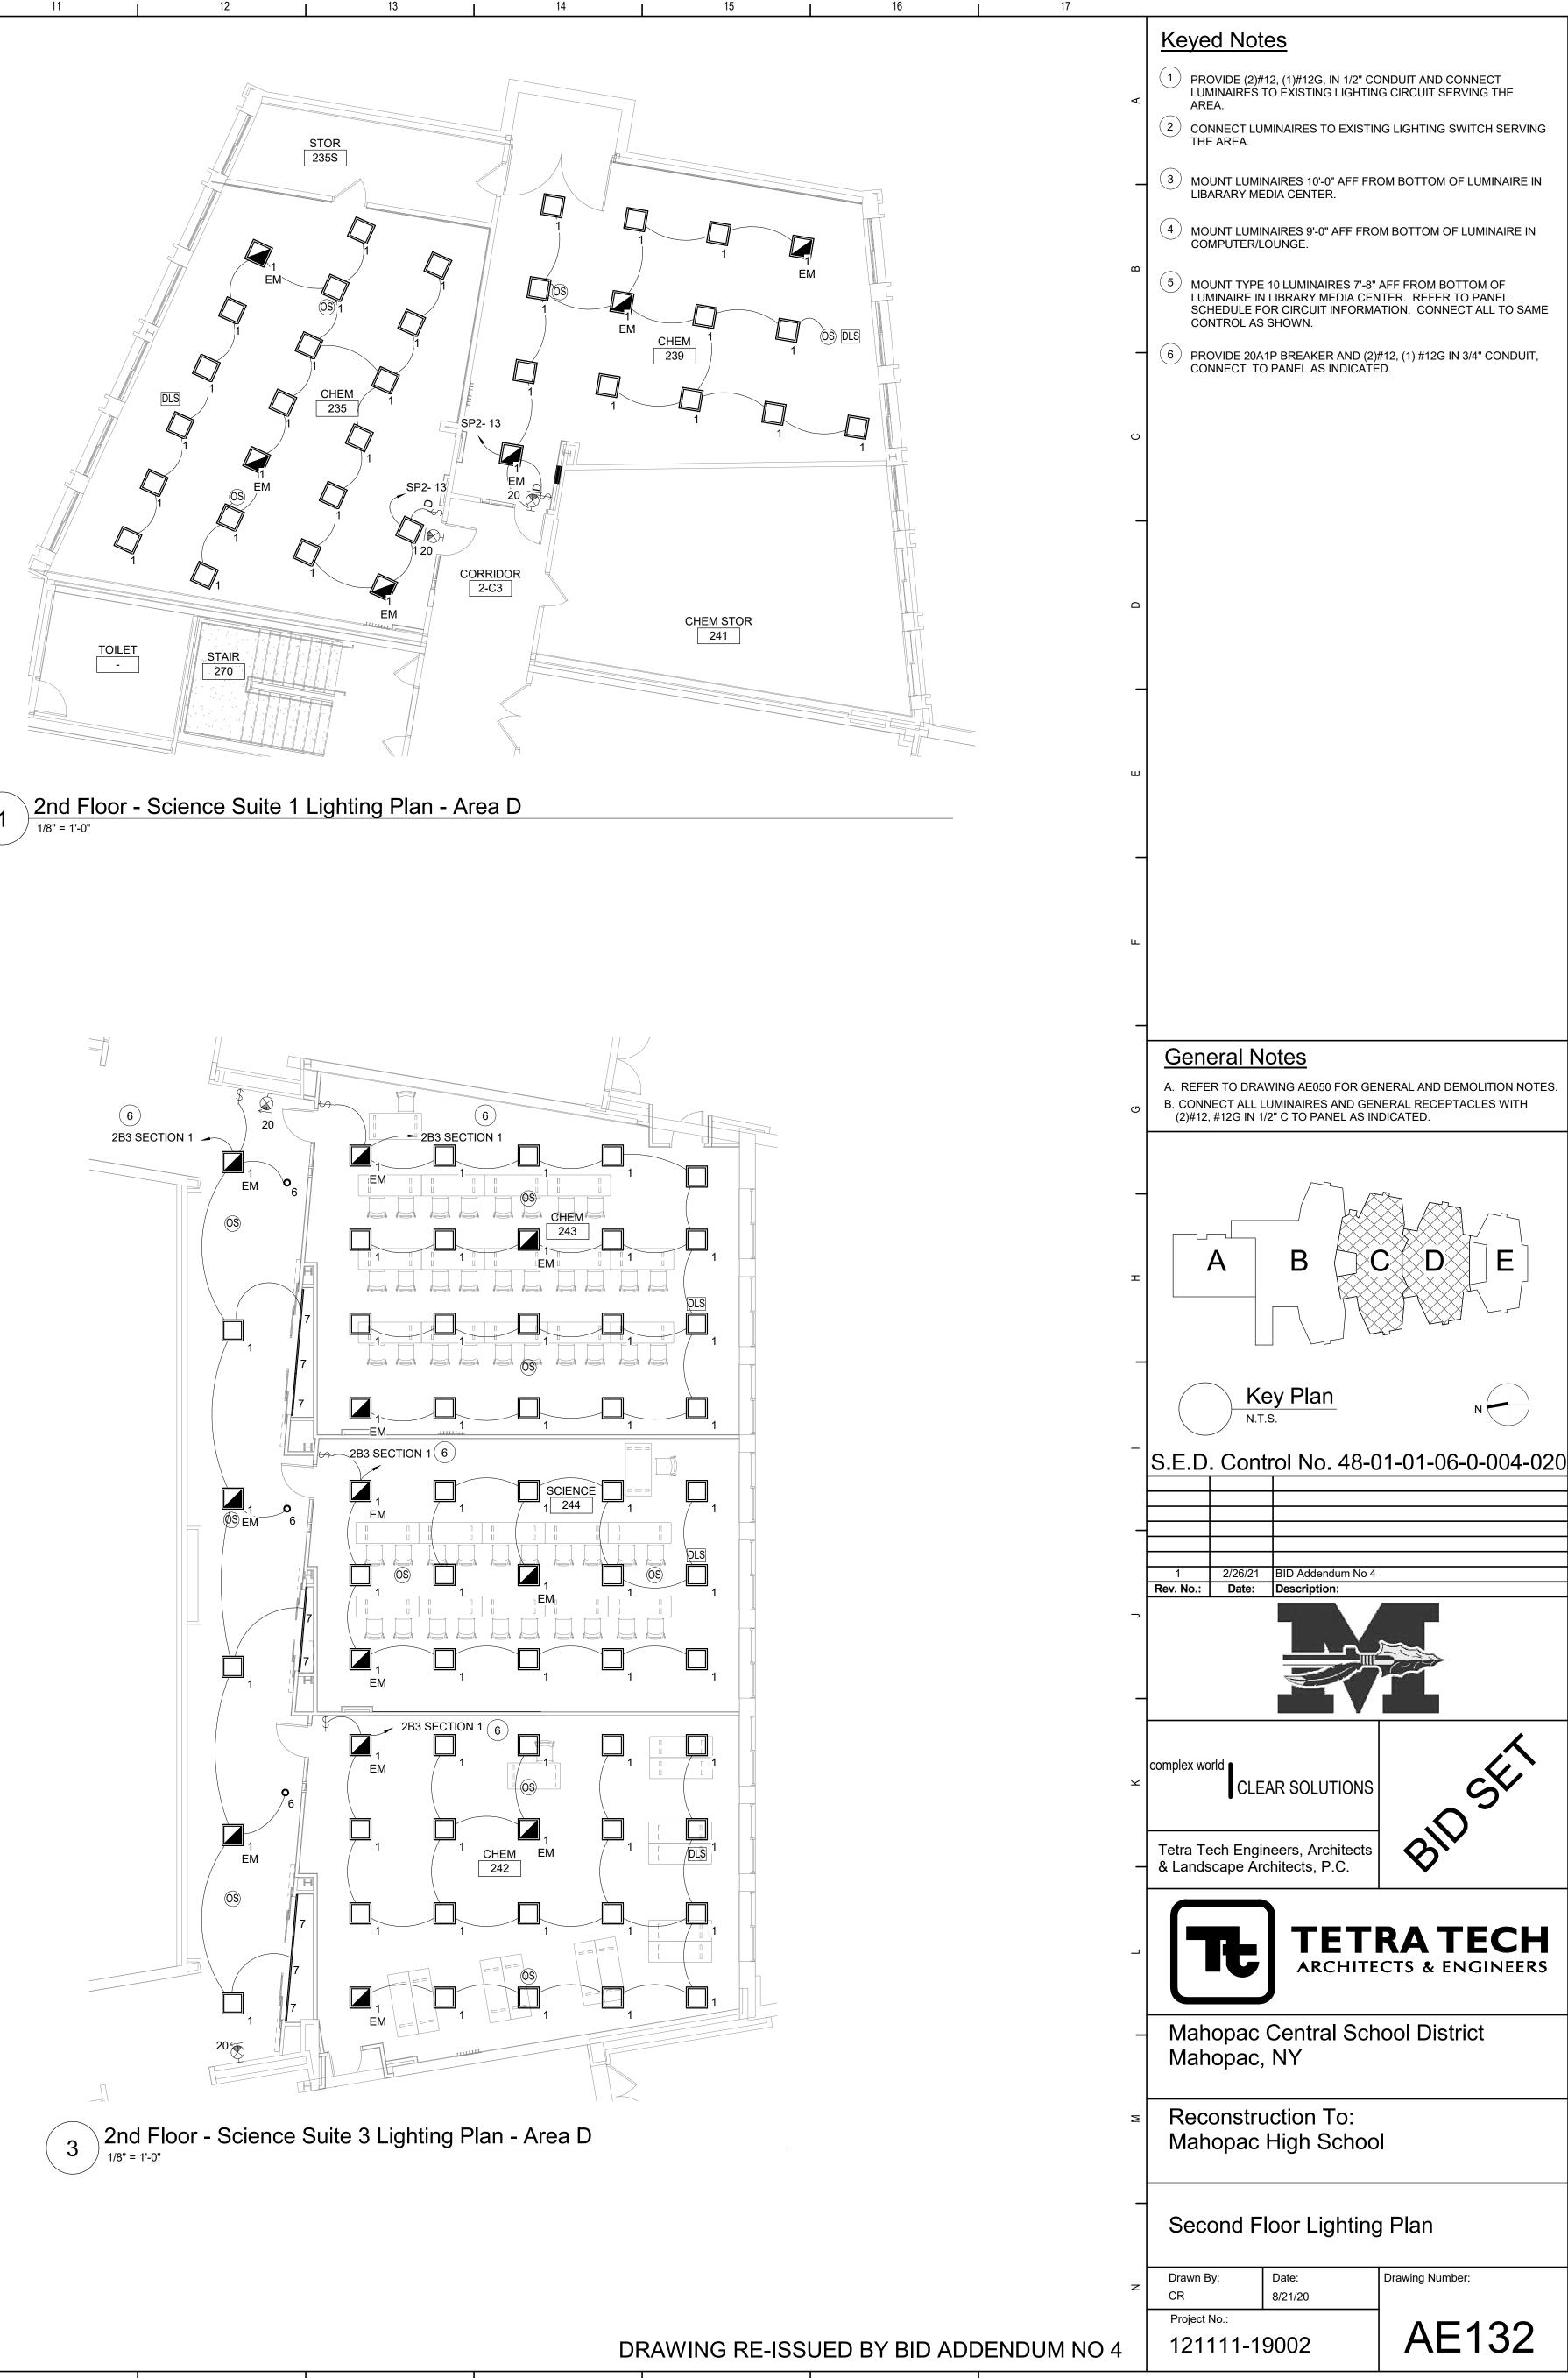

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SH2 SECTION 1 SH2 SECTION 2 SH2 SECTION 3	Basement	Serving	Recessed     12       Recessed     42	42 120/2 42 120/2	08/3P 400A	400A	- 10	Ж 2	8 4	2 2	2	1	1							
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BP MDP1	TBD Basement	TBD Meter Room 131	Surface         30           Floor         Switchboard St	30 120/2	08/3P 100A	100A		ж					3			8	4	**PROVIDE (6)30	0A 3P BREAKERS	
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1B3 1B4	1st Floor	Corridor outside 189 Rm Corridor outside 199 Rm	Recessed 42	54 120/2		400A	- 10	ЭК <u>36</u> ЭК 45		2 2	1 2									
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282 2B1 2B2	2nd Floor	Corridor outside 242 Rm	Recessed 36	36         120/2           30         120/2	08/3P 400A	400A	- 10	Ж 33			1									
2B2 2B3 SECTION 1	2nd Floor	Corridor outside 253 Rm	Recessed 30	42 120/2	08/3P 200A	-	200A 10	ж 38 ж 36	, 2											
2B3 SECTION 2 2B4	2nd Floor	Corridor outside 253 Rm	Recessed 42	42 120/2	08/3P 225A	225A	- 10	Ж 31	2				2							 
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ITEM	SYMBOL	2' X 2'	ITEM RECESSED TROFFER		4500	AIRES ARE 120V LAMPS	V TYPE LED	NAME SIGNIFY	MODEL 2FXP-45L-83	EQUAL)* OR SERIES 5-2-DS-UNV-DIM	NUMBER ARE PRO BASIS OF DESIGN	OVIDED TO S	EL HOW							
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ITEM	SYMBOL	2' X 2' 2' X 2' RECESS B 2.25" APEF	ITEM RECESSED TROFFER ED TROFFER WITH INTE	EGRAL	4500	AIRES ARE 120V LAMPS	V TYPE LED	NAME SIGNIFY	MODEL 2FXP-45L-83 2FXP-45L-83 E	EQUAL)* OR SERIES 5-2-DS-UNV-DIM 5-2-DS-UNV-DIM-	NUMBER ARE PRO BASIS OF DESIGN	OVIDED TO S								
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. NTS	SYMBOL	2' X 2' 2' X 2' RECESS B 2.25" APERATUF SUSPENDED LINEAF 2.25" X 4' AI DIFFUSER 2.25" X 4' AI DIFFUSER SUSPENDED LINEAF 2.25" X 4' APERATUF 2.25" X 4' APERATUF 2.25" X 4' APERATUF 3.5" DIAMET 3.5" DIAMET 4" DIAMETE 3.30" X 1.14" E 2.25"X 4' RECE	ITEM RECESSED TROFFER ED TROFFER WITH INTE ATTERY BACKUP RATURE WITH 12" BAFFLE ACC AND INTEGRAL BATTER PERATURE REGRESSED SURFACE MOUNT LINEAR PERATURE 1" REGRESSED SURFACE MOUNT LINEAR PERATURE 1" REGRESSED SURFACE MOUNT LINEAR AL BATTERY BACKUP ATURE SURFACE 1" DIFF ECESSED LINEAR URE WITH SUSPENDED LIN RE WITH SUSPENDED LIN RE WITH SUSPENDED LIN RE 12" CYLINDER PENDA R RECESSED DOWNLIG MSPLAY TASK LINEAR LIN	EGRAL EGRAL ELE COUSITIC ERY BACKUP D 1" EAR ED CWITH FUSER FUSER INEAR WITH DANT GHT IGHT	***ALL LUMINA LUMENS 4500 4500 1655 1655 1486 1486 1486 1486 1486 1486 1486 1486	AIRES ARE 120V LAMPS WATTAGE 42 42 42 4.6 4.6 4.6 4.6 4.6 4.6 4.6 4.6 4.6 4.6	V TYPE  LED  LED  LED  LED  LED  LED  LED  L	NAME SIGNIFY SIGNIFY FINELITE FINELITE FINELITE FINELITE FINELITE FINELITE INTENSE LIGHTING VODE LIGHTING	MODEL 2FXP-45L-83 2FXP-45L-83 E HP-2-B-P-D-4'-83 HP-2-B-P-D-4'-83 BS HP-2-SM-D-4-B-8 FC-109 HP-2-SM-D-4-B-8 FC-109 HP-2-SM-D-2-B-8 FC-109 HP-2-B-P-D-4'-83 BS MXPRD-TW2 4-R-N-Z4RDL-10 TO HP-2-R-D-4'-B-83 HP-2-R-D-4'-B-83	EQUAL)* OR SERIES -5-2-DS-UNV-DIM -5-2-DS-UNV-DIM- -5-2-DS-UNV-C4-FE -5-2-SCFC-10%-C4-FE -5-2-D10V1-WF-FR -5-3-SCFC-10%-C4-FE -5-2-D10V1-WF-FR -5-3-SC-W-O-CD-Z10-U -7-21-SL	NUMBER ARE PROBASIS OF DESIGN	S FOR LENG	SHOW							
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ITEM       ITEM       1 <td>SYMBOL</td> <td>2' X 2' 2' X 2' RECESS 2' X 2' RECESS 2.25" APERATUF 2.25" X 4' APERATUF 2.25" X 4' APERATUF 2.25" X 4' APERATUF 2.25" X 4' APERATUF 1NTEGI 2.25" X 4' APERATUF 1NTEGI 2.25" X 4' APERATUF 1NTEGI 3.5" DIAMETER 4" DIAMETER RECE 4" DIAMETER RECE</td> <td>ITEM RECESSED TROFFER ED TROFFER WITH INTE ATTERY BACKUP ATURE WITH 12" BAFFL IC SUSPENDED LINEAR REWITH 12" BAFFLE ACC AND INTEGRAL BATTER PERATURE REGRESSED SURFACE MOUNT LINEAR REACE MOUNT LINEAR REACE MOUNT LINEAR AL BATTERY BACKUP ATURE SURFACE 1" DIFF ECESSED LINEAR URE WITH SUSPENDED LIR REWITH SUSPENDED LIR RE 12" CYLINDER PENDA ER 12" CYLINDER PENDA R RECESSED DOWNLIG ISPLAY TASK LINEAR LIC 4' RECESSED LINEAR SSED LINEAR WITH INTE ATTERY BACKUP</td> <td>EGRAL EGRAL EGRAL CUSITIC ERY BACKUP D 1" EAR D 1" EAR D</td> <td>***ALL LUMINA LUMENS 4500 4500 1655 1655 1486 1486 1486 1486 1486 1488 1488 1488</td> <td>AIRES ARE 120V LAMPS WATTAGE 42 42 42 4.6 4.6 4.6 4.6 4.6 4.6 4.6 4.6 4.6 4.6</td> <td>V TYPE  TYPE  LED  LED  LED  LED  LED  LED  LED  L</td> <td>NAME SIGNIFY SIGNIFY FINELITE FINELITE FINELITE FINELITE FINELITE INTENSE LIGHTING INTENSE LIGHTING INTENSE LIGHTING FINELITE FINELITE FINELITE FINELITE SIGNIFY (LIGHTOLIER)</td> <td>MODEL 2FXP-45L-83 2FXP-45L-83 E HP-2-B-P-D-4'-83 HP-2-B-P-D-4'-83 HP-2-SM-D-4-B-8 FC-10% HR-2-SM-D-4-B-8 FC-10% HP-2-SM-D-2-B-8 FC-10% HP-2-SM-D-2-B-8 FC-10% HP-2-B-P-D-4'-83 BS MXPRD-TW2 4-R-N-Z4RDL-10 HP-2-R-D-4'-B-83 BS 4-R-N-Z4RDL-10 4-R-N-Z4RDL-10</td> <td>EQUAL)* OR SERIES 0-5-2-DS-UNV-DIM 5-2-DS-UNV-DIM- MLED -F-SC-FC-10%-C4-FE -5-F-SC-FC-10%-C4-FE -35-RG-D-120-SC- 6-C4-FE -35-RG-D-120-SC- 6-C4-FE -5-F-SCFC-10%-C4-FE -5-F-SCFC-10%-C4-FE -5-F-SCFC-10%-C4-FE -2-D10V1-WF-FR -835-W-O-CD-Z10-U -835-W-O-CD-Z10-U 0-835-W-O-CD-Z10-U 0-835-W-O-CD-Z10-U</td> <td>NUMBER ARE PROBASIS OF DESIGN</td> <td>S FOR LENG</td> <td>SHOW</td> <td></td> <td></td> <td></td> <td></td> <td></td> <td></td> <td></td>	SYMBOL	2' X 2' 2' X 2' RECESS 2' X 2' RECESS 2.25" APERATUF 2.25" X 4' APERATUF 2.25" X 4' APERATUF 2.25" X 4' APERATUF 2.25" X 4' APERATUF 1NTEGI 2.25" X 4' APERATUF 1NTEGI 2.25" X 4' APERATUF 1NTEGI 3.5" DIAMETER 4" DIAMETER RECE 4" DIAMETER RECE	ITEM RECESSED TROFFER ED TROFFER WITH INTE ATTERY BACKUP ATURE WITH 12" BAFFL IC SUSPENDED LINEAR REWITH 12" BAFFLE ACC AND INTEGRAL BATTER PERATURE REGRESSED SURFACE MOUNT LINEAR REACE MOUNT LINEAR REACE MOUNT LINEAR AL BATTERY BACKUP ATURE SURFACE 1" DIFF ECESSED LINEAR URE WITH SUSPENDED LIR REWITH SUSPENDED LIR RE 12" CYLINDER PENDA ER 12" CYLINDER PENDA R RECESSED DOWNLIG ISPLAY TASK LINEAR LIC 4' RECESSED LINEAR SSED LINEAR WITH INTE ATTERY BACKUP	EGRAL EGRAL EGRAL CUSITIC ERY BACKUP D 1" EAR D	***ALL LUMINA LUMENS 4500 4500 1655 1655 1486 1486 1486 1486 1486 1488 1488 1488	AIRES ARE 120V LAMPS WATTAGE 42 42 42 4.6 4.6 4.6 4.6 4.6 4.6 4.6 4.6 4.6 4.6	V TYPE  TYPE  LED  LED  LED  LED  LED  LED  LED  L	NAME SIGNIFY SIGNIFY FINELITE FINELITE FINELITE FINELITE FINELITE INTENSE LIGHTING INTENSE LIGHTING INTENSE LIGHTING FINELITE FINELITE FINELITE FINELITE SIGNIFY (LIGHTOLIER)	MODEL 2FXP-45L-83 2FXP-45L-83 E HP-2-B-P-D-4'-83 HP-2-B-P-D-4'-83 HP-2-SM-D-4-B-8 FC-10% HR-2-SM-D-4-B-8 FC-10% HP-2-SM-D-2-B-8 FC-10% HP-2-SM-D-2-B-8 FC-10% HP-2-B-P-D-4'-83 BS MXPRD-TW2 4-R-N-Z4RDL-10 HP-2-R-D-4'-B-83 BS 4-R-N-Z4RDL-10 4-R-N-Z4RDL-10	EQUAL)* OR SERIES 0-5-2-DS-UNV-DIM 5-2-DS-UNV-DIM- MLED -F-SC-FC-10%-C4-FE -5-F-SC-FC-10%-C4-FE -35-RG-D-120-SC- 6-C4-FE -35-RG-D-120-SC- 6-C4-FE -5-F-SCFC-10%-C4-FE -5-F-SCFC-10%-C4-FE -5-F-SCFC-10%-C4-FE -2-D10V1-WF-FR -835-W-O-CD-Z10-U -835-W-O-CD-Z10-U 0-835-W-O-CD-Z10-U 0-835-W-O-CD-Z10-U	NUMBER ARE PROBASIS OF DESIGN	S FOR LENG	SHOW							
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ITEM         ITEM         10		2' X 2' 2' X 2' RECESS 2 2 25" APERATUF 2 25" APERATUF 2 25" X 4' APERATUF 1 01FFUSER SU 2 25" X 4' APERATUF 1 01AMETER 4" DIAMETER RECE 4" DIAMETER RECE 1 01AMETER RECE 1 01AMETER RECE 1 01AMETER RECE 1 01AMETER RECE 1 01AMETER RECE 1 01AMETER RECE	ITEM RECESSED TROFFER ED TROFFER WITH INTE ATTERY BACKUP ATURE WITH 12" BAFFL IC SUSPENDED LINEAR REWITH 12" BAFFLE ACC AND INTEGRAL BATTER PERATURE REGRESSED SURFACE MOUNT LINEAR REACE MOUNT LINEAR REACE MOUNT LINEAR AL BATTERY BACKUP ATURE SURFACE 1" DIFF ECESSED LINEAR URE WITH SUSPENDED LIR REWITH SUSPENDED LIR RE 12" CYLINDER PENDA ER 12" CYLINDER PENDA R RECESSED DOWNLIG ISPLAY TASK LINEAR LIC 4' RECESSED LINEAR SSED LINEAR WITH INTE ATTERY BACKUP	EGRAL  EGRAL  CUSITIC ERY BACKUP  D 1" EAR  ED  TUSER  FUSER  INEAR WITH  ANT  GHT  IGHT  EGRAL  VNLIGHT  LIGHT WITH	***ALL LUMINA LUMENS 4500 4500 1655 1655 1486 1486 1486 1486 1488 1488 1488 1488	AIRES ARE 120V LAMPS WATTAGE 42 42 4.6 4.6 4.6 4.6 4.6 4.6 4.6 4.6 4.6 18 20 4.1 4.6 18 20 4.1 11 11 750	V TYPE  LED  LED  LED  LED  LED  LED  LED  L	NAME SIGNIFY SIGNIFY FINELITE FINELITE FINELITE FINELITE FINELITE FINELITE INTENSE LIGHTING INTENSE LIGHTING INTENSE LIGHTING FINELITE FINELITE SIGNIFY (LIGHTOLIER) NEMO LIGHTING	MODEL 2FXP-45L-83 2FXP-45L-83 E HP-2-B-P-D-4'-83 HP-2-B-P-D-4'-83 BS HP-2-SM-D-4-B-8 FC-10 HR-2-SM-D-4-B-8 FC-10 HP-2-B-P-D-4'-83 BS HP-2-B-P-D-4'-83 BS MXPRD-TW2 4-R-N-Z4RDL-10 TO HP-2-R-D-4'-B-83 BS MXPRD-TW2 4-R-N-Z4RDL-10 TO HP-2-R-D-4'-B-83 BS	EQUAL)* OR SERIES 0-5-2-DS-UNV-DIM 5-2-DS-UNV-DIM- MLED -F-SC-FC-10%-C4-FE F-SC-FC-10%-C4-FE 	NUMBER ARE PROBASIS OF DESIGN	ONLY.								
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NTS         ITEM         1         1         1         1         1         1         1         2         2EM         3         3EM         3A         4         4         4         4         4         4         5         6         7         8         8         8         9         9         9         9         9         9         9         9         9         9         9         9         9         9         10         20		2' X 2' 2' X 2' RECESS 2 25" APERATUF 2 25" APERATUF 2 25" X 4' APERATUF 2 25" X 4' APERATUF 2 25" X 4' APERATUF 2 25" X 4' APERATUF 1 2 25" X 4' APERATUF 1 2 25" X 4' APERATUF 1 3.5" DIAMET 2 25" X 4' APERATUF 1 3.5" DIAMET 4" DIAMETER 4" DIAMETER RECE 1 3 30" X 1.14" E 2 25"X 4' RECE 8 4" DIAMETER RECE 1 1 1 1 1 1 1 1 1 1 1 1 1 1 1 1 1 1 1	ITEM RECESSED TROFFER ED TROFFER WITH INTE ATTERY BACKUP RATURE WITH 12" BAFFL IC SUSPENDED LINEAR REWITH 12" BAFFLE ACC AND INTEGRAL BATTER PERATURE REGRESSED SURFACE MOUNT LINEAR PERATURE SURFACE 1" DIFF ECESSED LINEAR URE WITH SUSPENDED INEAR URE WITH SUSPENDED LINEAR RECESSED DOWNLIG R RECESSED DOWNLIG ISPLAY TASK LINEAR LIC 4' RECESSED LINEAR SSED LINEAR WITH INTE ATTERY BACKUP CESSED SHOWER DOWNL RATERY BACKUP	EGRAL	***ALL LUMINA LUMENS 4500 4500 1655 1655 1486 1486 1486 1486 1488 1488 1488 1488	AIRES ARE 120V LAMPS WATTAGE 42 42 42 4.6 4.6 4.6 4.6 4.6 4.6 4.6 4.6 18 20 4.1 4.6 18 20 4.1 11 11 750 2.5	V TYPE     LED     LED	NAME SIGNIFY SIGNIFY FINELITE FINELITE FINELITE FINELITE FINELITE FINELITE INTENSE LIGHTING INTENSE LIGHTING INTENSE LIGHTING FINELITE SIGNIFY (LIGHTOLIER) NEMO LIGHTING (SIGNIFY (CHLORIDE)	MODEL 2FXP-45L-83 2FXP-45L-83 2FXP-45L-83 EXP-45L-83 EXP-2-B-P-D-4'-83 HP-2-B-P-D-4'-83 HP-2-SM-D-4-B-8 FC-10% HP-2-SM-D-2-B-4 FC-10% HP-2-B-P-D-4'-83 BS MXPRD-TW2 HP-2-B-P-D-4'-83 BS MXPRD-TW2 HP-2-R-D-4'-B-83 BS MXPRD-TW2 HP-2-R-D-4'-B-83 BS A-R-N-Z4RDL-10 HP-2-R-D-4'-B-83 BS A-R-N-Z4RDL-10 A-R-N-Z4RDL-10 HP-2-R-D-4'-B-83 BS A-R-N-Z4RDL-10 A-R-N-Z4	EQUAL)* OR SERIES 0-2-DS-UNV-DIM 5-2-DS-UNV-DIM- 5-2-DS-UNV-DIM- 5-F-SC-FC-10%-C4-FI 3-F-SC-FC-10%-C4-FI 3-F-SC-FC-10%-C4-FI 3-F-SCFC-10%-C4-FI 3-F-SCFC-10%-C4-FI 5-F-SCFC-10%-C4-FI 2-2-D10V1-WF-FR 	NUMBER ARE PROBASIS OF DESIGN NOTE NOTE NOTE REFER TO PLAN REFER TO PLAN CO REFER TO PLAN SEE PLANS F	ONLY.	SHOW							

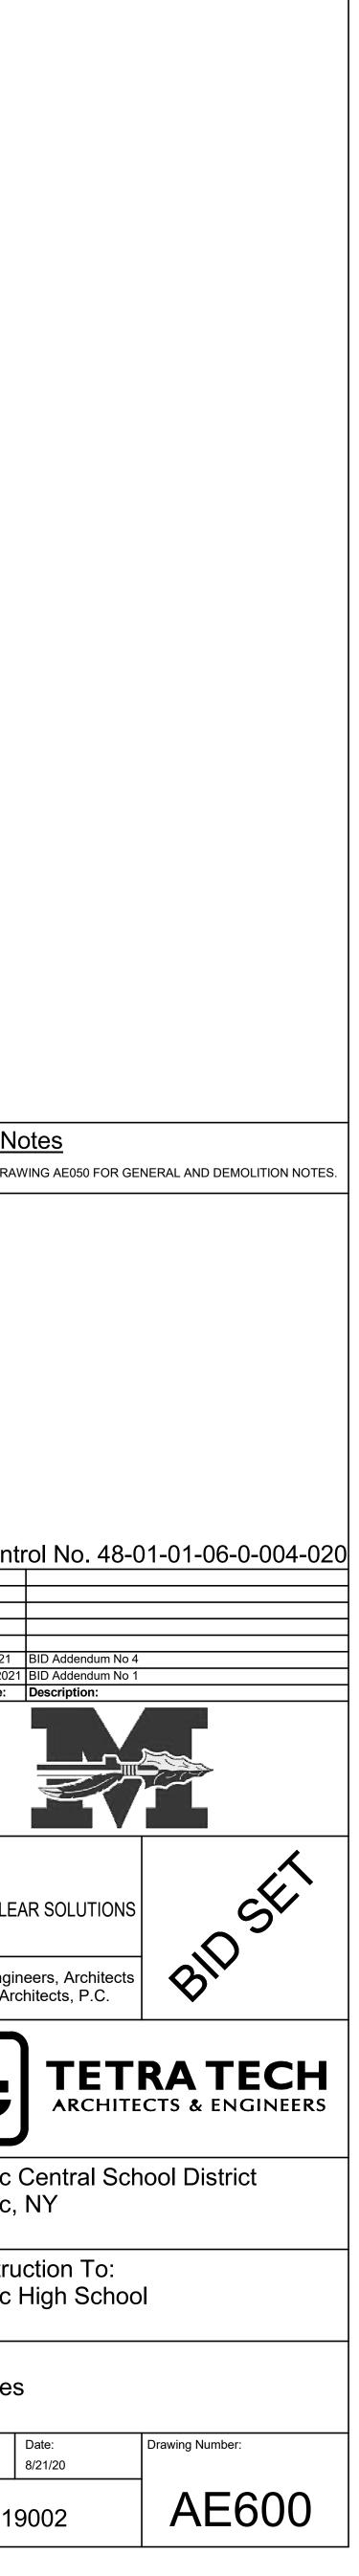

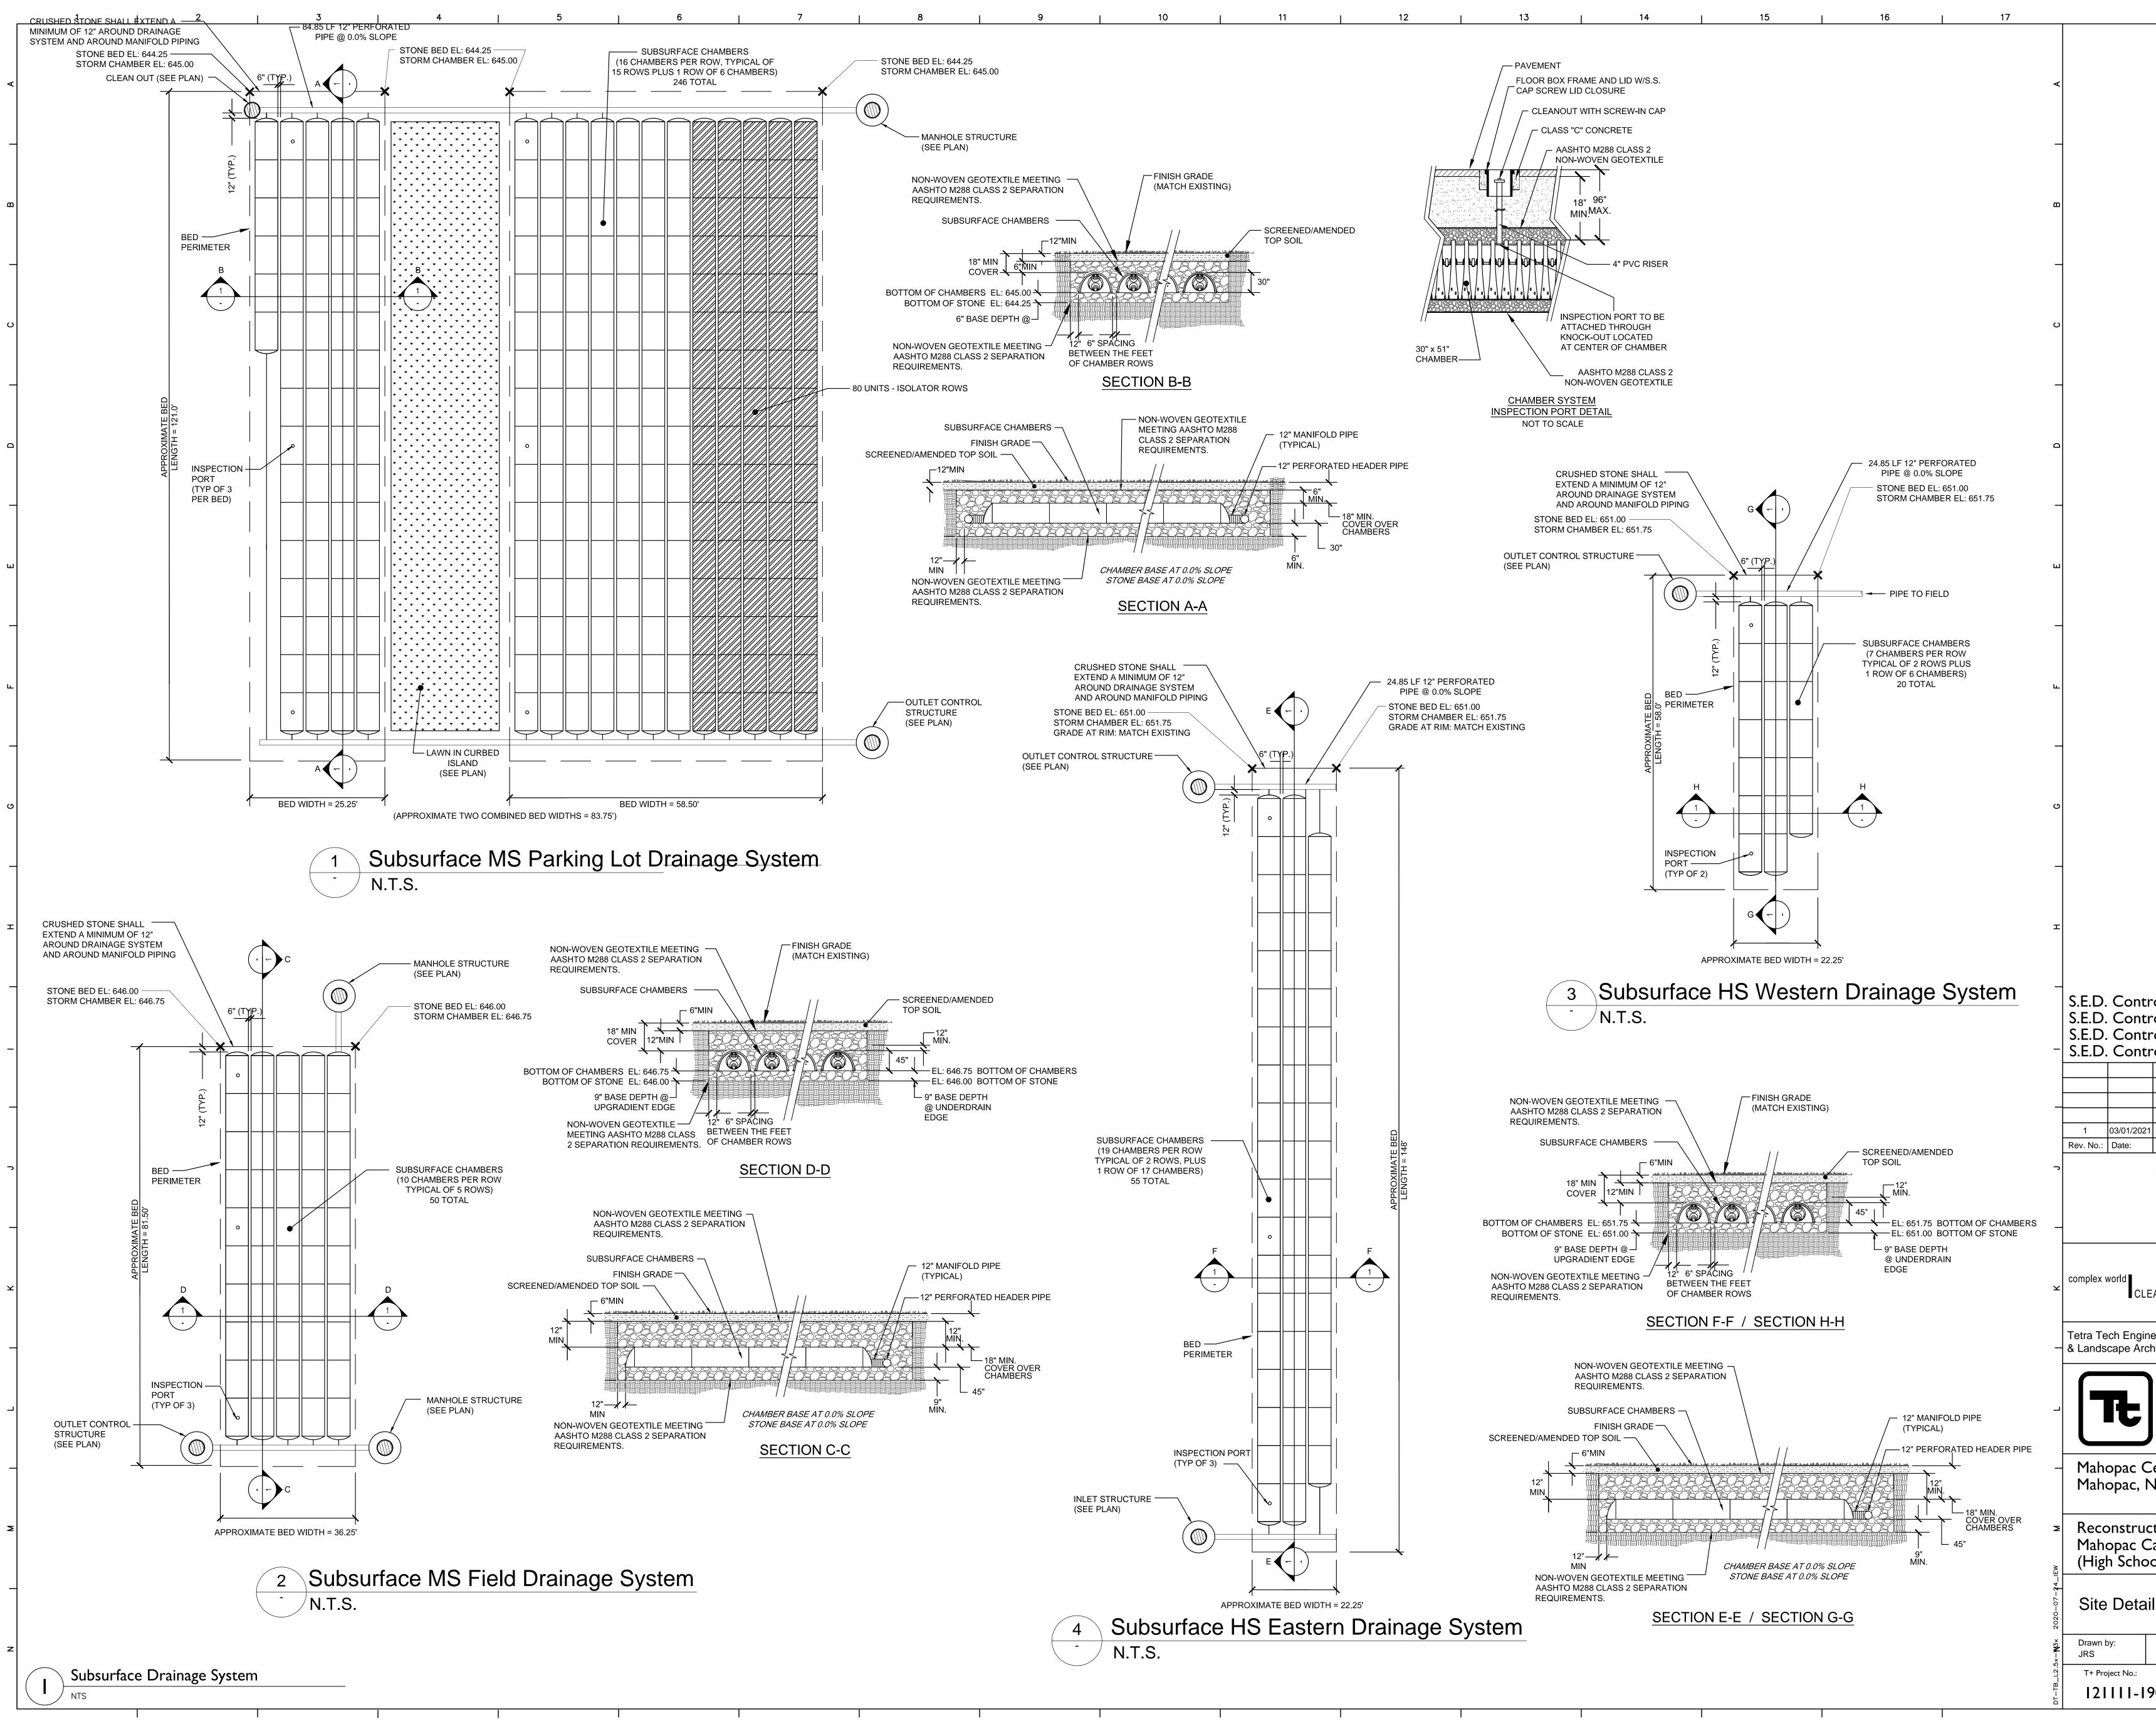

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ISSUED PER ADD           Description:	ENDUM #4
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