BULLETIN #04R

DATE:	March 11, 2025
TO:	Piazza Inc. Attn: Phil Pignatelli
CC:	Jordan Medina, Hill Intl.,
FROM:	Brian Dunn, AIA KG+D Architects, PC
PROJECT:	Harrison Recreation & Community Center – PHASE 2 Harrison, NY
RE:	Additional Work from Phase 1 to Phase 2 Contractor

Message:

The following represents additional Work that is required of the Phase 2 Contractor for items that require correction from Phase 1.

Upper Level Alterations:

The Drawing sheets referenced in this section only are contained in the Phase 1 Documents.

Phase 2 Contractor to provide proof rolling of structural base material per the Skylands report attached to confirm compaction and perform corrective measures, if necessary, based on third party observation of proof rolling. Contractor to provide 6" of gravel sub base at the slab on grade not shown on the Phase 2 Bid Documents. Refer to Bulletin 2 Skylands Engineering Letter.

Phase 2 Contractor to re-excavate the area to the north of the 6 wall and stockpile the removed Item 4 material installed by the Phase 1 Contractor for re-use. Phase 2 Contractor to re-excavate to the point where the Geotech engineer determines that the material meets compaction requirements, extending down to the level of the footings if necessary. Re-excavation to extend the length of the 6 wall footings up to and including where they step up to the SOG level at column lines A and G as shown on S-101. Extents of excavation going north of the 6 wall to be determined by the Geotech engineer. The intent is to limit the amount of excavation while maintaining the correct compaction. Phase 2 Contractor to remove the incorrectly installed storm drain pipe including the vertical pipe located adjacent to the A wall. Contractor to leave corrugated pipe stub penetrating the A wall once the 90 degree elbow is removed.

KG+D Architects, PC

285 Main Street, Mount Kisco, New York 10549 914.666.5900 kgdarchitects.com





Phase 2 Contractor to install the specified cast iron storm pipes as shown on the Phase 1 Documents with the appropriately pitched drain pipe behind the 6 wall as originally designed. Connect the cast iron piping to the in place corrugated pipe on the inside of the A wall with a Fernco coupling. Phase 2 Contractor to provide the drain piping as shown on M-001 with vertical drops located at the 6 wall penetrations. Phase 2 Contractor to remove the grouted in place pipes at the wall penetrations and replace with the sleeves shown on 3/M-701. If the in place backfill compaction allows for a shallower excavation the vertical drops can be sloped to drain to the main drain pipe to reduce the necessary excavation.

Lower Level Occupied Space Alterations:

Lower Level slab elevations raised from -12'-0" and -12'-6" below First Floor to 11'-6" below First Floor. Phase 2 Contractor to provide additional 6" of gravel below slab at all areas. Phase 2 Contractor to provide vapor barrier at all areas except Parking Area B01. Contractor to provide Domestic and Fire Service valves not installed in Phase 1. Ref Dwg Phase 1 M-101.

Parking Garage Alterations:

Provide 3 under slab drain pipes running east to west directly under the slab per the Skylands report dated February 5, 2025. Contractor to core the side of the trench drain to accept the added under slab drain pipes. Provide striping to replace the eliminated curb at the perimeter of the Parking area. Provide additional gravel below slab, 6" at occupied space and walkways and approximately 12" at the Parking Area. Contractor to delete the vapor barrier below the Parking Area only. Please note to the south of Stair B entrance ramp to pitch down to trench drain. Ref Dwg A 201.

Stair Alterations:

Stairs A, B, and D have been modified due to the change in slab elevation at the Lower Level. Contractor to increase the gravel base by 6" as noted above. The stairs contain one less riser and tread and the railing length has been reduced. Refer to Drawings A201 and A701.

General Alterations:

Correct anchor bolts where not within construction tolerances in 19 locations. Phase 2 Contractor to replace out of tolerance bolts per Structural recommendations.

Cc: File

Encl:

HARRISON RECREATION & COMMUNITY CENTER



DRAWING LIST

G-000	COVER SHEET	STRUCTU	RAL
		S-001	GENERAL S
GENERAL		S-100	LOWER LEV
G-100	EXISTING CONDITIONS & REMOVALS PLAN	S-101	FIRST FLOC
		S-201	FOUNDATIC
SURVEY		S-202	FOUNDATIC
V-001	TOPOGRAPHIC SURVEY	S-210	FOUNDATIC
		S-211	FOUNDATIC
CIVIL			
C-001	CONSTRUCTION NOTES & LEGENDS	ARCHITEC	TURAL
C-100	GRADING PLAN	A-200	LOWER LEV
C-101	LAYOUT PLAN	A-201	1st FLOOR F
C-200	UTILITIES PLAN	A-301	EXTERIOR E
C-300	EROSION & SEDIMENT CONTROL PLAN	A-302	EXTERIOR E
C-400	CONSTRUCTION DETAILS		
C-401	CONSTRUCTION DETAILS		
C-402	CONSTRUCTION DETAILS		
C-403	CONSTRUCTION DETAILS		
C-404	CONSTRUCTION DETAILS		
C-405	CONSTRUCTION DETAILS		
C-501	SITE DETAILS		

Town / Village of Harrison

270 Harrison Avenue Harrison, NY 10528

PHASE 1 - ISSUE FOR BID

STRUCTURAL NOTES EVEL FOUNDATION PLAN OOR FOUNDATION PLAN TION SCHEDULES AND TYPICAL DETAILS TION SCHEDULES AND TYPICAL DETAILS ION SECTIONS ION SECTIONS

EVEL PLAN & FOUNDATION DETAIL R PLAN - For Reference Only R ELEVATIONS - For Reference Only R ELEVATIONS - For Reference Only

MECHANICAL SYMBOLS, ABBREVIATIONS & NOTES PARKING FLOOR PLAN PHASE 1 M-101 FIRST FLOOR PLAN PHASE 1 M-102 MECHANICAL SITE PLAN M-201 M-202 ELECTRICAL SITE PLAN M-701 DETAILS Grand total: 32

JULY 12, 2023



SYSTEMS ENGINEER OLA Consulting Engineers, PC 50 Broadway - Suite 2 Hawthorne, NY 10532 phone: 914.747.2800

STRUCTURAL ENGINEER The Di Salvo Engineering Group 93 Lake Ave - Suite 201 Danbury, CT 06810 phone: 203.490.4140


CIVIL ENGINEER Woodard & Curran Engineering & Geological Services, PA, PC 800 Westchester Ave - Suite N507 Rye Brook, NY 10573 phone: 914.246.2931

KG+D Project No. 2020-1005 DESIGN TEAM

KG+D Architects, PC

Mount Kisco, NY 10549



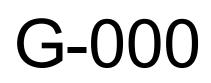


GENERAL NOTES:

- 1. THE CONTRACTOR IS CAUTIONED TO VERIFY ALL DIMENSIONS, GRADES AND EXISTING CONDITIONS AT THE SITE PRIOR TO ORDERING MATERIALS OR COMMENCING WORK. ALL DIMENSIONS SHOWN ARE APPROXIMATE ONLY.
- 2. LOCATIONS OF UNDERGROUND UTILITIES AND SUBSURFACE DRAINAGE SHOWN ARE APPROXIMATE ONLY. ALL EXISTING UTILITY LINES MAY NOT BE SHOWN ON THE DRAWINGS. IT IS THE CONTRACTOR'S RESPONSIBILITY TO IDENTIFY AND DETERMINE THE EXACT LOCATION OF ANY UTILITY OR DRAINAGE LINE THAT MAY BE ENCOUNTERED DURING CONSTRUCTION AND TO PROTECT ALL LINES INTENDED TO REMAIN.
- 3. THE CONTRACTOR SHALL IMMEDIATELY NOTIFY THE OWNER UPON DISCOVERY OF ANY UNDERGROUND UTILITY OR DRAINAGE LINE NOT SHOWN ON THE DRAWINGS.
- LIMIT OF WORK LINE (LOW) IS COINCIDENT WITH PROPERTY LINE UNLESS OTHERWISE SHOWN. EXTEND CONTRACT LIMIT LINE TO INCLUDE UTILITY WORK.
 THE CONTRACTOR SHALL BE RESPONSIBLE FOR RESTORING ALL CONSTRUCTION DAMAGE INSIDE AND OUTSIDE THE CONTRACT LIMITS TO THEIR ORIGINAL NEW CONDITION.
- 6. SOURCE OF BASE TOPOGRAPHIC DATA: EXISTING CONDITIONS TOPOGRAPHIC SURVEY BY TC MERRITTS LAND SURVEYORS LAST DATED FEBRUARY 18, 2019. NOTE THAT THE BUILDINGS SHOWN ON THE 2019 SURVEY ARE NOW REMOVED IN THEIR ENTIRETY AND KNOWN UTILITIES CAPPED.


REMOVALS NOTES:

- 1. IT IS THE RESPONSIBILITY OF THE CONTRACTOR TO COORDINATE WITH THE OWNER'S REPRESENTATIVE ON ALL MATERIALS TO BE REMOVED AND RECYCLED/DISPOSED OF OFF SITE. ALL HANDLING OF MATERIALS TO BE REMOVED, RECYCLED, OR DISPOSED OF MUST BE DONE SO IN A SAFE, LEGAL MANNER, IN ACCORDANCE WITH ALL LOCAL, COUNTY, STATE, FEDERAL AND ANY OTHER APPLICABLE REGULATIONS.
- 2. ALL ITEMS REQUIRING REMOVAL SHALL BE REMOVED TO FULL DEPTH TO INCLUDE BASE MATERIAL AND FOOTINGS OR FOUNDATIONS AS APPLICABLE UNLESS OTHERWISE NOTED.
- 3. EXISTING ITEMS INDICATED TO BE SALVAGED OR STOCKPILED SHALL BE CAREFULLY REMOVED AND STORED AS DIRECTED BY THE OWNER'S REPRESENTATIVE.
- 4. EVERY CONTRACTOR IS RESPONSIBLE FOR ANY DAMAGE INSIDE AND OUTSIDE THE LIMIT OF WORK DUE TO ITS CONTRACT OPERATIONS.
- 5. CONTRACTOR SHALL PROTECT AND SUSTAIN IN NORMAL SERVICE ALL EXISTING UTILITIES, STRUCTURES, EQUIPMENT, ROADWAYS AND DRIVEWAYS SURROUNDING THE WORK SITE.
- 6. CONTRACTOR SHALL INSTALL AND MAINTAIN NECESSARY TRAFFIC CONTROL DEVICES, DRUMS, DELINEATORS, SIGNS, FENCES, AND BARRICADES IN ACCORDANCE WITH THE LATEST EDITION OF THE NATIONAL MUTCD WITH NYS SUPPLEMENT TO PROPERLY PROTECT WORK, EQUIPMENT, PERSONS, AND PROPERTY FROM DAMAGE.
- 7. THE CONTRACTOR SHALL BE RESPONSIBLE FOR THE PROTECTION OF ALL EXISTING TREES AND PLANTS OUTSIDE THE LIMIT OF WORK FOR THE DURATION OF THE CONSTRUCTION PERIOD AND SHALL, AT A MINIMUM, INSTALL TREE PROTECTION FENCE AS SHOWN AND SPECIFIED. VEHICLES, EQUIPMENT OR MATERIALS SHALL NOT BE STORED WITHIN THE DRIP LINE OR WHERE DAMAGE MAY RESULT TO TREES TO BE SAVED.
- 8. AT ALL LOCATIONS WHERE EXISTING PAVEMENT ABUTS NEW CONSTRUCTION, THE EDGE OF THE EXISTING PAVEMENT SHALL BE SAW CUT TO A CLEAN, SMOOTH AND SHARP EDGE AND PROTECTED UNTIL ABUTTING MATERIALS ARE INSTALLED.
- EXISTING CURB TO BE REPLACED SHALL BE COMPLETELY REMOVED BETWEEN EXISTING EXPANSION JOINTS, EXCEPT FOR EXPANSION JOINT REINFORCING RODS WHICH MAY REMAIN IN PLACE.
- 10. LIMIT OF WORK LINE IS COINCIDENT WITH THE PERIMETER PROPERTY LINE. LIMIT OF WORK SHALL EXTEND TO INCLUDE OFF-SITE UTILITIES OR OTHER CONNECTIONS AS NECESSARY. WORK LIMIT / CONSTRUCTION FENCE SHALL BE RESTORED TO THE PERIMETER SHOWN AT THE END OF EVERY WORK DAY.
- 11. THE POST-DEMOLITION GRADING AND OTHER EXISTING CONDITIONS INFORMATION SHOWN ON THIS PLAN IS PROVIDED FOR BIDDING PURPOSES ONLY AND SHALL BE SUPERSEDED AND REPLACED BY AN AS-BUILT SURVEY NOT AVAILABLE AT THE TIME OF BIDDING BUT TO BE PROVIDED BY THE OWNER PRIOR TO BEGINNING OF PHASE 1 CONSTRUCTION. THE POST-DEMOLITION GRADING REPRESENTS THE GRADES AND STABILIZED CONDITIONS TO BE PRESENT AT THE CONCLUSION OF BUILDING DEMOLITION WORK UNDER A SEPARATE CONTRACT.

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HARRISON RECREATION & COMMUNITY CENTER New Construction - Phase 1 Town / Village of Harrison 270 Harrison Avenue Harrison, NY 10528
KG+D ARCHITECTS, PC 285 MAIN STREET • MOUNT KISCO, NEW YORK 10549 P:914.666.5900 KGDARCHITECTS.COM
CONSTRUCTION DOCUMENTS
NOTE: ALL IDEAS, DESIGNS, ARRANGEMENTS AND PLANS INDICATED OR REPRESENTED BY THIS DRAWING ARE OWNED BY AND ARE THE PROPERTY OF KG+D ARCHITECTS, PC (KG+D), AND WERE CREATED FOR USE ON THIS PROJECT. NONE OF SUCH IDEAS, DESIGNS, ARRANGEMENTS OR PLANS SHALL BE USED BY OR DISCLOSED TO ANY PURPOSE WHATSOEVER WITHOUT THE WRITTEN DIMENSIONS ON THIS DRAWING SHALL HAVE PRECEDENCE OVER SCALED DIMENSIONS ON THIS DRAWING SHALL HAVE PRECEDENCE OVER SCALED DIMENSIONS ON THE JOB AND THE ARCHITECT MUST BE NOTIFIED OF ANY VARIATIONS FROM DIMENSIONS AND CONDITIONS SHOWN. SHOP DETAILS MUST BE SUBMITTED TO THIS OFFICE FOR APPROVAL BEFORE PROCEEDING WITH FABRICATION. ALTERATIONS BY ANY PERSON, IN ANY WAY, OF ANY ITEM CONTAINED ON THIS DOCUMENT, UNLESS ACTING UNDER THE DIRECTION OF THE LICENSED ARCHITECT WHOSE PROFESSIONAL SEAL IS AFFIXED HERETO, IS A VIOLATION OF TITLE VII, SECT. 69.5 (b) OF NEW YORK STATE LAW. • COPYRIGHT KG+D ARCHITECTS, PC ALL RIGHTS RESERVED. Professional Seal
1 07/12/2023 ISSUE FOR BID - PHASE 1 No. Date Issue Sheet Title
CONDITIONS & CONDITIONS & REMOVALS PLANJob No. 2020-1005Date 07/12/2023Scale 1" = 20'Drawn / Checked Sheet NumberG-100

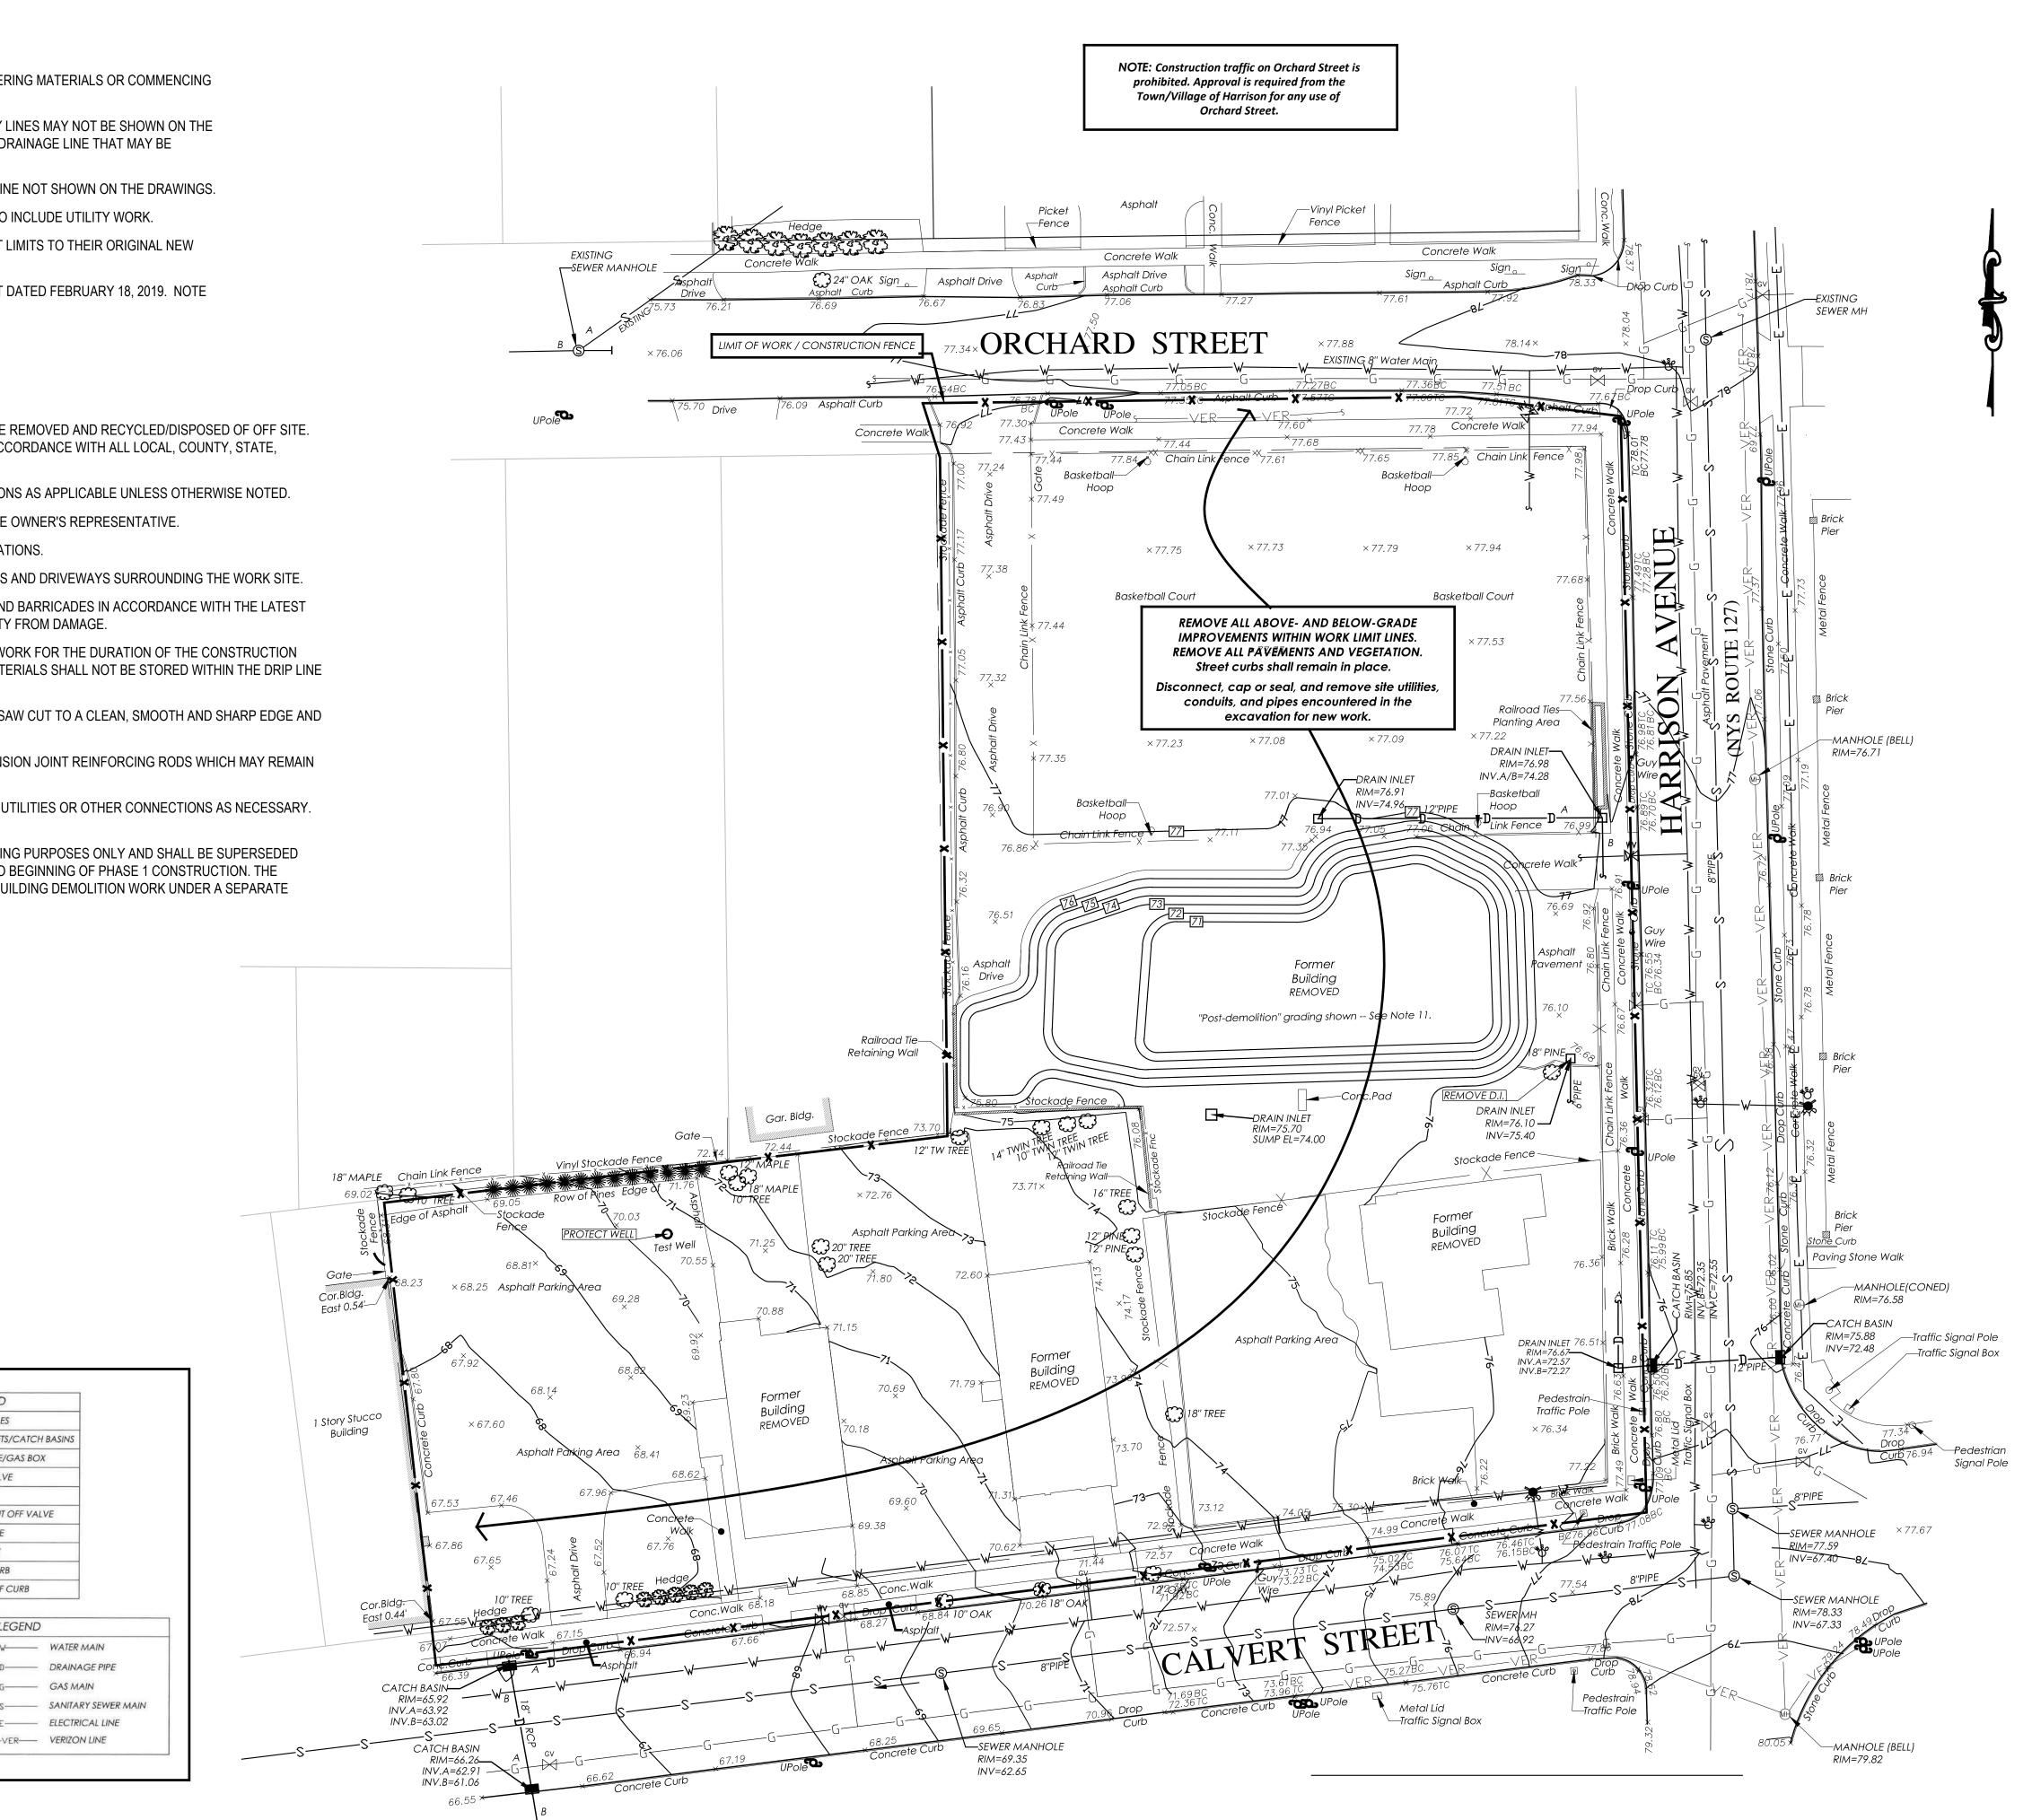

SITUATE IN THE TOWN OF HARRISON WESTCHESTER COUNTY, NEW YORK *SCALE:* 1'' = 20'GRAPHIC SCALE

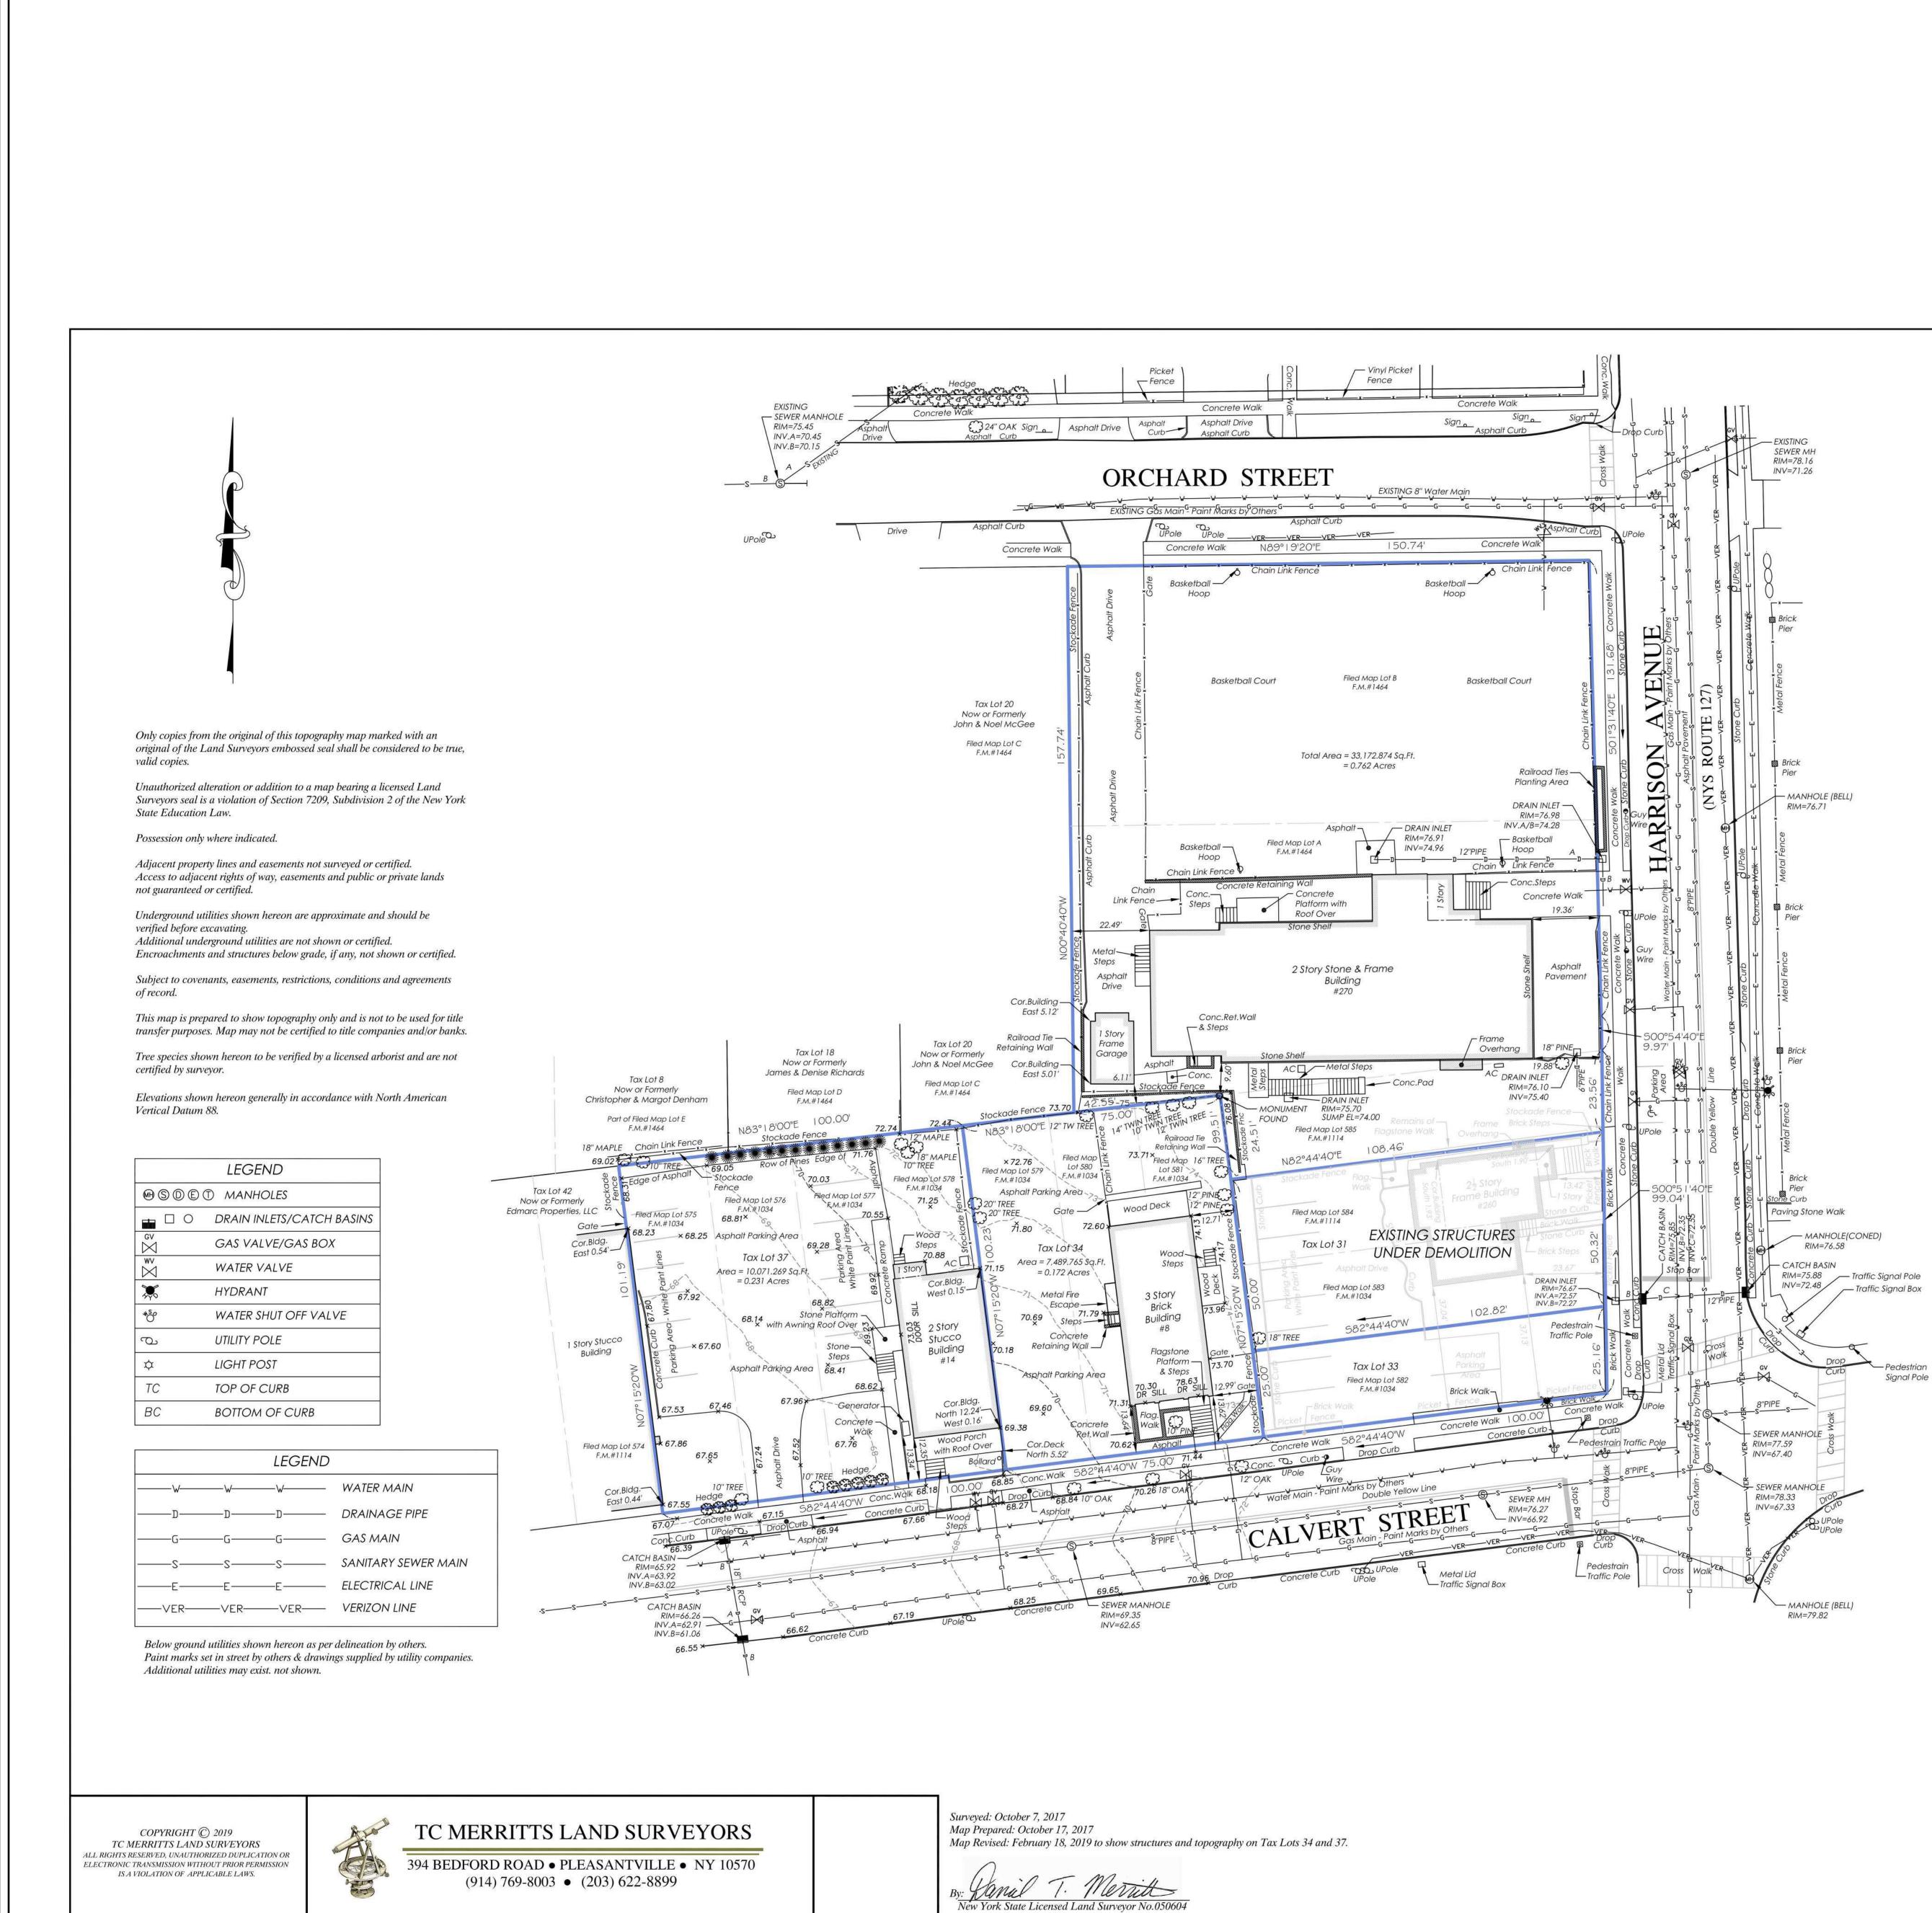(IN FEET)

1 inch = 20 ft.

Project: Ref.10-216 Field Survey By: 17-356 BC/CR

Checked By:

DM

Drawn By:

DA

TOPOGRAPHY OF PROPERTY PREPARED FOR TOWN OF HARRISON

Property Address: 14 Calvert Street Harrison, NY 10528

Premises shown hereon designated on the Town of Harrison Tax Maps as: Block 253, Lot 37.

TAXLOT 37 Premises hereon being Lots 575, 576, 577 and 578 as shown on a certain map entitled, "2nd Map of Brentwood Plaza." Said map filed in the Westchester County Clerk's Office, Division of Land Records July 27, 1892 as map number 1034.

Property Address: 8 Calvert Street Harrison, NY 10528

Premises shown hereon designated on the Town of Harrison Tax Maps as: Block 253, Lot 34.

Land Records July 27, 1892 as map number 1034. Surveyed in accordance with Deed Control Number 532243364.

TAX LOT 34 Premises hereon being Lots 579, 580 and 581 as shown on a certain map entitled, "2nd Map of Brentwood Plaza." Said map filed in the Westchester County Clerk's Office, Division of

Property Address: 270 Harrison Avenue Harrison, NY 10528

Premises shown hereon designated on the Town of Harrison Tax Maps as: Block 253, Lot 28.

Premises hereon being Lot 585 as shown on a certain map entitled, "4th Map of Brentwood Plaza." Said map filed in the Westchester County Clerk's Office, Division of Land Records May 31, 1894 as map number 1114. Premises hereon being Lots A and B as shown on a certain map entitled, "Map of Lots Belonging to Mary B. Purdy." Said map filed in the Westchester County Clerk's Office, Division of Land Records February 23, 1905 as map number 1464.

Property Address: 260 Harrison Avenue Harrison, NY 10528

Premises shown hereon designated on the Town of Harrison Tax Maps as: Block 253, Lots 31 and 33.


Surveyed in accordance with Deed Control Number 572483257.

Premises hereon being Lot 584 as shown on a certain map entitled, "4th Map of Brentwood Plaza." Said map filed in the Westchester County Clerk's Office, Division of Land Records May 31, 1894 as map number 1114.

TAX LOTS 31 AND 33 Premises hereon being Lots 582 and 583 as shown on a certain map entitled, "2nd Map of Brentwood Plaza." Said map filed in the Westchester County Clerk's Office, Division of Land Records July 27, 1892 as map number 1034.

Vicinity Map

TAX LOT 28

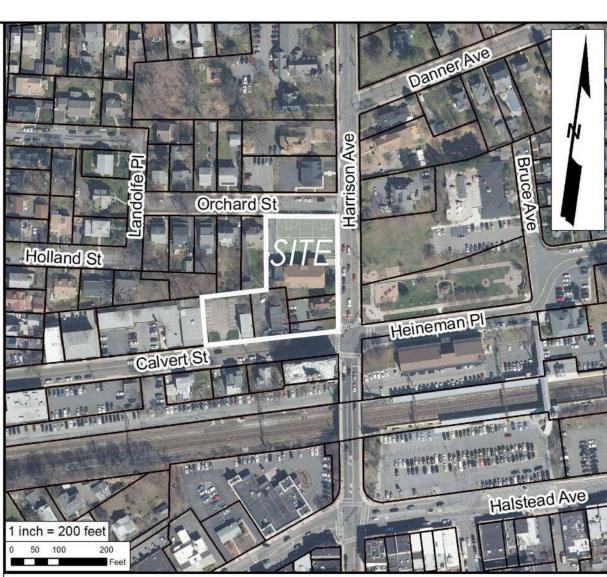

HARRISON **RECREATION &** COMMUNITY CENTER New Construction - Phase 1 Town / Village of Harrison 270 Harrison Avenue Harrison, NY 10528 KG+D ARCHITECTS, 285 MAIN STREET • MOUNT KISCO, NEW YORK 10549 P:914.666.5900 KGDARCHITECTS.COM CONSTRUCTION DOCUMENTS DTE: ALL IDEAS, DESIGNS, ARRANGEMENTS AND PLANS INDICATED OR RESENTED BY THIS DRAWING ARE OWNED BY AND ARE THE PROPERTY C ARCHITECTS, PC (KG+D), AND WERE CREATED FOR USE ON THIS OJECT. NONE OF SUCH IDEAS, DESIGNS, ARRANGEMENTS OR PLANS SHA SED BY OR DISCLOSED TO ANY PURPOSE WHATSOEVER WITHOUT THE EN PERMISSION OF KG+D. FEN DIMENSIONS ON THIS DRAWING SHALL HAVE PRECEDENCE OVER CALED DIMENSIONS. CONTRACTOR SHALL VERIFY ALL ACTUAL DIMENSIONS ID CONDITIONS ON THE JOB AND THE ARCHITECT MUST BE NOTIFIED OF AN TIONS FROM DIMENSIONS AND CONDITIONS SHOWN. SHOP DETAILS M SUBMITTED TO THIS OFFICE FOR APPROVAL BEFORE PROCEEDING WIT FERATIONS BY ANY PERSON, IN ANY WAY, OF ANY ITEM CONTAINED ON THIS CUMENT, UNLESS ACTING UNDER THE DIRECTION OF THE LICENSED HITECT WHOSE PROFESSIONAL SEAL IS AFFIXED HERETO, IS A VIOLATIC TITLE VII, SECT. 69.5 (b) OF NEW YORK STATE LAW. PYRIGHT KG+D ARCHITECTS, PC . RIGHTS RESERVED Professional Seal 3 07/12/2023 ISSUE FOR BID - PHASE 1 No. Date Issue Sheet Title TOPOGRAPHIC SURVEY Date Job No. 07/12/2023 2020-1005 Scale Drawn / Checked AS NOTED - -Sheet Number V-001

<u>GENERAL NOTES:</u>

- 1. EXISTING CONDITIONS SHOWN HEREON HAVE BEEN TAKEN FROM A FIELD SURVEY PREPARED BY TC MERRITTS LAND SURVEYORS, FOR THE TOWN OF HARRISON, WESTCHESTER COUNTY, NEW YORK, LAST REVISED FEBRUARY 18, 2019.
- 2. TC MERRITTS LAND SURVEYORS IS LOCATED AT THE FOLLOWING ADDRESS: 394 BEDFORD ROAD PLEASANTVILLE, NEW YORK 10570
- (914) 769–8003
- 3. EXISTING UTILITIES SHOWN ON THESE PLANS WERE COMPILED FROM A FIELD SURVEY PREPARED BY TC MERRITTS LAND SURVEYORS. THESE PLANS DO NOT NECESSARILY DEPICT THE EXACT LOCATIONS OF ALL UTILITIES, WHICH MAY EXIST AT THIS TIME WITHIN THE SURVEY LIMITS. THERE MAY BE EXISTING LINES OTHER THAN THOSE INDICATED. THE CONTRACTOR SHALL FIELD LOCATE ALL EXISTING UTILITIES USING GROUND PENETRATION RADAR (GPR) PRIOR TO THE START OF CONSTRUCTION. THE CONTRACTOR SHALL REPORT ANY DISCREPANCIES TO THE ENGINEER IN WRITING. THE CONTRACTOR SHALL CONTACT THE RESPECTIVE UTILITY COMPANIES RELATIVE TO THE LOCATIONS AND ELEVATIONS OF THESE LINES. NO SEPARATE OR ADDITIONAL COMPENSATION WILL BE ALLOWED TO THE CONTRACTOR DUE TO ANY VARIANCE BETWEEN THE DATA SHOWN ON THE PLANS AND ACTUAL FIELD CONDITIONS ENCOUNTERED. THE CONTRACTOR IS RESPONSIBLE FOR HIS/HER OWN DETERMINATION AS TO THE TYPE AND LOCATION OF THE EXISTING UTILITIES AS MAY BE NECESSARY TO AVOID THEIR DAMAGE AND TO FACILITATE THE PROPOSED CONNECTION(S).
- 4. LAND OUTSIDE THE PROPOSED LIMIT OF WORK SHALL NOT BE DISTURBED BY THE CONTRACTOR.
- 5. PRIOR TO CONSTRUCTION THE ENGINEER AND CONTRACTOR WILL REVIEW THE PERMITTED LIMITS OF WORK.
- 6. THE CONTRACTOR SHALL BE RESPONSIBLE FOR ESTABLISHING AND MAINTAINING ALL CONTROL POINTS AND BENCH MARKS NECESSARY FOR THE WORK.
- 7. CONTRACTOR SHALL BE RESPONSIBLE FOR ALL RELOCATIONS THAT CONFLICT WITH THE PROPOSED IMPROVEMENTS SHOWN ON THE SITE DRAWINGS, INCLUDING BUT NOT LIMITED TO ALL UTILITIES, STORM INFRASTRUCTURE, SIGNS, UTILITY POLES, FENCES, ETC. AS REQUIRED. ALL WORK SHALL BE IN ACCORDANCE WITH THE GOVERNING AUTHORITY'S SPECIFICATIONS AND SHALL BE APPROVED BY SUCH. ALL COSTS SHALL BE INCURRED BY THE CONTRACTOR.
- 8. THE CONTRACTOR SHALL CALL "DIG SAFELY. NEW YORK" AT 811 AT LEAST 72 HOURS PRIOR TO EXCAVATION IN ACCORDANCE WITH LOCAL, STATE AND FEDERAL SAFETY CODES.
- 9. THE CONTRACTOR SHALL COMPLY WITH ALL APPLICABLE LOCAL, STATE AND FEDERAL SAFETY CODES, REGULATIONS, LEGAL REQUIREMENTS, PERMIT CONDITIONS, ETC. PERMIT CONDITIONS RELATE TO THOSE OUTLINED IN THE NYSDEC (NEW YORK STATE DEPARTMENT OF ENVIRONMENTAL CONSERVATION) SPDES GENERAL PERMIT 0-20-001, AND ALL PERTINENT TOWN/VILLAGE OF HARRISON PERMITS.
- 10. THE CONTRACTOR SHALL TAKE ADEQUATE PRECAUTIONS TO PROTECT ALL WALKS, STREETS, PAVEMENTS, CURBING, TREES, PLANTINGS, LAWN, FENCING TO REMAIN ON OR OFF THE PREMISES, AND SHALL REPAIR AND REPLACE AT HIS/HER OWN EXPENSE AS DIRECTED BY THE ENGINEER ANY ITEMS DAMAGED AS A RESULT OF THE CONTRACTOR'S WORK.
- 11. THE CONTRACTOR SHALL PROVIDE ADEQUATE BRACING AND SHORING OF ALL EXCAVATIONS IN ACCORDANCE WITH THE REQUIREMENTS OF ALL GOVERNING CODES AND REGULATIONS.
- 12. ALL SURFACES TO REMAIN THAT ARE DISTURBED BY THIS WORK SHALL BE RESTORED TO THEIR ORIGINAL CONDITION, AS DETAILED, OR AS SPECIFIED BY THE ENGINEER.
- 13. SAWCUTS IN EXISTING PAVEMENT SHALL BE SMOOTH AND STRAIGHT.
- 14. WORK WITHIN PUBLIC RIGHT-OF-WAY SHALL COMPLY WITH APPLICABLE MUNICIPAL AND STATE REQUIREMENTS.
- 15. IF ANY EXISTING STRUCTURES TO REMAIN ARE DAMAGED DURING CONSTRUCTION IT SHALL BE THE CONTRACTOR'S RESPONSIBILITY TO REPAIR AND/OR REPLACE THE EXISTING STRUCTURE AS NECESSARY.
- 16. IF IMPORTED FILL MATERIAL IS REQUIRED, IT SHALL BE CERTIFIED IN WRITING BY A NEW YORK STATE LICENSED PROFESSIONAL ENGINEER AS NON-CONTAMINATED, CLEAN FILL SUITABLE FOR THE INTENDED USE. THE MATERIAL SHALL BE TESTED WITH THE ENVIRONMENTAL PARAMETERS AS OUTLINED IN THE PROJECT SPECIFICATIONS.
- 17. THIS PROJECT INCLUDES THE COMPLETION OF DEEP EXCAVATIONS TO COMPLETE THE WORK. THE CONTRACTOR IS RESPONSIBLE FOR COMPLETING ALL EXCAVATION WORK IN ACCORDANCE WITH ALL LOCAL, STATE AND FEDERAL REQUIREMENTS TO ENSURE WORKER AND PUBLIC SAFETY. SPECIAL NOTICE SHOULD BE TAKEN THAT THE CONTRACTOR IS RESPONSIBLE FOR THE COSTS OF DESIGN AND CONSTRUCTION OF ALL SYSTEMS REQUIRED TO COMPLETE EXCAVATIONS SUCH AS SHEETING AND SHORING SYSTEMS. THESE COSTS MUST BE INCLUDED IN THE BID.
- 18. CONTRACTOR SHALL PROVIDE ALL MAINTENANCE AND PROTECTION OF TRAFFIC LABOR AND EQUIPMENT AS REQUIRED AND SHALL OBTAIN ALL NECESSARY PERMITS AND APPROVALS IN ORDER TO COMPLETE THE WORK IN A SATISFACTORY AND SAFE MANOR.
- 19. WHENEVER AN ITEM OF MATERIAL, EQUIPMENT, CONSTRUCTION METHODS OR PROCEDURES IS SPECIFIED OR DESCRIBED IN THE CONTRACT/BIDDING DOCUMENTS BY USING THE NAME OF A PROPRIETARY ITEM. MAKE OR CATALOGUE NUMBER. OR THE NAME OF A PARTICULAR SUPPLIER, THE SPECIFICATION OR DESCRIPTION IS INTENDED TO ESTABLISH A STANDARD OF THE REQUIRED TYPE, FUNCTION, APPEARANCE, AND QUALITY REQUIRED TO BE MET BY ANY PROPOSED SUBSTITUTE OR "OR-EQUAL" ITEM. OTHER ITEMS OF MATERIAL OR EQUIPMENT OF OTHER SUPPLIERS MAY BE SUBMITTED TO AND CONSIDERED BY THE ENGINEER FOR REVIEW AS AN EQUAL OR SUBSTITUTE.

MATERIALS NOTES:

- 1. ALL FULL DEPTH PAVEMENT REPLACEMENT SHALL BE CONSTRUCTED IN ACCORDANCE WITH THE NEW YORK STATE DEPARTMENT OF TRANSPORTATION SPECIFICATIONS, LATEST REVISION.
- 2. ALL EXISTING PAVEMENT DEPICTED TO BE SAWCUT, SHALL BE MILLED 2 FEET FROM THE SAWCUT EDGE. SAWCUTS IN
- EXISTING PAVEMENT SHALL BE SMOOTH AND STRAIGHT. 3. EXISTING PAVEMENT TO BE REMOVED AROUND STRUCTURES SHALL BE SAWCUT 3 FEET FROM THE OUTSIDE WALL OF
- STRUCTURE AND RESURFACED 2 FEET BEYOND THE EDGE OF THE SAWCUT. 4. TOPSOIL FROM THE EXISTING SITE SHALL BE REUSED ON-SITE IN ALL AREAS REQUIRING TOPSOIL. THE CONTRACTOR SHALL NOT REMOVE ANY TOPSOIL FROM THE SITE PRIOR TO COMPLETION OF WORK, UNLESS PRIOR APPROVAL FROM THE OWNER/ENGINEER IS OBTAINED.
- 5. ALL FILL GENERATED FROM REQUIRED EXCAVATION ACTIVITY SHALL BE REUSED ON-SITE WHERE IT MEETS THE SPECIFICATIONS, TO THE MAXIMUM EXTENT POSSIBLE. REMOVE AND DISPOSE OF ALL EXCESS FILL MATERIAL GENERATED THAT IS NOT REQUIRED AND/OR SUITABLE TO COMPLETE THE WORK.

- - ACCORDINGLY.

GRADING AND DRAINAGE NOTES:

1. CASTINGS FOR EXISTING STRUCTURES TO REMAIN AND PROPOSED STRUCTURES SHALL BE SET TO THE PROPOSED ELEVATIONS SHOWN ON THE DRAWINGS.

2. THE FILLING OF SOIL OVER THE ROOTS OF TREES TO BE PRESERVED IS PROHIBITED. 3. SUITABLE SOIL MATERIALS ARE DEFINED AS THOSE COMPLYING WITH ASTM D2487 SOIL CLASSIFICATION

GROUPS GW, SM, SW AND SP AS STATED IN THE PROJECT SPECIFICATIONS. 4. UNSUITABLE FILL AND BACKFILL MATERIALS ARE MATERIALS CONTAINING EXCESSIVE AMOUNT OF WATER, PLASTIC, CLAY, VEGETATION, ORGANIC MATTER, DEBRIS, PAVEMENT, STONES OR BOULDERS OVER 3 INCHES IN GREATEST DIMENSION, FROZEN MATERIAL, AND MATERIAL WHICH, IN THE OPINION OF THE ENGINEER, WILL NOT PROVIDE A SUITABLE FOUNDATION OR SUBGRADE.

5. SUITABLE SOIL SHALL BE PLACED IN LAYERS TO THE REQUIRED ELEVATIONS AS SHOWN ON THE DRAWINGS. FILL, BACKFILL AND COMPACT TO PRODUCE MINIMUM SUBSEQUENT SETTLEMENT OF THE MATERIAL AND PROVIDE ADEQUATE SUPPORT FOR THE SURFACE TREATMENT OR STRUCTURE TO BE PLACED ON THE MATERIAL. PLACE MATERIAL IN APPROXIMATELY HORIZONTAL LAYERS OF BEGINNING AT LOWEST AREA TO BE FILLED. DO NOT IMPAIR DRAINAGE. DO NOT USE ON-SITE TOPSOIL AS FILL MATERIAL.

6. CONTRACTOR SHALL PLACE BACKFILL AND FILL MATERIALS IN LAYERS NOT MORE THAN (6) INCHES IN LOOSE DEPTH FOR MATERIAL COMPACTED BY HEAVY COMPACTION EQUIPMENT, AND NOT MORE THAN (4) INCHES IN LOOSE DEPTH FOR MATERIAL COMPACTED BY HAND-OPERATED TAMPERS. DO NOT PLACE BACKFILL OR FILL MATERIAL ON SURFACES THAT ARE MUDDY, FROZEN, OR CONTAIN FROST OR ICE.

7. FOR GROUND SURFACE PREPARATION, CONTRACTOR SHALL REMOVE VEGETATION, DEBRIS, UNSUITABLE SOIL MATERIALS, OBSTRUCTIONS, AND DELETERIOUS MATERIALS FROM GROUND SURFACE PRIOR TO PLACEMENT OF FILL. REMOVE MATERIAL TO THE FULL EXTENT OF ROOT PENETRATION. PROOF-ROLL EXISTING GROUND SURFACE PRIOR TO PLACEMENT OF FILL TO PROVIDE A DENSE, STABLE BASE FOR THE FIRST LIFTS OF THE STRUCTURAL FILL.

8. PRIOR TO CONSTRUCTION, COMPLETE CAMERA INSPECTION OF EXISTING STORM DRAINAGE PIPES ADJACENT TO THE PROJECT AS SHOWN ON THE DRAWINGS.

9. PRIOR TO THE START OF CONSTRUCTION, CONTRACTOR SHALL HAND DIG TEST PITS TO VERIFY THE LOCATION OF ALL EXISTING UNDERGROUND UTILITIES. CONTRACTOR SHALL VERIFY LOCATION AND ELEVATION OF ALL EXISTING UTILITIES AT PROPOSED UTILITY CROSSINGS, AND ADVISE THE ENGINEER IN WRITING OF ANY DISCREPANCIES.

10. ALL PROPOSED UTILITIES AND THEIR CONNECTIONS, DISCONNECTION AND RELOCATION OF EXISTING UTILITIES SHALL BE COMPLETED IN ACCORDANCE WITH THE REQUIREMENTS OF THE UTILITY COMPANY HAVING JURISDICTION. ANY COORDINATION WITH THE MUNICIPALITY AND/OR UTILITY COMPANY, PERMITS OR APPROVALS REQUIRED SHALL BE THE RESPONSIBILITY OF THE CONTRACTOR.

11. AT NO TIME SHALL THE CONTRACTOR DISTURB MORE THAN 5 ACRES AT ANY ONE TIME WITHOUT WRITTEN APPROVAL FROM AUTHORITIES HAVING JURISDICTION. THE CONTRACTOR SHALL SEQUENCE THE WORK

MEASURE	DATES FOR USE	TIMING, ACTIVITY, AND LOCATION
SILT FENCE/ CONSTRUCTION FENCE	ALL	CONTRACTOR TO INSTALL CONSTRUCTION AND SILT FENCE PRIOR TO THE START OF ANY EXCAVATION AND/OR FILLING ON THE SITE. SILT FENCE SHALL BE INSTALLED AS SHOWN ON THE EROSION AND SEDIMENT CONTROL PLAN AND DETAIL SHEETS, AND SHALL BE MAINTAINED IN EFFECTIVE OPERATING CONDITION THROUGHOUT THE CONSTRUCTION PROCESS. ALL STOCKPILES OF DIRT SHALL BE RIMMED WITH SILT FENCE IN ADDITION TO BEING TEMPORARILY SEEDED. DAMAGED SECTIONS OF SILT FENCE SHALL BE REPLACED IMMEDIATELY. FENCING SHALL BE REMOVED ONLY AFTER ALL CONSTRUCTION HAS BEEN COMPLETED AND ALL AREAS HAVE BEEN PERMANENTLY STABILIZED.
INLET PROTECTION	ALL	SHORT TERM PROTECTION OF CATCH BASIN INLETS. ALL EXISTING AND PROPOSED CATCH BASINS SHALL BE PROTECTED WITH INLET PROTECTION INSTALLED BY THE CONTRACTOR AS DETAILED, AND SHALL BE REPLACED AS NECESSARY. INLET PROTECTION SHALL REMAIN IN ALL STRUCTURES UNTIL THE SITE HAS BEEN PERMANENTLY STABILIZED.
DUST CONTROL	ALL	DURING DRY WEATHER, FOR AREAS OF EXPOSED SOIL WHERE IT IS NOT FEASIBLE TO ESTABLISH TEMPORARY GROUND COVER DUE TO CONSTRUCTION OPERATIONS, THE CONTRACTOR SHALL WET AREAS WITH WATER AT LEAST TWICE A DAY IN ORDER TO CONTROL DUST. THE MOISTENING OF SUCH AREAS MAY BE INCREASED TO FOUR TIMES A DAY DURING PERIODS OF LITTLE RAIN AS DETERMINED BY THE ENGINEER AND/OR THE CONTRACTOR.
TEMPORARY SEEDING	ALL	CONTRACTOR SHALL TEMPORARILY SEED ALL EXPOSED AREAS OF SOIL THAT WILL NOT RECEIVE PERMANENT SURFACE TREATMENT IMMEDIATELY (WITHIN SEVEN DAYS) AND ALL PILES OF DIRT AND SOIL STOCKPILES. GRASS SEED MIX FOR EROSION AND SEDIMENT CONTROL MAY BE APPLIED BY EITHER MECHANICAL OR HYDROSEEDING METHODS. HYDROSEEDING SHALL BE PERFORMED IN ACCORDANCE WITH THE AMERICAN ASSOCIATION OF NURSERYMAN, AMERICAN STANDARD FOR NURSERY STOCK, LATEST EDITION. SEEDING RATES AND DATES OF APPLICATION SHALL BE DETERMINED AS FOLLOWS.
	APRIL 1–JULY 1 AUGUST 15–SEPT. 15	<u>SEED MIXTURE:</u> 0ATS <u>APPLIED RATE:</u> 1.8 LBS/1,000 S.F.
	APRIL 1-JULY 1	<u>SEED MIXTURE:</u> ANNUAL RYEGRASS <u>APPLIED RATE:</u> 0.9 LBS/1,000 S.F.
	MAY 15- AUGUST 15	<u>SEED MIXTURE:</u> SUDANGRASS <u>APPLIED RATE:</u> 0.9 LBS/1,000 S.F.
	SEPTEMBER 15- OCTOBER 15	<u>SEED MIXTURE:</u> WINTER RYE <u>APPLIED RATE:</u> 2.6 LBS/1,000 S.F.
MULCH	APRIL 1 – NOVEMBER 30	ON ALL AREAS OF EXPOSED SOIL WHICH WILL NOT BE DISTURBED AGAIN WITHIN 7 DAYS, APPLY AT A RATE OF 1.5 TO 2.0 TONS PER ACRE.
WINTER MULCH	DECEMBER 1 – MARCH 31	ON ALL AREAS OF EXPOSED SOIL WHICH WILL NOT BE DISTURBED AGAIN WITHIN 7 DAYS, APPLY AT A RATE OF 3.0 TO 4.0 TONS PER ACRE EROSION CONTROL BLANKET MAY BE USED AS A SUBSTITUTE FOR WINTER MULCH.
EROSION CONTROL BLANKET	ALL	INSTALL IMMEDIATELY FOLLOWING SEEDING, WITHIN DRAINAGE CHANNELS AND ON ALL EXPOSED SOIL SLOPES WHICH ARE 25% OR STEEPER GRADE, AND LOCATIONS SHOWN ON PLAN. ECB MAY ALSO BE SUBSTITUTED FOR WINTER MULCH.
INSPECTIONS	UNTIL SITE IS PERMANENTLY STABILIZED	ALL EROSION AND SEDIMENT CONTROL MEASURES SHALL BE INSPECTED BY THE CONTRACTOR IMMEDIATELY AFTER EACH RAINFALL EVENT AND AT LEAST DAILY DURING PROLONGED RAINFALL. ANY REQUIRED REPAIRS SHALL BE MADE BY THE CONTRACTOR. SEDIMENT DEPOSITS SHALL BE REMOVED BY THE CONTRACTOR WHE THEY REACH APPROXIMATELY ONE—THIRD THE HEIGHT OF THE SILT FENCE. SEDIMENTS SHALL BE DISPOSED OF IN A MANNER THAT DOES NOT RESULT IN ADDITIONAL EROSION OR POLLUTION.
SCHEDULE O	F PERMANE	NT EROSION CONTROL MEASURES:
MEASURE	DATES FOR USE	TIMING, ACTIVITY, AND LOCATION
PAVEMENT – BASE COURSE/ FINAL COURSE	WHEN OUTSIDE AMBIENT TEMP. IS ABOVE 40°F	INSTALL ONLY IN AREAS SHOWN ON THE PLAN, SHORTLY AFTER PAVEMENT BASE IS BROUGHT TO FINAL GRADE. INSTALL NEAR COMPLETION OF PROJECT.
PERMANENT SEEDING	APRIL 15 TO SEPT. 15	ON FINAL GRADE AREAS, WITHIN 10 DAYS OF FINAL GRADE PREPARATION. PREPARE TOPSOIL, FOLLOWED WITH SEEDING AND MULCH APPLICATION. PERMANENT VEGETATION MUST BE SEEDED OR SODDED ON ALL EXPOSED AREAS. MULCH MUST BE USED AS NECESSARY FOR PROTECTION, UNTIL SEEDING IS ESTABLISHED.
DORMANT SEEDING	SEPT. 16 TO APRIL 15	ON FINAL GRADE AREAS, WITH PREPARED TOPSOIL. APPLY SEED AT DOUBLE THE SPECIFIED RATE, ON BARE SOIL, AND FOLLOW WITH AN APPLICATION OF WINTER MULCH.
GROUND COVER, TREES, SHRUBS	APRIL 15 TO NOV. 1	INSTALL WITH FINAL LANDSCAPING.
PERMANENT MULCH	ALL	INSTALL WITH FINAL LANDSCAPING.

MULCH NOTES:

1. ALL PROPOSED EROSION AND SEDIMENT CONTROL MEASURES SHALL BE INSTALLED AS INDICATED ON THE PLANS. AND IN ACCORDANCE WITH THE NEW YORK STATE DEPARTMENT OF ENVIRONMENTAL CONSERVATION (NYSDEC) "NEW YORK STATE STANDARDS AND SPECIFICATIONS FOR EROSION AND SEDIMENT CONTROL," LATEST REVISION. 2. ADDITIONAL SOIL STABILIZATION WILL BE REQUIRED IF THERE IS THE POSSIBILITY OF WIND EROSION.

3. SEDIMENT AND DEBRIS DROPPED, WASHED, SPILLED OR TRACKED ONTO PUBLIC OR PRIVATE ROADWAYS OR OTHER HARDSCAPE SURFACES SHALL IMMEDIATELY BE REMOVED.

CONTRACTOR CERTIFICATION STATEMENT:

New York State Department of Environmental Conservation (NYSDEC) **SPDES General Permit for** Stormwater Discharges from **CONSTRUCTION ACTIVITY** Permit No. GP-0-20-001 **CONTRACTOR CERTIFICATION STATEMENT**

Project Address: Harrison Recreation & Community Center 270 Harrison Avenue Harrison, NY 10528

Date: _____

Certification Statement:

"I hereby certify under penalty of law that I understand and agree to comply with the terms and conditions of the SWPPP and agree to implement any corrective actions identified by the qualified inspector during a site inspection. I also understand that the owner or operator must comply with the terms and conditions of the most current version of the New York State Pollutant Discharge Elimination System ("SPDES") general permit for stormwater discharges from construction activities and that it is unlawful for any person to cause or contribute to a violation of water quality standards. Furthermore, I am aware that there are significant penalties for submitting false information, that I do not believe to be true, including the possibility of fine and imprisonment for knowing violations." Signature: _____

	Name (Print): Title:	
Contracting Firm: Address:		
Telephone:		

SUBCONTRACTOR CERTIFICATION STATEMENT:

SPDES General Permit for Stormwater Discharges from **CONSTRUCTION ACTIVITY** Permit No. GP-0-20-001 SUBCONTRACTOR CERTIFICATION STATEMENT

Project Address: <u>Harrison Recreation & Community Center</u> 270 Harrison Avenue Harrison, NY 10528

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violations.		
Contracting Firm:		
Address:		
Telephone:	 	

COLLEDULE OF TENDODADY EDOCION CONTROL MEACUDES

New York State Department of Environmental Conservation (NYSDEC)

---- PROPERTY LINE EXISTING CURB -0-V \bigcirc -\$<u></u> 30" STORM _____n_____ ---23 --- EXISTING CONTOUR ×22.6

----- EXISTING EDGE OF PAVEMENT EXISTING RETAINING WALL EXISTING SIGN EXISTING UTILITY POLE EXISTING FIRE HYDRANT EXISTING MANHOLE EXISTING CATCH BASIN (TYP.) EXISTING LIGHT POLE EXISTING STORM LINE AND SIZE EXISTING SANITARY SEWER EXISTING SPOT GRADE EXISTING FEATURE TO BE REMOVED

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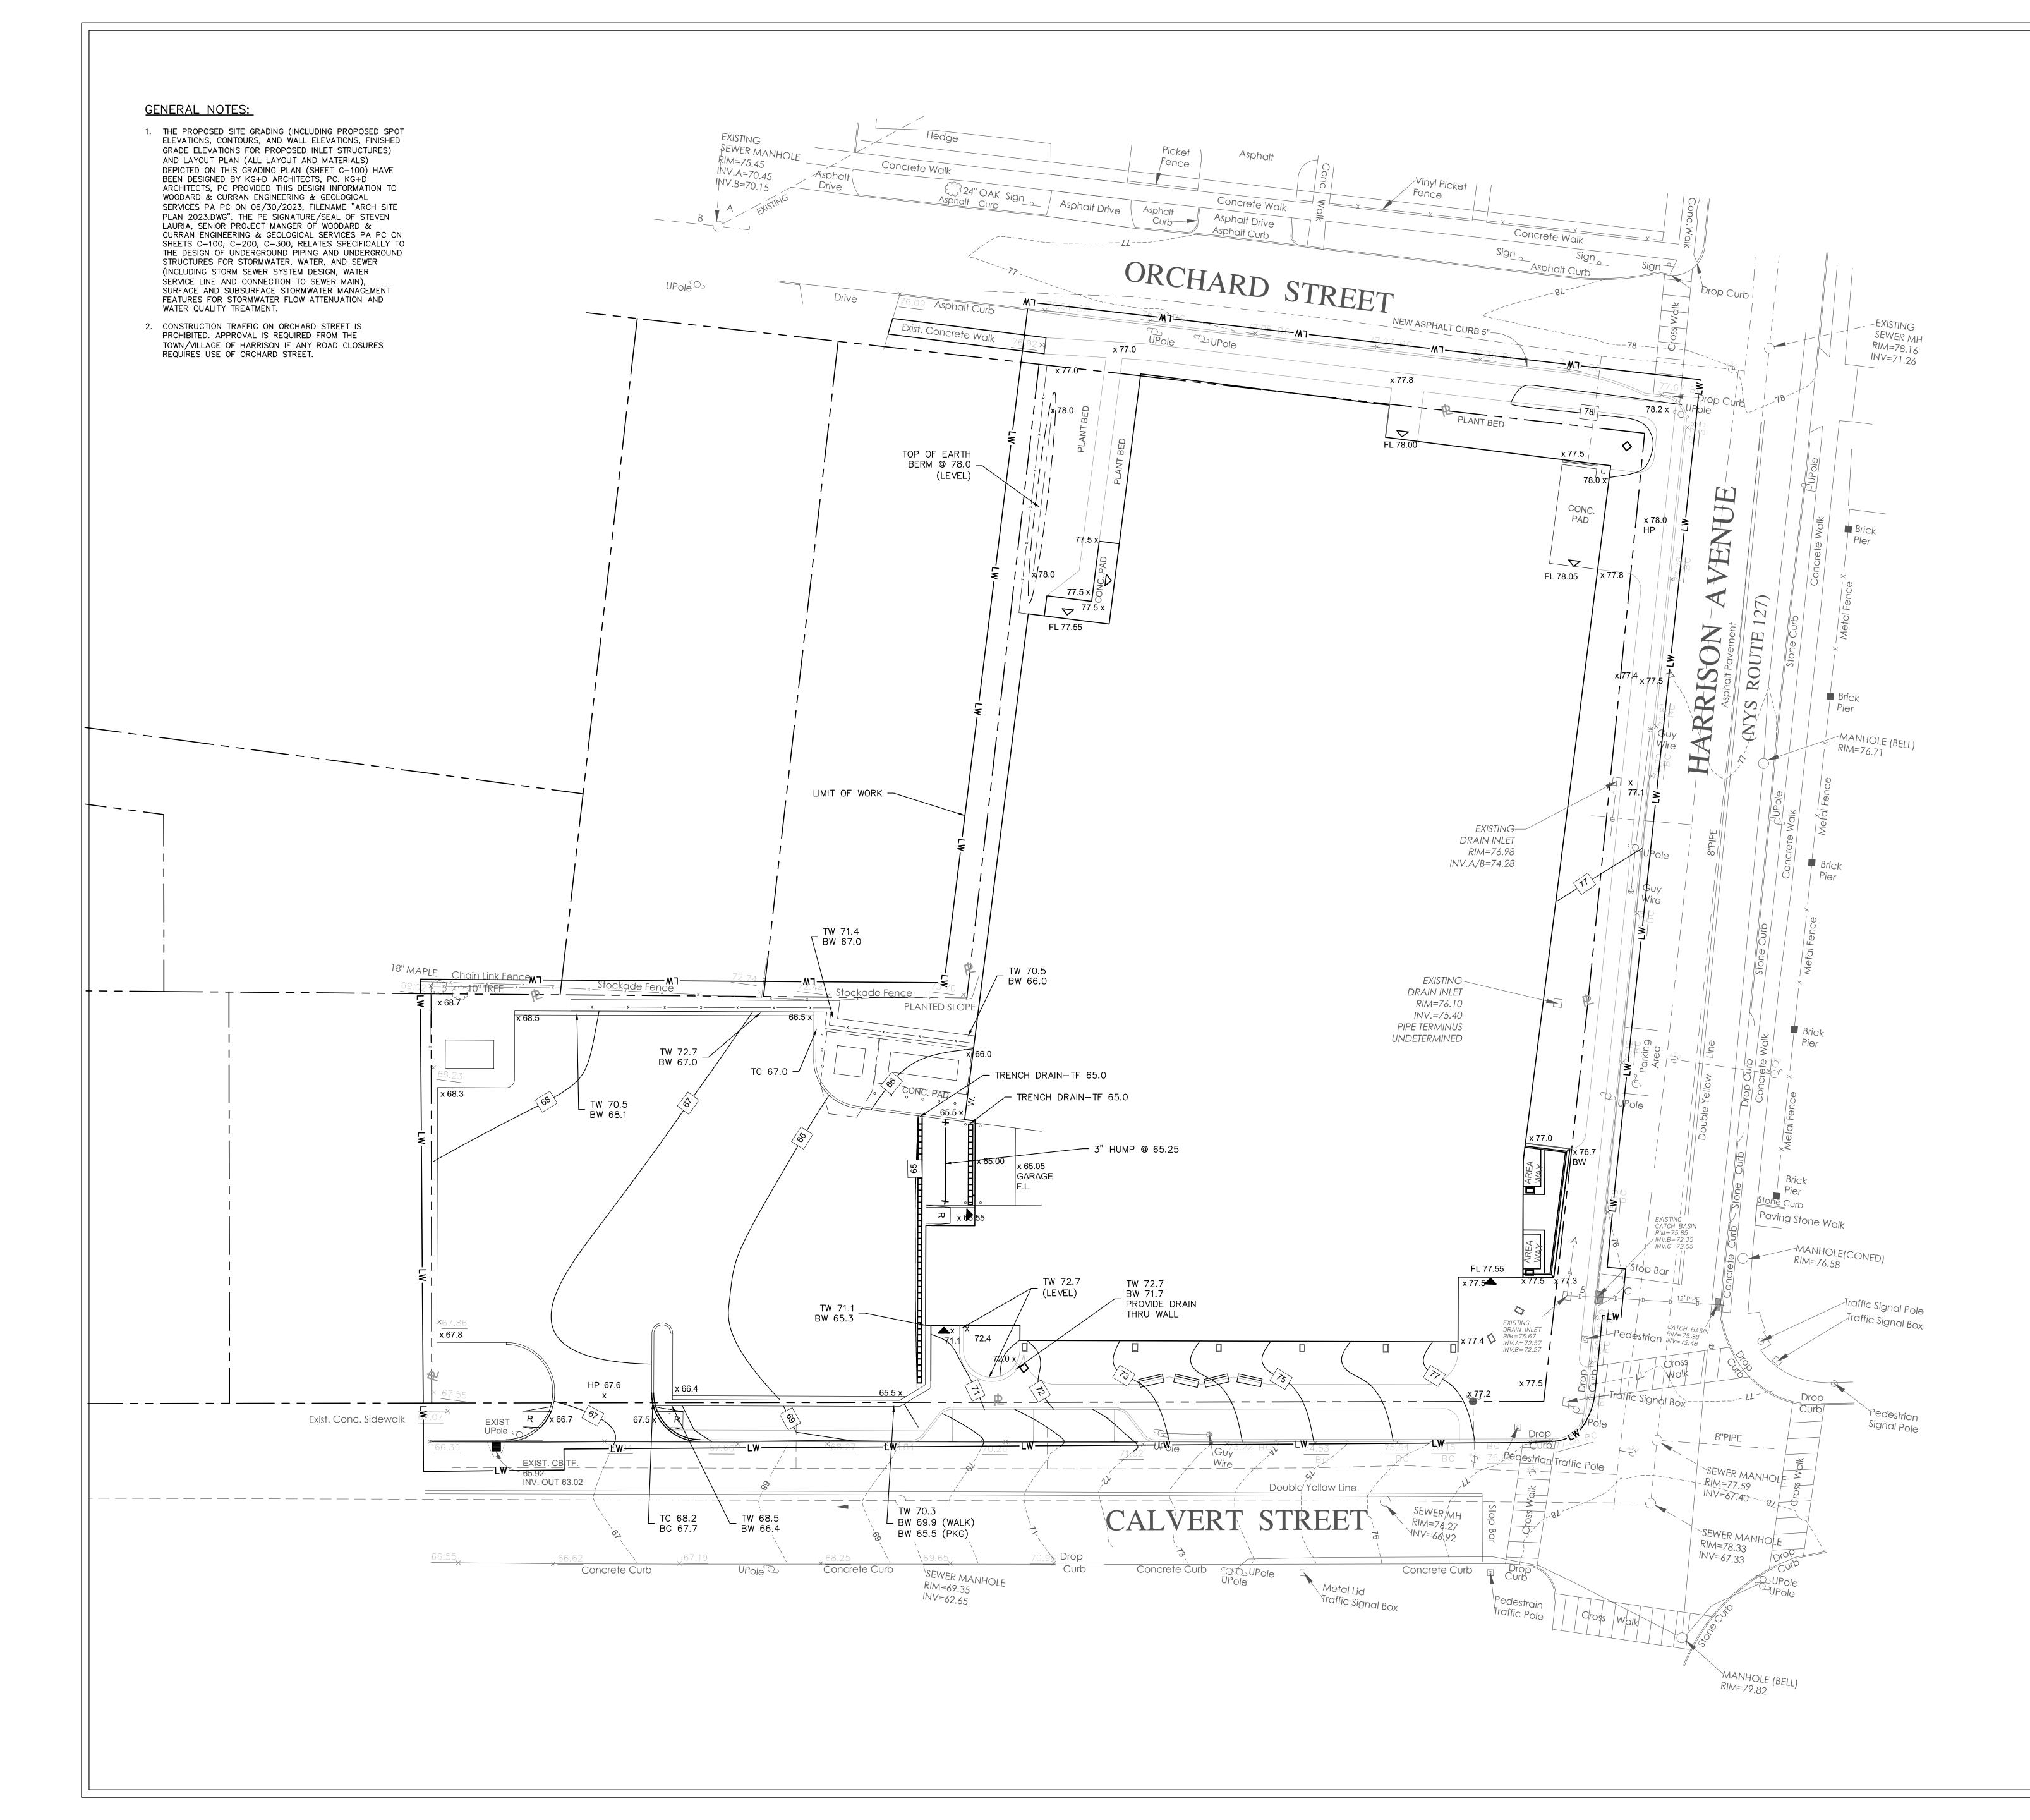
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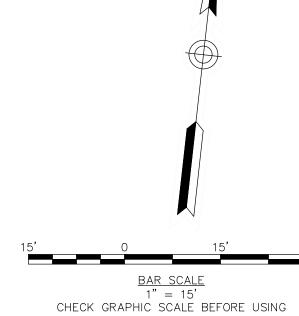
PROPOSED BUILDING LINE
PROPOSED CONTOUR
PROPOSED SPOT GRADE
PROPOSED SLOPE AND DIRECTION OF FLOW
PROPOSED DRAIN INLET
PROPOSED MANHOLE
PROPOSED BYPASS MANH
PROPOSED HYDRODYNAMIC SEPARATOR (OPEN GRATE
PROPOSED WATER QUALIT
PROPOSED CLEANOUT
PROPOSED HYDRANT
PROPOSED SOLID WALL STORM PIPE
PROPOSED PERFORATED STORM DRAIN
PROPOSED SANITARY SEWER PIPE
PROPOSED GAS LINE
PROPOSED WATER LINE
PROPOSED UNDERGROUND ELECTRIC LINE
PROPOSED CONSTRUCTION ENTRANCE
PROPOSED SOIL STOCKPILI
PROPOSED TRENCH DRAIN
PROPOSED CONSTRUCTION WITH PRIVACY SCREENING
PROPOSED CONSTRUCTION
PROPOSED SILT FENCE
PROPOSED INLET PROTECT

LIMIT OF DISTURBANCE / CONTRACT LIMIT LINE

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OLE) Y	KG+D ARCHITECTS, PC 285 MAIN STREET • MOUNT KISCO, NEW YORK 10549 P:914.666.5900 KGDARCHITECTS.COM
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	2 06/01/2020 DESIGN DEVELOPMENT 1 03/31/2020 50% DESIGN DEVELOPMENT No. Date Issue Sheet Title
	CONSTRUCTION NOTES & LEGENDS
	Job No.Date2020-100506/29/2023ScaleDrawn / CheckedAS NOTEDCJL/JLMTSheet Number0
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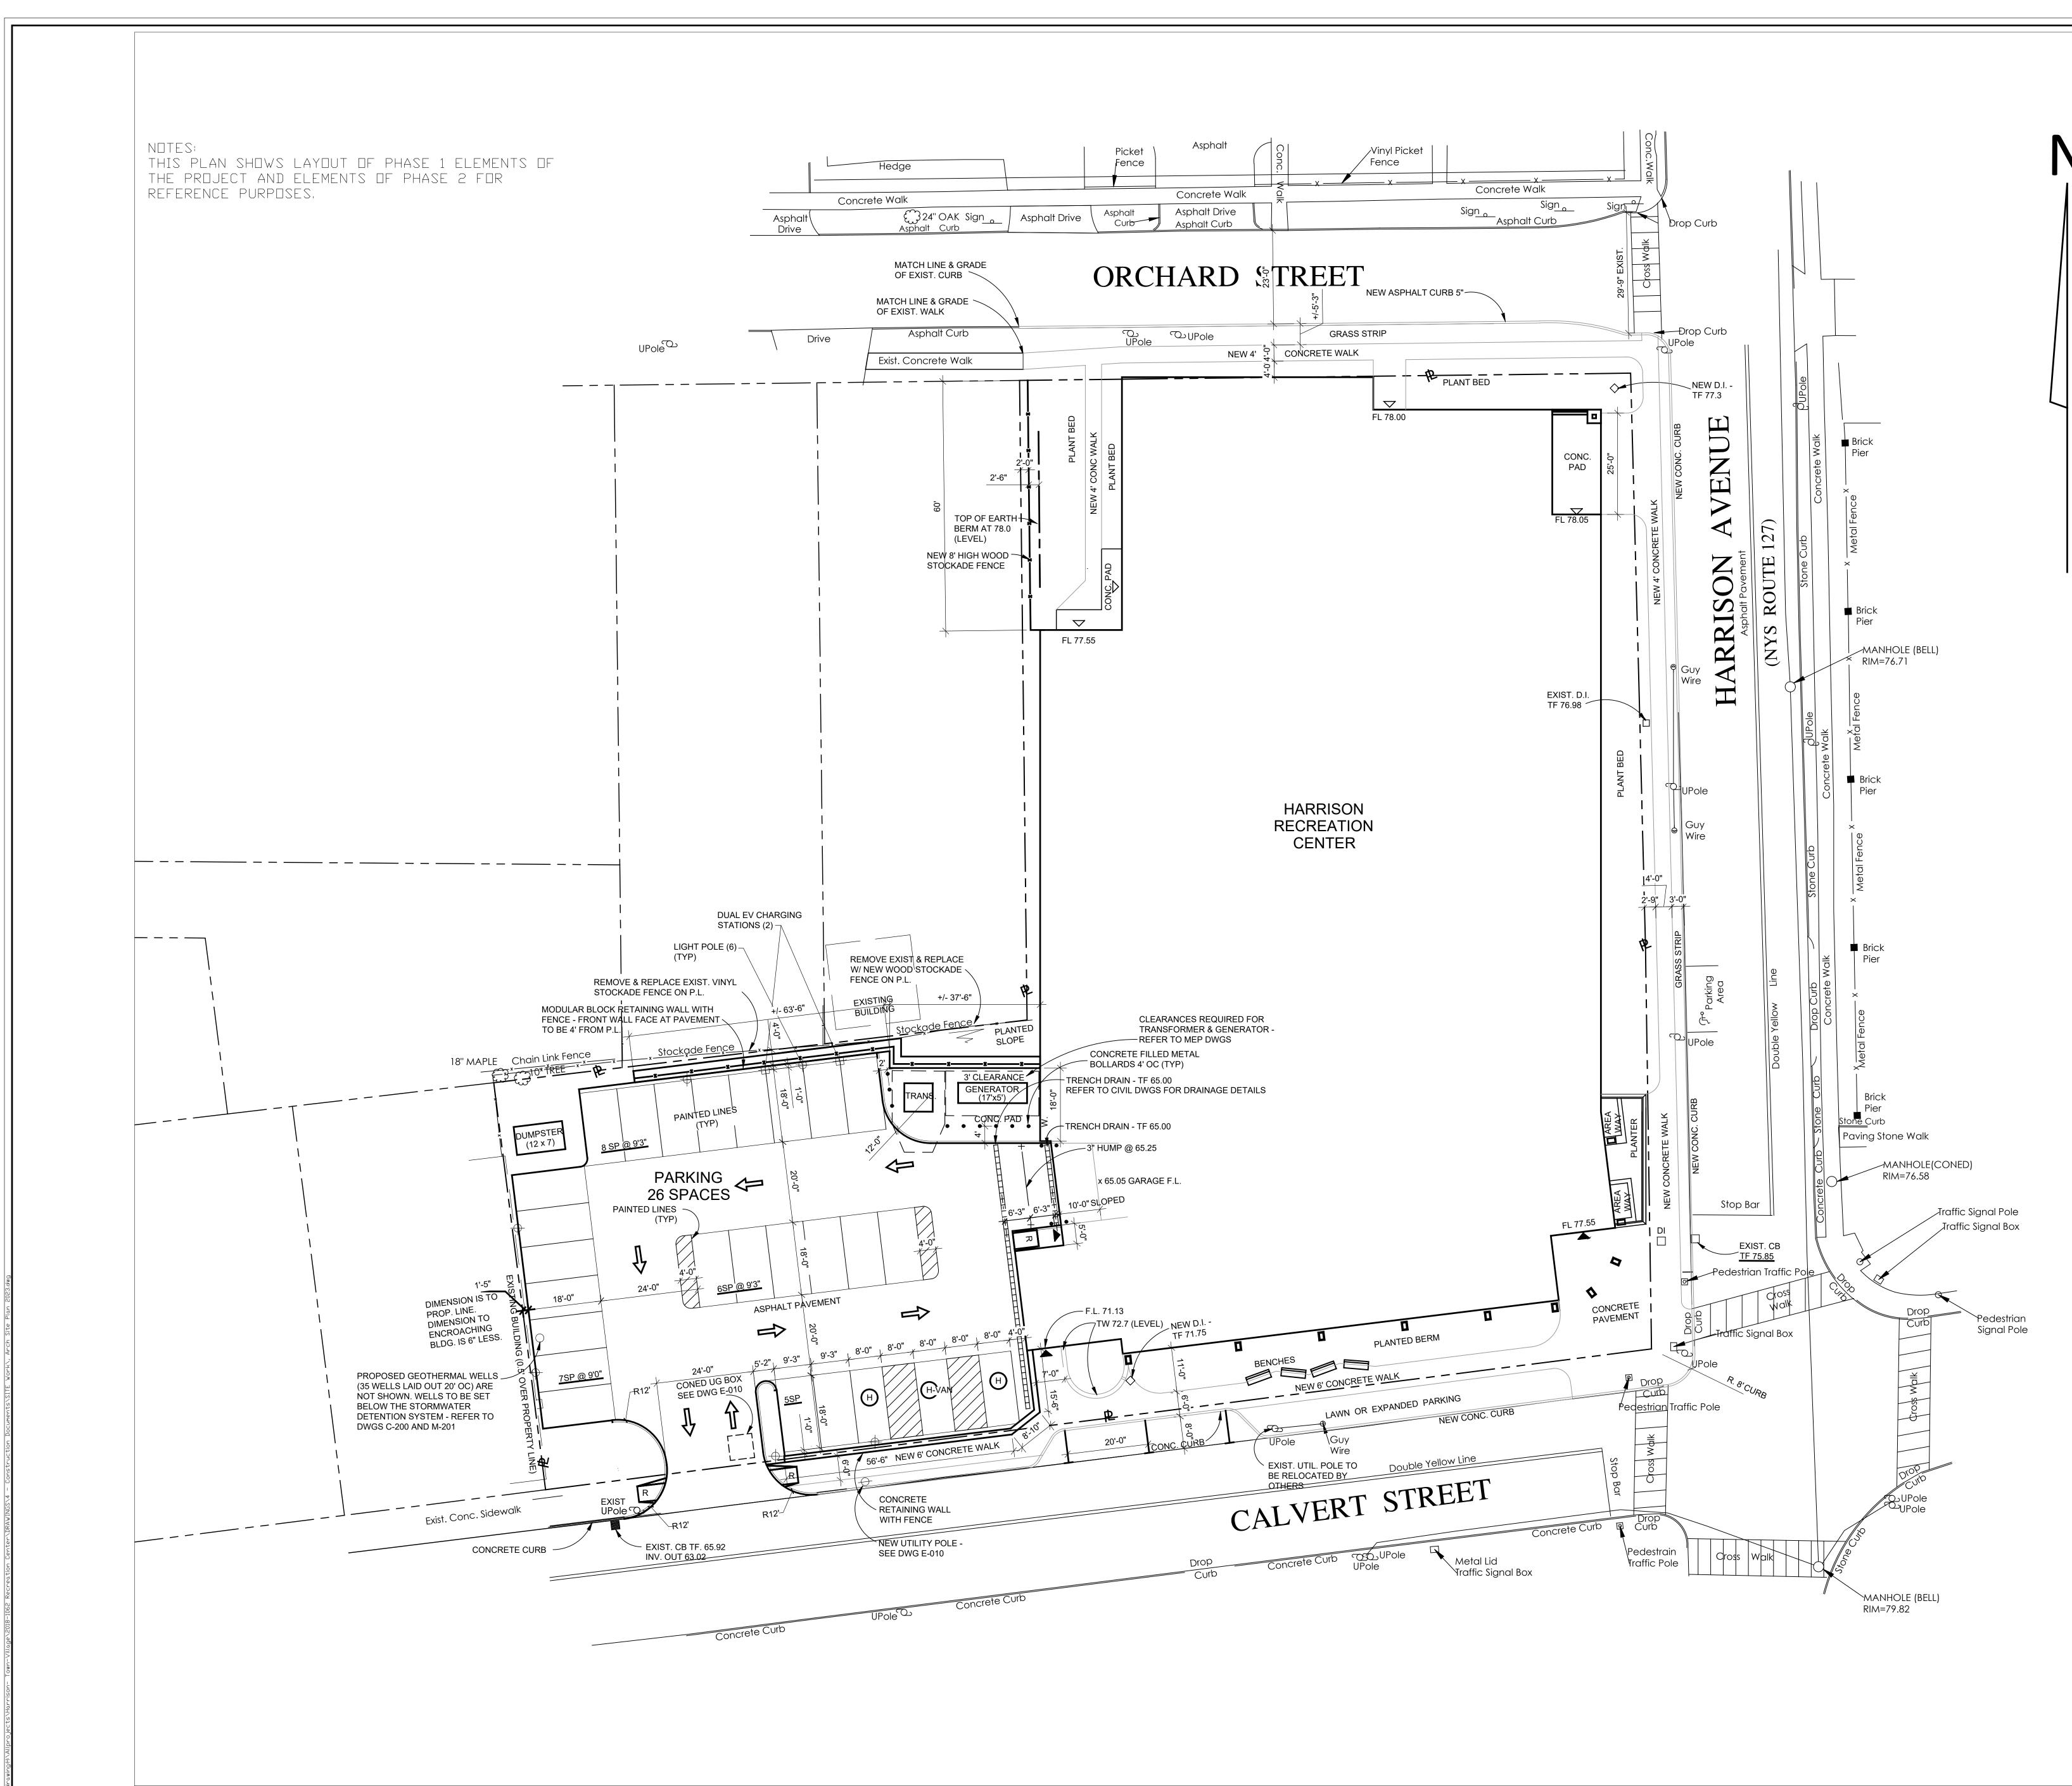
<u>KEY</u>	<u>TO SPOT GRADES:</u>
x 67.55	EXISTING ELEVATION TO REMAIN
x 67.55	PROPOSED SPOT GRADE
67—	PROPOSED CONTOUR
HP	HIGH POINT
TW/BW	TOP/BOTTOM OF WALL ELEV.
TC/BC	TOP/BOTTOM OF CURB





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 3
 06/09/2023
 ISSUE FOR PERMIT - PHASE 1
 2 06/01/2020 DESIGN DEVELOPMENT
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 03/31/2020
 50% DESIGN DEVELOPMENT

 No.
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 Sheet Title GRADING PLAN Job No. Date 07/07/2023 2020-1005 Drawn / Checked Scale AS NOTED CJL/JLMT Sheet Number C-100







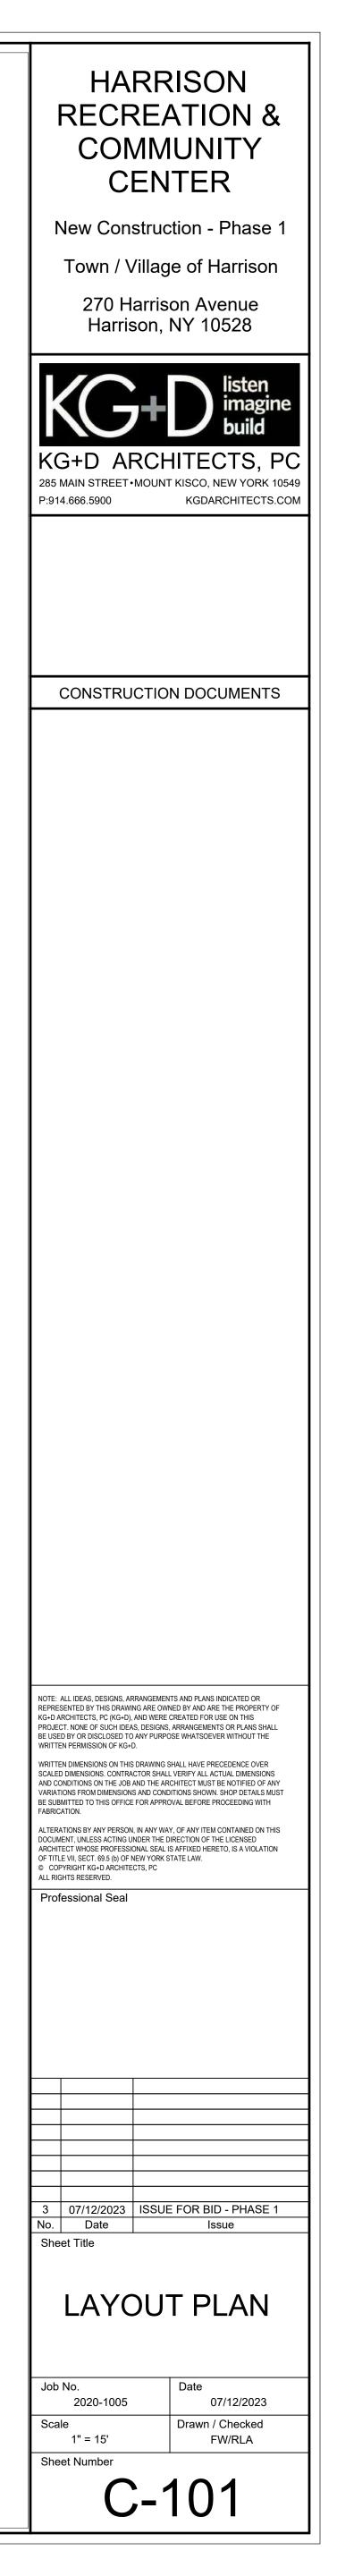

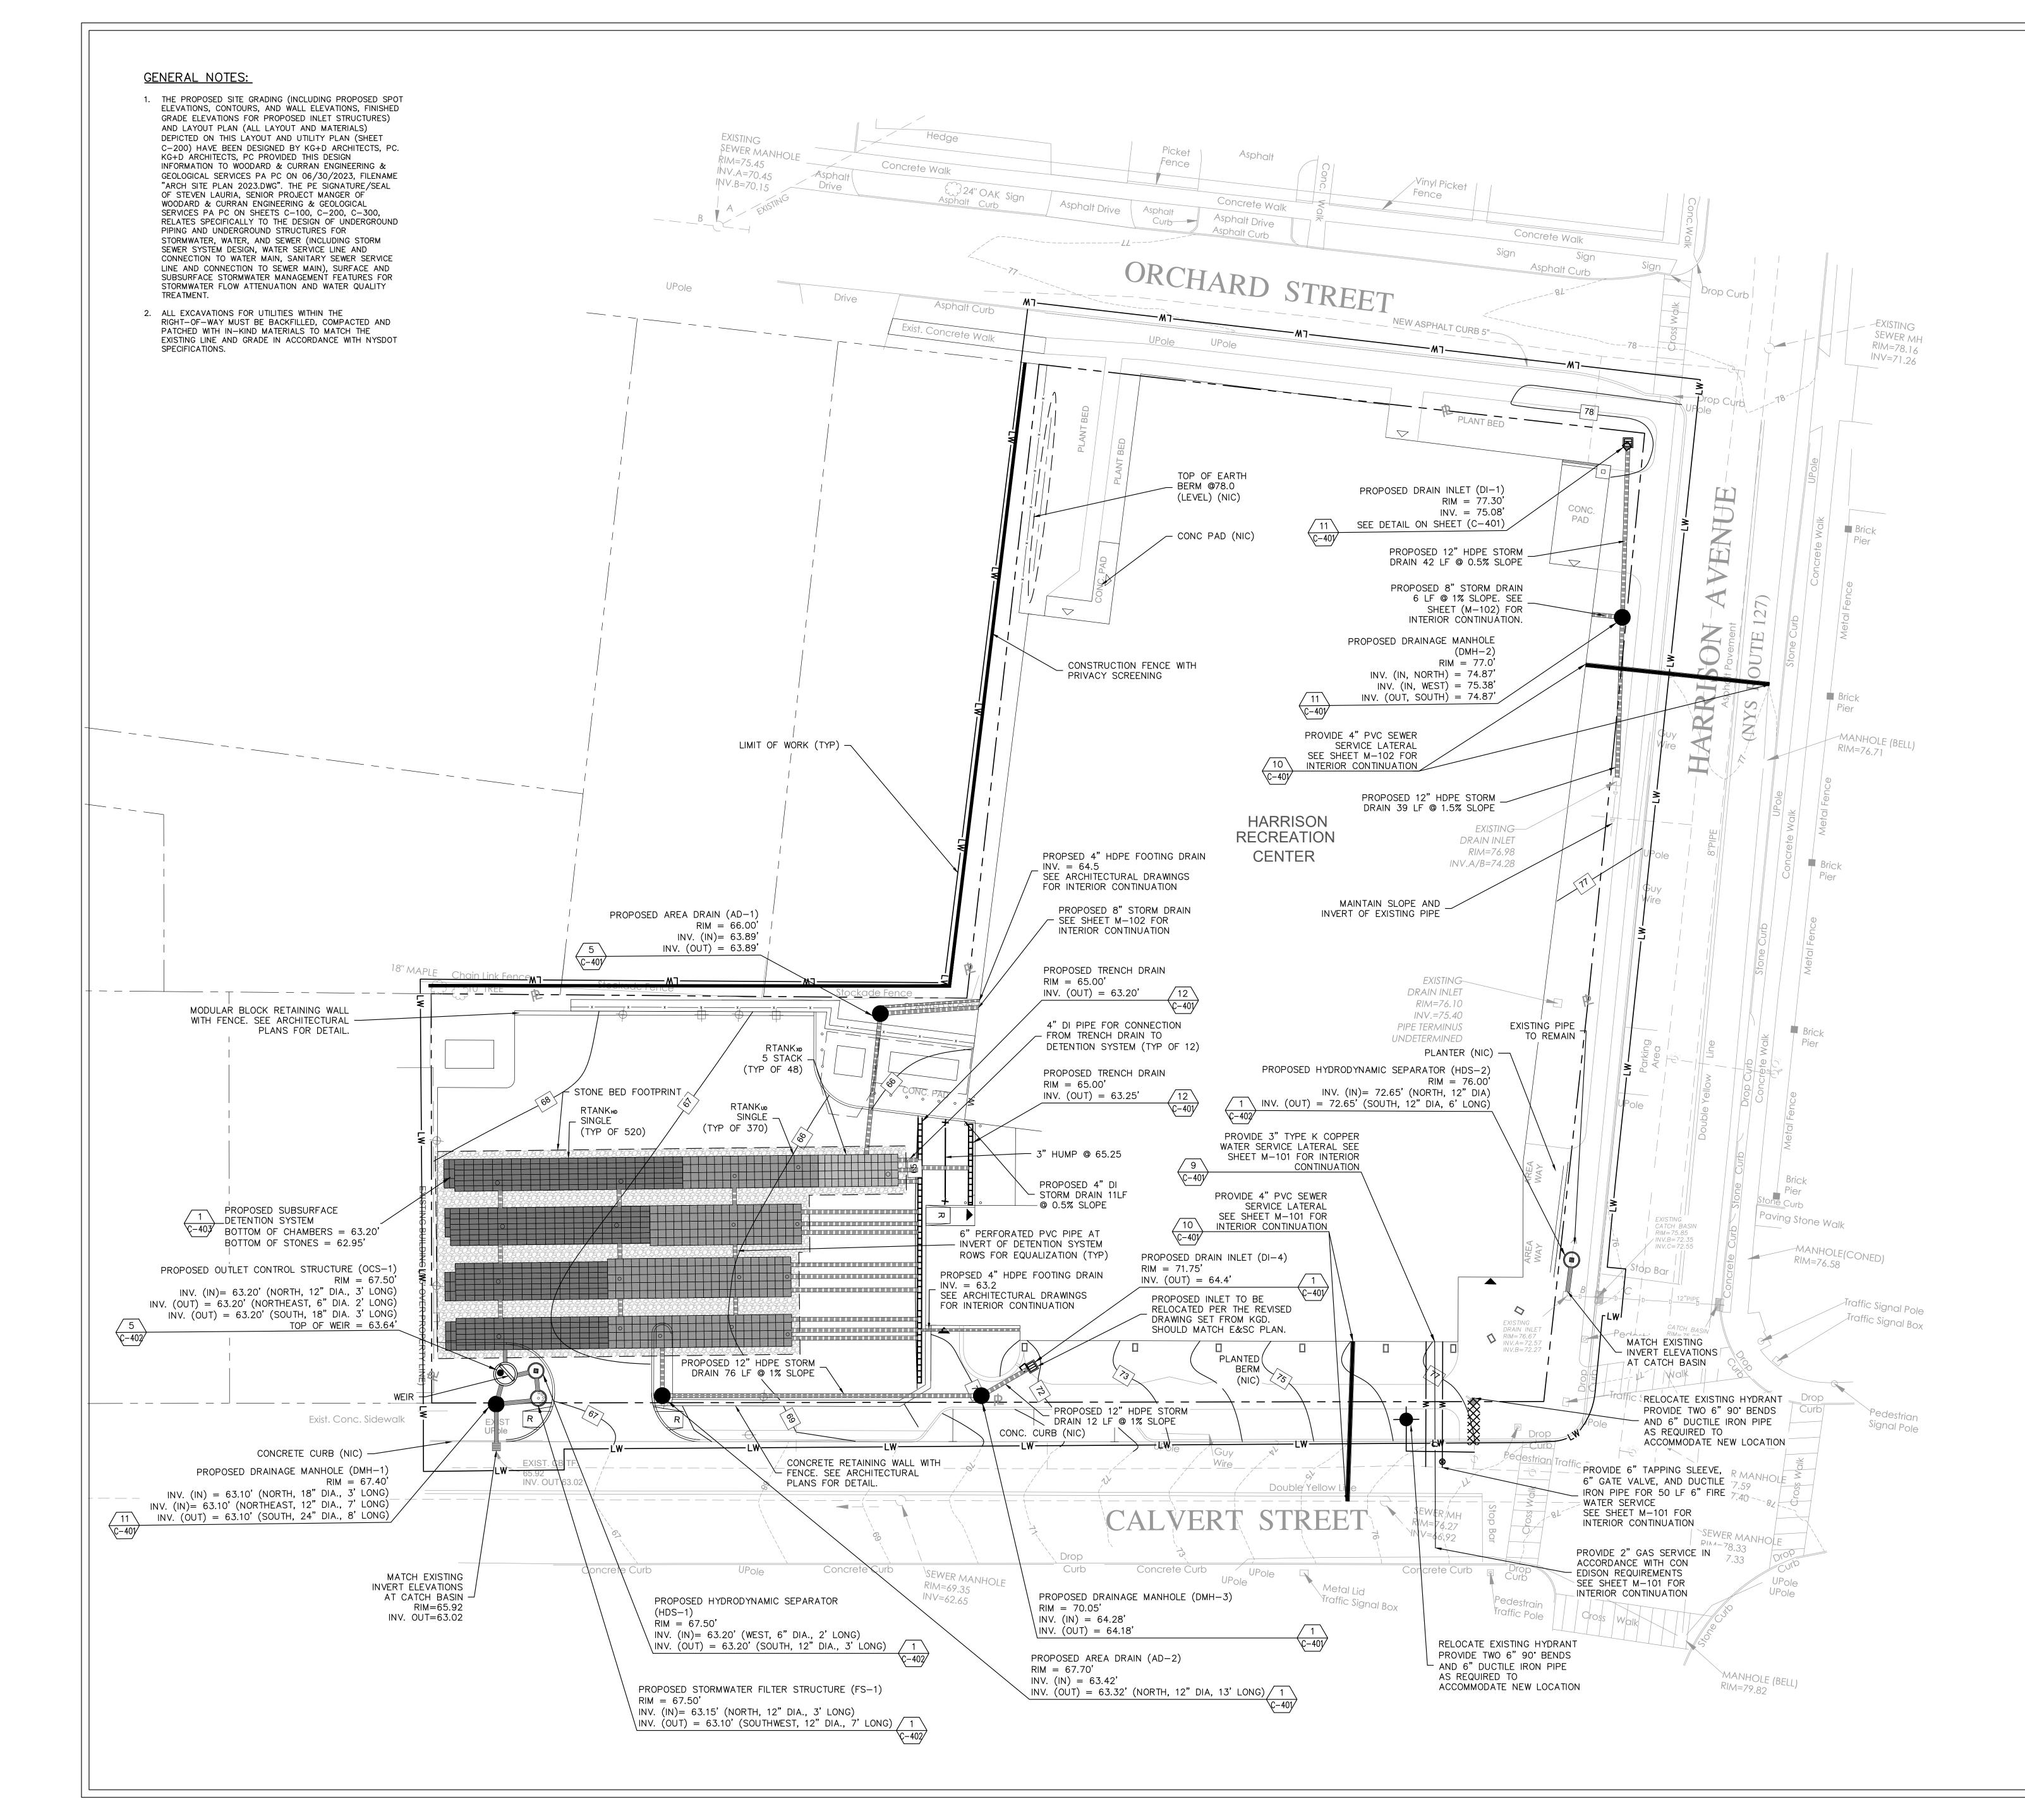15' 0 15'BAR SCALE 1'' = 15'CHECK GRAPHIC SCALE BEFORE USING

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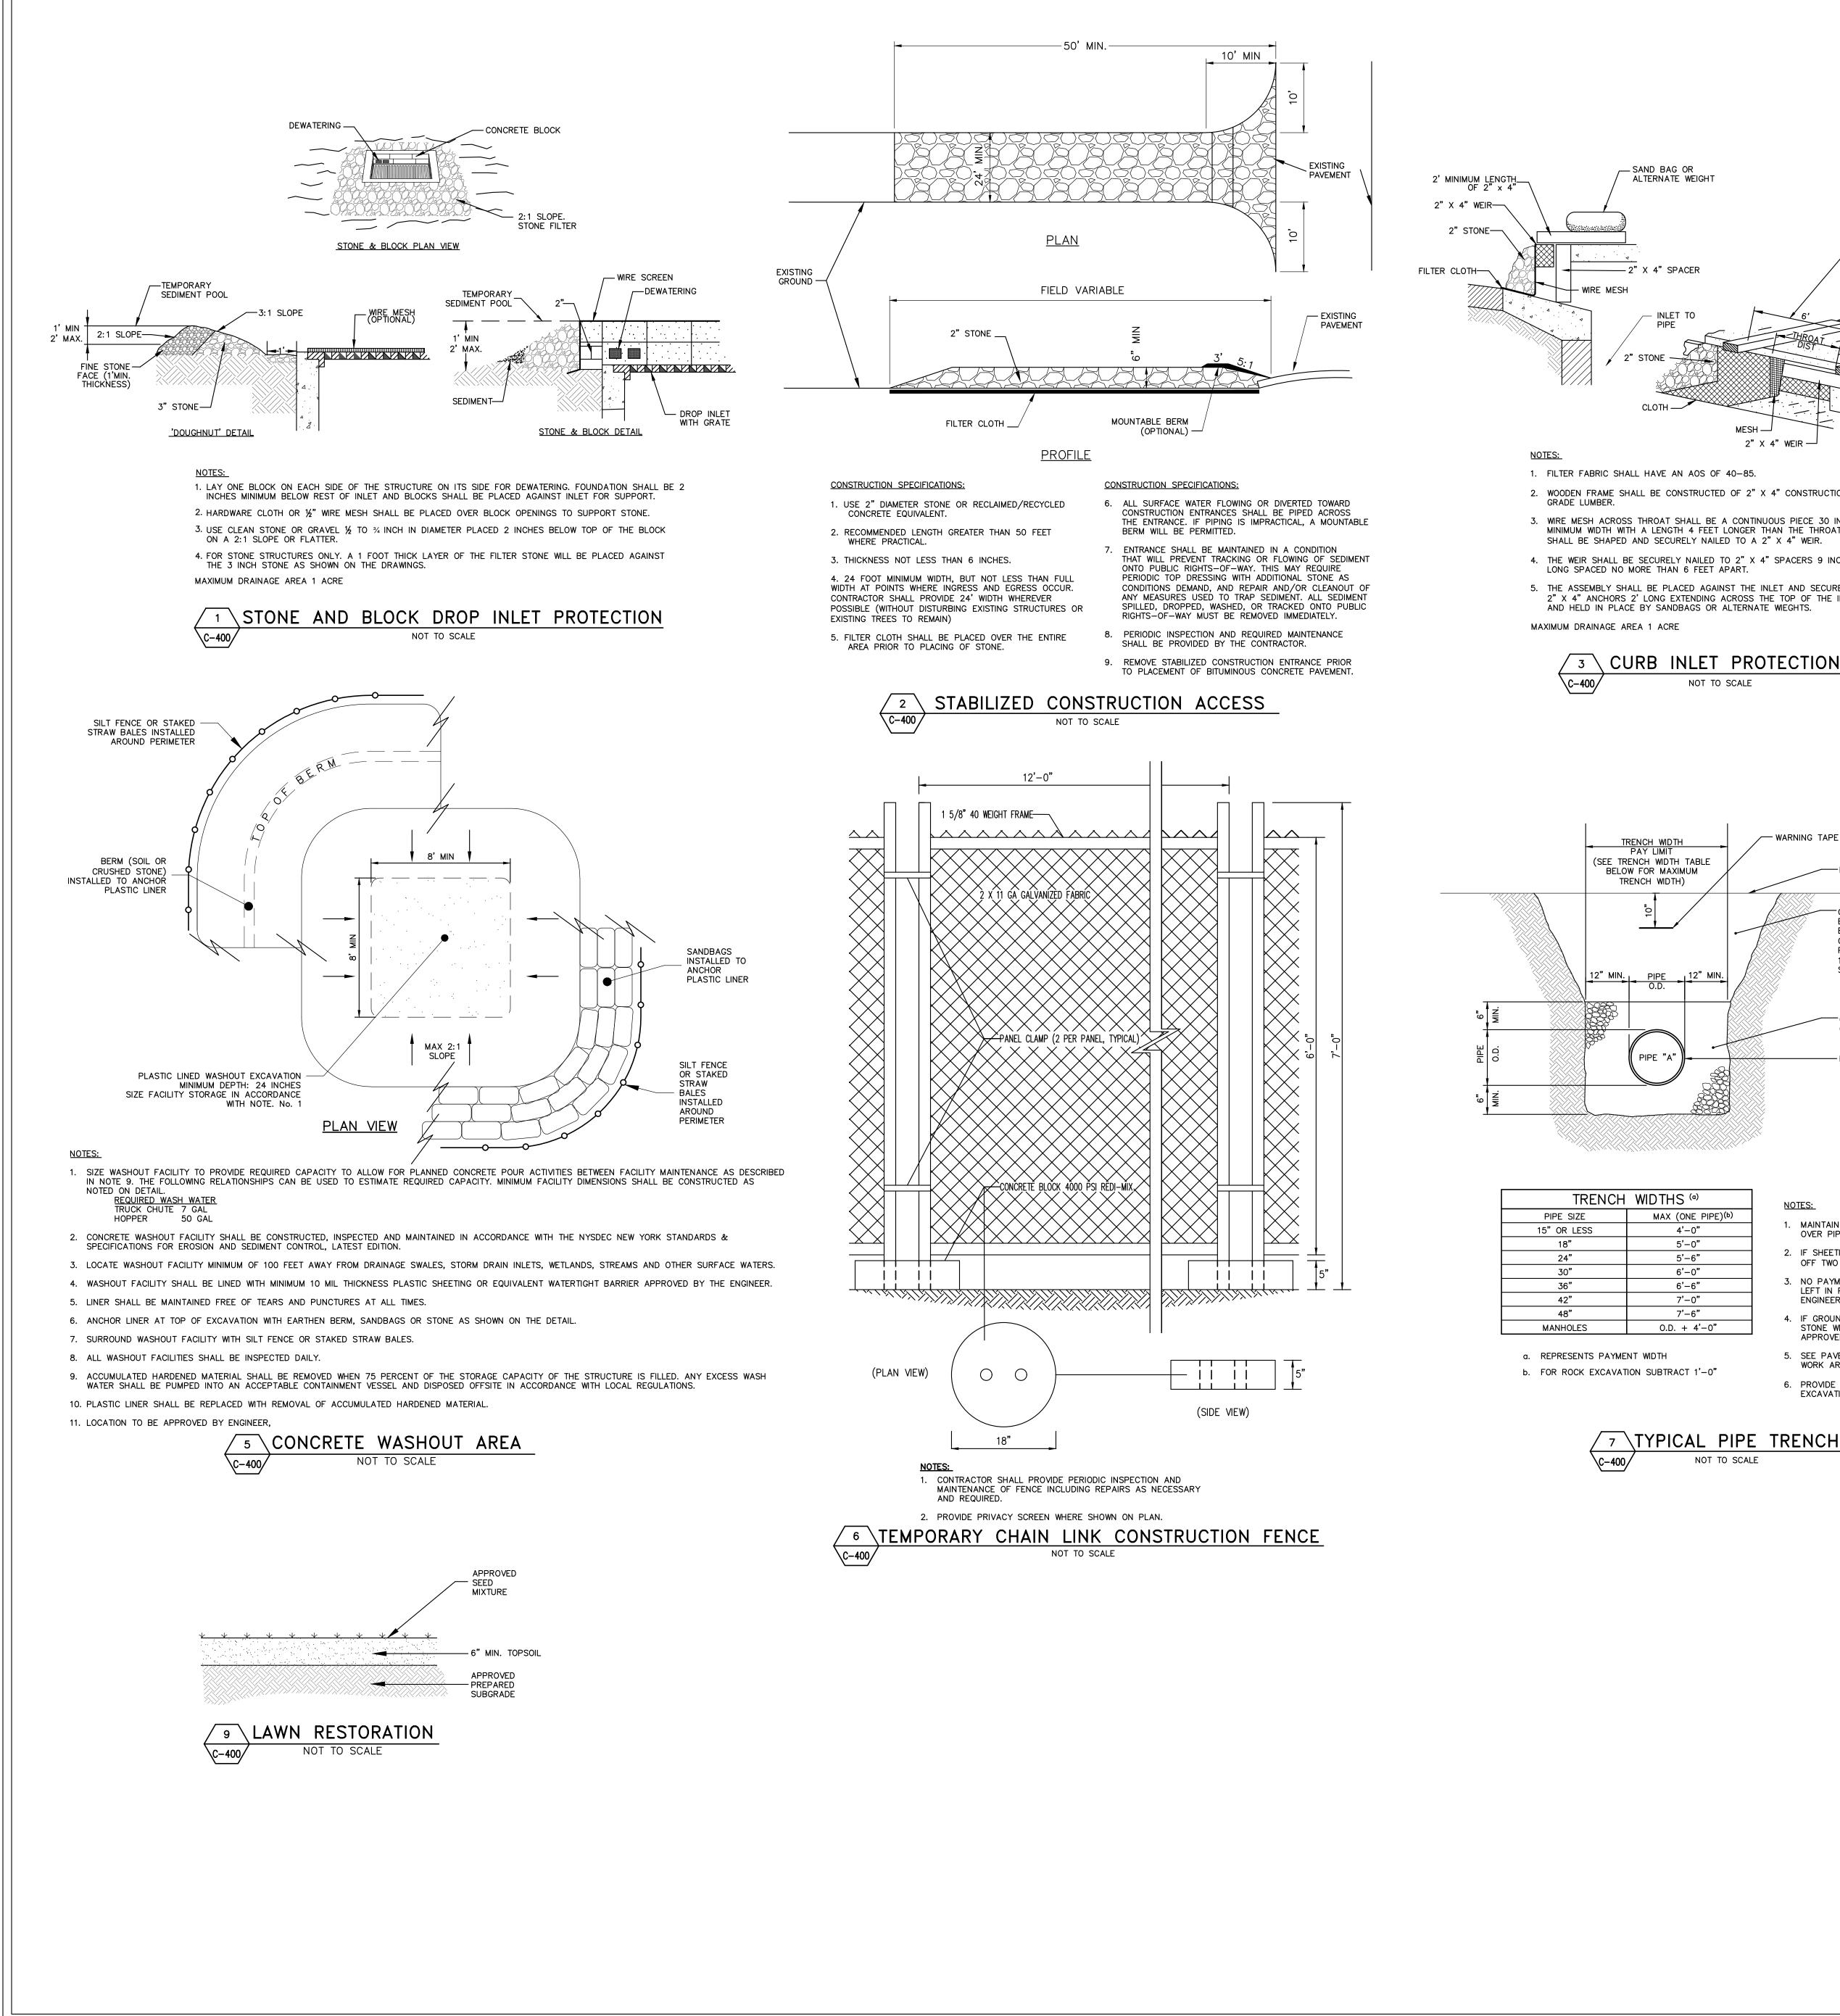

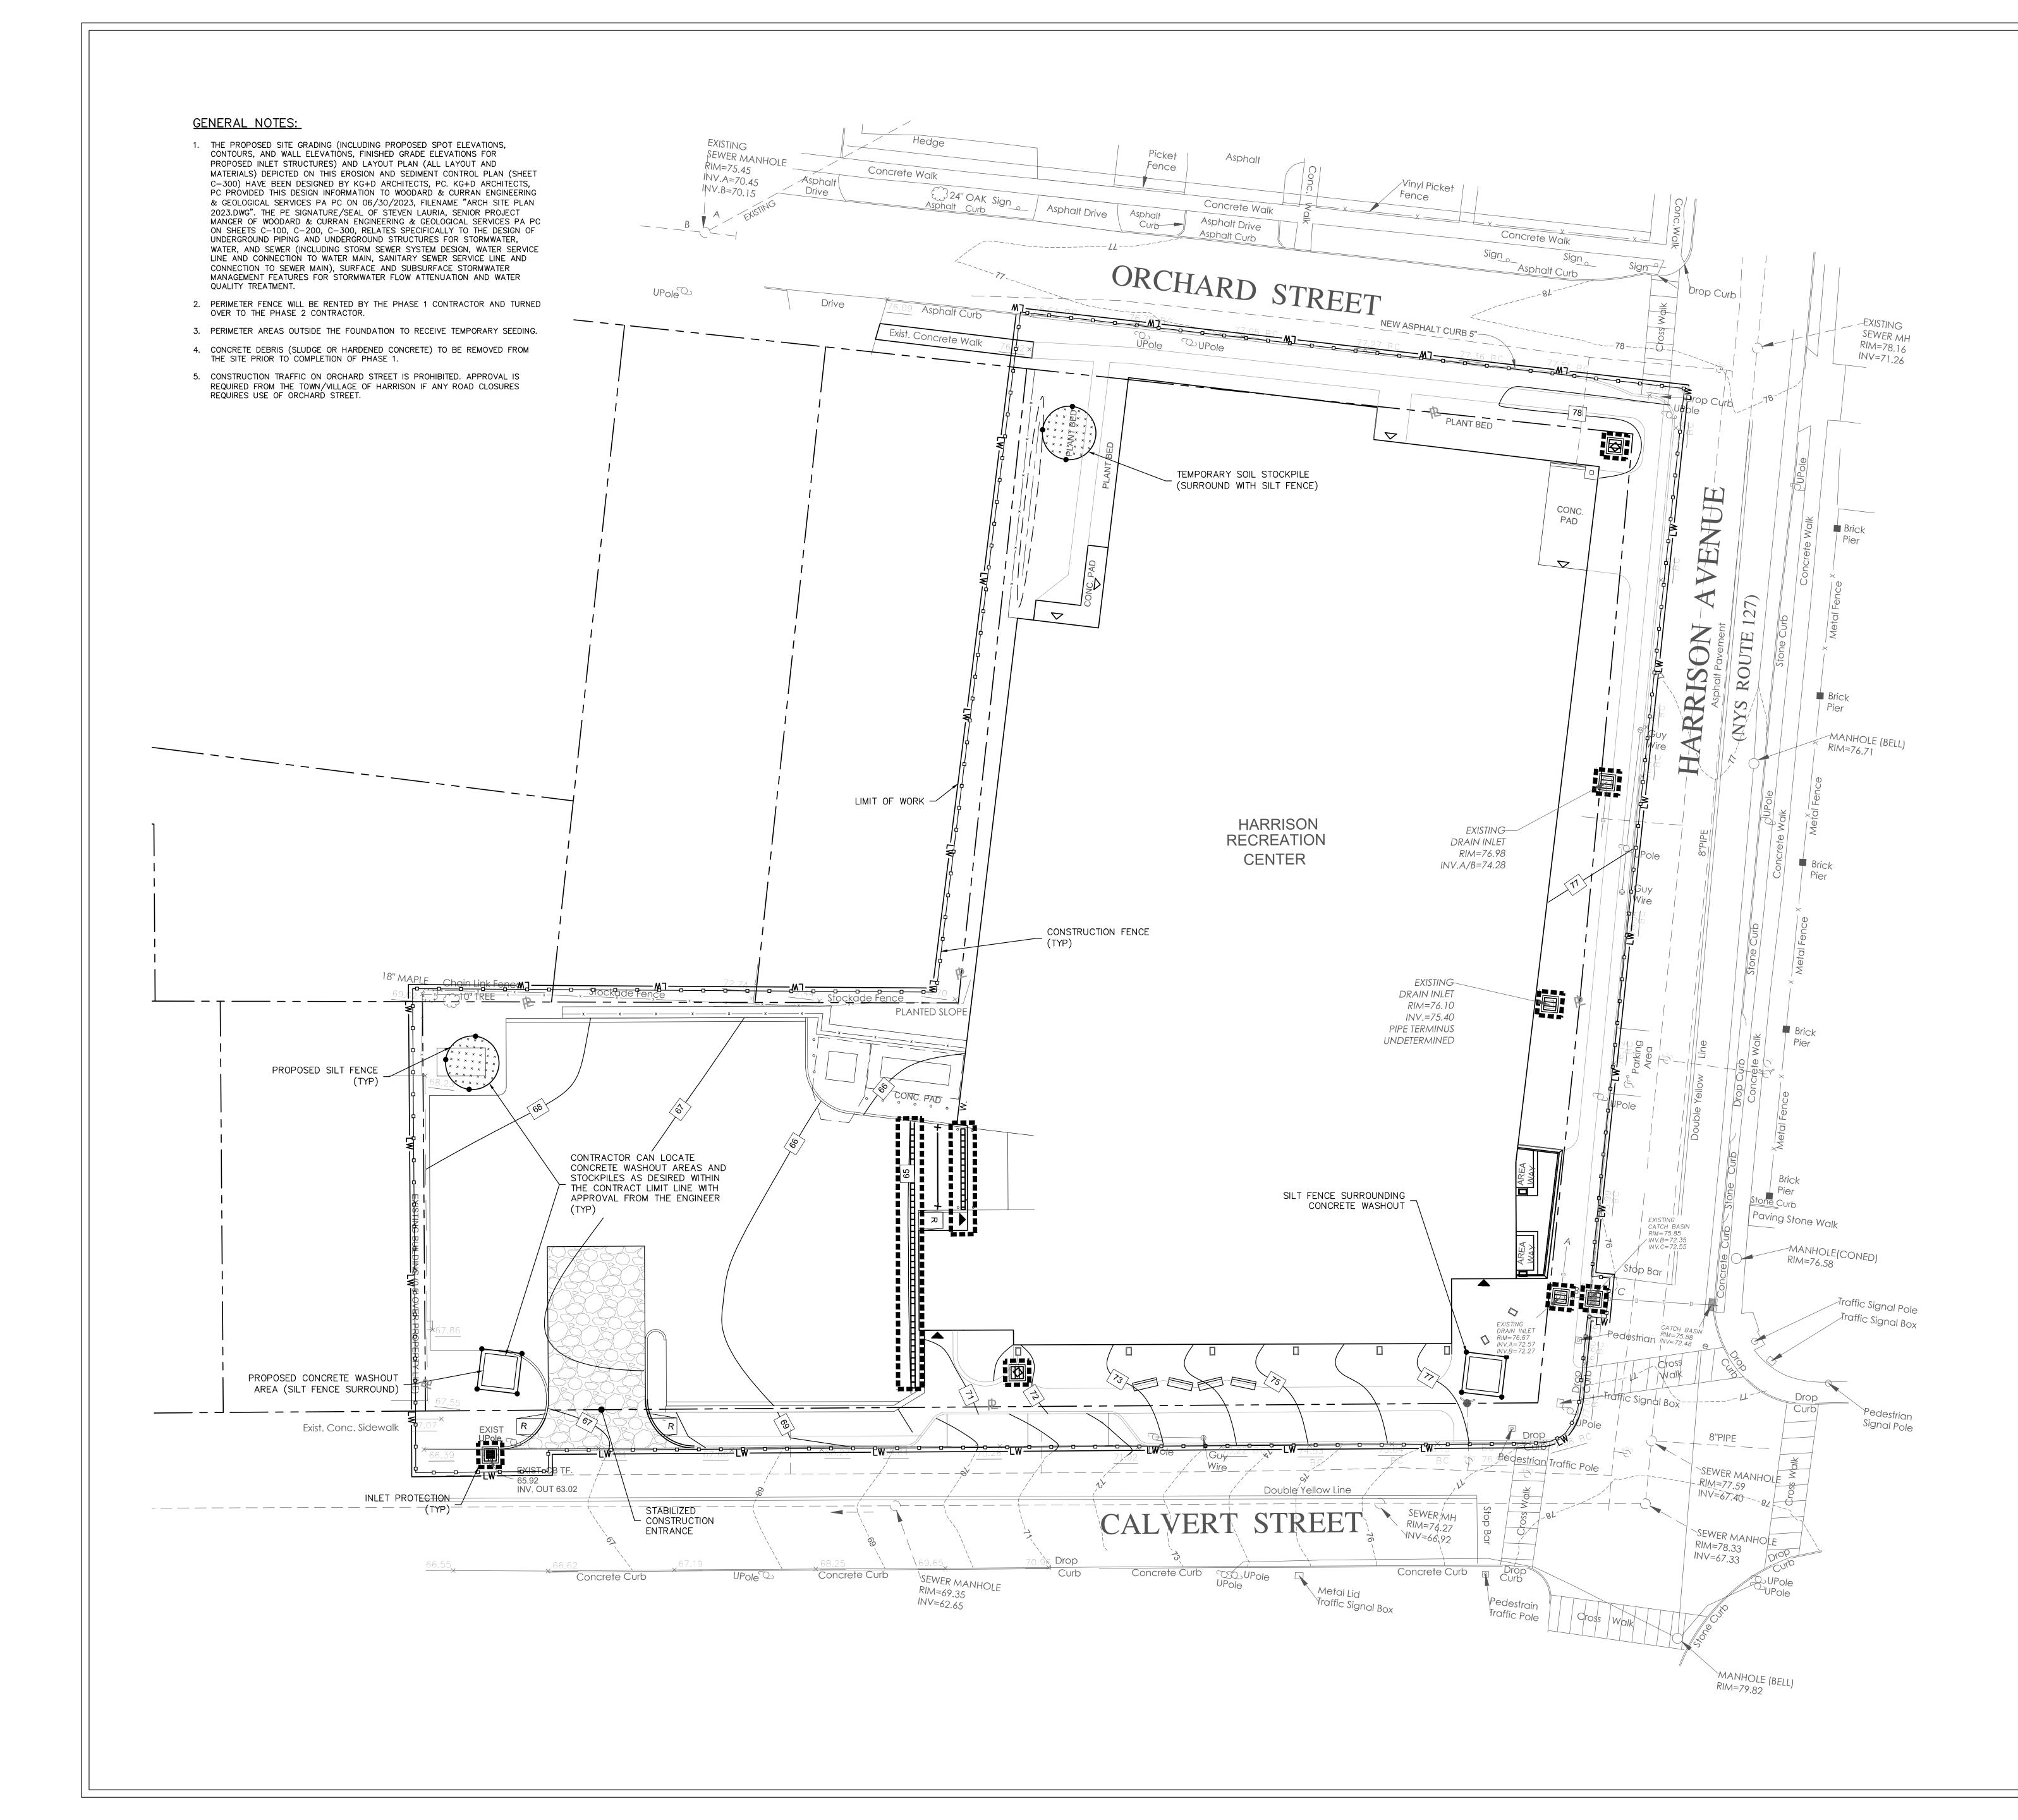
<u>BAR_SCALE</u> 1" = 15' CHECK GRAPHIC SCALE BEFORE USING
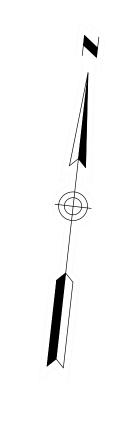
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 2 06/01/2020 DESIGN DEVELOPMENT
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 03/31/2020
 50% DESIGN DEVELOPMENT

 No.
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 Sheet Title **EROSION &** SEDIMENT CONTROL PLAN Job No. Date 07/07/2023 2020-1005 Drawn / Checked Scale AS NOTED MBA/JM Sheet Number C-300




NOT TO SCALE

7'–0"

6. PROVIDE 6" MIN. BEDDING FOR AREAS OF EXCAVATION IN ROCK.

- WORK AREAS
- 5. SEE PAVEMENT REPAIR DETAILS FOR ROAD
- STONE WITH MIRAFI 140N FILTER FABRIC OR APPROVED EQUAL.
- 4. IF GROUNDWATER IS ENCOUNTERED, WRAP
- ENGINEER.
- 3. NO PAYMENT WILL BE MADE FOR SHEETING LEFT IN PLACE UNLESS DIRECTED BY
- 2. IF SHEETING IS REQUIRED TO REMAIN, CUT OFF TWO (2) FEET BELOW FINISH GRADE.
- MAINTAIN UNIFORM TRENCH WIDTH TO 6" OVER PIPE.
- <u>NOTES:</u>

- COMPACTED 3/4" CRUSHED STONE

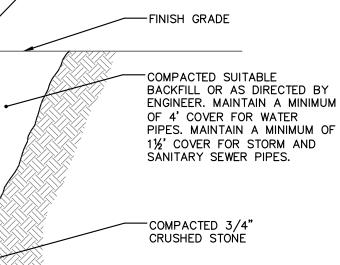


WARNING TAPE


$\sqrt{3}$ CURB INLET PROTECTION NOT TO SCALE


AND HELD IN PLACE BY SANDBAGS OR ALTERNATE WIEGHTS.


4. THE WEIR SHALL BE SECURELY NAILED TO 2" X 4" SPACERS 9 INCHES 5. THE ASSEMBLY SHALL BE PLACED AGAINST THE INLET AND SECURED BY 2" X 4" ANCHORS 2' LONG EXTENDING ACROSS THE TOP OF THE INLET

MINIMUM WIDTH WITH A LENGTH 4 FEET LONGER THAN THE THROAT. IT SHALL BE SHAPED AND SECURELY NAILED TO A 2" X 4" WEIR.

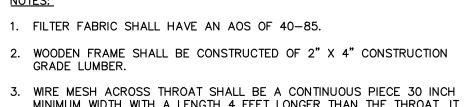

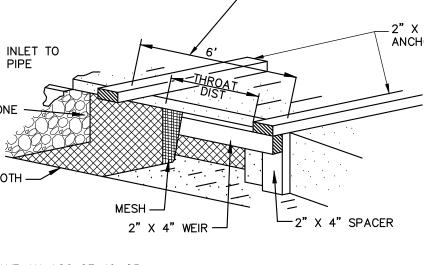

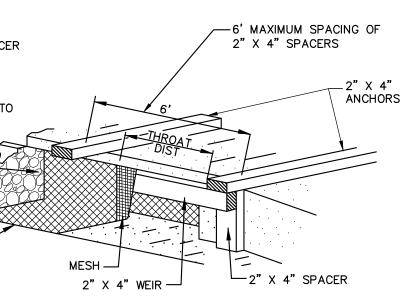

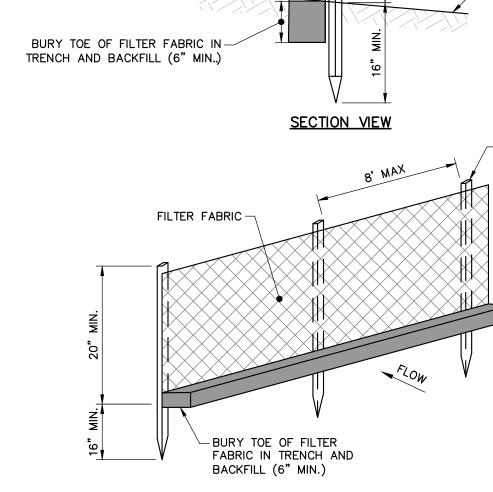

1. INSTALL FABRIC ON UPHILL SIDE OF WOOD STAKES.

3. SILT FENCE WILL NOT BE USED IN DRAINAGE WAYS.

IT REACHES A DEPTH OF SIX-INCHES OR MORE.


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ACCUMULATED SEDIMENT WILL BE REMOVED.

NOTES:

2"X2" WOOD STAKES -

UNDISTURBED FLOW GROUND / 2"X2" WOOD STAKES

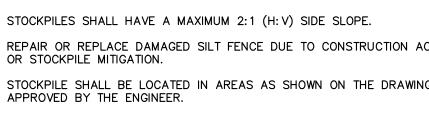

OR STOCKPILE MITIGATION. 4. STOCKPILE SHALL BE LOCATED IN AREAS AS SHOWN ON THE DRAWINGS OR

TEMPORARY SOIL STOCKPILE

NOT TO SCALE

- 3. REPAIR OR REPLACE DAMAGED SILT FENCE DUE TO CONSTRUCTION ACTIVITIES
- 2. STOCKPILES SHALL HAVE A MAXIMUM 2:1 (H: V) SIDE SLOPE.
- SILT FENCE <u>NOTES:</u>

- 1. STOCKPILES SHALL BE SURROUNDED BY SILT FENCE.

8 \

\C-400/

ISOMETRIC VIEW

2. SPACING BETWEEN WOOD STAKES PER MANUFACTURER'S RECOMMENDATION.

SUPPORTS. REPAIR AS NECESSARY. REMOVE ACCUMULATED SEDIMENT WHEN


4 SILT FENCE


NOT TO SCALE

5. REMOVAL: WHEN UPSLOPE AREAS ARE STABILIZED, THE STRUCTURE AND ANY

4. MAINTENANCE: INSPECT FOR TEARS IN THE FABRIC OR DAMAGE TO

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AS NOTED CJL/JLMT Sheet Number
C-400

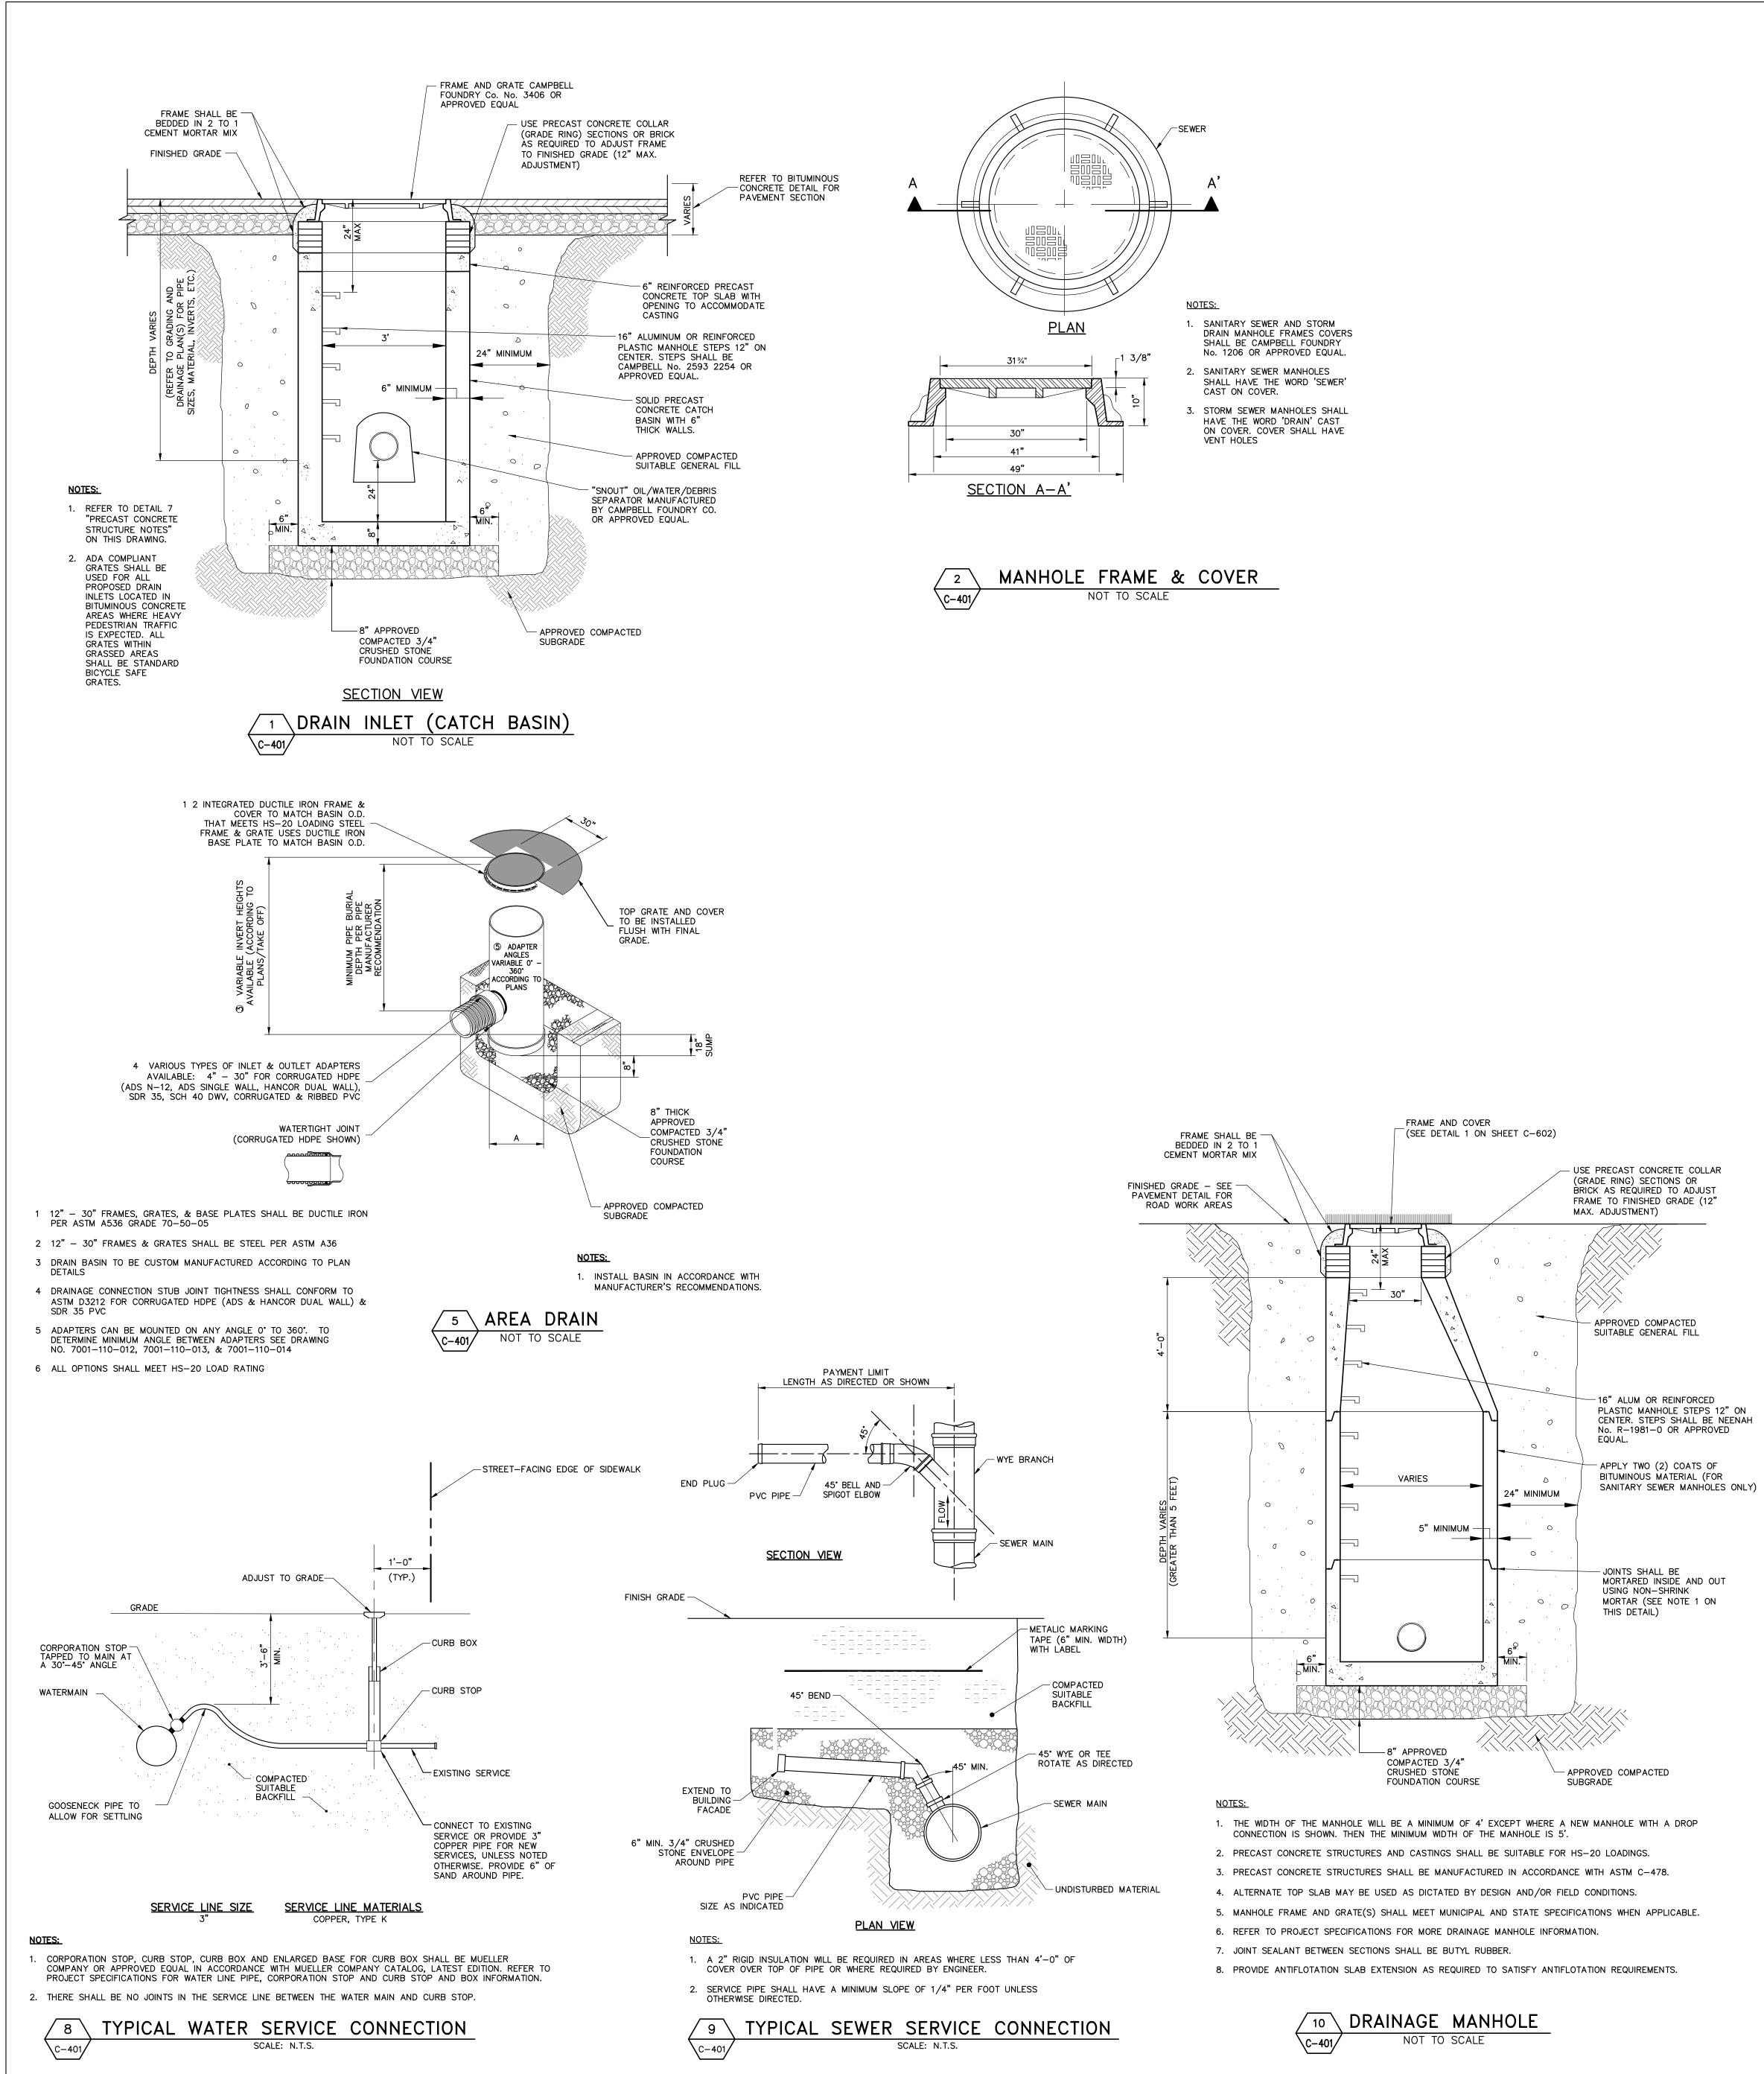

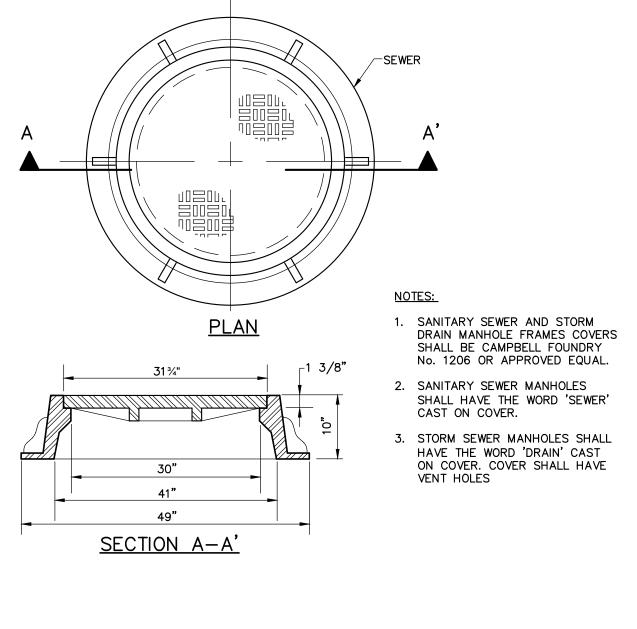







		SPECIFICATION CLAUSE
SEE NOTE 4	PAVEMENT PER DESIGN DOCUMENTS	K300 KLASSIKDRAIN 'DRAINLOK' LOAD CLASS C <u>GENERAL</u> THE SURFACE DRAINAGE SYSTEM SHALL BE POLYMER CONCRETE K300 CHANNEL SYSTEM
		GALVANIZED STEEL EDGE RAILS AS MANUFAG BY ACO POLYMER PRODUCTS, INC. <u>MATERIALS</u> CHANNELS SHALL BE MANUFACTURED FROM POLYESTER RESIN POLYMER CONCRETE WIT INTEGRALLY CAST-IN GALVANIZED STEEL EDG MINIMUM PROPERTIES OF POLYMER CONCRE BE AS FOLLOWS: COMPRESSIVE STRENGTH: 14 FLEXURAL STRENGTH: 14 FLEXURAL STRENGTH: 14 FLEXURAL STRENGTH: 14 FROST PROOF DILUTE ACID AND ALKALI RESISTANT B117 SALT SPRAY TEST COMPLIANT
		THE SYSTEM SHALL BE 12" (300mm) NOMINAL INTERNAL WIDTH WITH A 14.2" (390mm) OVERJ WIDTH AND A BUILT-IN SLOPE OF 0.5%. CHAN INVERT SHALL HAVE DEVELOPED "V" SHAPE. CHANNELS SHALL BE INTERLOCKING WITH A MALE/FEMALE JOINT. THE COMPLETE DRAINAGE SYSTEM SHALL BE ACO POLYMER PRODUCTS, INC. ANY DEVIAT PARTIAL SYSTEM DESIGN AND/OR IMPROPER INSTALLATION WILL VOID ANY AND ALL WARF
 NOTES: 10" [250mm] 11 IS NECESSARY TO ENSURE MINIMUM DIMENSIONS SHOWN ARE SUITABLE FOR EXISTING GROUND CON ENGINEERING ADVICE MAY BE REQUIRED. MINIMUM CONCRETE STRENGTH OF 4,000 PSI IS RECOMMENDED. CONCRETE SHOULD BE VIBRATED TO I AIR POCKETS. EXPANSION AND CONTRACTION CONTROL JOINTS AND REINFORCEMENT ARE RECOMMENDED TO PROT AND CONCRETE SURROUND. ENGINEERING ADVICE MAY BE REQUIRED. THE FINISHED LEVEL OF THE CONCRETE SURROUND MUST BE APPROX. 1/8" [3mm] ABOVE THE TOP OF T CONCRETE BASE THICKNESS SHOULD MATCH SLAB THICKNESS. ENGINEERING ADVICE MAY BE REQUIRED DETERMINE PROPER LOAD CLASS. REFER TO ACO'S LATEST INSTALLATION INSTRUCTIONS FOR FURTHER DETAILS. 	ELIMINATE ECT CHANNEL HE CHANNEL EDGE.	PROVIDED BY ACO POLYMER PRODUCTS, INC CHANNEL SHALL WITHSTAND LOADING TO P LOAD CLASS AS OUTLINED BY EN 1433. GRAT SHALL BE APPROPRIATE TO MEET THE SYSTI CLASS SPECIFIED AND INTENDED APPLICATIO GRATES SHALL BE SECURED USING 'DRAINLO BOLTLESS LOCKING SYSTEM. CHANNEL AND SHALL BE CERTIFIED TO MEET THE SPECIFIE 1433 LOAD CLASS. THE SYSTEM SHALL BE INS IN ACCORDANCE WITH THE MANUFACTURER INSTRUCTIONS AND RECOMMENDATIONS.
K3-C-HAP K300 - KLASSIKDRAIN - LOAD CLASS: C		ACO Polymer Products, Inc.
Haunched Asphalt Pavement	825 W. Beech Casa Grande,	craft St 9470 Pinecone Dr. 4211 Pleas AZ 85122 Mentor, OH 44060 Fort Mill, S
DATE: 08/18/16 INSTALLATION DRAWING - ACO DRAIN	Tel: 520-421-5 Fax: 520-421-	


HARRISON RECREATION & COMMUNITY CENTER New Construction - Phase 1 Town / Village of Harrison
270 Harrison Avenue Harrison, NY 10528 INCOMPOSITION STREET OF CONTRACT OF CONTACT OF CON
CONSTRUCTION DOCUMENTS
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<u>GENERAL</u>

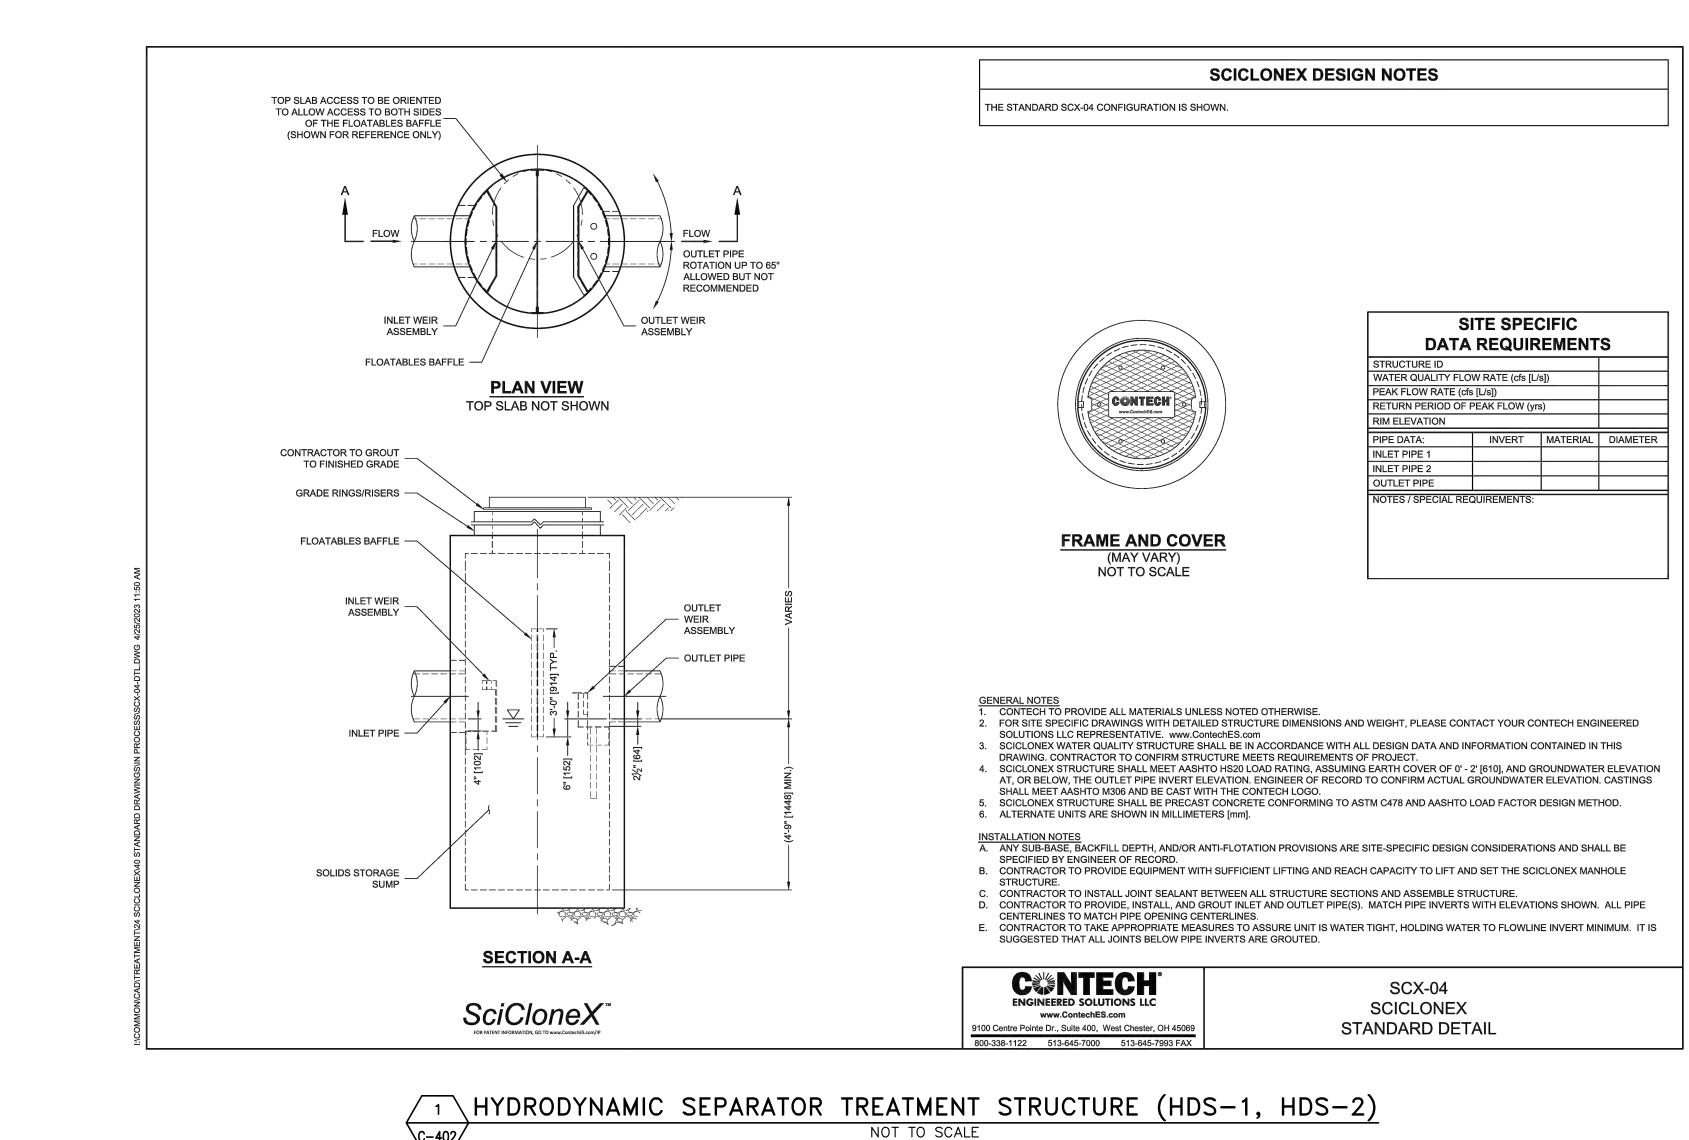- 1. FOUNDATION COURSE FOR PRECAST CONCRETE STRUCTURES SHALL BE PLACED ON A COMPACTED LAYER OF APPROVED CRUSHED STONE HAVING A MINIMUM COMPACTED THICKNESS OF EIGHT (8) INCHES.
- 2. ALL PRECAST CONCRETE STRUCTURES SHALL BE DESIGNED TO ACCOMMODATE AN HS-20 DESIGN LOAD.
- 3. IT SHALL BE THE CONTRACTOR'S RESPONSIBILITY TO FURNISH AND CONSTRUCT THE PROPER SIZE STRUCTURE INCLUDING THE NECESSARY OPENINGS TO ACCOMMODATE THE WORK AS SHOWN ON THE DRAWINGS OR AS ORDERED BY THE ENGINEER (AOBE), AT NO ADDITIONAL COST TO THE OWNER.
- 1,000 PSI COMPRESSIVE STRENGTH IN (1) DAY AND 5,000 PSI COMPRESSIVE STRENGTH IN (28) DAYS AS TESTED PER ASTM C109 AND ASTM C-707. PATCHING PRODUCTS INCLUDE "DURAGROUT" BY L & M CONST. CHEMICAL CO., "FIVE STAR GROUT" BY U.S. GROUT COMPANY OR APPROVED EQUAL.
- 5. REFER TO PROJECT SPECIFICATIONS FOR DRAINAGE AND SANITARY PIPE CONNECTIONS INTO PRECAST CONCRETE STRUCTURES.
- 6. PIPES SHALL BE CUT FLUSH WITH THE INSIDE WALL OF THE STRUCTURE. 7. MINIMUM COMPRESSIVE STRENGTH OF CLASS 'A' CONCRETE (4,000 PSI).
- 8. PRECAST CONCRETE STRUCTURE LIFT HOLES SHALL BE PLUGGED AND MORTARED.
- 9. STRUCTURES SHALL CONFORM TO CURRENT ASTM AND OSHA REQUIREMENTS. 10. PRECAST CONCRETE STRUCTURE JOINTS SHALL CONFORM TO THE CURRENT ASTM DESIGNATION C-443.
- 11. PRECAST CONCRETE STRUCTURES SHALL COMPLY WITH ASTM STANDARD C-478. MANHOLE JOINTS SHALL COMPLY WITH ASTM STANDARD C-443. <u>MANHOLES</u>
- 1. FOR PRECAST CONCRETE MANHOLES FIVE (5) FEET OR LESS IN HEIGHT, TOP CONE SECTION SHALL BE REPLACED WITH PRECAST REINFORCED CONCRETE SLAB (6" MIN. THICKNESS) WITH OPENING OF SUFFICIENT SIZE TO ACCOMMODATE MANHOLE CASTING. 2. FOR MANHOLES 10 FEET OR MORE IN DEPTH, MANHOLE DIAMETER SHALL BE FIVE (5) FEET.
- 3. TERMINAL MANHOLE FLOORS SHALL BE SLOPED TOWARD OUTFALL PIPE.

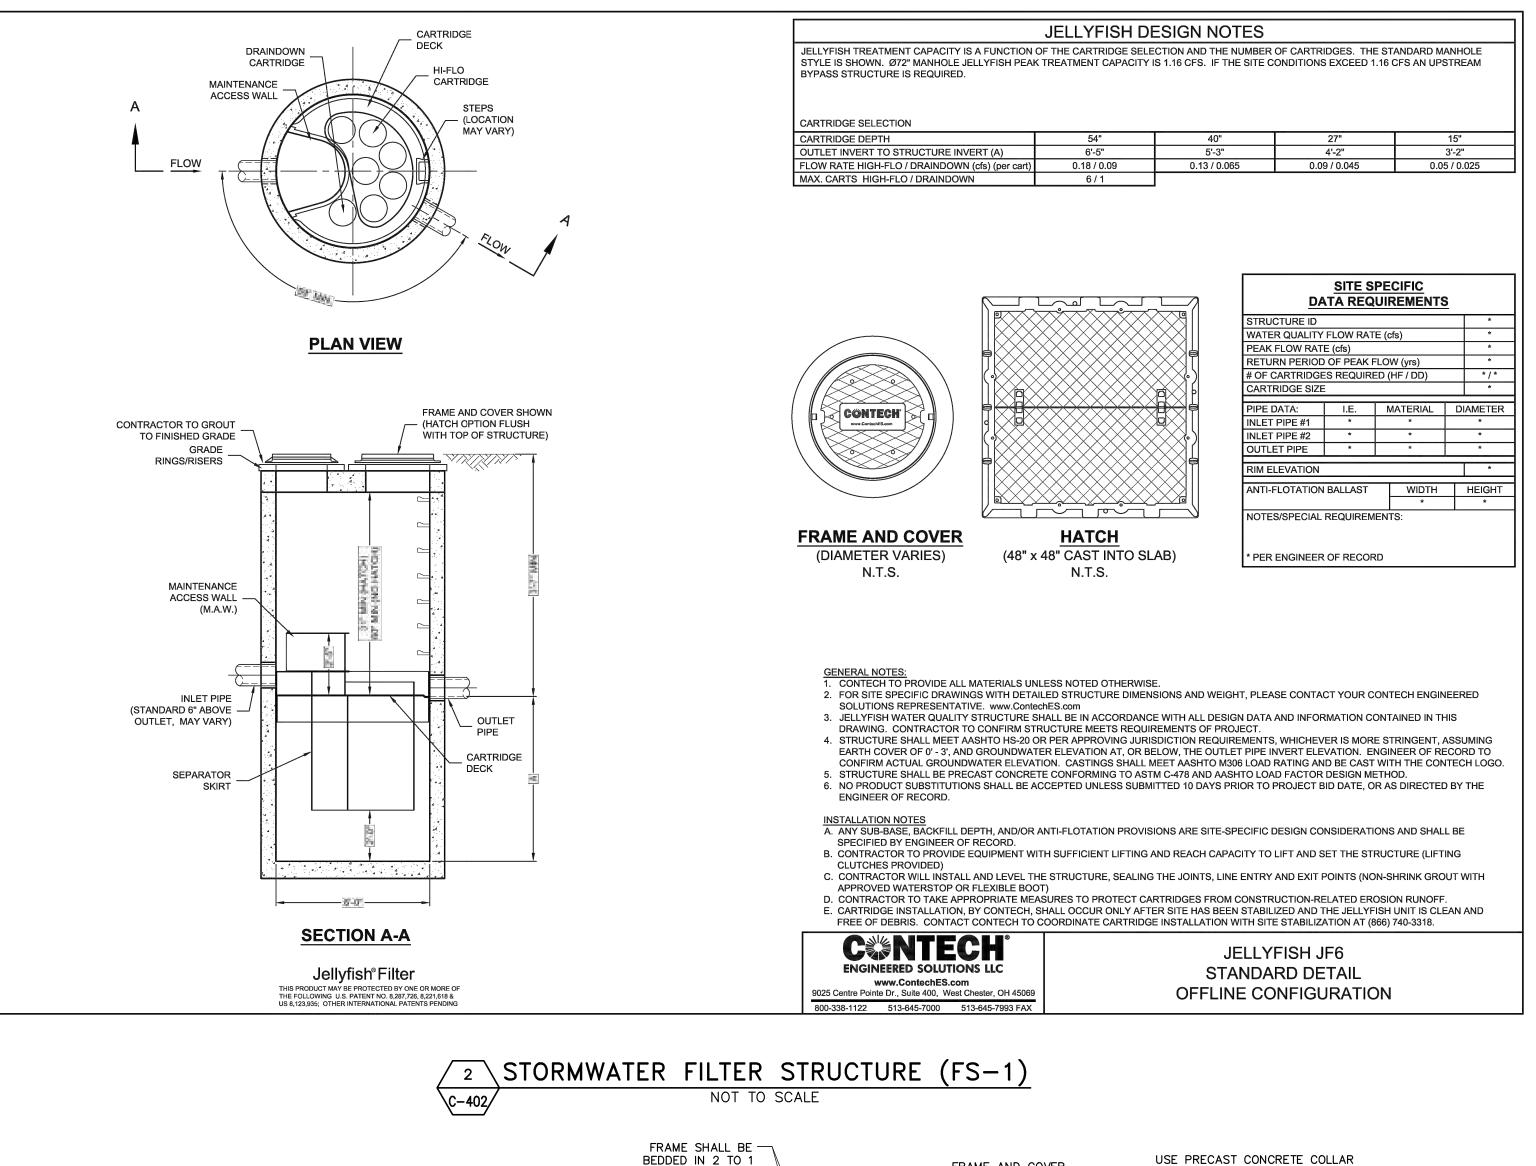


CATCH BASINS AND OUTLET CONTROL STRUCTURES


- 1. STEPS WILL NOT BE REQUIRED IN CATCH BASINS LESS THAN FOUR (4) FEET IN DEPTH. STEPS WILL BE REQUIRED IN CATCH BASINS FOUR (4) FEET OR GREATER IN DEPTH. DEPTHS FOR CATCH BASINS SHALL BE MEASURED FROM FINISHED GRADE TO INSIDE BOTTOM OF STRUCTURE (INCLUDING SUMP AS APPLICABLE).
- 2. STEPS SHALL BE LOCATED WITHIN STRUCTURE TO AVOID PLACEMENT OVER PIPES.
- 3. WHEN STEPS ARE REQUIRED, STEPS SHALL COMPLY WITH THE SAME REQUIREMENTS OF ASTM STANDARD C-478, ARTICLE
- 13 ENTITLED "MANHOLE STEPS & LADDERS". 4. PROVIDE REINFORCED CONCRETE TOP SLAB FOR OVERSIZED CATCH BASIN WITH PROPER SIZE OPENING TO ACCOMMODATE
- INSTALLATION OF CASTING (FRAME & GRATE).
- 5. FOR ALL STRUCTURES GREATER THAN 10 FEET IN DEPTH, STRUCTURES SHALL PROVIDE MINIMUM INSIDE DIMENSIONS OF 4 FEET X 4 FEET.

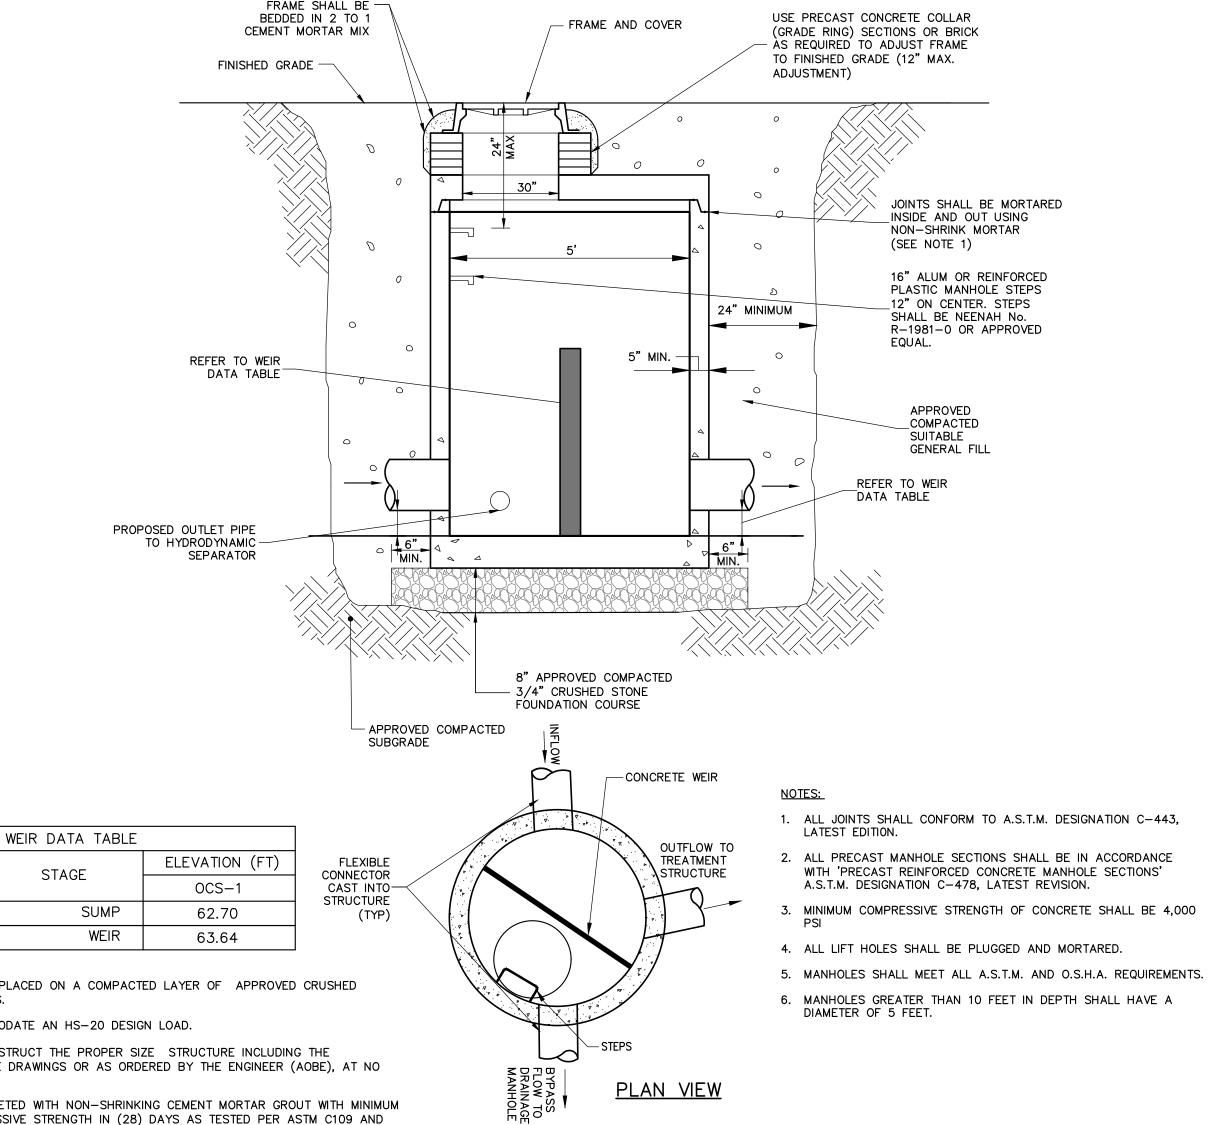
OUTLET CONTROL STRUCTURE C-402/ NOT TO SCALE


4. ALL REQUIRED PATCHING FOR DRAINAGE STRUCTURES SHALL BE COMPLETED WITH NON-SHRINKING CEMENT MORTAR GROUT WITH MINIMUM

HARRISON **RECREATION &** COMMUNITY CENTER New Construction - Phase ' Town / Village of Harrison 270 Harrison Avenue Harrison, NY 10528 KG+D ARCHIT 285 MAIN STREET • MOUNT KISCO, NEW YORK 10549 P:914.666.5900 KGDARCHITECTS.COM Woodard & Curran Woodard & Curran Engineering & Geological Services PA PC 800 Westchester Avenue, Suite N507 Rye Brook, New York 10573 800.807.4080 | www.woodardcurran.com CONSTRUCTION DOCUMENTS NOTE: ALL IDEAS, DESIGNS, ARRANGEMENTS AND PLANS INDICATED OR REPRESENTED BY THIS DRAWING ARE OWNED BY AND ARE THE PROPERTY OF KG+D ARCHITECTS, PC (KG+D), AND WERE CREATED FOR USE ON THIS PROJECT. NONE OF SUCH IDEAS, DESIGNS, ARRANGEMENTS OR PLANS SHALI BE USED BY OR DISCLOSED TO ANY PURPOSE WHATSOEVER WITHOUT THE WRITTEN PERMISSION OF KG+D. WRITTEN DIMENSIONS ON THIS DRAWING SHALL HAVE PRECEDENCE OVER SCALED DIMENSIONS. CONTRACTOR SHALL VERIFY ALL ACTUAL DIMENSIONS AND CONDITIONS ON THE JOB AND THE ARCHITECT MUST BE NOTIFIED OF ANY VARIATIONS FROM DIMENSIONS AND CONDITIONS SHOWN. SHOP DETAILS MUST BE SUBMITTED TO THIS OFFICE FOR APPROVAL BEFORE PROCEEDING WITH FABRICATION. ALTERATIONS BY ANY PERSON, IN ANY WAY, OF ANY ITEM CONTAINED ON THIS DOCUMENT, UNLESS ACTING UNDER THE DIRECTION OF THE LICENSED ARCHITECT WHOSE PROFESSIONAL SEAL IS AFFIXED HERETO, IS A VIOLATION OF TITLE VII, SECT. 69.5 (b) OF NEW YORK STATE LAW. © COPYRIGHT KG+D ARCHITECTS, PC ALL RIGHTS RESERVED. 4 07/12/2023 ISSUE FOR BID - PHASE 1 3 06/09/2023 ISSUE FOR PERMIT - PHASE 1 2 06/01/2020 DESIGN DEVELOPMENT 1 03/31/2020 50% DESIGN DEVELOPMENT No. Date Issue Sheet Title CONSTRUCTION DETAILS Job No Date 2020-1005 06/29/2023 Scale Drawn / Checked CJL/JLMT AS NOTED Sheet Number C-402

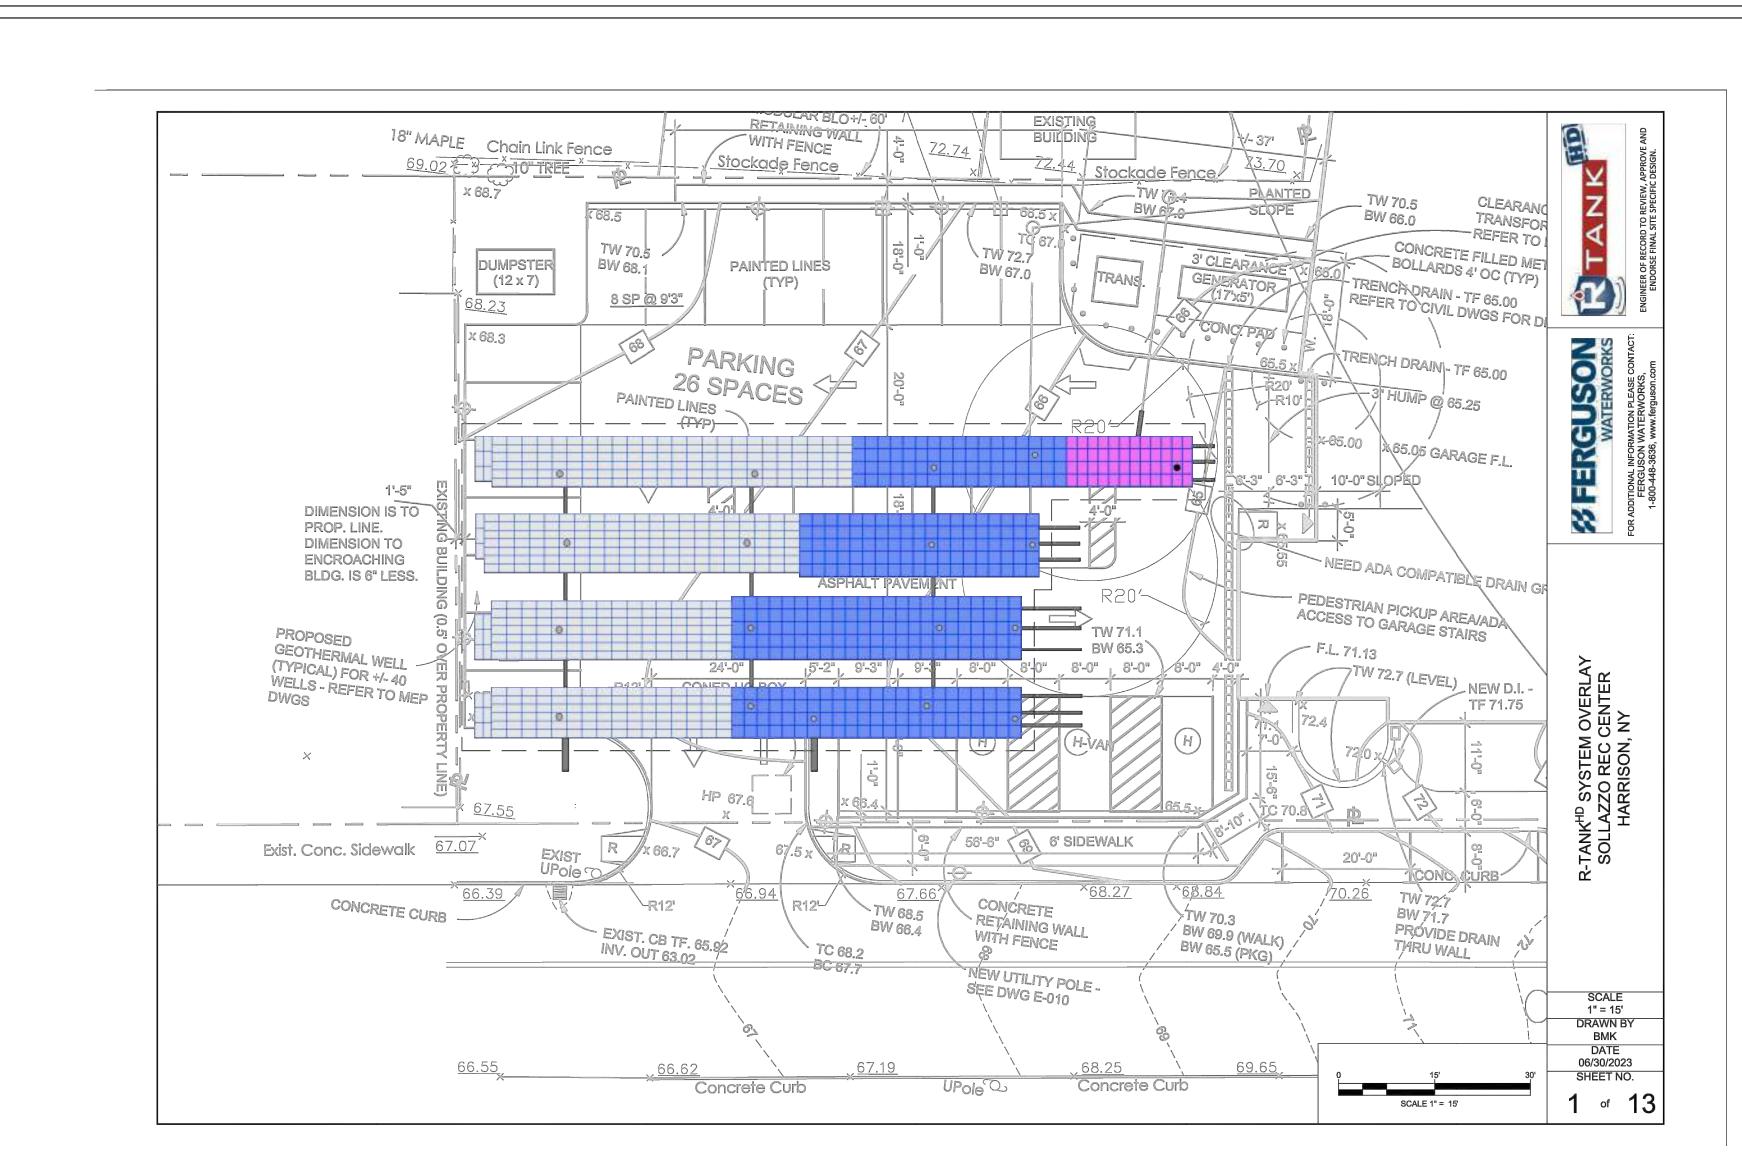


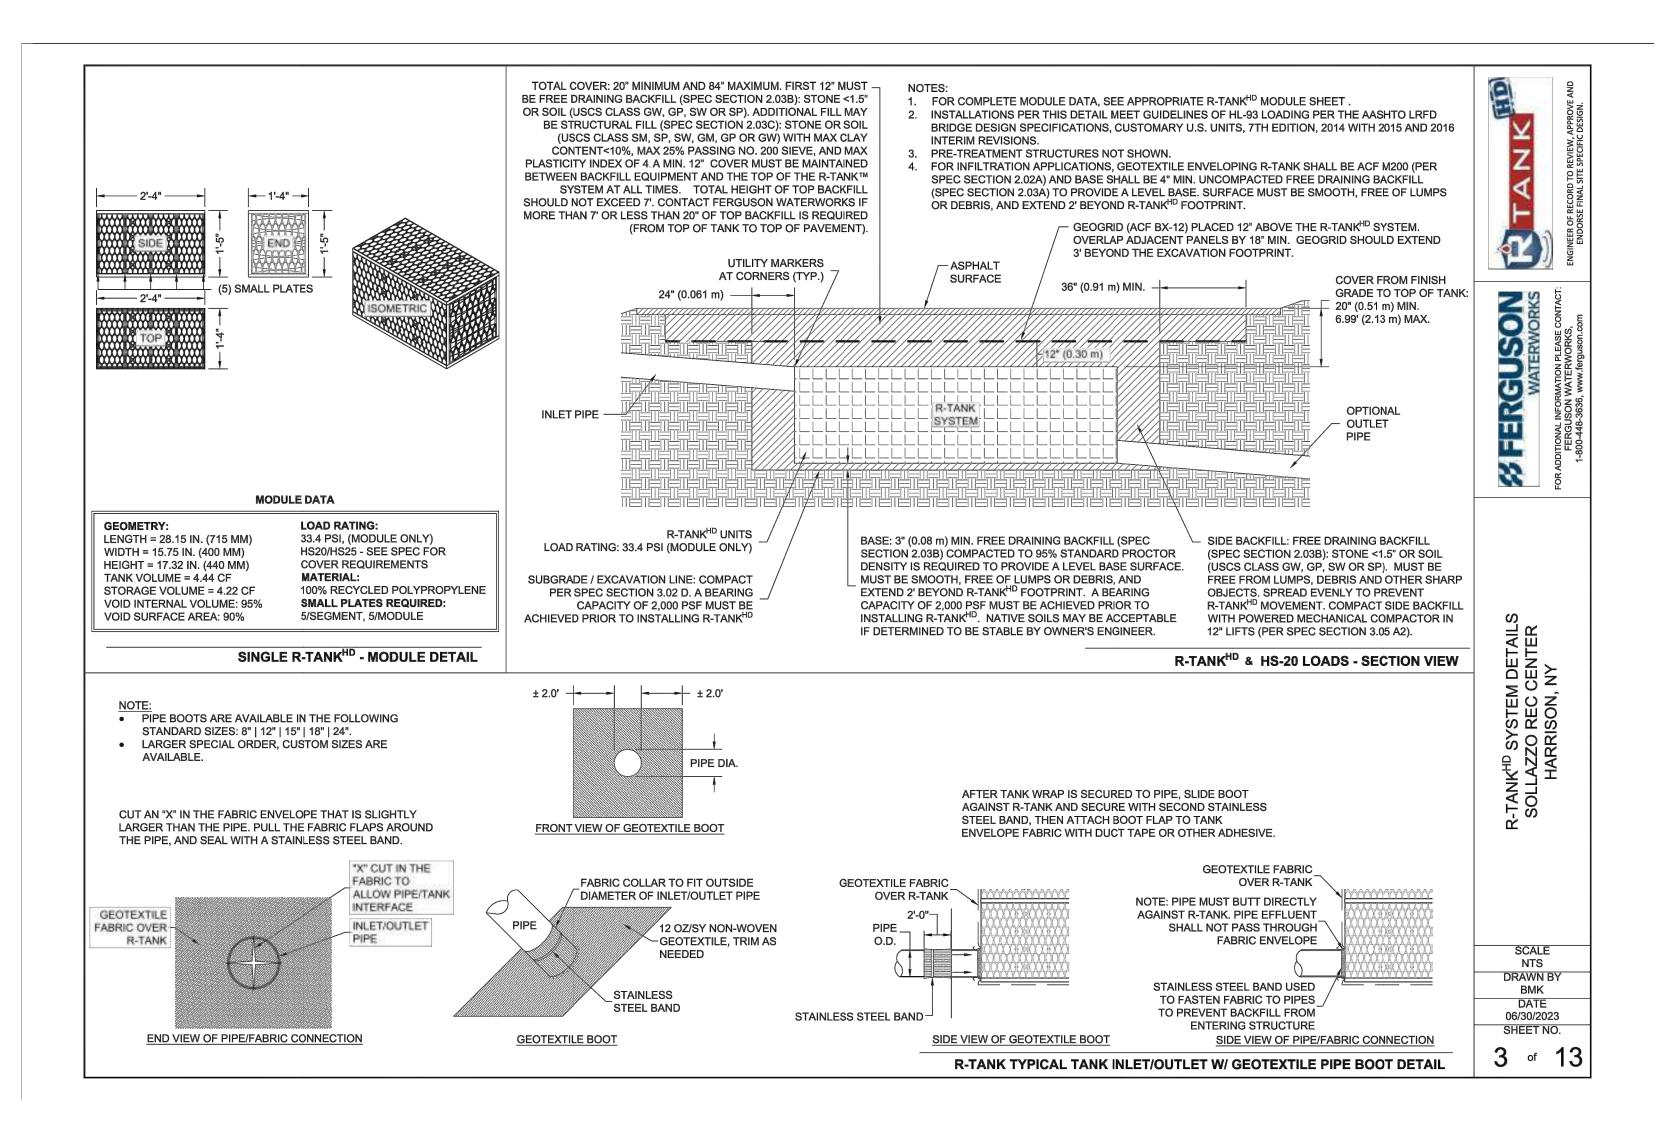


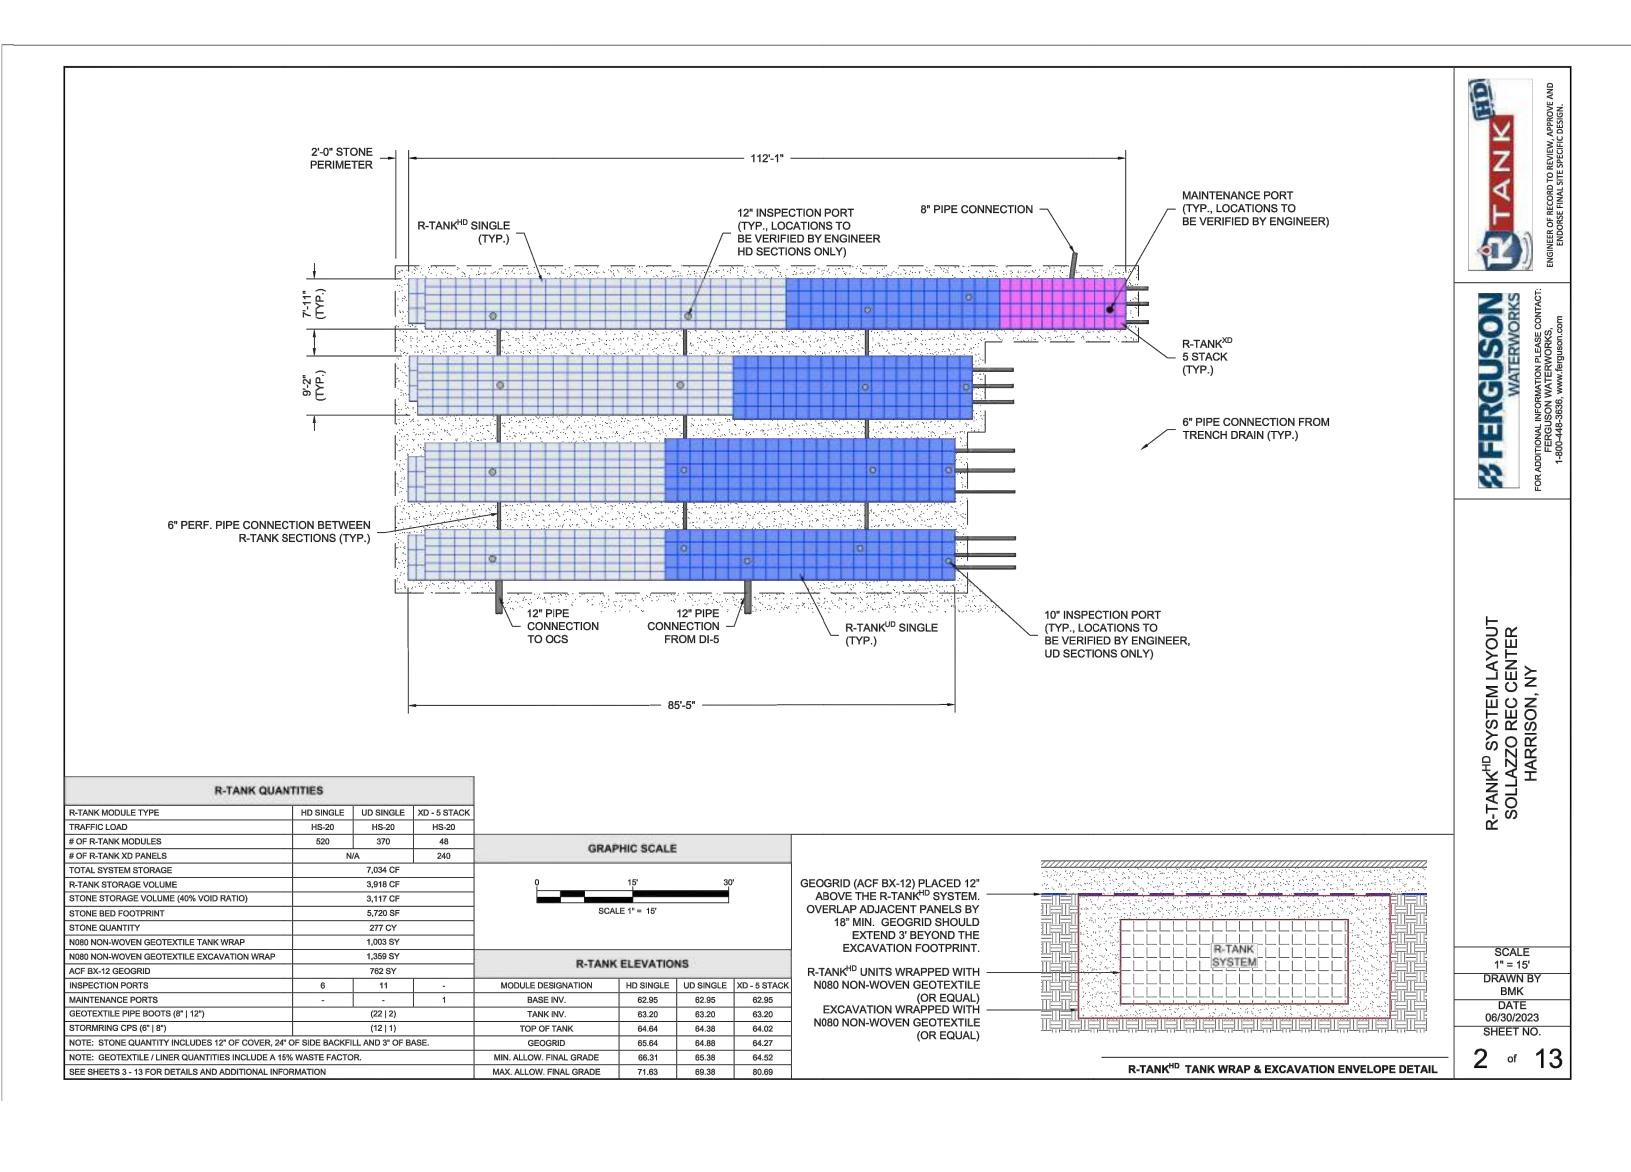


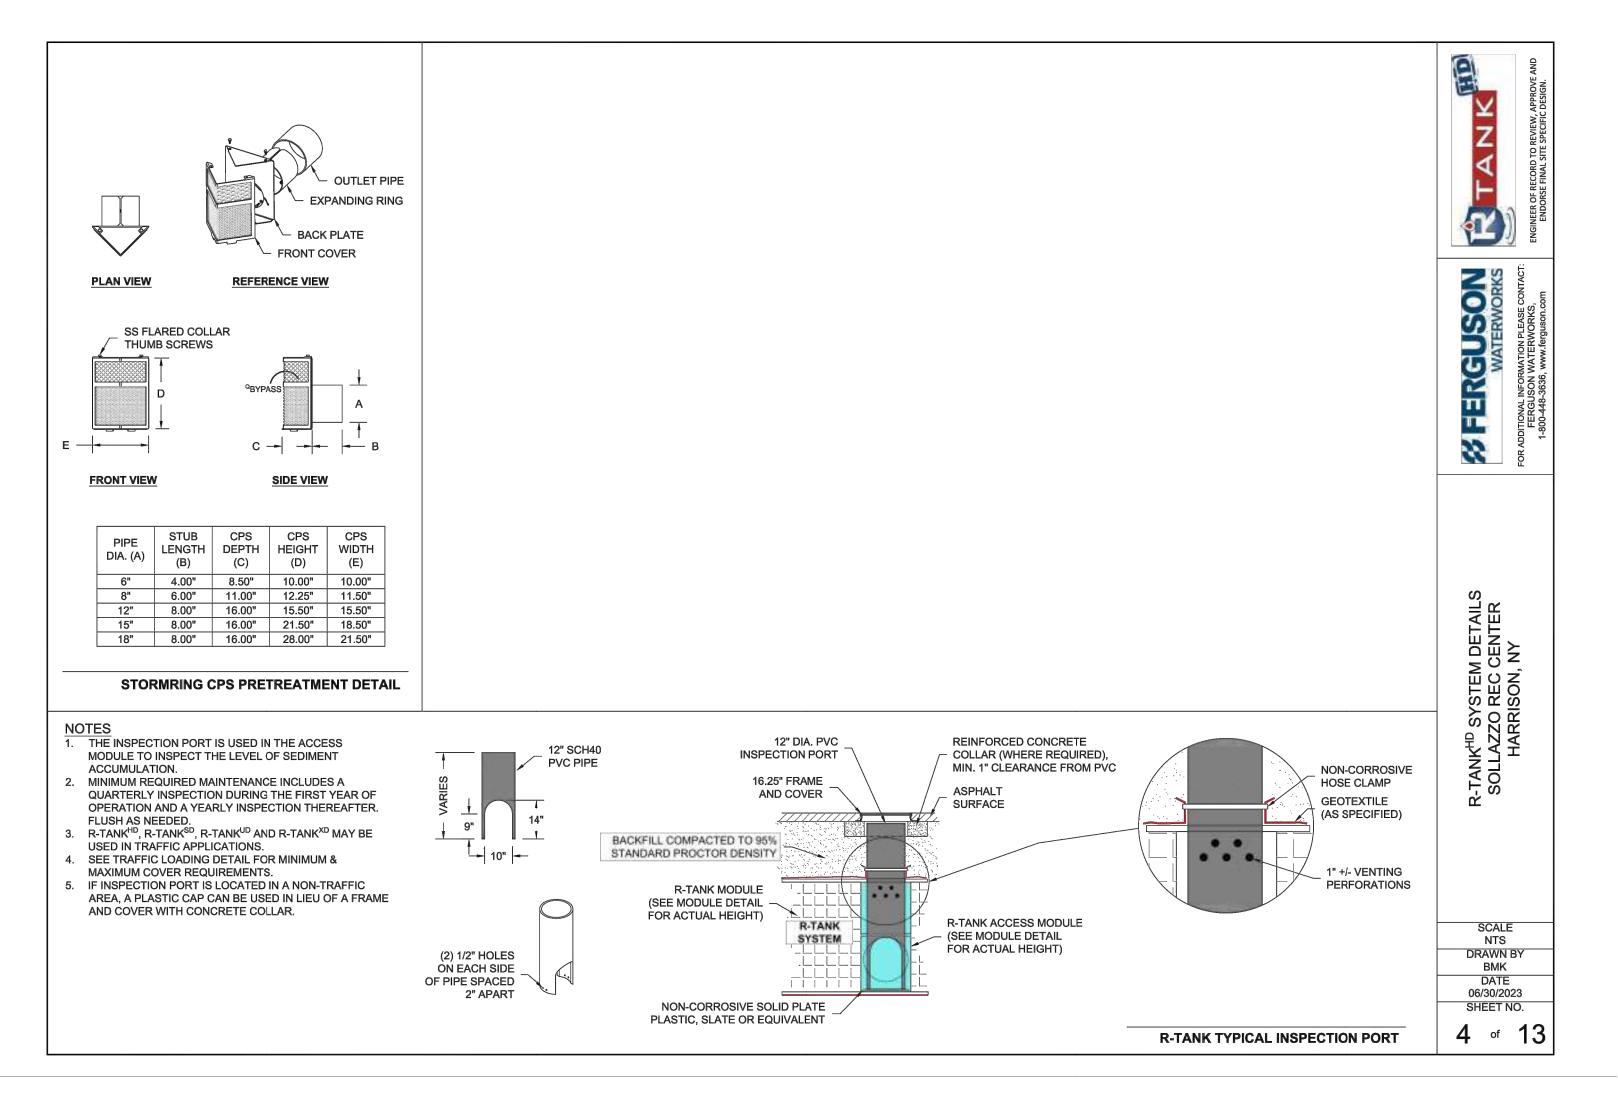


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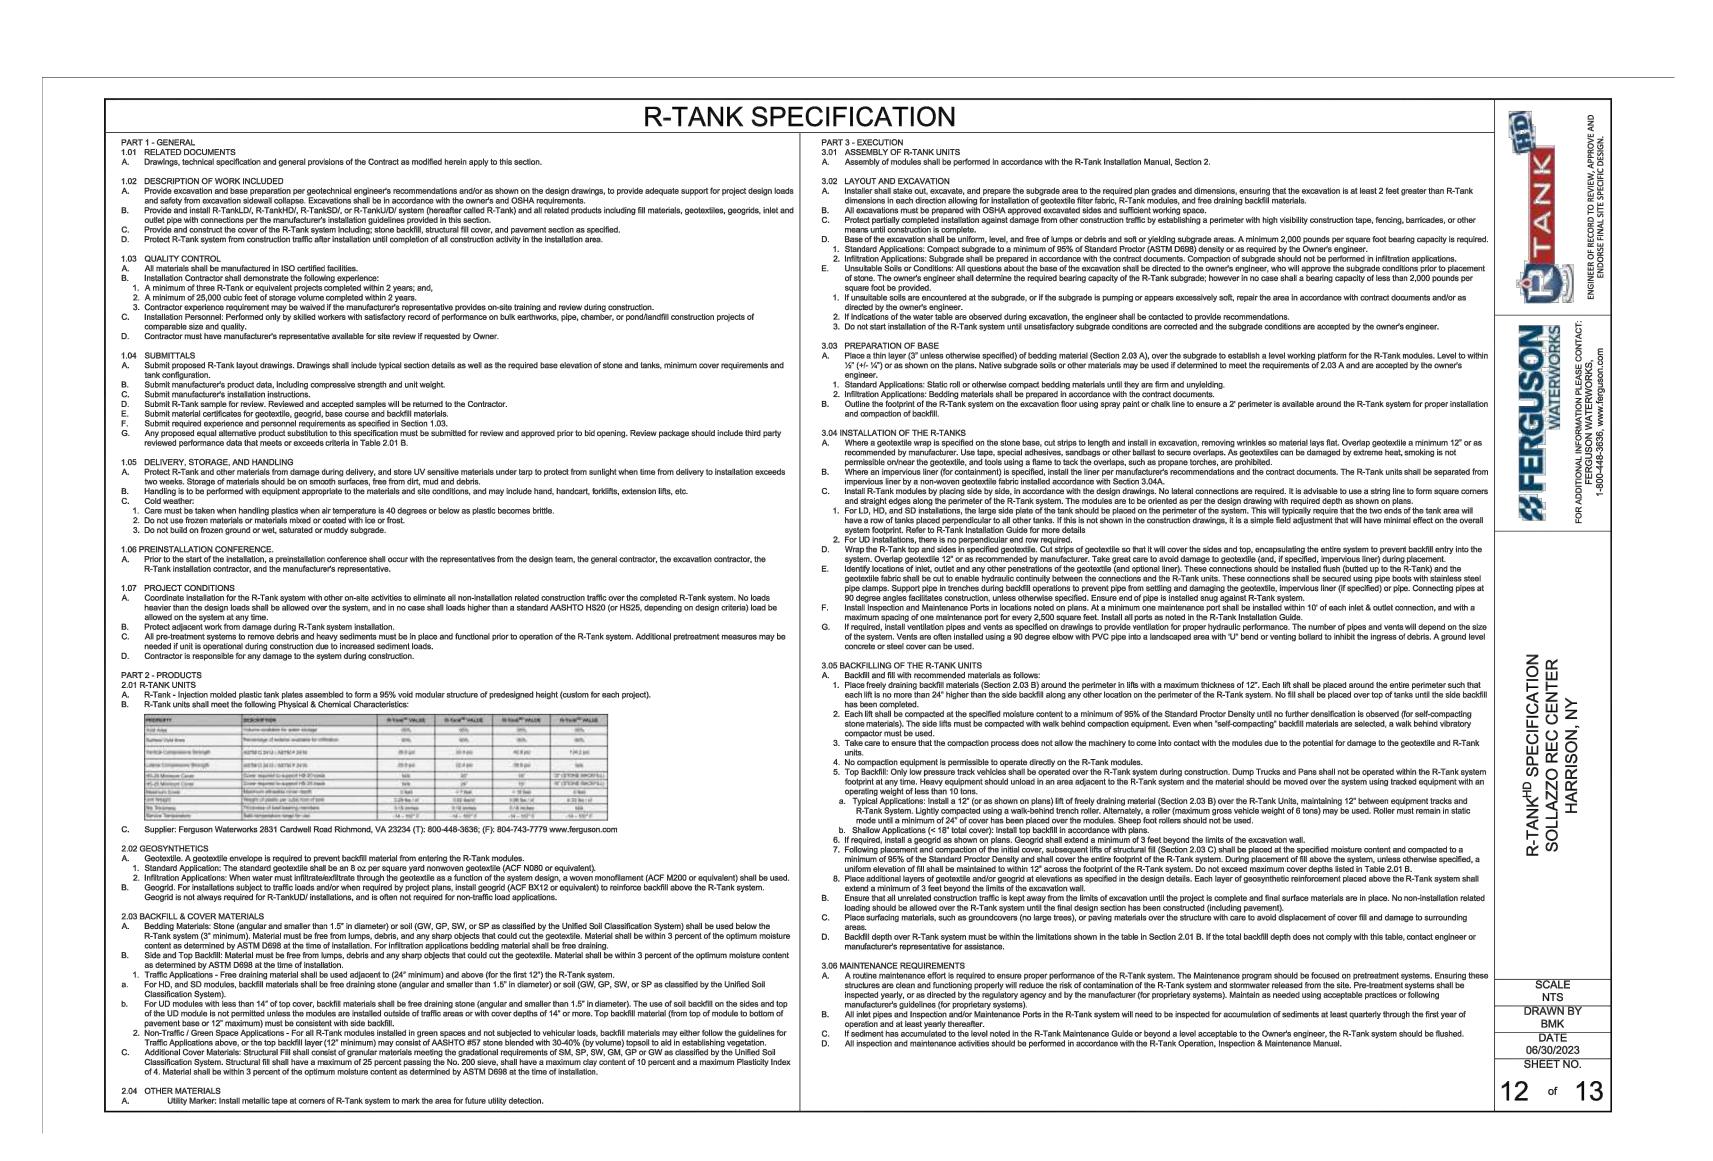


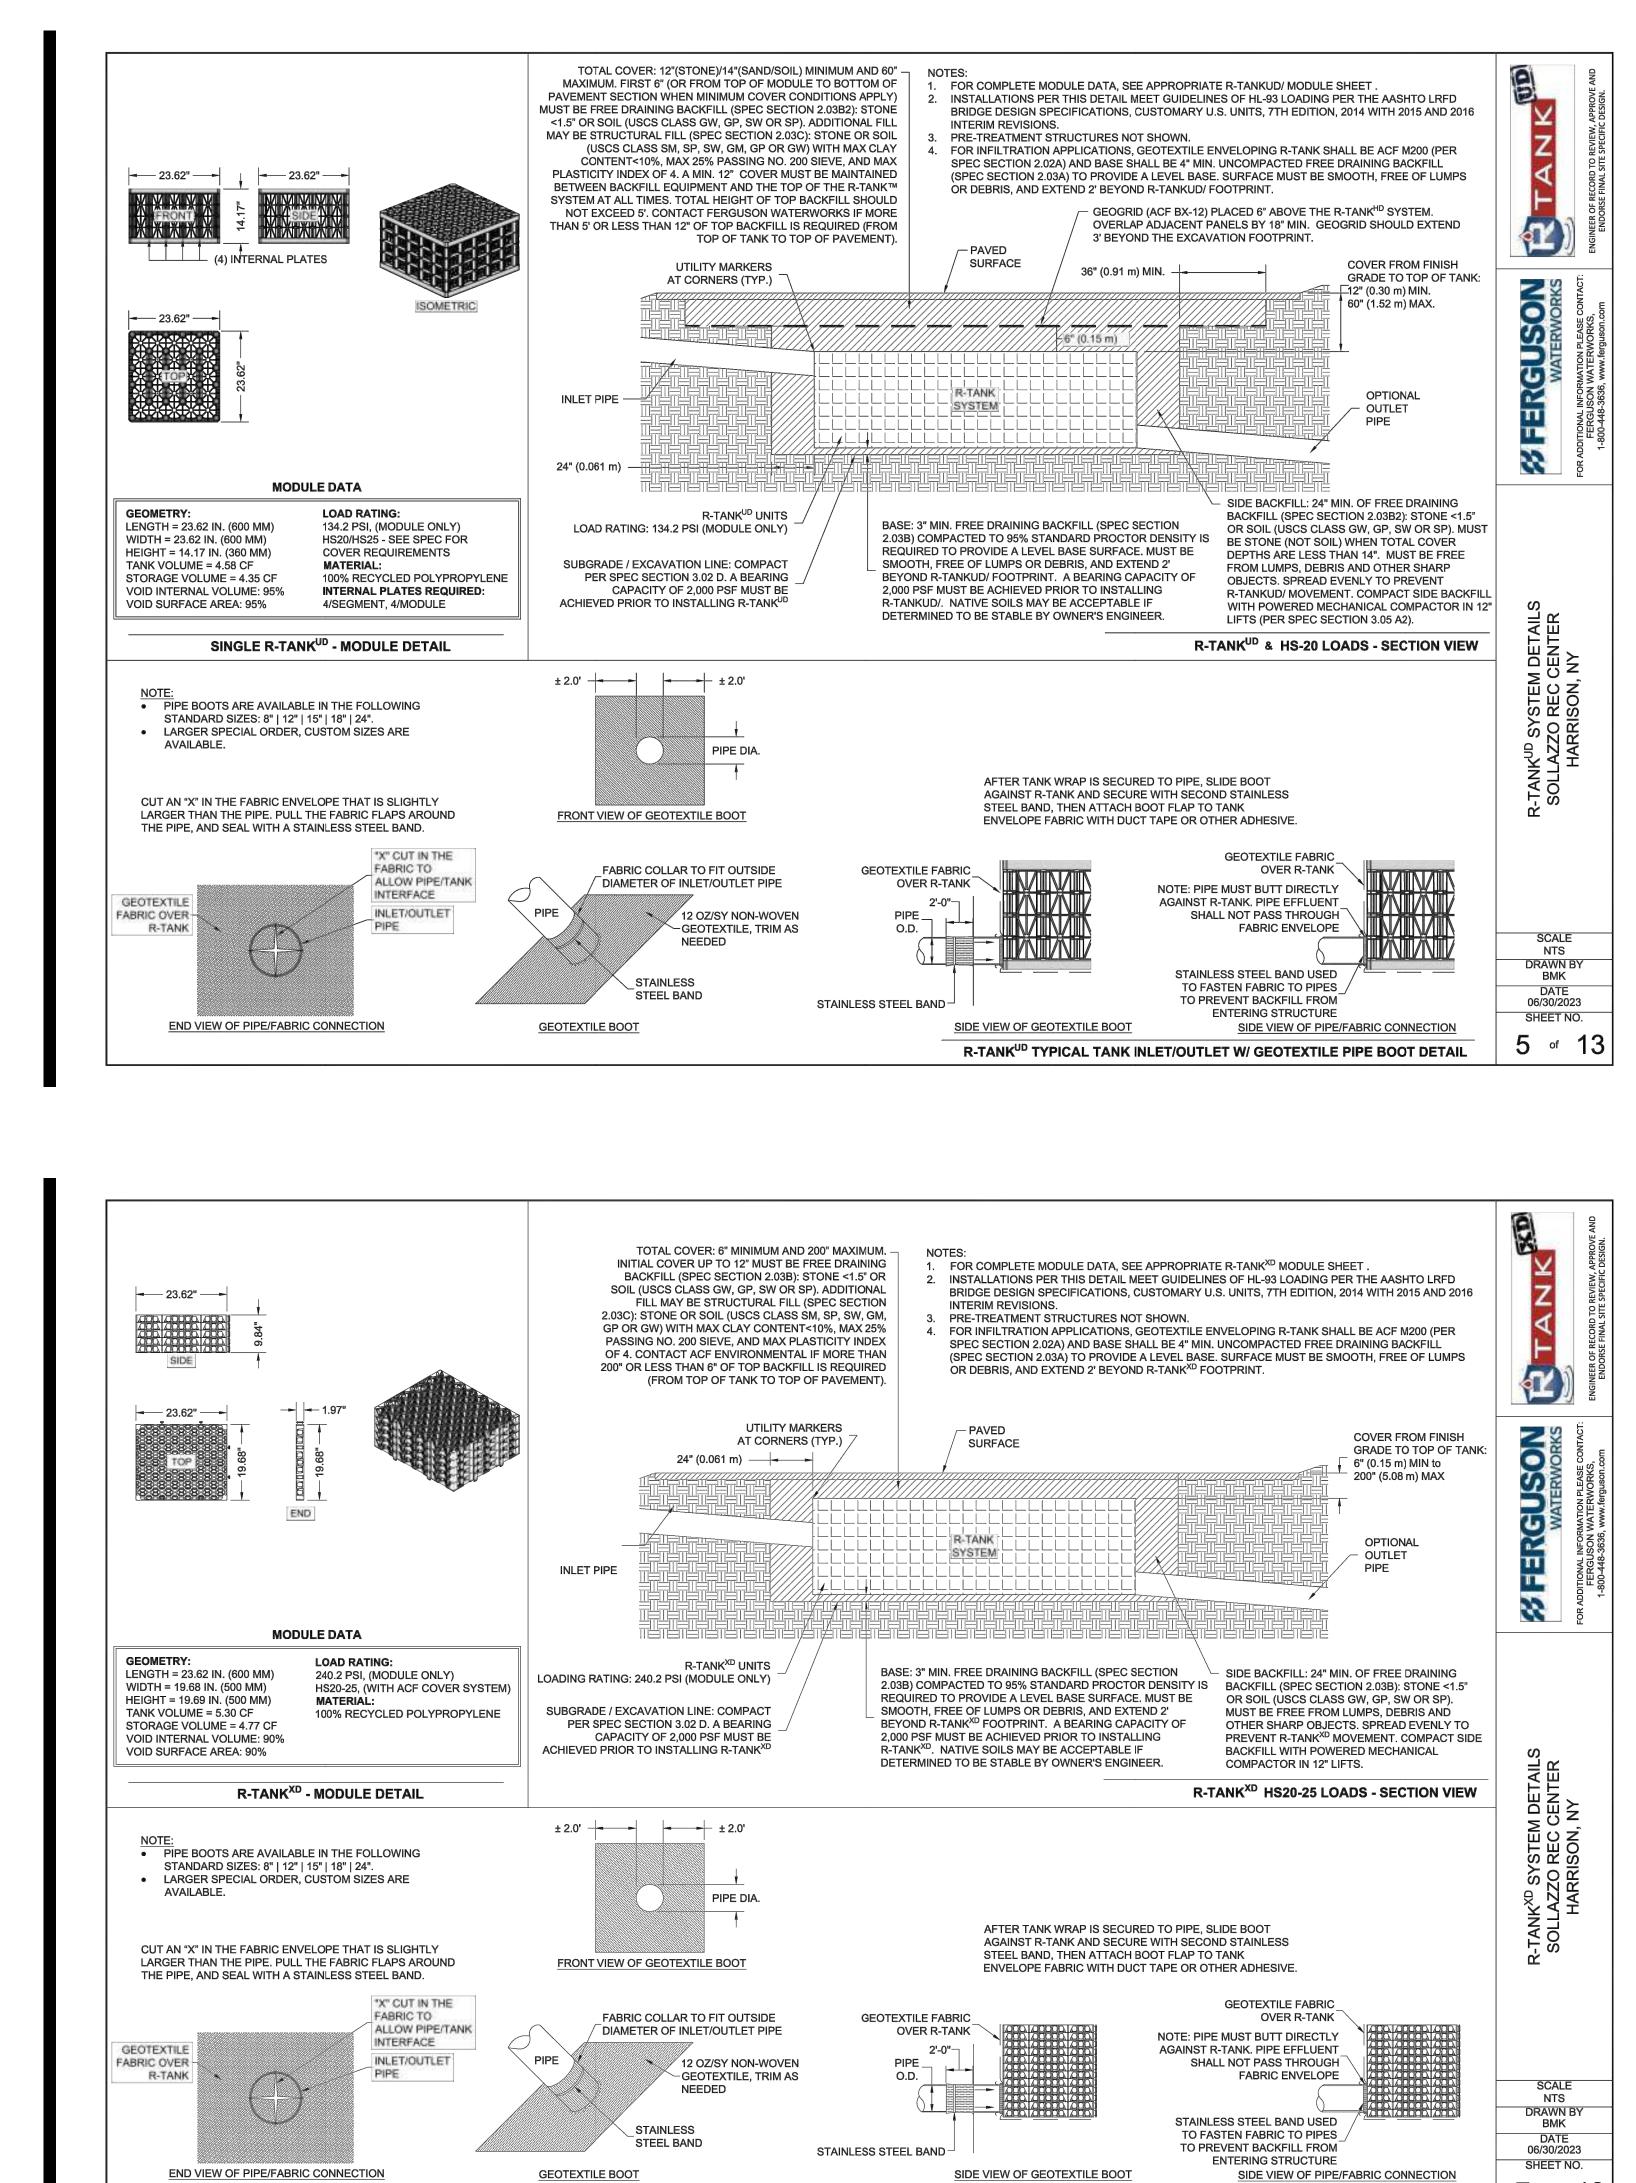


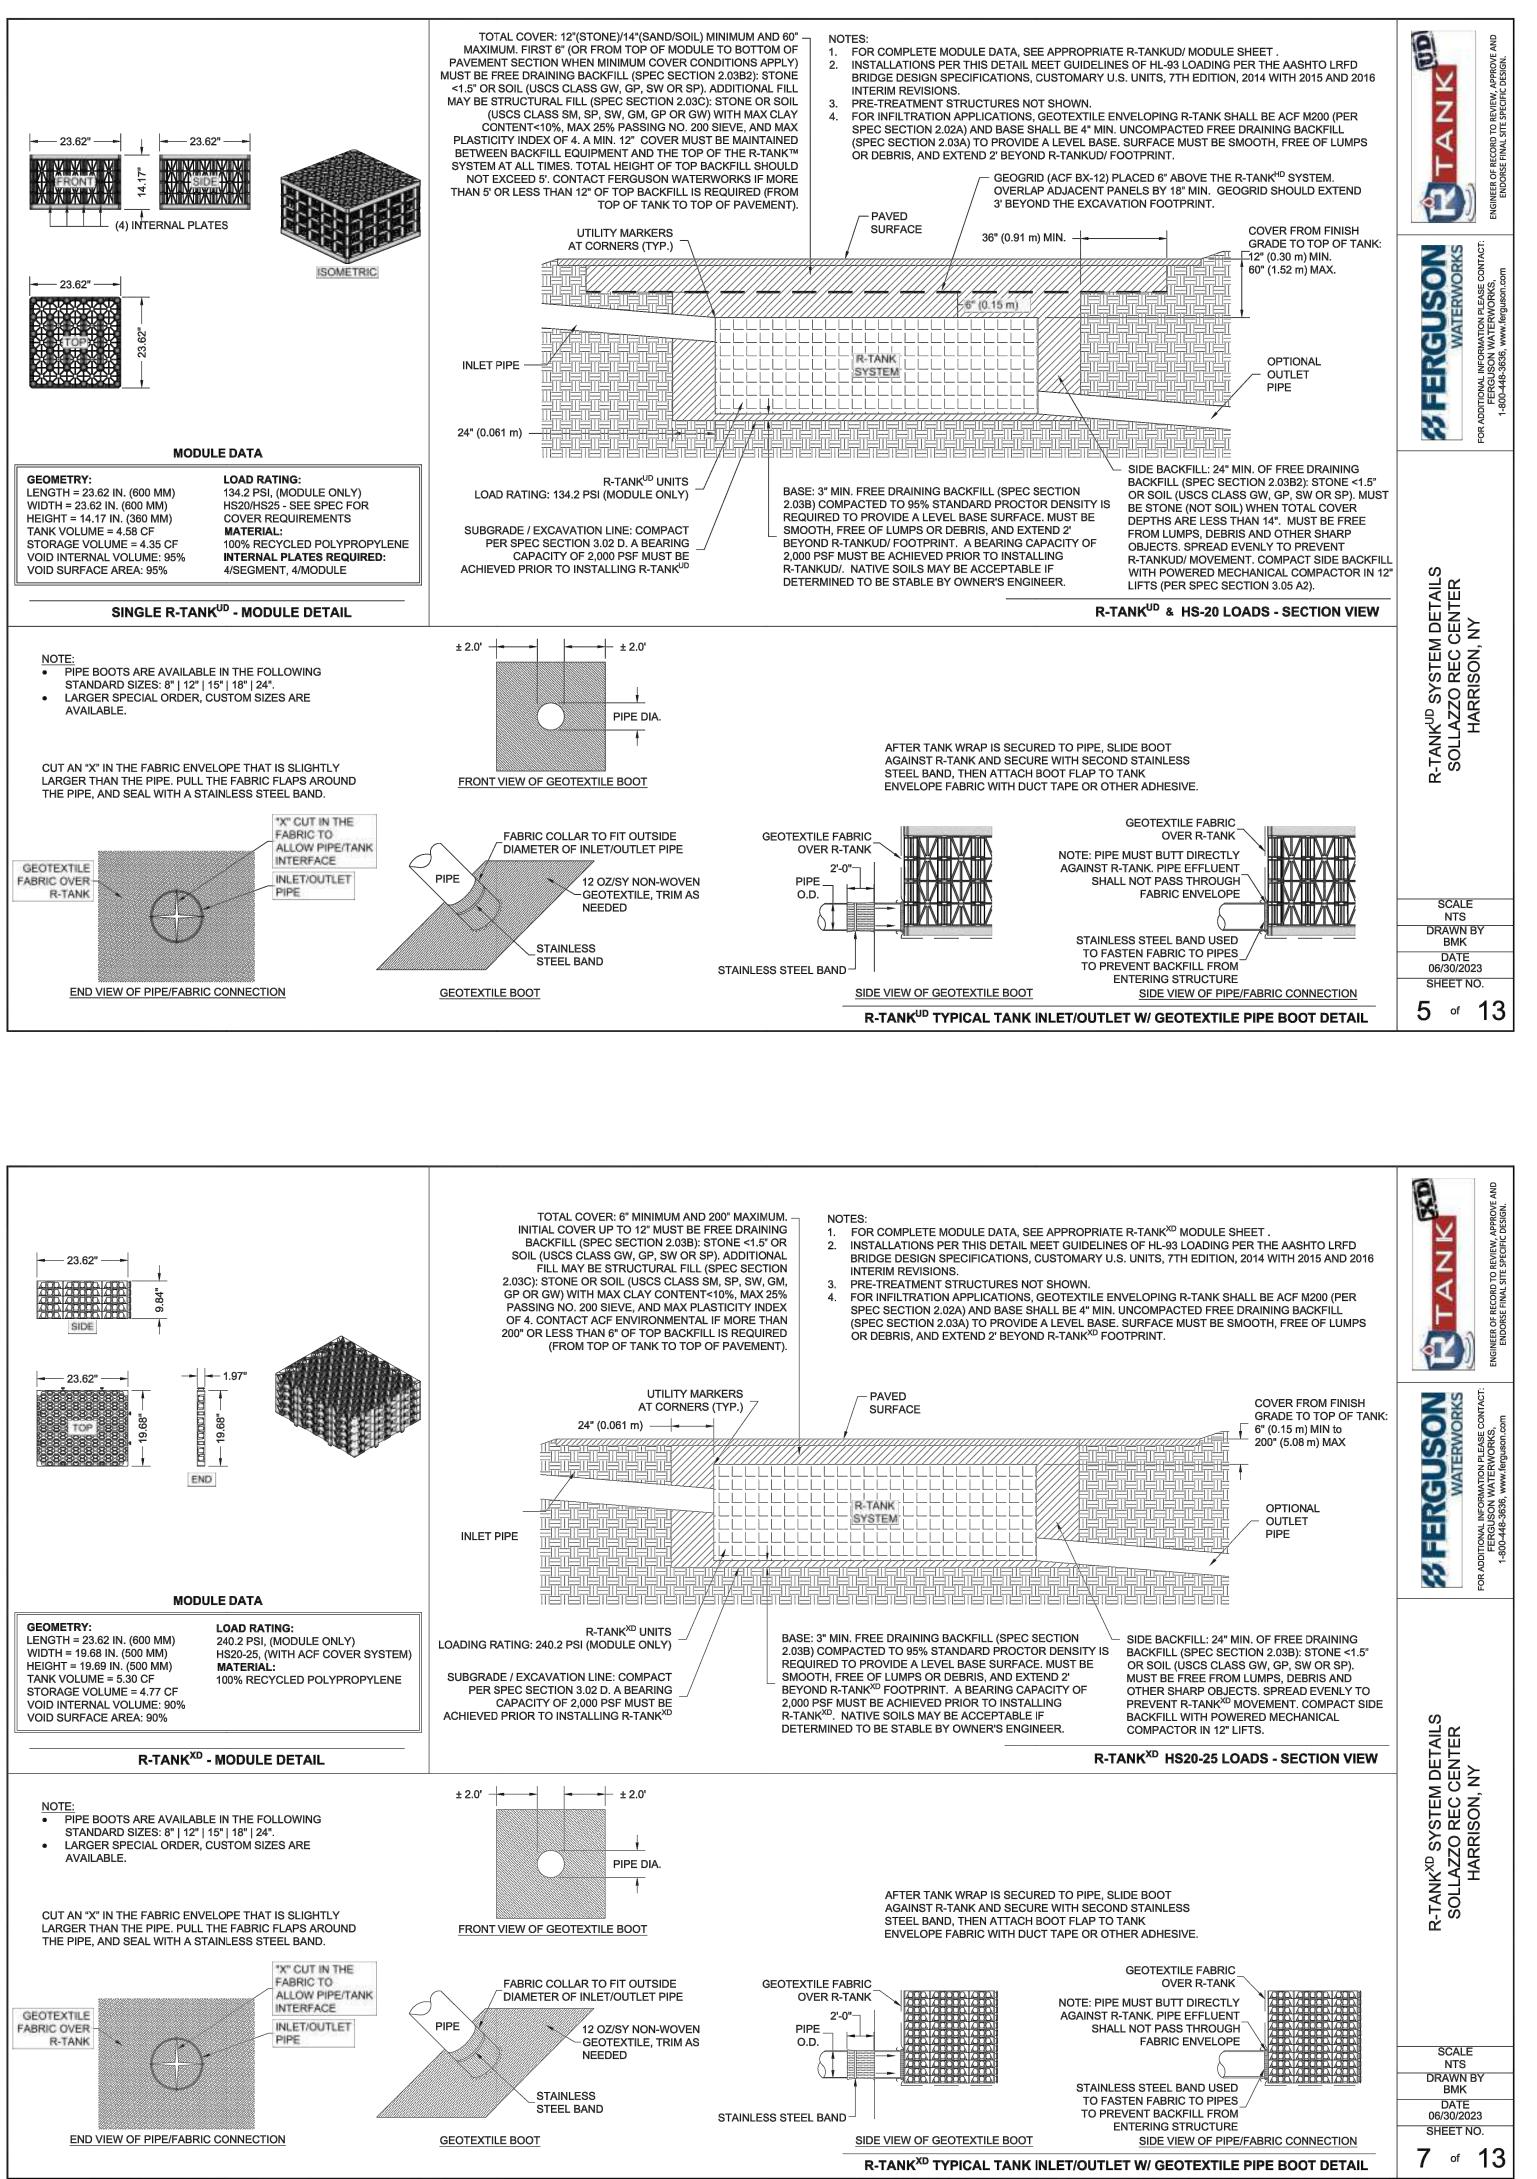

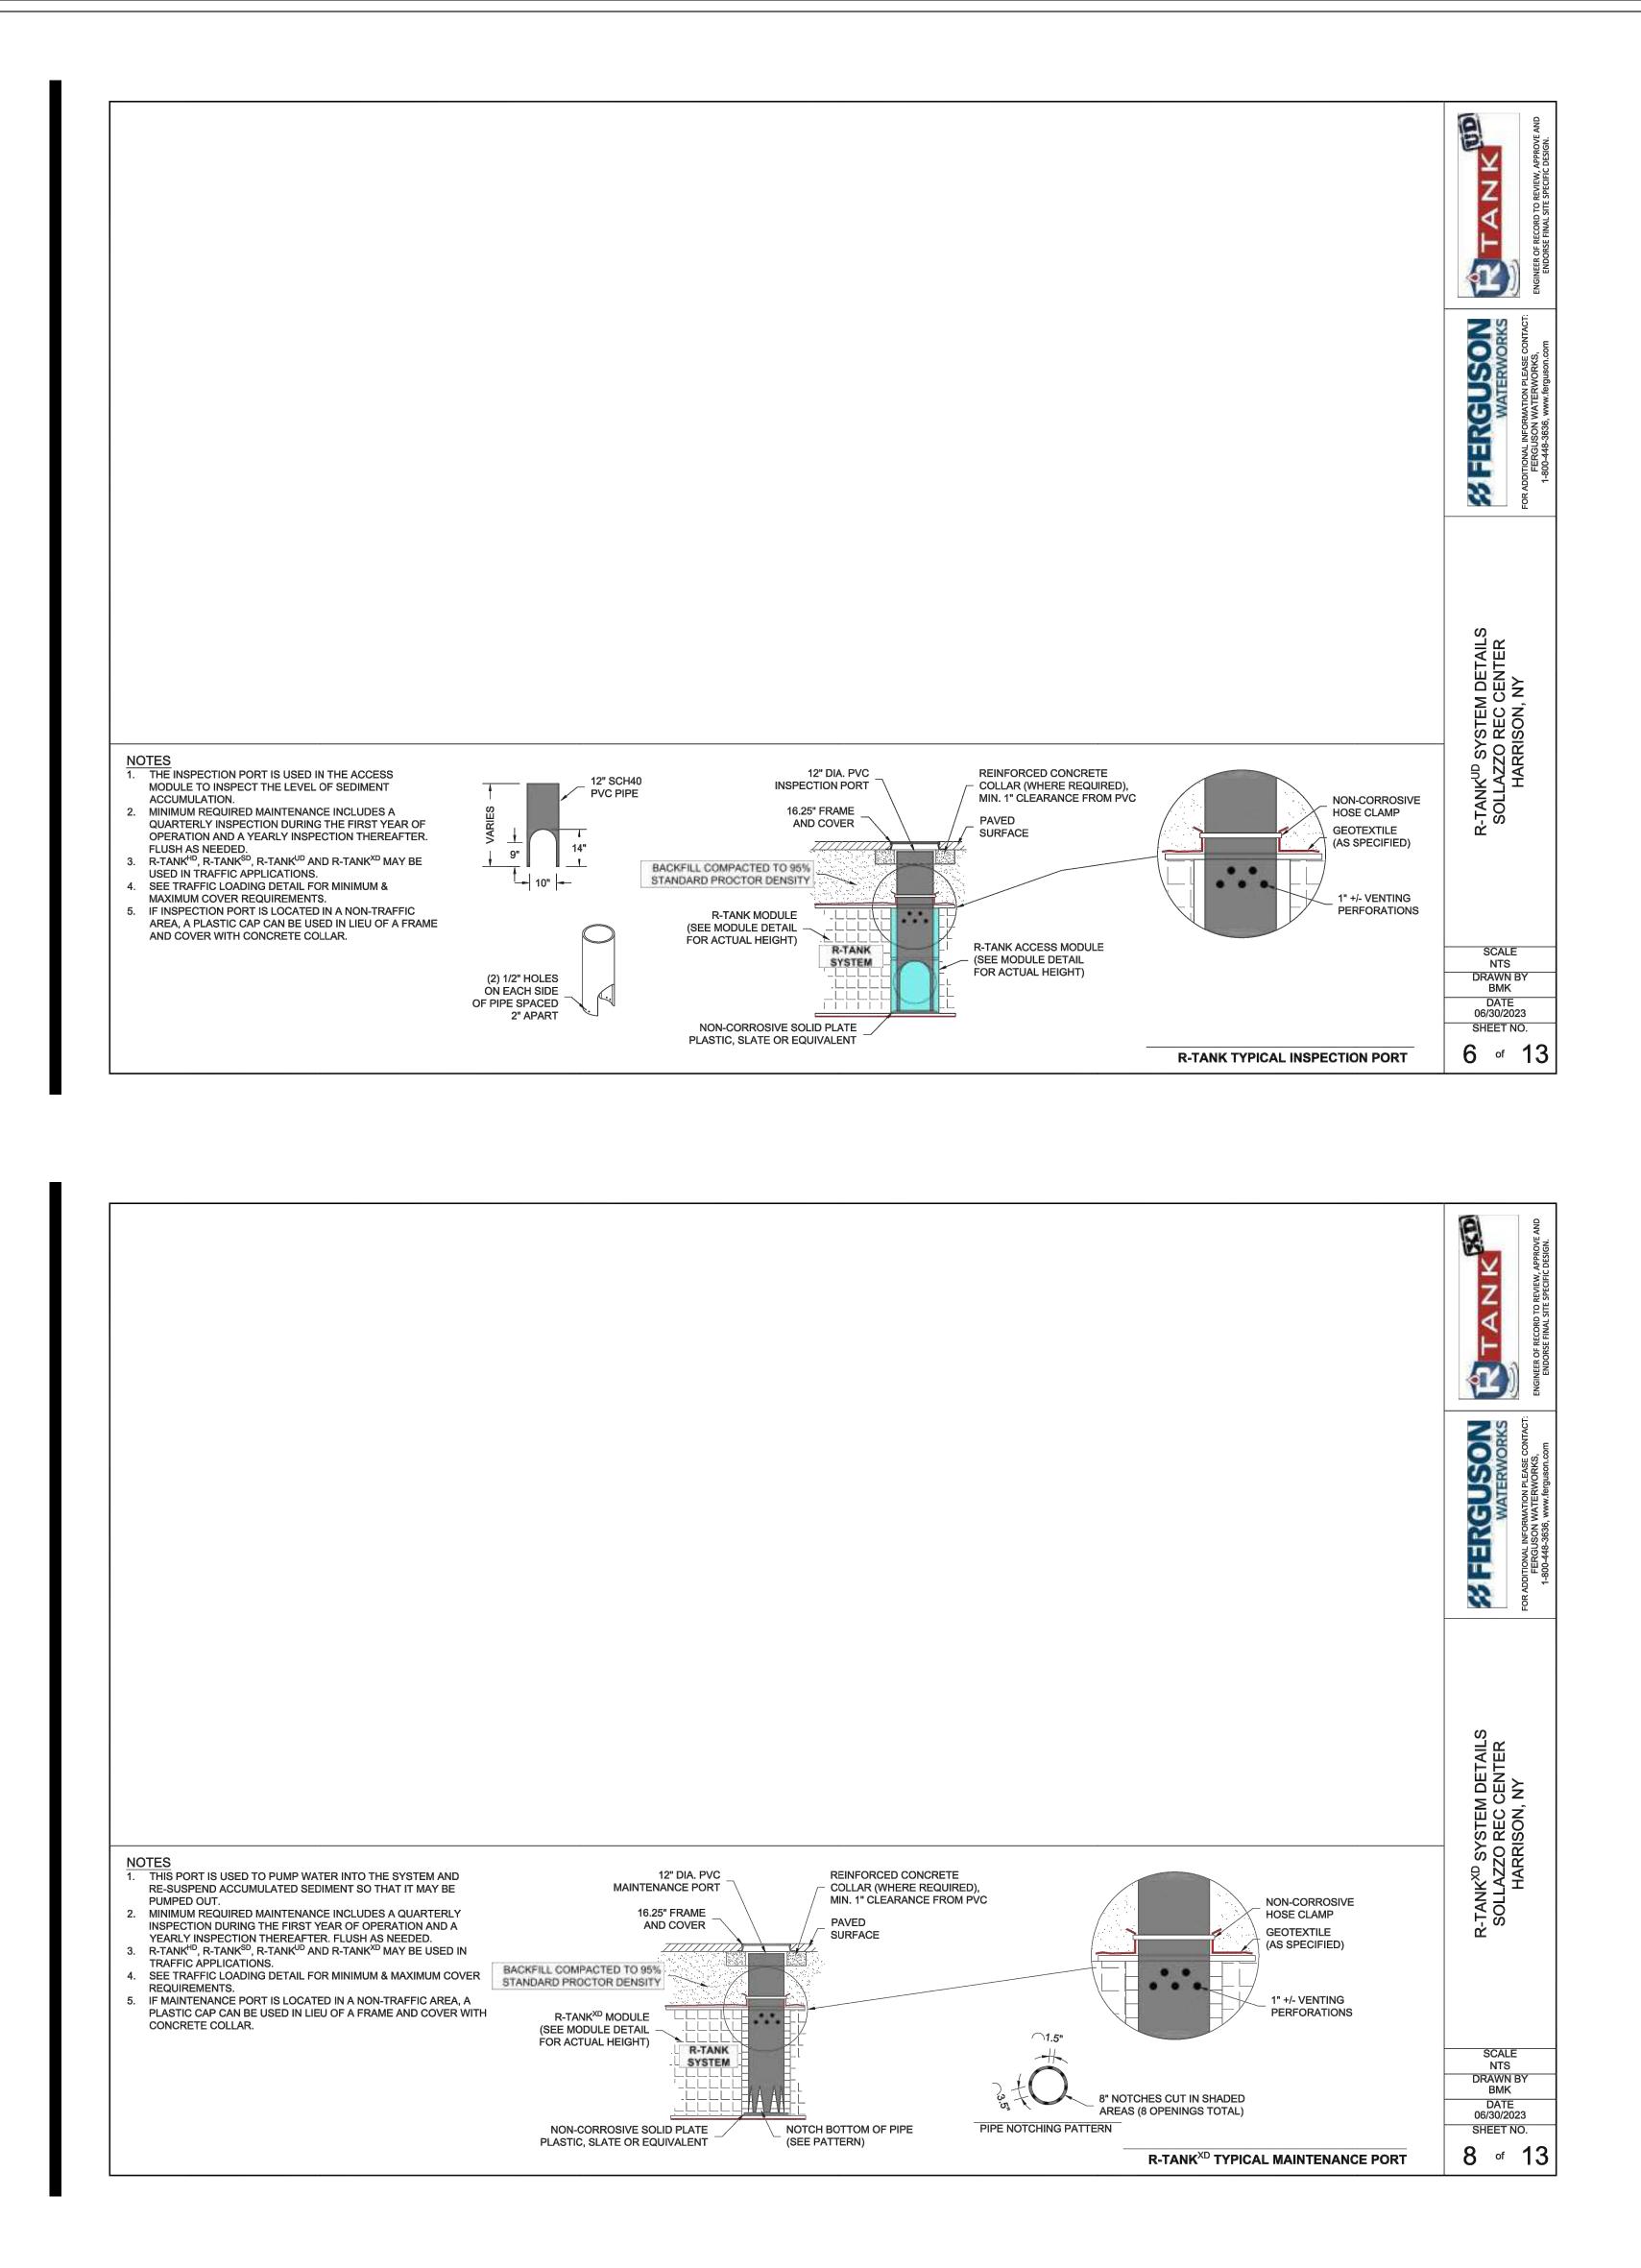
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General Notes: 1 The purpose of these drawings is to show the structural work associated with Harrison Recreational Center in Harrison, NY. 2 The work shown on these drawings has been designed in accordance with the structural requirements of the 2020 edition of the Building Code of New York State. 3 The structural components have been designed for the following loads: A. Uniform live load: Corridors 100 psf First floor 6arages Passenger vehicles 40 psf Office buildings Corridors above first floor Coffices 50 psf + 15 psf partitions Recreational uses Gymnasiums Stairs and exits 100 psf	 11 The contractor and subcontractors shall obtain the latest copies of approved plans and surveys and they shall familiarize themselves thoroughly with these plans before commencing any work. 12 These drawings are supplemented by a detailed technical specification. The notes shown under certain categories of work are intended to summarize basic requirements. 13 Work shown as "Typical Details" apply throughout the project as required. Work shown as "Sections" shall be considered to apply for the same and similar conditions in the building. 14 Some details of the work are shown on the architectural drawings. A careful review and study of these details are necessary before the full scope of the work can be comprehended. 15 Do not scale drawings. Codes and Standards References 1 Concrete: Concrete work shall conform to the requirements of: ACI 301-10, "Specifications for Structural Concrete in Buildings" and ACI 318-14, "Building Code Requirements for Structural Concrete". 2 Structural steel: Design, fabrication and erection of structural steel shall conform to the "Specification for Structural Steel for Buildings" as adopted on July 7, 2016, by the American Institute of Steel Construction (AISC) and the 15th Edition of the AISC Steel Construction Manual.
All other 100 psf Live load has been reduced on girders, columns and footings in accordance with the building code B. Roof loads: Snow: Ground snow load, pg 20 psf Flat roof snow load, pf 30 psf* Exposure factor, Ce 1.0 Importance factor, Is 1.1 Thermal factor, Ct 1.0 Rain loads: in accordance with Section 1611 Roof live load: 20 psf min Rainfall intensity (15-min. duration/100 year avg. interval) 2.90 in./hr. *Note: the flat roof snow load shall be no less than 30 psf. C. Wind design data:	 Foundation notes: Recommendations for the site preparation and earthwork within the perimeter of the proposed new structure, preparation of soil bearing surfaces, material specification and placement of structural backfill for support of foundations and slabs-on-grade, and drainage are stated in the geotechnical engineering report prepared for this project by Skylands Engineering, LLC and dated 19 April, 2019. The recommendations of this report are project requirements. The foundations have been designed to rest on inorganic, undisturbed soil or compacted granular fill having a bearing value of 4000 psf as recommended in the geotechnical engineering report referenced above. Such bearing strata are anticipated at the bottom of footing elevations noted on the foundation plan. All bearing strata shall be reviewed by the geotechnical engineer prior to placing concrete in order to verify the bearing value. If ledge rock is encountered above the proposed bottom of footing elevations indicated, then it shall be removed to the extent necessary to provide a minimum of 1'-0" soil cover above the top of the
Wind loads have been determined based on Section 1609.1.1 in accordance with ASCE 7-16, Chapters 26, 27, 29 and 30, Directional Procedure Risk category Risk category III Basic wind speed (3-second gust): Ultimate design wind speed, Vult 126 mph Nominal design wind speed, Vasd Nominal design wind speed, Vasd 98 mph Exposure B Internal pressure coefficient 0.18 "a" dimension for use with components and cladding 13.2 ft Design wind pressure (Nominal design wind pressures) for components and cladding on building walls (use Zone 4 generally; use Zone 5 within "a" of building wall corners): Surface pressure (psf) Area 10 sq.ft 20 sq. ft. 50 sq. ft. 100 sq. ft. Negative Zone 4 -17.5 -16.7 -15.8 -15.1 Negative Zone 5 -21.5 -20.1 -18.2 -16.7	 concrete footing. Footings supported on ledge shall rest on broom clean solid rock. If the slope of the rock surface exceeds 1 on 6, then the footing shall be dowelled to the ledge with 3/4" steel rods drilled 10 inches into the rock surface at 2 feet on center. If ledge rock and soil both occur at the bottom of footing bearing elevation, then a minimum of one foot of ledge rock below planned bottom of footing elevation shall be removed and replaced with a "cushion" layer of crushed stone to minimize differential settlement. The crushed stone "cushion" layer shall extend beyond the end of the ledge rock for a minimum of 10 feet along the length of the supported footing. The slab-on-grade sub-base shall be a crusher run stone free from soft disintegrated pieces, mud, dirt, or other injurious material. The material shall have no stone greater than 2 inches in any one dimension and with less than 10 percent by weight passing a No.100 sieve. The bottom of exterior footings not on solid rock shall be at least 3' - 6" below finished grade. All soil surrounding and under footings shall be protected from freezing and frost action during the course of construction. Step footings where elevations change at a maximum slope of one vertical on two horizontal and place lower footings first.
Positive Zones 4 & 516.115.414.513.7Positive Zones 4 & 516.115.414.513.7Design wind pressure (Nominal design wind pressures) for components and cladding on building roofs (for locations of zones 1, 2 and 3, refer to building code): Surface pressure (psf)Area10 sq.ft20 sq. ft.50 sq. ft.100 sq.ft.Negative Zone 1-28.1-26.2-23.8-21.9Negative Zone 1-28.1-26.2-23.8-21.9Negative Zone 1-28.1-26.2-23.8-21.9Negative Zone 1-28.1-66.2-23.8-29.1Negative Zone 1-16.1-16.1-16.1Negative Zone 2-37.0-34.6-31.5-29.1Negative Zone 3-37.0-34.6-31.5-29.1Negative Zone 1 & 1'10.010.010.0Positive Zone 2 & 3-36.1-29.1Negative Zone 1 & 1'-26.2-24.3-29.1 <td> Foundation basement walls shall not be backfilled before they are temporarily braced or before the concrete has attained its specified compressive strength and the framed floor system at the top of the wall is in place. Foundation frost walls shall be backfilled by placing fill on both sides simultaneously and to the same level. Keep foundation excavations free of water at all times. Use crushed stone backfill or controlled compacted fill or lean concrete (f'c=1500 psi) for over-excavation of footings. Existing utilities: locate existing underground utilities in areas of excavation work. Provide adequate means of support and protection during earthwork operations. Where footings are in close proximity to sub-surface piping bottom of footings shall be at least 8" below elevation of piping unless otherwise shown on the drawings. Submittals to the engineer are required for structural fill and slab sub-base. </td>	 Foundation basement walls shall not be backfilled before they are temporarily braced or before the concrete has attained its specified compressive strength and the framed floor system at the top of the wall is in place. Foundation frost walls shall be backfilled by placing fill on both sides simultaneously and to the same level. Keep foundation excavations free of water at all times. Use crushed stone backfill or controlled compacted fill or lean concrete (f'c=1500 psi) for over-excavation of footings. Existing utilities: locate existing underground utilities in areas of excavation work. Provide adequate means of support and protection during earthwork operations. Where footings are in close proximity to sub-surface piping bottom of footings shall be at least 8" below elevation of piping unless otherwise shown on the drawings. Submittals to the engineer are required for structural fill and slab sub-base.
D.Earthquake design data: Risk categoryIII Seismic importance factor, l_e :1.25 0.285g 0.285g 0.060g BMapped short period spectral response accelerations, S_s :0.285g 0.060g 0.0060g 0.0171g 0.032g 0.032g 0.032g 0.032g 0.032g 0.032g 0.032g 0.032g 0.032g 	 All concrete work shall conform to all the requirements of ACI 301, "Specifications for Structural Concrete in Buildings" and ACI 318 "Building Code Requirements for Structural Concrete", as specified in the code reference section of these general notes. Concrete shall be the specified weight and develop a minimum compressive strength in 28 days as follows: Concrete shall be the specified weight and develop a minimum compressive strength in 28 days as follows: Maximum Location Weight Strength where indicated) Footings Normal 3,000 psi 0.55 Walls and piers: Interior Normal 3,000 psi 0.45 Exterior exposed Normal 5,000 psi 0.40
 E. Other loads: Concentrated loads: All floors except as noted (on 2-1/2 feet square) Stair treads and catwalks (on 4 inches square) Stair treads and catwalks (on 4 inches square) Garages with passenger vehicles (on 4 ½ inches square) All other roof members All other roof members Impact loads Loads increased as follows: Elevator machinery Hangers for floors or balconies Vehicle and wheel loads F. Special loads: Retaining walls Lateral equivalent fluid pressure 32.5 pcf 	 latest ACI code and the latest ACI "Manual of Standard Practice for Detailing Reinforced Concrete Structures". Concrete design mix will be submitted to the engineer for review, together with laboratory reports attesting that the mixes can attain the minimum strength required in accordance with ACI 301 indicated above. No admixtures are permitted without the engineer's written permission other than entrained air. Concrete exposed to the weather, such as that used in foundation walls, shall contain 5% +/- 1 1/2% entrained air. Concrete exposed to the weather and to de-icing compounds shall contain 6% +/- 1 1/2% entrained air. Do not use air entrainment admixture for interior normal weight concrete slabs. Limit water-soluble, chloride-ion content in hardened concrete to the following percent by weight of cement: 1.00 for reinforced concrete that will be dry and protected from moisture, 0.30 for reinforced concrete that will exposed to moisture but not exposed to chlorides, 0.15 for reinforced concrete exposed to moisture and chlorides from deicing chemicals and salt/seawater, and 0.06 for prestressed (post-tensioned) concrete. Reinforcing steel shall conform to ASTM A 615, Grade 60. The following concrete cover shall be provided for reinforcement:
 Seismic load (h = height of wall) Vertical live load surcharge 4 This structure has been designed to be self-supporting and stable after the construction of the building has been completed. The stability of the structure prior to completion is solely the responsibility of the contractor. This responsibility extends to all related aspects of the construction activity including, but not limited to, erection methods, erection sequence, temporary bracing, forms, shoring, use of equipment, and similar construction procedures. Review of the construction by the engineer is for conformance with design aspects only, not to review the contractor's construction procedures. 5 Jobsite safety and construction procedures are solely the responsibility of the contractor. Review of the construction. Review of the construction by the engineer is for conformance with design aspects only, not to review the contractor. Review of the construction procedures is not to be interpreted as approval of those procedures. 5 Jobsite safety and construction procedures are solely the responsibility of the contractor. Review of the construction by the engineer is for conformance with design aspects only, not to review the contractor's provisions for job site safety. Lack of comment by the engineer is not to be interpreted 	LocationCover (inches)Concrete cast against and Permanently exposed to earth3Concrete exposed to earth or weather: #6 through #18 bars2 #5 bar and smaller#6 through #18 bars2 #1 1/2Concrete not exposed to weather or in contact with ground: Slabs, walls, joists: #14 and #18 bars1 1/2Slabs, walls, joists: #14 and #18 bars1 1/2 3/4Beams, columns3/4
 as approval of those aspects of work. PDF digital files of all erection and detail shop drawings for steel reinforcing bars, indicating the fabricator, manufacturer, finish, layout, and all accessories, must be submitted to and be checked by the contractor and subcontractor and bear the checker's initials before submission to the architect for review prior to fabrication. Fabrication and/or delivery to the site of components prior to receiving approved shop drawings shall be at the fabricator's own risk. 7 Testing and inspection of concrete, steel reinforcing bars, and other work are described in the project "Statement of Special Inspections". The contractor shall review the "Statement of Special Inspections" and coordinate the scheduling of inspections with the special inspector. Uninspected work that required inspections may be rejected solely on that basis. 8 If faulty construction procedures, or material, result in defective work that requires additional engineering time to devise corrective measures, professional fees may be charged to the contractor at the standard hourly rate of additional services. Such fees may be withheld from the general contractor's payment. 9 Loads, openings and structure in any way related to requirements of other (non-structural) disciplines are shown for bidding purposes only. However, these plans do not show the full scope of openings, in roofs, floors and walls. For size and location of all openings, see architectural and mechanical drawings. Do not scale openings. The contractor shall obtain from the heating and ventilating, electrical, plumbing and other trades the final approved size and location of all openings, equipment are not shown on structural drawings. Excess cost related to variation in requirements or equipment are not 	 Primary reinforcement, ties, stirrups, spirals 11/2 9 The conveyance, placement and protection of the concrete shall conform to the requirements of ACI 318, indicated above, and ACI 304R, "Guide for Measuring, Mixing, Transporting and Placing Concrete". Mechanical vibrators are to be used to consolidate the freshly cast concrete around the reinforcing and against form surfaces and to prevent the formation of air or stone pockets, honeycombing, pitting or planes of weakness. However, care must be used to avoid over vibration that can lead to aggregate segregation. 10 No welding of reinforcing will be permitted. 11 All lap splices shall be Class B, in accordance with ACI 318 indicated above. 12 Concrete piers: Place concrete piers and walls together. Set pier reinforcing and set wall reinforcing through pier vertical bars. Provide dowels with standard hook from footing at all piers. Size and quantity of dowels to match vertical pier reinforcing (Class "B" splice). 13 The contractor shall be responsible for limiting pours to minimize shrinkage cracking. In general, walls shall not be poured in continuous lengths exceeding 30 feet without providing construction joints or control joints. The location and configuration of joints exposed to view shall be coordinated with the architect. 14 The installation of slabs shall conform to the requirements of ACI 302.1R, "Guide to Concrete Floor and Slab Construction". Interior finish slab surfaces are to have a steel trowel finish. Exterior slab surfaces are to have a broom finish unless specified on the architectural drawings. 15 Sizes and locations of all required embedded items, such as anchor bolts, piping sleeves, etc., for all

Connections to Hardened Concrete:

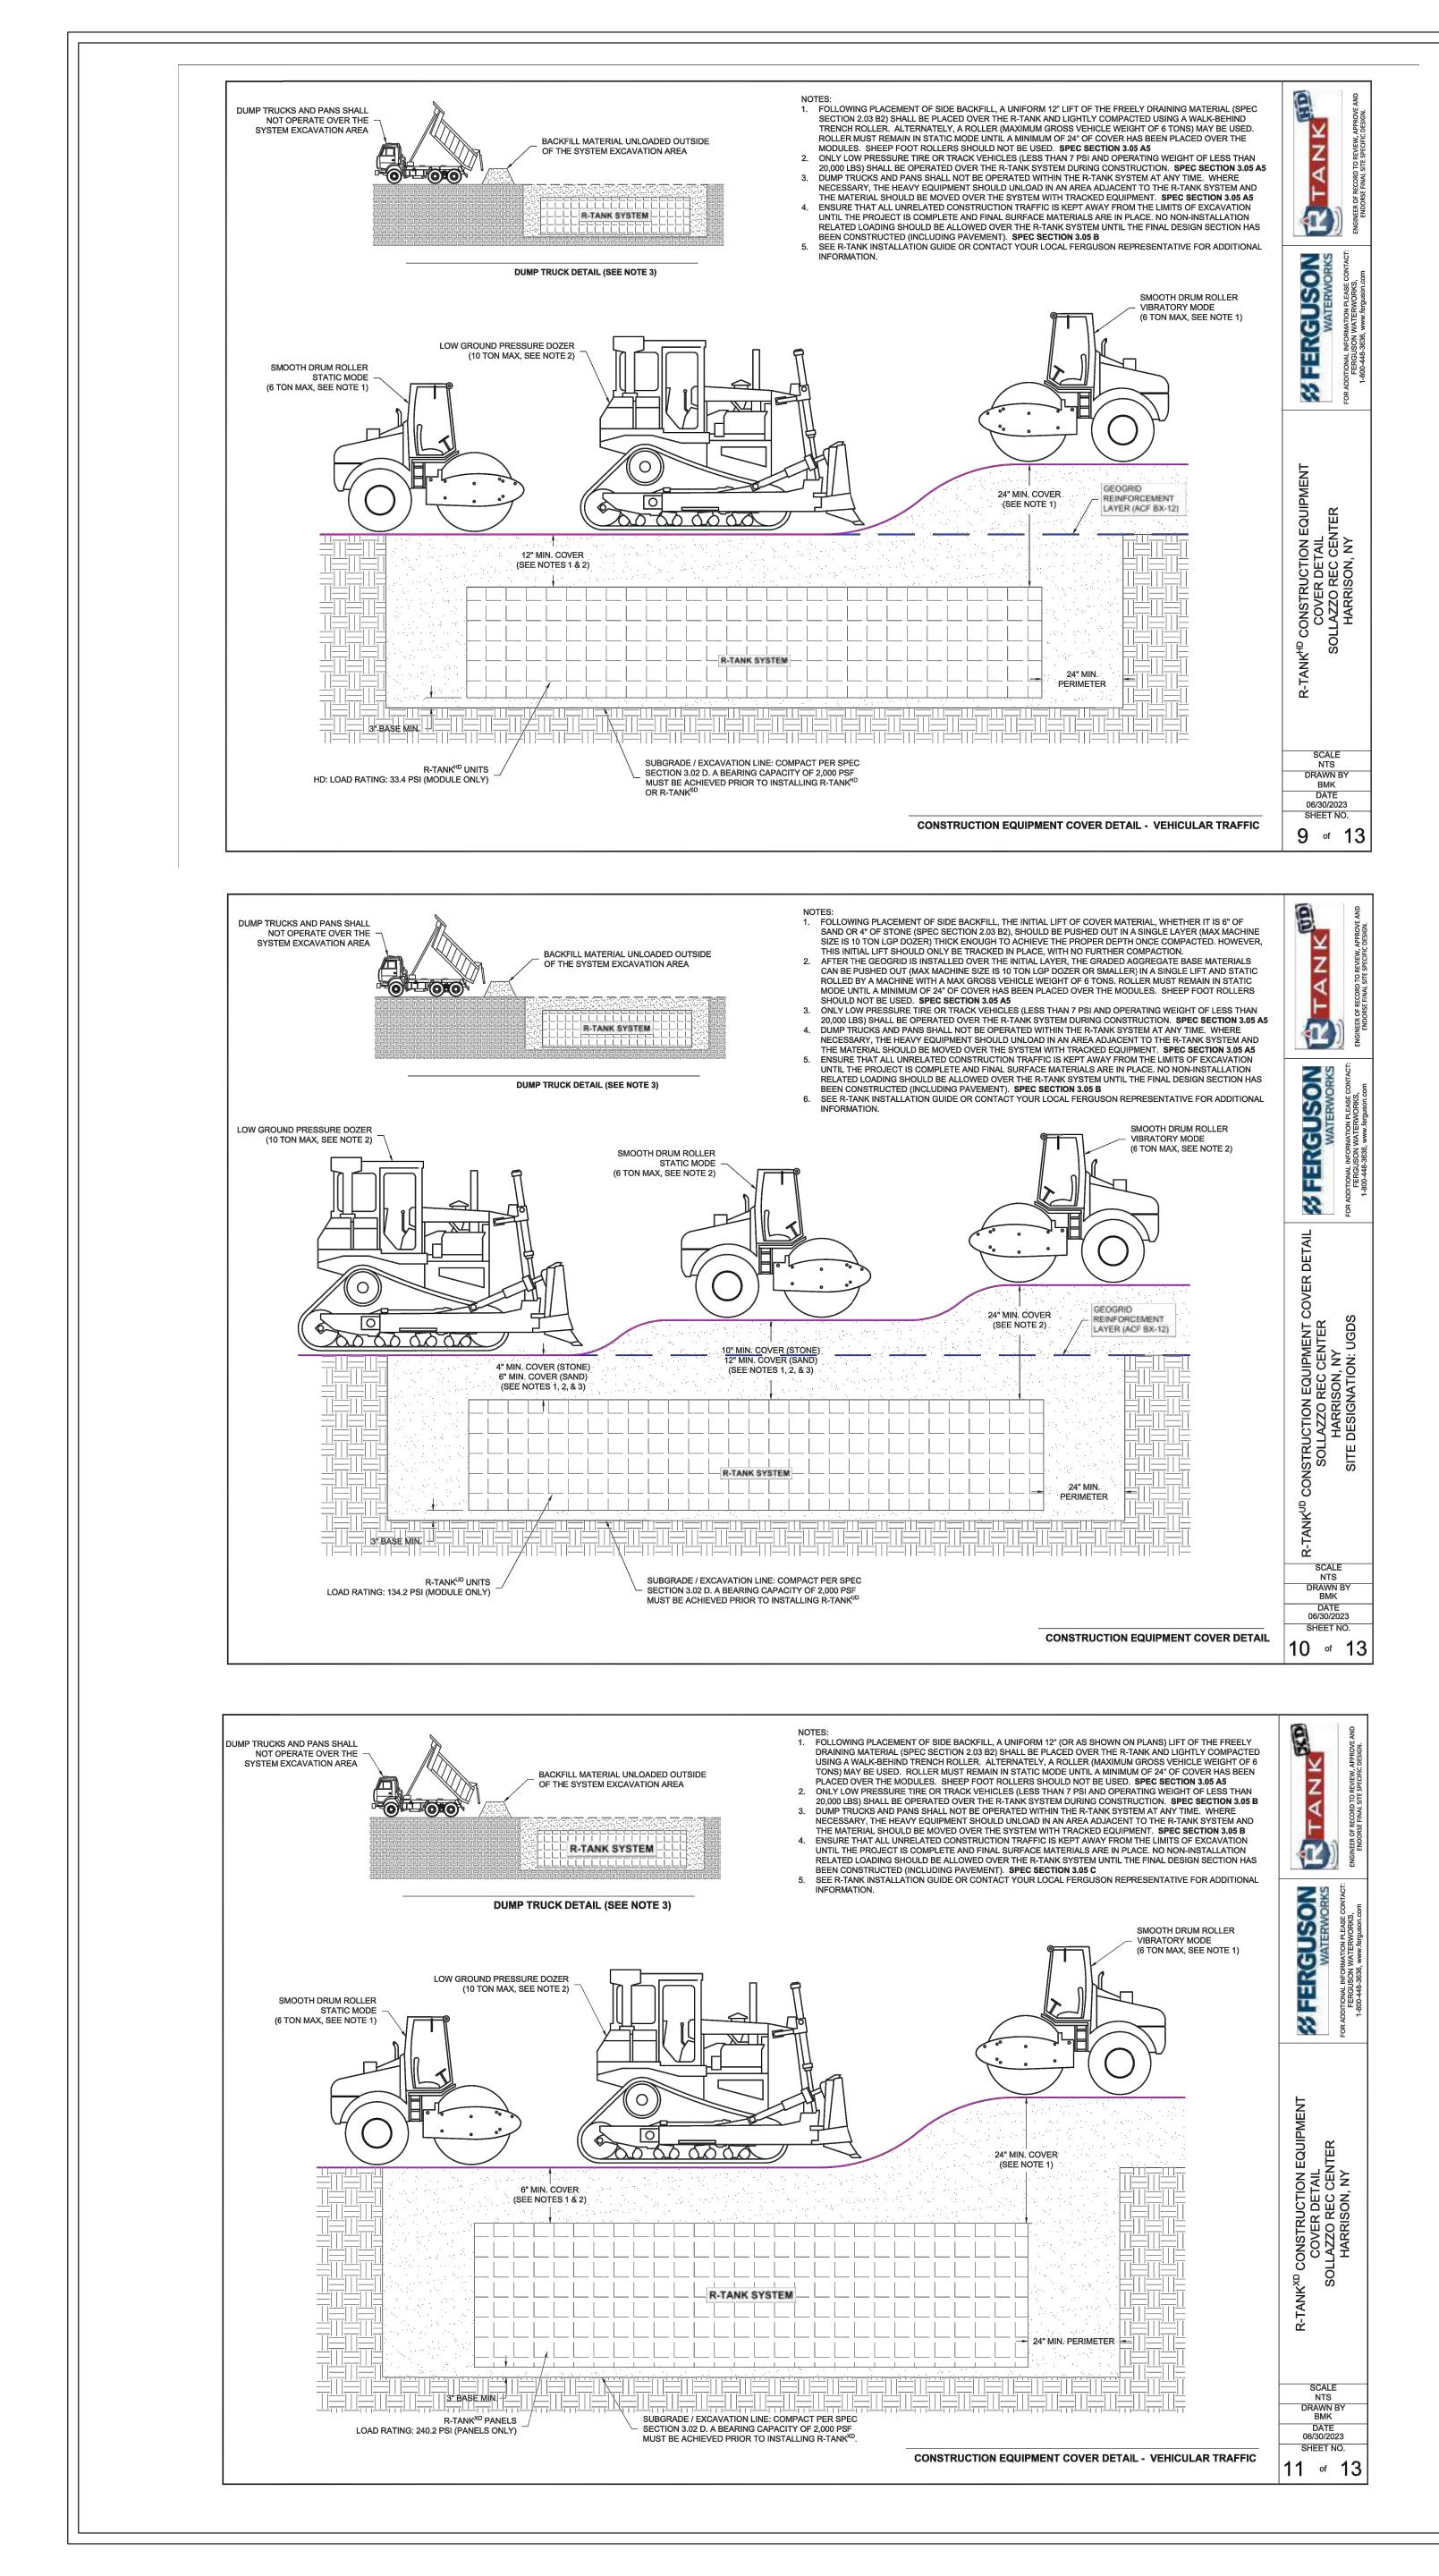- 1 All proprietary anchoring systems (expansion, adhesive anchoring systems, etc.) to be installed into hardened concrete elements are to be installed in strict accordance with the manufacturer's instructions for drilling and preparation of holes, for spacing and edge distance requirements, and for the utilization of supplemental components for the anchoring systems such as screen tubes, doweling adhesives, etc.
- 2 Connections to hardened concrete shall be made with anchors conforming to ACI 318, as specified in the code reference section of these general notes, for cracked concrete, and Chapter 19 of the state building code indicated at the beginning of these general notes. A. Mechanical anchors shall be either
 - Hilti "Kwik Bolt TZ" expansion anchor.
 - Hilti "Kwik HUS-EZ" screw anchor (use only in permanently dry, interior non-corrosive environments) Simpson "Strong Bolt 2" expansion anchor
 - iii. Simpson "Titen HD" screw ancho, zinc-plated or galvanized (use only in permanently iv.
 - dry, interior non-corrosive environments) Dewalt "Power-Stud + SD2" expansion anchor. ν. vi.
 - Dewalt "Power-Stud + SD4/SD6", Type 304/316 SS expansion anchor Dewalt "Screw-Bolt+" screw anchor, zinc-plated or galvanized (use only in permanently vii. dry, interior non-corrosive environments)

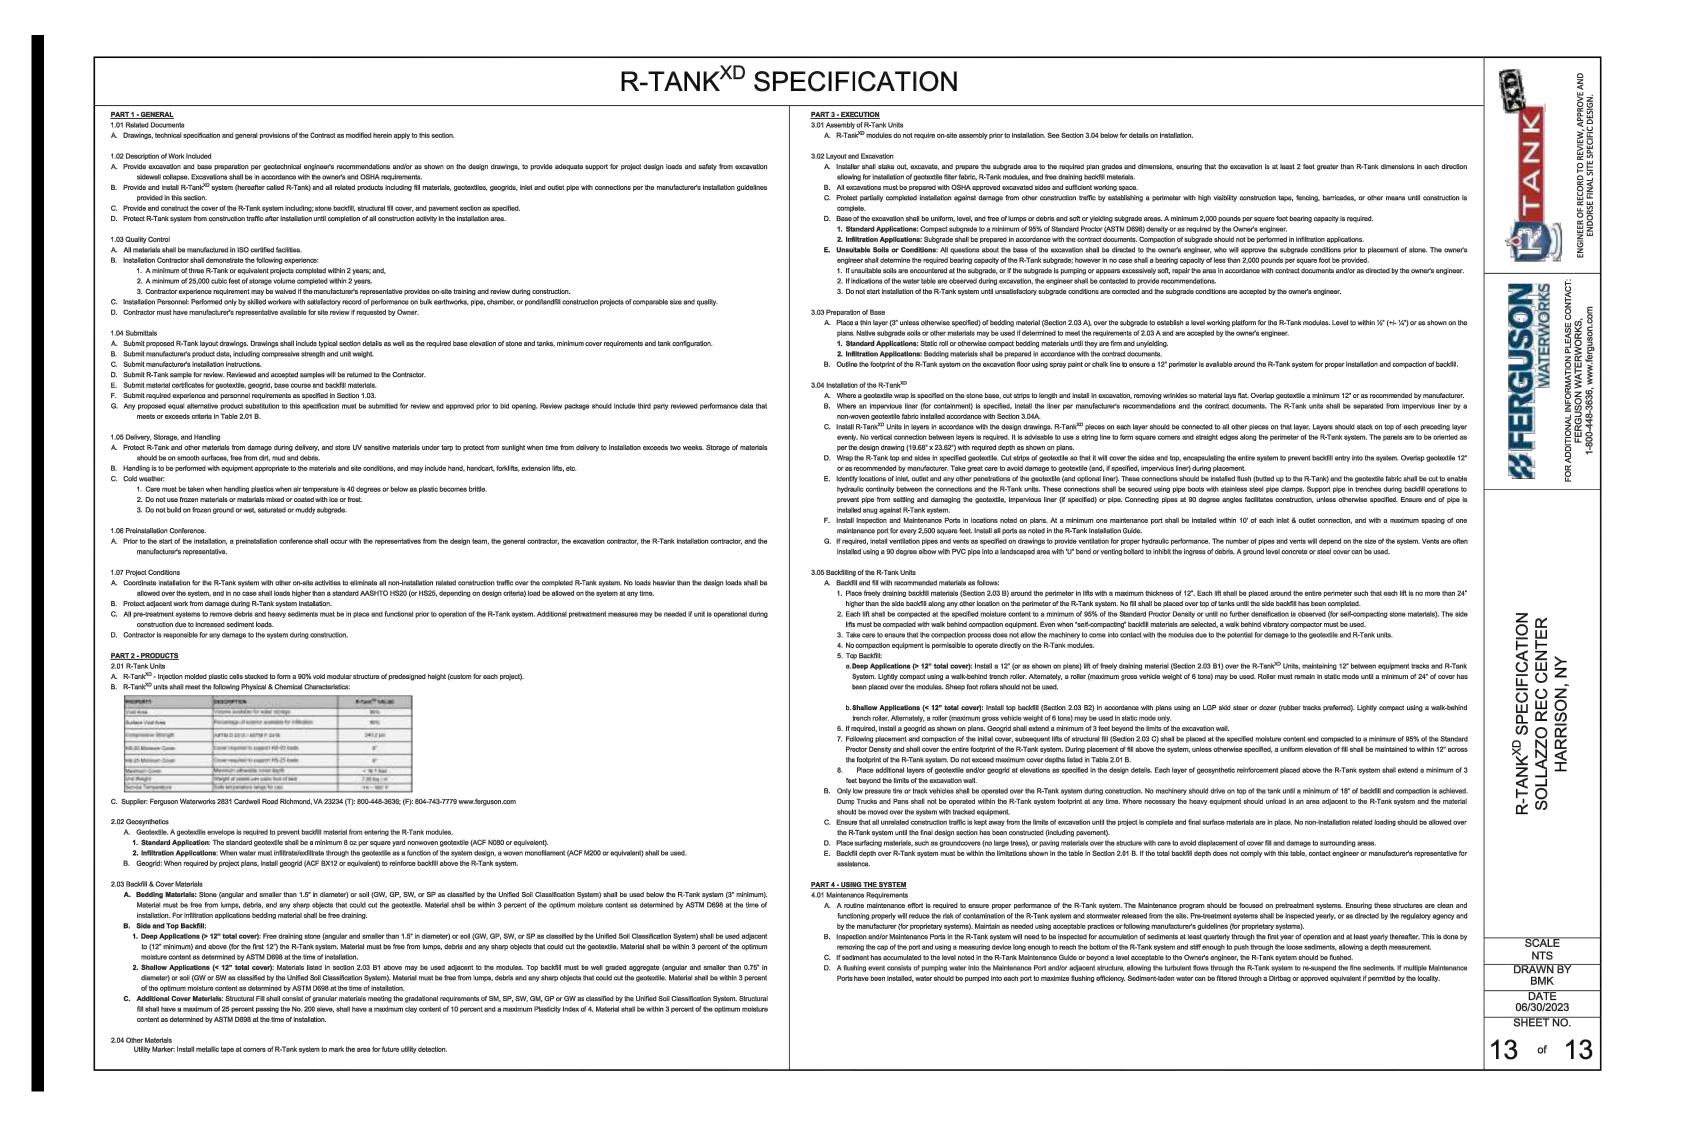Size, embedment, spacing and edge distance of anchors shall be as indicated on the drawings.

- B. Adhesive anchor rods or reinforcing bars shall be installed in rotary hammered drilled holes with carbide drill bits using one of the following adhesive anchoring systems: Hilti "HIT-HY 200 safe set adhesive anchoring system with Hilti "HAS" ASTM F1554, i.
 - Grade 36 anchor rods. Simpson "AT-XP" adhesive anchoring system for base material temperatures between 14 degrees and 80 degrees or Simpson "Set-3G" adhesive anchoring system for
 - temperatures above 40 degrees, with Simpson "RFB" ASTM F1554 Grade 36 anchor
 - Dewalt "AC200+" two part adhesive, cold temperature cure with ASTM F1554, Grade iii. 36 anchor rods. Reinforcing bars shall conform to the requirements of the Concrete General Notes. Reinforcing bars shall conform to the requirements of the Concrete General Notes.
 - iv.

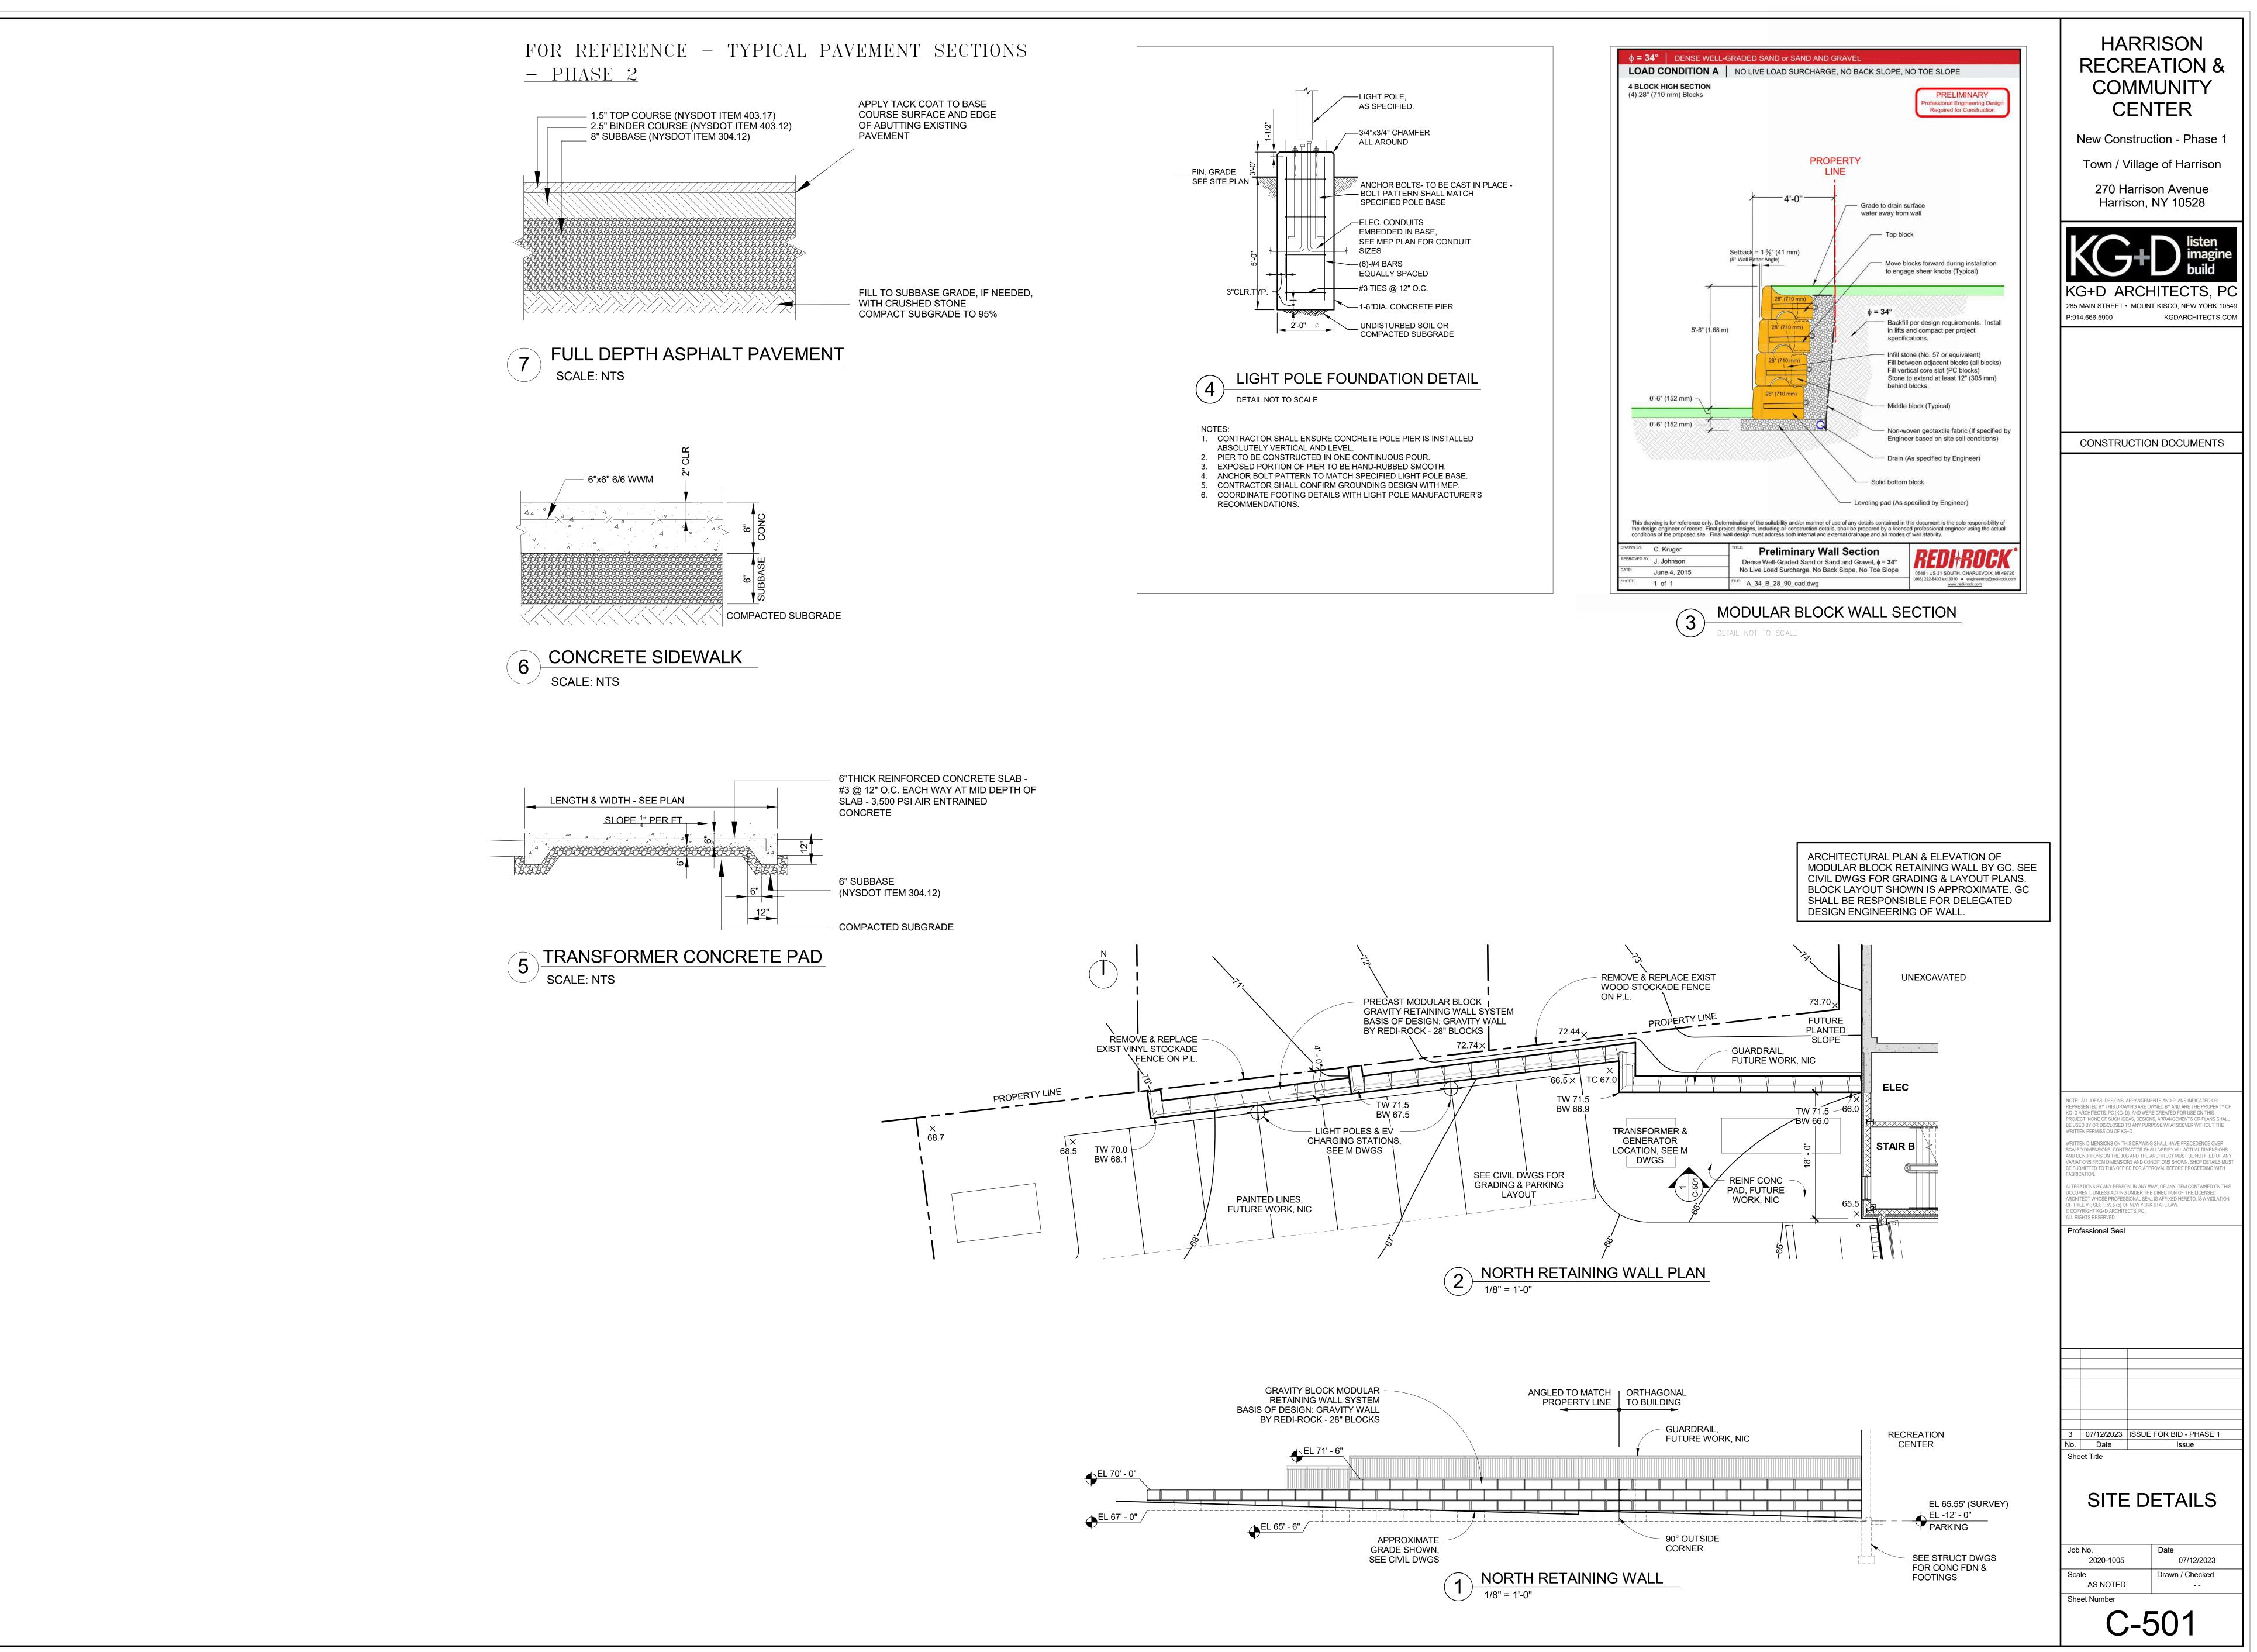Adhesive for reinforcing bars and anchors shall have been tested in accordance with ACI 355.4 "Qualification of Post-Installed Adhesive Anchors in Concrete" and ICC-ES (ICC Evaluation Service) "Acceptance Criteria for Post-Installed Adhesive Anchors in Concrete Elements" (AC308) for cracked concrete and seismic applications.

Adhesive bond design strength is based upon concrete that has cured at least 21 days with a minimum compressive strength of 2,500 psi and an in-service temperature in accordance with ACI 355.4 Temperature Category B.

Installation method shall be in accordance with the Manufacturer's Printed Installation Instructions (MPII

Installation of adhesive anchors horizontally or upwardly inclined to support sustained tension loads shall be performed by personnel certified by the ACI/CRSI Adhesive Anchor Installer Certification program or equal.

Unless otherwise noted on the drawings, embed anchor rods and reinforcing bars into drilled holes a minimum of 9 anchor diameters, with a minimum edge distance of 4 inches, measured from the edge of the concrete to the centerline of the anchor/reinforcing bar. Increased embedment depths or edge distances may be required at certain locations, see plans and details.

Structural Steel Notes:


1 Design fabrication and erection of structural steel shall conform to the American Institute of Steel Construction's "Specification for Structural Steel for Buildings", as specified in the code reference section of these general notes.

- 2 Materials: American standard shapes, angles, Plates and bars: Anchor rods Welding electrode
- 3 All welding shall conform to American Welding Society's AWS D1.1 "Structural Welding Code-Steel" code for arc and gas welding and be performed by a certified welder in accordance with A.W.S. standards.
- 4 Structural steel shall be cleaned in accordance with the Steel Structures Painting Council Specification SP 3 for Power Tool Cleaning (except for steel exposed to weather). 5 All steel members and bolting exposed to weather shall be cleaned in accordance with the Steel Structures Painting Council Specification SP 6 for Commercial Blast Cleaned and hot-dipped
- galvanized in accordance with ASTM A 123 and ASTM A 153. Minimum acceptable zinc coating weight shall be 2 oz./sq. Ft. See architectural specifications for finished paint if required. Clean areas where galvanizing is damaged or missing and repair galvanizing to comply with ASTM A 780. 6 Provide bitumastic protection coating for all structural steel below grade.
- 7 Fabricator shall hold a current AISC certification for "Certified Building Fabricator (BU)", (formerly known as "Standard for Steel Building Structures (STD)".) 8 For miscellaneous steel, see architectural drawings.
- 9 Submittals to the engineer are required for certificates of compliance for structural steel, bolts, nuts, and weld filler material prior to the fabrication of any steel
- 10 At the completion of fabrication, the fabricator shall submit a certificate of compliance stating that the work was performed in accordance with the approved contract documents, as required by Section 1704.2 of the building code indicated at the beginning of these General Notes.

ASTM A 36 ASTM F 1554, Grade 36

ASTM E 70xx, low hydrogen

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Bigging Group Structural Engineers 83 Wooster Heights Rd, Ste 200 Danbury, CT 06810
[203] 490-4140 www.tdeg.com CONSTRUCTION DOCUMENTS
Key Plan
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5 07/12/2023 ISSUE FOR BID - PHASE 1 4 06/09/2023 ISSUE FOR PERMIT - PHASE 1 2 2023-03-31 PHASE 1 - 50% CD'S 1 2020-06-01 DESIGN DEVELOPMENT
No. Date Issue Sheet Title
GENERAL STRUCTURAL
Job No. Date
Sob NO.Date20029.002020-06-01ScaleDrawn / CheckedAS NOTEDJM / EM
Sheet Number S-001

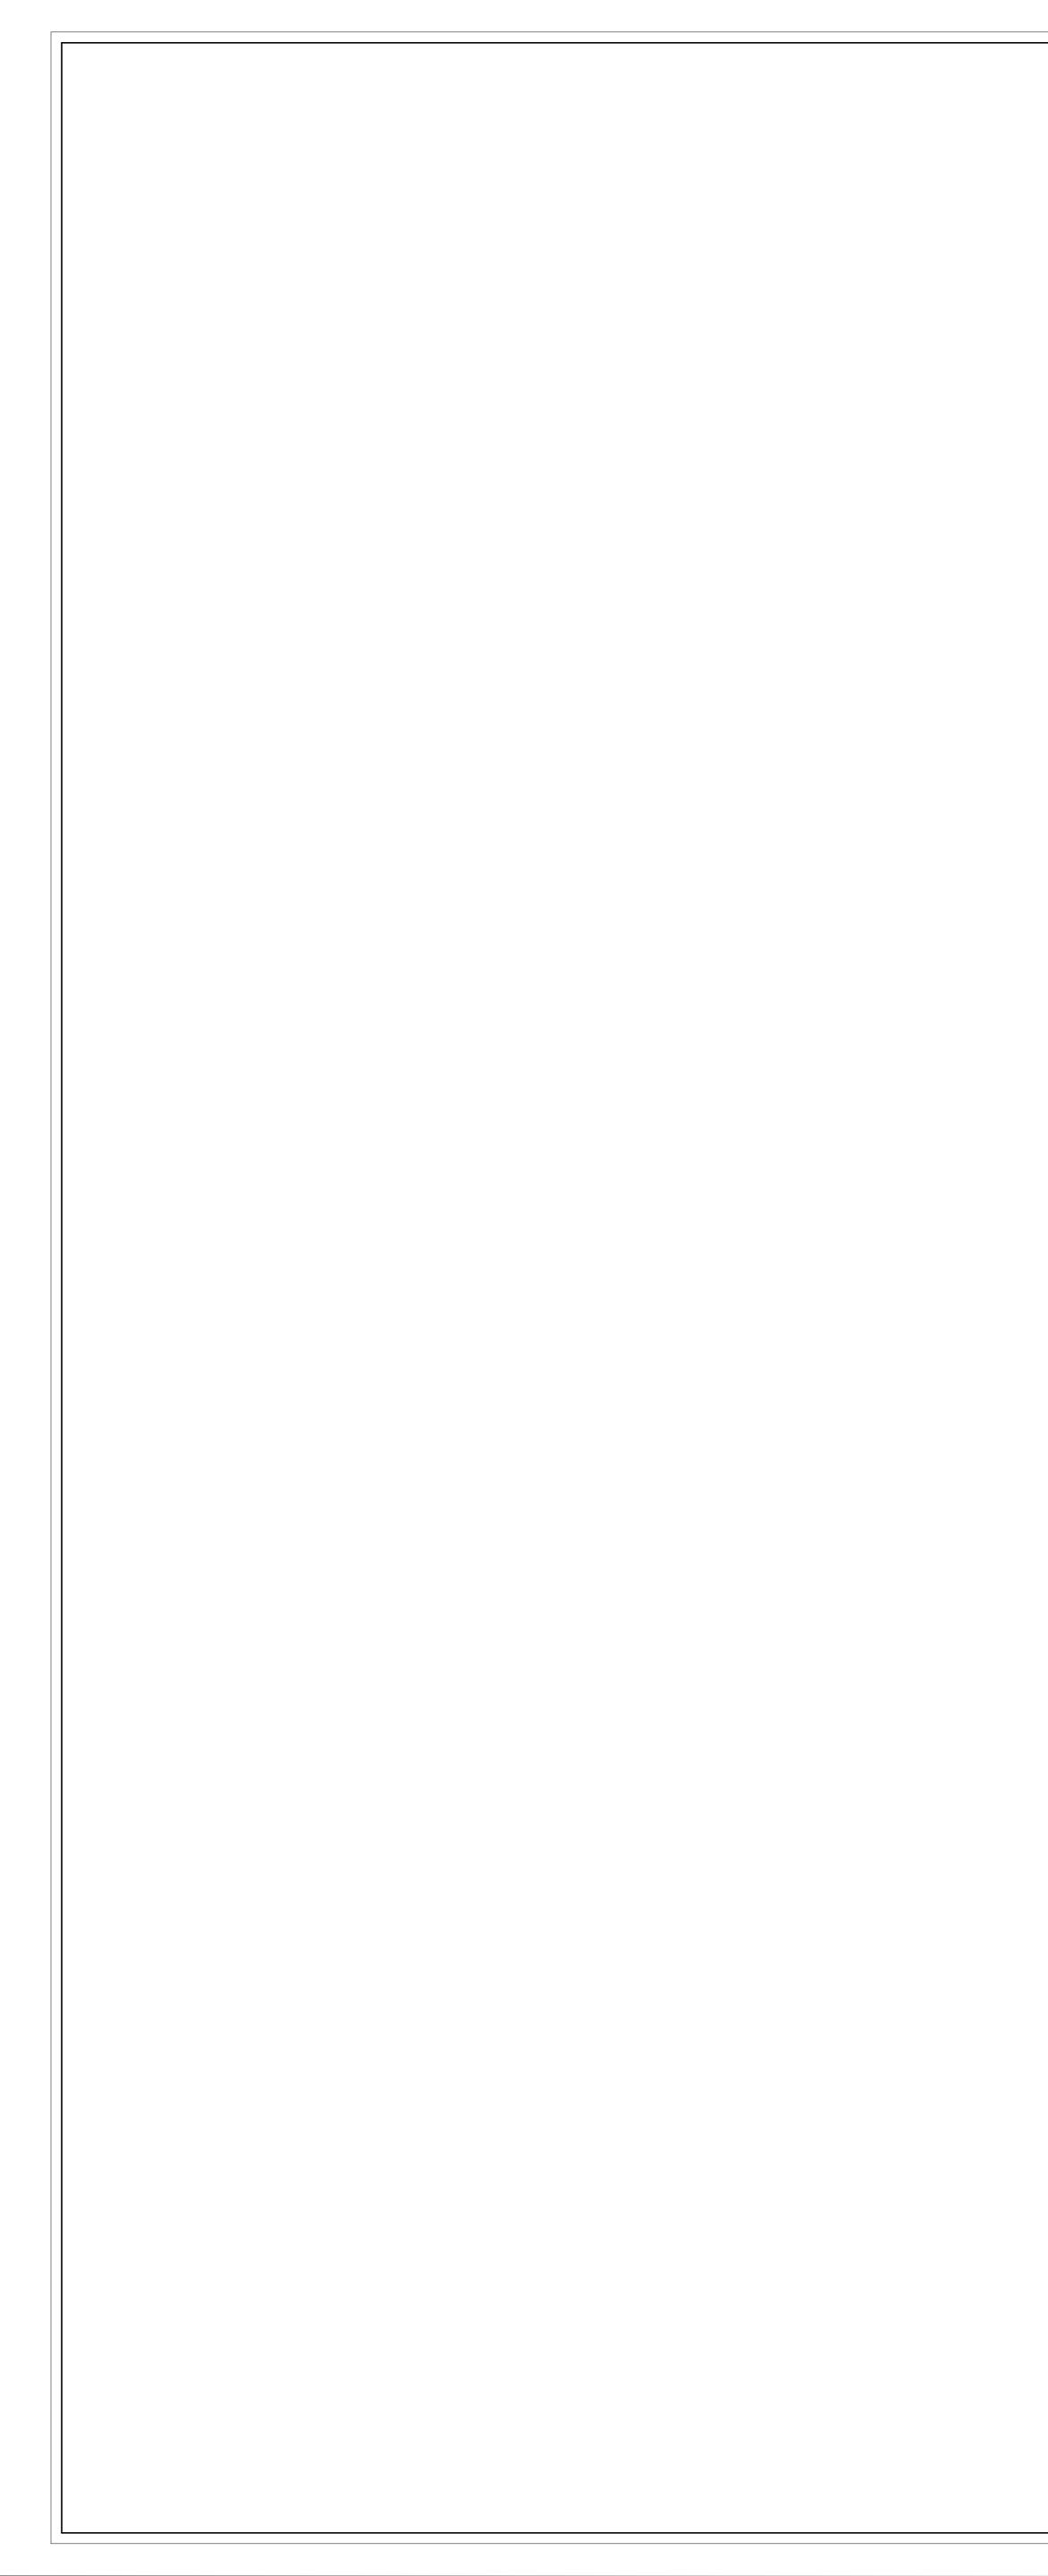


(1.4)1 4 5-210/ -16'-6"] P-1, AR-1 F-4.0 [-16'-4"] (-12'-8") (A.1) (-6'-5") 5 5-210 -12'-0" **A.8** 4 P-3, AR-2 F-5.0 S-202/ [-16'-6"] Ч 2 5-210 B.8 \square P-3, AR-2 F-5.0 [-16'-6"] P-3, AR-2 F-5.0 [-16'-6"] D.1 P-3, AR-2 F-5.0 [-16'-6"] **E.1** P-3, AR-2 F-5.0 [-16'-6"] 1 5-210 6 ά. P-3, AR-2 F-4.0 E.8 P-2, AR-2 F-4.0 [-16'-4"] G H **R1**

<u>NOTE:</u> SEE SITE/ELEC MECH. DWG'S FOR EQUIP. PAD LOCATIONS, SEE 2/S2O2 FOR TYP. PAD DETAIL

<u>NOTE:</u> SEE SITE/CIVIL DWG'S FOR EXTENT OF SITE RETAINING WALLS IN PARKING LOT

LOWER LEVEL FOUNDATION PLAN

- 1/8"=1'-0" TOP OF PARKING LEVEL = -12'-0" FROM FIRST FLOOR DATUM
- FOR FOUNDATION CONDITION AT EXTERIOR DOORS, SEE "TYPICAL DETAIL AT EXTERIOR DOORS".
- COORDINATE ALL PITS, TRENCHES, POCKETS, BRICK SHELVES, SLEEVES, PENETRATIONS AND INSERTS IN CONCRETE WALLS AND SLABS WITH ARCHITECTURAL AND MECHANICAL DRAWINGS.
- SEE GENERAL NOTES ON SHEET SOO1 FOR ADDITIONAL INFORMATION.

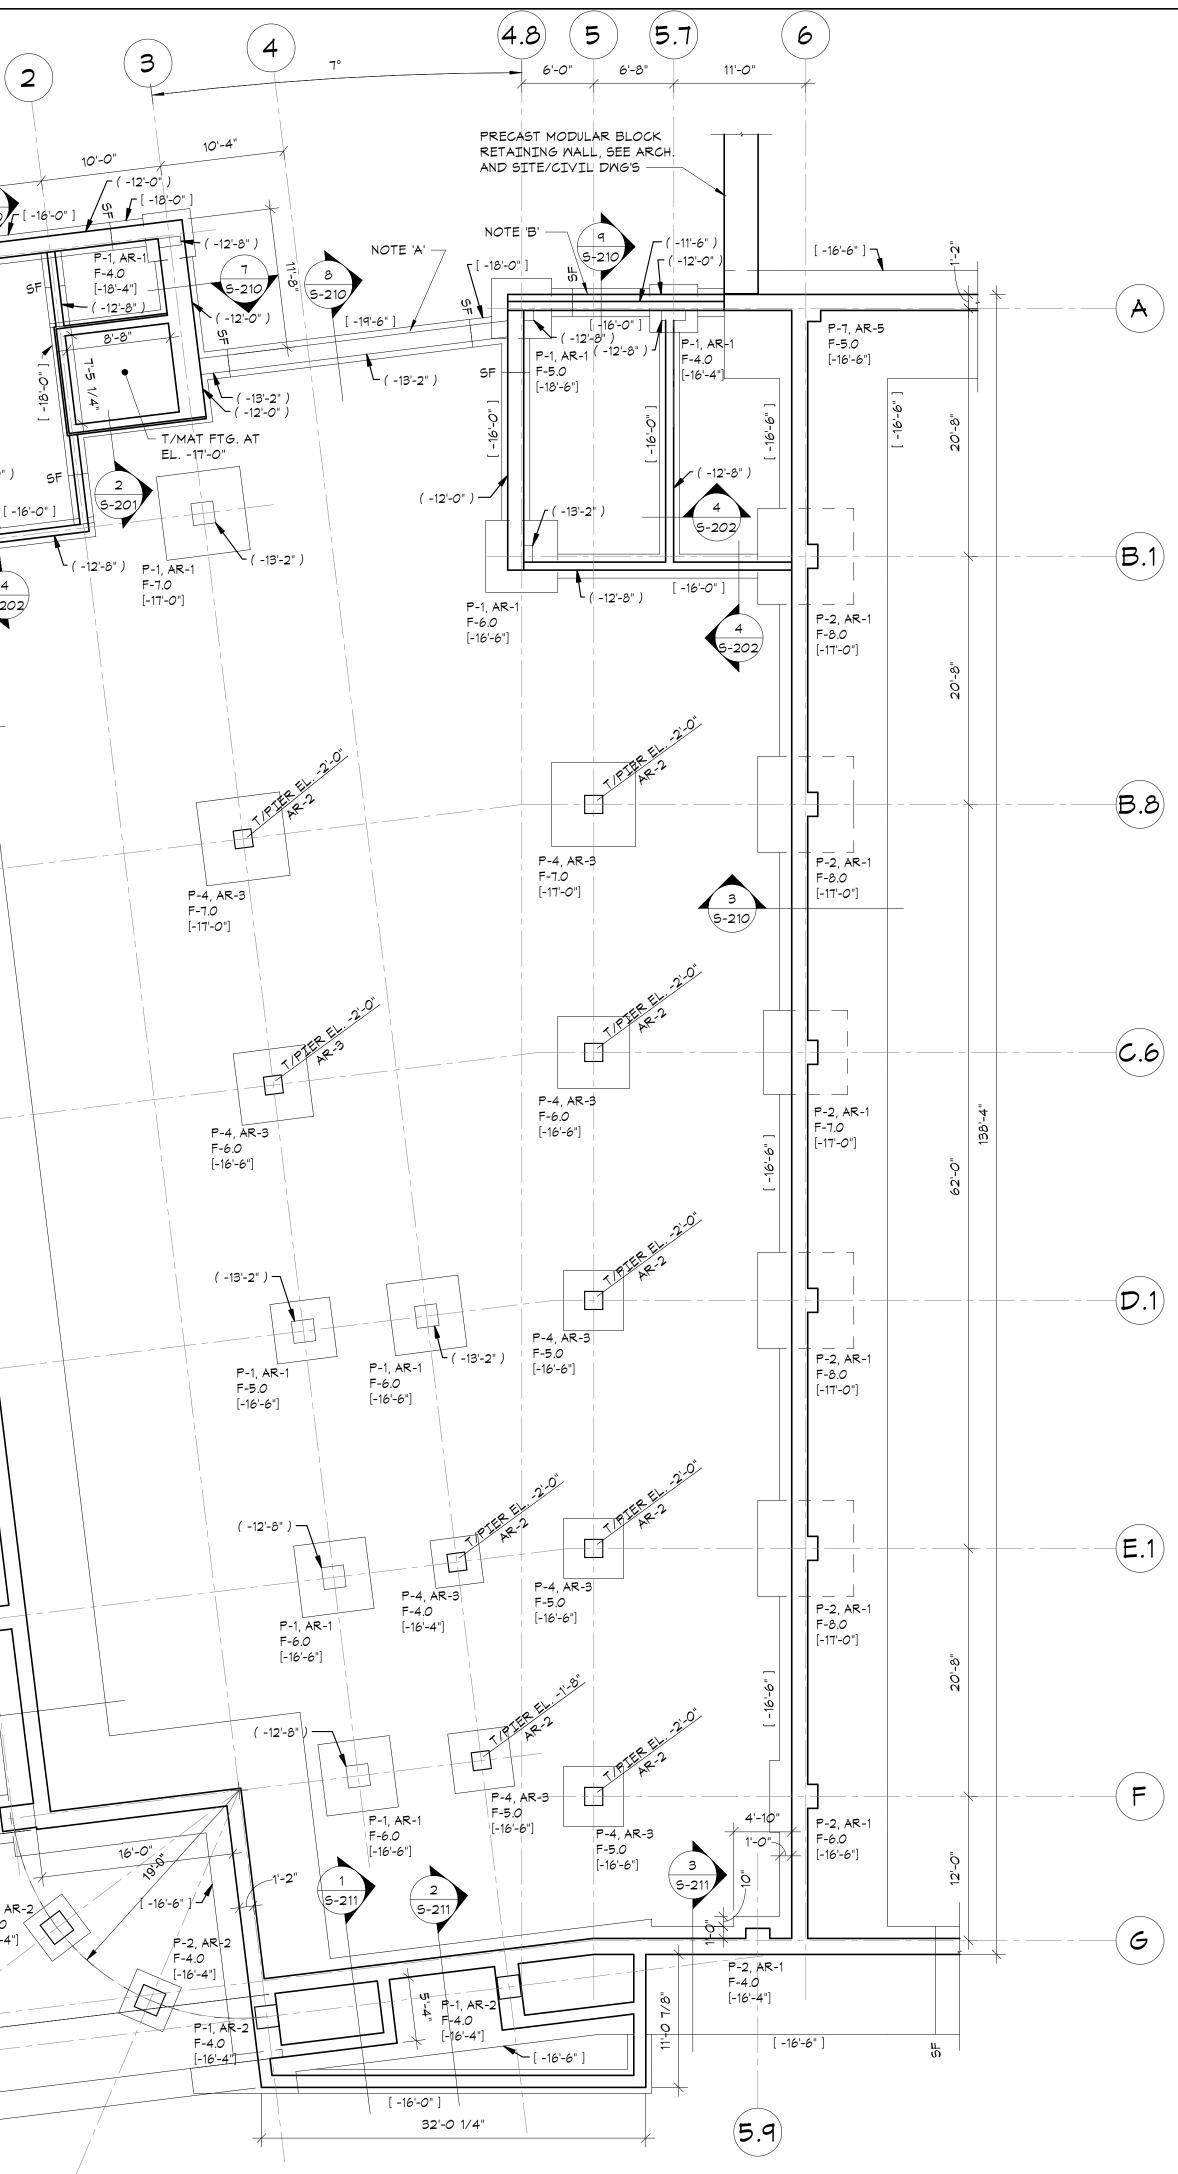

R2


NORTH:


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LEGEND:

- [+/-] INDICATES BOTTOM OF FOOTING ELEVATION FROM FIRST FLOOR DATUM ELEVATION.
- (+/-...) INDICATES TOP OF WALL/PIER ELEVATION FROM FIRST FLOOR DATUM ELEVATION.
- "SF" INDICATES APPROXIMATE LOCATION OF STEPS IN FOOTINGS ON PLAN. COORDINATE LOCATION AND ELEVATION WITH SITE GRADING AND MECHANICAL, ELECTRICAL AND PLUMBING DRAWINGS. FOR DETAILS, SEE "TYPICAL STEPPED FOOTING DETAIL".
- F-## INDICATES FOOTING TYPE. SEE "FOOTING SCHEDULE AND FOOTING DETAIL".
- P-# INDICATES PIER TYPE. SEE "PIER SCHEDULE AND PIER DETAILS".
- "AR-#" INDICATES BASEPLATE AND ANCHOR BOLT SIZES AND DIMENSIONS, SEE 5/S202.
- NOTE 'A': PROVIDE (3)-5'-0" WIDE x 1'-6" HIGH OPN'G IN FDN. WALL FOR PIPE PEN'S. MAINTAIN 1'-O" WIDE 'PIER' BTWN. OPNG'S. PROVIDE ADD'L (3)-#5 BARS ABOVE & BELOW OPN'G & EXTEND 2'-6" BEYOND OPN'G, EA. SIDE. PROVIDE (4)-#5 VERT. AT 'PIERS'. COORD. W/ MEP DWGS FOR LOCATION AND ELEVATION.
- NOTE 'B': PROVIDE (2)-3'-0" WIDE X 1'-0" HIGH OPN'G IN FDN. WALL FOR CONDUIT PEN'S. MAINTAIN 1'-O" WIDE 'PIER' BTWN. OPNG'S. PROVIDE ADD'L (3)-#5 BARS ABOVE & BELOW OPN'G & EXTEND 2'-6" BEYOND OPN'G, EA. SIDE. PROVIDE (4)-#5 VERT. AT 'PIER'. COORD. W/ MEP DWGS FOR LOCATION AND ELEVATION.


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P:914.666.5900 KGDARCHITECTS.COM The Di Salvo Engineering Group Structural Engineers 83 Wooster Heights Rd, Ste 200 Danbury, CT 06810 [203] 490-4140 www.tdeg.com CONSTRUCTION DOCUMENTS
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LOWER LEVEL FOUNDATION PLAN
20029.00 2020-06-01 Scale AS NOTED Drawn / Checked JM / EM Sheet Number Sheet Number




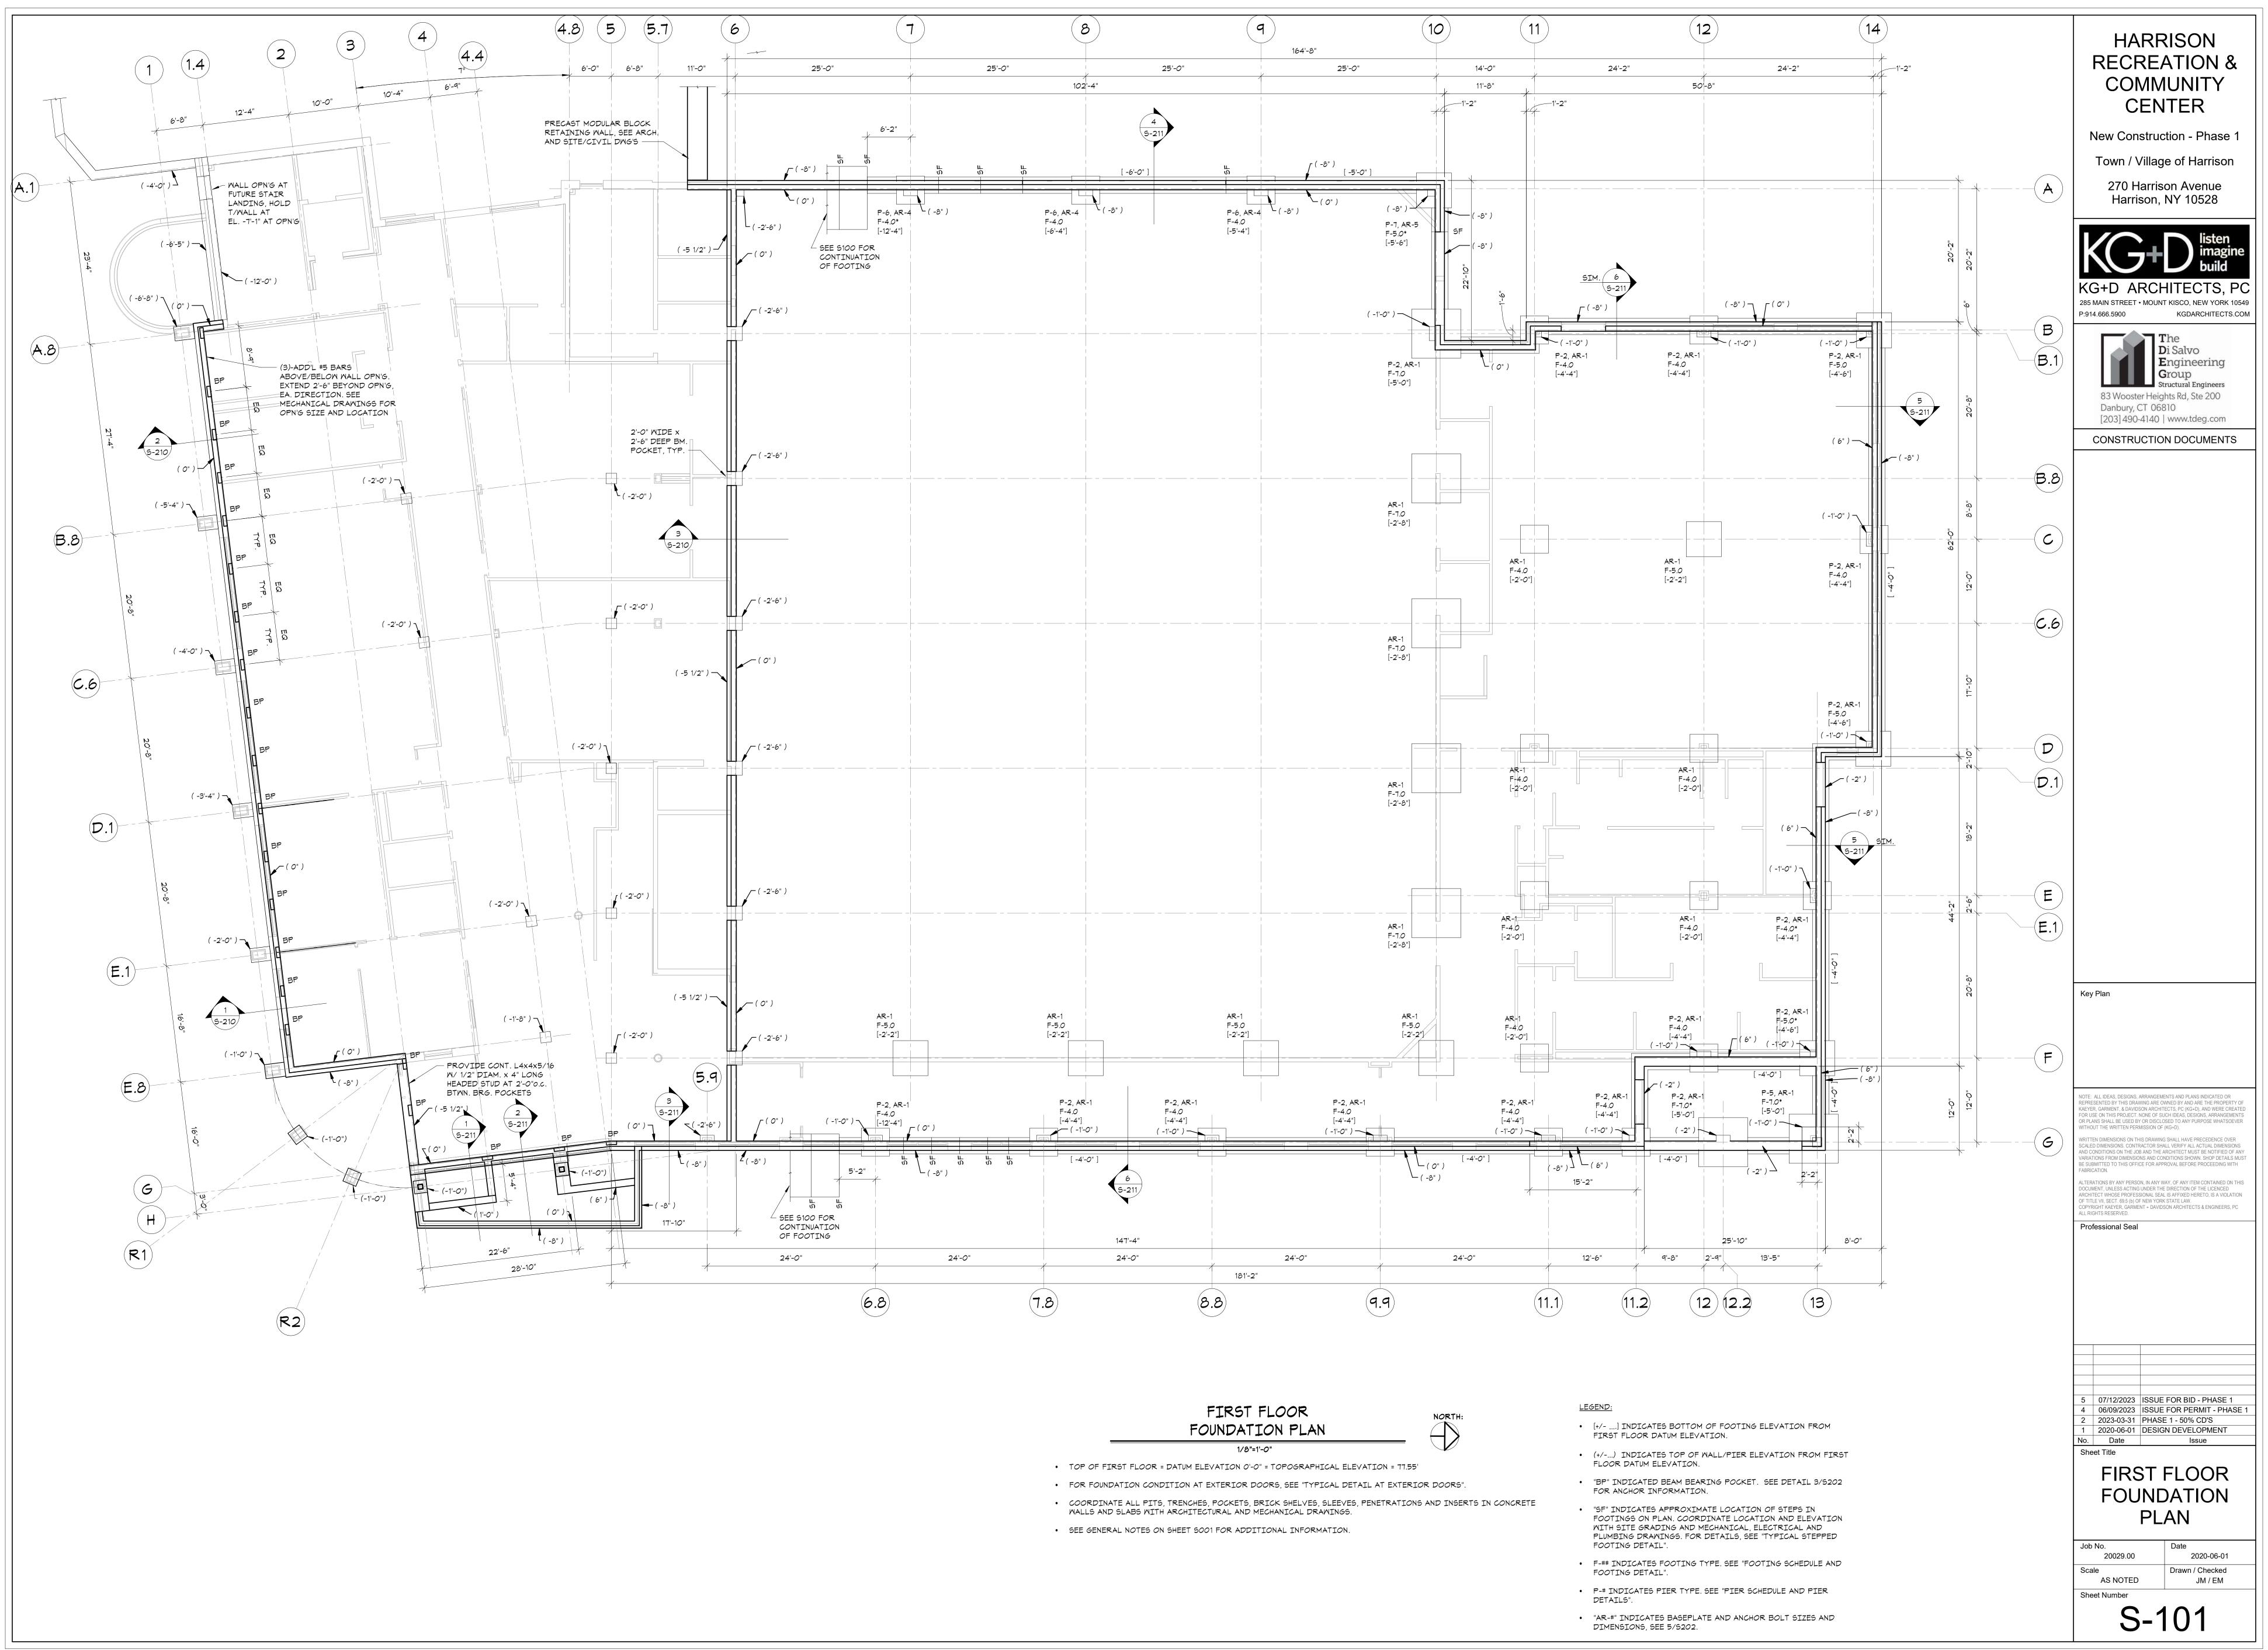

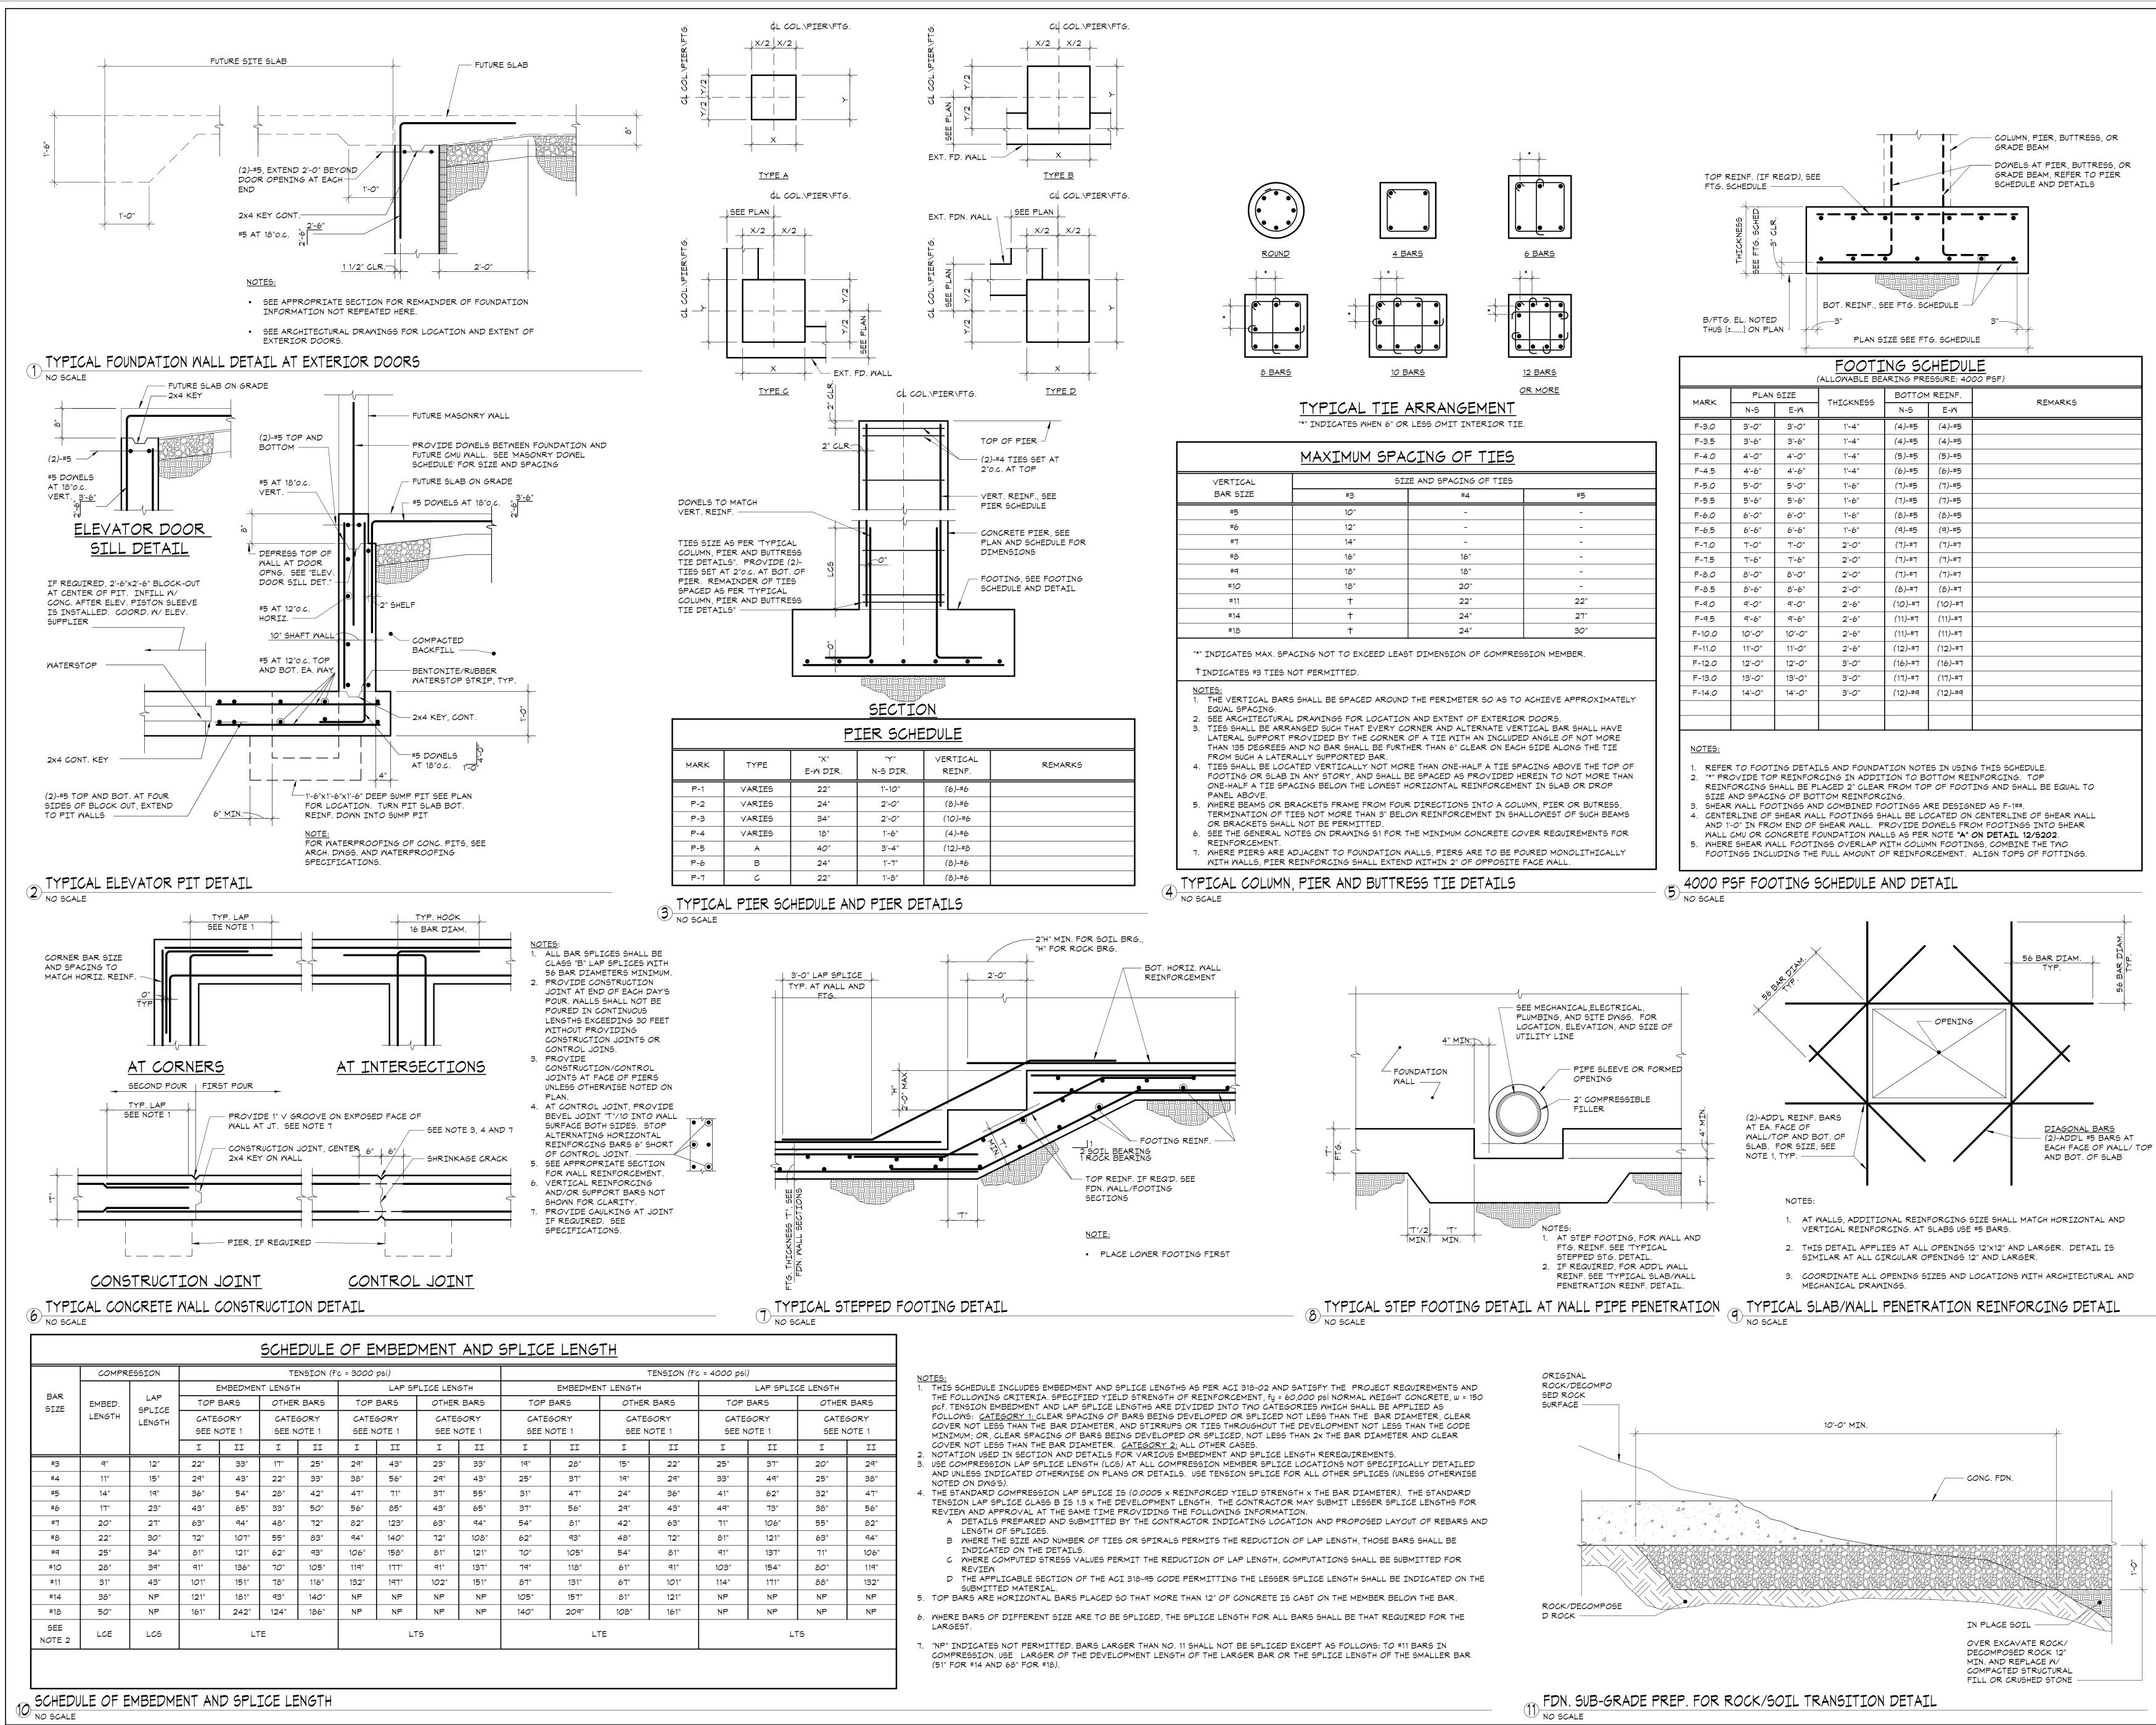	LAP SPLICE LENGTH			
ARS	TOP BARS OTHER BARS			
RY	CATEGORY CATEGORY		GORY	
ТЕ 1	SEE NOTE 1		SEE N	IOTE 1
II	I	II	I	II
22"	25"	37"	20"	29"
29"	33"	49"	25"	38"
36"	41"	62"	32"	47"
43"	49"	73"	38"	56"
63"	71"	106"	55"	82"
72"	81"	121"	63"	94"
81"	91"	137"	71"	106"
91"	103"	154"	80"	119"
101"	114"	171"	88"	132"
121"	NP	NP	NP	NP
161"	NP	NP	NP	NP
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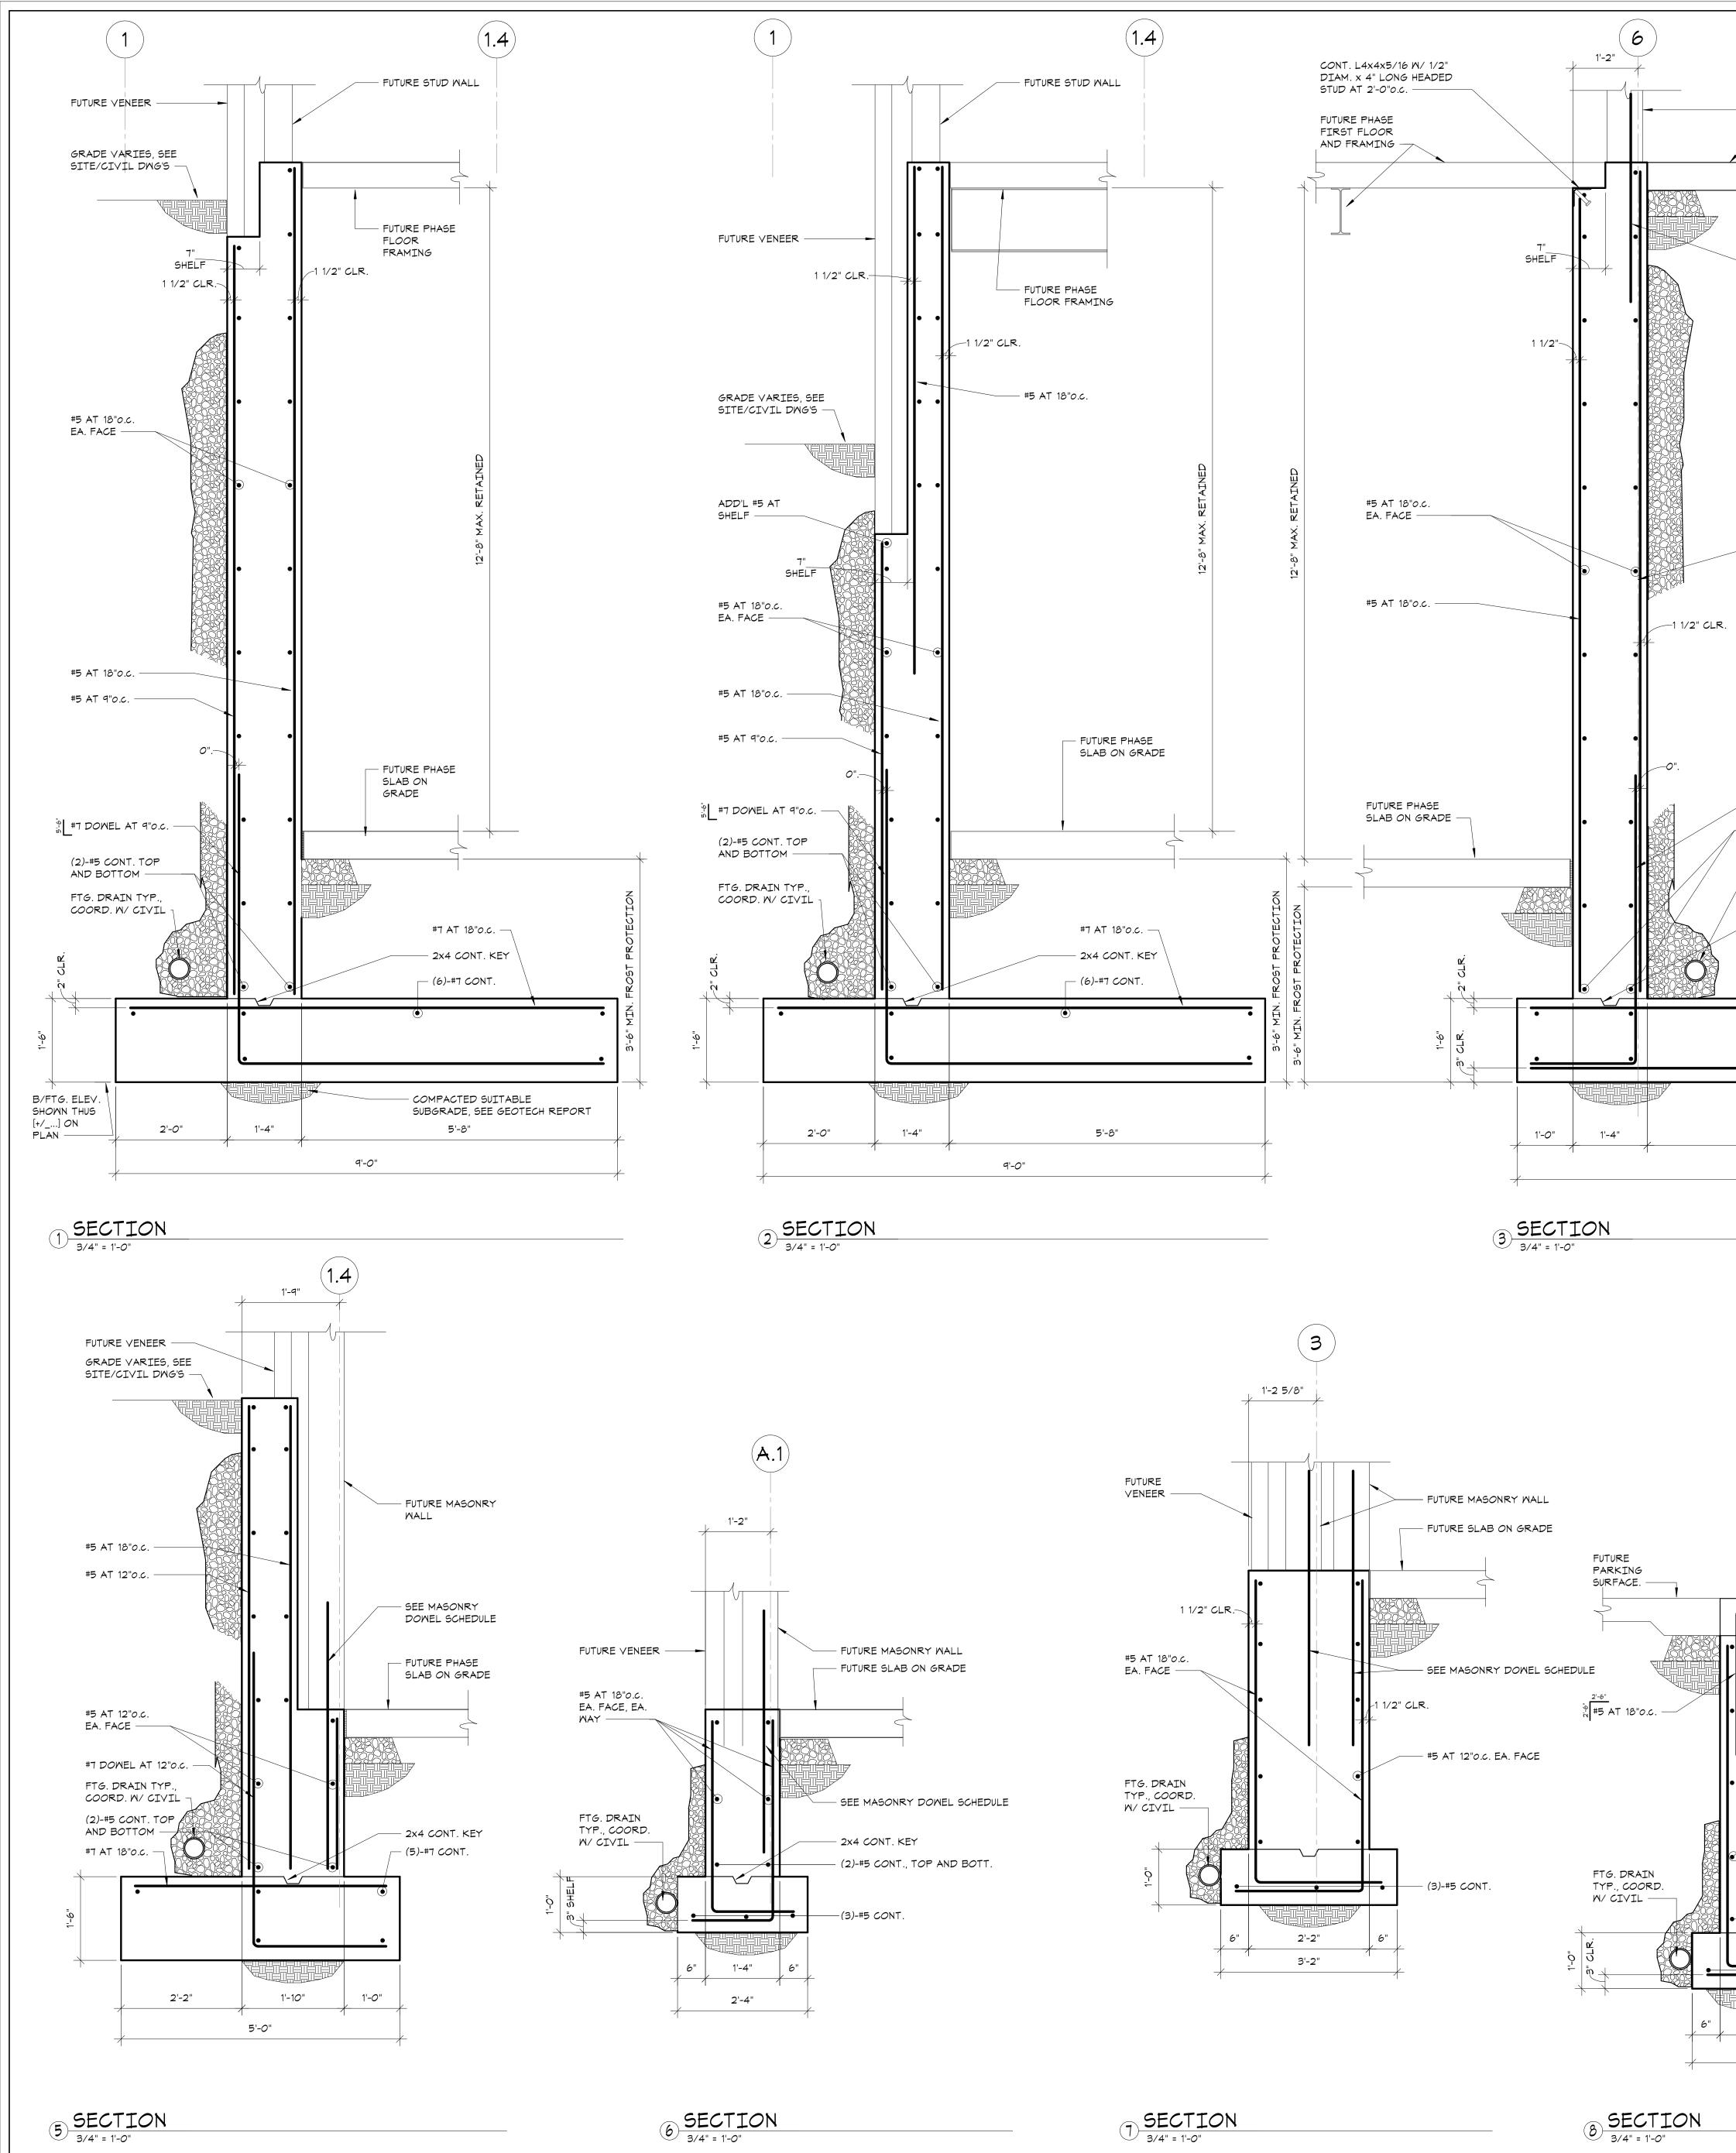



	(4)-3/4" DIAM. F1554 GRADE 36 HEX HEAD ANCHOR RODS W/ 12" EMBEDMENT, 5" THREADED PROJECTION AND 2" SQUARE X 1/4" A36 WASHERS
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TO SIZE AND SPACING OF MAGONRY VERT. WALL REINFORCING. FOR SIZE AND SPACING OF DOWELS, SEE "MAGONRY DOWEL SCHEDULE". REINFORCING DOWELS SHALL EXTEND UP FROM FOUNDATION WALLS, WITH LENSTHS SUFFICIENT TO PROVIDE FOR LAP LENGTHS OF 4& BAR DIAMETERS. NOTE "B": PROVIDE REINF. DOWELS BETWEEN FTG. AND FDN. WALL EQUAL TO SIZE AND SPACING OF MAGONRY WALL DOWELS. FOR SIZE AND SPACING OF DOWELS, SEE "MAGONRY DOWEL SCHEDULE". NOTE "C": PROVIDE 2x4 KEY AT TOP OF WALL AT WALL OPENING LOCATIONS SEE NOTE "A"		
I SIZE AL. (2)-I/2*0 x ANCHOR IN ROLTS TI "HIT-HY 200"		PROVIDE REINFORCING DOWELS BETWEEN FOUNDATION AND FUTURE MASONRY WALL EQUAL TO SIZE AND SPACING OF MASONRY VERT. WALL REINFORCING. FOR SIZE AND SPACING OF DOWELS, SEE "MASONRY DOWEL SCHEDULE". REINFORCING DOWELS SHALL EXTEND UP FROM FOUNDATION WALLS, WITH LENGTHS SUFFICIENT TO PROVIDE FOR LAP LENGTHS OF 48 BAR DIAMETERS.
PROVIDE 2x4 KEY AT TOP OF WALL AT WALL OPENING LOCATIONS SEE NOTE "A" SEE NOTE "C" 1/2" PREMOLDED JOINT FILLER, T 1/2" PR		NOTE "B": PROVIDE REINF. DOWELS BETWEEN FTG. AND FDN. WALL EQUAL TO SIZE AND SPACING OF MASONRY WALL DOWELS. FOR SIZE AND SPACING OF DOWELS, SEE "MASONRY DOWEL SCHEDULE".
1 SIZE (2)-#5 CONT., TOP AND BOT. (2)-#5 CONT., TOP AND BOT. (2)-#5 CONT., TOP AND BOT. T/WALL OR FTG. T/FUTURE CONC. SLAB ON GRADE ON GRADE ON GRADE		PROVIDE 2x4 KEY AT TOP OF WALL AT WALL OPENING LOCATIONS FUTURE MASONRY WALL
T/FUTURE CONC. SLAB ON GRADE ON GRADE ON GRADE TI "HIT-HY 200"		T/WALL OR FTG.
HOR BOLTS TI "HIT-HY 200"	L. (2)-1/2"Ø x	T/FUTURE CONC. SLAB
	OR BOLTS	
2x4 KEY CONT.		2x4 KEY CONT.
#5 AT 12"0.C.		
	ĸ	
NALL SECTIONS (3)-#5 CONT B/FTG. EL. NOTED THUS	NALL SECTIONS	

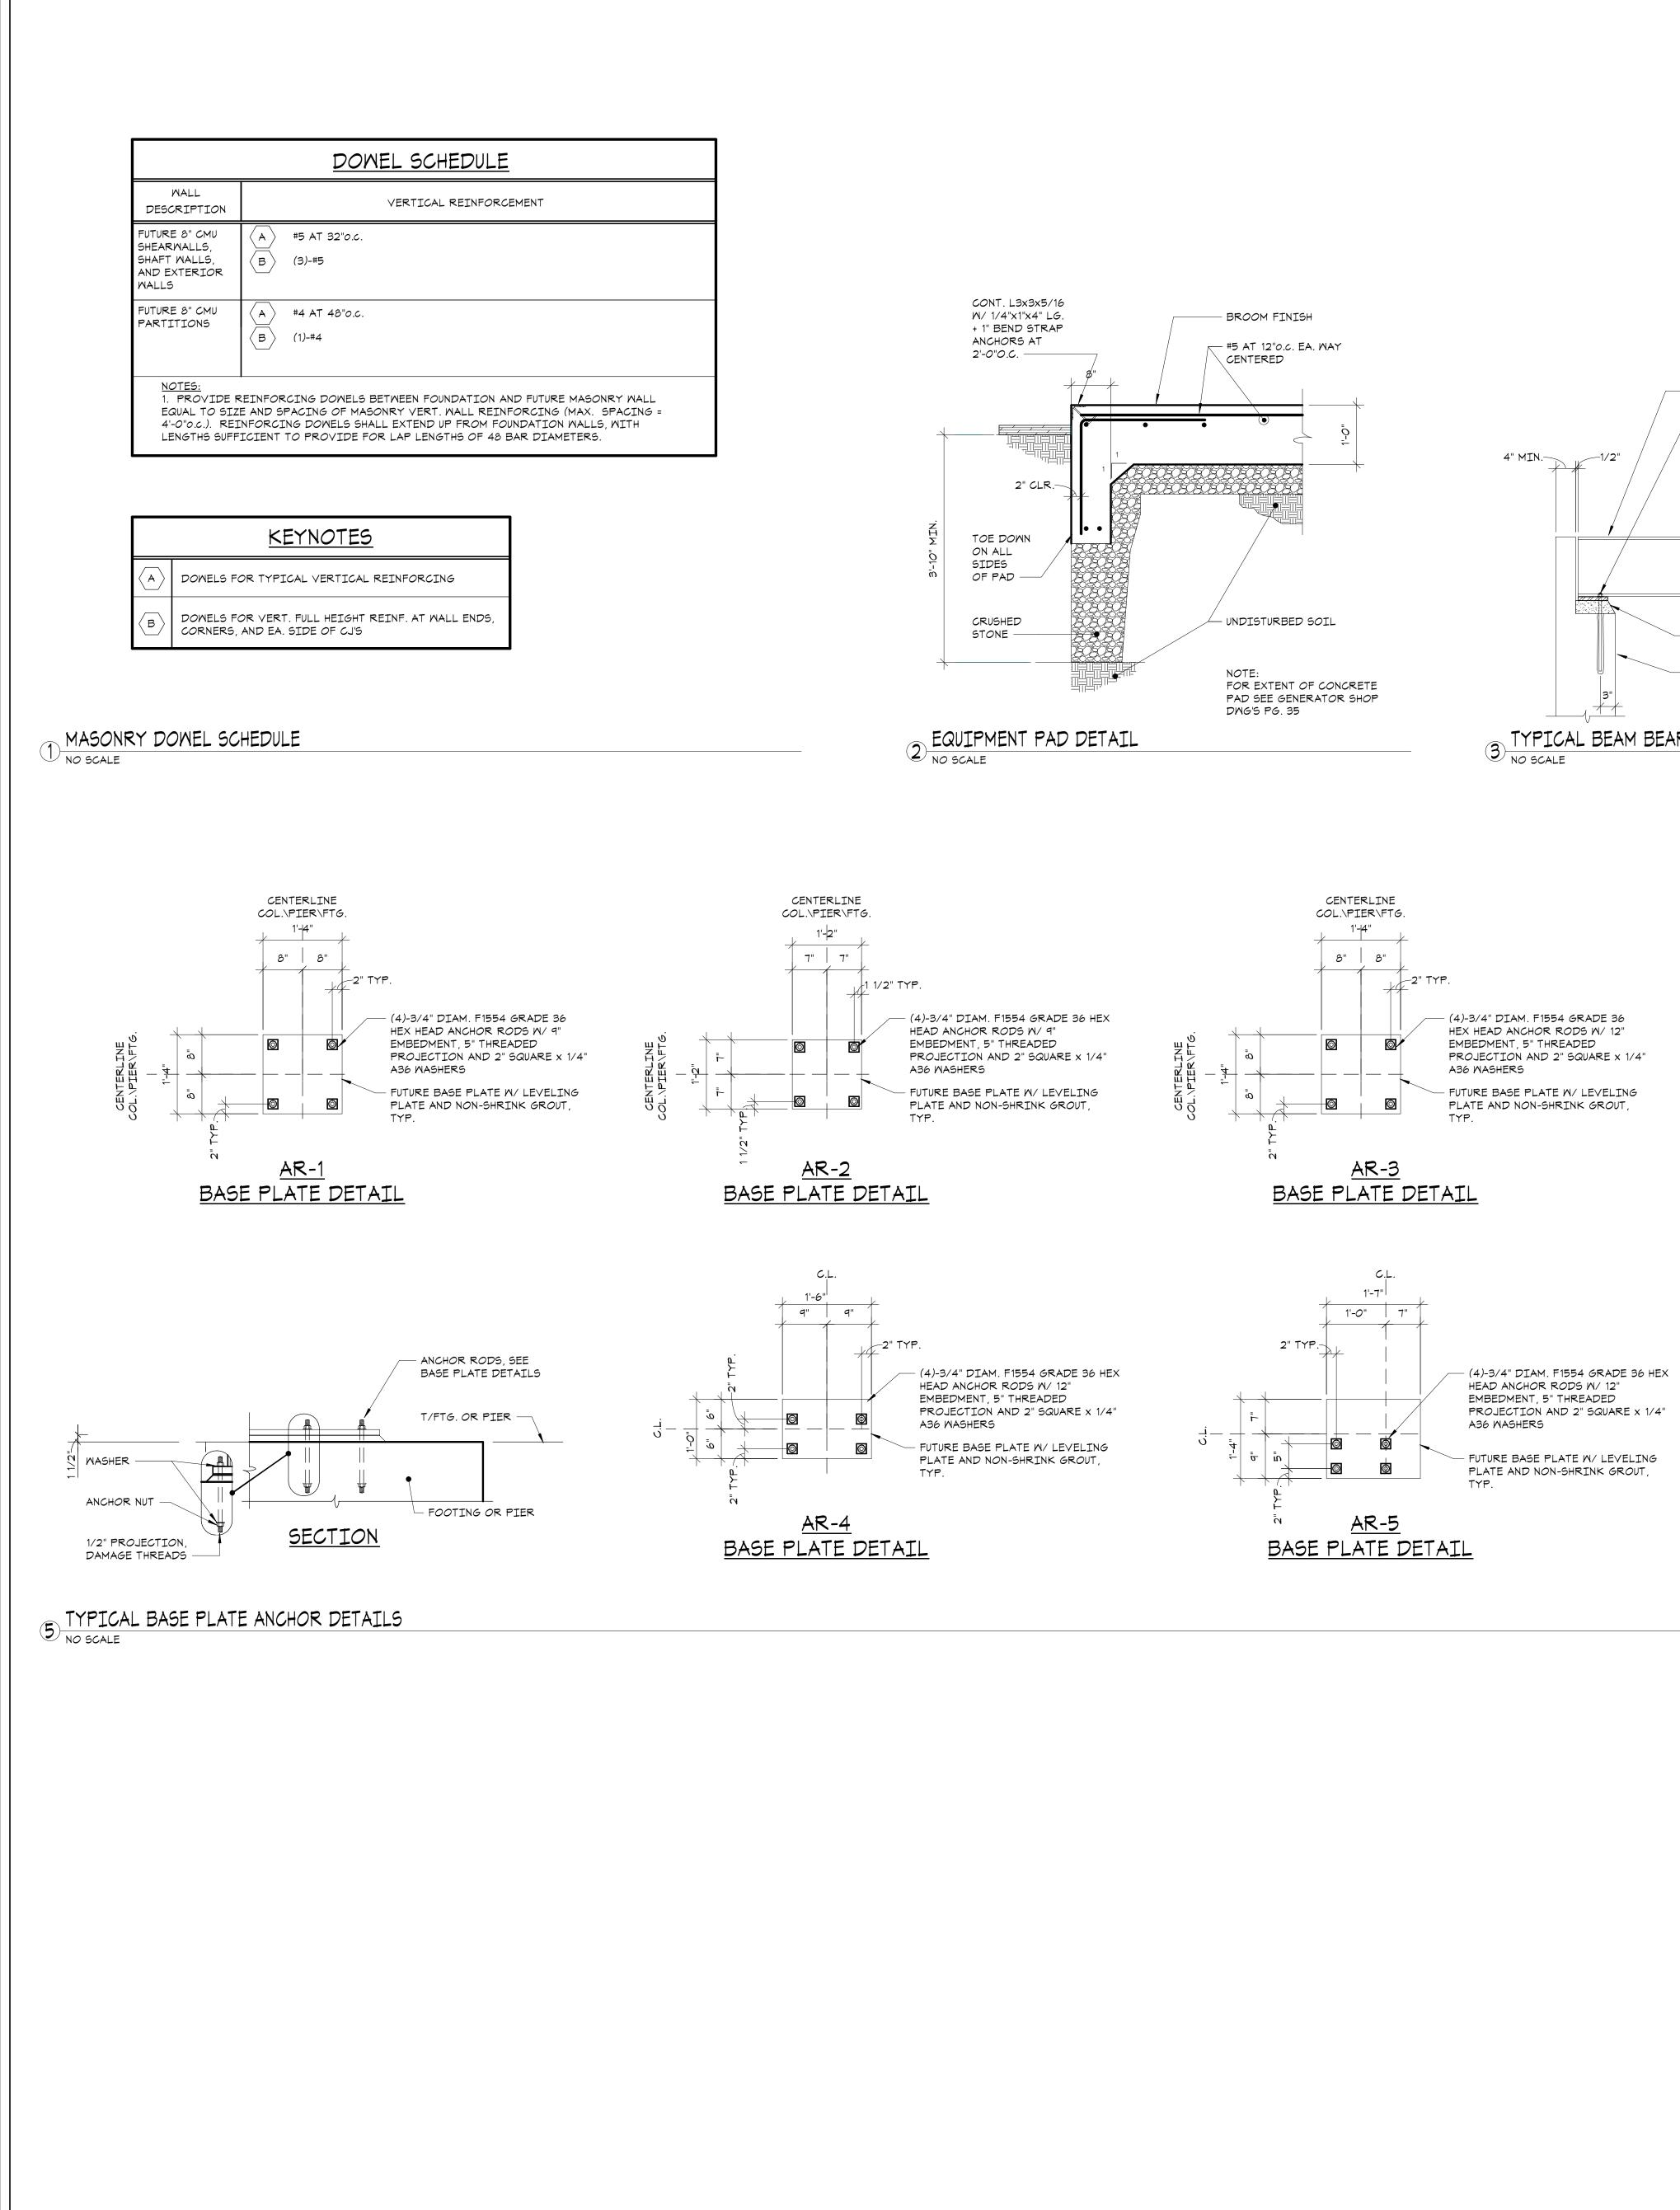
4 TYPICAL FOUNDATION DETAIL FOR FUTURE MASONRY WALLS

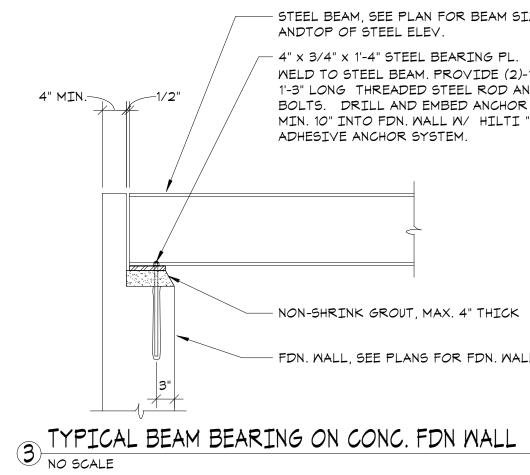
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270 Harrison Avenue Harrison, NY 10528 INFORMATION STREET - MOUNT KISCO, NEW YORK 10549 P:914.666.5900 INFORMATION STREET - MOUNT KISCO, NEW YORK 10549 P:914.666.5900 INFORMATION STREET - MOUNT KISCO, NEW YORK 10549 P:914.666.5900
Engineering Group Structural Engineers 83 Wooster Heights Rd, Ste 200 Danbury, CT 06810 [203] 490-4140 www.tdeg.com CONSTRUCTION DOCUMENTS
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No. Date Issue Sheet Title FOUNDATION FOUNDATION SCHEDULES AND SCHEDULES AND DETAILS Job No. Date 20029.00 04/20/23 Scale Drawn / Checked AS NOTED Drawn / Checked Sheet Number Sheet Number




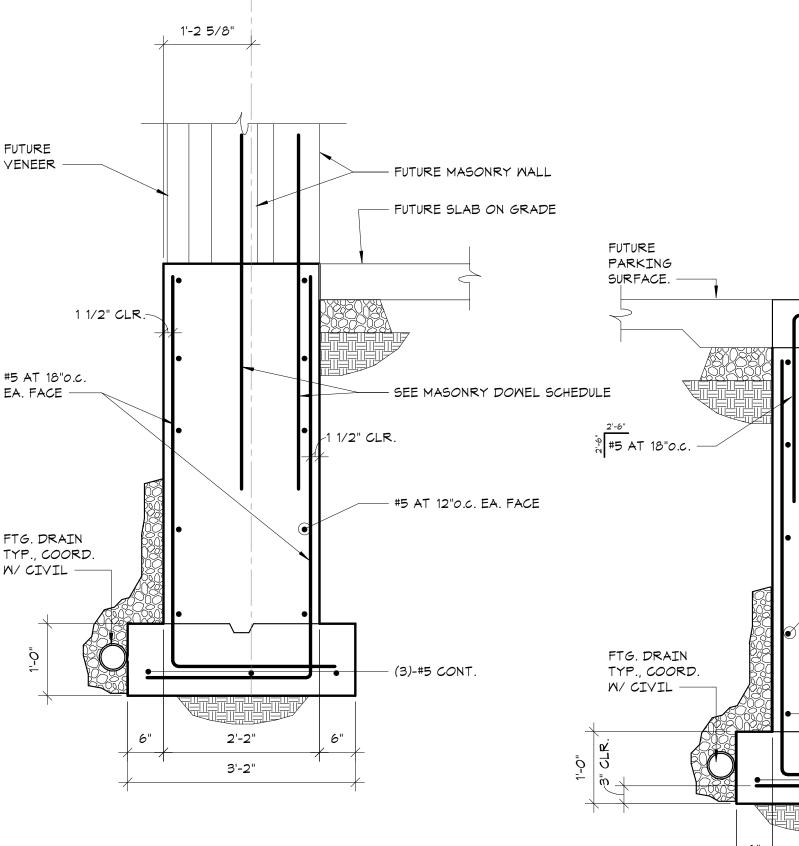



9 SECTION 3/4" = 1'-0"

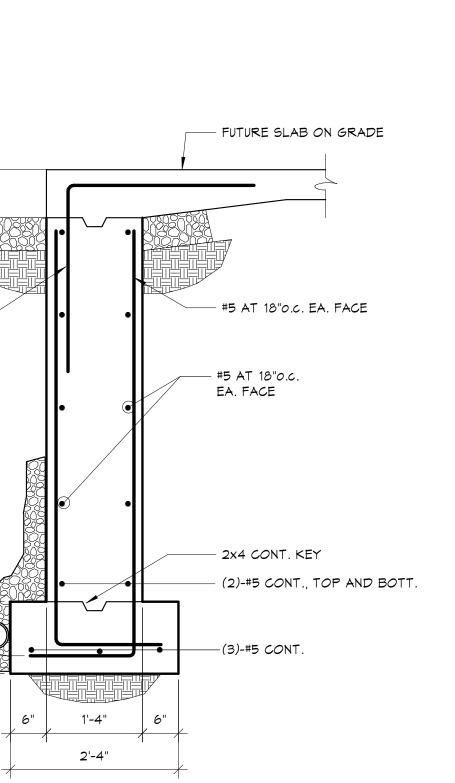

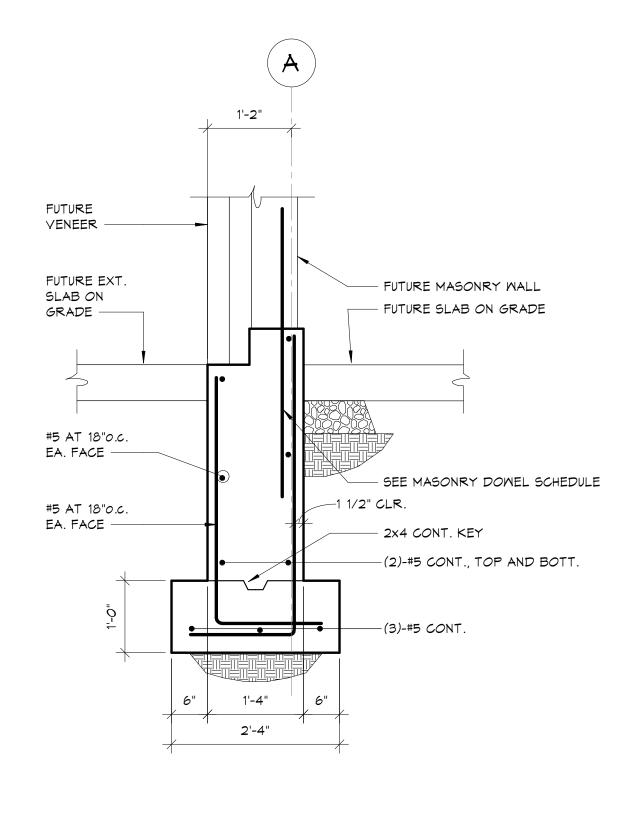

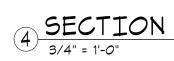

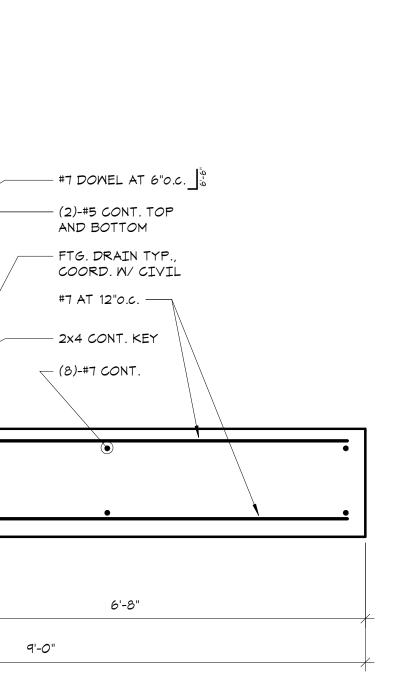

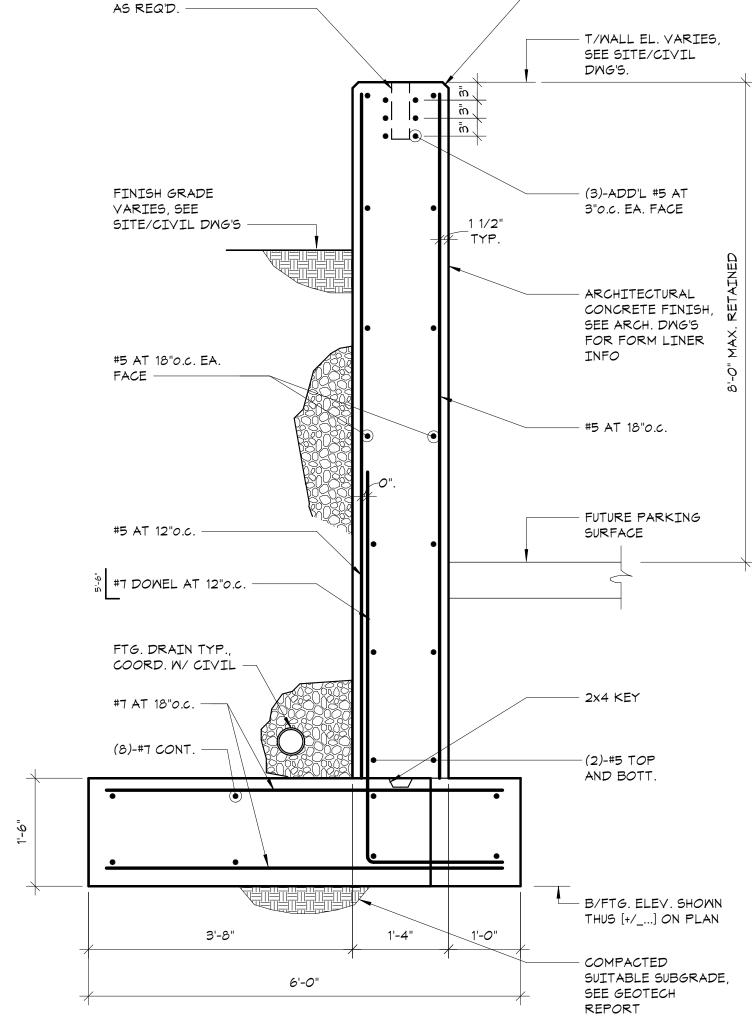

- CHAMFER EDGE


FENCE POST INSERT

- SEE MASONRY DOWEL SCHEDULE


- #5 AT 12"0.c.

— FUTURE PHASE SLAB ON GRADE


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4 06/09/2023 ISSUE FOR PERMIT - PHASE 1 2 2023-03-31 PHASE 1 - 50% CD'S No. Date Issue Sheet Title Issue
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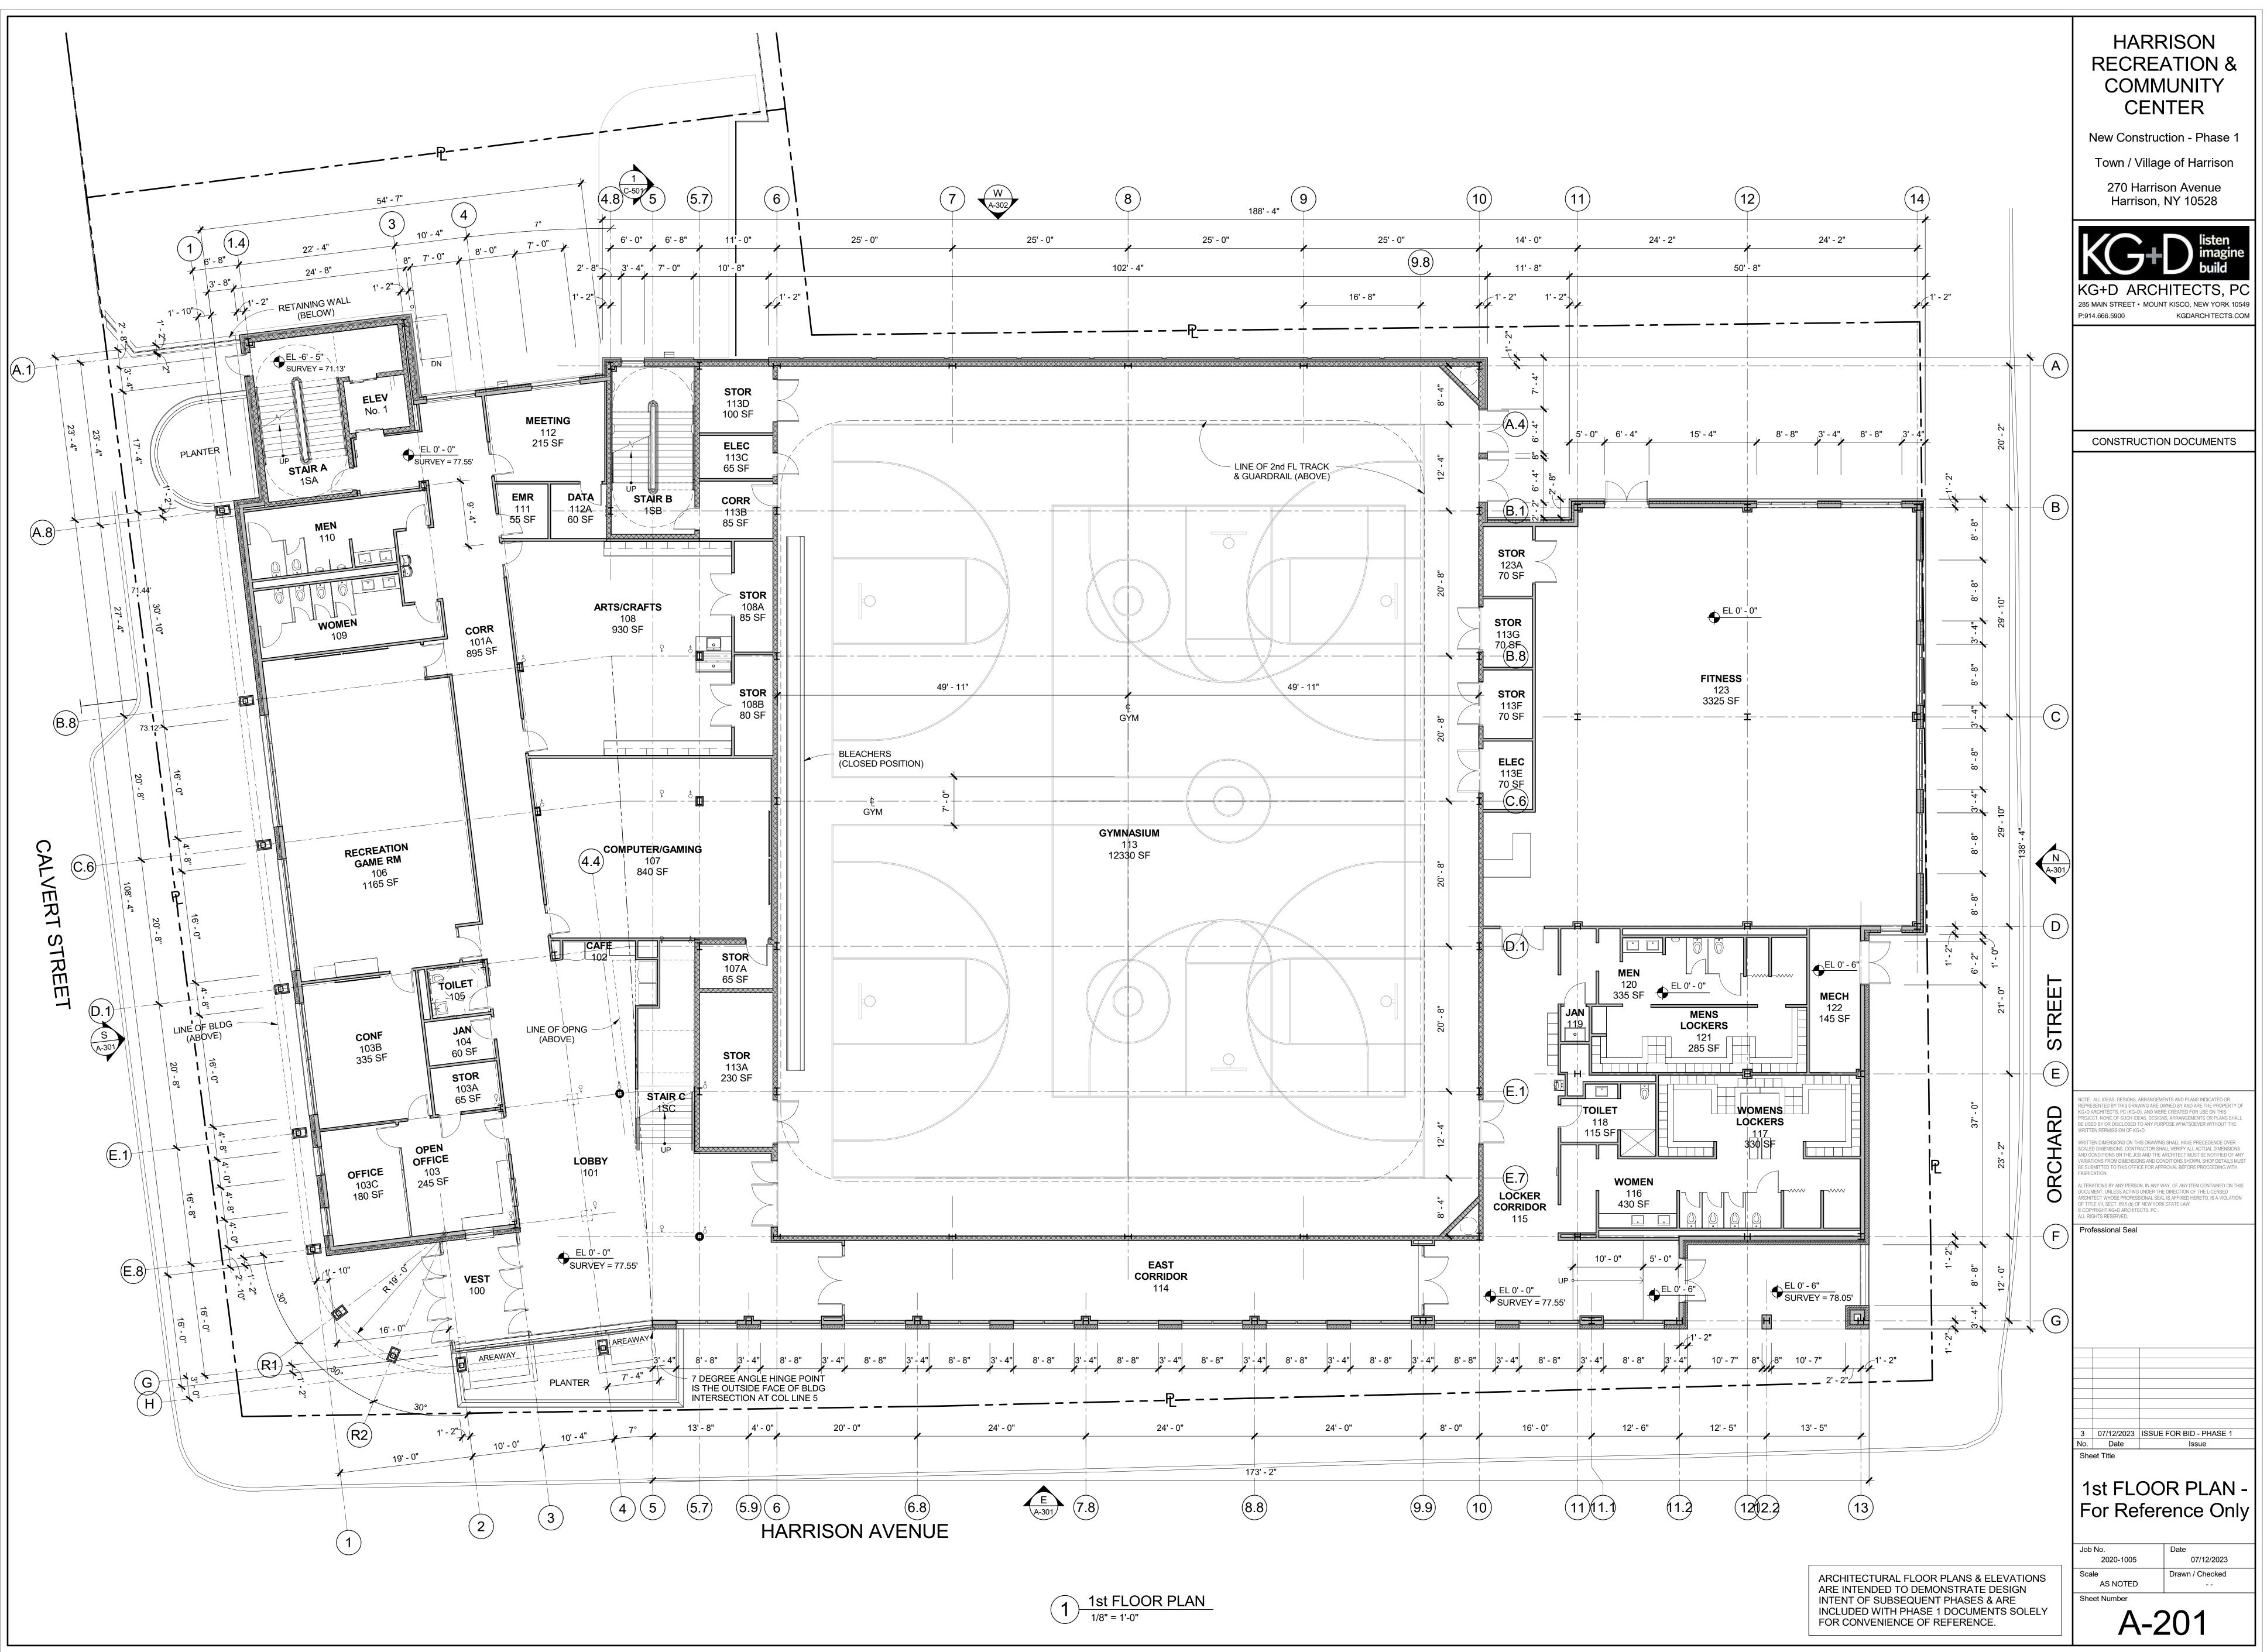
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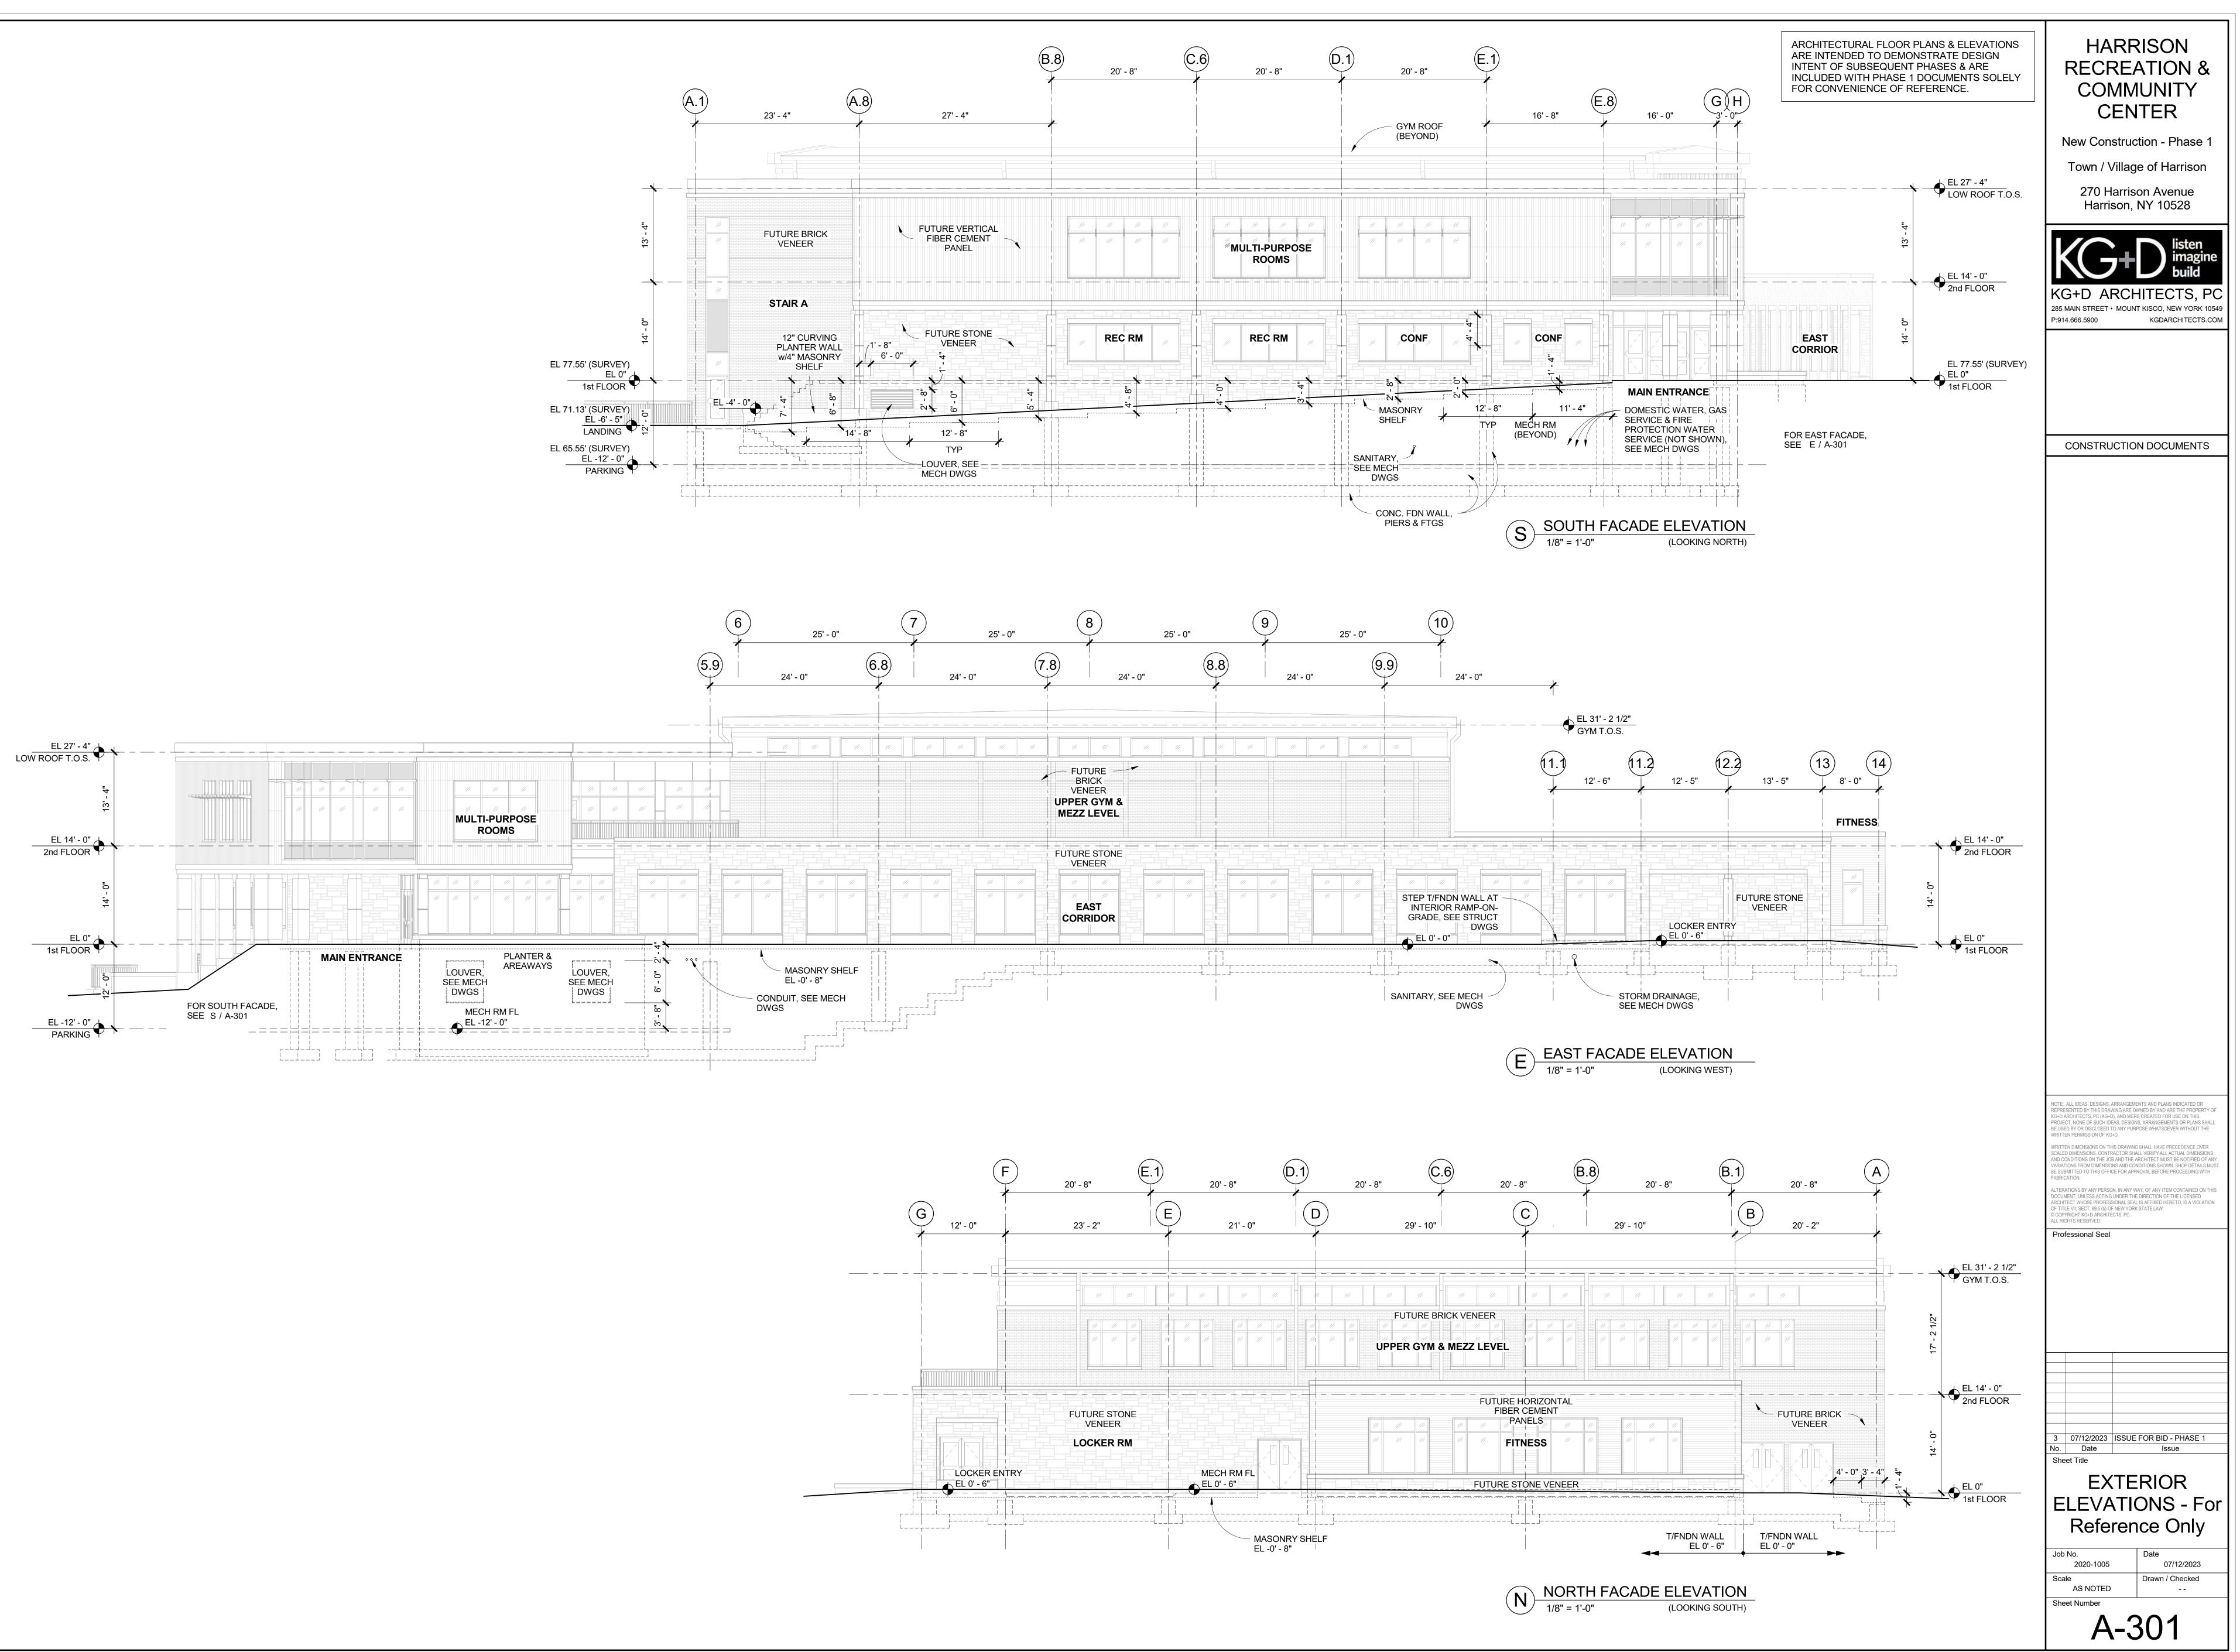


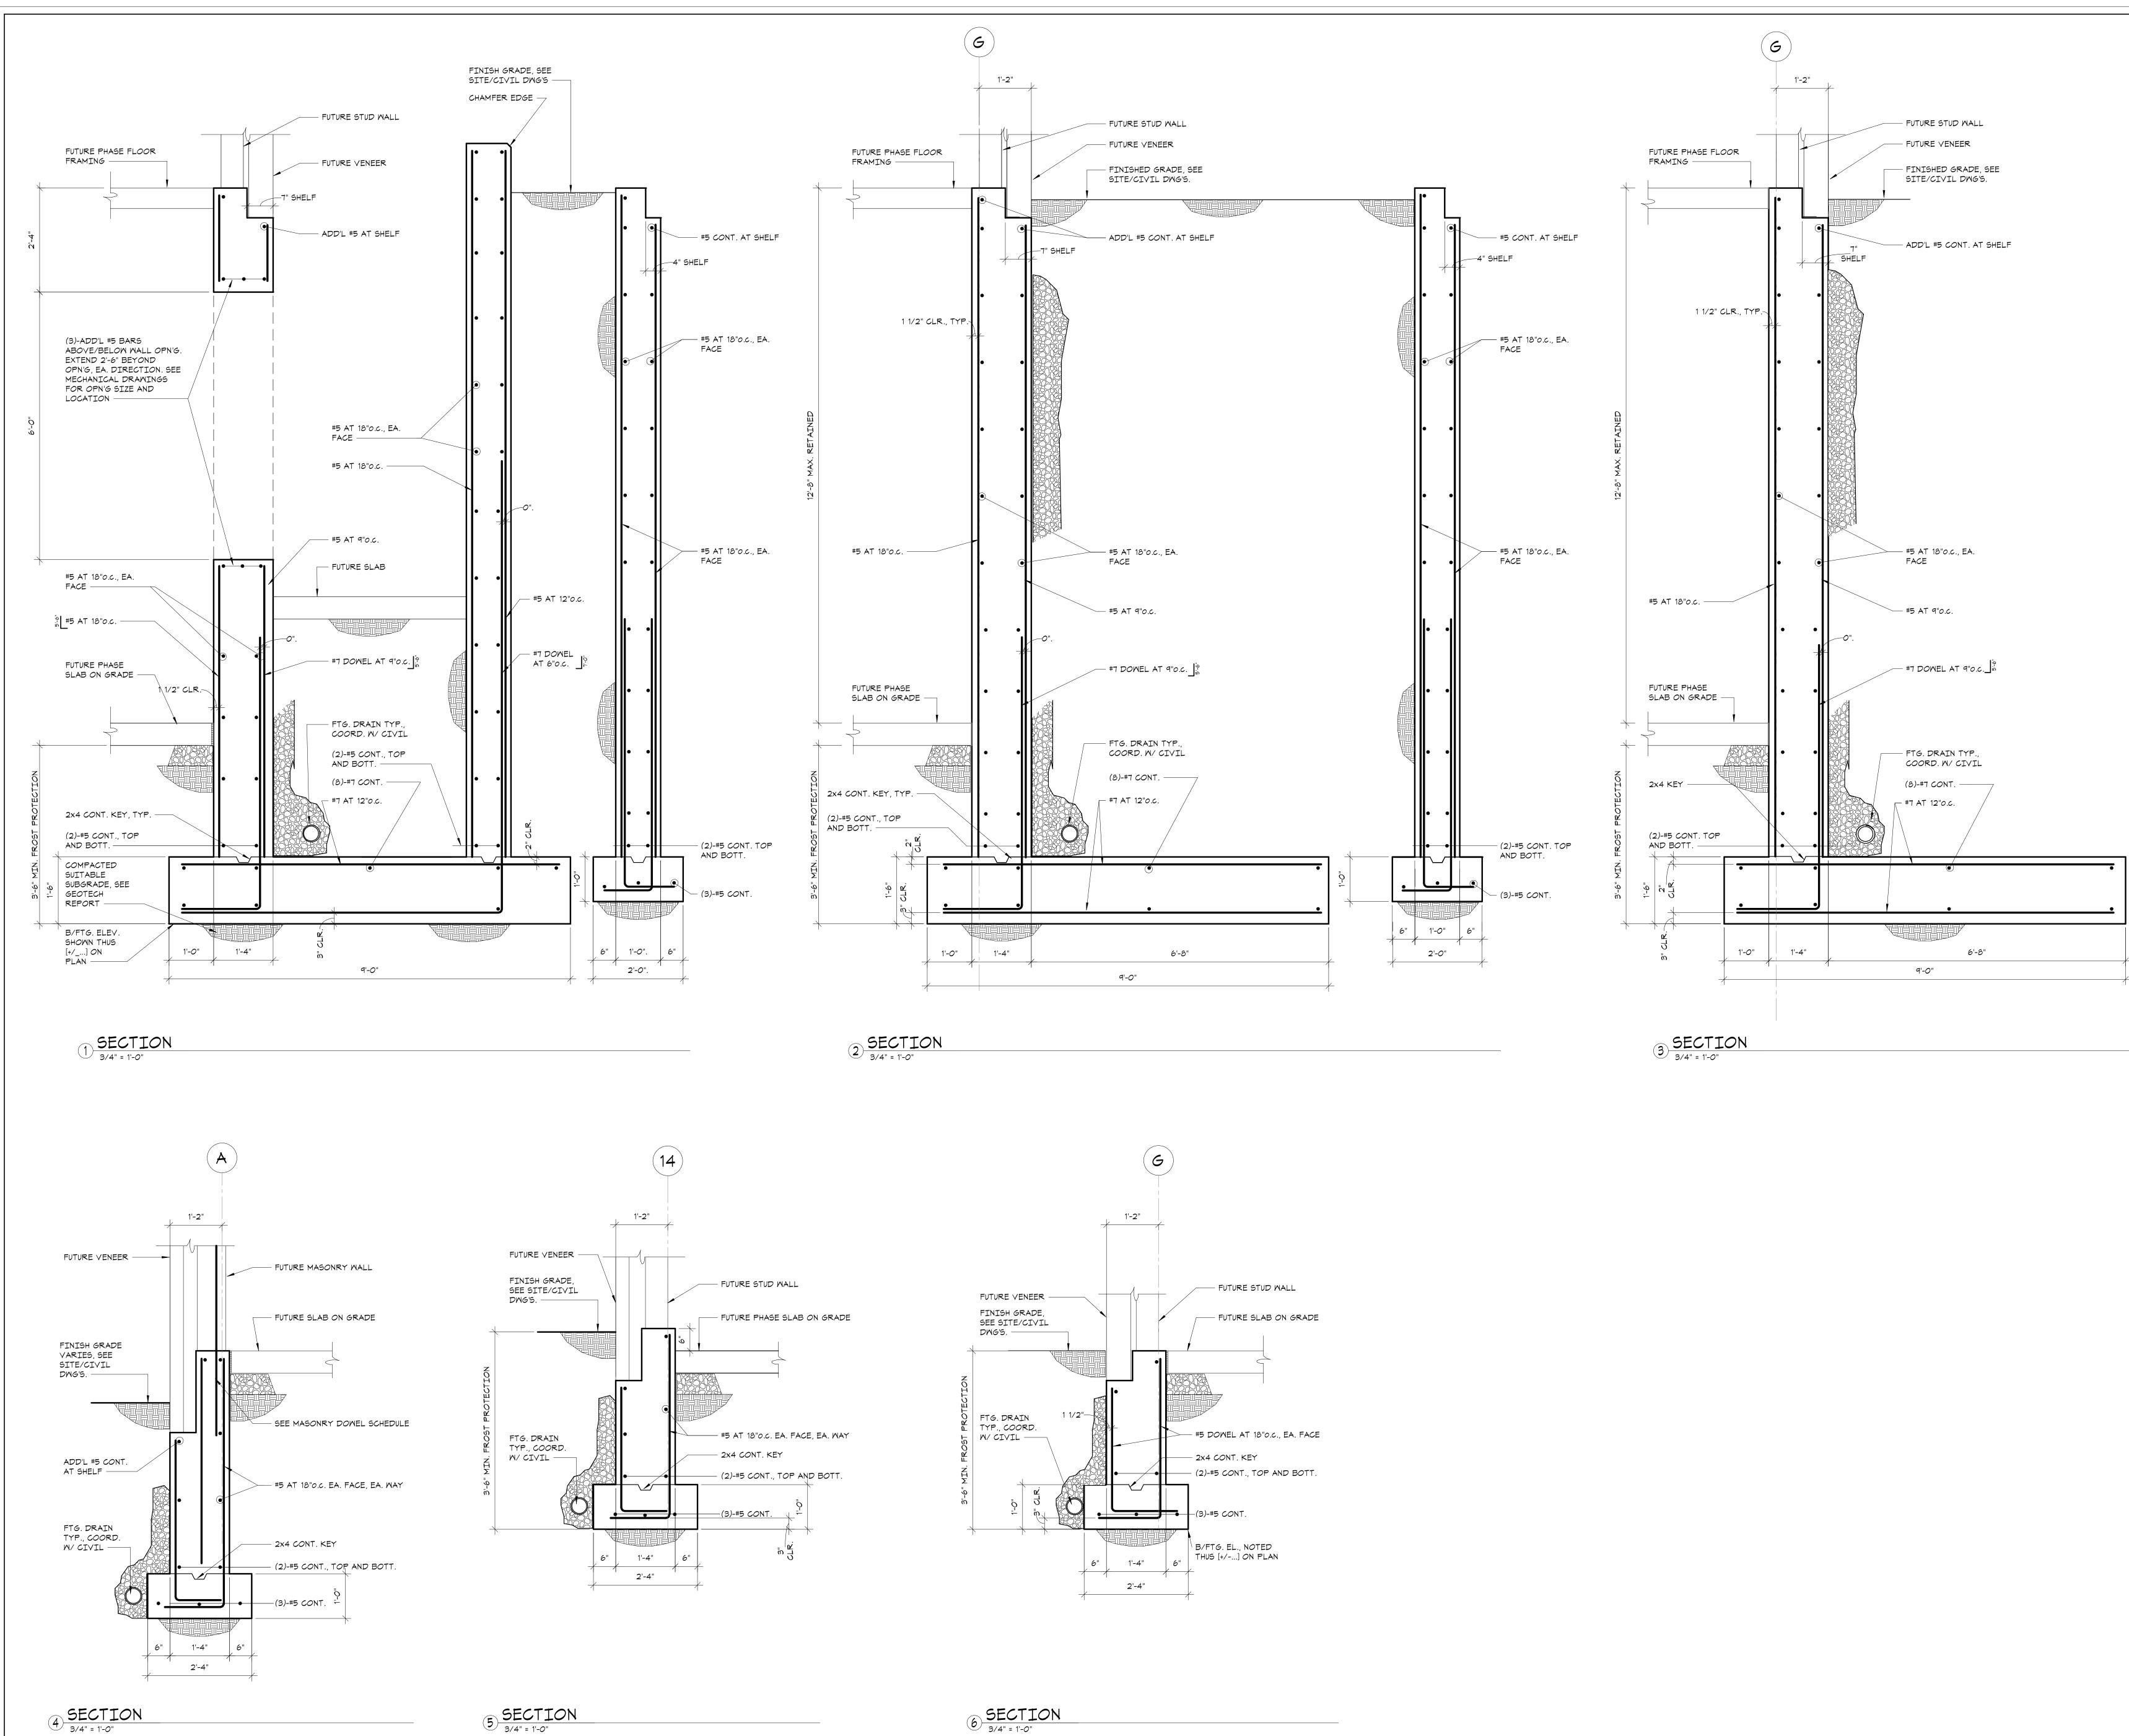
 CONC RETAINING
 WALL, SEE STRUCT
 DWGS 14' - 11" 1' - 10" _' HEH (A.8) (B.8) \mathbf{O} A (C.6) VERT ഗ R Π (E.1) (E.8) (G)

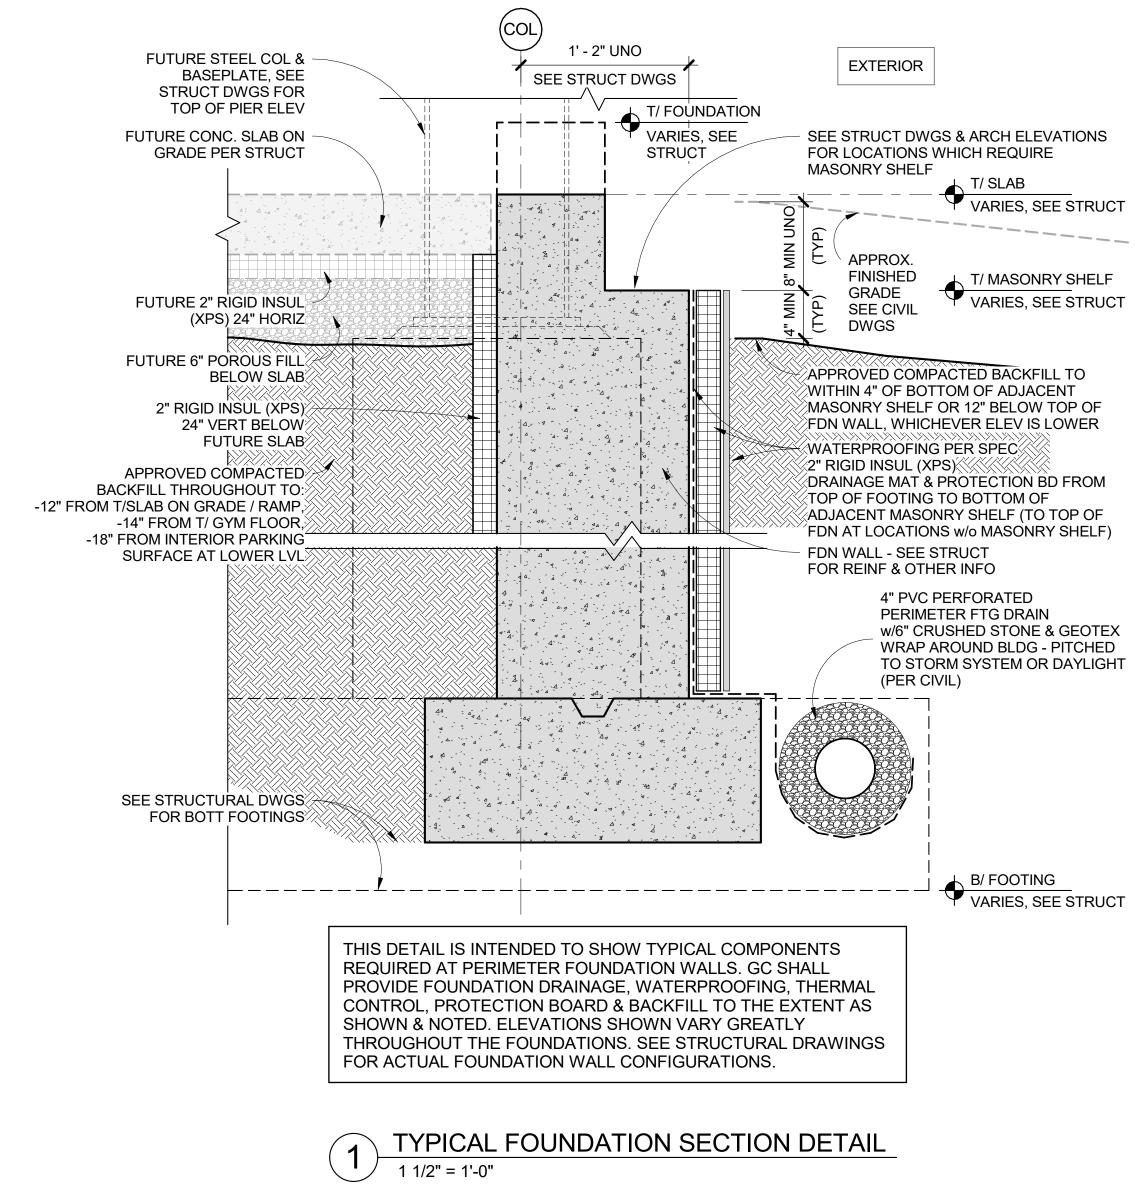


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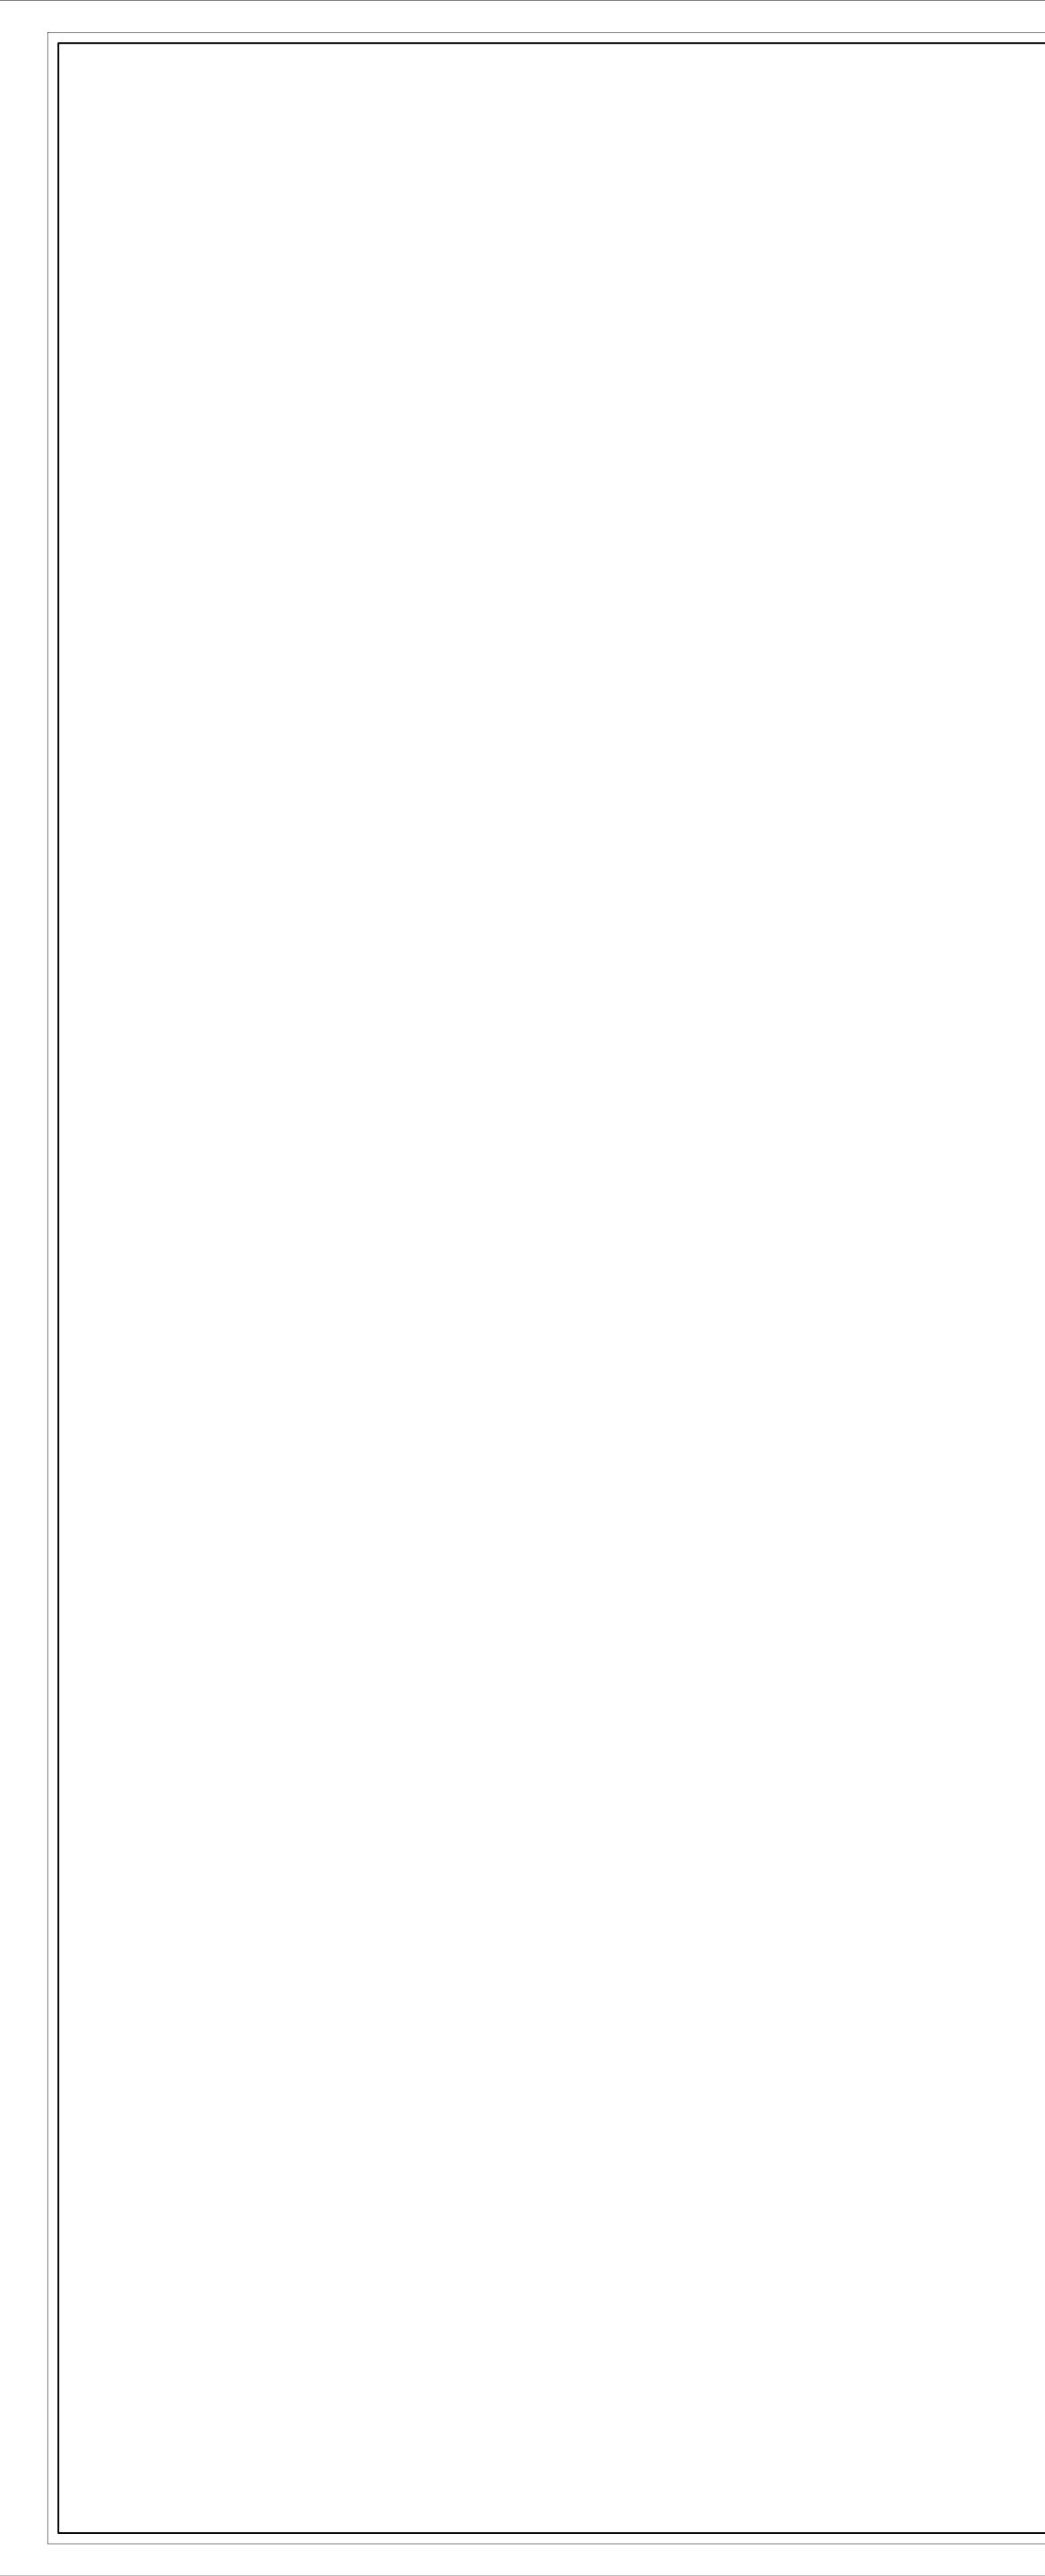




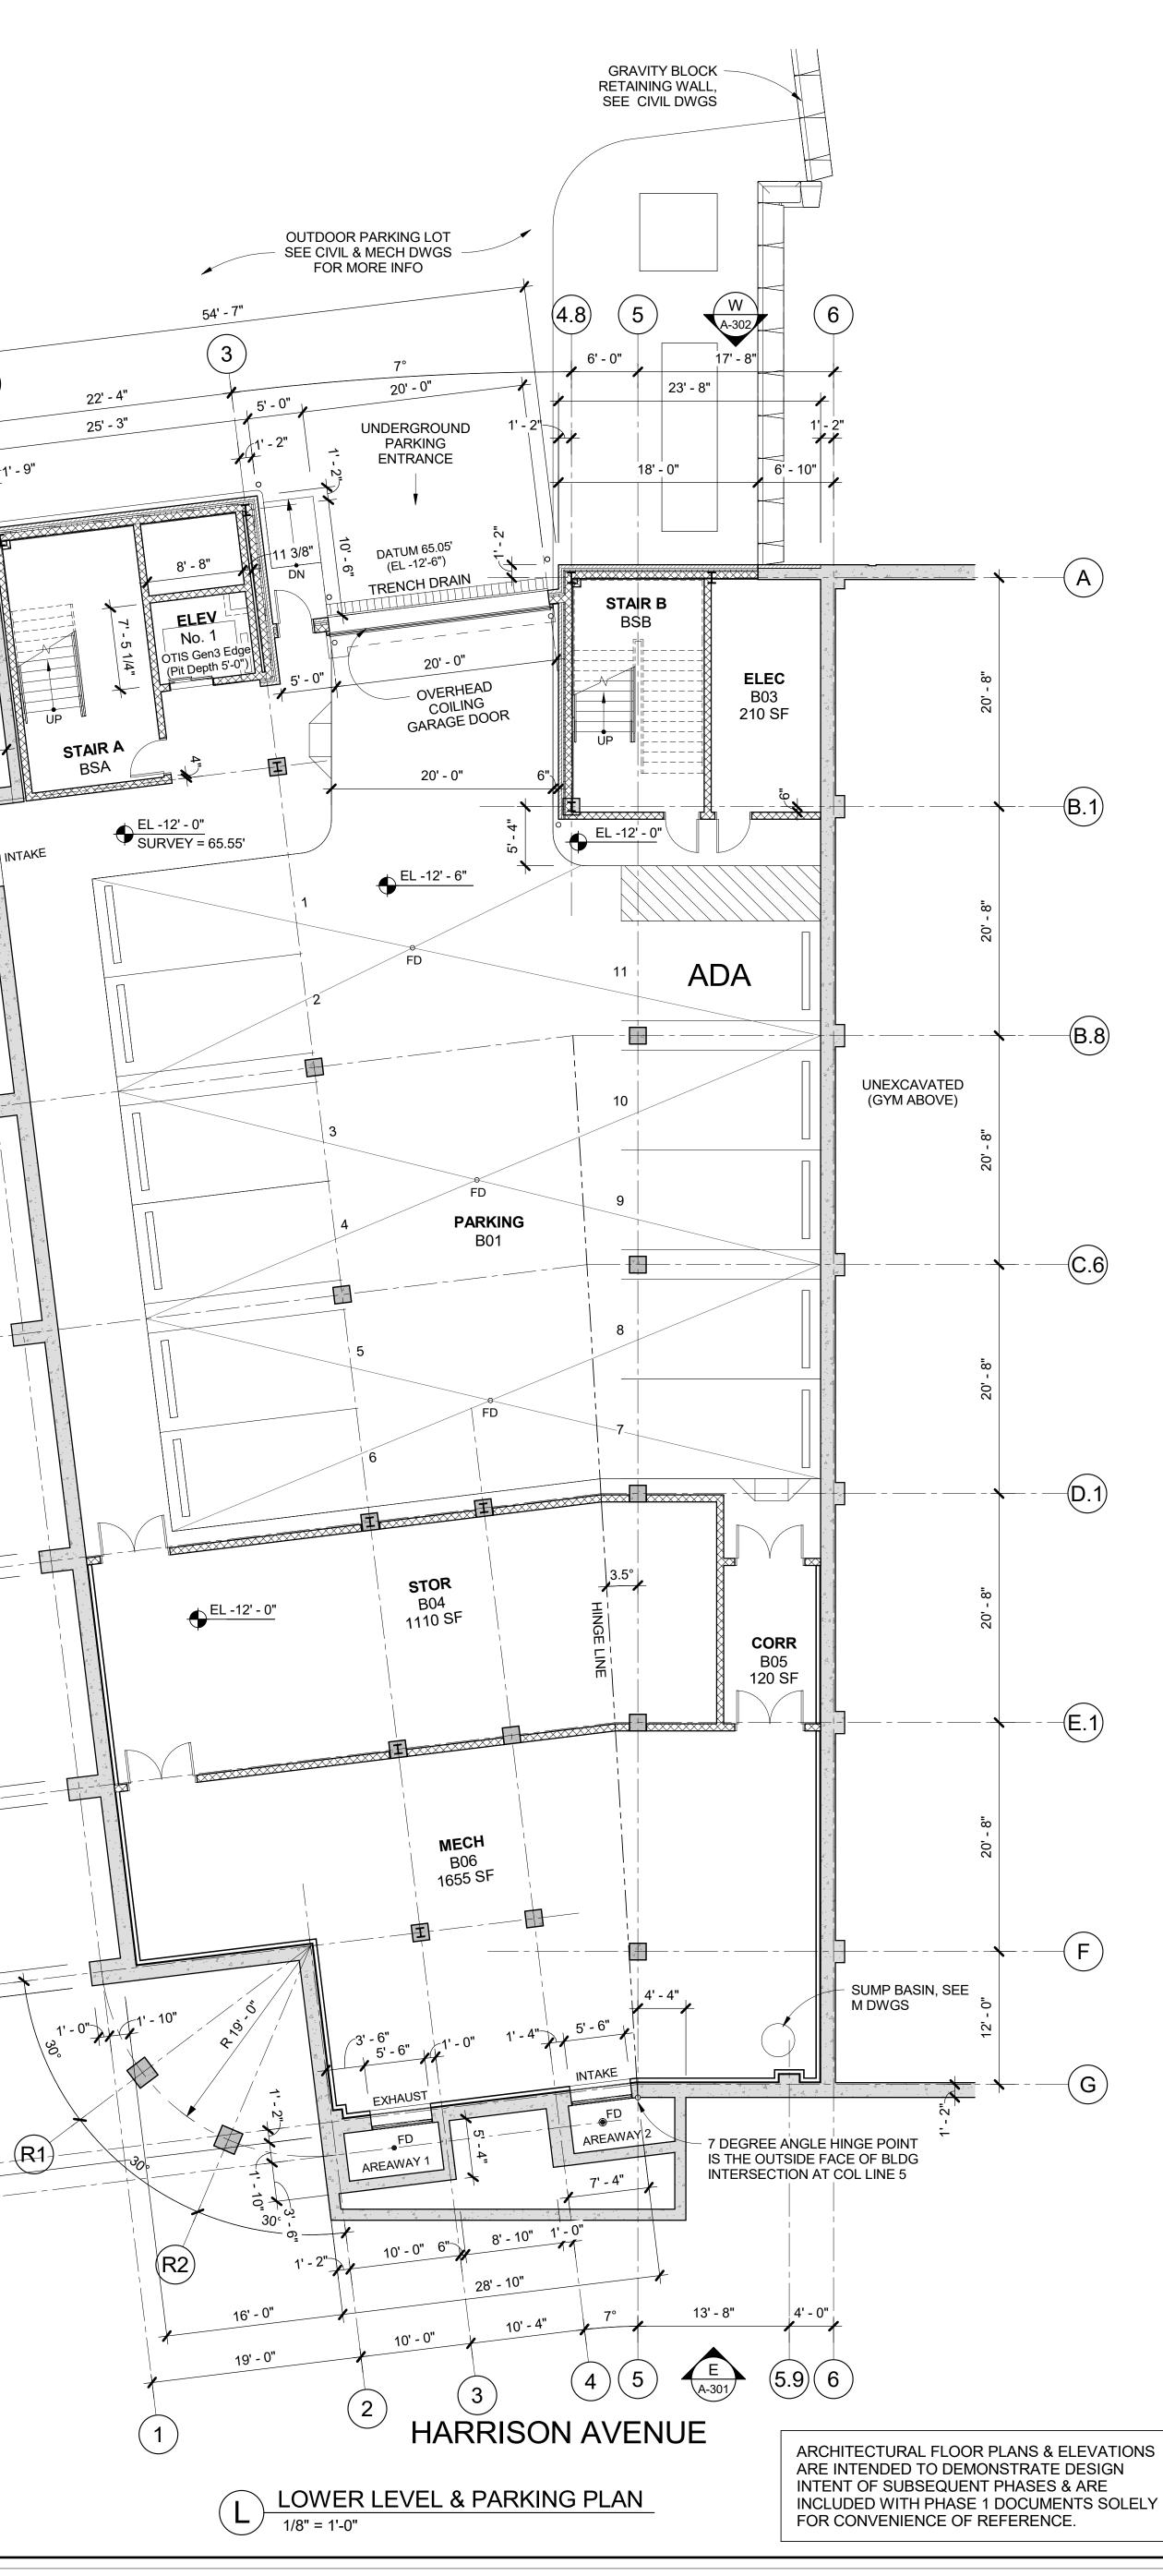

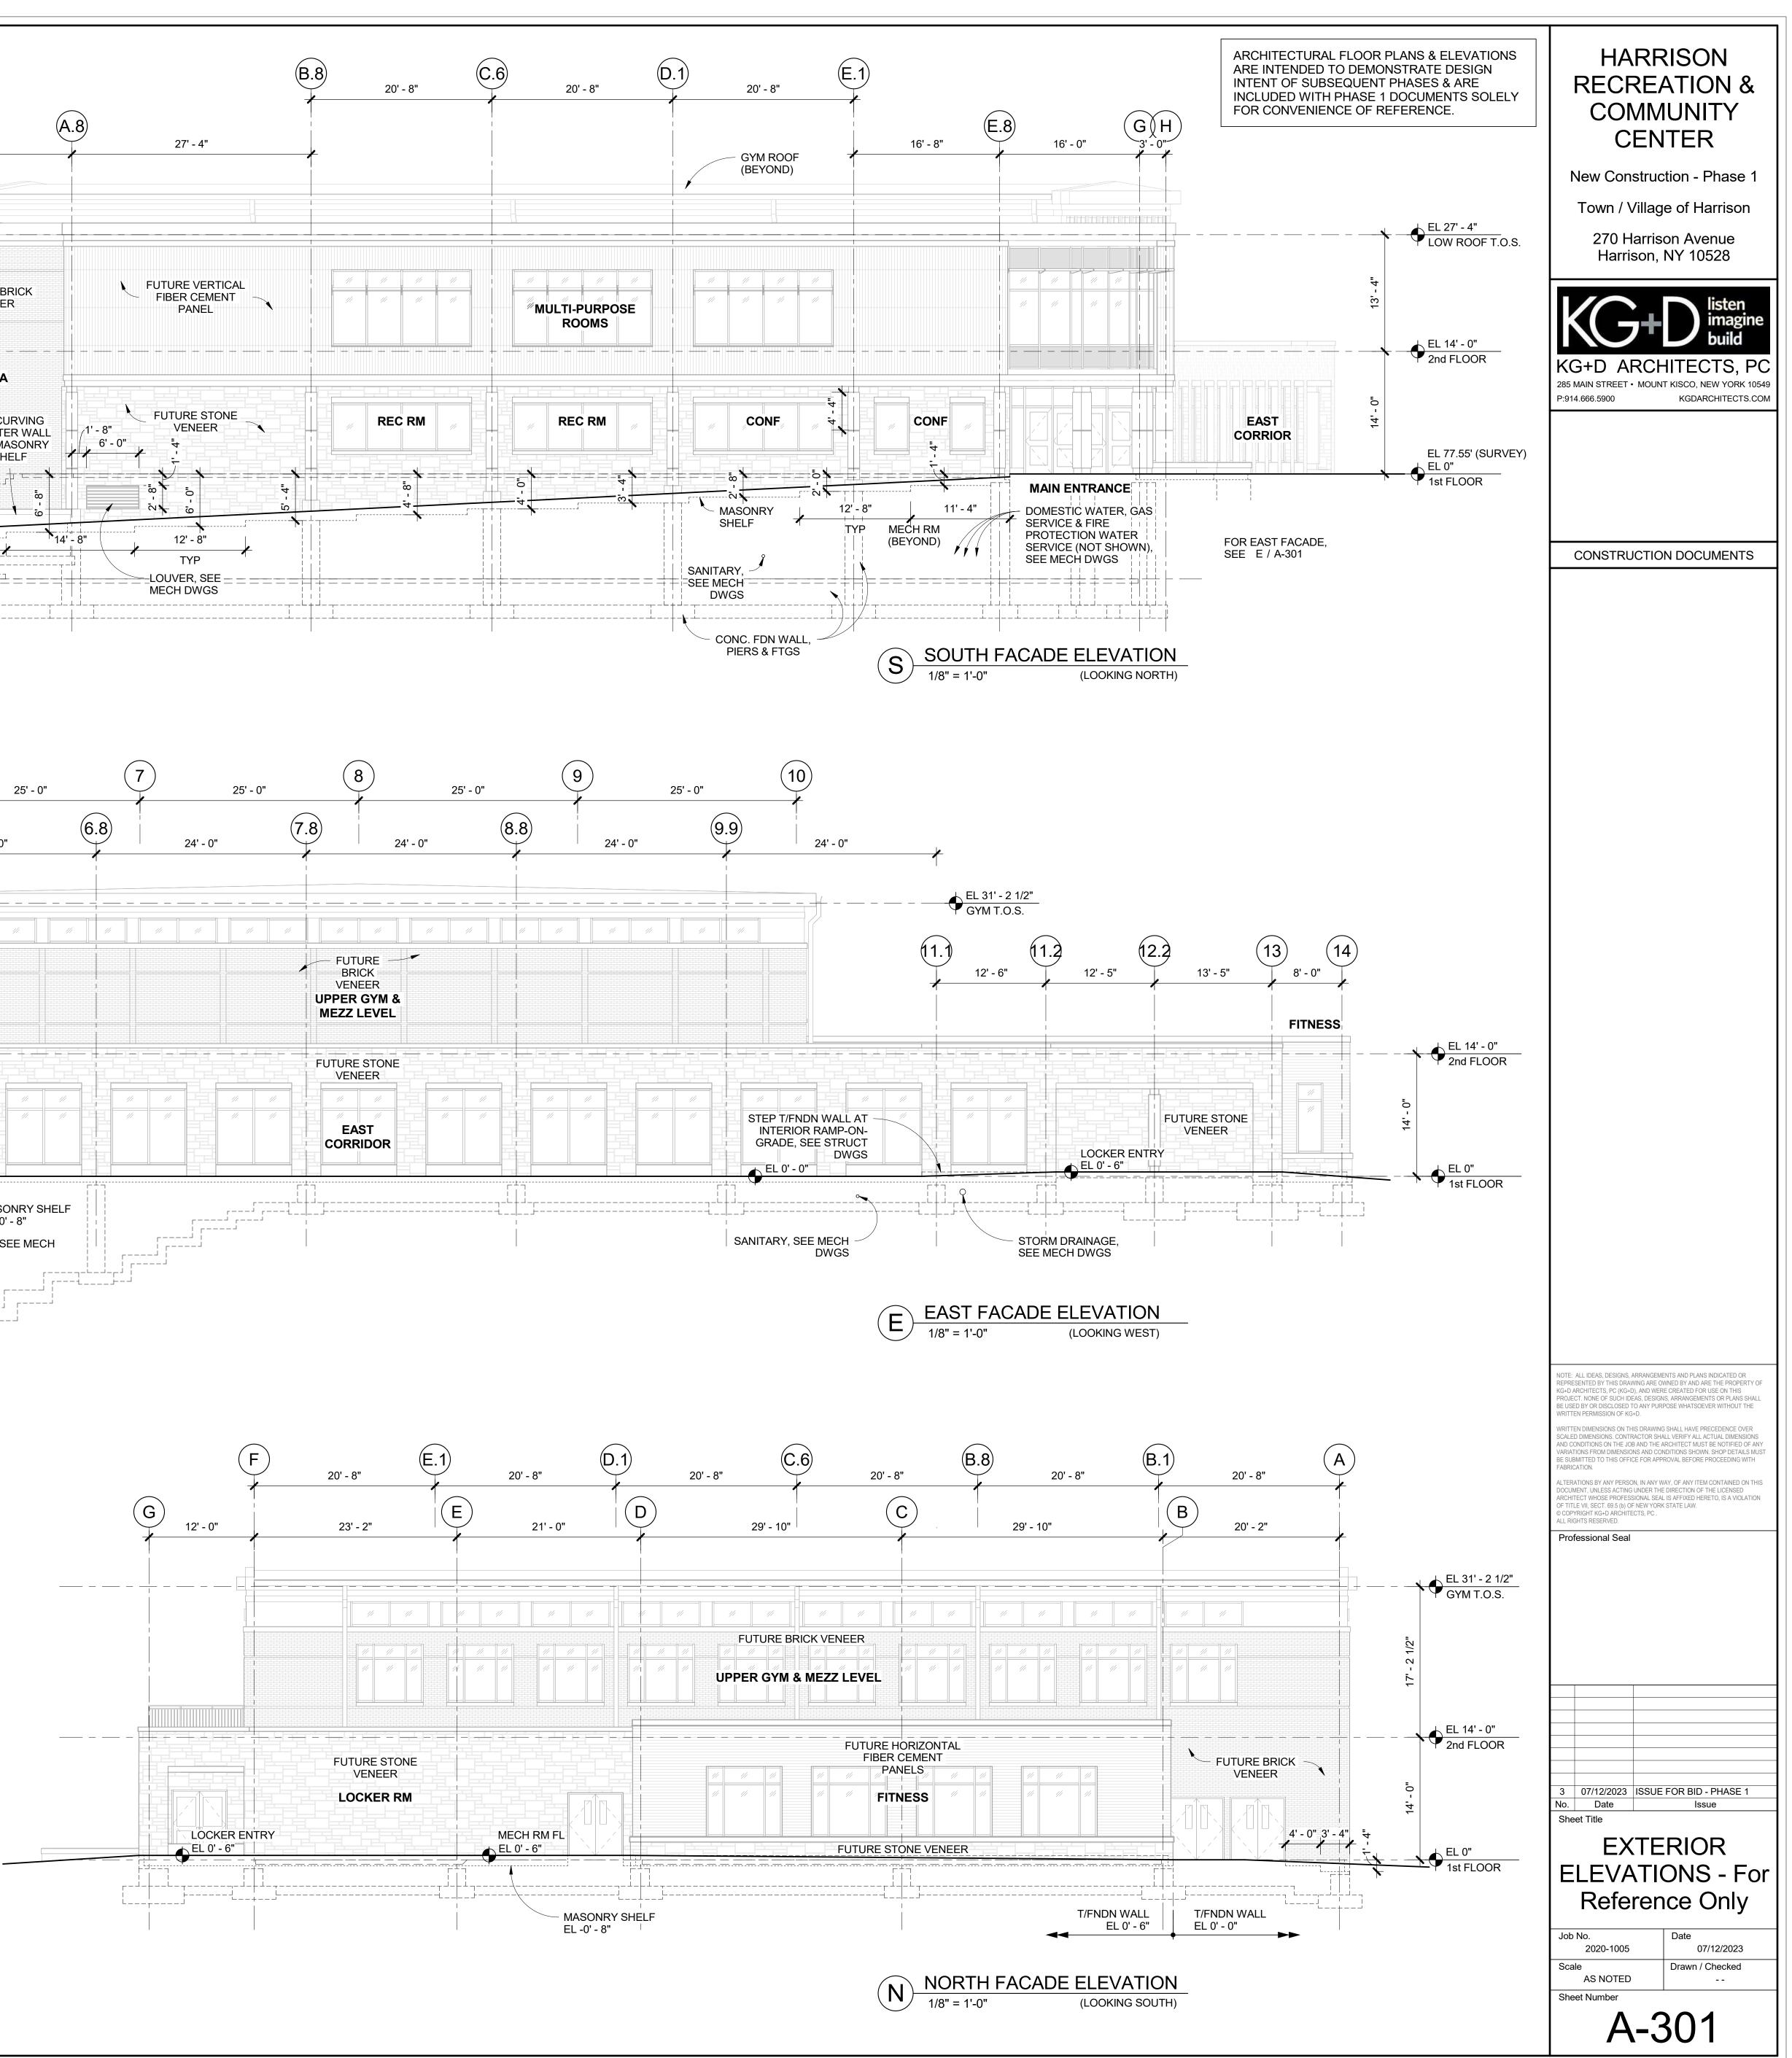

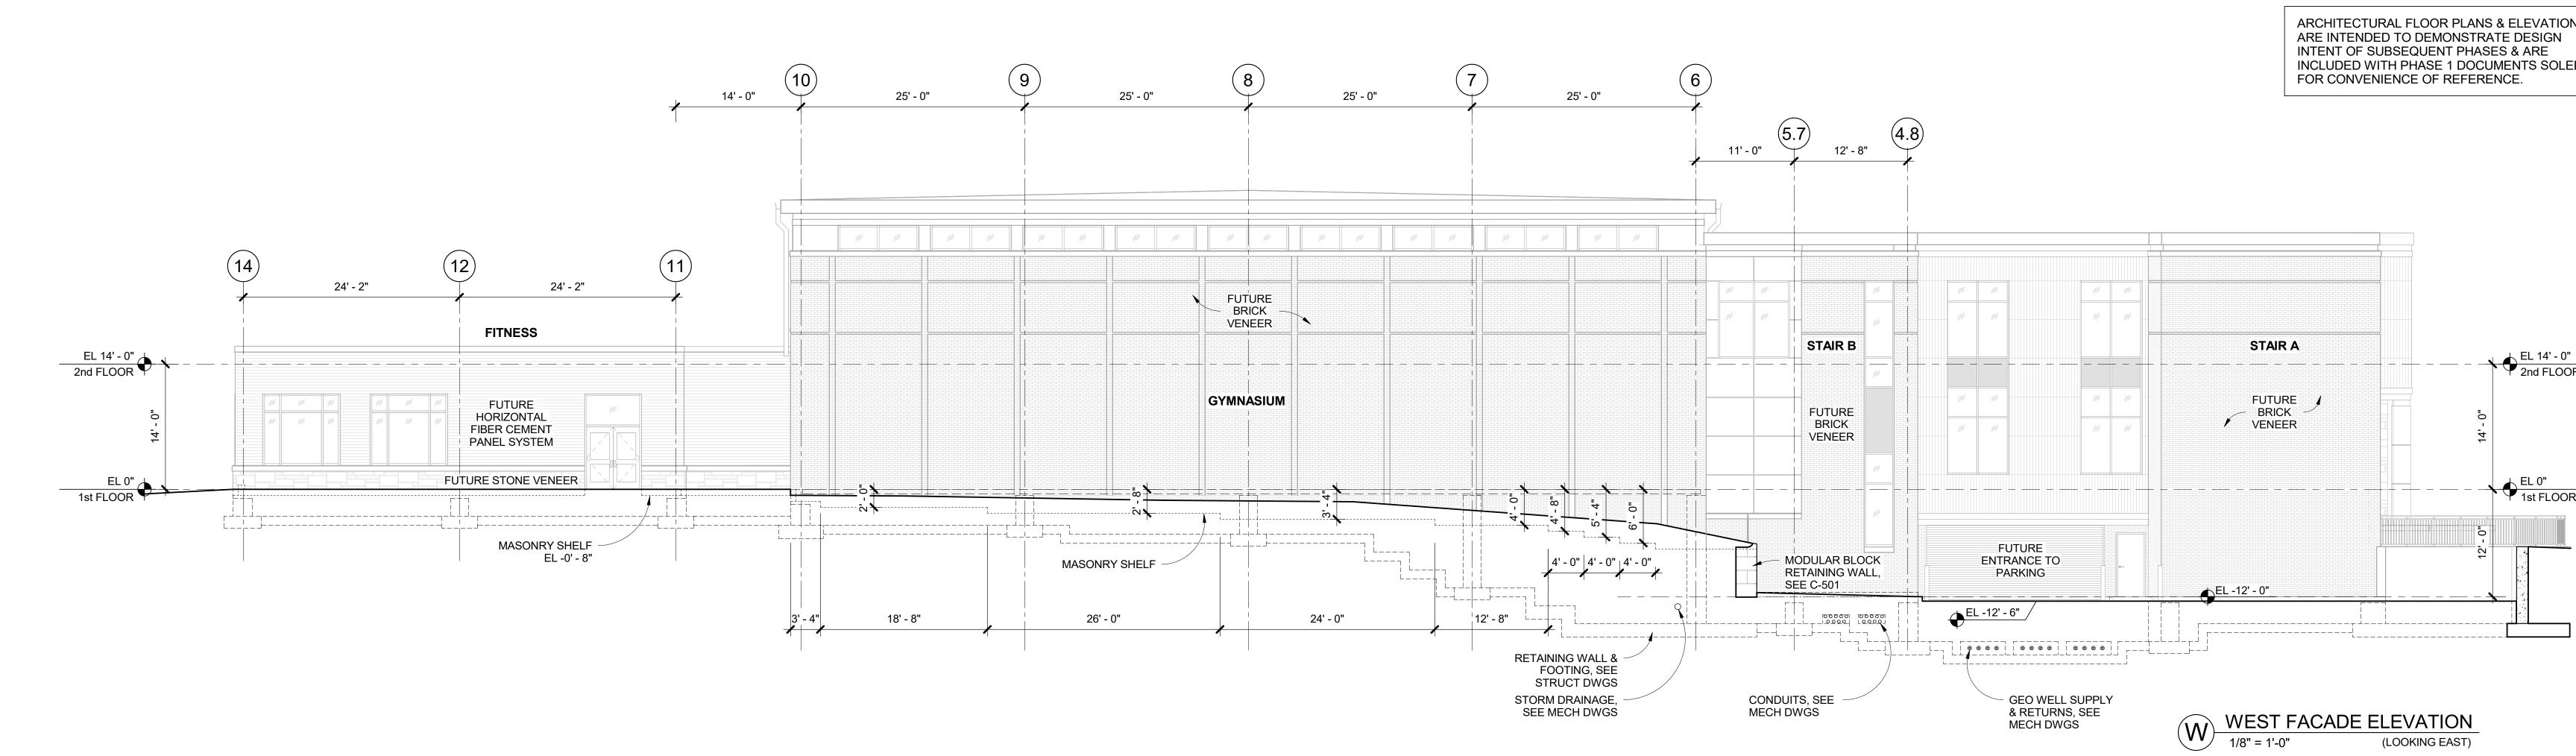
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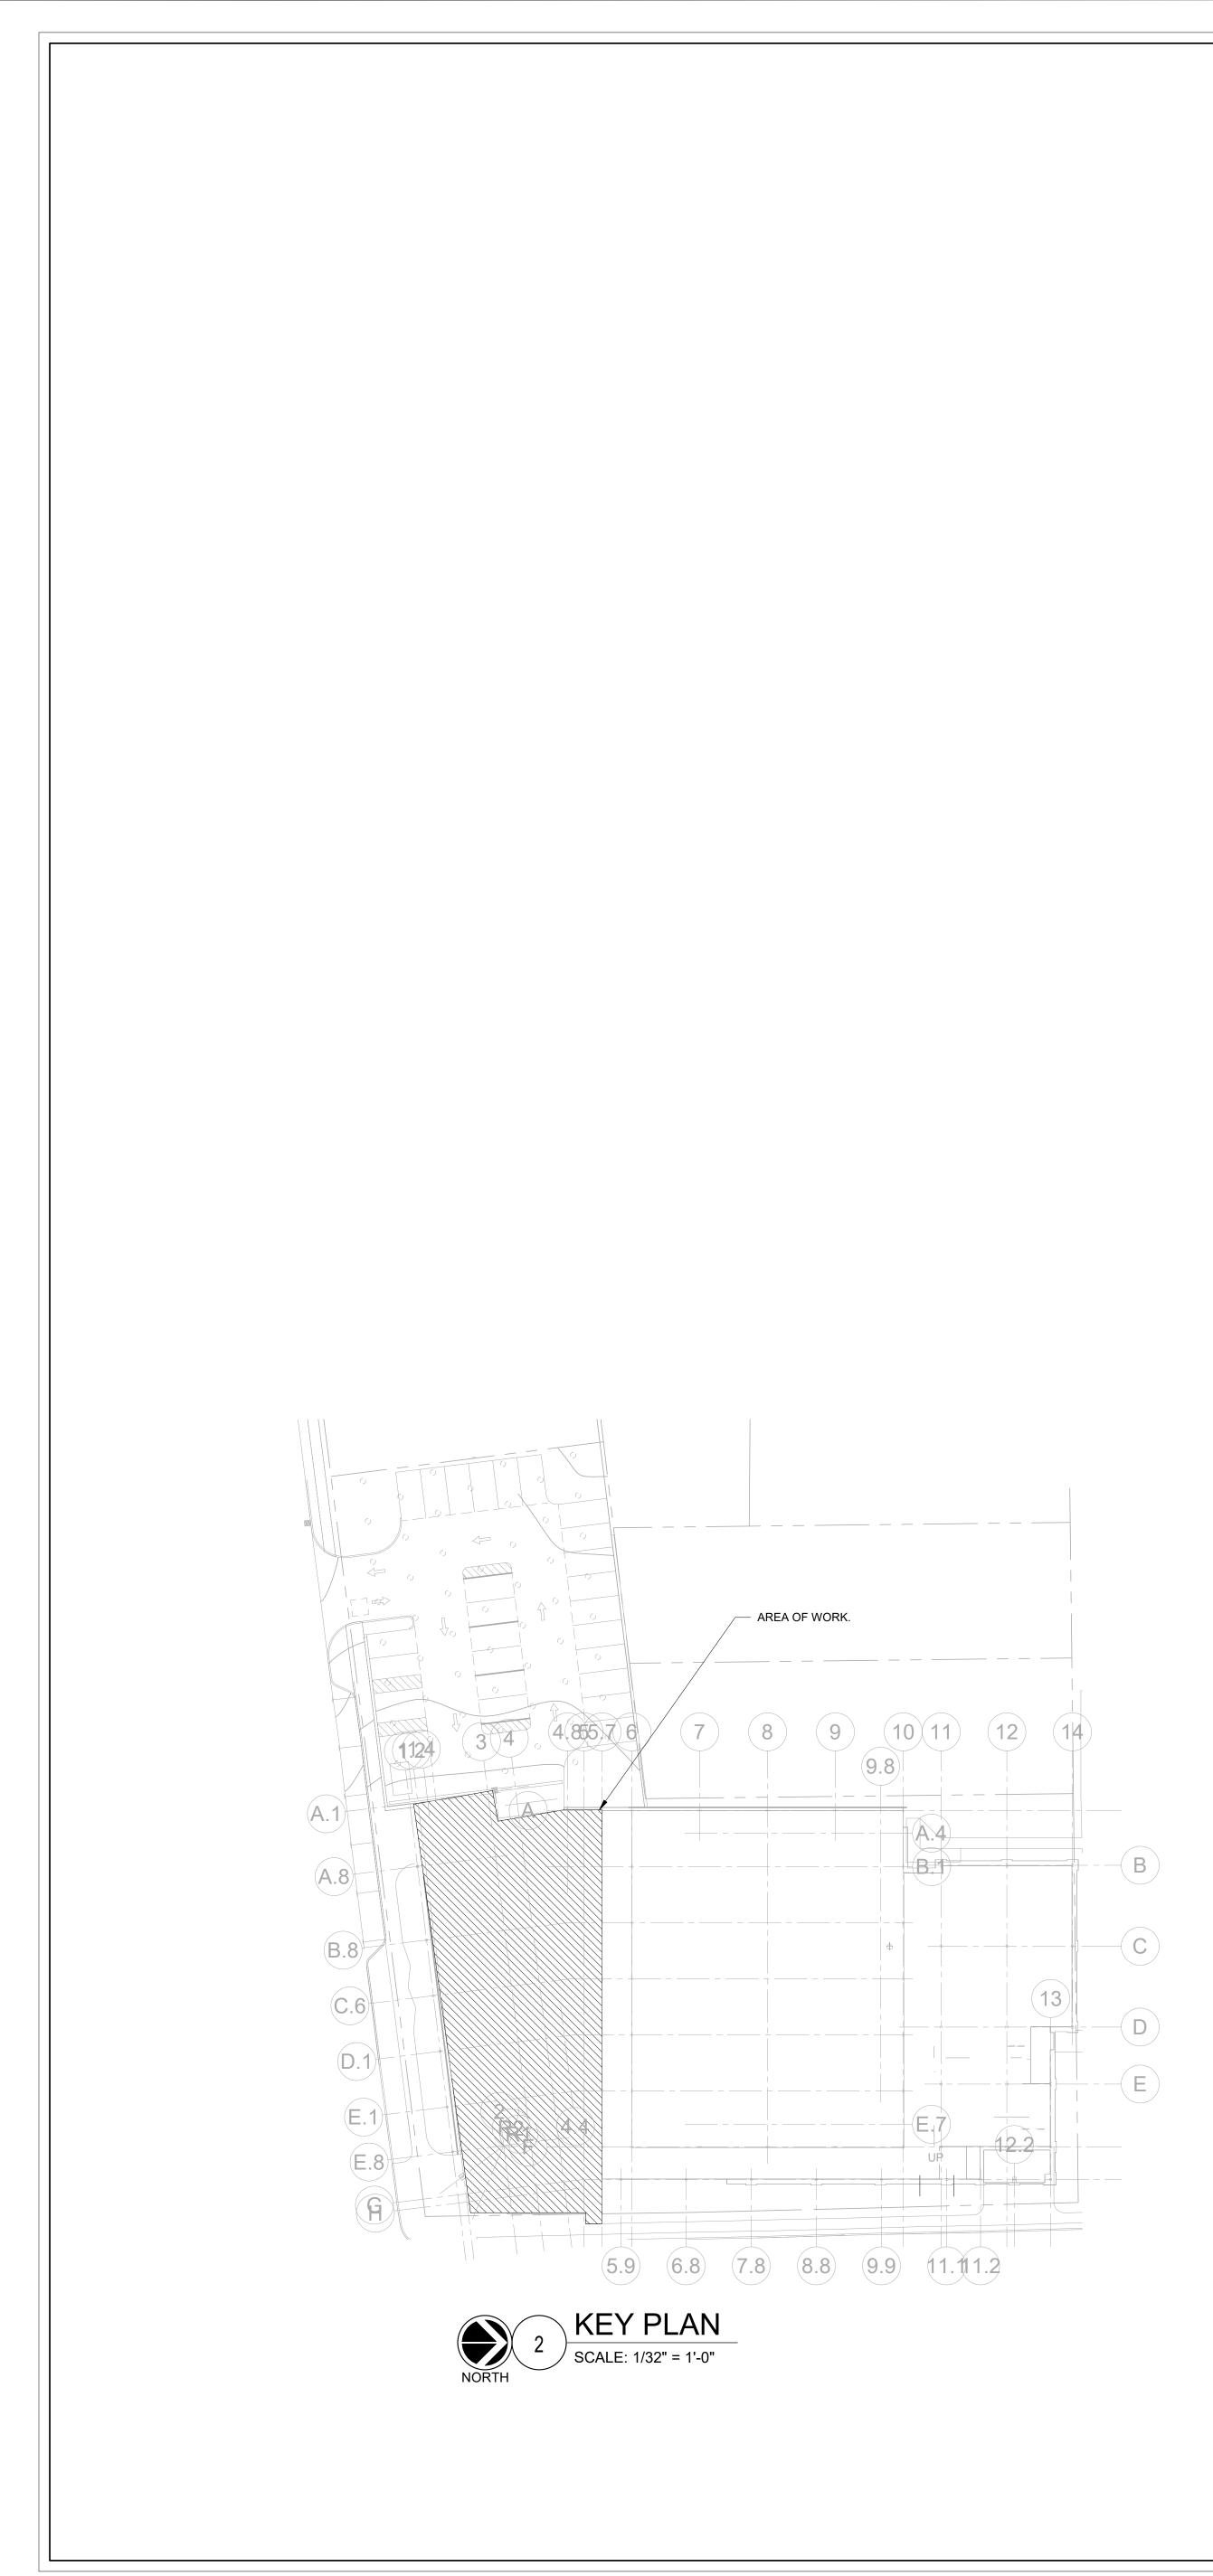



SYMBOL		
	ABBREVIATION	
	AFF	
	DEM.	NEW WORK EXISTING TO BE REMOVED
Ţ		BALL VALVE
• 		CONDUIT AND WIRING
		CONDUIT & WIRING TO BE REMOVED UON
— — UG— —	_	BURIED CONDUIT
		ELECTRICAL EQUIPMENT AS INDICATED
OH		OVERHEAD CONDUCTORS
	_	UNDERGROUND ELECTRICAL
—UG-T	_	UNDERGROUND TELCO
	CW	COLD WATER
С		ELBOW DOWN
0	_	ELBOW UP
及		GATE VALVE
Ā		GLOBE VALVE
_	NEW	NEW WORK
内	_	OS&Y GATE VALVE
₽	-	PLUG VALVE
	_	PIPE CAP
	S	SANITARY
_	SD	STORM DRAINAGE
\bigcirc	_	TEE DOWN
0	_	TEE UP
_	TYP.	TYPICAL
_	V	VENT
	W	WASTE LINE
NOTE: FOR REFERENCE O PROJECT.	NLY. NOT ALL SY	MBOLS OR ABBREVIATIONS ARE USED IN THIS
TRENCHING	NOTES	
1. CONTRACTOR SHAP	L LOCATE ALL EY	ISTING UNDERGROUND UTILITIES THAT ARE NOT PART OF N.Y. STATE "CO
753" PRIOR TO DIGG		
		HE EXISTING UNDERGROUND EQUIPMENT, PIPES AND CONDUITS SHALL
PERFORMED BY HAN		
		ING OR PAVEMENTS DISTURBED DURING THE EXCAVATION SHALL EXISTING CONDITIONS BY THE CONTRACTOR AT NO COST TO THE OWNE
4. ANY EXISTING BURI	ED CONDUITS, D	RAINAGE, SPRINKLER PIPING, ETC. THAT IS DISTURBED AND/OR DAMAG
DURING CONSTRUC	TION SHALL BE R	EPAIRED BY THE CONTRACTOR AT NO COST TO THE OWNER.
		BSURFACE STRUCTURES, ABOVE GROUND STRUCTURES AND/OR UTILIT
Believed to exist Indicated. In Part Of Such Pipelines	IN THE WORKIN TICULAR, THE CO S, SUBSURFACE S IS RESPONSIBILI	BSURFACE STRUCTURES, ABOVE GROUND STRUCTURES AND/OR UTILIT NG AREA, EXACT LOCATION OF WHICH MAY VARY FROM THE LOCATION NTRACTOR IS WARNED THAT THE EXACT OR EVEN APPROXIMATE LOCAT STRUCTURES AND/OR UTILITIES IN THE AREA MAY OR MAY NOT BE SHOW TY TO PROCEED WITH GREAT CARE IN EXECUTING ANY WORK. 48 HOL
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GENERAL NOTES 1. THE CONTRACT DRAWINGS INDICATE THE EXTENT AND GENERAL ARRANGEMENTS OF THE ELECTRICAL, FIRE PROTECTION, MECHANICAL AND PLUMBING SYSTEMS. IF ANY DEPARTURES FROM THE DRAWINGS ARE DEEMED NECESSARY BY THE CONTRACTOR, DETAILS OF SUCH DEPARTURES AND THE REASONS THEREFORE SHALL BE SUBMITTED TO THE OWNER AND ENGINEER FOR APPROVAL. NO SUCH DEPARTURES SHALL BE MADE WITHOUT PRIOR WRITTEN APPROVAL OF THE OWNER AND ENGINEER. EQUIPMENT AND PIPING ARRANGEMENTS SHALL PROVIDE ADEQUATE AND ACCEPTABLE CLEARANCES FOR ENTRY, SERVICING, AND MAINTENANCE. ANY CHANGES TO PIPING AND EQUIPMENT LOCATIONS NECESSARY TO AVOID INTERFERENCE WITH OTHER TRADES SHALL BE MADE AT NO EXTRA COST. 2. THE WORK SHALL BE PERFORMED IN STRICT ACCORDANCE WITH THE LATEST EDITION OF THE PREVAILING NEW YORK STATE PLUMBING, MECHANICAL, ELECTRICAL, AND BUILDING CODES. IN CASE OF CONFLICT BTWEEN THE CONTRACT DOCUMENTS AND A GOVERNING CODE OR ORDINANCE, THE MORE STRINGENT STANDARD SHALL APPLY. 3. THE CONTRACTOR SHALL BE RESPONSIBLE FOR OBTAINING ALL NECESSARY PERMITS AND FOR PAYING

- 4. CONNECTIONS TO EXISTING UTILITIES AND SERVICES ARE SHOWN ACCORDING TO THE BEST INFORMATION AVAILABLE. THE CONTRACTOR SHALL VERIFY THE FXACT LOCATIONS INVERT FLEVATIONS AND SIZES OF
- AVAILABLE. THE CONTRACTOR SHALL VERIFY THE EXACT LOCATIONS, INVERT ELEVATIONS, AND SIZES OF EXISTING PLUMBING AND ELECTRICAL SERVICES IN FIELD, AND SHALL CONNECT NEW PLUMBING AND ELECTRICAL SERVICES AS INDICATED ON DRAWINGS.
- 5. PRIOR TO FABRICATION, THIS CONTRACTOR SHALL VERIFY ALL MEASUREMENTS AND CONDITIONS ON JOB SITE, AND COORDINATE THIS WORK WITH THE WORK OF ALL OTHER TRADES
- 6. PROVIDE ALL PLUMBING PIPING, VALVES AND ACCESSORY ITEMS AS SPECIFIED AND AS REQUIRED FOR A COMPLETE INSTALLATION.
- 7. PITCH ALL WASTE, SANITARY, AND STORM DRAIN PIPING AT MAXIMUM SLOPE POSSIBLE, BUT NOT LESS THAN 1/8" PER FOOT FOR PIPING ≥ 3" AND 1/4" PER FOOT FOR PIPING ≤ 2½".
 8. DROVIDE DIELECTED FOR PIPING > 1.20 1.
- 8. PROVIDE DIELECTRIC FITTINGS OR COUPLINGS WHEREVER DISSIMILAR METALS ARE JOINED.
- ALL WORK SHALL BE PROPERLY TESTED, BALANCED, AND CLEANED AND DISINFECTED. PROVIDE A ONE YEAR WARRANTY FROM DATE OF FINAL INSPECTION ON ALL PARTS AND LABOR.
 10. DROVIDE AND STREET FOR
- 10. PROVIDE ALL PIPE OPENINGS THROUGH PARTITIONS WITH PIPE SLEEVES. FOR PIPES PENETRATING FIRE RATED PARTITIONS, THE SPACE BETWEEN THE PIPE AND THE SLEEVE SHALL BE SEALED WITH FIRE STOPPING MATERIAL. PENETRATIONS FOR PIPING SHALL BE MADE BY CORE DRILLING WHENEVER POSSIBLE.
- 11. PROVIDE TRAP SEAL PRIMERS FOR FLOOR DRAINS AS REQUIRED. INSTALL THE PRIMER VALVE IN THE COLD WATER SERVICE, WITH THE TRAP CONNECTION PIPED TO THE FLOOR DRAIN TRAP. LOCATE THE VALVE IN AN ACCESSIBLE LOCATION.
- 12. THE CONTRACTOR SHALL PROVIDE ALL CUTTING, PATCHING, CORE DRILLING AND FINAL RESTORATION REQUIRED TO FACILITATE THE INSTALLATION OF SCOPE OF WORK RELATED TO THIS PROJECT.
 13. SEE THE ADOLUTEOTICE
- 13. SEE THE ARCHITECTURAL DRAWINGS FOR EXACT PHASING AND TIME SCHEDULE FOR CONSTRUCTION.
- 14. THE CONTRACTOR SHALL BE RESPONSIBLE FOR PROVIDING TEMPORARY VENTILATION AND EXHAUST AIR WHEN WELDING OR SOLDERING OPERATIONS ARE PERFORMED, AS REQUIRED BY OSHA.
 15. THE CONTRACTOR SHALL FIELD VERIES ALL EXISTING CONTRACTOR SHALL FIELD FIELD
- 15. THE CONTRACTOR SHALL FIELD VERIFY ALL EXISTING CONDITIONS PRIOR TO THE BEGINNING OF WORK, AND SHALL COORDINATE ALL WORK WITH OTHER TRADES.
 16. THE CONTRACTOR SHALL SUBMIT FOR REVIEW A COMPOSITE SHOP DRAWING, FULLY COORDINATED WITH ALL
- OTHER TRADES, INDICATING PLUMBING, SPRINKLER PIPING, STRUCTURAL, CONDUITS, ETC.
- 17. COORDINATE PIPING PENETRATIONS THRU FLOORS/SLABS, WALLS, AND ROOF WITH ARCHITECTURAL AND STRUCTURAL DRAWINGS.
 18. CONTRACTOR SHALL SHAL
- 18. CONTRACTOR SHALL CONDUCT HYDRANT FLOW TEST TO ESTABLISH EXACT FLOW AND PRESSURE AVAILABLE ON THE SITE FOR PREPARATION OF HYDRAULIC CALCULATIONS. HYDRANT FLOW TEST SHALL BE CONDUCTED ON TWO HYDRANTS ON THE SITE WATER MAIN SERVING THE BUILDING FLOWING A MINIMUM OF 500 GPM.
- 19. PROVIDE TWO 2-1/2 GALLON PRESSURIZED WATER AND ONE 10 LB ABC DRY CHEMICAL EXTINGUISHERS FOR EMERGENCY USE DURING CONSTRUCTION.





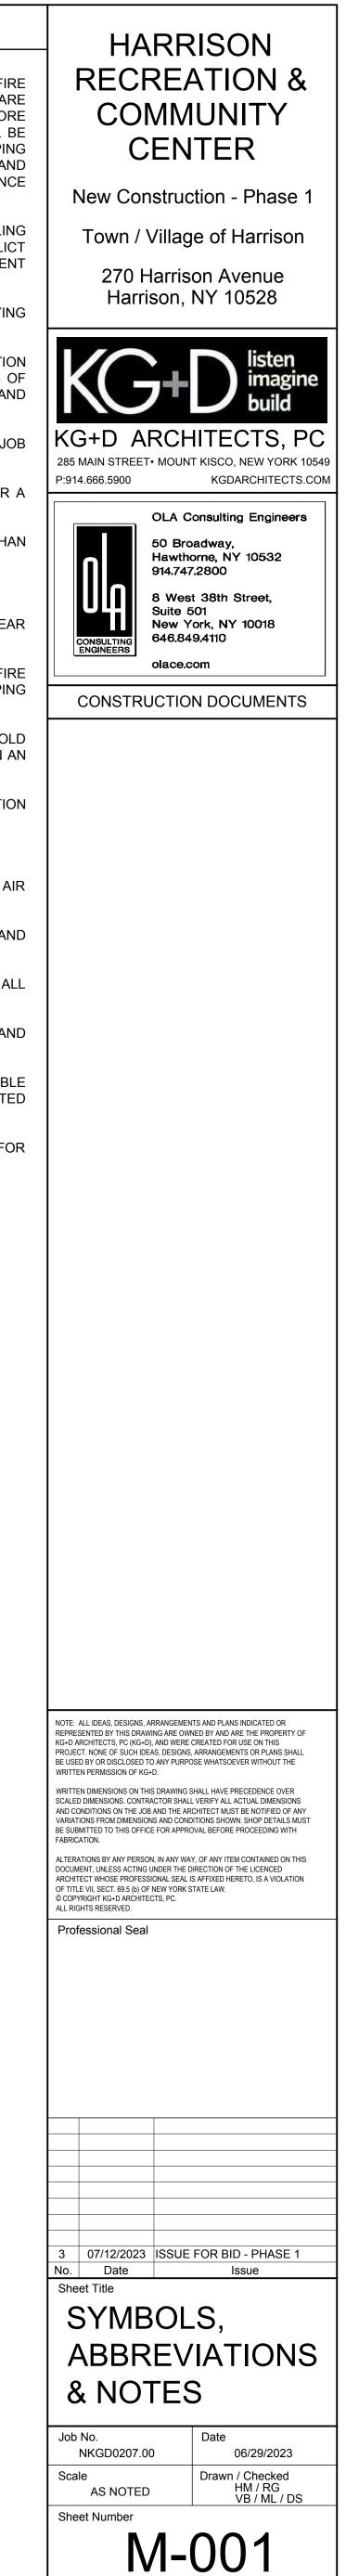

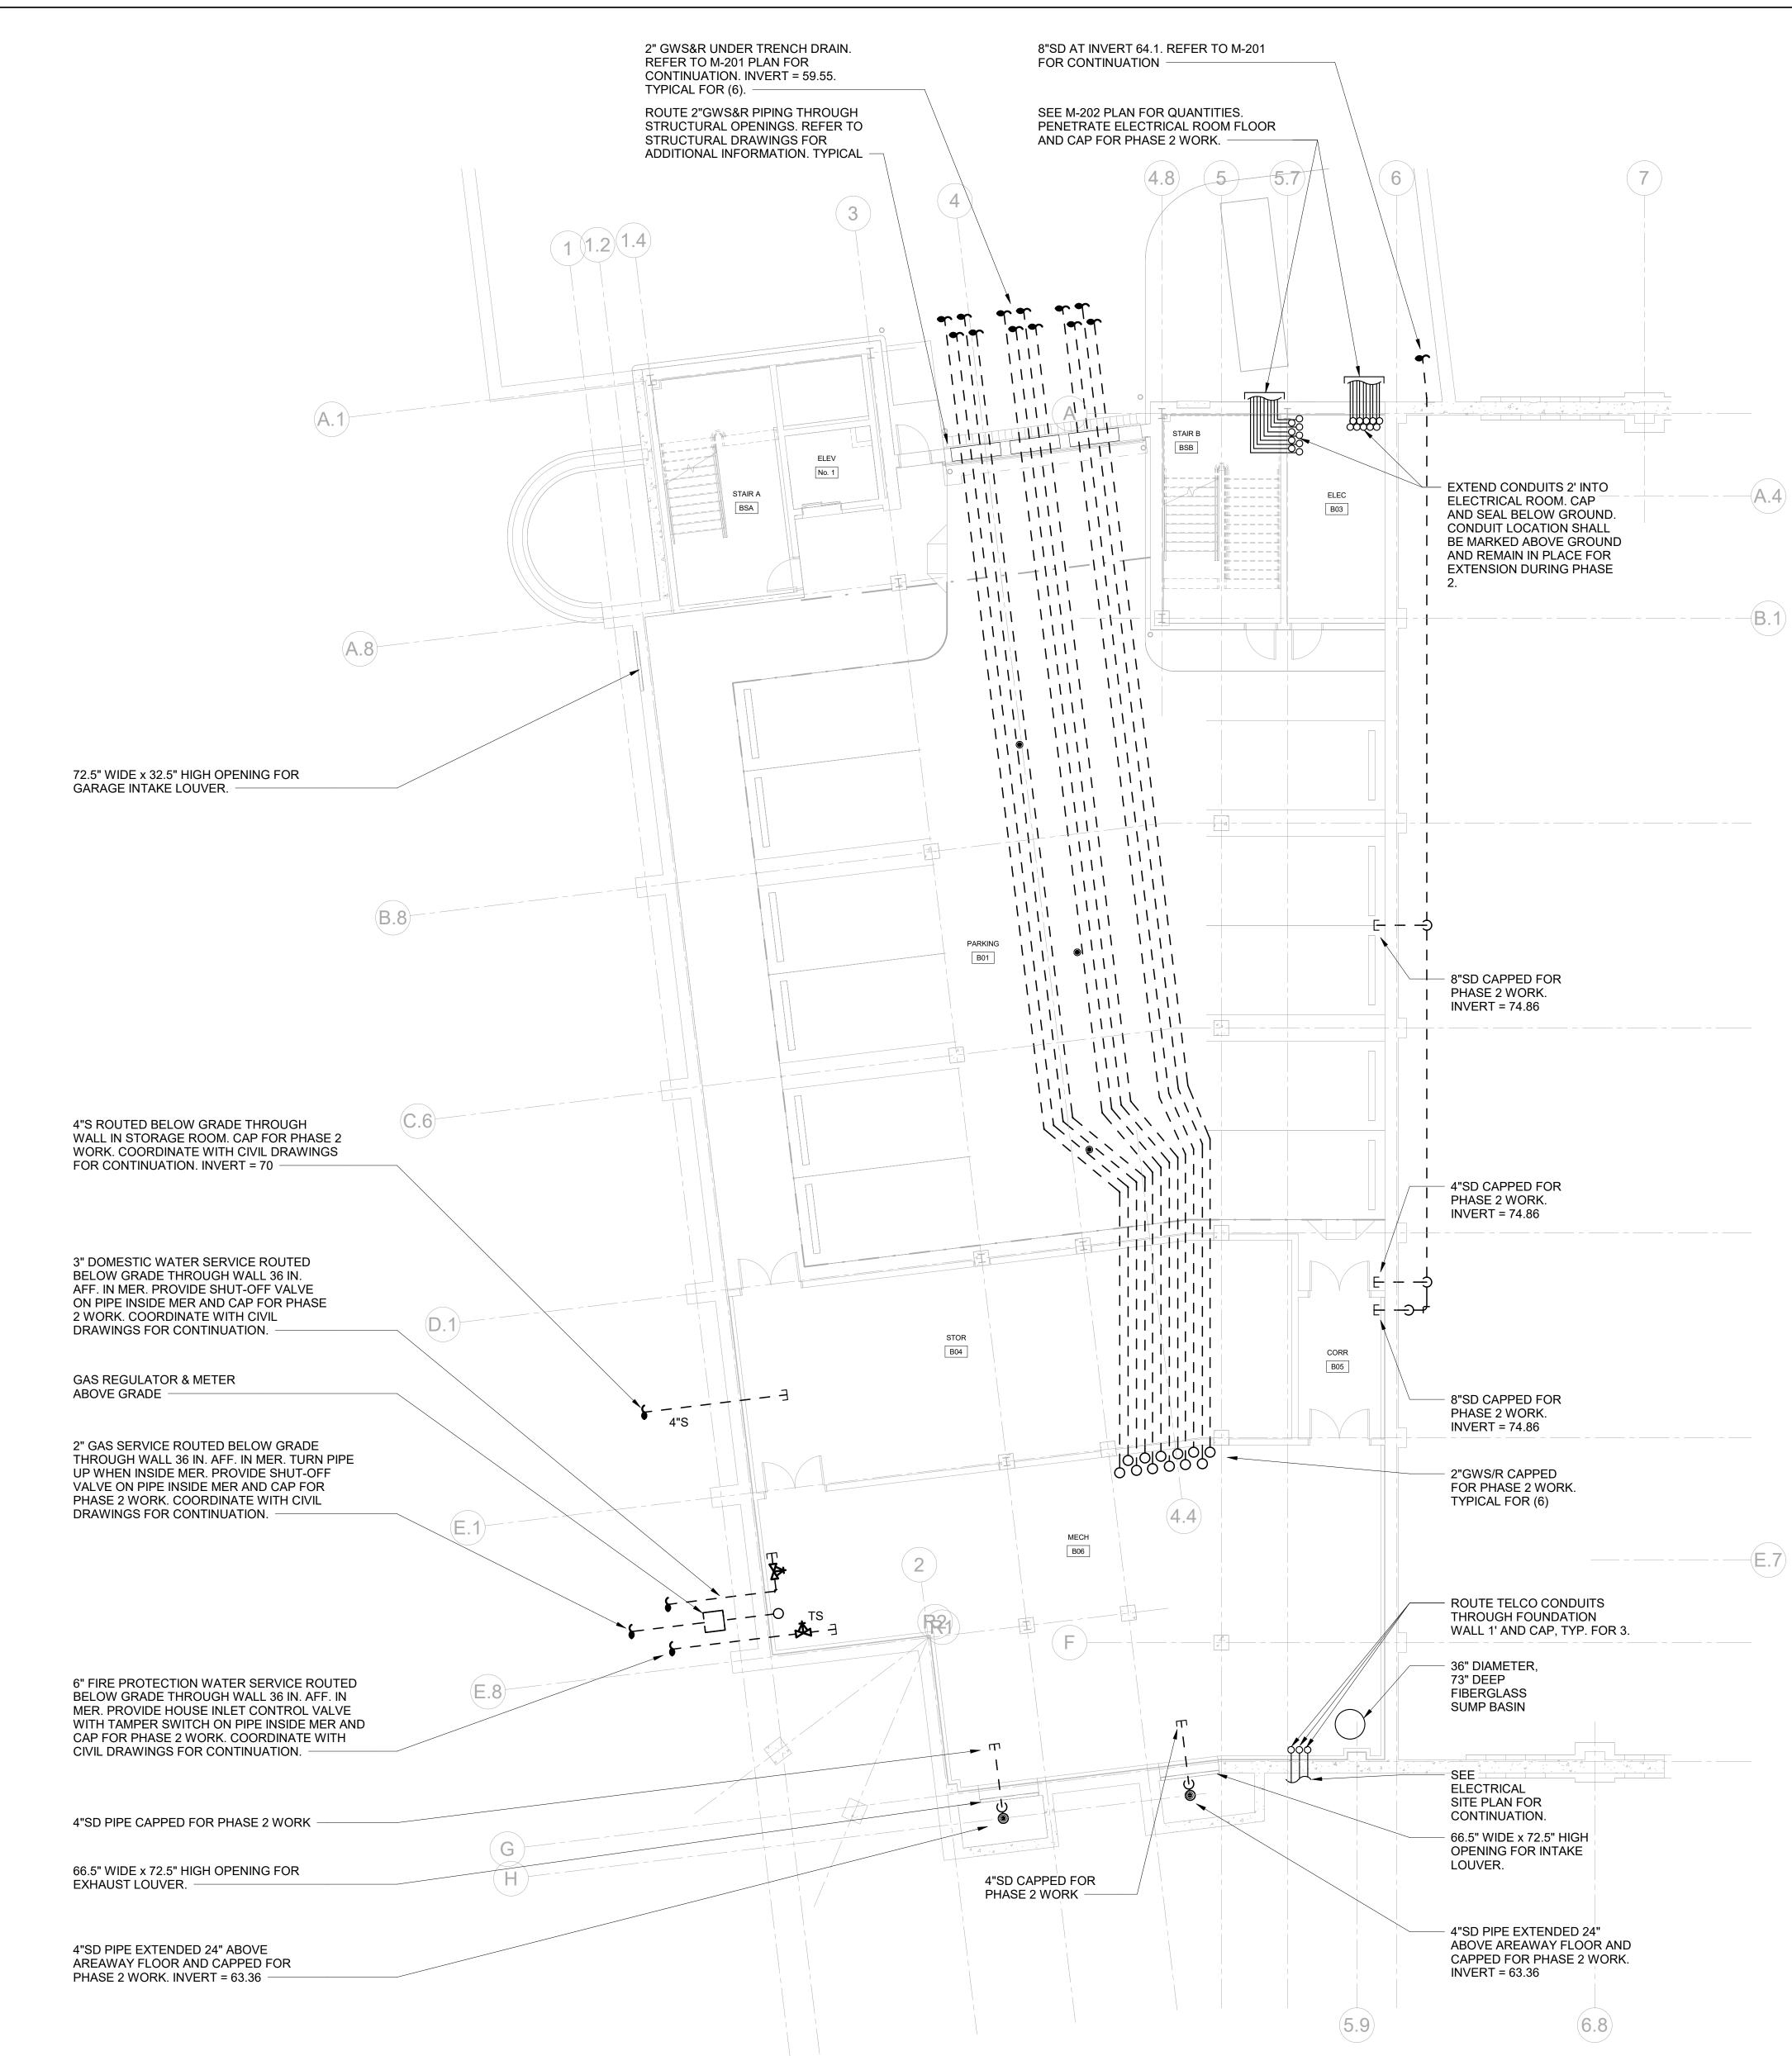

PARKING FLOOR PLAN PHASE 1

SCALE: 1/8" = 1'-0"

ALL ELECTRICAL CONDUITS ARE ROUTED UNDERGROUND, UON.
 ALL ELECTRICAL CONDUITS SHALL BE PROVIDED WITH DRAGLINES.

