BULLETIN #01

DATE: December 17, 2024

TO: Piazza Inc.

Attn: Phil Pignatelli

TVH Building Dept. Attn: Rocco Germani

CC: Jordan Medina, Hill Intl.,

FROM: Brian Dunn, AIA

KG+D Architects, PC

PROJECT: Harrison Recreation & Community Center – PHASE 2

Harrison, NY

RE: Phase 2 Permit Review Revisions

Message:

Please see the attached revised drawings and documents in support of the Phase 2 Permit Application. The revised drawings reflect the responses to the permit review comments and to the SOG elevations at the Parking Level. Please see the COMcheck compliance certificates and the OLA letter addressing compliance with the Mechanical Code.

Cc: TVH Engineering Department

File

Encl: COMcheck Certificates

Sheets: S100, A201, A301, A302, A303, A304, A701, A702, A703, A801, A804,

FFE 01, P001, M601, M602, ASK 01

OLA Permit Comments












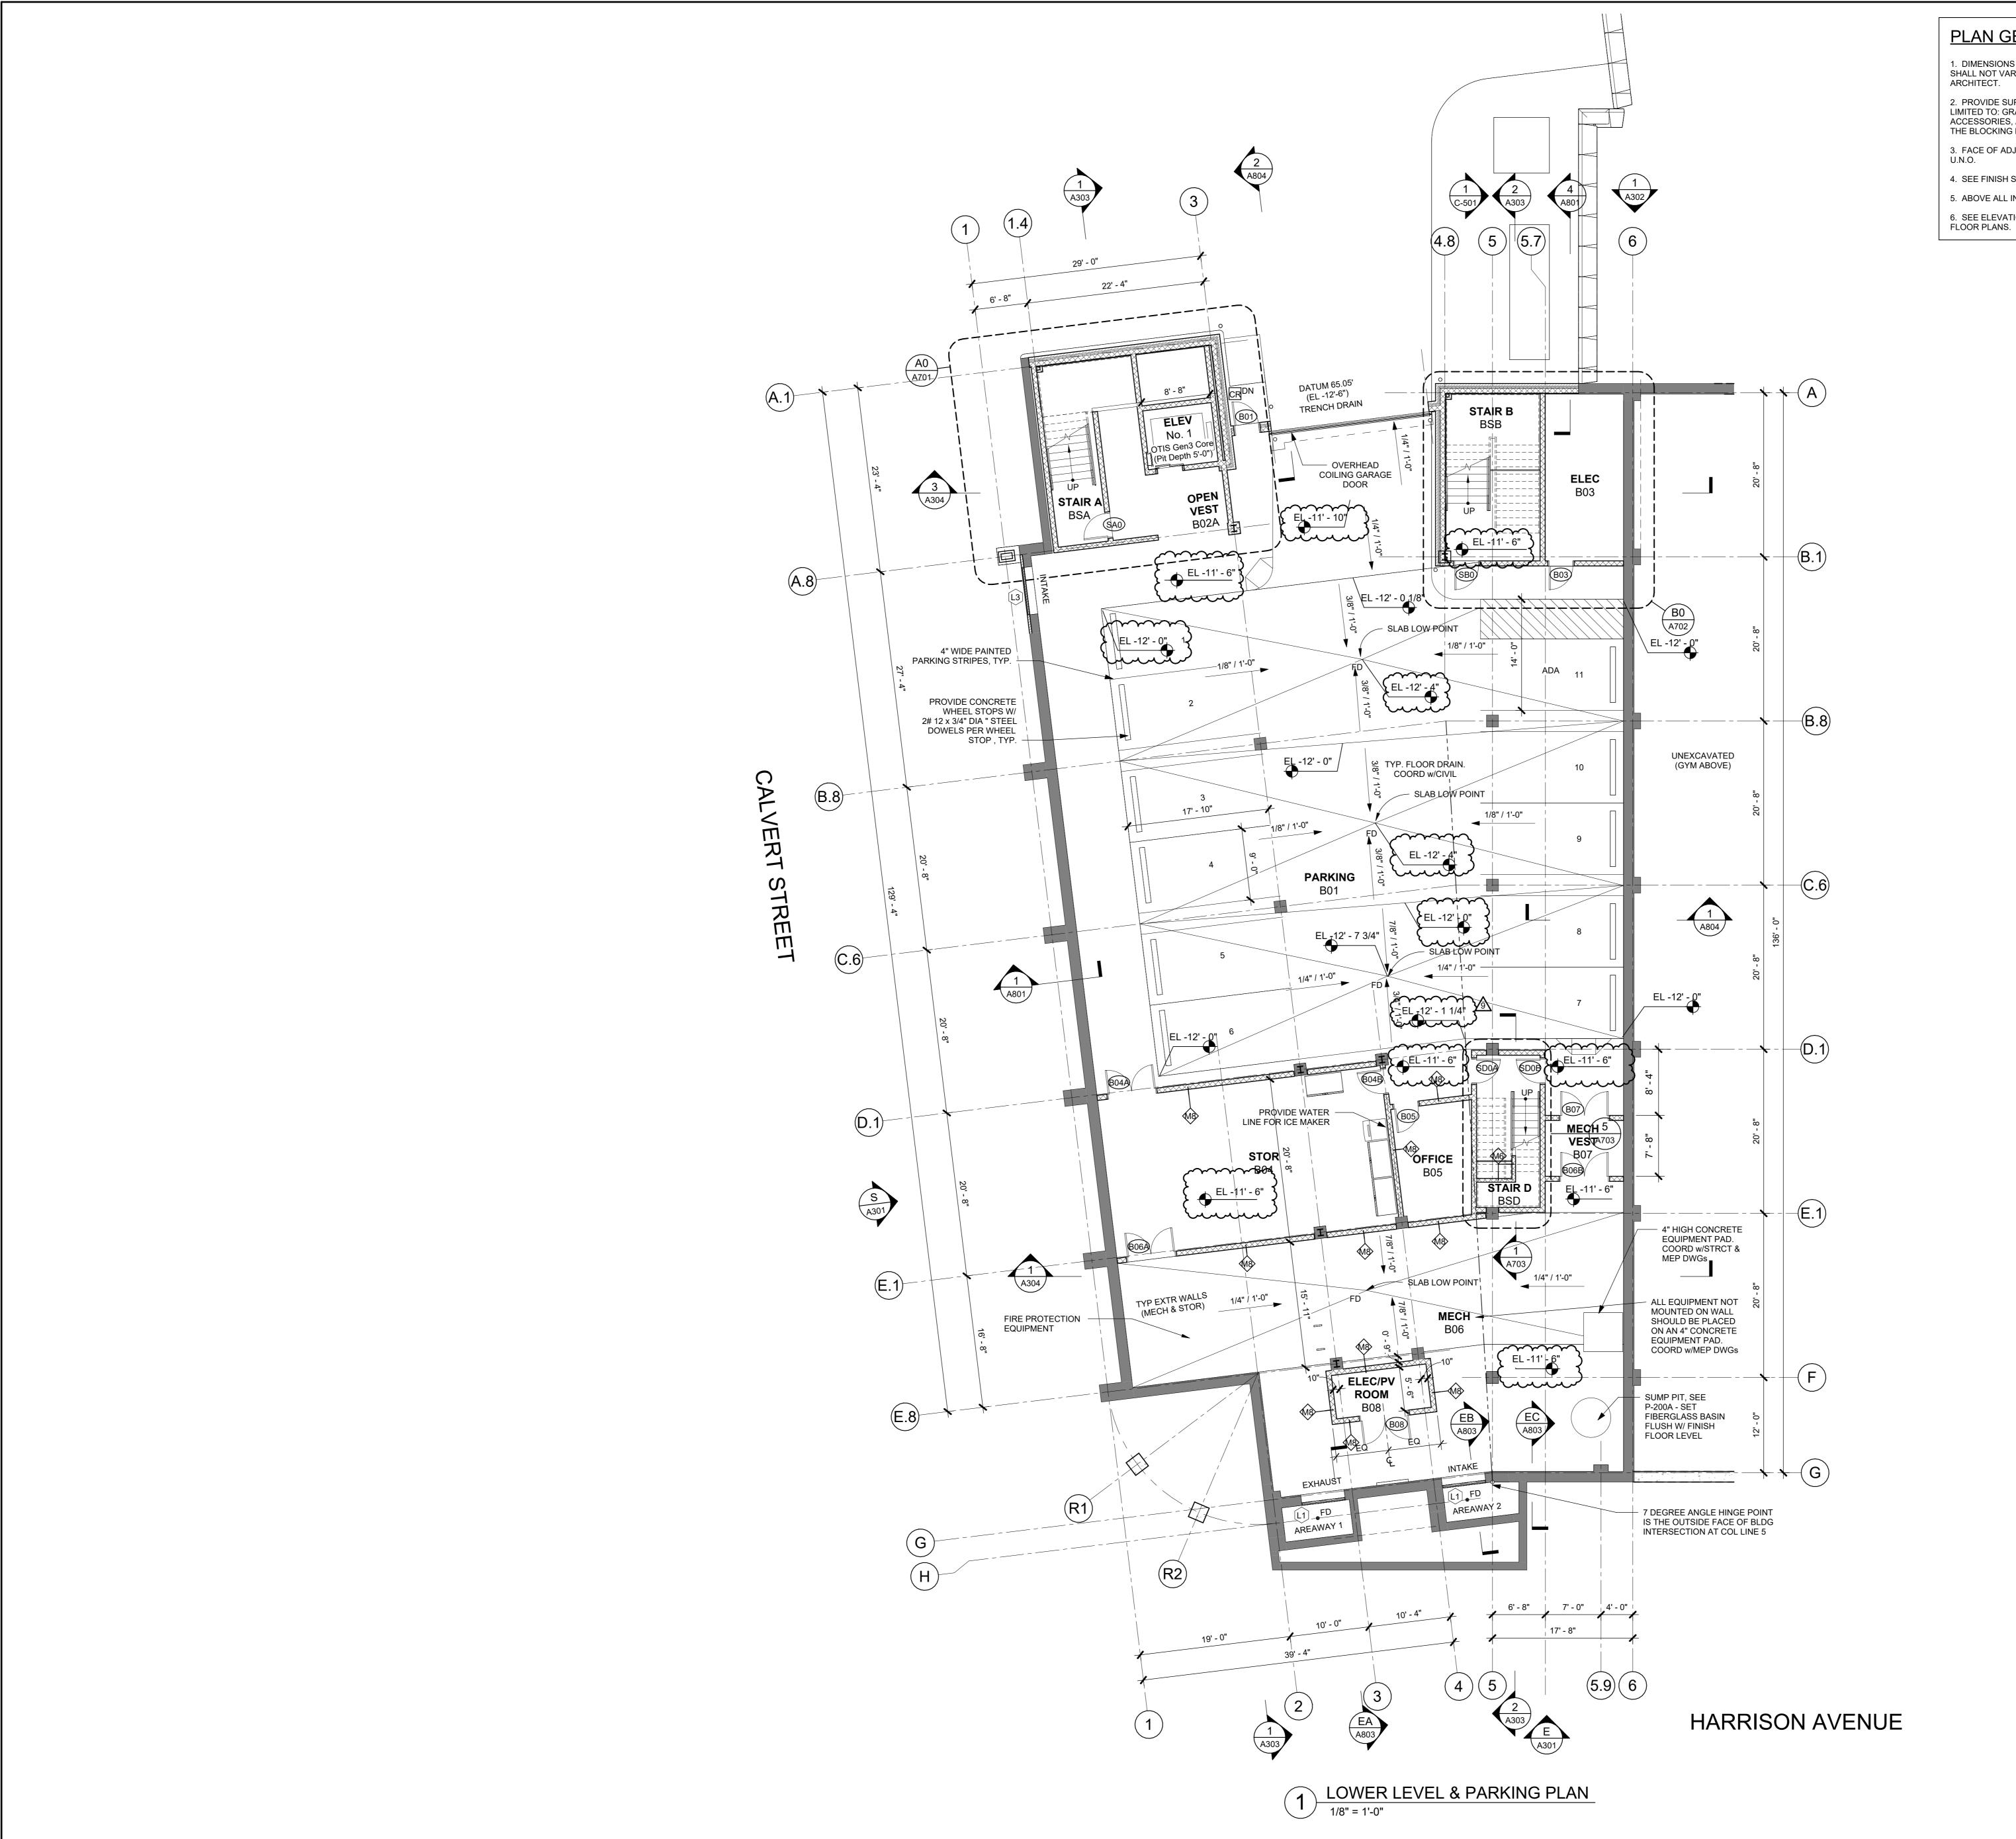

PLAN GENERAL NOTES

1. DIMENSIONS SHOWN ARE TO FACE OF GYPSUM OR FACE OF CMU. DIMENSIONS SHALL NOT VARY MORE THAN +/- 1/8" WITHOUT WRITTEN CONSENT FROM THE

2. PROVIDE SUPPLEMENTAL BLOCKING AT LOCATIONS INCLUDING, BUT NOT LIMITED TO: GRAB BARS, SHELVING, CABINETS, SIGNAGE, TOILET ROOM ACCESSORIES, AV EQUIPMENT, DISPLAY BOARDS, ETC. THE CONFIGURATION OF THE BLOCKING MUST MATCH THE SPECIFIC ITEM PROVIDED.

3. FACE OF ADJACENT WALL TO INSIDE EDGE OF DOOR FRAME IS 6" (TYPICAL)

4. SEE FINISH SCHEDULE FOR MATERIALS & FINISHES.

5. ABOVE ALL INTERIOR OPENINGS, PROVIDE ADJACENT PARTITION TYPE U.N.O.

6. SEE ELEVATIONS FOR ADDITIONAL WINDOWS THAT MAY NOT BE SHOWN IN

FLOOR PLAN LEGEND

NEW PARTITION AS INDICATED NEW GLAZED OPENING WITH ALUM OR HM FRAME AS INDICATED FEC - FIRE EXTINGUISHER CABINET

101 NEW DOOR, DOOR NUMBER WALL TYPE

FRAME TYPE

CONSTRUCTION DOCUMENTS

HARRISON

RECREATION &

COMMUNITY

CENTER

New Construction - Phase 2

Town / Village of Harrison

270 Harrison Avenue

Harrison, NY 10528

285 MAIN STREET • MOUNT KISCO, NEW YORK 10549

KGDARCHITECTS.COM

P:914.666.5900

IOTE: ALL IDEAS, DESIGNS, ARRANGEMENTS AND PLANS INDICATED OR EPRESENTED BY THIS DRAWING ARE OWNED BY AND ARE THE PROPERTY OF G+D ARCHITECTS, PC (KG+D), AND WERE CREATED FOR USE ON THIS PROJECT. NONE OF SUCH IDEAS, DESIGNS, ARRANGEMENTS OR PLANS SHAL BE USED BY OR DISCLOSED TO ANY PURPOSE WHATSOEVER WITHOUT THE ITTEN PERMISSION OF KG+D.

CALED DIMENSIONS. CONTRACTOR SHALL VERIFY ALL ACTUAL DIMENSIONS IND CONDITIONS ON THE JOB AND THE ARCHITECT MUST BE NOTIFIED OF AN E SUBMITTED TO THIS OFFICE FOR APPROVAL BEFORE PROCEEDING WITH

TERATIONS BY ANY PERSON, IN ANY WAY, OF ANY ITEM CONTAINED ON TH OCUMENT, UNLESS ACTING UNDER THE DIRECTION OF THE LICENSED ARCHITECT WHOSE PROFESSIONAL SEAL IS AFFIXED HERETO, IS A VIOLATION OF TITLE VII, SECT. 69.5 (b) OF NEW YORK STATE LAW.

Professional Seal

12/17/2024 BULLETIN #1 10/09/2024 | CONFORMED SET

06/05/2024 ISSUED FOR BID 01/16/2024 ISSUED FOR PERMIT 06/01/2020 DESIGN DEVELOPMENT 03/31/2020 50% DESIGN DEVELOPMENT Sheet Title


LOWER LEVEL PARKING PLAN


2020-1005

03/31/2020 AS NOTED

A201

PROJECT TRUE NORTH

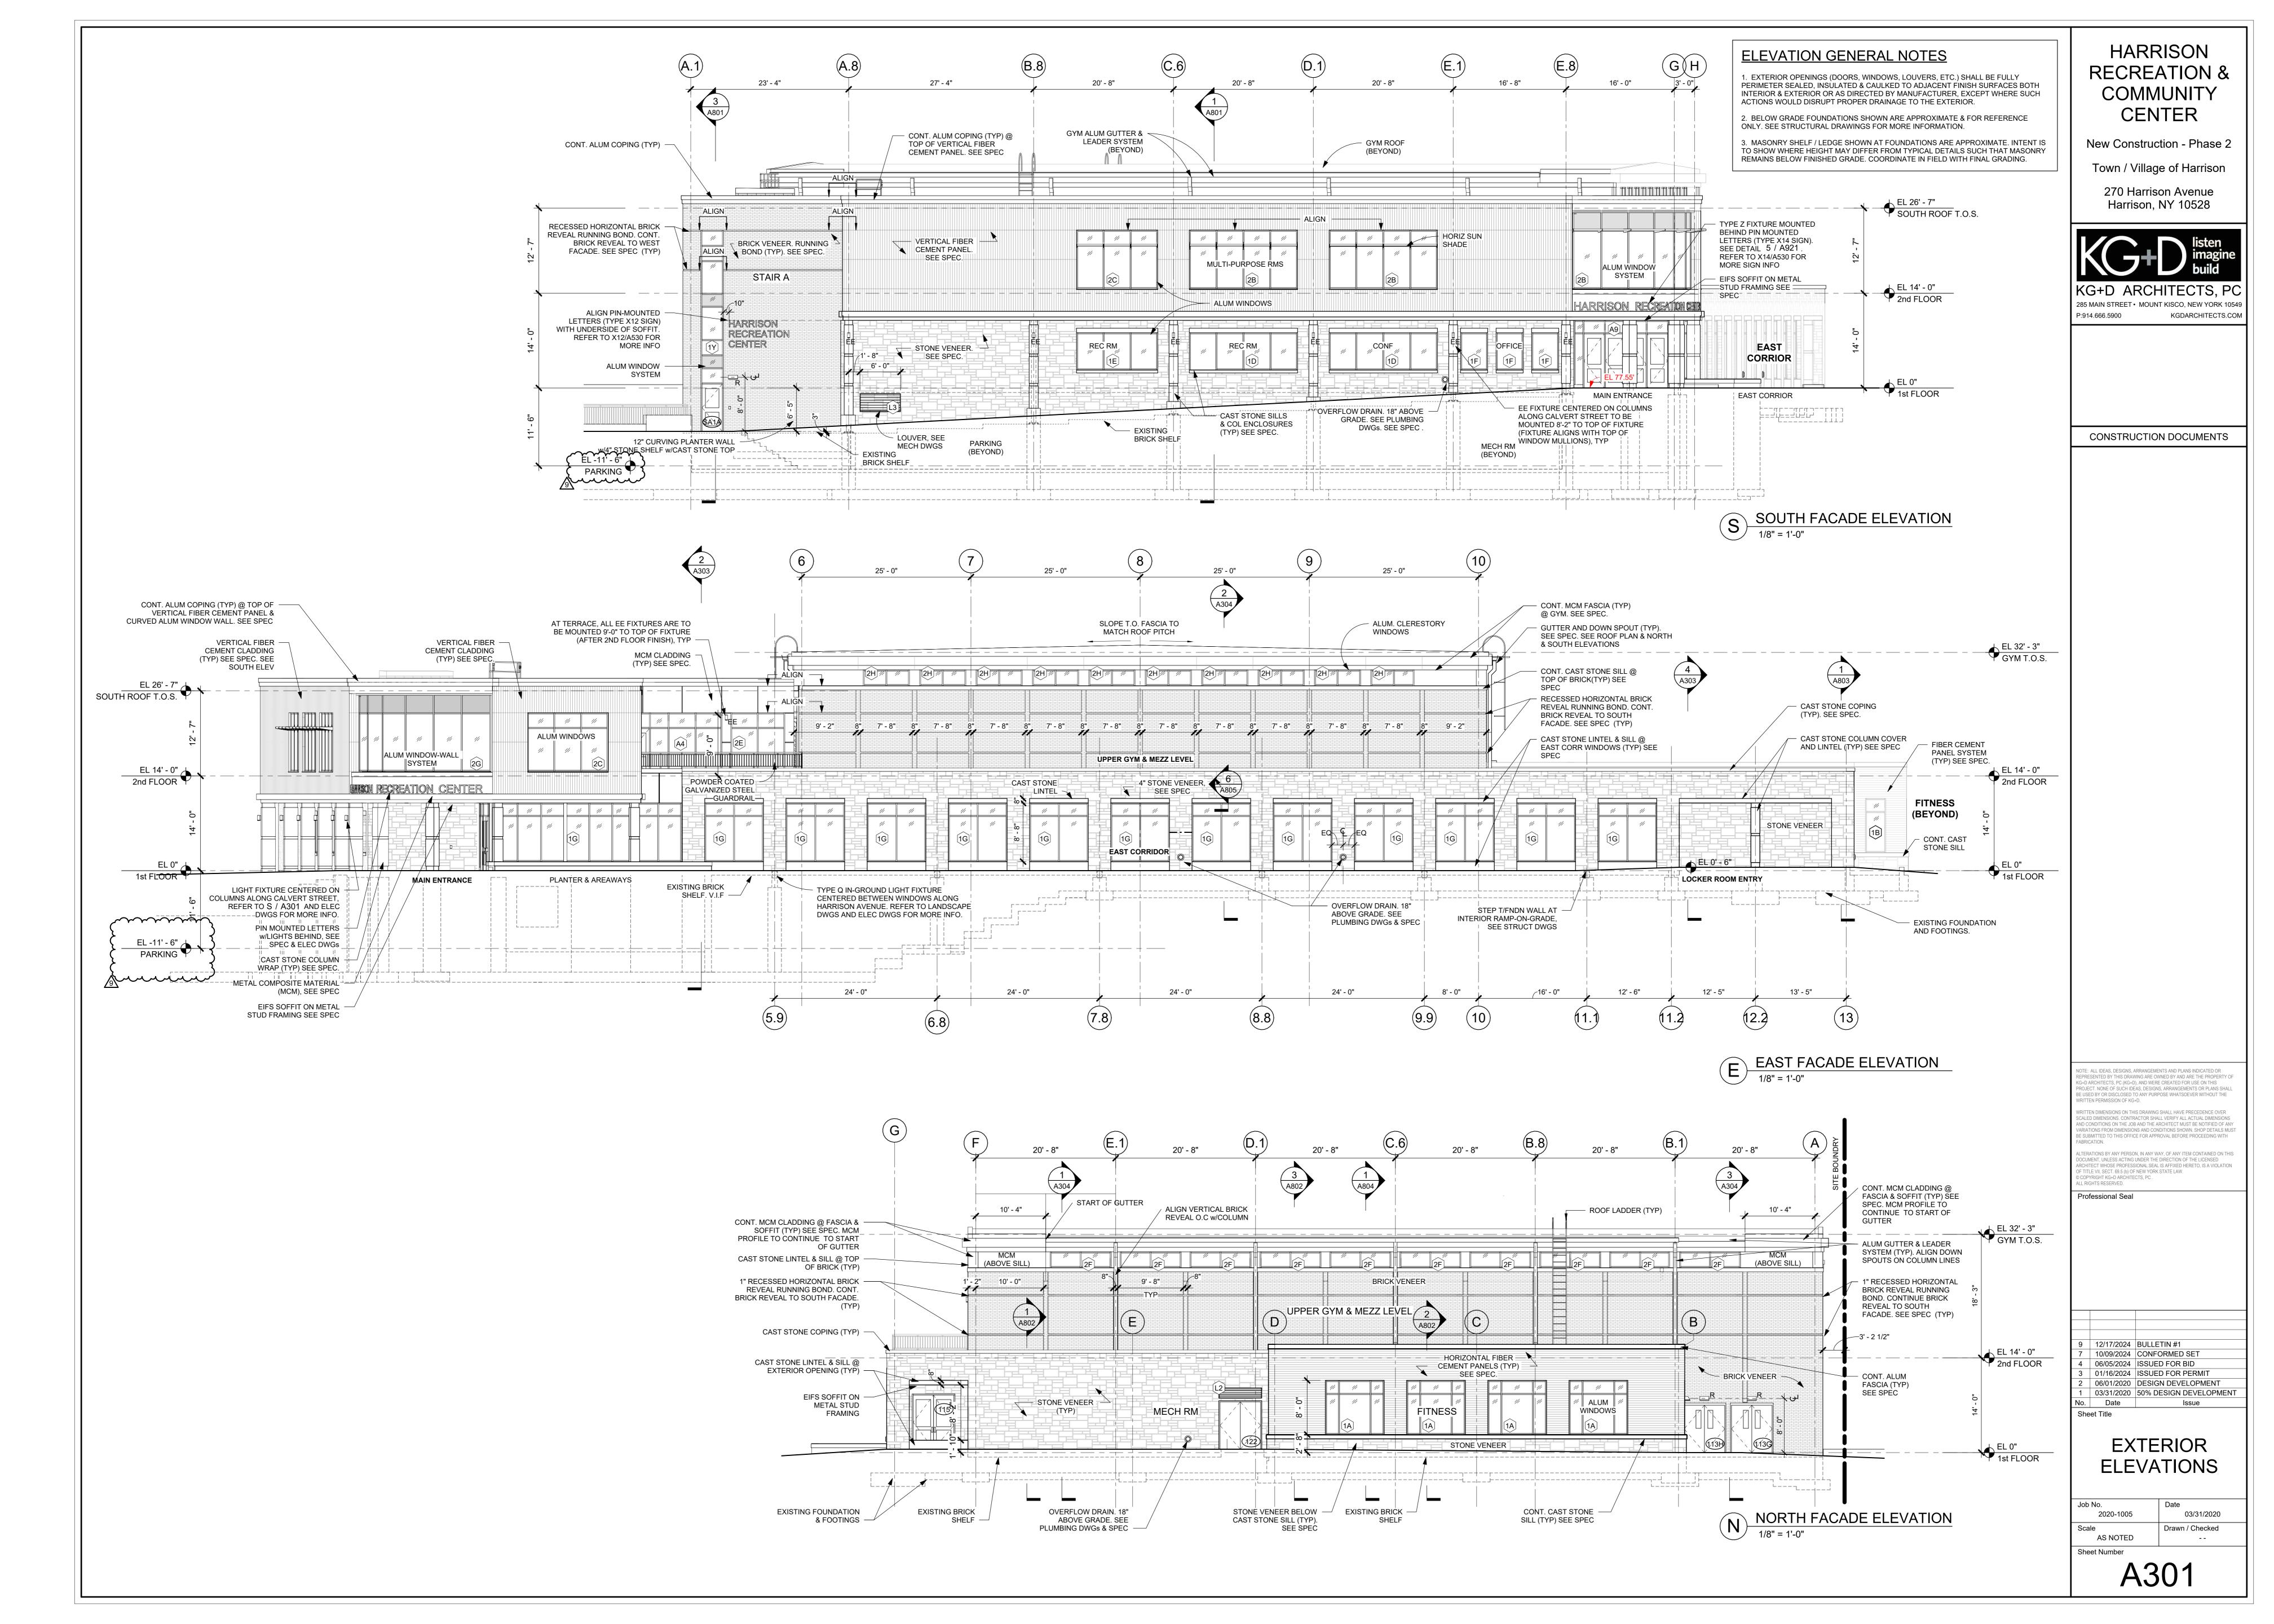

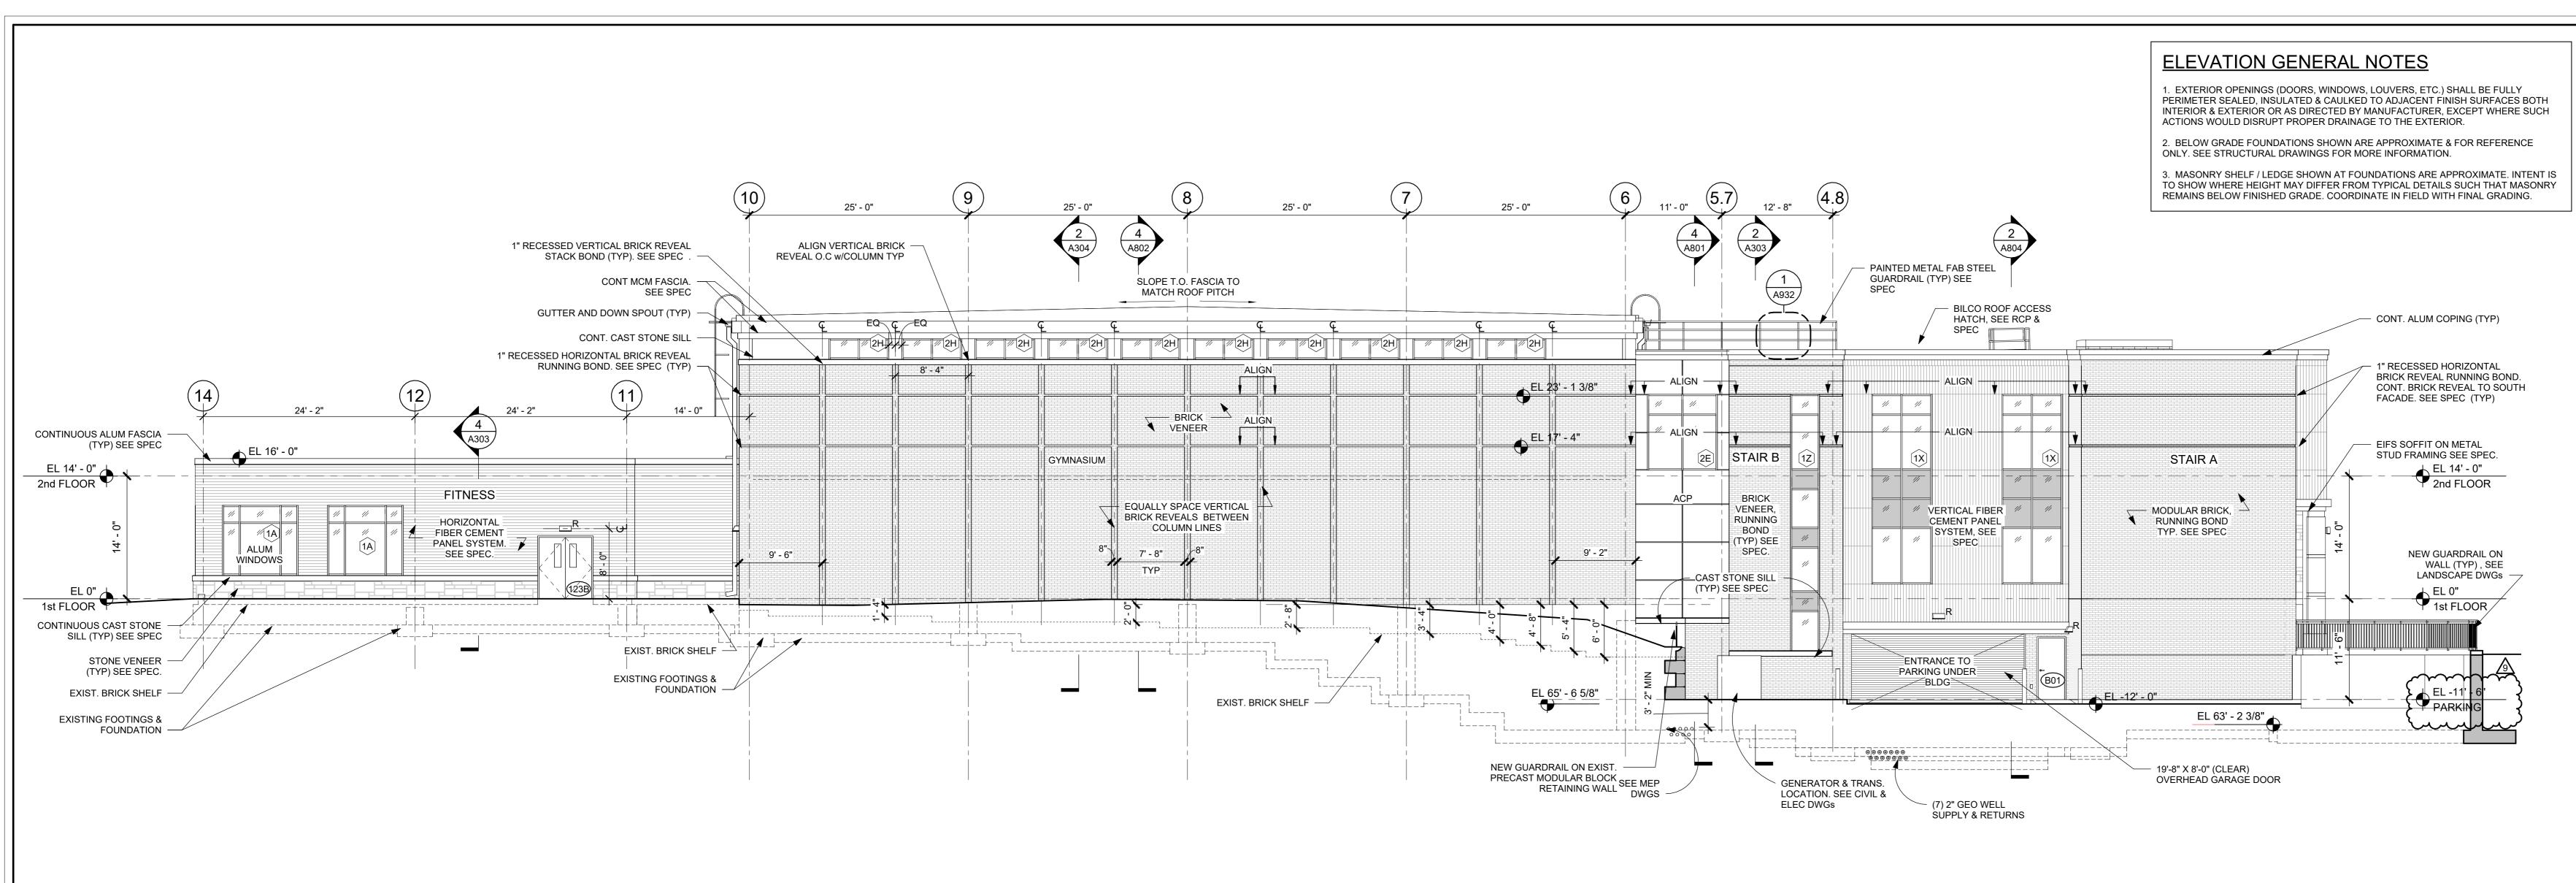

HARRISON

RECREATION & COMMUNITY CENTER

New Construction - Phase 2

Town / Village of Harrison

Harrison, NY 10528

270 Harrison Avenue



CONSTRUCTION DOCUMENTS

NOTE: ALL IDEAS, DESIGNS, ARRANGEMENTS AND PLANS INDICATED OR REPRESENTED BY THIS DRAWING ARE OWNED BY AND ARE THE PROPERTY OF KG+D ARCHITECTS, PC (KG+D), AND WERE CREATED FOR USE ON THIS PROJECT. NONE OF SUCH IDEAS, DESIGNS, ARRANGEMENTS OR PLANS SHALL BE USED BY OR DISCLOSED TO ANY PURPOSE WHATSOEVER WITHOUT THE WRITTEN PERMISSION OF KG+D.

WRITTEN DIMENSIONS ON THIS DRAWING SHALL HAVE PRECEDENCE OVER SCALED DIMENSIONS. CONTRACTOR SHALL VERIFY ALL ACTUAL DIMENSIONS AND CONDITIONS ON THE JOB AND THE ARCHITECT MUST BE NOTIFIED OF ANY BE SUBMITTED TO THIS OFFICE FOR APPROVAL BEFORE PROCEEDING WITH FABRICATION.

ALTERATIONS BY ANY PERSON, IN ANY WAY, OF ANY ITEM CONTAINED ON THIS DOCUMENT, UNLESS ACTING UNDER THE DIRECTION OF THE LICENSED ARCHITECT WHOSE PROFESSIONAL SEAL IS AFFIXED HERETO, IS A VIOLATION OF TITLE VII, SECT. 69.5 (b) OF NEW YORK STATE LAW. © COPYRIGHT KG+D ARCHITECTS, PC . ALL RIGHTS RESERVED.

Professional Seal

9 | 12/17/2024 | BULLETIN #1

10/09/2024 | CONFORMED SET 06/05/2024 ISSUED FOR BID 01/16/2024 ISSUED FOR PERMIT 06/01/2020 DESIGN DEVELOPMENT 03/31/2020 50% DESIGN DEVELOPMENT


Sheet Title

EXTERIOR ELEVATIONS

2020-1005 Scale AS NOTED

Drawn / Checked

05/01/2023

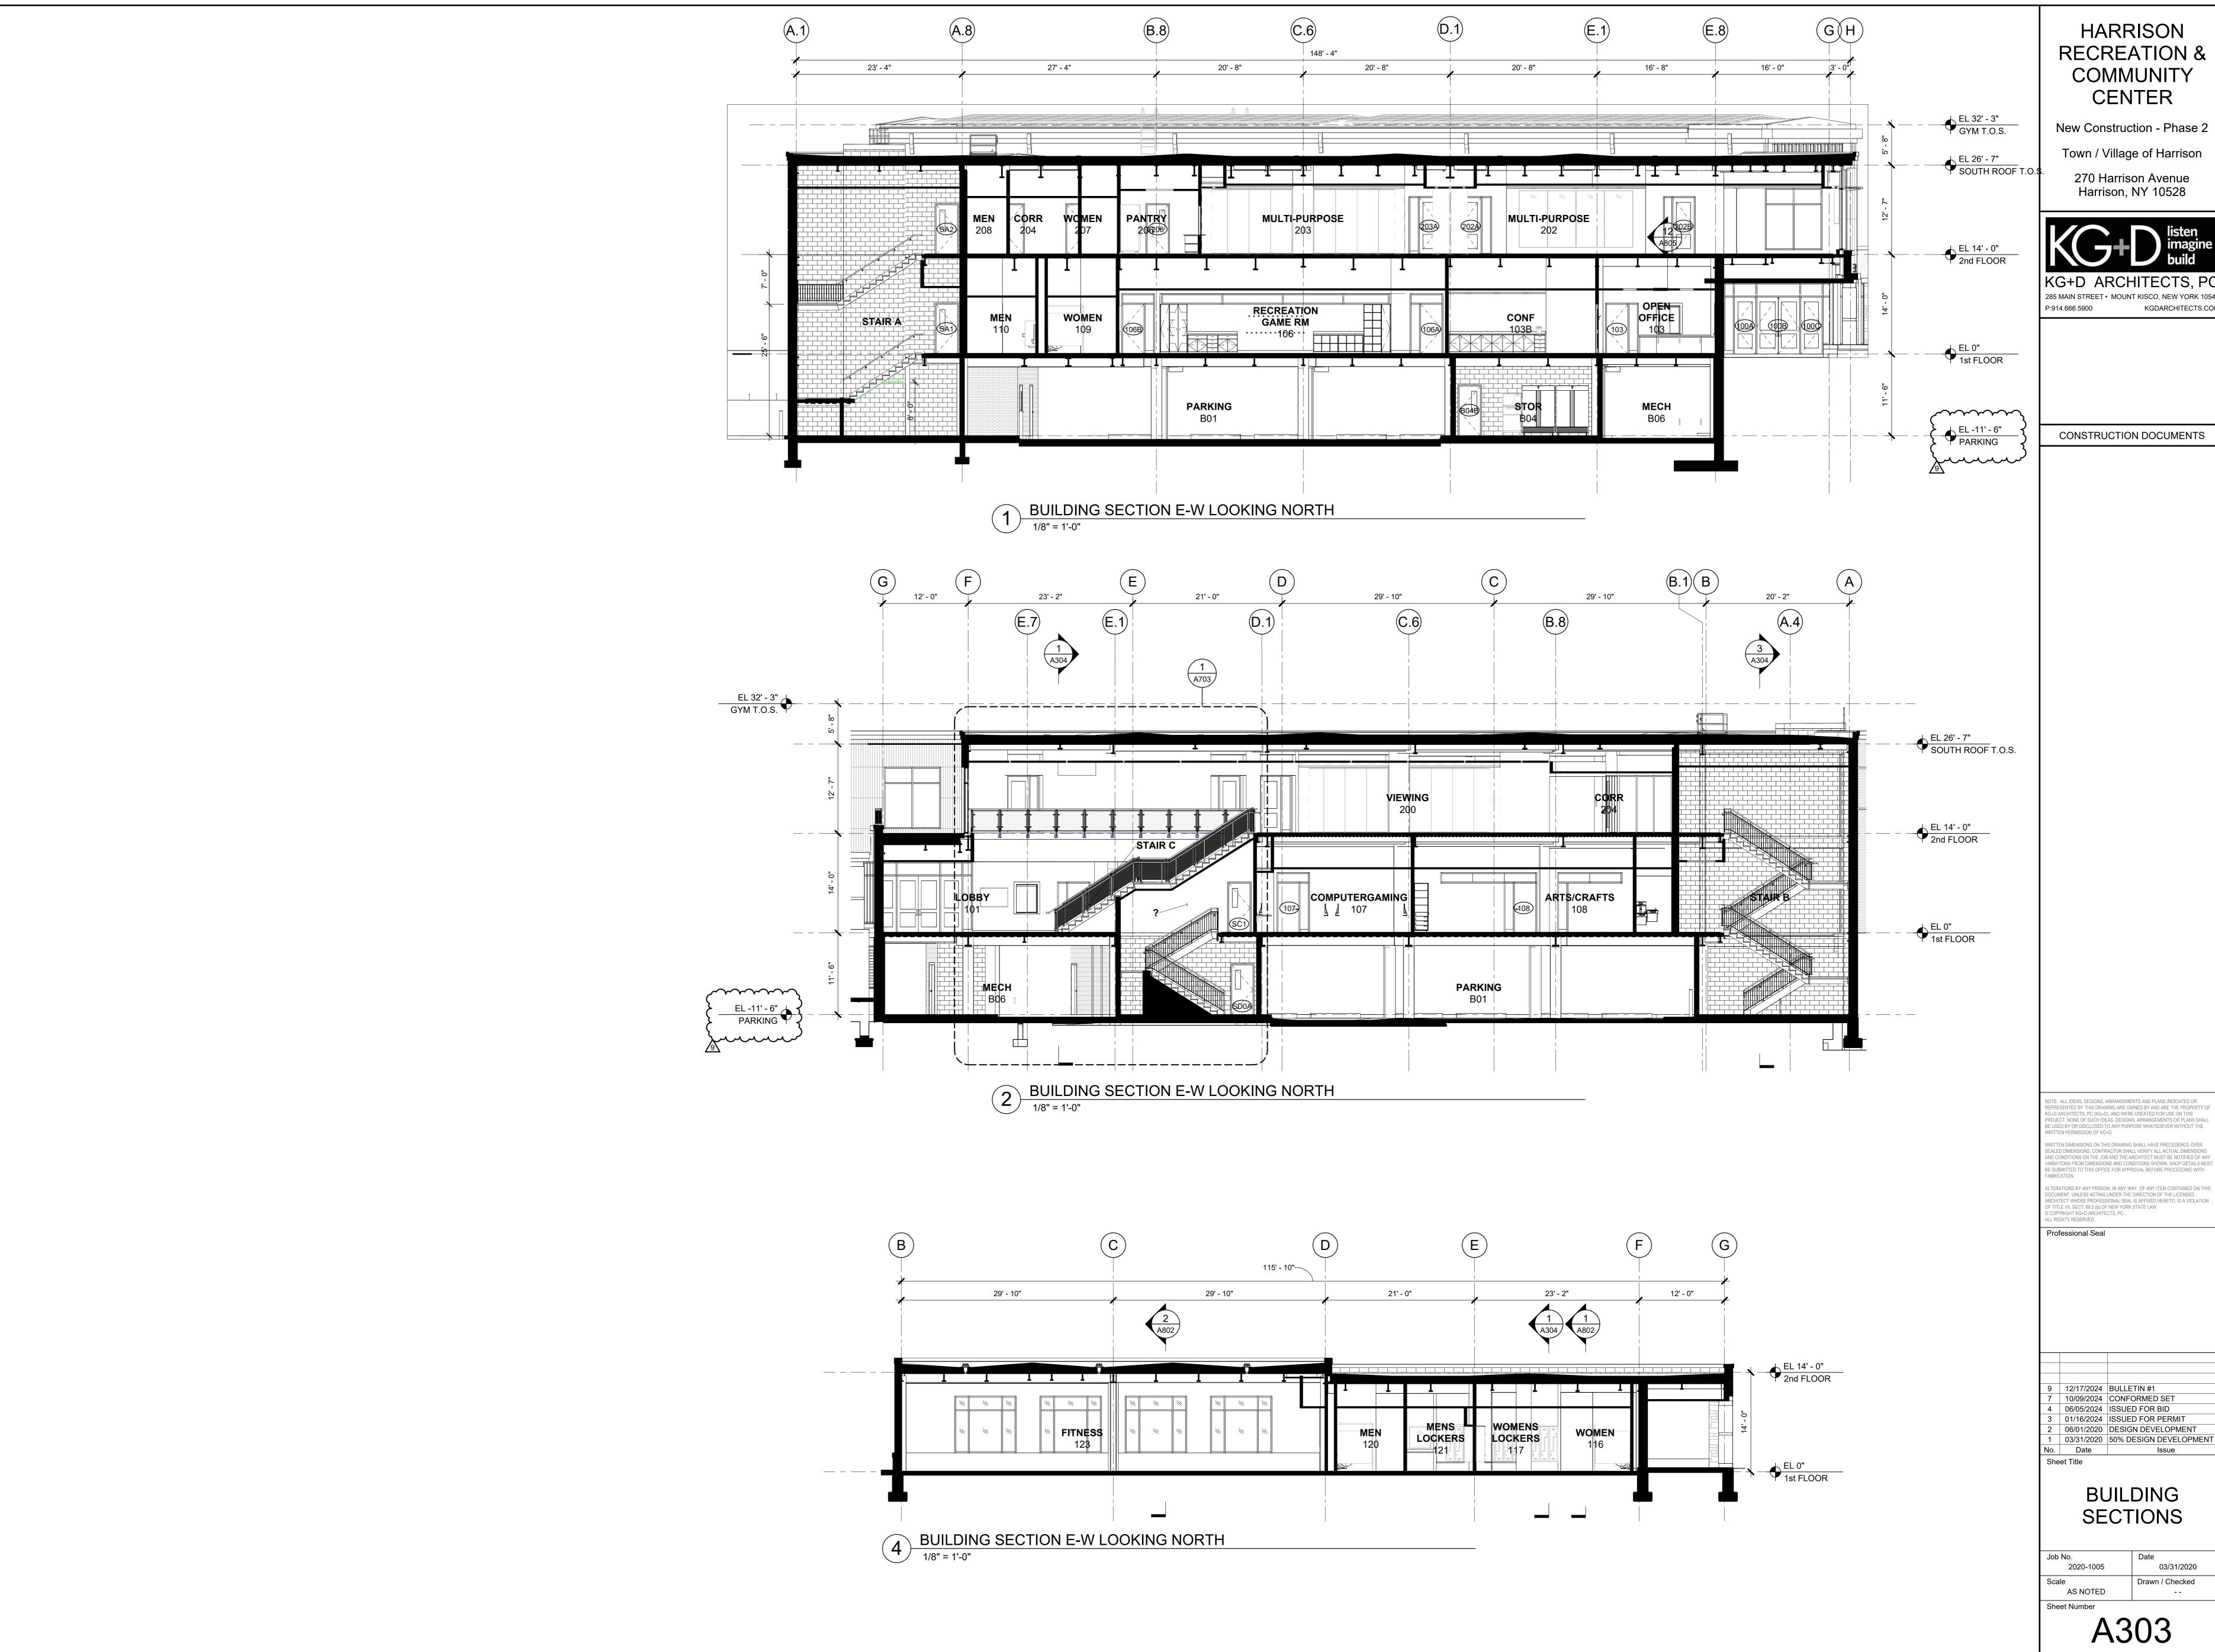

New Construction - Phase 2 Town / Village of Harrison

Harrison, NY 10528

KGDARCHITECTS.COM

CONSTRUCTION DOCUMENTS

NOTE: ALL IDEAS, DESIGNS, ARRANGEMENTS AND PLANS INDICATED OR REPRESENTED BY THIS DRAWING ARE OWNED BY AND ARE THE PROPERTY OF KG+D ARCHITECTS, PC (KG+D), AND WERE CREATED FOR USE ON THIS PROJECT. NONE OF SUCH IDEAS, DESIGNS, ARRANGEMENTS OR PLANS SHALL BE USED BY OR DISCLOSED TO ANY PURPOSE WHATSOEVER WITHOUT THE RITTEN PERMISSION OF KG+D.

WRITTEN DIMENSIONS ON THIS DRAWING SHALL HAVE PRECEDENCE OVER SCALED DIMENSIONS. CONTRACTOR SHALL VERIFY ALL ACTUAL DIMENSIONS AND CONDITIONS ON THE JOB AND THE ARCHITECT MUST BE NOTIFIED OF ANY VARIATIONS FROM DIMENSIONS AND CONDITIONS SHOWN. SHOP DETAILS MUS BE SUBMITTED TO THIS OFFICE FOR APPROVAL BEFORE PROCEEDING WITH FABRICATION.


LTERATIONS BY ANY PERSON, IN ANY WAY, OF ANY ITEM CONTAINED ON THIS OCUMENT, UNLESS ACTING UNDER THE DIRECTION OF THE LICENSED ARCHITECT WHOSE PROFESSIONAL SEAL IS AFFIXED HERETO, IS A VIOLATION OF TITLE VII, SECT. 69.5 (b) OF NEW YORK STATE LAW.


Professional Seal

12/17/2024 BULLETIN #1 10/09/2024 | CONFORMED SET 06/05/2024 ISSUED FOR BID 01/16/2024 ISSUED FOR PERMIT 06/01/2020 DESIGN DEVELOPMENT

BUILDING

03/31/2020 2020-1005 Drawn / Checked AS NOTED

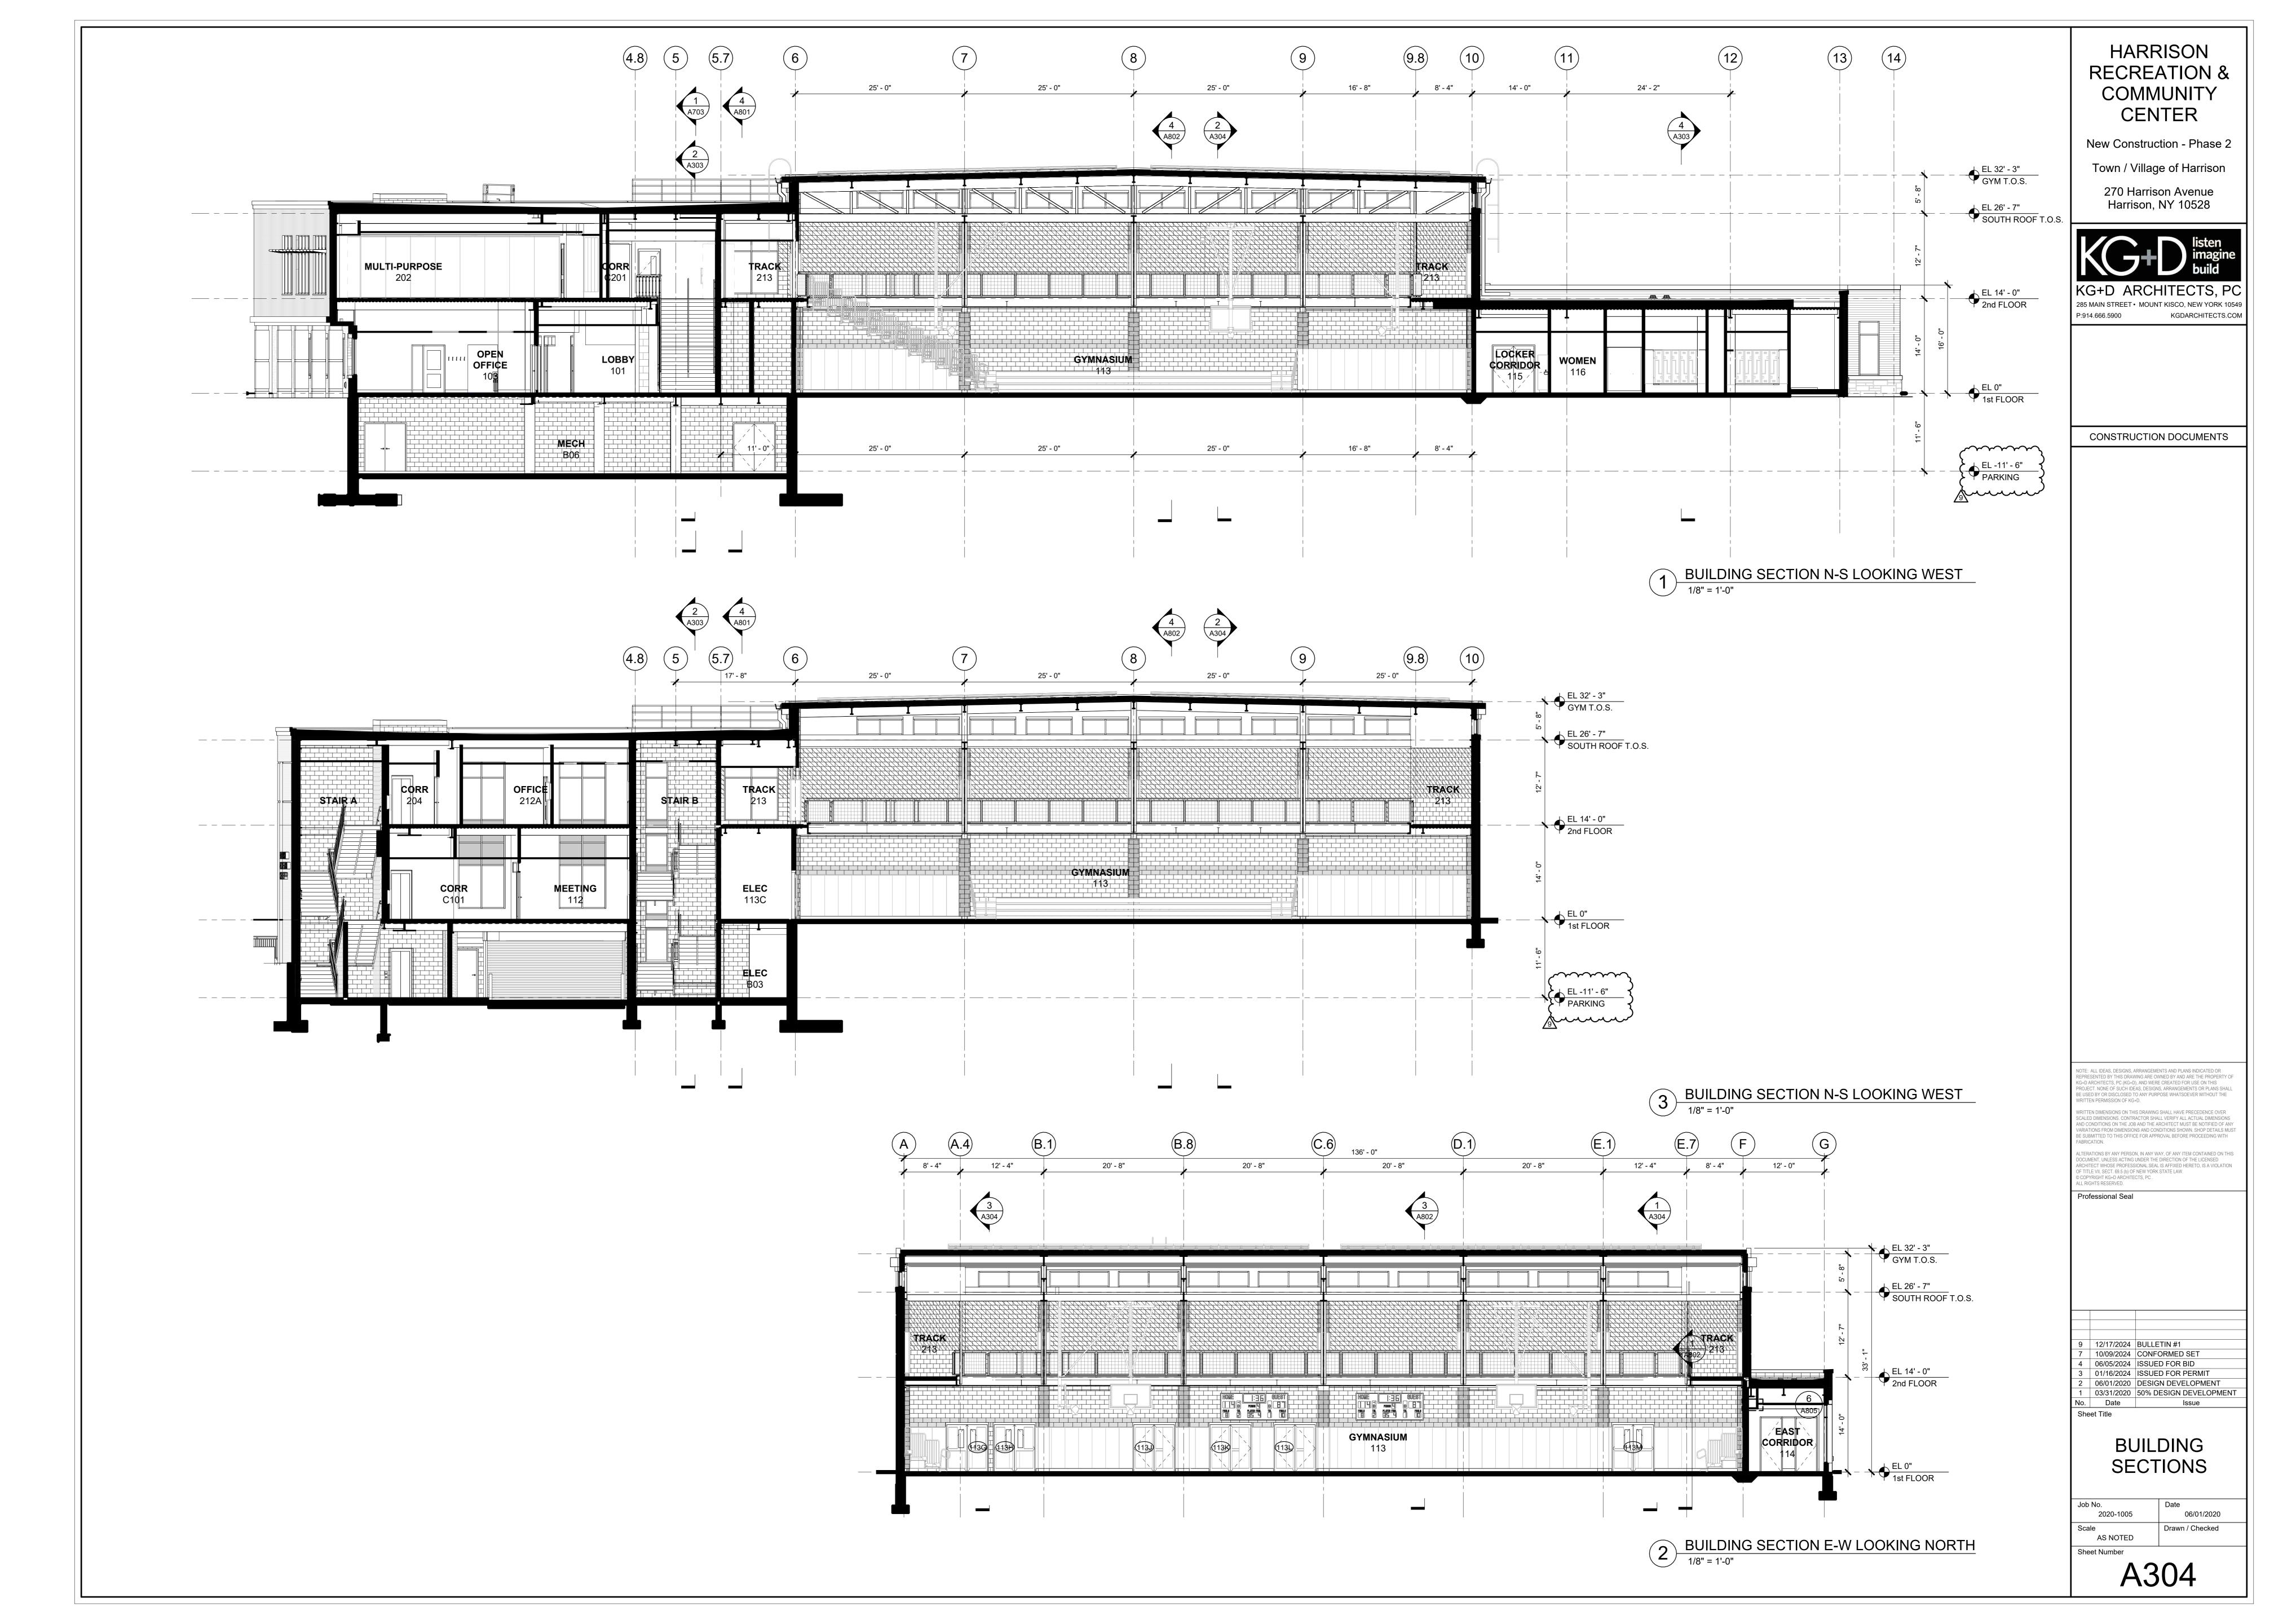

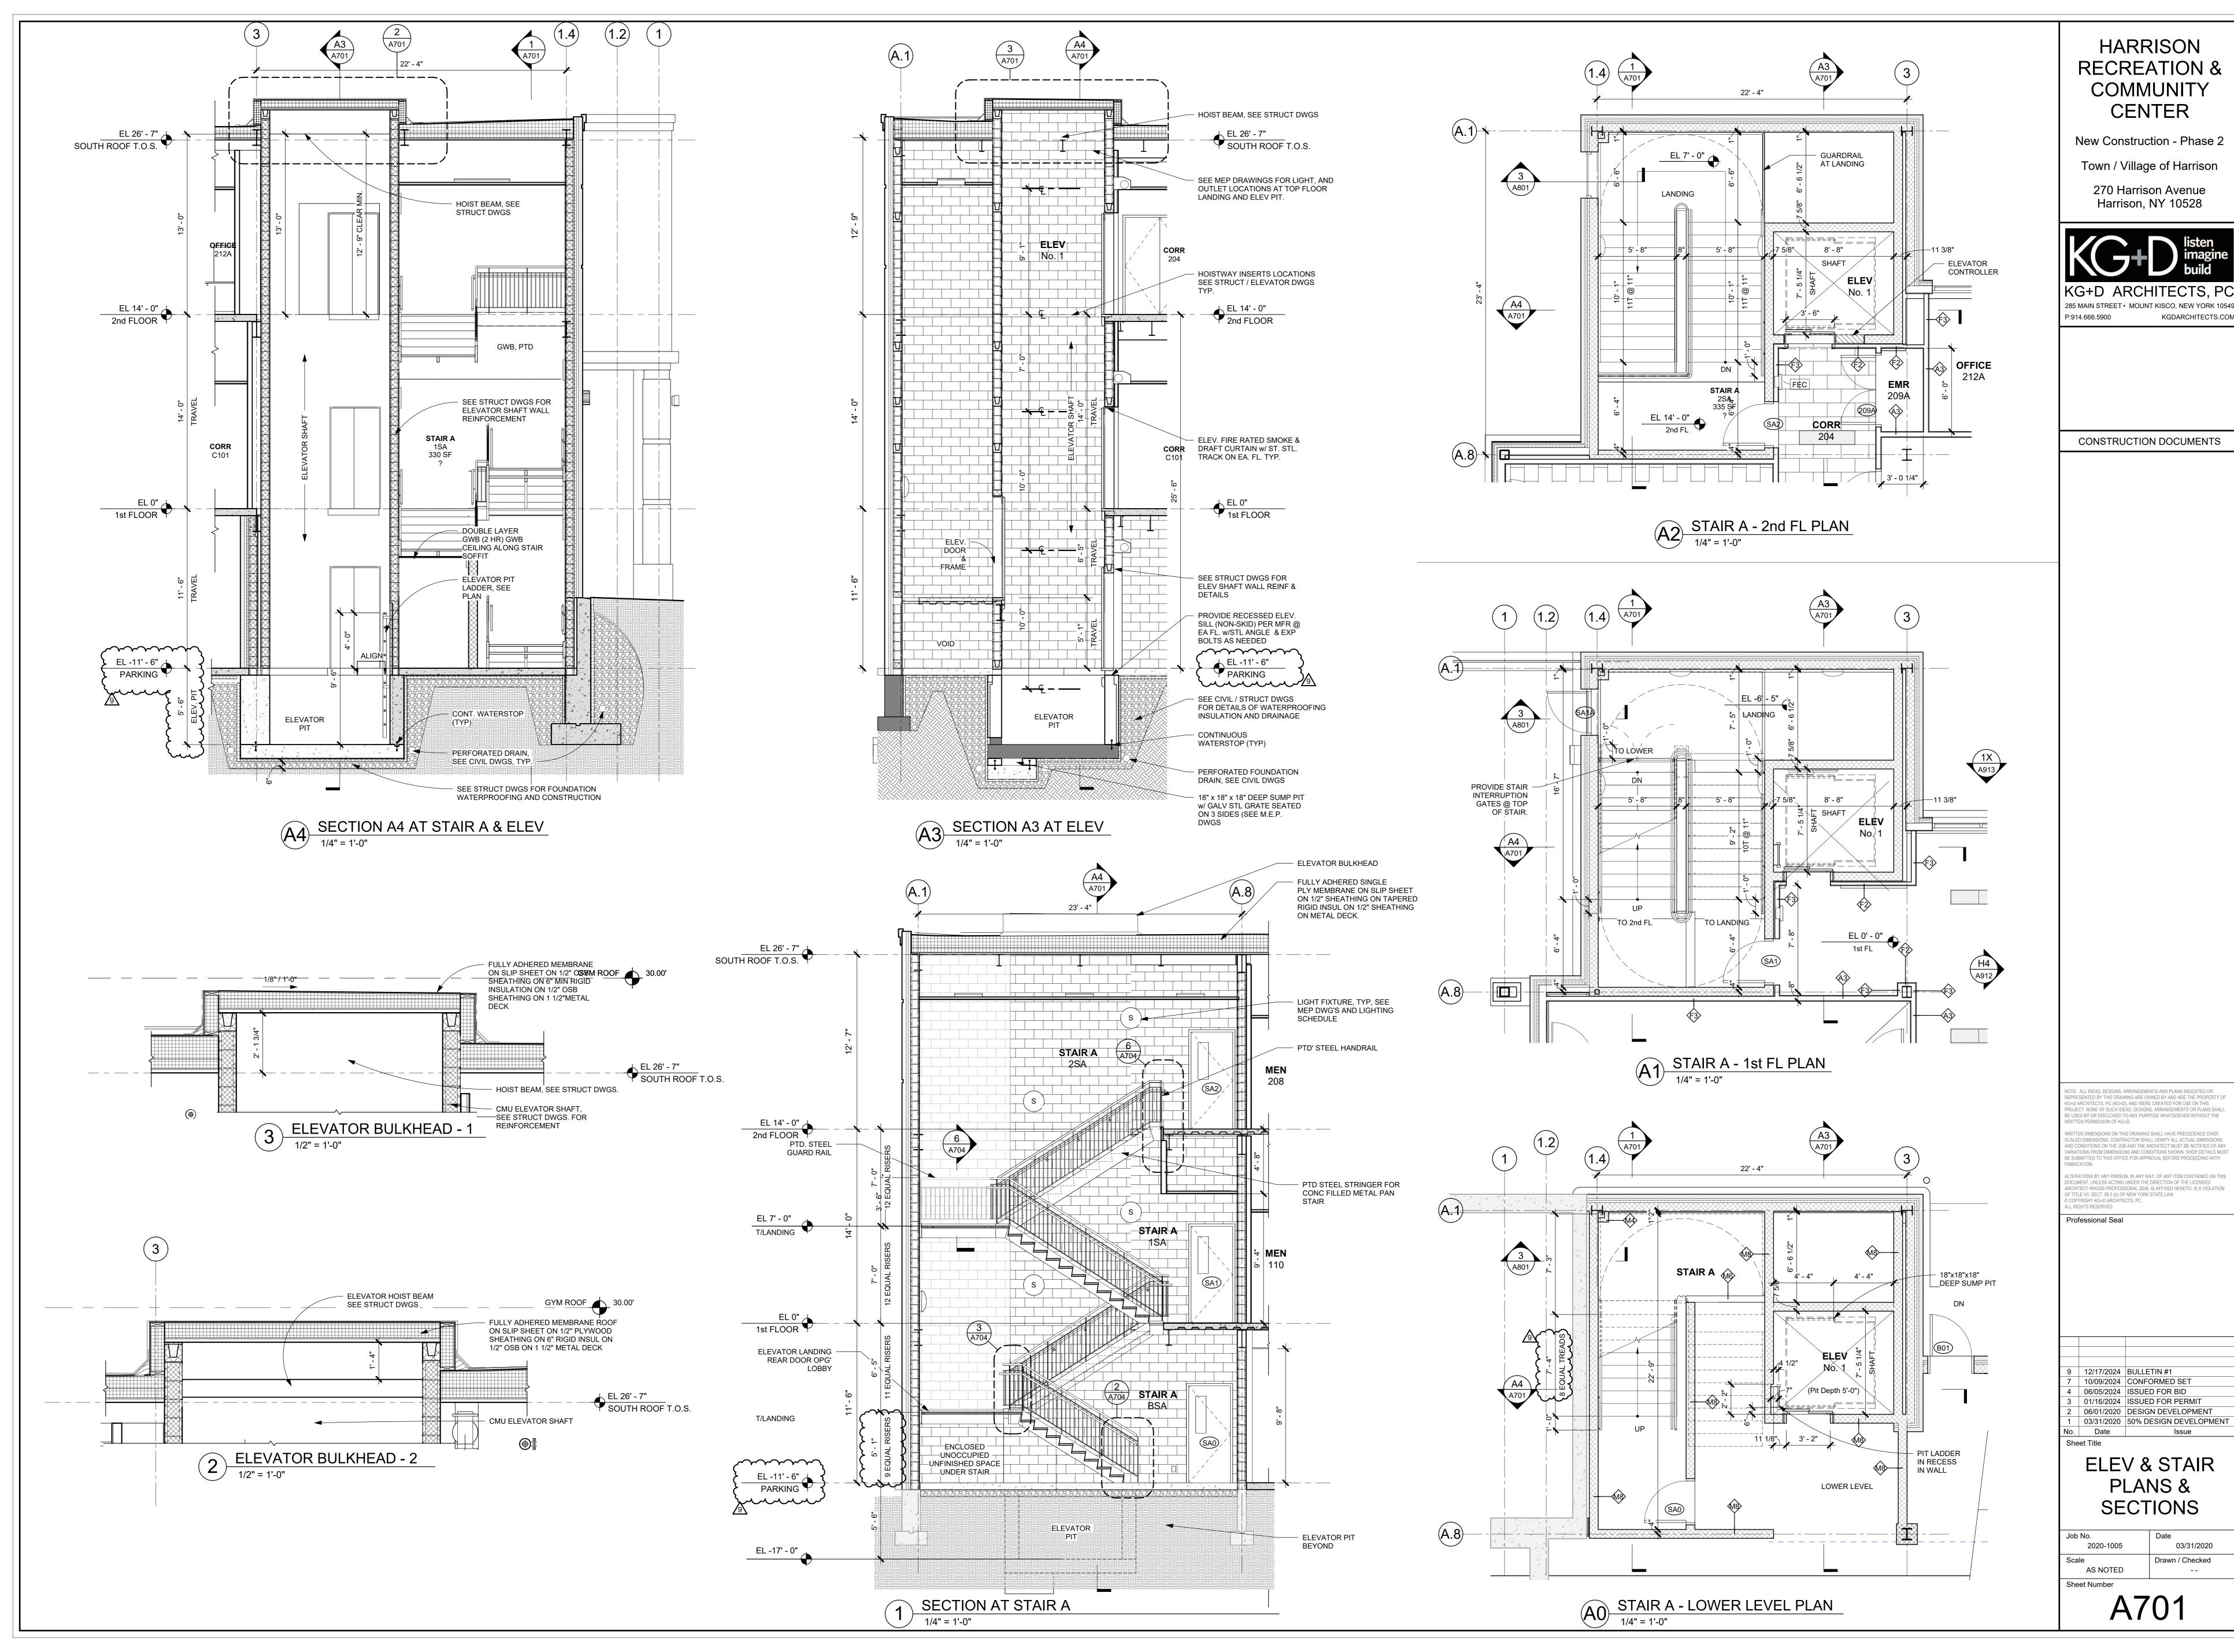

New Construction - Phase 2 Town / Village of Harrison



TE: ALL IDEAS, DESIGNS, ARRANGEMENTS AND PLANS INDICATED OR PRESENTED BY THIS DRAWING ARE OWNED BY AND ARE THE PROPERTY OF ARCHITECTS, PC (KG+D), AND WERE CREATED FOR USE ON THIS ROJECT. NONE OF SUCH IDEAS, DESIGNS, ARRANGEMENTS OR PLANS SHA USED BY OR DISCLOSED TO ANY PURPOSE WHATSOEVER WITHOUT TH

ALED DIMENSIONS. CONTRACTOR SHALL VERIFY ALL ACTUAL DIMENSIONS D CONDITIONS ON THE JOB AND THE ARCHITECT MUST BE NOTIFIED OF AN SUBMITTED TO THIS OFFICE FOR APPROVAL BEFORE PROCEEDING WITH


CHITECT WHOSE PROFESSIONAL SEAL IS AFFIXED HERETO, IS A VIOLATIC FITTLE VII, SECT. 69.5 (b) OF NEW YORK STATE LAW.

12/17/2024 BULLETIN #1 10/09/2024 | CONFORMED SET

ELEV & STAIR PLANS &

SECTIONS

03/31/2020 Drawn / Checked

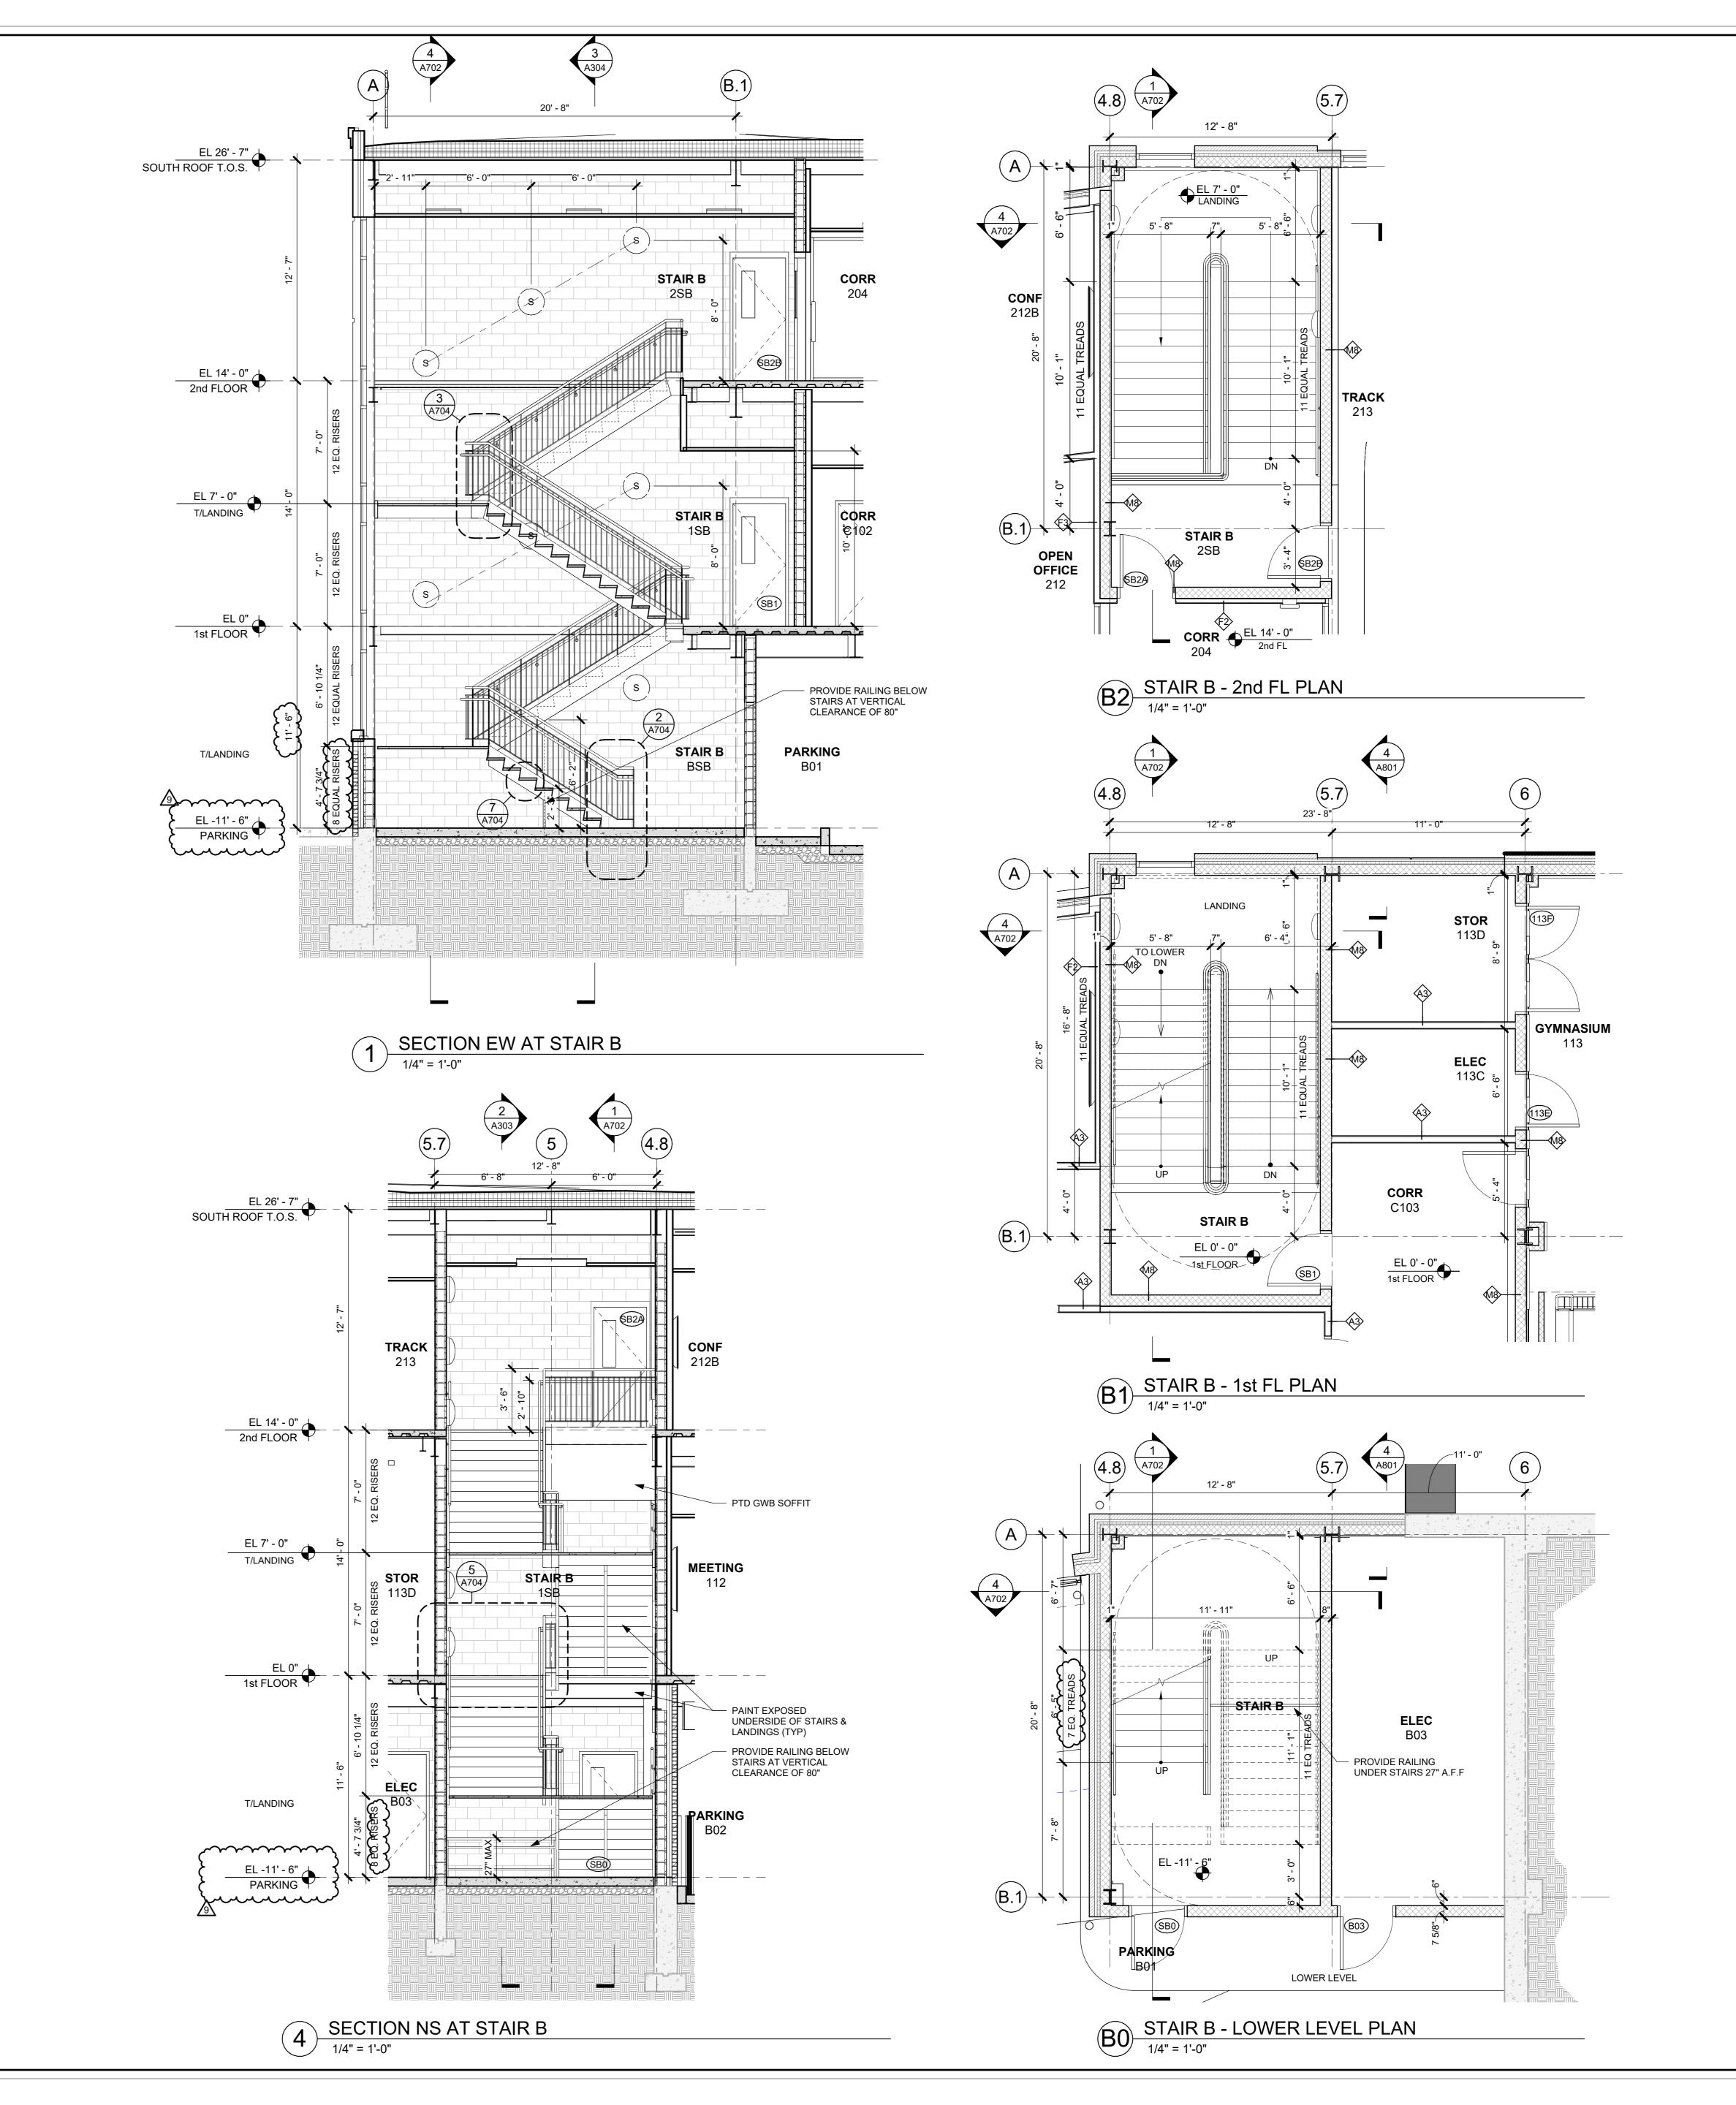

New Construction - Phase 2

Town / Village of Harrison

270 Harrison Avenue
Harrison, NY 10528



CONSTRUCTION DOCUMENTS

NOTE: ALL IDEAS, DESIGNS, ARRANGEMENTS AND PLANS INDICATED OR REPRESENTED BY THIS DRAWING ARE OWNED BY AND ARE THE PROPERTY OF KG+D ARCHITECTS, PC (KG+D), AND WERE CREATED FOR USE ON THIS PROJECT. NONE OF SUCH IDEAS, DESIGNS, ARRANGEMENTS OR PLANS SHALL BE USED BY OR DISCLOSED TO ANY PURPOSE WHATSOEVER WITHOUT THE WRITTEN PERMISSION OF KG+D.

WRITTEN DIMENSIONS ON THIS DRAWING SHALL HAVE PRECEDENCE OVER SCALED DIMENSIONS. CONTRACTOR SHALL VERIFY ALL ACTUAL DIMENSIONS AND CONDITIONS ON THE JOB AND THE ARCHITECT MUST BE NOTIFIED OF ANY VARIATIONS FROM DIMENSIONS AND CONDITIONS SHOWN. SHOP DETAILS MUS BE SUBMITTED TO THIS OFFICE FOR APPROVAL BEFORE PROCEEDING WITH FABRICATION.

ALTERATIONS BY ANY PERSON, IN ANY WAY, OF ANY ITEM CONTAINED ON THIS DOCUMENT, UNLESS ACTING UNDER THE DIRECTION OF THE LICENSED ARCHITECT WHOSE PROFESSIONAL SEAL IS AFFIXED HERETO, IS A VIOLATION OF TITLE VII, SECT. 69.5 (b) OF NEW YORK STATE LAW.


© COPYRIGHT KG+D ARCHITECTS, PC.
ALL RIGHTS RESERVED.

Professional Seal

12/17/2024 BULLETIN #1 10/09/2024 CONFORMED SET

7 10/09/2024 CONFORMED SET
4 06/05/2024 ISSUED FOR BID
3 01/16/2024 ISSUED FOR PERMIT
2 06/01/2020 DESIGN DEVELOPMENT
1 03/31/2020 50% DESIGN DEVELOPMENT
No. Date Issue
Sheet Title

STAIR PLANS & SECTIONS

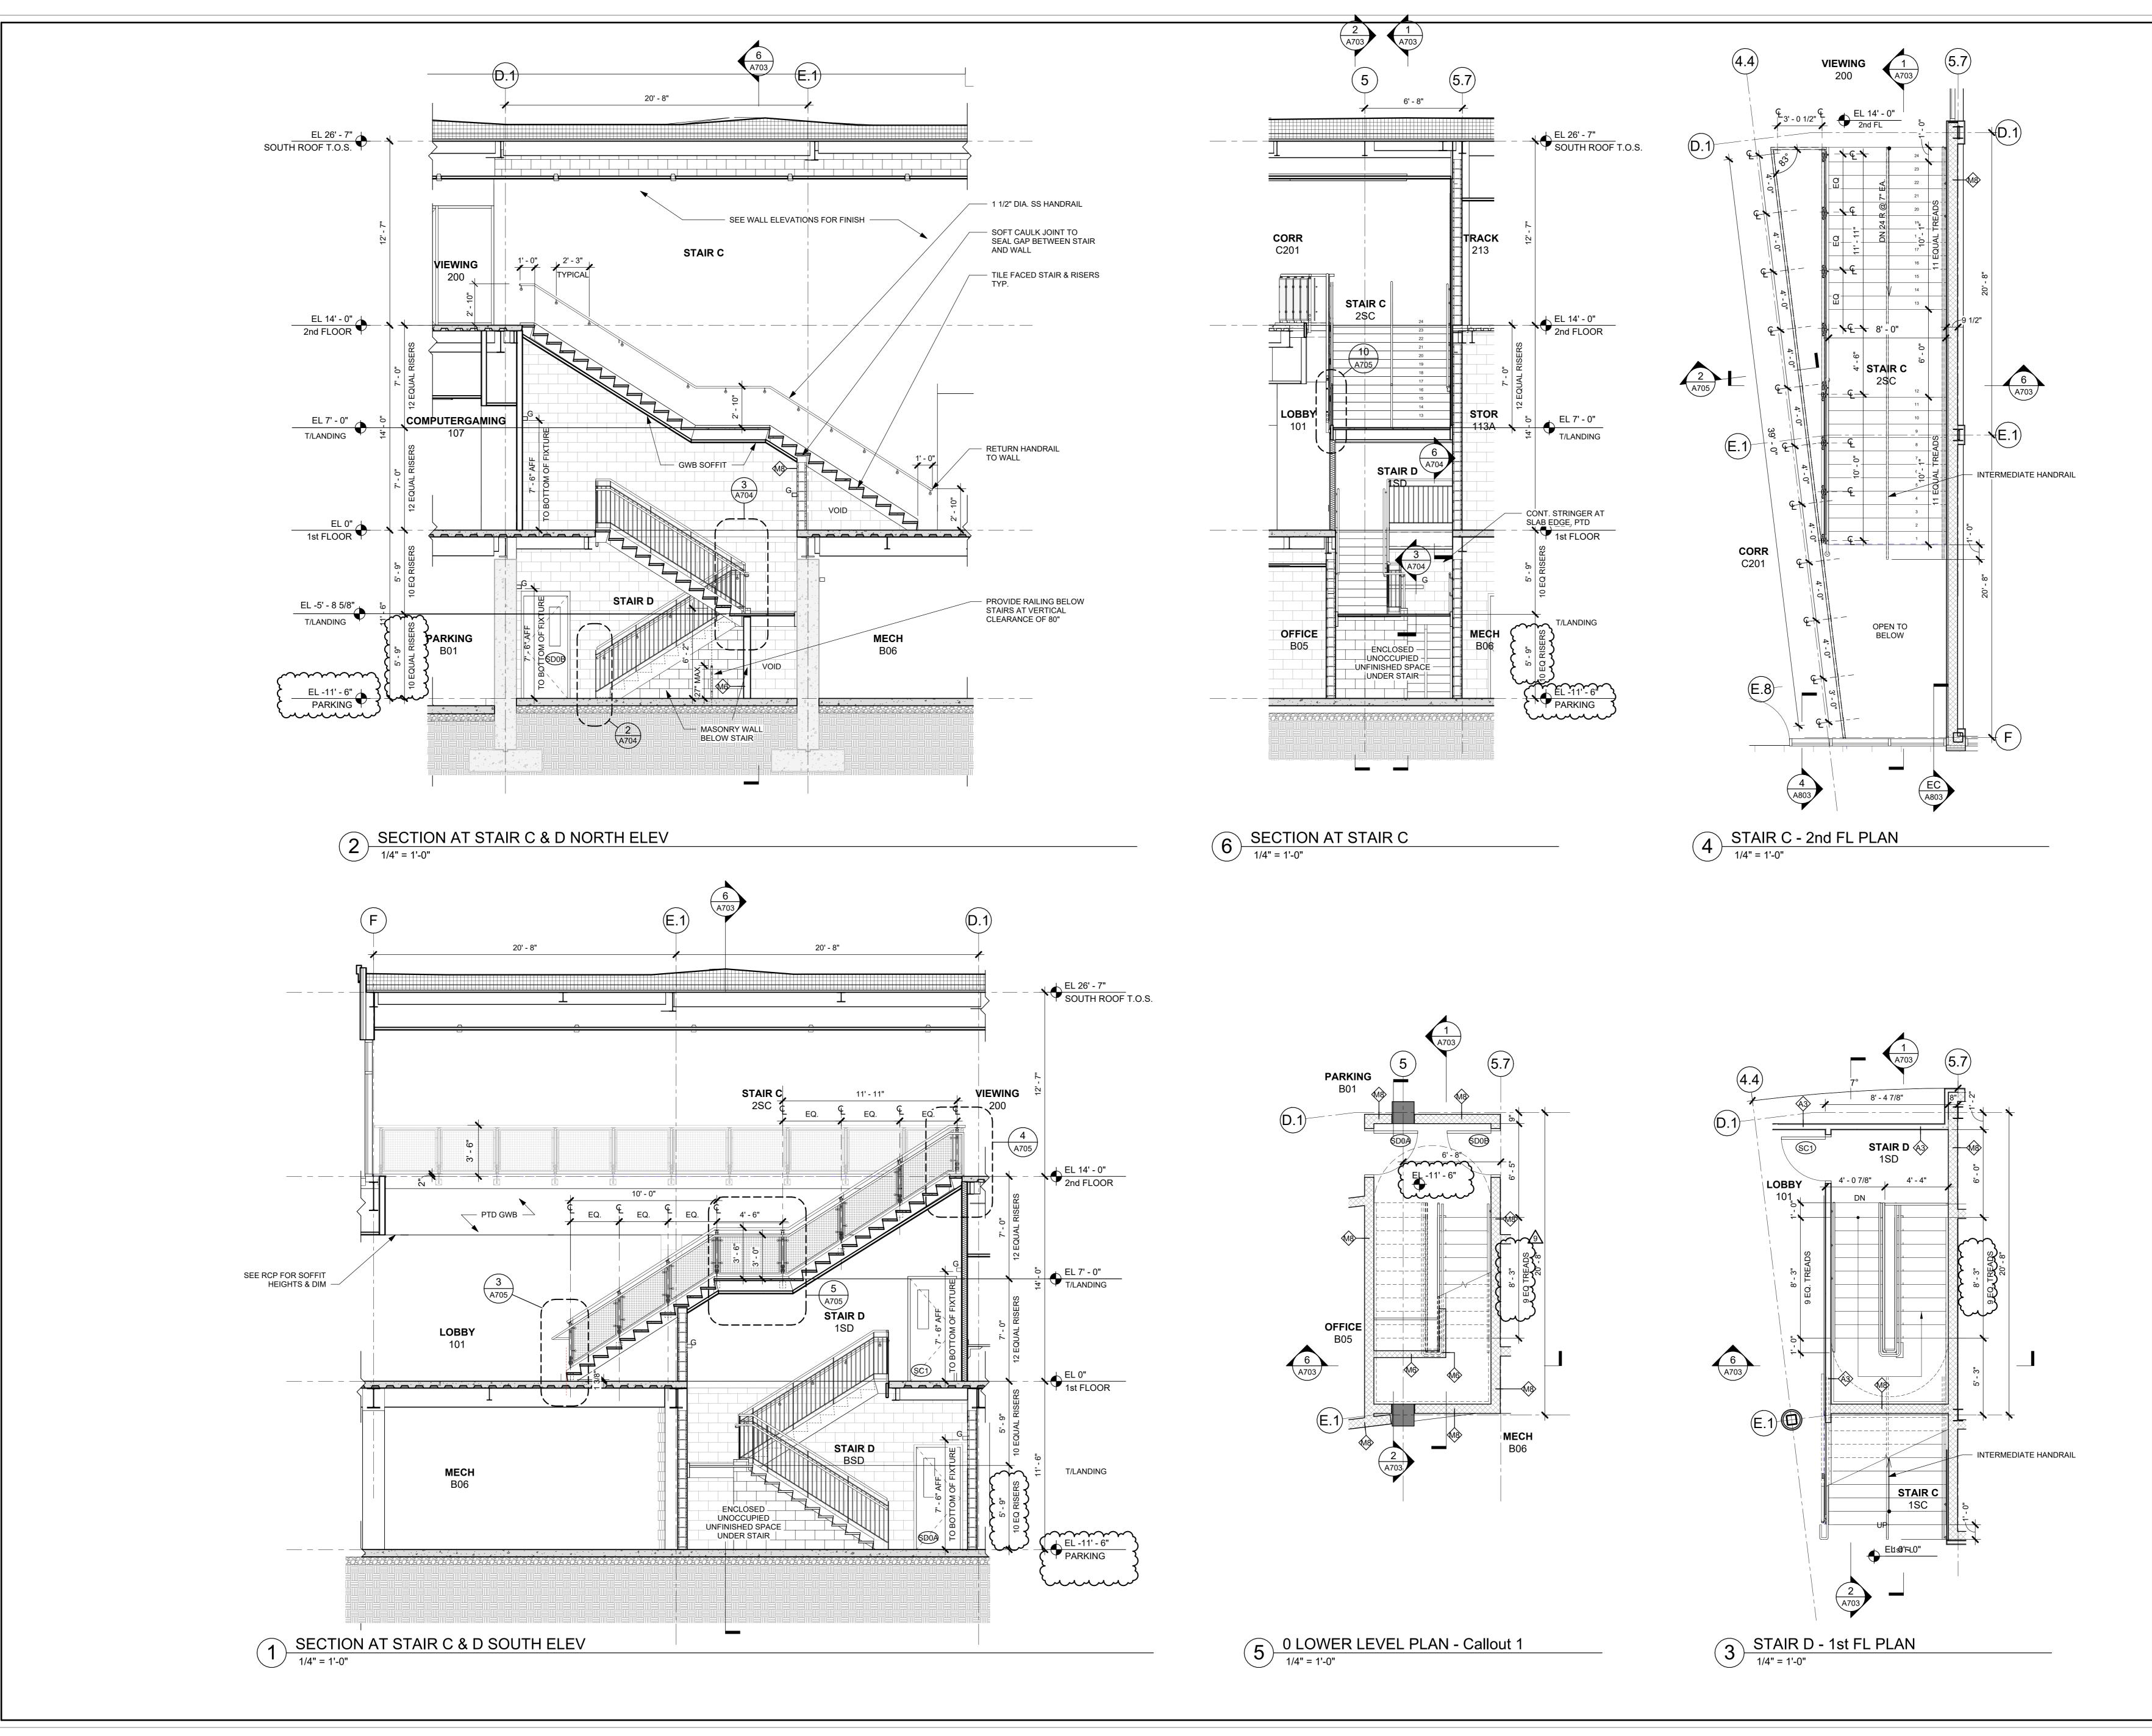

New Construction - Phase 2 Town / Village of Harrison

> 270 Harrison Avenue Harrison, NY 10528



CONSTRUCTION DOCUMENTS

DTE: ALL IDEAS, DESIGNS, ARRANGEMENTS AND PLANS INDICATED OR EPRESENTED BY THIS DRAWING ARE OWNED BY AND ARE THE PROPERTY OF +D ARCHITECTS, PC (KG+D), AND WERE CREATED FOR USE ON THIS ROJECT. NONE OF SUCH IDEAS, DESIGNS, ARRANGEMENTS OR PLANS SHA BE USED BY OR DISCLOSED TO ANY PURPOSE WHATSOEVER WITHOUT THE CALED DIMENSIONS. CONTRACTOR SHALL VERIFY ALL ACTUAL DIMENSIONS ID CONDITIONS ON THE JOB AND THE ARCHITECT MUST BE NOTIFIED OF ANY SUBMITTED TO THIS OFFICE FOR APPROVAL BEFORE PROCEEDING WITH

DCUMENT, UNLESS ACTING UNDER THE DIRECTION OF THE LICENSED ARCHITECT WHOSE PROFESSIONAL SEAL IS AFFIXED HERETO, IS A VIOLATION OF TITLE VII, SECT. 69.5 (b) OF NEW YORK STATE LAW.

Professional Seal


Sheet Title


12/17/2024 BULLETIN #1 10/09/2024 | CONFORMED SET 06/05/2024 ISSUED FOR BID 01/16/2024 ISSUED FOR PERMIT 06/01/2020 DESIGN DEVELOPMENT 03/31/2020 50% DESIGN DEVELOPMENT

STAIR PLANS & SECTIONS

02/16/24

2020-1005 Drawn / Checked Scale AS NOTED Author Checker

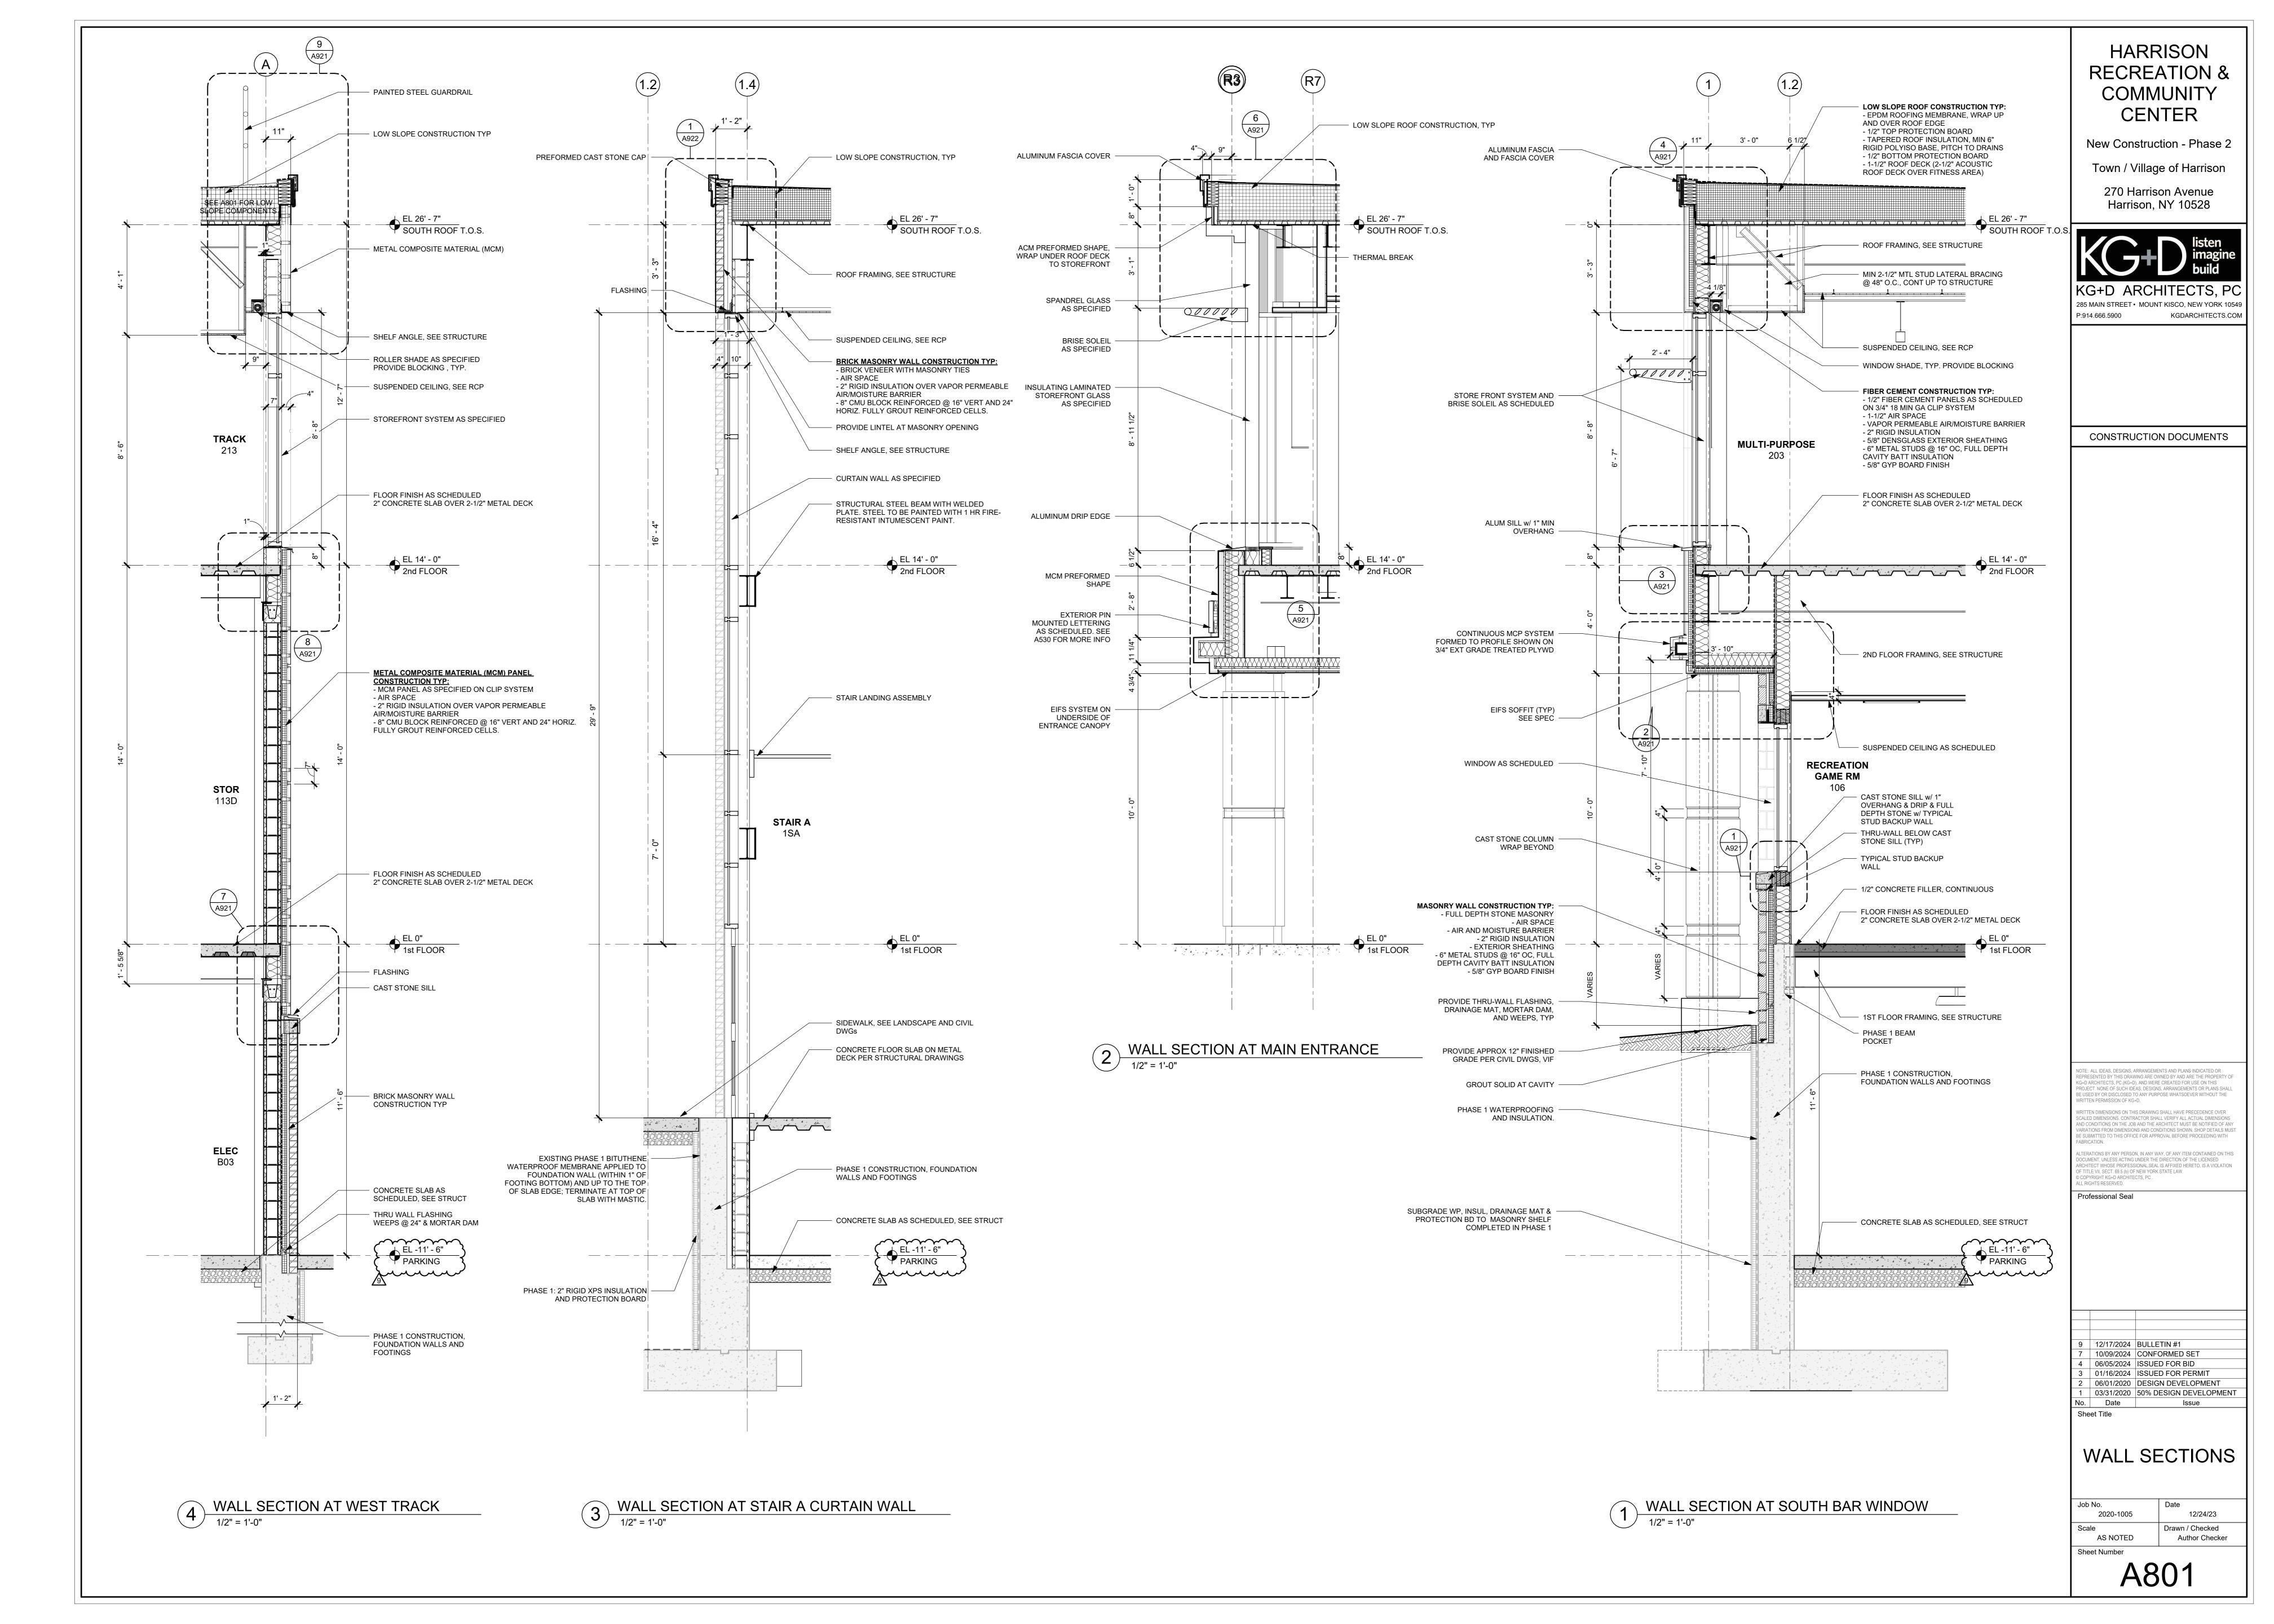

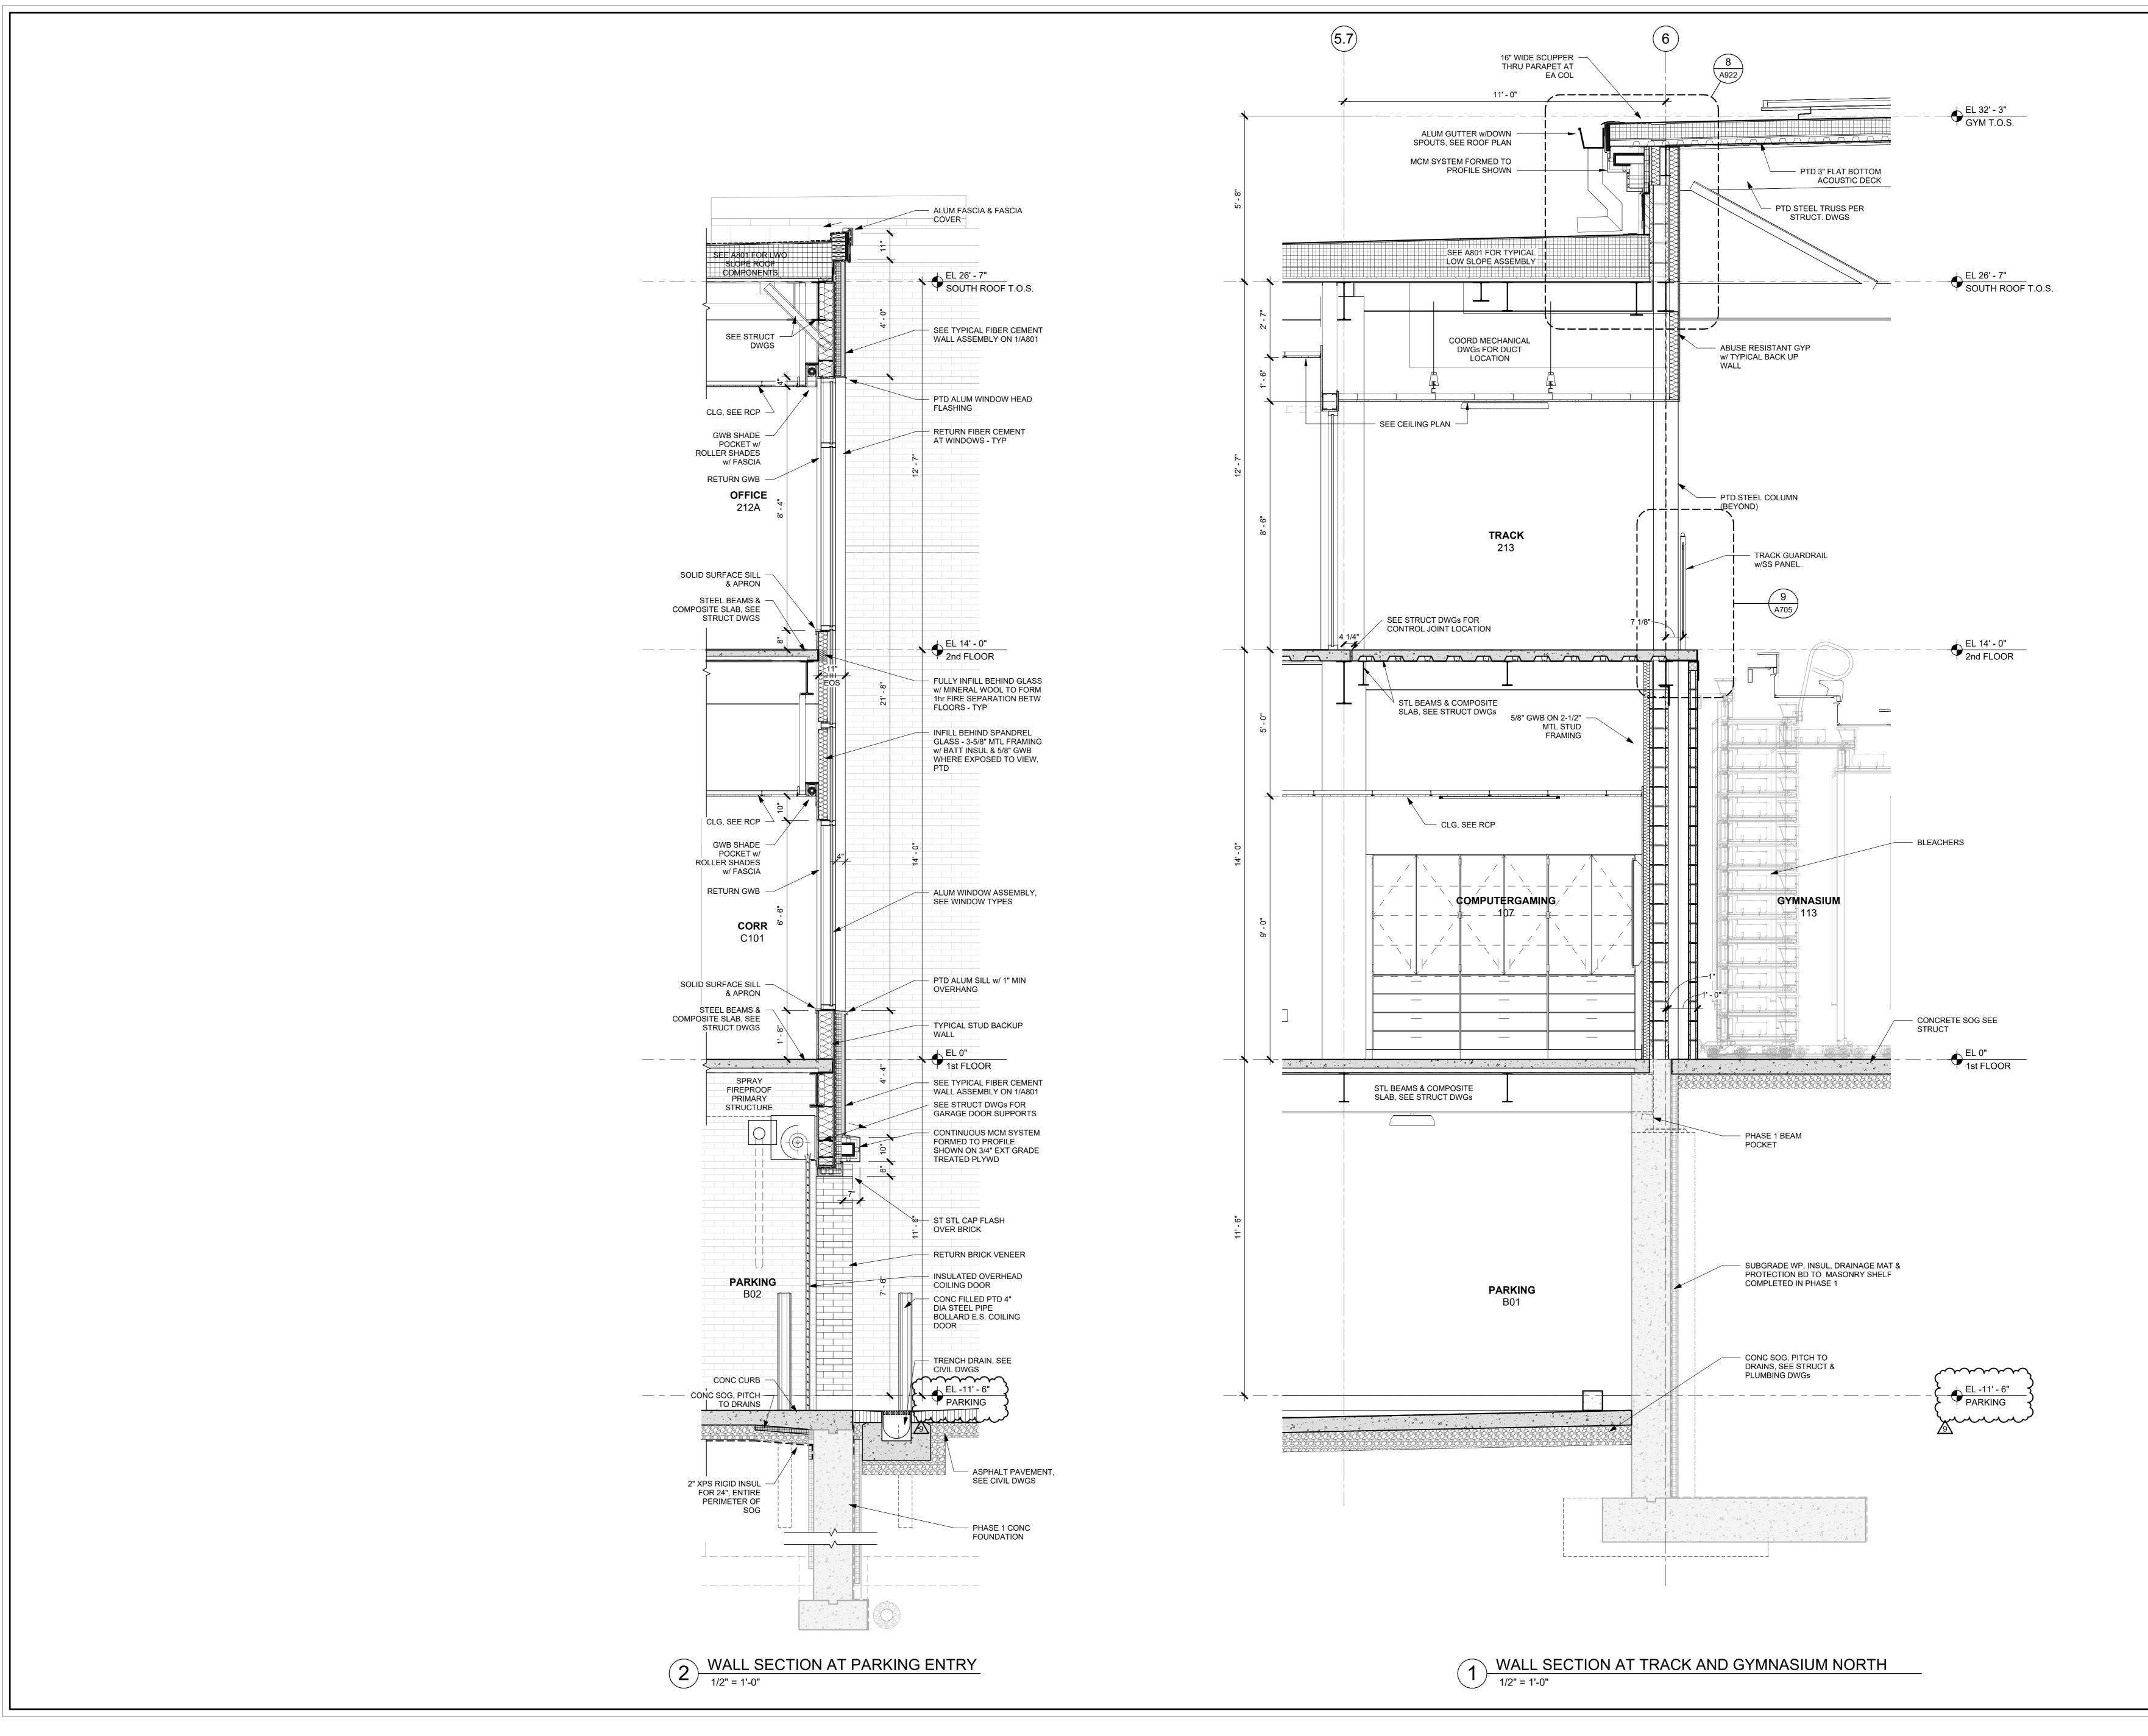

New Construction - Phase 2 Town / Village of Harrison

> 270 Harrison Avenue Harrison, NY 10528



CONSTRUCTION DOCUMENTS

IOTE: ALL IDEAS, DESIGNS, ARRANGEMENTS AND PLANS INDICATED OR REPRESENTED BY THIS DRAWING ARE OWNED BY AND ARE THE PROPERTY OF G+D ARCHITECTS, PC (KG+D), AND WERE CREATED FOR USE ON THIS PROJECT. NONE OF SUCH IDEAS, DESIGNS, ARRANGEMENTS OR PLANS SHAL BE USED BY OR DISCLOSED TO ANY PURPOSE WHATSOEVER WITHOUT THE ITTEN PERMISSION OF KG+D.

RITTEN DIMENSIONS ON THIS DRAWING SHALL HAVE PRECEDENCE OVER CALED DIMENSIONS. CONTRACTOR SHALL VERIFY ALL ACTUAL DIMENSIONS IND CONDITIONS ON THE JOB AND THE ARCHITECT MUST BE NOTIFIED OF ANY E SUBMITTED TO THIS OFFICE FOR APPROVAL BEFORE PROCEEDING WITH

LTERATIONS BY ANY PERSON. IN ANY WAY, OF ANY ITEM CONTAINED ON THIS OCUMENT, UNLESS ACTING UNDER THE DIRECTION OF THE LICENSED ARCHITECT WHOSE PROFESSIONAL SEAL IS AFFIXED HERETO, IS A VIOLATION OF TITLE VII, SECT. 69.5 (b) OF NEW YORK STATE LAW. COPYRIGHT KG+D ARCHITECTS, PC . LL RIGHTS RESERVED.

Professional Seal


12/17/2024 BULLETIN #1 10/09/2024 | CONFORMED SET


06/05/2024 ISSUED FOR BID 01/16/2024 ISSUED FOR PERMIT 06/01/2020 DESIGN DEVELOPMENT 03/31/2020 50% DESIGN DEVELOPMENT No. Date Sheet Title

WALL SECTIONS

01/22/24

2020-1005 Drawn / Checked Scale AS NOTED Author Checker

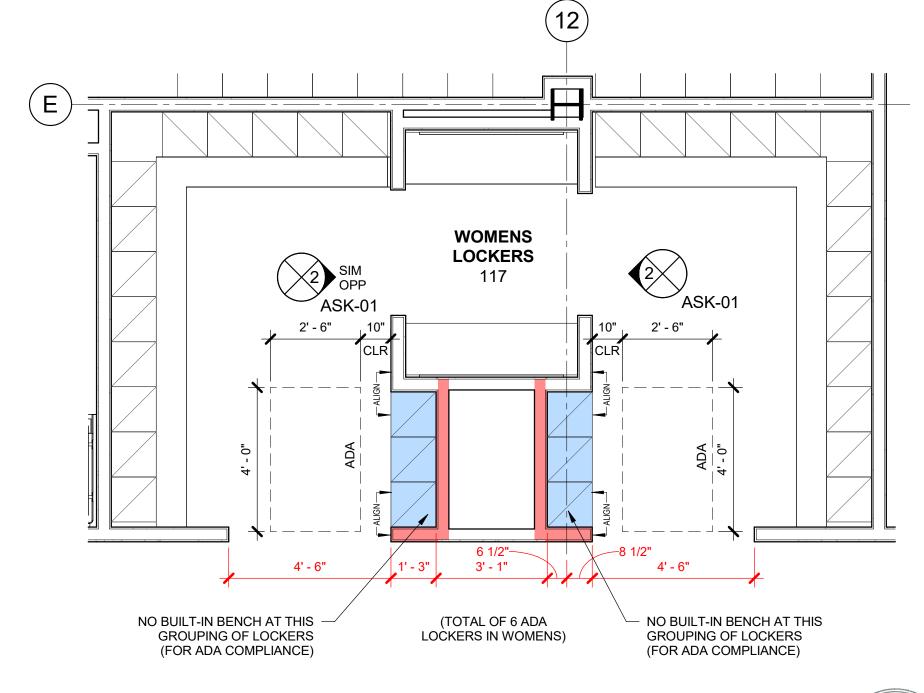

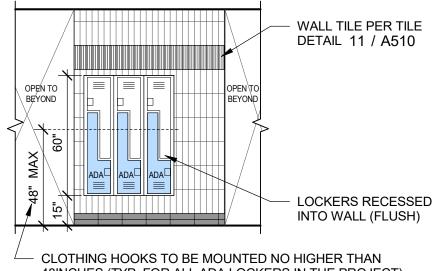

CLOTHING HOOKS TO BE MOUNTED NO HIGHER THAN 48INCHES (TYP. FOR ALL ADA LOCKERS IN THE PROJECT)





WOMEN'S LOCKER ROOM - ADA LOCKERS 3/8" = 1'-0"





HARRISON RECREATION & COMMUNITY **CENTER**

Town / Village of Harrison


LOCKER ROOMS - ADA LOCKER **LOCATIONS**

Job No.
2020-1005
Date
12/11/2024
Scale
As indicated
Drawn / Checked

KG+D

Sheet No.

ASK-01

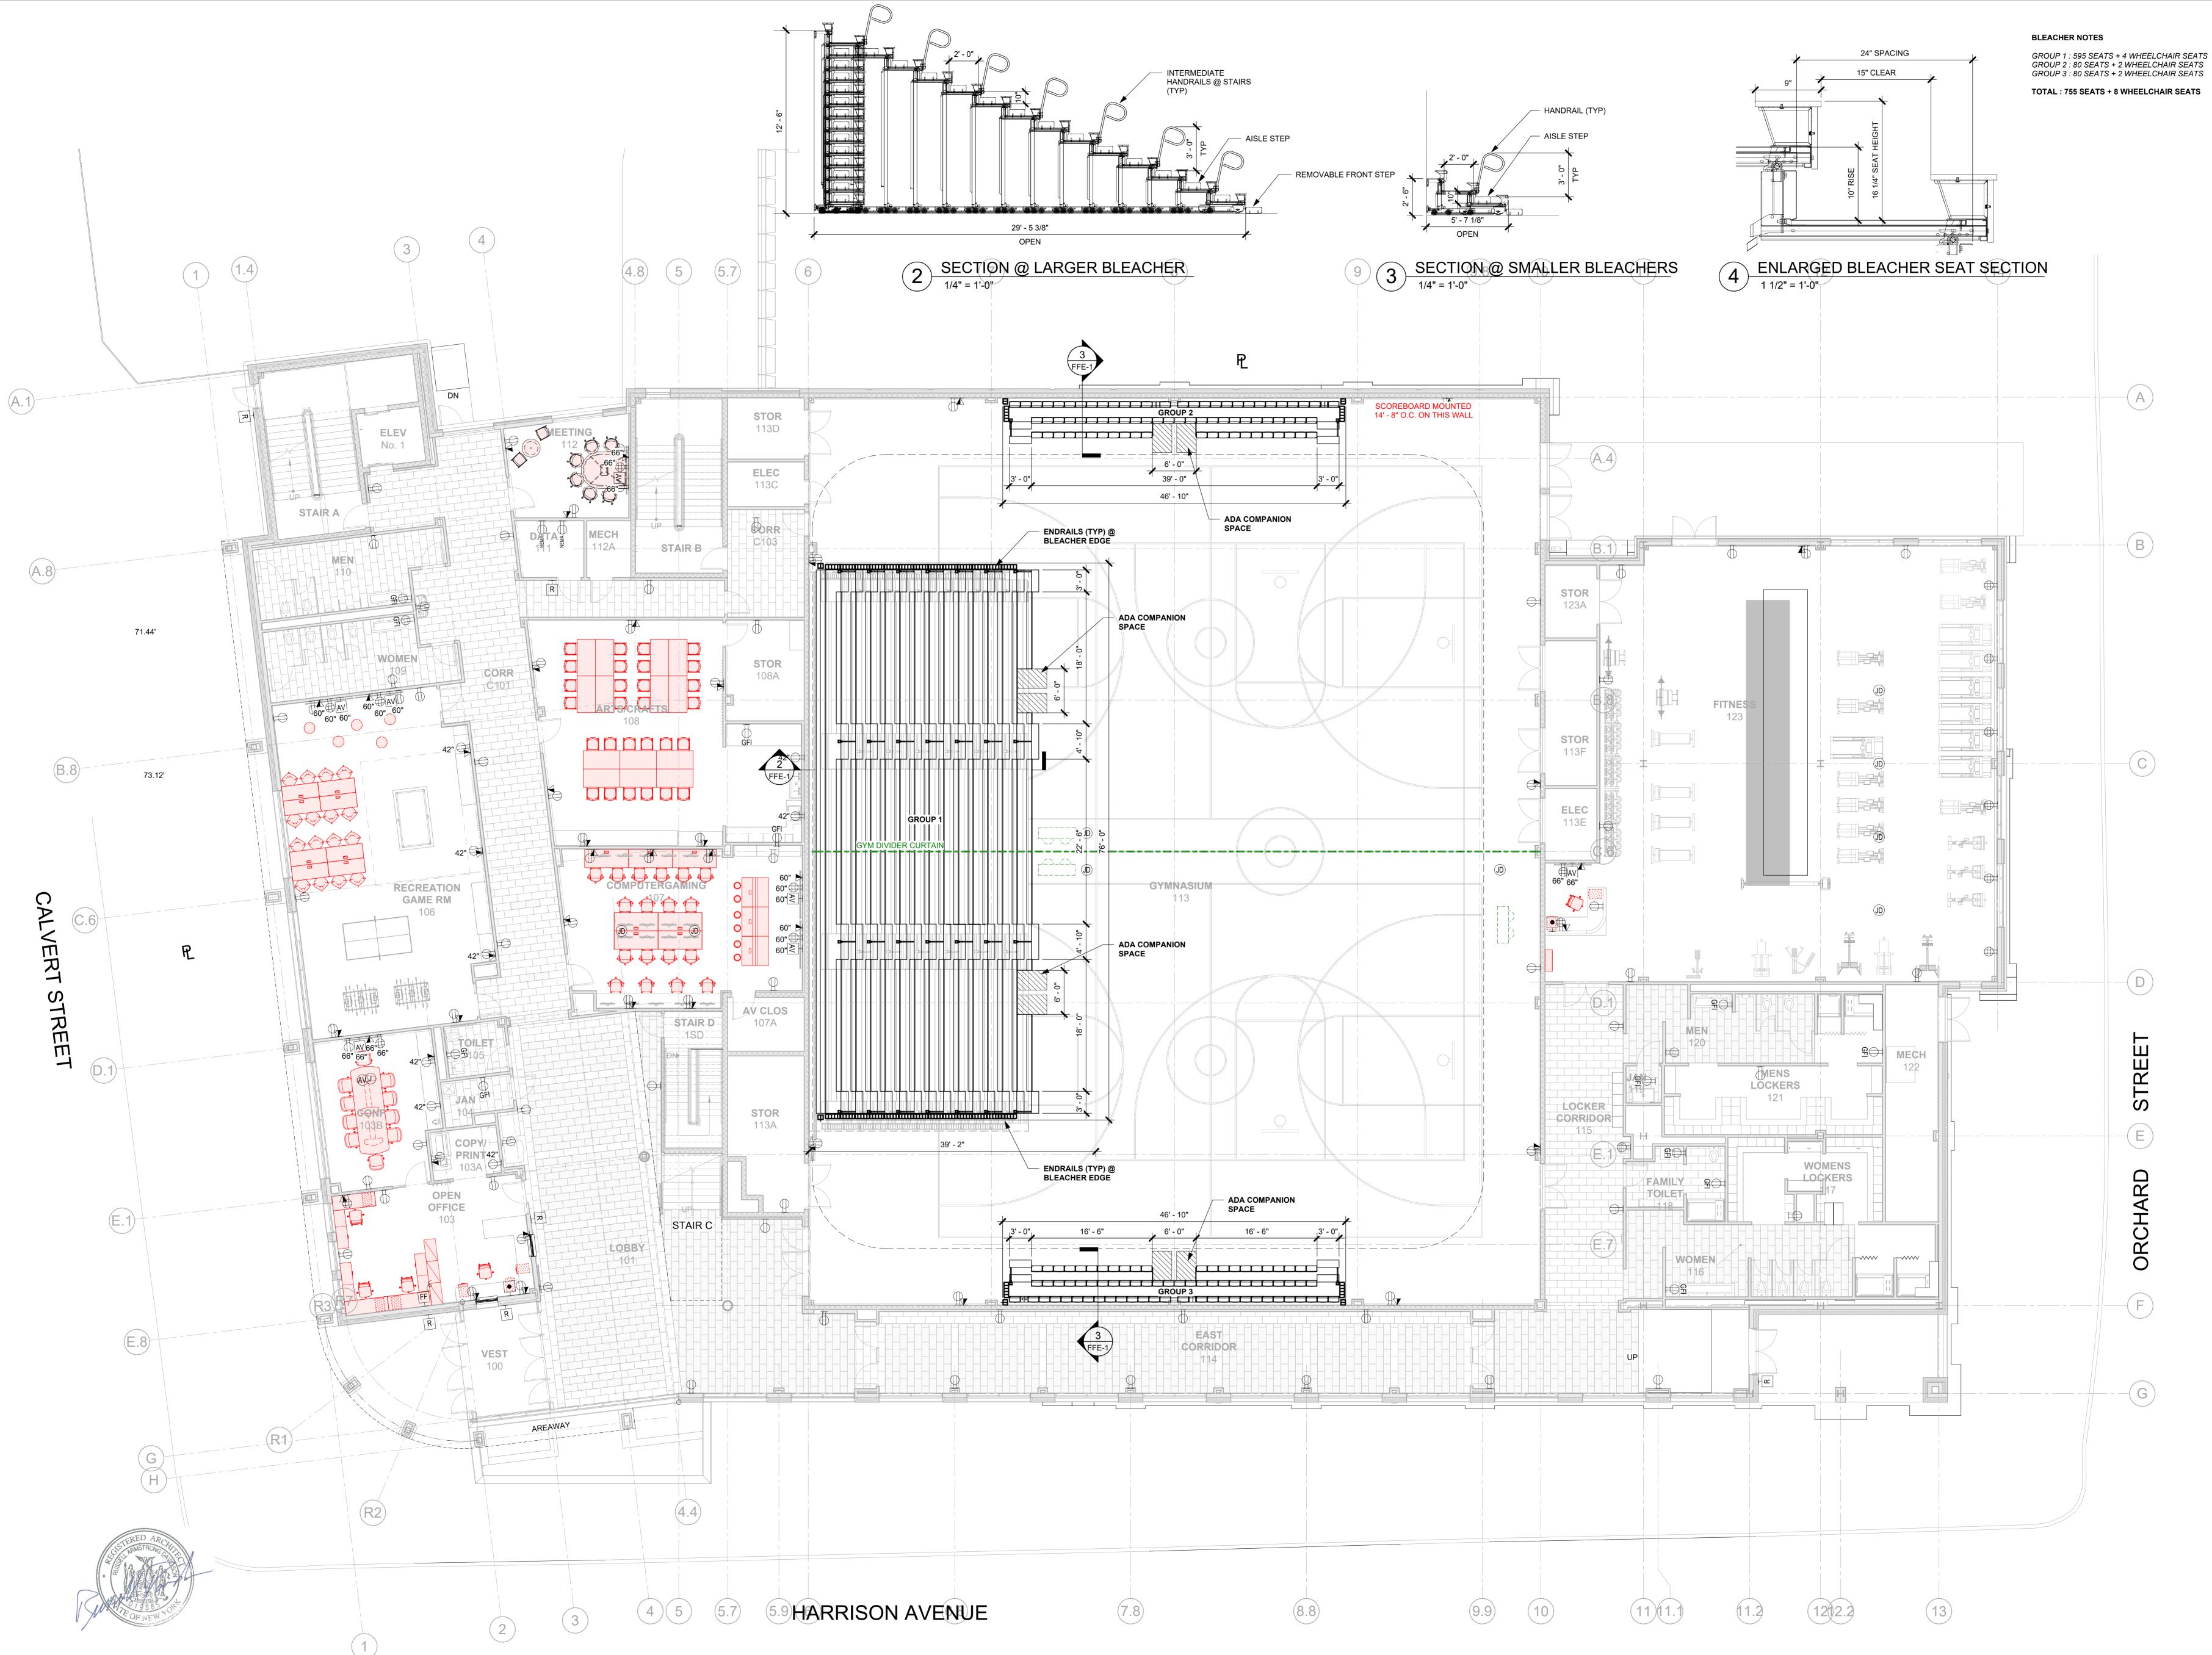

	SYMB	OLS		PL		CONNECTION		URE SCHEDULE
TAG	PLAN	ELEVATION	FIXTURES	WASTE	VENT	COLD WATER	HOT WATER	DESCRIPTION
P-1	0:0		WATER CLOSET WALL-MOUNT	4"	2"	11⁄4"	-	MANUFACTURER: AMERICAN STANDARD MODEL: AFWALL ELONGATED TOILET LESS EVERCLEAN 1.6 GPF FLUSH VALVE, WALL MOUNTED TOILET, WITH ELONGATED BOWL, VITREOUS CHINA, WITH EVERCLEAN. 1½" INLET SPUD, 2½" TRAPWAY, 10"x12" WATER SURFACE AREA. FLUSH VALVE: AMERICAN STANDARD SELECTRONIC #6065.161.002 BATTERY POWER (TOP SPUD) RECESSED WALL MOUNT TYPE PROVIDE WALL CARRIER
P-2			LAVATORY WALL HUNG	2"	2"	3/4"	3/4"	MANUFACTURER: SLOAN SOLID SURFACE 1-STATION WALL MOUNTED SINK MODEL: ELGR-81000 SLOANSTONE SOLID SURFACE. DOUBLE HOLE FAUCET; MODEL: REFER TO ARCHITECTURAL PLANS
P-2A			LAVATORY WALL HUNG	2"	2"	3/4"	3/4"	MANUFACTURER: SLOAN SOLID SURFACE 2-STATION WALL MOUNTED SINK MODEL: ELGR-82000 SLOANSTONE SOLID SURFACE. DOUBLE HOLE FAUCET; MODEL: REFER TO ARCHITECTURAL PLANS
P-2B			LAVATORY WALL HUNG	2"	2"	3/4"	3/4"	MANUFACTURER: SLOAN MODEL: ELGR-83000 SLOANSTONE SOLID SURFACE. TRIPLE HOLE FAUCET; MODEL: REFER TO ARCHITECTURAL PLANS
P-3			URINAL	3"	2"	3/4"	-	MANUFACTURER: AMERICAN STANDARD MODEL: 6002.001 TOP SPUD HIGH EFFICIENCY URINAL 0.125 GPF, VITREOUS CHINA, ¾" INLET SPUD, OUTLET CONNECTION 2" THREADED INSIDE. FLUSH VALVE: MODEL 6063013.002, 0.125 GPF EXPOSED TOP SPUD RECESSED WALL MOUNT TYPE S ELECTRONIC URINAL FLUSH VALVE. 20 PSI (FLOWING), 80 PSI (STATIC) OPERATING PRESSURE. 10 GPM FLOW REQUIREMENT PROVIDE WALL CARRIER
P-4			SHOWER (ADA)	3"	2"	3/4"	3/4"	MANUFACTURER: BEST BATH SYSTEMS MODEL: 4LSS24038A75FTB.V3* 38.25"x40.5"x80.5" SHOWER, FIBERGLASS NOTES: INSTALL IN ACCORDANCE WITH MANUFACTURER'S SPECIFICATIONS AND ADA GUIDELINES. PROVIDE MOEN HANDHELD KIT KACXMOAN1001 OR APPROVED EQUIVALENT.
P-4A			SHOWER (ADA)	3"	2"	3/4"	3/4"	MANUFACTURER: BEST BATH SYSTEMS MODEL: 4LSS26337A75FTB.V3* 38.5"x63"x80.5" SHOWER, FIBERGLASS NOTES: INSTALL IN ACCORDANCE WITH MANUFACTURER'S SPECIFICATIONS AND ADA GUIDELINES. PROVIDE MOEN HANDHELD KIT KACXMOAN1001 OR APPROVED EQUIVALENT.
P-5			ART ROOM SINK	2"	2"	3/4"	3/4"	MANUFACTURER: ELKAY MODEL: EWMA4820C 304 STAINLESS STEEL WALL HUNG MULTIPLE STATION HAND WASH SINK. INCLUDE SOLIDS INTERCEPTOR AT DRAIN.
P-6			SINK (ADA)	2"	2"	3/4"	3/4"	MANUFACTURER: ELKAY MODEL: LRAD221955 FAUCET; MAKE: ELKAY MODEL: LK406GN05T4 304 STAINLESS STEEL DROP IN ADA SINK. FAUCET SHALL BE BRASS MATERIAL, & DOUBLE HOLE WITH A FLOW RATE OF 1.5 GPM. INCLUDE SOLIDS INTERCEPTOR AT DRAIN.
P-7			JANITOR'S SINK	3"	2"	3/4"	3/4"	MANUFACTURER: ZURN MODEL: Z5850 FAUCET: ZURN SINK FAUCET Z843M1-XL ENAMELED CAST IRON CORNER FLOOR SINK WITH 28x28x8 BOWL, 3" DRAIN WITH DRAIN GRID
СМ			COFFEE MAKER	-	-	3/4"	-	MANUFACTURER: CURTIS MODEL: ALPHA G3 AUTOMATIC COFFEE BREWING SYSTEM SHALL BE ABLE TO BREW 12 GAL/HR ELECTRICAL: 120/1/60, 1800 WATTS, 15 AMPS
CM-1			COFFEE MAKER	-	-	3/4"	-	MANUFACTURER: KEURIG MODEL: KEURIG K-2500 PLUMBED COMMERCIAL COFFEE MAKER ELECTRICAL: 120/1/60, 1800 WATTS, 12 AMPS
IM	ICE	ICE	ICE MACHINE	ı	ı	3/4"	-	MANUFACTURER: AVANTCO ICE MACHINES MODEL: KMC-H-530-A 30" AIR COOLED MODULAR HALF CUBE ICE MACHINE WITH BIN - 500LB. ICE MAKER WITH BIN. SHALL BE ABLE TO PRODUCE 500 LBS/DAY AT 90°F. 350 LB BIN STORAGE CAPACITY. ELECTRICAL: 115/1/60, 9.4 AMPS
IM-1	ICE	ICE	ICE MACHINE	-	-	3/4"	-	MANUFACTURER: AVANTCO ICE MACHINES MODEL:UC-F-120-A-19" AIR COOLED UNDERCOUNTER FULL CUBE ICE MACHINE - 129LB. ICE MAKER WITH BIN. SHALL BE ABLE TO PRODUCE 129 LBS/DAY AT 90°F. 40 LB BIN STORAGE CAPACITY. ELECTRICAL: 115/1/60, 5 AMPS
DW			DISHWASHER	1- ³ ⁄ ₈ "	-	-	1/2"	MANUFACTURER: JACKSON WAREWASHING SYSTEMS MODEL: DISHSTAR HT-E UNDERCOUNTER DISHWASHER, HIGH TEMPERATURE SANITIZING. 27 RACKS PER HOUR CAPACITY, 100 SECOND CYCLE, BOTTOM MOUNTED CONTROLS WITH STAINLESS STEEL TOP AND SIDE PANELS, AND BUILT IN BOOSTEF HEATER. 180°F FINAL RINSE WATER. ELECTRICAL: 208/60/1
DF			DRINKING FOUNTAIN	2"	2"	3/4"	-	MANUFACTURER: ELKAY MODEL: LZSTL8WSLK ezH20 BOTTLE FILLING STATION AND BI-LEVEL ADA COOLER FILTERED REFRIGERATED LIGHT GRAY. 8.0 GPH OF 50°F DRINKING WATER BASED ON 80°F INLET WATER AND 90°F AMBIENT MODEM: V/P/Hz: 115/1/60, FLA=6
DF-1			DRINKING FOUNTAIN	2"	2"	3/4"	-	MANUFACTURER: ELKAY MODEL: LZS8WSLK exH20 BOTTLE FILLING STATION WITH SINGLE ADA COOLER FILTERED REFRIGERATED LIGH GRAY. 8.0 GPH OF 50°F DRINKING WATER BASED ON 80°F INLET WATER AND 90°F AMBIENT MODEM: V/P/Hz: 115/1/60, FLA=6
FD			FLOOR DRAIN	3"	2"	-	-	FLOOR DRAIN; MAKE: JR SMITH MODEL: 2110 MEDIUM DUTY DRAIN, 8.5" ROUND TOP, STRAINER. PROVIDE TRAP SEAL
FD-1			PARKING GARAGE FLOOR DRAIN	3"	2"	-	-	WADE #W-1210-27 WITH CAST IRON BODY, CAST IRON DRAINAGE FLANGE, SEDIMENT BUCKET, FLASHING COLLAR, 12" ROUND HEAVY DUTY CAST IRON GRATE. PROVIDE <u>TG-1</u> FOR EACH FD.
NFHB	1#5		NON FREEZE HOSE-BIB	-	-	-	-	HOSE BIB; MAKE: WOODFORD MODEL: 65 ANTI-SIPHON PROTECTED AUTOMATIC DRAINING FREEZELESS WALL HYDRANT WITH INTEGRAL VACUUM BREAKER
COPD	©		CLEANOUT DECK PLATE	-	-	-	-	FLOOR CLEANOUT WITH ADJUSTABLE HEAD, ANCHOR FLANGE, CUT-OF SECTIONS AND ROUND SCORIATED NICKEL-BRONZE TOP: WADE #W-6000 OR APPROVED EQUAL. PROVIDE HEAVY DUTY CAST IRON TOP FOR MECHANICAL ROOMS. CODP IN GARBAGE ROOM TO BE RATED FOR VEHICULAR TRAFFIC.
WCO	_	<u> </u>	WALL CLEANOUT	-	-	-	-	WALL CLEANOUT WITH CLEANOUT TEE AND CHROME PLATED BRONZE SQUARE ACCESS COVER AND FRAME. WADE #W-8480 OR APPROVED EQUAL.
RD-1			ROOF DRAIN	4"	2"	2	-	JOSAM 21500 4" SERIES COATED CAST IRON ROOF DRAIN. LARGE POLYPROPYLENE LOCKING DOME, WEJOC NON-PUNCTURING CLAMP RING WITH INTEGRAL GRAVEL STOP, LARGE SUMP WITH WIDE ROOF FLANGE AND BOTTOM OUTLET.
OD-1			ROOF DRAIN	4"	2"	2	-	JOSAM 21500 4" 16 SERIES COATED CAST IRON ROOF DRAIN. LARGE POLYPROPYLENE LOCKING DOME, WEJOC NON-PUNCTURING CLAMP RING WITH INTEGRAL GRAVEL STOP, INTERNAL WATER GUARD FOR OVERFLOW, LARGE SUMP WITH WIDE ROOF FLANGE AND BOTTOM OUTLET.

SYMBOL	ABBREVIATION	DESCRIPTION
_	AFF	ABOVE FINISHED FLOOR
_	AHC	ABOVE HUNG CEILING
_	BFP	BACK FLOW PREVENTOR
Ī	_	BALL VALVE
\bigcup	_	BASKET STRAINER
L Ø1	_	BUTTERFLY VALVE
<u>*</u>	_	CHECK VALVE
©	_	CIRCUIT SETTER
	CODP	CLEAN OUT DECK PLATE
_	CW	COLD WATER
	_	CONCENTRIC REDUCER
_	DCV	DOUBLE CHECK VALVE - BFP
	_	ECCENTRIC REDUCER
C	_	ELBOW DOWN
	_	ELBOW UP
_	DEM.	EXISTING TO BE REMOVED
_	EX.	EXISTING TO REMAIN
	_	FLEXIBLE CONNECTION
	FCO	FLOOR CLEAN OUT
_	FS	FLOOR SINK
	_	FLOW ARROW
	FAI	FRESH AIR INTAKE
	- FAI	GATE VALVE
	_	
	1.04/	GLOBE VALVE
-	HW	HOT WATER LIFATER
_	HW HTR	HOT WATER REGIDALITATION
	HWC	HOT WATER RECIRCULATION
_	LDR	LEADER
	_	MANUAL AIR VENT
_	NEW	NEW WORK
<u> </u>	_	OS&Y GATE VALVE
<u> </u>	_	PLUG VALVE
	_	PIPE CAP
2	_	PRESSURE GAGE
<u> </u>	_	PRESSURE REDUCING VALVE
•	_	PUMP
_	PD	PUMP DISCHARGE
_	RPZ	REDUCED PRESSURE ZONE - BFP
_	REL.	REMOVE AND RELOCATE
_	S	SANITARY
<u>\$</u>	_	SOLENOID VALVE
	_	STRAINER
_	SD	STORM DRAINAGE
\Box	_	TEE DOWN
0	_	TEE UP
<u> </u>	_	THERMOMETER
_	TYP.	TYPICAL
Z.	_	T&P RELIEF VALVE
	_	UNION
_	V	VENT
	VTD	VENT THROUGH ROOF
_	VTR	VENT TIMOGGITHOOF

NOTE: FOR REFERENCE ONLY. NOT ALL SYMBOLS OR ABBREVIATIONS ARE USED IN THIS

1. ALL PIPING BURIED BELOW THE GARAGE SLAB SHALL BE HIGH PERFORMANCE HUB & SPIGOT SERVICE WEIGHT CAST IRON CHARLOTTE PIPE "EDGE HP IRON" ATSM A74, CISPI TM/NSF, EN 877 COMPRESSION GASKETS ASTM C564 OR LEAD & OAKUM. REFER TO SPECIFICATIONS 221316

GENERAL NOTES

PLUMBING MATERIALS

- THE CONTRACT DRAWINGS INDICATE THE EXTENT AND GENERAL ARRANGEMENTS OF THE PLUMBING SYSTEMS. IF ANY DEPARTURES FROM THE DRAWINGS ARE DEEMED NECESSARY BY THE PLUMBING CONTRACTOR, DETAILS OF SUCH DEPARTURES AND THE REASONS THEREFORE SHALL BE SUBMITTED TO THE OWNER AND ENGINEER FOR APPROVAL. NO SUCH DEPARTURES SHALL BE MADE WITHOUT PRIOR WRITTEN APPROVAL OF THE OWNER AND ENGINEER. EQUIPMENT AND PIPING ARRANGEMENTS SHALL PROVIDE ADEQUATE AND ACCEPTABLE CLEARANCES FOR ENTRY, SERVICING, AND MAINTENANCE. ANY CHANGES TO PIPING AND EQUIPMENT LOCATIONS NECESSARY TO AVOID INTERFERENCE WITH OTHER TRADES SHALL BE MADE AT NO EXTRA COST.
- 2. THE PLUMBING WORK SHALL BE PERFORMED IN STRICT ACCORDANCE WITH THE LATEST EDITION OF THE PREVAILING NEW YORK STATE PLUMBING AND BUILDING CODES. IN CASE OF CONFLICT BETWEEN THE CONTRACT DOCUMENTS AND A GOVERNING CODE OR ORDINANCE, THE MORE STRINGENT STANDARD SHALL
- 3. THE PLUMBING CONTRACTOR SHALL BE RESPONSIBLE FOR OBTAINING ALL NECESSARY PERMITS AND FOR PAYING RELATED FEES.
- 4. CONNECTIONS TO EXISTING UTILITIES AND SERVICES ARE SHOWN ACCORDING TO THE BEST INFORMATION AVAILABLE. THE CONTRACTOR SHALL VERIFY THE EXACT LOCATIONS, INVERT ELEVATIONS, AND SIZES OF EXISTING PLUMBING SERVICES IN FIELD, AND SHALL CONNECT NEW PLUMBING SERVICES AS INDICATED ON DRAWINGS.
- 5. PRIOR TO FABRICATION, THIS CONTRACTOR SHALL VERIFY ALL MEASUREMENTS AND CONDITIONS ON JOB SITE. AND COORDINATE THIS WORK WITH THE WORK OF ALL OTHER TRADES.
- 6. ALL ACCESS PANELS SHALL BE BY GENERAL CONTRACTOR. THE PLUMBING CONTRACTOR SHALL BE RESPONSIBLE FOR THEIR LOCATION.

GENERAL NOTES

- 7. PROVIDE ALL PLUMBING FIXTURES, PIPING, VALVES AND ACCESSORY ITEMS AS SPECIFIED AND AS REQUIRED FOR A COMPLETE INSTALLATION. ROUGHING DIMENSIONS OF FIXTURES MUST BE COORDINATED WITH THE GENERAL CONTRACTOR.
- 8. PITCH ALL WASTE, SANITARY, AND STORM DRAIN PIPING AT MAXIMUM SLOPE POSSIBLE, BUT NOT LESS THAN 1/8" PER FOOT FOR PIPING \geq 3" AND 1/4" PER FOOT FOR PIPING \leq 2\(\frac{1}{2}\)".
- 9. NO PIPING SHALL RUN EXPOSED IN FINISHED AREAS.
- PROVIDE DIELECTRIC FITTINGS OR COUPLINGS WHEREVER DISSIMILAR METALS ARE JOINED.
- 11. PROVIDE SHUTOFF VALVES AT ALL FIXTURES AND EQUIPMENT ON COLD WATER, AND HOT WATER PIPES.
- 12. ALL WORK SHALL BE PROPERLY TESTED, BALANCED, AND CLEANED AND DISINFECTED. PROVIDE A ONE YEAR WARRANTY FROM DATE OF FINAL INSPECTION ON ALL PARTS AND LABOR.
- 13. PROVIDE ALL PIPE OPENINGS THROUGH PARTITIONS WITH PIPE SLEEVES. FOR PIPES PENETRATING FIRE RATED PARTITIONS, THE SPACE BETWEEN THE PIPE AND THE SLEEVE SHALL BE SEALED WITH FIRE STOPPING MATERIAL. PENETRATIONS FOR PIPING SHALL BE MADE BY CORE DRILLING WHENEVER POSSIBLE
- 14. PROVIDE TRAP SEAL PRIMERS FOR FLOOR DRAINS AS REQUIRED. INSTALL THE PRIMER VALVE IN THE COLD WATER SERVICE, WITH THE TRAP CONNECTION PIPED TO THE FLOOR DRAIN TRAP. LOCATE THE VALVE IN AN ACCESSIBLE LOCATION.
- 15. THE PLUMBING CONTRACTOR SHALL PROVIDE ALL CUTTING, PATCHING, CORE DRILLING, PAINTING, ACCESS PANELS. AND FINAL RESTORATION REQUIRED TO FACILITATE THE INSTALLATION OF PLUMBING PIPING. INCLUDING ABOVE CEILINGS AND IN SHAFTS THAT WILL NOT BE REPLACED OR OPENED UNDER ANY OTHER SCOPE OF WORK RELATED TO THIS PROJECT. CONTRACTOR TO REMOVE AND REPLACE CEILINGS, AND OPEN AND PATCH SHAFTS AND WALLS, AS REQUIRED TO EXECUTE THE PLUMBING WORK.
- 16. SEE THE ARCHITECTURAL DRAWINGS FOR EXACT PHASING AND TIME SCHEDULE FOR CONSTRUCTION.
- 17. ALL MOTOR STARTERS AND DISCONNECT SWITCHES FOR PLUMBING EQUIPMENT SHALL BE FURNISHED BY THE PLUMBING CONTRACTOR AND INSTALLED BY THE ELECTRICAL CONTRACTOR, UNLESS OTHERWISE NOTED. DISCONNECT SWITCHES FURNISHED BY THE PLUMBING CONTRACTOR FOR PLUMBING EQUIPMENT SHALL BE HEAVY DUTY TYPE.
- 18. THE CONTRACTOR SHALL BE RESPONSIBLE FOR PROVIDING TEMPORARY VENTILATION AND EXHAUST AIR WHEN WELDING OR SOLDERING OPERATIONS ARE PERFORMED, AS REQUIRED BY OSHA.

EQUIPMENT NOTES

- 1. NATURAL GAS-FIRED DOMESTIC HOT WATER HEATER, (HWH-1): SHALL BE BASED ON AO SMITH MODEL BTH-120 MXI, RATED FOR 138 GPH @ 100° RISE, GAS FIRED. 120,000 BTUH INPUT CAPACITY. THERMAL EFFICIENCY = 98%
- 2. NATURAL GAS-FIRED DOMESTIC HOT WATER HEATER, (HWH-2): SHALL BE BASED ON AO SMITH MODEL BTH-150 MXI, RATED FOR 178 GPH @ 100° RISE, GAS FIRED. 150,000 BTUH INPUT CAPACITY. THERMAL EFFICIENCY = 98%
- 3. NATURAL GAS-FIRED DOMESTIC HOT WATER HEATER, (HWH-3): SHALL BE BASED ON AO SMITH MODEL BTH-120 MXI, RATED FOR 138 GPH @ 100° RISE, GAS FIRED. 120,000 BTUH INPUT CAPACITY. THERMAL EFFICIENCY = 98%
- 4. ELEVATOR SUMP PUMP, (ESP-1), TO BE BASED ON STANCOR MODEL SE50 PUMP, 0.5 HP, 115V-1 PHASE-60 HERTZ, 8 FLA, 55 GPM @ 20 FEET HEAD AND 3450 RPM, 40A LOCKED ROTOR AMPS, 33 FEET MAX. SUBMERGENCE. PROVIDE STANCOR CHECK VALVE WITH EACH PUMP. PROVIDE OIL MINDER CONTROL SYSTEM FOR EACH PUMP WITH BUILT IN AUDIBLE AND VISUAL ALARM WHEN PUMP DOES NOT RUN DUE TO OIL IN PIT OR HIGH LIQUID ALARM. PROVIDE SILENCING BUTTON FOR AUDIBLE ALARM BUILT INTO PANEL. PANEL SHALL HAVE ADDITIONAL CONTACT FOR A REMOTE ALARM LOCATION. PROVIDE JUNCTION BOX WITH MULTI PIN CONNECTOR AND CORD LENGTHS AS REQUIRED. PANEL TO HAVE INDICATOR LIGHTS FOR OIL SPILL, HIGH LIQUID LEVEL, OVERLOAD AND PUMP RUN. CONTROL PANEL ENCLOSURE TO BE NEMA4X WATERTIGHT CORROSION RESISTANT FIBERGLASS.
- 5. SUMP PUMP, (SP-1) AND (SP-2), TO BE BASED ON STANCOR MODEL SV500 PUMP, 5 HP, 208V-3 PHASE-60 HERTZ, 16.6 FLA, 210 GPM @ 35 FEET HEAD AND 3450 RPM, 83A LOCKED ROTOR AMPS, 33 FEET MAX. SUBMERGENCE. PROVIDE STANCOR CHECK VALVE WITH EACH PUMP. PROVIDE OIL MINDER CONTROL SYSTEM FOR EACH PUMP WITH BUILT IN AUDIBLE AND VISUAL ALARM WHEN PUMP DOES NOT RUN DUE TO OIL IN PIT OR HIGH LIQUID ALARM. PROVIDE SILENCING BUTTON FOR AUDIBLE ALARM BUILT INTO PANEL. PANEL SHALL HAVE ADDITIONAL CONTACT FOR A REMOTE ALARM LOCATION. PROVIDE JUNCTION BOX WITH MULTI PIN CONNECTOR AND CORD LENGTHS AS REQUIRED. PANEL TO HAVE INDICATOR LIGHTS FOR OIL SPILL, HIGH LIQUID LEVEL, OVERLOAD AND PUMP RUN. CONTROL PANEL ENCLOSURE TO BE NEMA4X WATERTIGHT CORROSION RESISTANT FIBERGLASS.
- 6. LD-1 SPOT TYPE LEAK DETECTORS SHALL BE LIEBERT MODEL LT-410. PROVIDE 100 WATT LOW-VOLTAGE TRANSFORMER. PROVIDE CONNECTION TO BMS FOR LD ALARM.
- 7. DOMESTIC HOT WATER HEATER RECIRCULATION PUMP, (HWCP-1): SHALL BE BASED ON BELL AND GOSSETT MODEL PL-55 RATED FOR 1- GPM AT 40' TDH, 2/5 HP, 120V/1Ø/60HZ. MOTOR STARTERS AND DISCONNECT SWITCHES SHALL BE FURNISHED BY THE PLUMBING CONTRACTOR AND INSTALLED BY THE ELECTRICAL CONTRACTOR.
- 8. 3" DOMESTIC WATER BACKFLOW PREVENTION ASSEMBLY: SHALL BE WATTS MODEL LF009 LEAD FREE REDUCED PRESSURE ZONE BACKFLOW PREVENTER. ASSEMBLY SHALL BE SUITABLE FOR PRESSURES UP TO 175 PSI AND TEMPERATURES UP TO 110°F. THE ASSEMBLY SHALL INCLUDE TWO RESILIENT OS&Y SEATED SHUTOFF VALVES AND FOUR BALL TYPE TEST COCKS. THE 3" DOMESTIC WATER BACKFLOW PREVENTER SHALL BE PROVIDED WITH WATTS AIR GAP / SPLASH GUARD.
- 9. 6" FIRE PROTECTION BACKFLOW PREVENTION ASSEMBLY: SHALL BE WATTS SERIES 709DCDA DOUBLE CHECK DETECTOR ASSEMBLY BACKFLOW PREVENTER. ASSEMBLY SHALL BE SUITABLE FOR PRESSURES UP TO 175 PSI AND TEMPERATURES UP TO 110°F. THE ASSEMBLY SHALL INCLUDE TWO RESILIENT OS&Y SEATED SHUTOFF VALVES AND TWO BALL TYPE TEST COCKS.
- 10. WATER METER: SHALL BE BASED ON ELSTER EVOQ4 METER, 3" SIZE. FINAL WATER METER AND SIZE, MODEL, AND DIMENSIONS SHALL BE DETERMINED AND APPROVED BY THE WATER UTILITY. THE PLUMBING CONTRACTOR IS RESPONSIBLE FOR COORDINATION AND INSTALLATION, AND ALL RELATED WATER DEPARTMENT FEES.
- 11. ALL DOMESTIC, SANITARY, AND STORM PIPING ROUTED EXPOSED WITHIN GARAGE SHALL BE HEAT TRACED COMPLETE, INCLUDING A MINIMUM OF 5'-0" INTO THE TEMPERED SPACES. PIPING SHALL BE INSULATED
- COMPLETE AND WRAPPED WITH PVC JACKETING. 12. COORDINATE WITH ARCHITECTURAL DRAWINGS FOR FINAL LOCATION, TYPE, AND QUANTITY OF FIXTURES AND ROOF DRAINS THROUGHOUT THE BUILDING.
- 13. COORDINATE WITH SITE ENGINEER DRAWINGS FOR FINAL LOCATION, TYPE, AND QUANTITY OF ROADWAY
- 14. ALL PIPING INCLUDING HANGERS/SUPPORTS WITHIN THE GARAGE SHALL BE ROUTED AS HIGH AS POSSIBLE TO MAINTAIN VEHICLE CLEARANCE THROUGHOUT. REFER TO ARCHITECTURAL DRAWINGS FOR MINIMUM
- ELEVATIONS. 15. THE PLUMBING CONTRACTOR SHALL SUBMIT FOR REVIEW A COMPOSITE SHOP DRAWING, FULLY COORDINATED WITH ALL OTHER TRADES. INDICATING EQUIPMENT. DUCTWORK. PLUMBING AND SPRINKLER PIPING, SMOKE DETECTORS, LIGHTS, CONDUITS, SMOKE DETECTORS, DIFFUSERS, GRILLES, AND ALL RCP
- 16. PROVIDE TRAP AND VALVE GUARDS AT ALL LAVATORIES WITH EXPOSED PIPING SIMILAR TO TRUEBRO

ELEMENTS, ETC.

P-TRAP AND TWO (2) VALVE COVERS WITH VINYL COVER.

17. GAS BOOSTER PUMP (GMP-1): SHALL BE ACCARDI COMPAC HB4615-1. SYSTEM SHALL BE A PACKAGE HERMETICALLY SEALED SYSTEM THAT INCLUDES AUTO FLOW CONTROL, INTEGRAL VFD, NEMA 4 PANEL, NEMA 4 LOW PRESSURE SWITCH, INLET AND OUTLET ISOLATION VALVES, FLEXIBLE CONNECTIONS, INLET AND OUTLET PRESSURE GAUGES, AND CHECK VALVE. SYSTEM SHALL BE CAPABLE OF OF DELIVERING A VARIABLE VOLUME OF NATURAL GAS OF 1,370 CFH WHILE PROVIDING A CONSTANT ELEVATED DIFFERENTIAL GAS PRESSURE OF 11" WC.

HARRISON **RECREATION &** COMMUNITY **CENTER**

New Construction - Phase 2

Town / Village of Harrison

270 Harrison Avenue

Harrison, NY 10528

KG+D ARCHITECTS, PC KGDARCHITECTS.COM

OLA Consulting Engineers 00 Summit Lake Drive, Suite 102 /alhalla, NY 10595 W. 38th St, Suite 900, New York, NY 10018 646-849-4110


ewyorkcity@olace.com

CONSTRUCTION DOCUMENTS

NOTE: ALL IDEAS DESIGNS ARRANGEMENTS AND PLANS INDICATED OR REPRESENTED BY THIS DRAWING ARE OWNED BY AND ARE THE PROPERTY OF S+D ARCHITECTS, PC (KG+D), AND WERE CREATED FOR USE ON THIS PROJECT, NONE OF SUCH IDEAS, DESIGNS, ARRANGEMENTS OR PLANS SHALL BE USED BY OR DISCLOSED TO ANY PURPOSE WHATSOEVER WITHOUT THE

VRITTEN PERMISSION OF KG+D. WRITTEN DIMENSIONS ON THIS DRAWING SHALL HAVE PRECEDENCE OVER SCALED DIMENSIONS, CONTRACTOR SHALL VERIFY ALL ACTUAL DIMENSIONS AND CONDITIONS ON THE JOB AND THE ARCHITECT MUST BE NOTIFIED OF ANY VARIATIONS FROM DIMENSIONS AND CONDITIONS SHOWN. SHOP DETAILS MUST BE SUBMITTED TO THIS OFFICE FOR APPROVAL BEFORE PROCEEDING WITH

ALTERATIONS BY ANY PERSON. IN ANY WAY, OF ANY ITEM CONTAINED ON THIS OCUMENT, UNLESS ACTING UNDER THE DIRECTION OF THE LICENCED RCHITECT WHOSE PROFESSIONAL SEAL IS AFFIXED HERETO, IS A VIOLATION OF TITLE VII, SECT. 69.5 (b) OF NEW YORK STATE LAW.

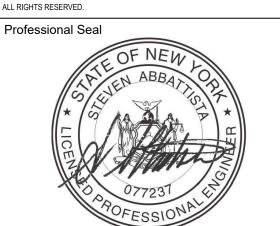

12/13/2024 PERMIT ADDENDUM 10/09/2024 ISSUED FOR CONSTRUCTION 10/09/2024 | CONFORMED SET

06/05/2024 ISSUED FOR BID 01/16/2024 ISSUED FOR PERMIT 06/01/2020 DESIGN DEVELOPMENT 1 03/31/2020 50% DESIGN DEVELOPMENT No. Date

Sheet Title

PLUMBING SYMBOLS, ABBREVIATIONS, & NOTES

NKGD0207.00 03/01/2024 Drawn / Checked AS NOTED HM / RG

Sheet Number P-001

RETURN REGISTER / TRANSFER GRILLE							
	SCHED	ULE					
DESIGNATION	RG-1 / TG	G-1 / EG-1	RG-2				
MODEL	3 F	S	56	FL			
MAX NK VEL (FT/MIN)	50	00	-				
MAX NC	2	5	-				
CONSTRUCTION	ALUM	INUM	ALUM	INUM			
BORDER/FRAME	SURFACE	MOUNTED	SURFACE MOUNTED				
DEFLECTION	45° F	IXED	0° FIXED				
SPACING	3/-	4"	3/4"				
	CFM RANGE	NOMINAL NECK SIZE	CFM RANGE	NOMINAL NECK SIZE			
	0-150	8x8	0 - 10,500	48x48			
	151-250	10x10					
	251-350	12x12					
	351-725	18x18					
	726-950	22x22					
	951-1100	24x24					
	1101-1400	24x30					

CORE AREA.

COORDINATE.

I. RETURN REGISTERS ARE BASED ON TITUS.

- 2. THE ABOVE SCHEDULE INDICATES NOMINAL REGISTER NECK SIZES. THE CONTRACTOR SHALL COORDINATE THE REGISTER SIZE IN THE FIELD ACCORDING TO THE ACTUAL DUCT DIMENSIONS AND MAINTAIN AN EQUIVALENT
- 3. ALL REGISTERS SHALL BE EQUIPPED WITH AN OPPOSED BLADE VOLUME DAMPER.
- 4. SUBMIT COLOR CHART FOR REVIEW AND APPROVAL BY ARCHITECT. 5. RETURN REGISTERS SHALL HAVE FRAMES AND BORDERS SUITABLE FOR THE CONSTRUCTION IN WHICH THEY WILL BE INSTALLED. CONTRACTOR TO

_							
	S	SUPPLY	/ REGIS	TER S	CHEDUL	-E	
	DESIGNATION	S	R-1	SI	R-2	SR-3	
	MODEL	30	0RL	S30	00FS	Γ	DL
	MAX NK VEL (FT/MIN)	5	50	5	50	5	50
	MAX NC	2	25	2	25	2	25
	CONSTRUCTION	ALUN	ЛINUM	ALUN	ЛINUM	ALUMINUM	
	BORDER/FRAME	SURFACE	MOUNTED	SURFACE MOUNTED DOUBLE 22.5°		SURFACE MOUNTED	
	DEFLECTION	DOL	JBLE				
	SPACING	3.	/4"	3/4"		-	
		CFM RANGE	NOMINAL NECK SIZE	CFM RANGE	NOMINAL NECK SIZE	CFM RANGE	NOMINAL NECK SIZE
		0-200	8x8	0-170	14x6	800-1000	36x8
		201-300	10x10				
		301-500	12x12				
		501-850	16x16				
		851-1100	18x18				
		1101-1700	22x22				
		1701-2000	24x24				

1. SUPPLY REGISTERS BASED ON TITUS.

- 2. THE ABOVE SCHEDULE INDICATES NOMINAL REGISTER NECK SIZES. THE CONTRACTOR SHALL COORDINATE THE REGISTER SIZE IN THE FIELD ACCORDING TO THE ACTUAL DUCT DIMENSIONS AND MAINTAIN EQUIVALENT CORE AREA.
- 3. ALL REGISTERS SHALL BE EQUIPPED WITH AN OPPOSED BLADE VOLUME DAMPER. 4. SUBMIT COLOR CHART FOR REVIEW AND APPROVAL BY ARCHITECT.
- 5. SUPPLY REGISTERS SHALL HAVE FRAMES AND BORDERS SUITABLE FOR THE CONSTRUCTION IN WHICH THEY WILL BE INSTALLED, CONTRACTOR TO COORDINATE. 6. SR-2 AND SR-3 SHALL BE PROVIDED WITH AIR SCOOP DEVICE.

CEILING DIFFU	SER SCI	HEDULE		
DESIGNATION	C	D-1	1	INDOOR/OUTDO
MODEL	0	MNI	1	MANUFACTURE
MAX CORE VEL (FT/MIN)		550	1	NOMINAL COOL
MAX NC		25	1	NOMINAL COOL
CONSTRUCTION	S1	EEL	1	NOMINAL HEAT
FRAME	LA	Y-IN]	NOMINAL HEAT
DEFLECTION	4 \	WAY		SEER/EER
FACE SIZE	24	1x24	<mark>/9\</mark>	HPSF
	CFM RANGE	NOMINAL NECK SIZE		RS PIPE SIZE (II
	0-100	6"	1	RL PIPE SIZE (IN
	101-200	8"	1	CONDENSATE [
	201-350	10"	1	ELECTRICAL DA
	351-450	12"	1	VOLTS/Ø/Hz
	451-600	14"	1	BREAKER SIZE
	601-700	15"	1	INDOOR EVAPO
NOTES:			1	LOCATION
1. CEILING SUPPLY DIFFUSE				MODEL
2. ALL DIFFUSERS SHALL BE OPPOSED BLADE VOLUME I		ITH AN		HEIGHT x WIDTI
3. COORDINATE COLOR SEL	ECTION WITH			WEIGHT (LBS)
4. SUPPLY DIFFUSERS SHAP				IYPE ~~~
BORDERS SUITABLE FOR TI WHICH THEY WILL BE INSTA				SUPPLY FAN AI

	601-700	15"
NOTES:		
1. CEILING SUPPLY DIFFUSER	RS ARE BASED	ON TITUS.
2. ALL DIFFUSERS SHALL BE I	EQUIPPED WI	TH AN
OPPOSED BLADE VOLUME DA		
3. COORDINATE COLOR SELE	CTION WITH	ARCH PLANS
4. SUPPLY DIFFUSERS SHALL	. HAVE FRAME	ES AND
BORDERS SUITABLE FOR THE	E CONSTRUC [*]	ΓΙΟΝ IN
WHICH THEY WILL BE INSTAL	LED, CONTRA	CTOR TO
COORDINATE.		
5. ALL LAY-IN DIFFUSERS SHA	ALL HAVE A M	ODULE SIZE
OF 24x24. FACE SIZES SHOW!	N IN SCHEDUI	LE ARE FOR
SURFACE MOUNT DIFFUSERS	S. NECK SIZES	S VARY
ACCORDING TO THE SCHEDU	JLE.	
6. DIFFUSER BLOW PATTERN	IS AS SHOWN	NON
DRAWINGS.		

DESIGNATION	WCHP-1	WCHP-2	WCHP-3	WCHP-4	WCHP-5
DESCRIPTION	HEAT RECOVERY	HEAT RECOVERY	HEAT RECOVERY	HEAT RECOVERY	HEAT RECOVERY
RATED COOLING CAPACITY	<u>'</u>				
BTUH/HR	168,000	168,000	239,000	264,000	264,000
EWT (°F)	85	85	85	85	85
LWT (°F)	94.2	94.2	94.8	95.1	94
GPM	45.7	45.7	60.8	65.9	65.9
RATED HEATING CAPACITY					
BTUH/HR	189,000	189,000	269,000	297,000	297,000
EWT (°F)	45	45	45	45	45
LWT (°F)	38.3	38.3	37.7	36.4	37.9
GPM	45.7	45.7	60.8	65.9	65.9
REFRIGERANT CHARGE					
TOTAL CHARGE (LBS)	30.6	30.6	40.8	47.6	42.9
FACTORY CHARGE (LBS)	15.4	15.4	15.4	15.4	15.4
ADDITIONAL REFRIGERANT (LBS)	15.2	15.2	25.4	32.2	27.5
ELECTRICAL DATA:					
VOLTS / Ø / Hz	208/3/60	208/3/60	208/3/60	208/3/60	208/3/60
MCA (MODULE 1 / MODULE 2)	13.8/19.4	13.8/19.4	27.7/27.7	27.7/32.7	27.7/32.7
MOCP (MODULE 1 / MODULE 2)	20/30	20/30	45/45	45/50	45/50
PHYSICAL:					
TONS	14	14	20	22	22
WEIGHT (LBS) (MODULE 1 / MODULE 2)	322/322	322/322	322/322	322/322	322/322
DIMENSIONS (WxHxD) (IN) (MODULE 1 / MODULE 2)	30.5 x 44.25 x 21.5 / 30.5 x 44.25 x 21.5	30.5 x 44.25 x 21.5 / 30.5 x 44.25 x 21.5	30.5 x 44.25 x 21.5 / 30.5 x 44.25 x 21.5	30.5 x 44.25 x 21.5 / 30.5 x 44.25 x 21.5	30.5 x 44.25 x 21.5 / 30.5 x 44.25 x 21.
PERFORMANCE:					
COOLING (BTU/H/W)	15.6	15.6	15.6	16	15.4
HEATING (BTU/H/W)	15.3	15.3	15.5	16.3	14.2
BASIS OF DESIGN	ARWM168BAS5	ARWM168BAS5	ARWM240BAS5	ARWM264BAS5	ARWM264BAS5

1. UNITS BASED ON LG.

PROVIDE RUBBER VIBRATION ISOLATION FOR EACH UNIT. B. WARRANTY SHALL BE 10 YEARS PARTS AND 10 YEARS ON THE COMPRESSORS.

4. CONTRACTOR SHALL HIRE THE MANUFACTURER'S INSTALLATION TECHNICIAN FOR INSTALLATION AND STARTUP. PROVIDE STARTUP REPORTS TO THE ENGINEER FOR REVIEW AND APPROVAL. 5. PROVIDE ALL UNITS WITH RATED DISCONNECT SWITCH.

. UNITS BASED ON LG.

208/1/60 1.5

7.2

2. PROVIDE DISCONNECT SWITCH.

ELECTRONIC EXPANSION VALVE KIT

DESIGNATION	EEV-R-5, EEV-R-6	EEV-B-1, EEV-1-1, EEV-R-1, EEV-R-2, EEV-R-3, EEV-R-4
QUANTITY	2	6
MAX AH CAPACITY (MBH)	96	192
WEIGHT (LBS)	6.8	6.8
DIMENSIONS (WxHxD)	8.75 x 16 x 3.5	8.75 x 16 x 3.5
ELECTRICAL DATA:		
VOLTS / Ø / Hz	208/1/60	208/1/60
AMPS	0.1	0.1
BASIS OF DESIGN	PRLK048A0	PRLK096A0
NOTES:		

. UNITS BASED ON LG.

2. CONTRACTOR TO MAINTAIN A MAXIMUM DISTANCE OF 10 FEET BETWEEN EEV AND COMM

VOLTS/Ø/Hz

VARIABLE REFRIGERANT FLOW - ZONE HEAT RECOVERY UNIT SCHEDULE

DESIGNATION	HRU-2-1, HRU-2-2, HRU-2-4	HRU-B-1, HRU-1-1, HRU-2-3, HRU-2-5, HRU-2-6	HRU-1-2	
NUMBER OF PORTS	3	2	6	
QUANTITY	3	3	1	
CAPACITY PER BRANCH (MBH)	60	60	60	
WEIGHT (LBS)	37	33	60	
DIMENSIONS (WxHxD) (IN)	19.25 x 8.75 x 19	19.25 x 8.75 x 19	31.25 x 8.75 x 19	
ELECTRICAL DATA:				
VOLTS / Ø / Hz	208/1/60	208/1/60	208/1/60	
MCA	0.17	0.17	0.27	
MOCP	15	15	15	
BASIS OF DESIGN	PRHR033A	PRHR023A	PRHR063A	

3. INDIVIDUAL CONTROL AND CHANGEOVER FOR ONE GROUP OF INDOOR UNITS. 4. MAINTAIN REQUIRED CLEARANCES FOR UNIT.

3. REFRIGERANT TYPE IS R410A

ELECTRIC FIN TUBE RADIATORS				
DESIGNATION	FTR-1	FTR-2		
LOCATION	SEE PLANS	SEE PLANS		
AREA SERVED	SEE PLANS	SEE PLANS		
MODEL	CPH05A8125	CPH05A8188		
LENGTH	8 FEET	8 FEET		
NUMBER OF ELEMENTS	1	1		

208/1/60

4.8

NOTES:

1. HEATERS BASED ON QMARK. 2. PROVIDE DPHOSA PEDESTAL. PEDESTAL SHALL BE 3-3/8" TALL. INSTALL

PER MANUFACTURERS RECOMMENDATIONS. 3. PROVIDE DISCONNECT SWITCH FOR EACH HEATER

4. PROVIDE UNITARY CONTROLLER BY AUTOMATIC TEMPERATURE CONTROLS MANUFACTURER. COMPATIBLE WITH THE BUILDING AUTOMATION

5. PROVIDE FACTORY INSTALLED LINEAR THERMAL CUT-OUT. 6. CABINET FINISH SHALL BE APPROVED BY ARCHITECT.

7. PROVIDE THERMOSTAT AT AT LOCATION SHOWN ON DRAWINGS.

ELECTRIC HEATER								
DESIGNATION	UH-1	WH-1	WH-2	CUH-1	CUH-2			
LOCATION	SEE PLANS							
AREA SERVED	SEE PLANS							
MODEL	MUH03-81	AWH3150E	AWH4404E	CU935	CU935			
CFM	350	100	100	250	250			
HP	0.01	0.1	0.1	0.1	0.1			
FAN RPM	11000	\sim						
VOLTS/Ø/Hz	208/1/60	120/1/60	208/3/60	208/3/60	208/3/60			
KW	3	1.5	3	2	3			

14.5 12.5 14.4 6

NOTES:

AMPS

1. HEATER BASED ON QMARK. 2. PROVIDE DISCONNECT SWITCH FOR EACH HEATER.

6. PROVIDE THERMOSTAT AT LOCATION SHOWN ON DRAWINGS.

3. CABINET UNIT HEATERS SHALL HAVE UNITARY CONTROLLER BY AUTOMATIC TEMPERATURE CONTROLS MANUFACTURER, COMPATIBLE WITH THE BUILDING AUTOMATION SYSTEM, KEY LOCK ACCESS DOORS, UNIT MOUNTED THERMOSTAT WITH FAN ON-OFF-AUTO SWITCH AND TEMP SETTING, AND (2) SETS OF SPARE FILTERS

FOR EACH UNIT. 4. CABINET UNIT HEATER FINISH SHALL BE APPROVED BY ARCHITECT. 5. UNIT HEATERS SHALL BE PROVIDED WITH 24 VOLT CONTROL TRANSFORMER, FACTORY HANGING KIT TO MOUNT TO SLAB/CEILING/WALL AS INDICATED ON DRAWINGS. AND FACTORY INSTALLED AUTOMATIC RESET LINEAR THERMAL CUT-OUT. CONTRACTOR SHALL COORDINATE SUPPORT FOR UNIT HEATERS FOR EACH CONDITION.

INDOOR/OUTDOOR UNIT DESIGNATION	AC-1 / CU-1	AC-2 / CU-2	AC-3 / CU-3
MANUFACTURER	LG	LG	LG
NOMINAL COOLING CAPACITY (TONS)	1	1	1
NOMINAL COOLING CAPACITY (MBH)	12,000	12,000	11,100
NOMINAL HEATING CAPACITY AT 47°F (MBH)	12,000	12,000	14,000
NOMINAL HEATING CAPACITY AT 19°F (MBH)	9640	9,640	11,990
SEER/EER	17 / 10.5	17 / 10.5	19.4 / -
HPSF	8.5	8.5	8.2
RS PIPE SIZE (IN)	3/8	3/8	3/8
RL PIPE SIZE (IN)	1/4	1/4	1/4
CONDENSATE DRAIN PIPE SIZE (IN)	5/8	5/8	5/8
ELECTRICAL DATA:			
VOLTS/Ø/Hz	208/1/60	208/1/60	208/1/60
BREAKER SIZE (AMPS) AT OUTDOOR UNIT	10 / 15	10 / 15	12.3 / 15
INDOOR EVAPORATOR UNIT DATA			
LOCATION	DATA 111	DATA 205A	OFFICE B05
MODEL	LSN120HFV3	LSN120HFV3	LCN128HV4
HEIGHT x WIDTH x DEPTH (IN)	12.2 x 33 x 7.5	12.2 x 33 x 7.5	8.1 x 22.5 x 22.5
WEIGHT (LBS)	19.2	19.2	31
TYPE	WALLWOUNTED	WALLMOUNTED	CELLING CASSETTE
SUPPLY FAN AIRFLOW (CFM)	353	353	335
HP	0.1	0.1	0.1
OUTDOOR CONDENSING UNIT DATA:			
LOCATION	ROOF	ROOF	ROOF
MODEL	LSU120HFV3	LSU120HFV3	LUU120HV
HEIGHT x WIDTH x DEPTH (IN)	19.5 x 28.3 x 10.7	19.5 x 28.3 x 10.7	21.5 x 30.4 x 11.4
WEIGHT (LBS)	55.3	55.3	71
REFRIGERANT TYPE	R-410A	R-410A	R-410A

DUCTIESS SOLIT SYSTEM AS LIMIT SCHEDULE

1. PROVIDE THE FOLLOWING OPTIONS FOR EACH UNIT: 0° LOW AMBIENT CONTROLS.

HARD WIRED REMOTE CONTROLLER

· WIND BAFFLE

2. FIELD SUPPLIED LOCAL DISCONNECT SWITCH AT INDOOR UNIT SHALL BE FURNISHED BY THE MECHANICAL CONTRACTOR & INSTALLED BY THE ELECTRICAL CONTRACTOR.

3. FIELD SUPPLIED WEATHERPROOF LOCAL DISCONNECT SWITCH AT OUTDOOR UNIT SHALL BE FURNISHED BY THE MECHANICAL CONTRACTOR & INSTALLED BY THE ELECTRICAL CONTRACTOR. 4. SINGLE POINT EXTERNAL POWER CONNECTION FOR EACH INDOOR/OUTDOOR SET OF UNITS SHALL BE AT THE

OUTDOOR UNIT. THE ELECTRICAL CONTRACTOR SHALL PROVIDE POWER WIRING FROM THE OUTDOOR UNIT TO THE INDOOR UNIT. 5. THE AUTOMATIC TEMPERATURE CONTROLS CONTRACTOR SHALL PROVIDE CONTROL WIRING BETWEEN THE

OUTDOOR UNIT AND INDOOR UNIT. 6. PROVIDE ALL REQUIRED MOUNTING BRACKETS, SUPPORTS, HANGERS, PADS, ETC. FOR INSTALLATION. 7. PROVIDE ACCESSORIES AS REQUIRED BY MANUFACTURER, WHICH MAY INCLUDE: LIQUID LINE SOLENOID, RELAYS, FILTERS, ETC.

LINEAR DIFFUSER SCHEDULE							
DESIGNATION	LC	LD-1		LD-2		LD-3	
MODEL	FL	-15	FL-20		FL-20		
MAX NC	2	25		25		25	
CONSTRUCTION	ALUM	ALUMINUM		ALUMINUM		ALUMINUM	
FRAME	LAY	LAY-IN		LAY-IN		LAY-IN	
NUMBER OF SLOTS		1		1		1	
SLOT WIDTH (IN)	1.	1.5		2		2	
LENGTH	4	8"	48"		24	4"	
	CFM RANGE	NOMINAL NECK SIZE	CFM RANGE	NOMINAL NECK SIZE	CFM RANGE	NOMINAL NECK SIZE	
	0 - 140	6"	0 - 200	8"	0 - 110	8"	
	141 - 170	8"	201 - 230	12"			

I. CEILING LINEAR SUPPLY DIFFUSERS ARE BASED ON TITUS.

2. COORDINATE COLOR SELECTION WITH ARCHITECTURAL PLANS.

3. SUPPLY DIFFUSERS SHALL HAVE FRAMES AND BORDERS SUITABLE FOR THE CONSTRUCTION IN WHICH THEY WILL BE INSTALLED, CONTRACTOR TO COORDINATE

4. DIFFUSER BLOW PATTERN IS AS SHOWN ON DRAWINGS. PROVIDE PATTERN CONTROLLER.

5. DIFFUSERS SHALL BE INSTALLED WITH FACTORY-BUILT SUPPLY PLENUMS WITH MANUFACTURERS INTERNAL SOUND LINING. FIELD. INSULATED PLENUMS SHALL BE BASED ON TITUS FBPI.

6. COORDINATE DIFFUSER INSTALLATION WITH REFLECTED CEILING PLANS AND ALL OTHER TRADES.

INACTIVE DIFFUSER SECTIONS SHALL BE OPEN TO CEILING PLENUM AND PROVIDED WITH FACTORY LIGHT SHIELD. 8. PROVIDE CONCEALED CABLE OPERATED BALANCING DAMPERS THROUGH SLOT OPENINGS FOR ALL LINEAR DIFFUSERS WITH INACCESSIBLE VOLUME DAMPERS.

VARIABLE	REFRIGE	RANT FLC	DW - INDC	OR UNIT	S SCHED	ULE
DESIGNATION	VRF-1	VRF-2	VRF-3	VRF-4	VRF-5	VRF-6
TONNAGE	4	4	3.5	3	2.5	2
TYPE	DUCTED	DUCTED	DUCTED	DUCTED	DUCTED	DUCTED
QUANTITY	1	1	1	1	1	1
SUPPLY FAN AIRFLOW	1,191	1,191	1.076	845	676	710
SUPPLY FAN HP	2@0.6	2@0.6	2@0.6	2@0.6	0.9	0.6
ESP (IN WC)	0.6	0.6	0.6	0.6	0.6	0.6
COOLING PERFORMANCE						
TOTAL (BTUH)	34.6	31.8	30.5	24.7	18.2	21
SENSIBLE (BTUH)	25.9	25.9	23.6	19.5	14.6	15
EAT (DB / WB)	74.8 / 62.7	72.7 / 61	73.6 / 61.7	73 / 61.2	72.3 / 60.6	74.8 / 62.7
LAT (DB)	55.6	53.5	54.3	52.6	53.2	56
HEATING PERFORMANCE						
TOTAL CAPACITY (BTUH)	45.8	45.8	42	34.8	26.5	28.3
EAT (DB)	68	68	68	68	68	68
LAT (DB)	102.4	102.4	103	104.9	103.1	103.7
ELECTRICAL DATA:						
VOLTS / Ø / Hz	208/1/60	208/1/60	208/1/60	208/1/60	208/1/60	208/1/60
MCA	3.1	3.1	2.9	2.9	2.9	1.2
MOCP	15	15	15	15	15	15
WEIGHT (LBS)	96.1	96.1	86.2	86.2	86.2	60
DIMENSIONS (WxHxD) (IN)	49.5x14.5x27.5	49.5x14.5x27.5	49.5x10.5x27.5	49.5x10.5x27.5	49.5x10.5x27.5	49.5x7.5x27.5
MODEL	ARNU483M3A4	ARNU483M3A4	ARNU423M2A4	ARNU363M2A4	ARNU283M2A4	ARNU243L3G4

1. UNITS BASED ON LG.

2. PROVIDE DUCTED UNITS WITH CONDENSATE PUMP. REFER TO M-601 FOR CONDENSATE PUMP SPECIFICATION. 3. PROVIDE UNITS WITH DISCONNECT SWITCH.

EQUIPMENT NOTES

- FIRE DAMPERS: SHALL BE RUSKIN MODEL DIBD-2, 1-1/2 HOUR UL555 RATED, SUITABLE FOR INSTALLATION IN WALL AND FLOOR PARTITIONS WITH FIRE RATINGS OF LESS THAN 3 HOURS. DAMPER SHALL BE A COMPLETE FACTORY PACKAGE INCLUDING U.L. APPROVED ANGLES, WALL SLEEVE, AND BREAKAWAY CONNECTIONS. DAMPER SHALL BE RATED FOR DYNAMIC AIRFLOW CONDITIONS OF 2,000 FPM AND 4,0" SP.
- 2. VOLUME CONTROL DAMPERS: FOR ALL ROUND & RECTANGULAR VOLUME CONTROL DAMPERS THAT ARE LOCATED ABOVE INACCESSIBLE CEILINGS, PROVIDE CABLE OPERATED DAMPERS. ROUND DAMPERS SHALL BE YOUNG BOWDEN MODEL 5020-CC. RECTANGULAR DAMPERS SHALL BE MODEL 830-CC2. CABLE CONTROLS SHALL BE MODEL 270-275 FOR CONCEALED LOCATIONS & MODEL 270-896C FOR LOCATIONS WHERE CABLES
- MOTORIZED DAMPERS: SHALL BE LOW LEAKAGE TYPE RUSKIN MODEL CD40. 4" DEEP EXTRUDED ALUMINUM AIRFOIL DAMPER. DAMPER SHALL HAVE OPPOSED BLADES, MOTOR

AND LINKAGE. DAMPERS SHALL BE LOW-LEAKAGE RATED TYPE. DAMPERS SHALL BE

TERMINATE IN FINISHED SPACES. COORDINATE LOCATIONS IN THE FIELD.

- 120V/1\phi/60Hz, 3 AMPS MAX. FURNISH DISCONNECT SWITCH. 3.1. OUTSIDE AIR INTAKE & EXHAUST DAMPERS SHALL BE CLASS I MOTORIZED DAMPERS WITH MAXIMUM LEAKAGE RATE OF 4 CFM/SQFT @ 1.0" W.G.; TESTED IN ACCORDANCE WITH AMCA 500D. DAMPERS SHALL BE CONFIGURED TO CLOSE AUTOMATICALLY WHEN THE SYSTEMS OF THE SPACE SERVED ARE NOT IN USE.
- 4. CONDENSATE PUMP: SHALL BE LITTLE GIANT VCCA-20-P. PUMP SHALL BE HARD WIRED PLENUM RATED AND SHALL BE ABLE TO PUMP 45 GPH AT 10 FEET OF HEAD. CONDENSATE PUMP SHALL BE 115/1/60, 1.5 AMPS.
- 5. FURNISH ALL REQUIRED PIPE AND ENCLOSURE SUPPORTS, BRACKETS, AND FASTENERS ETC. FURNISH VALVE ACCESS DOORS AND KNOCK OUT FOR ELECTRICAL RECEPTACLES. FURNISH END CAPS AND CORNER ANGLES. RUN ENCLOSURES CONTINUOUS WALL TO WALL. FINISH SHALL BE BAKED ON ENAMEL, SUBMIT COLOR CHART FOR REVIEW AND APPROVAL.
- 6. EXPANSION TANK EXP-1: TO BE AMTROL MODEL AX-40V, 21.7 GALLON TANK AND 11.3 GALLON ACCEPTANCE VOLUME, 30" HIGH, 16" DIAMETER AND HAVE A SHIPPING WEIGHT OF APPROXIMATELY 99 POUNDS.
- AIR SEPARATOR AS-1: SHALL BE BELL & GOSSETT MODEL R-4F, 300 GPM MAXIMUM CAPACITY, 4" FLANGED INLET AND OUTLET, REMOVABLE GALVANIZED STEEL SYSTEM | STRAINER, INTERNAL STAINLESS STEEL AIR COLLECTOR TUBE WITH NPT CONNECTION AND BLOWDOWN CONNECTION. THE AIR SEPARATOR MUST BE DESIGNED, CONSTRUCTED, AND STAMPED FOR 125 PSIG @ 350°F IN ACCORDANCE WITH SECTION VIII, DIVISION I OF THE ASME BOILER AND PRESSURE VESSEL CODE, AND REGISTERED WITH THE NATIONAL BOARD OF BOILER AND PRESSURE VESSEL INSPECTORS. THE AIR SEPARATOR SHALL BE PAINTED WITH ONE SHOP COAT OF LIGHT GRAY AIR DRY ENAMEL.
- 8. GLYCOL MIXING TANK: GMU-1, SHALL BE WESSELS COMPANY MODEL GMPD-13050 WITH INDUSTRIAL GRADE GRADUATED POLYETHYLENE 50 GALLON TANK, OBSERVABLE FLUID LEVEL SCALE. & REMOVABLE LID. EQUIPPED WITH ONE (1) AUTOMATIC PUMPING ASSEMBLIES, RATED AT 1.8 GPM @ 70 PSI, 1/3 HP; FITTED WITH H-O-A CONTROLS ADJUSTABLE PRV. PRESSURE GAUGE, HIGH LEVEL ALARM AND LOW-LEVEL ALARM WITH AUDIBLE AND VISUAL ALARMS. FURNISH DISCONNECT SWITCH FOR GMU PUMP FOR INSTALLATION BY THE ELECTRICAL CONTRACTOR. ELECTRICAL: 120/1/60. PROVIDE BMS PROTOCOL FOR CONNECTION/MONITORING TO BMS.
- PROPYLENE GLYCOL: SHALL BE BASED ON DOW DOWFROST HD INHIBITED PROPYLENE GYLCOL-BASED HEAT TRANSFER FLUID. THE MECHANICAL CONTRACTOR SHALL PROVIDE PROPYLENE GLYCOL FOR DUAL TEMPERATURE WATER SYSTEM AS NOTED ON PLANS (20% CONCENTRATION).
- 10. PIPE INSULATION JACKETING: SHALL BE WHITE ZESTON 2000 PVC COVERS FOR PIPING AND FITTINGS. JACKET ALL PIPING AND FITTING THAT ARE EXPOSED IN ANY ROOM.
- 11. PIPE LABELS: SHALL BE SETON ULTRA-MARK WEATHER RESISTANT FOR OUTDOOR APPLICATION AND OPTI-CODE FOR INDOOR APPLICATION. LETTERS AND ARROWS SHALL BE 2 1/2" HIGH AND SHALL BE WHITE ON A GREEN BACKGROUND AND SHALL CONFORM TO ANSI AND OSHA STANDARDS. APPLY OVER INSULATION ONLY.
- 12. ALL HVAC EQUIPMENT SHALL HAVE 3" HIGH BLACK LAMACOID NAME PLATES WITH WHITE ENGRAVED LETTERS PERMANENTLY FASTENED TO EQUIPMENT. TYPICAL FOR All BOILERS PUMPS, AIR HANDLERS, AC UNITS AND CONDENSERS.
- 13. REFRIGERANT PIPE INSULATION: SHALL BE AP ARMAFLEX PIPE INSULATION. 1" THICK UNSLIT, TO BE INSTALLED BEFORE FINAL CONNECTION. FIELD FABRICATE FITTING INSULATION WITH MITER-CUTS. ALL BUTT JOINTS AND SEAMS ARE TO BE SEALED WITH ARMSTRONG 520 ADHESIVE. ALL INSULATION INSTALLED OUTDOORS SHALL BE COATED WITH UV RESISTANT COATING/FINISH, AS PER THE MANUFACTURERS RECOMMENDATIONS.

HARRISON **RECREATION & CENTER**

New Construction - Phase 2

Town / Village of Harrison 270 Harrison Avenue

Harrison, NY 10528

KG+D ARCHITECTS, PC 285 MAIN STREET. MOUNT KISCO, NEW YORK 10549 KGDARCHITECTS.COM

OLA Consulting Engineers 00 Summit Lake Drive, Suite 102 alhalla. NY 10595 914-747-2800 3 W. 38th St, Suite 900, New York, NY 10018

646-849-4110 newyorkcity@olace.com


CONSTRUCTION DOCUMENTS

NOTE: ALL IDEAS, DESIGNS, ARRANGEMENTS AND PLANS INDICATED OR REPRESENTED BY THIS DRAWING ARE OWNED BY AND ARE THE PROPERTY OF G+D ARCHITECTS, PC (KG+D), AND WERE CREATED FOR USE ON THIS PROJECT. NONE OF SUCH IDEAS, DESIGNS, ARRANGEMENTS OR PLANS SHALL BE USED BY OR DISCLOSED TO ANY PURPOSE WHATSOEVER WITHOUT THE RITTEN PERMISSION OF KG+D.

AND CONDITIONS ON THE JOB AND THE ARCHITECT MUST BE NOTIFIED OF ANY BE SUBMITTED TO THIS OFFICE FOR APPROVAL BEFORE PROCEEDING WITH ALTERATIONS BY ANY PERSON, IN ANY WAY, OF ANY ITEM CONTAINED ON THIS DOCUMENT, UNLESS ACTING UNDER THE DIRECTION OF THE LICENCED

SCALED DIMENSIONS, CONTRACTOR SHALL VERIFY ALL ACTUAL DIMENSIONS

ARCHITECT WHOSE PROFESSIONAL SEAL IS AFFIXED HERETO, IS A VIOLATION OF TITLE VII, SECT. 69.5 (b) OF NEW YORK STATE LAW. ALL RIGHTS RESERVED.

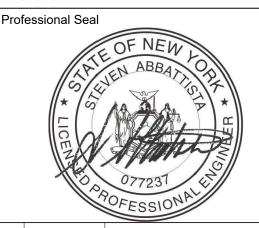

12/13/2024 PERMIT ADDENDUM 10/09/2024 ISSUED FOR CONSTRUCTION

10/09/2024 ∣CONFORMED SET 06/05/2024 ISSUED FOR BID 01/16/2024 ISSUED FOR PERMIT

06/01/2020 DESIGN DEVELOPMENT 03/31/2020 50% DESIGN DEVELOPMENT

MECHANICAL **EQUIPMENT NOTES**

& SCHEDULES NKGD0207.00 03/01/2024

Drawn / Checked

AS NOTED HM / RG Sheet Number M-601

DESIGNATION	DOAS-1	DOAS-2
OCATION	ROOF	ROOF
AREA SERVED	SEE PLANS	SEE PLANS
MANUFACTURER	VTS AMERICA INC.	VTS AMERICA INC.
MODEL	AVS020-R-FRMCHVE	AVS020-R-FRMCHVE
WEIGHT OF UNIT (LBS)	1,770	1,770
DIMENSION (WxHxD) (IN)	47 x 54 x 189	47 x 54 x 189
DUTSIDE AIR (CFM)	2,000	2,010
SUPPLY FAN:	_,,000	2,010
CFM	2,000	2,010
ESP/TSP (IN H ₂ O)	1.0	1.0
TYPE	DIRECT DRIVE PLENUM	DIRECT DRIVE PLENUM
MOTOR HP	2	2
CONTROL	VFD	VFD
/OLTS / Ø / Hz	208 / 3 / 60	208 / 3 / 60
MCA / MOCP (AMPS)	8.3 / 15	8.3 / 15
EXHAUST FAN:	0.5 / 15	0.57 15
CFM	2,000	2,010
ESP/TSP (IN H ₂ O)	1.0	1.0
TYPE	DIRECT DRIVE PLENUM	DIRECT DRIVE PLENUM
MOTOR HP	1.5	1.5
CONTROL	VFD	VFD
/OLTS / Ø / Hz	208 / 3 / 60	208 / 3 / 60
MCA / MOCP (AMPS)	5.6 / 15	5.6 / 15
COOLING PERFORMANCE:	3.0 / 13	3.0713
E.A.T (DB / WB)	80.2 / 65.8	80.2 / 65.8
A.T (DB / WB)	52.8 / 51.9	52.8 / 52.8
GROSS TOTAL CAPACITY (MBH)	82.4	175.6
GROSS SENSIBLE CAPACITY (MBH)	60.2	94.3
REHEAT CAPACITY (MBH)	48.6	48.9
REHEAT (DB / WB)	75 / 60.7	75.0 / 60.7
HEATING PERFORMANCE: HEAT PUMP	13100.1	13.0100.1
E.A.T. / L.A.T. (DB)	54.2 / 70	54.1 / 70.0
HEATING CAPACITY (MBH)	34.7	35
HEAT ENTHALPY WHEEL PERFORMANCE (VALUES		33
WINTER RETURN (EXHAUST AIR STREAM)	68 / 68	68 / 68
VINTER EXHAUST (EXHAUST AIR STREAM)	13.9 / 13.9	13.9 / 13.9
WINTER SUPPLY (SUPPLY AIR STREAM)	54.2 / 54.2	54.1 / 54.1
WINTER OUTDOOR AIR (OUTDOOR AIR STREAM)	0.0 / -1.0	0.0 / -1.0
SUMMER RETURN (EXHAUST AIR STREAM)	77 / 63	77 / 63
SUMMER EXHAUST (EXHAUST AIR STREAM)	91.2 / 75.4	91.2 / 75.4
,	80.2 / 65.8	80.2 / 65.8
SUMMER SUPPLY (SUPPLY AIR STREAM) SUMMER OUTDOOR AIR (OUTDOOR AIR STREAM)	95 / 78	95 / 78
OLTS / Ø / Hz	208 / 3 / 60	208 / 3 / 60
MCA / MOCP (AMPS)	0.8 / 15.0	0.8 / 15.0
INES & FILTERS:	1"	1"
CONDENSATE DRAIN LINE SIZE (IN)	I	I "

. PROVIDE THE FOLLOWING OPTIONS: ● 100% OUTSIDE AIR UNIT

• DIRTY FILTER SENSOR • EXTRA DRIVE BELT AND FILTER SET • DISCONNECT SWITCH

FREEZE-STAT

2. PROVIDE THE FOLLOWING MOTOR CONTROL OPTIONS: • TRIPLE POINT EXTERNAL POWER CONNECTION AT UNIT.

• ALL MOTORS 1 HP OR GREATER SHALL BE PREMIUM EFFICIENCY. ALL MOTORS FURNISHED WITH VARIABLE FREQUENCY DRIVES SHALL BE INVERTER DUTY RATED & APPROVED FOR VARIABLE SPEED AND TORQUE

• UNITARY CONTROLLER BY AUTOMATIC TEMPERATURE CONTROLS MANUFACTURER, COMPATIBLE WITH THE BUILDING AUTOMATION SYSTEM 3. MOTOR STARTER & DISCONNECT SWITCH FOR EACH UNIT SHALL BE FURNISHED BY THE MECHANICAL

CONTRACTOR & INSTALLED BY THE ELECTRICAL CONTRACTOR. EACH UNIT SHALL BE FURNISHED WITH THE UNIT- MOUNTED LOCAL DISCONNECT SWITCH. 4. UNIT SHALL BE MOUNTED ON VIBRATION ISOLATION ROOF CURB. HEIGHT OF CURB IS TO BE COORDINATED WITH FINAL FINISHED ROOF SURFACE, INCLUDING DEVIATIONS DUE TO CRICKETS, ROOF DRAINS, ETC. LOWER PORTION OF VIBRATION CURB SHALL EXTEND 12" MINIMUM ABOVE FINISHED ROOF SURFACE.

PROVIDE BLOCKING OR SIMILAR AS NECESSARY. MASON INDUSTRIES TYPE RSC OR EQUIVALENT. 5. PROVIDE UNIT WITH AIR SIDE ECONOMIZER AND HOT GAS REHEAT. 5. INTERNAL VFDS SHALL BE RATED FOR TEMPERATURE RANGING FROM 0°F TO 100°F.

DESIGNATION	RTU-1	RTU-2	RTU-3
LOCATION	ROOF	ROOF	ROOF
AREA SERVED	GYM	GYM	FITNESS
MANUFACTURER	TEMPMASTER	TEMPMASTER	TEMPMASTER
MODEL	CV25T3DQ2S1ABN47E3	CV25T3DQ2S1ABN47E3	ZJ120S18R2B5BCE3A3
NOMINAL CAPACITY (TONS)	25	25	10
WEIGHT OF UNIT (LBS)	2,485	2,485	1285
SUPPLY DUCT CONNECTION	BOTTOM	BOTTOM	BOTTOM
RETURN DUCT CONNECTION	BOTTOM	BOTTOM	BOTTOM
OUTSIDE AIR (CFM)	3,450	3,450	960
SUPPLY FAN:	3,430	3,430	900
	1	4	4
QUANTITY	1 10 500	1	1
TOTAL CFM	10,500	10,500	3,500
CFM FOR EACH FAN	10,500	10,500	3,500
ESP/TSP (IN H ₂ O)	1.5 / -	1.5 / -	1 / -
TYPE	BELT	BELT	BELT
HP FOR EACH FAN	10	10	3
CONTROL	VFD	VFD	VFD
COOLING PERFORMANCE:	1		
E.A.T (DB / WB)	76.9 / 64	76.9 / 64	76.3 / 63.4
L.A.T (DB / WB)	58.3 / 55.5	58.3 / 55.5	53.6 / 52.5
,			
TOTAL CAPACITY (MBH)	268.1	268.1	110.3
SENSIBLE CAPACITY (MBH)	210.9	210.9	85.9
NUMBER OF COMPRESSORS	2	2	2
NUMBER OF CIRCUITS	2	2	2
NUMBER OF STAGES	4	4	2
REHEAT CAPACITY (MBH)	166.5	166.5	57.3
REHEAT (DB / WB)	72 / 62.4	72 / 62.4	71.8
HEATING PERFORMANCE: NATURAL GAS	FURNACE		
E.A.T. / L.A.T. (DB)	62.6 / 91.2	62.6 / 91.2	64.9 / 103.5
HEATING CAPACITY INPUT (MBH)			
, ,	400	400	180
HEATING CAPACITY OUTPUT (MBH)	324	324	146
INLET PRESSURE (IN WC)	7 - 14	7 - 14	7 - 14
ERV:			
MODEL	CV25T3DQ2S1ABN47E3	CV25T3DQ2S1ABN47E3	ZJ120S18R2B5BCE3A3
WEIGHT OF UNIT (LBS)	1,230	1,230	318
OUTSIDE AIR CFM	3,450	3,450	960
SUMMER ENTHALPY WHEEL PERFORMAN	ICE (VALUES IN °F DB/WB)		
RETURN (EXHAUST AIR STREAM)	75 / 62	75 / 62	75 / 62
EXHAUST (EXHAUST AIR STREAM)	80.4 / 67.61	80.4 / 67.61	79.2 / 66.4
SUPPLY (SUPPLY AIR STREAM)	76.9 / 64	76.9 / 64	76.3 / 63.4
· · · · · · · · · · · · · · · · · · ·			
OUTDOOR (OUTDOOR AIR STREAM)	95 / 78	95 / 78	95 / 78
WINTER ENTHALPY WHEEL PERFORMAN		<u> </u>	
RETURN (EXHAUST AIR STREAM)	70	70	70
EXHAUST (EXHAUST AIR STREAM)	49	49	53.9
SUPPLY (SUPPLY AIR STREAM)	62.6	62.6	64.9
OUTDOOR (OUTDOOR AIR STREAM)	0 / 0	0 / 0	0 / 0
LINES & FILTERS:		. L	
CONDENSATE DRAIN LINE SIZE (IN)	1	1	1
RETURN AIR FILTER TYPE	ANGLE FILTER 4" MERV 13	ANGLE FILTER 4" MERV 13	4" PLEATED MERV 13
QUANTITY AND SIZE	(9) 16x25	(9) 16x25	(4) 24x20
EFFICIENCY:			
EER	10	10	12
IEER	14.2	14.2	15
FURNACE EFFICIENCY	81%	81%	81%
ELECTRICAL DATA - RTU			
VOLTS / Ø / Hz	208 / 3 / 60	208 / 3 / 60	208 / 3 / 60
MCA / MOCP (AMPS)	143.7 / 175	143.7 / 175	44.9 / 50
ELECTRICAL DATA - ERV	l .		
	000 / 0 / 00	200 / 2 / 60	208 / 3 / 60
VOLTS / Ø / Hz	208 / 3 / 60	208 / 3 / 60	200/3/00
VOLTS / Ø / Hz MCA / MOCP (AMPS)	208 / 3 / 60	23.5 / 25	8.3 / 10

1. PROVIDE RTU-1, RTU-2, RTU-3 WITH DUCT MOUNTED SMOKE DETECTORS.

MCA / MOCP (AMPS)

2. PROVIDE RTU-1, RTU-2, RTU-3 WITH INSULATED ROOF CURB WITH VIBRATION ISOLATION RAIL. ROOF CURB SHALL BE RETURN

23.5 / 25

8.3 / 10

3. PROVIDE UNITS WITH DISCONNECT SWITCH. ALL OUTDOOR UNITS SHALL BE PROVIDED WITH RATED DISCONNECT SWITCH. 4. PROVIDE RTU-1, RTU-2, RTU-3 WITH AIRSIDE ECONOMIZER AND POWER EXHAUST. 5. PROVIDE RTU-1, RTU-2, RTU-3 WITH HOT GAS REHEAT.

23.5 / 25

6. PROVIDE THE FOLLOWING OPTIONS FOR ALL UNITS: • HIGH STATIC DRIVE MOTOR. COORDINATE LEFT/RIGHT HAND FAN DRIVE IN FIELD.

• 100% MODULATING ECONOMIZER WITH DIFFERENTIAL ENTHALPY CONTROL AND ECONOMIZER HOOD.

• FURNISH EXTRA DRIVE BELT AND EXTRA FILTER SET FOR EACH UNIT.

• UNIT SHALL BE MOUNTED ON VIBRATION ISOLATION ROOF CURB. HEIGHT OF CURB IS TO BE COORDINATED WITH FINAL FINISHED ROOF SURFACE, INCLUDING DEVIATIONS DUE TO CRICKETS, ROOF DRAINS, ETC. LOWER PORTION OF VIBRATION CURB SHALL EXTEND 12" MINIMUM ABOVE FINISHED ROOF SURFACE. PROVIDE BLOCKING OR SIMILAR AS NECESSARY. MASON INDUSTRIES TYPE RSC OR EQUIVALENT.

• PROVIDE 4" FIELD INSTALLED FILTER SECTION WITH HINGED ACCESS DOOR AND PROVIDE MERV 10 FILTERS. 7. PROVIDE THE FOLLOWING MOTOR CONTROL OPTIONS FOR ALL UNITS:

• UNITARY CONTROLLER BY AUTOMATIC TEMPERATURE CONTROLS MANUFACTURER, COMPATIBLE WITH THE BUILDING AUTOMATION SYSTEM.

• ALL MOTORS 1 HP OR GREATER SHALL BE PREMIUM EFFICIENCY. ALL MOTORS FURNISHED WITH VARIABLE FREQUENCY DRIVES SHALL BE INVERTER DUTY RATED & APPROVED FOR VARIABLE SPEED AND TORQUE APPLICATIONS.

• SINGLE POINT EXTERNAL POWER CONNECTION AT BOTH RTU ANDERV, UNIT-MOUNTED DISCONNECT SWITCH, AND FACTORY INSTALLED MOTOR STARTERS. VAV UNITS SHALL HAVE FACTORY MOUNTED VFD'S WITH H-O-A. 8. CONTRACTOR SHALL HIRE THE MANUFACTURER'S INSTALLATION TECHNICIAN FOR INSTALLATION AND STARTUP. PROVIDE

STARTUP REPORTS TO THE ENGINEER FOR REVIEW AND APPROVAL. INTERNAL VFDS SHALL BE RATED FOR TEMPERATURE RANGING FROM 0°F TO 100°F.

DULE		
JOLL		
RTU-3		DESIGNATION
ROOF		LOCATION
FITNESS		AREA SERVED
EMPMASTER		MANUFACTURER
S18R2B5BCE3A3 10		MODEL NOMINAL CAPACITY (
1285		`
BOTTOM		WEIGHT OF UNIT (LBS
BOTTOM		RETURN DUCT CONN
960		OUTSIDE AIR (CFM)
		SUPPLY FAN:
1		QUANTITY
3,500		TOTAL CFM
3,500		CFM FOR EACH FAN
1 / -		ESP/TSP (IN H ₂ O)
BELT		TYPE
3		HP FOR EACH FAN
VFD		CONTROL
		RETURN FAN:
76.3 / 63.4		QUANTITY
53.6 / 52.5		TOTAL CFM
110.3		CFM FOR EACH FAN
85.9		ESP/TSP (IN H ₂ O)
2		TYPE
2		HP FOR EACH FAN
2		CONTROL
57.3		COOLING PERFORMA
71.8		E.A.T (DB / WB)
		L.A.T (DB / WB)
64.9 / 103.5		TOTAL CAPACITY (MB
180		SENSIBLE CAPACITY
146		REHEAT CAPACITY (M
7 - 14		REHEAT (DB / WB)
		HEATING PERFORMAI
S18R2B5BCE3A3		E.A.T. / L.A.T. (DB)
318		HEATING CAPACITY C
960		SUMMER ENTHALPY
75 / 62		RETURN (EXHAUST A
79.2 / 66.4		EXHAUST (EXHAUST /
76.3 / 63.4		SUPPLY (SUPPLY AIR
95 / 78		OUTDOOR (OUTDOOF WINTER ENTHALPY W
33770		RETURN (EXHAUST A
70		EXHAUST (EXHAUST A
53.9		SUPPLY (SUPPLY AIR
64.9		OUTDOOR (OUTDOOF
0 / 0		LINES & FILTERS:
		CONDENSATE DRAIN
 1		RETURN AIR FILTER T
EATED MERV 13		QUANTITY AND SIZE
(4) 24×20		ELECTRICAL DATA - S
***		VOLTS / Ø / Hz
12		MCA / MOCP (AMPS)
15)	ELECTRICAL DATA - E
81%)	VOLTS / Ø / Hz
		MCA / MOCP (AMPS)
208 / 3 / 60		ELECTRICAL DATA - S
44.9 / 50		VOLTS / Ø / Hz
		MCA / MOCP (AMPS)
208 / 3 / 60		ELECTRICAL DATA E

DESIGNATION	RTU-4	RTU-5	RTU-6	RTU-7			
LOCATION	ROOF	ROOF	ROOF	ROOF			
AREA SERVED	2ND FLOOR COMMON AREA	MULTIPURPOSE 202	MULTIPURPOSE 202	MULTIPURPOSE 203			
MANUFACTURER	VTS	VTS	VTS	VTS			
MODEL	AVS030	AVS020	AVS020	AVS040			
NOMINAL CAPACITY (TONS)	-	-	-	-			
WEIGHT OF UNIT (LBS)	1,991	1,238	1,238	1,924			
SUPPLY DUCT CONNECTION	ВОТТОМ	BOTTOM	ВОТТОМ	BOTTOM			
RETURN DUCT CONNECTION	ВОТТОМ	воттом	ВОТТОМ	ВОТТОМ			
OUTSIDE AIR (CFM)	1,680	0	0	0			
SUPPLY FAN:	1,000			,			
QUANTITY	1	1	1	1			
TOTAL CFM	2,680	1,800	1,800	2,400			
CFM FOR EACH FAN	2,680	1,800	1,800	2,400			
ESP/TSP (IN H ₂ O)	1 / 2.8	1 / 2.23	1 / 2.23	1 / 2.05			
TYPE	DIRECT DRIVE PLENUM	DIRECT DRIVE PLENUM	DIRECT DRIVE PLENUM	DIRECT DRIVE PLENUM			
HP FOR EACH FAN	2	1.5	1.5	3			
CONTROL	VFD	VFD	VFD	VFD			
RETURN FAN:				T			
QUANTITY	1	1	1	1			
TOTAL CFM	2,680	1,800	1,800	2,400			
CFM FOR EACH FAN	2,680	1,800	1,800	2,400			
ESP/TSP (IN H ₂ O)	1 / 2.3	1 / 1.73	1 / 1.73	1 / 1.8			
TYPE	DIRECT DRIVE PLENUM	DIRECT DRIVE PLENUM	DIRECT DRIVE PLENUM	DIRECT DRIVE PLENUM			
HP FOR EACH FAN	2	1.5	1.5				
CONTROL	VFD	VFD	VFD	VFD			
COOLING PERFORMANCE:							
E.A.T (DB / WB)	78.5 / 64.7	72.4 / 60.9	73.7 / 61.9	73.5 / 61.3			
L.A.T (DB / WB)	49 / 49	52.2 /	53.1 /	50.9 / 50			
TOTAL CAPACITY (MBH)	120.3	57.2	61	75.1			
SENSIBLE CAPACITY (MBH)	86.9	41.1	41.7	59.5			
REHEAT CAPACITY (MBH)	76.2	44.3	42.6	62.5			
REHEAT (DB / WB)	75 / 59.6	75	75	75			
HEATING PERFORMANCE:		I	T				
E.A.T. / L.A.T. (DB)	61.6 / 80	68 / 80	68 / 80	68 / 80			
HEATING CAPACITY OUTPUT (MBH)	54.5	23.9	23.9	31.8			
SUMMER ENTHALPY WHEEL PERFORMANG	CE (VALUES IN °F DB/WB)						
RETURN (EXHAUST AIR STREAM)	77 / 63.5						
EXHAUST (EXHAUST AIR STREAM)	92 / 76.1	N1/A	NI/A	NI/A			
SUPPLY (SUPPLY AIR STREAM)	79.4 / 65.5	- N/A	N/A	N/A			
OUTDOOR (OUTDOOR AIR STREAM)	95 / 78						
WINTER ENTHALPY WHEEL PERFORMANC	E (VALUES IN °F DB/WB)						
RETURN (EXHAUST AIR STREAM)	68 / 67						
EXHAUST (EXHAUST AIR STREAM)	10.6 / 10.6						
SUPPLY (SUPPLY AIR STREAM)	57.7 / 57.7	N/A	N/A	N/A			
OUTDOOR (OUTDOOR AIR STREAM)	0/0						
LINES & FILTERS:	070						
CONDENSATE DRAIN LINE SIZE (IN)	1	1	1	1			
, ,	011 14 5 7 7 7 9			OIL MEDI / O			
RETURN AIR FILTER TYPE	2" MERV 8	2" MERV 8	2" MERV 8	2" MERV 8			
QUANTITY AND SIZE	(3) 15.5x24.5	(1) 19.5x19.5, (1) 19.5x23.5	(1) 19.5x19.5, (1) 19.5x23.5	(6) 14.25x17.35			
ELECTRICAL DATA - SINGLE POINT POWER CONNECTION:							
VOLTS / Ø / Hz	N/A	N/A	N/A	N/A			
MCA / MOCP (AMPS)							
ELECTRICAL DATA - ENERGY WHEEL:							
VOLTS / Ø / Hz	208 / 3 / 60	N/A	N/A	N/A			
MCA / MOCP (AMPS)	0.8 / 15	IN/A	IN/A	IN/A			
ELECTRICAL DATA - SUPPLY FAN:							
VOLTS / Ø / Hz	208 / 3 / 60	208 / 3 / 60	208 / 3 / 60	208 / 3 / 60			
MCA /MOCD (AMDS)	0.2/45	E 6 / 1 E	E C / 1E	11 2 / 20			

ROOFTOP UNIT SCHEDULE

MCA / MOCP (AMPS) 8.3 / 15

ELECTRICAL DATA - EXHAUST FAN:

VOLTS / Ø / Hz

1. PROVIDE RTU-4 AND RTU-7 WITH DUCT MOUNTED SMOKE DETECTORS. 2. PROVIDE RTU-4, RTU-5, RTU-6, AND RTU-7 WITH INSULATED ROOF CURB WITH VIBRATION ISOLATION RAIL. ROOF CURB SHALL BE RETURN PLENUM.

3. PROVIDE UNITS WITH DISCONNECT SWITCH. ALL OUTDOOR UNITS SHALL BE PROVIDED WITH RATED DISCONNECT SWITCH. 4. PROVIDE RTU-4, RTU-5, RTU-6, AND RTU-7 WITH AIRSIDE ECONOMIZER.

8.3 / 15

208 / 3 / 60

5. PROVIDE RTU-4, RTU-5, RTU-6, AND RTU-7 WITH HOT GAS REHEAT.

6. PROVIDE THE FOLLOWING OPTIONS FOR ALL UNITS:

9. INTERNAL VFDS SHALL BE RATED FOR TEMPERATURE RANGING FROM 0°F TO 100°F.

• HIGH STATIC DRIVE MOTOR. COORDINATE LEFT/RIGHT HAND FAN DRIVE IN FIELD. • 100% MODULATING ECONOMIZER WITH DIFFERENTIAL ENTHALPY CONTROL AND ECONOMIZER HOOD.

• FURNISH EXTRA DRIVE BELT AND EXTRA FILTER SET FOR EACH UNIT. • UNIT SHALL BE MOUNTED ON VIBRATION ISOLATION ROOF CURB. HEIGHT OF CURB IS TO BE COORDINATED WITH FINAL FINISHED ROOF SURFACE, INCLUDING DEVIATIONS DUE TO CRICKETS, ROOF DRAINS, ETC. LOWER PORTION OF VIBRATION CURB SHALL EXTEND 12" MINIMUM ABOVE FINISHED ROOF SURFACE. PROVIDE BLOCKING OR SIMILAR AS NECESSARY. MASON INDUSTRIES TYPE RSC OR EQUIVALENT.

5.6 / 15

208 / 3 / 60

5.6 / 15

5.6 / 15

208 / 3 / 60

5.6 / 15

11.3 / 20

208 / 3 / 60

11.3 / 20

7. PROVIDE THE FOLLOWING MOTOR CONTROL OPTIONS FOR ALL UNITS: • UNITARY CONTROLLER BY AUTOMATIC TEMPERATURE CONTROLS MANUFACTURER, COMPATIBLE WITH THE BUILDING AUTOMATION SYSTEM. • ALL MOTORS 1 HP OR GREATER SHALL BE PREMIUM EFFICIENCY. ALL MOTORS FURNISHED WITH VARIABLE FREQUENCY DRIVES SHALL BE INVERTER DUTY RATED

& APPROVED FOR VARIABLE SPEED AND TORQUE APPLICATIONS. • SINGLE POINT EXTERNAL POWER CONNECTION AT UNIT, UNIT-MOUNTED DISCONNECT SWITCH, AND FACTORY INSTALLED MOTOR STARTERS. VAV UNITS SHALL HAVE FACTORY MOUNTED VFD'S WITH H-O-A. RTU-4, 5, 6, 7 SHALL HAVE MULTIPLE POINT EXTERNAL POWER CONNECTIONS AT UNIT.

8. CONTRACTOR SHALL HIRE THE MANUFACTURER'S INSTALLATION TECHNICIAN FOR INSTALLATION AND STARTUP. PROVIDE STARTUP REPORTS TO THE ENGINEER FOR REVIEW AND APPROVAL.

NOTE: ALL IDEAS, DESIGNS, ARRANGEMENTS AND PLANS INDICATED OR

REPRESENTED BY THIS DRAWING ARE OWNED BY AND ARE THE PROPERTY OF KG+D ARCHITECTS, PC (KG+D), AND WERE CREATED FOR USE ON THIS

HARRISON

RECREATION &

COMMUNITY

CENTER

New Construction - Phase 2

Town / Village of Harrison

270 Harrison Avenue Harrison, NY 10528

100 Summit Lake Drive, Suite 102

8 W. 38th St, Suite 900, New York, NY 10018

CONSTRUCTION DOCUMENTS

Valhalla, NY 10595 914-747-2800

newyorkcity@olace.com


646-849-4110

PROJECT. NONE OF SUCH IDEAS, DESIGNS, ARRANGEMENTS OR PLANS SHALL BE USED BY OR DISCLOSED TO ANY PURPOSE WHATSOEVER WITHOUT THE WRITTEN PERMISSION OF KG+D. SCALED DIMENSIONS. CONTRACTOR SHALL VERIFY ALL ACTUAL DIMENSIONS AND CONDITIONS ON THE JOB AND THE ARCHITECT MUST BE NOTIFIED OF ANY

ALTERATIONS BY ANY PERSON, IN ANY WAY, OF ANY ITEM CONTAINED ON THIS DOCUMENT, UNLESS ACTING UNDER THE DIRECTION OF THE LICENCED ARCHITECT WHOSE PROFESSIONAL SEAL IS AFFIXED HERETO, IS A VIOLATION OF TITLE VII, SECT. 69.5 (b) OF NEW YORK STATE LAW.

BE SUBMITTED TO THIS OFFICE FOR APPROVAL BEFORE PROCEEDING WITH

Professional Seal

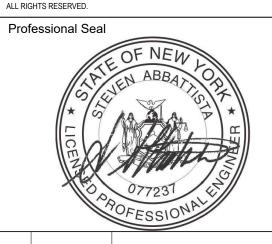

12/13/2024 PERMIT ADDENDUM 10/09/2024 ISSUED FOR CONSTRUCTION 10/09/2024 | CONFORMED SET

06/05/2024 ISSUED FOR BID 3 01/16/2024 ISSUED FOR PERMIT 06/01/2020 DESIGN DEVELOPMENT 03/31/2020 50% DESIGN DEVELOPMENT

MECHANICAL EQUIPMENT NOTES

& SCHEDULES

03/01/2024

Drawn / Checked

AS NOTED HM / RG Sheet Number

NKGD0207.00

M-602