

# NEW YORK CITY NEW YORK CITY DEPARTMENT OF ENVIRONMENTAL PROTECTION BUREAU OF WATER SUPPLY DIVISION OF INFRASTRUCTURE DESIGN & CONSTRUCTION

# CONTRACT NO. CRO-557G TOWN OF MOUNT PLEASANT, NY



**KEY PLAN** 

# WATERFOWL MANAGEMENT PROGRAM BUILDING AND PAVING

JANUARY 2023



**LOCATION PLAN** 

APPROVED FOR THE CITY OF NEW YORK

Todd A. West, P.E., Director

Digitally signed by Todd A. West, Date: 2022.12.20 13:34:31 -05'00'

TODD WEST, P. E. **DIRECTOR - PLANNING BUREAU OF WATER SUPPLY** 

PAUL V. RUSH, P.E. **DEPUTY COMMISSIONER BUREAU OF WATER SUPPLY** 

Digitally signed by Rohit T. Rohit T. Aggarwala Aggarwala Date: 2022.12.27 11:28:57 -05'00'

**ROHIT AGGARWALA COMMISSIONER** NYC DEPARTMENT OF ENVIRONMENTAL PROTECTION

# WATERFOWL MANAGEMENT PROGRAM BUILDING AND PAVING AT KENSICO CAMPUS MOUNT PLEASANT, NY

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28	L1-301	DETAILS SHEET 1	69	A1-509	STOREFRONT DETAILS			BID SET  IF SHEET IS LESS THAN 22"x3	(34"
29	L1-302	DETAILS SHEET 2	70	A1-510	INTERIOR WINDOWS AND CLERESTORY ELEVA	TIONS & DETAIL	_S	IT IS A REDUCED PRINT.  SCALE ACCORDINGLY	
		DESIGNED BY:  M LOPEZ  DRAWN BY:  M LOPEZ  M LOPEZ		® ACCOUNTABLE MANAGER	"WARNING-IT IS A VIOLATION, OF THE NEW YORK STATE EDUCATION LAW,	YORK CITY	, V	WATER OWE WATER TOOK WILLIAM TOOK WILLIAM	ANUARY 2023
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		E. BARBOE EDWARD BARBOE, P.E.		PORTFOLIO MANAGER	DIRECTION OF A LICENSED PROFESSIONAL ENGINEER, TO ALTER BUREAU	OF WATER SUPPLY		GENERAL 2	OF No. 80
			<b>7</b> // <b>-</b>	MARK DELBALZO, P.E.	THIS DOCUMENT IN ANY WAY. IF  465 COLUME	BUS AVENUE, SUITE	270	SHEET INDEX DRAWING	

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SHEET INDEX

DRAWING NO.

G1-001

All inquiries regarding this drawing(s) or project should be made to NYC Environmental Protection, Bureau of Engineering Design and Construction.

REVISIONS/DESCRIPTION

Hazen

# LEGEND **EXISTING** CHAINLINK FENCE STOCKADE FENCE SPLIT RAIL FENCE \_\_\_\_\_ 00 \_\_\_\_\_ 00 \_\_\_\_\_ BOTTOM OF CURB LINE TAX LOT LINE OVERHEAD UTILITY LINES SEWER LINE (OF RECORD) STORM DRAIN LINE — SD — SD — SD — WATER LINE (OF RECORD) WATER LINE (TONE OUT) GAS LINE (TONE OUT) ——— GAS——— GAS——— BUILDING SAW CUT LINE LIMIT OF WORK ELEVATION TOP OF CURB ELEVATION BOTTOM OF CURB ELEVATION

\* SEE INDIVIDUAL SHEETS FOR PROPOSED LEGEND ITEMS.

## **ABBREVIATIONS**

ABANDONED ABDN. AHEAD AMERICAN SOCIETY FOR TESTING AND MATERIALS ASTM AS ORDER BY THE ENGINEER AOBE ASPHALT ASPH. BACK BASE LINE BITUMINOUS BUILDING BLDG. BLOCK BLK. BOTTOM OF CURB **BOTTOM OF WALL** BW BOTTOM OF SIDEWALK ELEVATION CATCH BASIN CENTER LINE CENTER TO CENTER CHAIN LINK FENCE C.L.F. CLEARANCE CONC. CONCRETE CONCRETE SIDEWALK C.SW. CONCRETE CURB DIAMETER DRAWING DROP CURB D.C. DRYWELL DW. EDGE OF PAVEMENT E.O.P. ELEVATION ELEV ELECTRIC PULL BOX EPB **EXISTING** EXIST. FIELD INLET FRAME GAS VALVE GRD GROUND ELEVATION HIGH-DENSITY POLYETHYLENE HDPE HORZ HORIZONTAL INVERT ELEVATION LINEAR FEET LINEAR LONG MANHOI F MAX. MAXIMUM MINIMUM MIN. NEW YORK CITY DEPARTMENT OF ENVIRONMENTAL PROTECTION NYCDEP N.T.S. NOT TO SCALE ON CENTER OSHA OCCUPATIONAL SAFETY AND HEALTH ADMINISTRATION PAVT. PAVEMENT POUNDS POUNDS PER SQUARE INCH RCA RECYCLED CONCRETE AGGREGATE REINFORCED CONCRETE PIPE RIM ELEVATION RDWY. ROADWAY STONE UNDERDRAIN SAN SANITARY SWR. SEWER SPECIFICATIONS SPECS. SQ SQUARE STD. STANDARD ST.W. STORM WATER TOP OF CURB TOP OF WALL TYPICAL UPB UNKNOWN PULL BOXES VAC. VACANT VAR **VARIES** VIF VERIFY IN FIELD VERT VERTICAL WATER VALVE WWF WELDED WIRE FABRIC WWM WELDED WIRE MESH

#### **GENERAL NOTES**

- DEMOLITION AND REMOVALS / SITE CLEARING INCLUDES BUT IS NOT LIMITED TO THE REMOVAL OF SIDEWALK, CURB, PAVEMENT, DRIVEWAYS, PIPE. MANHOLES, AND OTHER SUBSURFACE STRUCTURES, TREES, BRUSH, ROOTS, DEBRIS, VEGETATION, EXISTING LIGHTS AND POLES AND ALL OTHER ITEMS REQUIRED TO CONSTRUCT THE PROJECT AND/OR AS SHOWN IN THE PLANS, SEE SPECIFICATION SECTION 02222 AND 02230 FOR REQUIREMENTS.
- 2. DEMOLITION AND REMOVALS AND EXCAVATION INCLUDES BUT IS NOT LIMITED TO EXCAVATION REQUIRED FOR SOIL RESTORATIONS, NEW MANHOLES, INLETS, OR DRAINAGE PIPES. ALL VOIDS CREATED BY THE REMOVAL OF EXISTING STORM DRAINS AND SUBSURFACE STRUCTURES SHALL BE BACKFILLED WITH SUITABLE EXCAVATION MATERIAL AS DIRECTED BY THE ENGINEER. IF NO SUITABLE EXCAVATION IS AVAILABLE IN THE OPINION OF ENGINEER, THE CONTRACTOR SHALL PROVIDE SATISFACTORY SOIL MATERIAL MEETING THE REQUIREMENTS OF THE SPECIFICATIONS FOR USE AS BACKFILL, ALL EXCAVATION SHALL COMPLY WITH OSHA REQUIREMENTS. EXPLOSIVES SHALL NOT BE ALLOWED FOR ROCK EXCAVATION. SEE SPECIFICATIONS SECTION 02222 AND 02316 FOR FULL REQUIREMENTS
- 3. LOCATIONS OF EXISTING UTILITIES AND SEWERS SHOWN ON THE PLANS WERE DETERMINED BY STANDARD SURVEYING METHODS, AVAILABLE RECORDS AND THROUGH SOLICITATION OF THE RESPECTIVE UTILITY OWNERS. THE INFORMATION FOR THE EXACT LOCATION OF THESE UTILITIES IS NOT GUARANTEED TO BE COMPLETE OR CORRECT. THE CONTRACTOR SHALL VERIFY THE EXACT LOCATION OF ALL UTILITIES IN THE FIELD PRIOR TO STARTING CONSTRUCTION.
- 4. THE CONTRACTOR IS RESPONSIBLE FOR PROVIDING ALL FIELD LAYOUT AND VERIFYING ALL EXISTING CONDITIONS IN THE FIELD.
- 5. EXISTING DIMENSIONS, OFFSETS, INVERTS, RADII, ETC. SHALL BE VERIFIED IN THE FIELD PRIOR TO ANY CONSTRUCTION ACTIVITY. ANY DISCREPANCY SHALL BE IMMEDIATELY BROUGHT TO THE ATTENTION OF THE ENGINEER FOR RESOLUTION. ALL NOTIFICATIONS SHALL BE IN WRITING.
- 6. ALL GRADING SHALL BE AS SHOWN ON THE PLANS. THE CONTRACTOR SHALL CAREFULLY DETERMINE ACTUAL GRADING LIMITS BEFORE BEGINNING DEMOLITION AND SITE CLEARING OPERATIONS. CARE SHALL BE TAKEN TO RETAIN EXISTING NATURAL GROWTH AND PREVENT DAMAGE TO TREES OUTSIDE THE PROJECT LIMITS. ANY DAMAGE CAUSED TO THIS NATURAL GROWTH SHALL BE RESTORED AT THE CONTRACTOR'S EXPENSE. ALL AREAS DISTURBED BY THE CONTRACTOR WITHOUT AUTHORIZATION BY THE ENGINEER SHALL BE RESTORED BY THE CONTRACTOR AT HIS EXPENSE.
- 7. WHERE CONSTRUCTION CROSSES OR IS ADJACENT TO AN EXISTING ELECTRIC, GAS, COMMUNICATIONS, OR OTHER UTILITY LINE, THE CONTRACTOR SHALL CAREFULLY HAND EXCAVATE TO LOCATE, MARK AND PROTECT THE UTILITY LINE AGAINST DISTURBANCE OR DAMAGE BY PROVIDING ADEQUATE SUPPORT AND PROTECTION AS APPROVED BY THE ENGINEER. THE CONTRACTOR SHALL REPAIR ANY ELECTRIC POWER INTERRUPTION IMMEDIATELY, AT NO ADDITIONAL COST TO THE CONTRACT.
- 8. THE CONTRACTOR SHALL COORDINATE THE LOCATIONS OF TREES AND OTHER PLANTINGS WITH THE DRAINAGE, INCLUDING UNDERGROUND DRAINAGE.
- 9. THE CONTRACTOR SHALL RESTORE ALL PUBLIC OR PRIVATE PROPERTY DAMAGED OR REMOVED TO AT LEAST AS GOOD A CONDITION AS BEFORE BEING DISTURBED, AS DETERMINED BY THE ENGINEER. ANY DAMAGED TREES, SHRUBS, AND/OR HEDGES SHALL BE REPLACED AT THE CONTRACTOR'S EXPENSE. NO WORK SHALL BE PERFORMED ON OTHER PROPERTIES AND BUILDINGS WITHOUT THE PROPER AUTHORIZATION.
- 10. CONTRACTOR SHALL EXERCISE CARE TO MINIMIZE CLEARING, SPECIFIC TREES AND ITEMS TO BE CLEARED MUST BE APPROVED BY THE ENGINEER
- 11. THE CONTRACTOR SHALL COMPLY WITH ALL REQUIRED PERMITS FROM LOCAL, STATE AND FEDERAL AGENCIES, AS REQUIRED. THE CONTRACTOR SHALL BE RESPONSIBLE FOR OBTAINING AND INCURRING THE COST OF ALL REQUIRED PERMITS, INSPECTIONS, CERTIFICATES, ETC.
- 12. THE CONTRACTOR SHALL PROTECT EXISTING SURVEYING AND PROPERTY LINE MONUMENTATION. ANY EXISTING SURVEYING AND PROPERTY LINE MONUMENTATION THAT IS DISTURBED OR DESTROYED, AS JUDGED BY THE ENGINEER, SHALL BE REPLACED AT THE CONTRACTOR'S EXPENSE UNDER THE SUPERVISION OF A NEW YORK STATE LICENSED LAND SURVEYOR.
- 13. BEFORE PLANNING OR PROCEEDING WITH ANY EXCAVATION WORK, THE CONTRACTOR SHALL NOTIFY THE "CALL BEFORE YOU DIG" NUMBER AT 811 A MINIMUM OF FIVE WORKING DAYS PRIOR TO ANY EXCAVATION OPERATIONS.
- 14. ALL TRENCH EXCAVATION AND ANY REQUIRED SHEETING AND SHORING SHALL BE DONE IN ACCORDANCE WITH THE LATEST REVISIONS OF NEW YORK STATE INDUSTRIAL CODE RULE 23 AND OSHA REGULATIONS FOR CONSTRUCTION AND IN ACCORDANCE WITH THE SPECIFICATIONS.
- 15. CONTRACTOR IS RESPONSIBLE FOR DEWATERING AND THE MAINTENANCE OF SURFACE DRAINAGE DURING THE COURSE OF WORK, IF REQUIRED, IN ACCORDANCE WITH THE SOIL EROSION AND SEDIMENTATION CONTROL PLANS AND DETAILS.
- CONTRACTOR SHALL GRADE ALL AREAS ON THE SITE TO MAINTAIN POSITIVE DRAINAGE.
- 17. ALL CONFINED SPACE ENTRIES SHALL BE MADE IN STRICT ACCORDANCE WITH OSHA REGULATIONS REGARDING CONFINED SPACE ENTRY.
- 18. ALL WORK SHALL BE DONE IN STRICT COMPLIANCE WITH ALL APPLICABLE NYSDOT AND LOCAL SPECIFICATIONS, AS THEY MAY APPLY.
- 19. CONTRACTOR SHALL MAINTAIN PEDESTRIAN AND VEHICLE ACCESS TO THE SITE AT ALL TIMES IN A MANNER ACCEPTABLE TO THE ENGINEER.
- 20. CONTRACTOR SHALL TAKE GREAT CARE TO MAINTAIN A SAFE AND SECURE WORK AREA AT ALL TIMES THROUGH THE USE OF BARRICADES AND
- 21. THE CONTRACTOR SHALL COMPLY WITH THE CONDITIONS AS SET FORTH IN THE PERMITS ISSUED BY THE REGULATORY AGENCIES, IF ANY.
- 22. PROVIDE SPECIAL INSPECTIONS AS FOLLOWS AS PER TOWN OF MOUNT PLEASANT BUILDING DEPARTMENT REQUIREMENTS, SPECIFICATIONS AND
- 23. HORIZONTAL DATUM IS NAD-83 NEW YORK EAST ZONE 3101. VERTICAL DATUM IS NAVD 88, EXPRESSED IN US FEET
- 24. THE CONTRACTOR SHALL DO TEST PIT FOR UTILITY CONFLICTS PRIOR TO CONSTRICTION ACTIVITIES.
- 25. KENSICO RESERVOIR IS RECOGNIZED AS A REGULATED WATERCOURSE BY THE NEW YORK STATE DEPARTMENT OF ENVIRONMENTAL CONSERVATION AND A REGULATED WETLAND BY THE TOWN OF MOUNT PLEASANT. BOTH ENTITIES REQUIRE A 50 FOOT BUFFER FOR ALL CONSTRUCTION ACTIVITIES NEAR THE MAXIMUM RESERVOIR ELEVATION OF 357 FEET. THE CONTRACTOR SHALL NOT PERFORM ANY CONSTRUCTION ACTIVITIES WITHIN 50 FEET OF THE 357 FOOT CONTOUR WITHOUT EXPLICIT DIRECTION FROM THE ENGINEER.

GEDEON GRC CONSULTING ENGINEERS . PLANNERS . CONSTRUCTION MANAGERS 6901 JERICHO TURNPIKE, SUITE 216 SYOSSET, N.Y. 11791

DRAWN BY:

I. CAUSARANO C. DEBONA CHECKED BY: **DESIGN LEAD:** R. GEDEON I. LAPADULA Hazen REVISIONS/DESCRIPTION NO. DATE APPR'D

**DESIGNED BY:** 



ACCOUNTABLE MANAGER JOSE NIEVES PROJECT MANAGER MARK DELBALZO, P.E.

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## **NEW YORK CITY ENVIRONMENTAL PROTECTION**

**BUREAU OF WATER SUPPLY** 465 COLUMBUS AVENUE, SUITE 270 VALHALLA, NEW YORK 10595-1336 www.nyc.gov/dep

WATERFOWL MANAGEMENT PROGRAM BUILDING

**BID SET** 

AND PAVING MOUNT PLEASANT, NEW YORK

IF SHEET IS LESS THAN 22" X 34"

IT IS A REDUCED PRINT.

SCALE ACCORDINGLY

GENERAL NOTES, LEGENDS, AND ABBREVIATIONS


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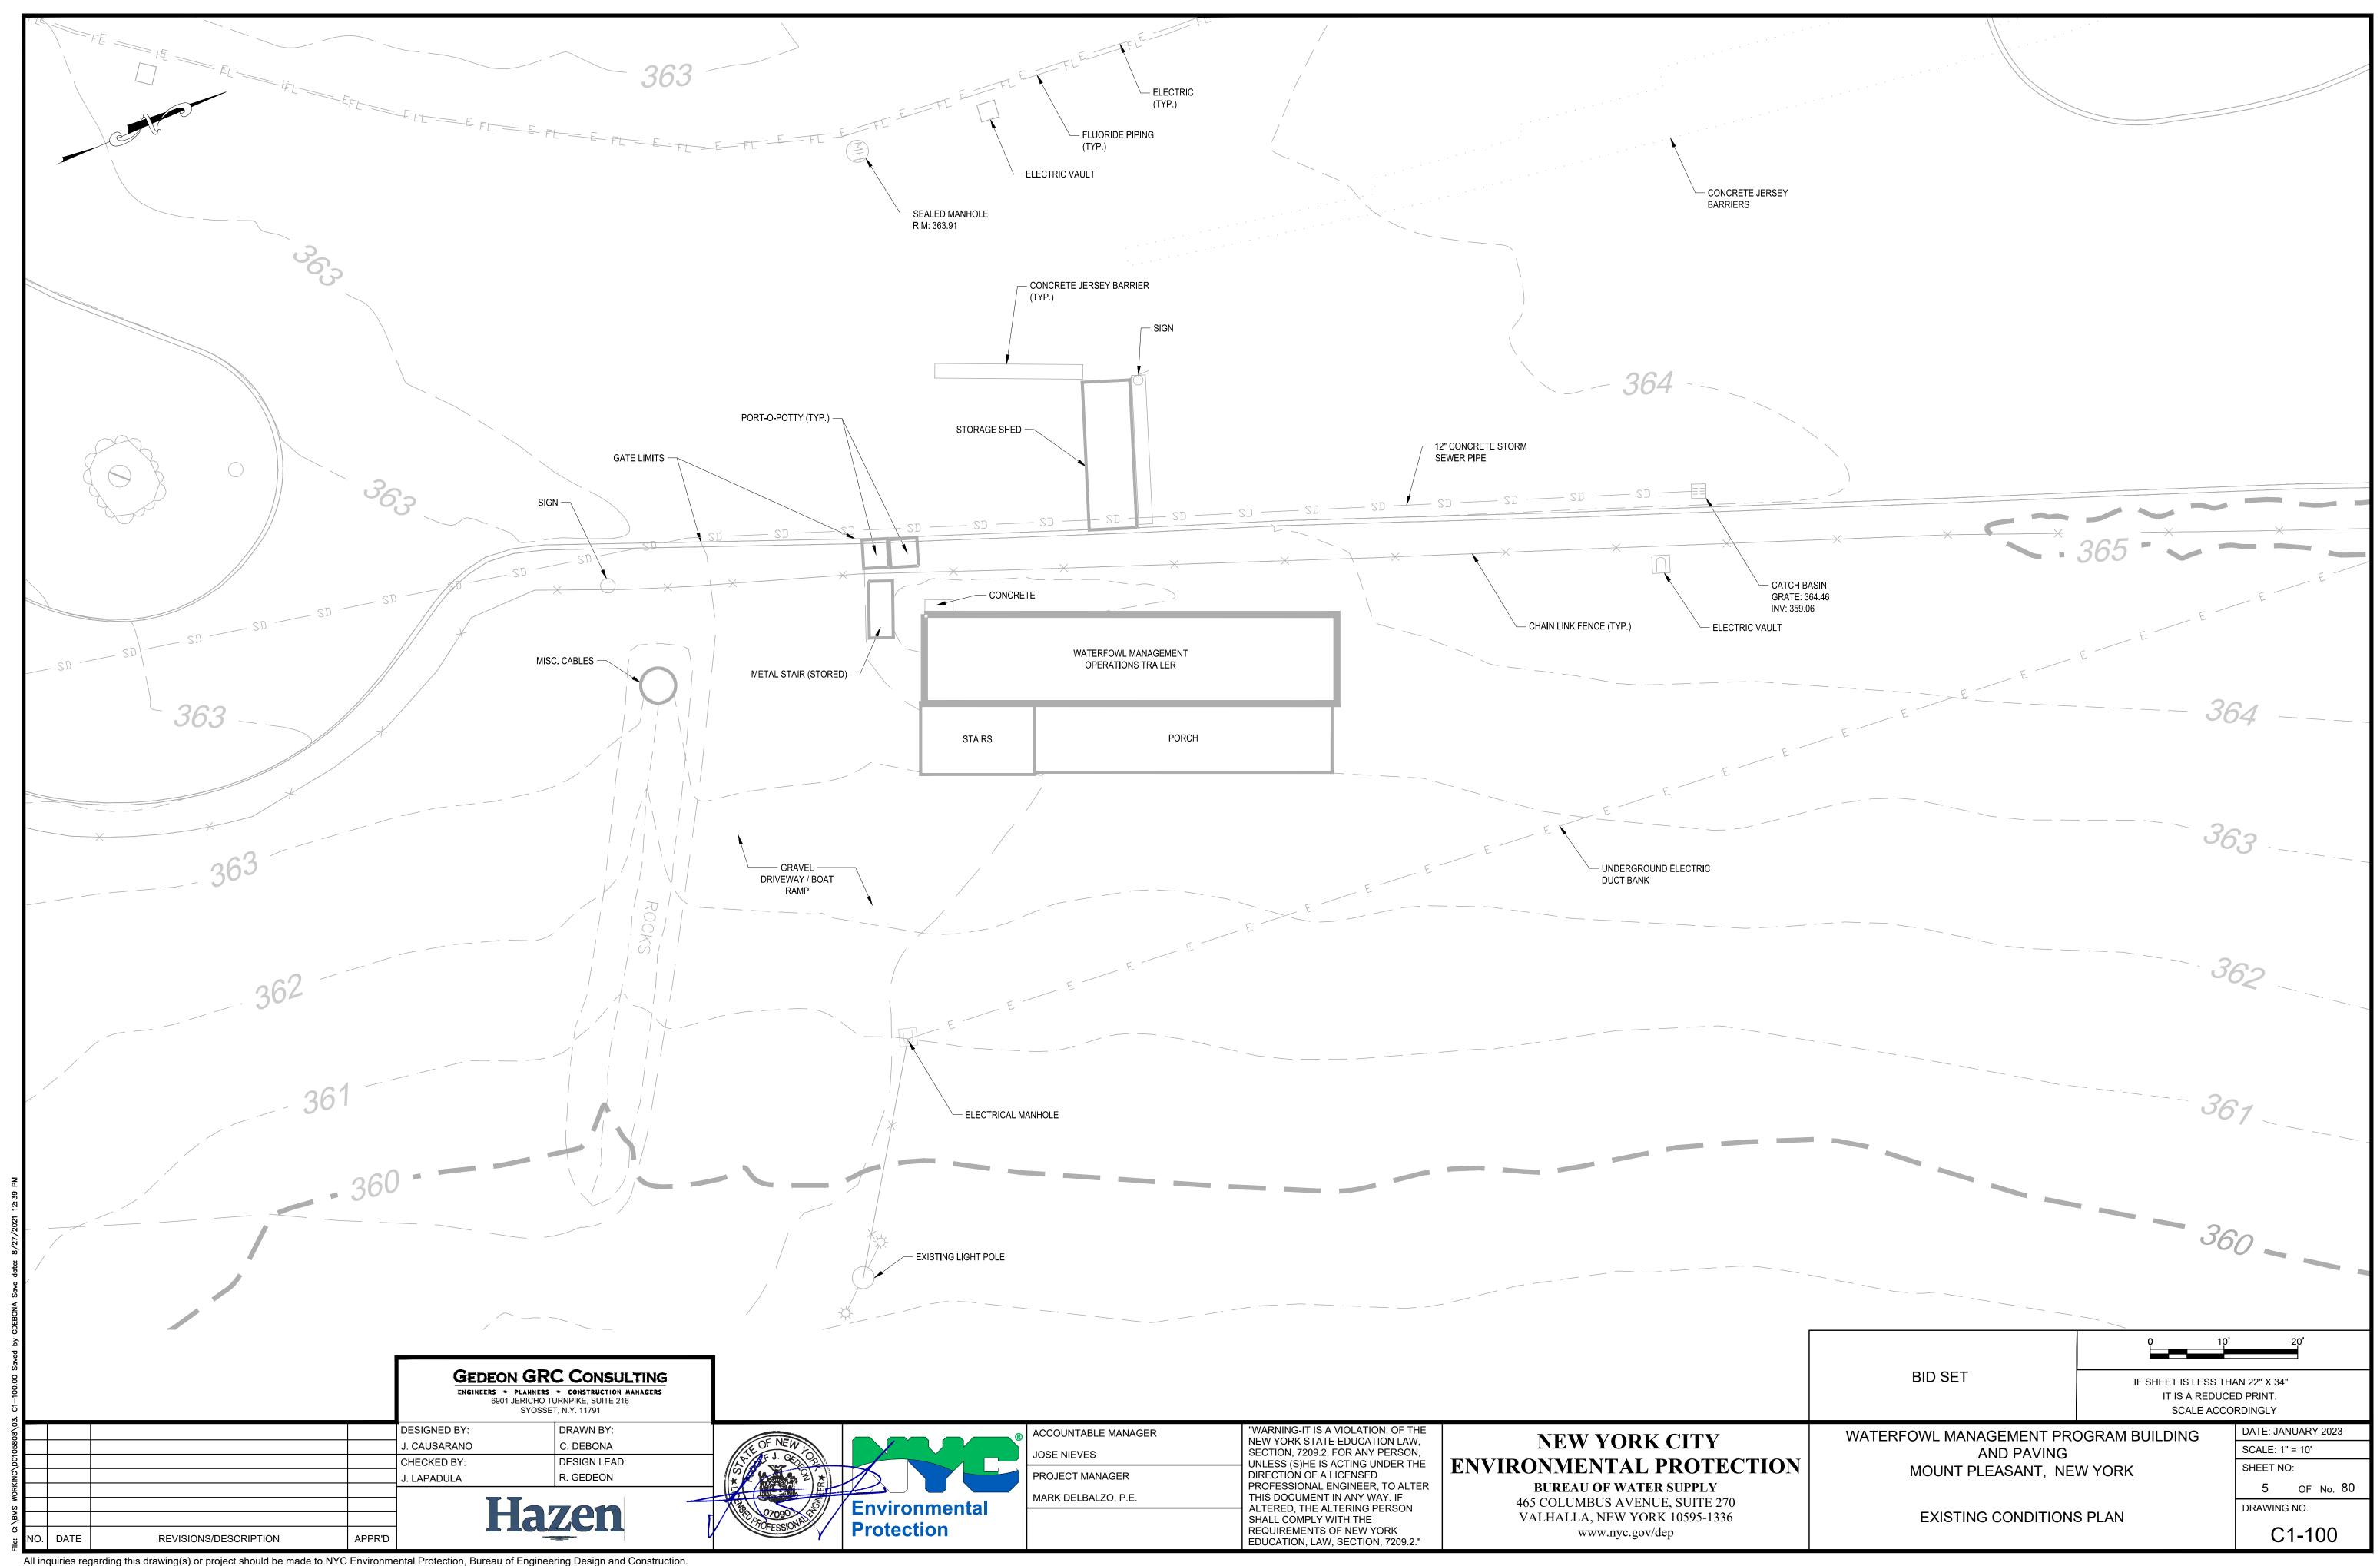
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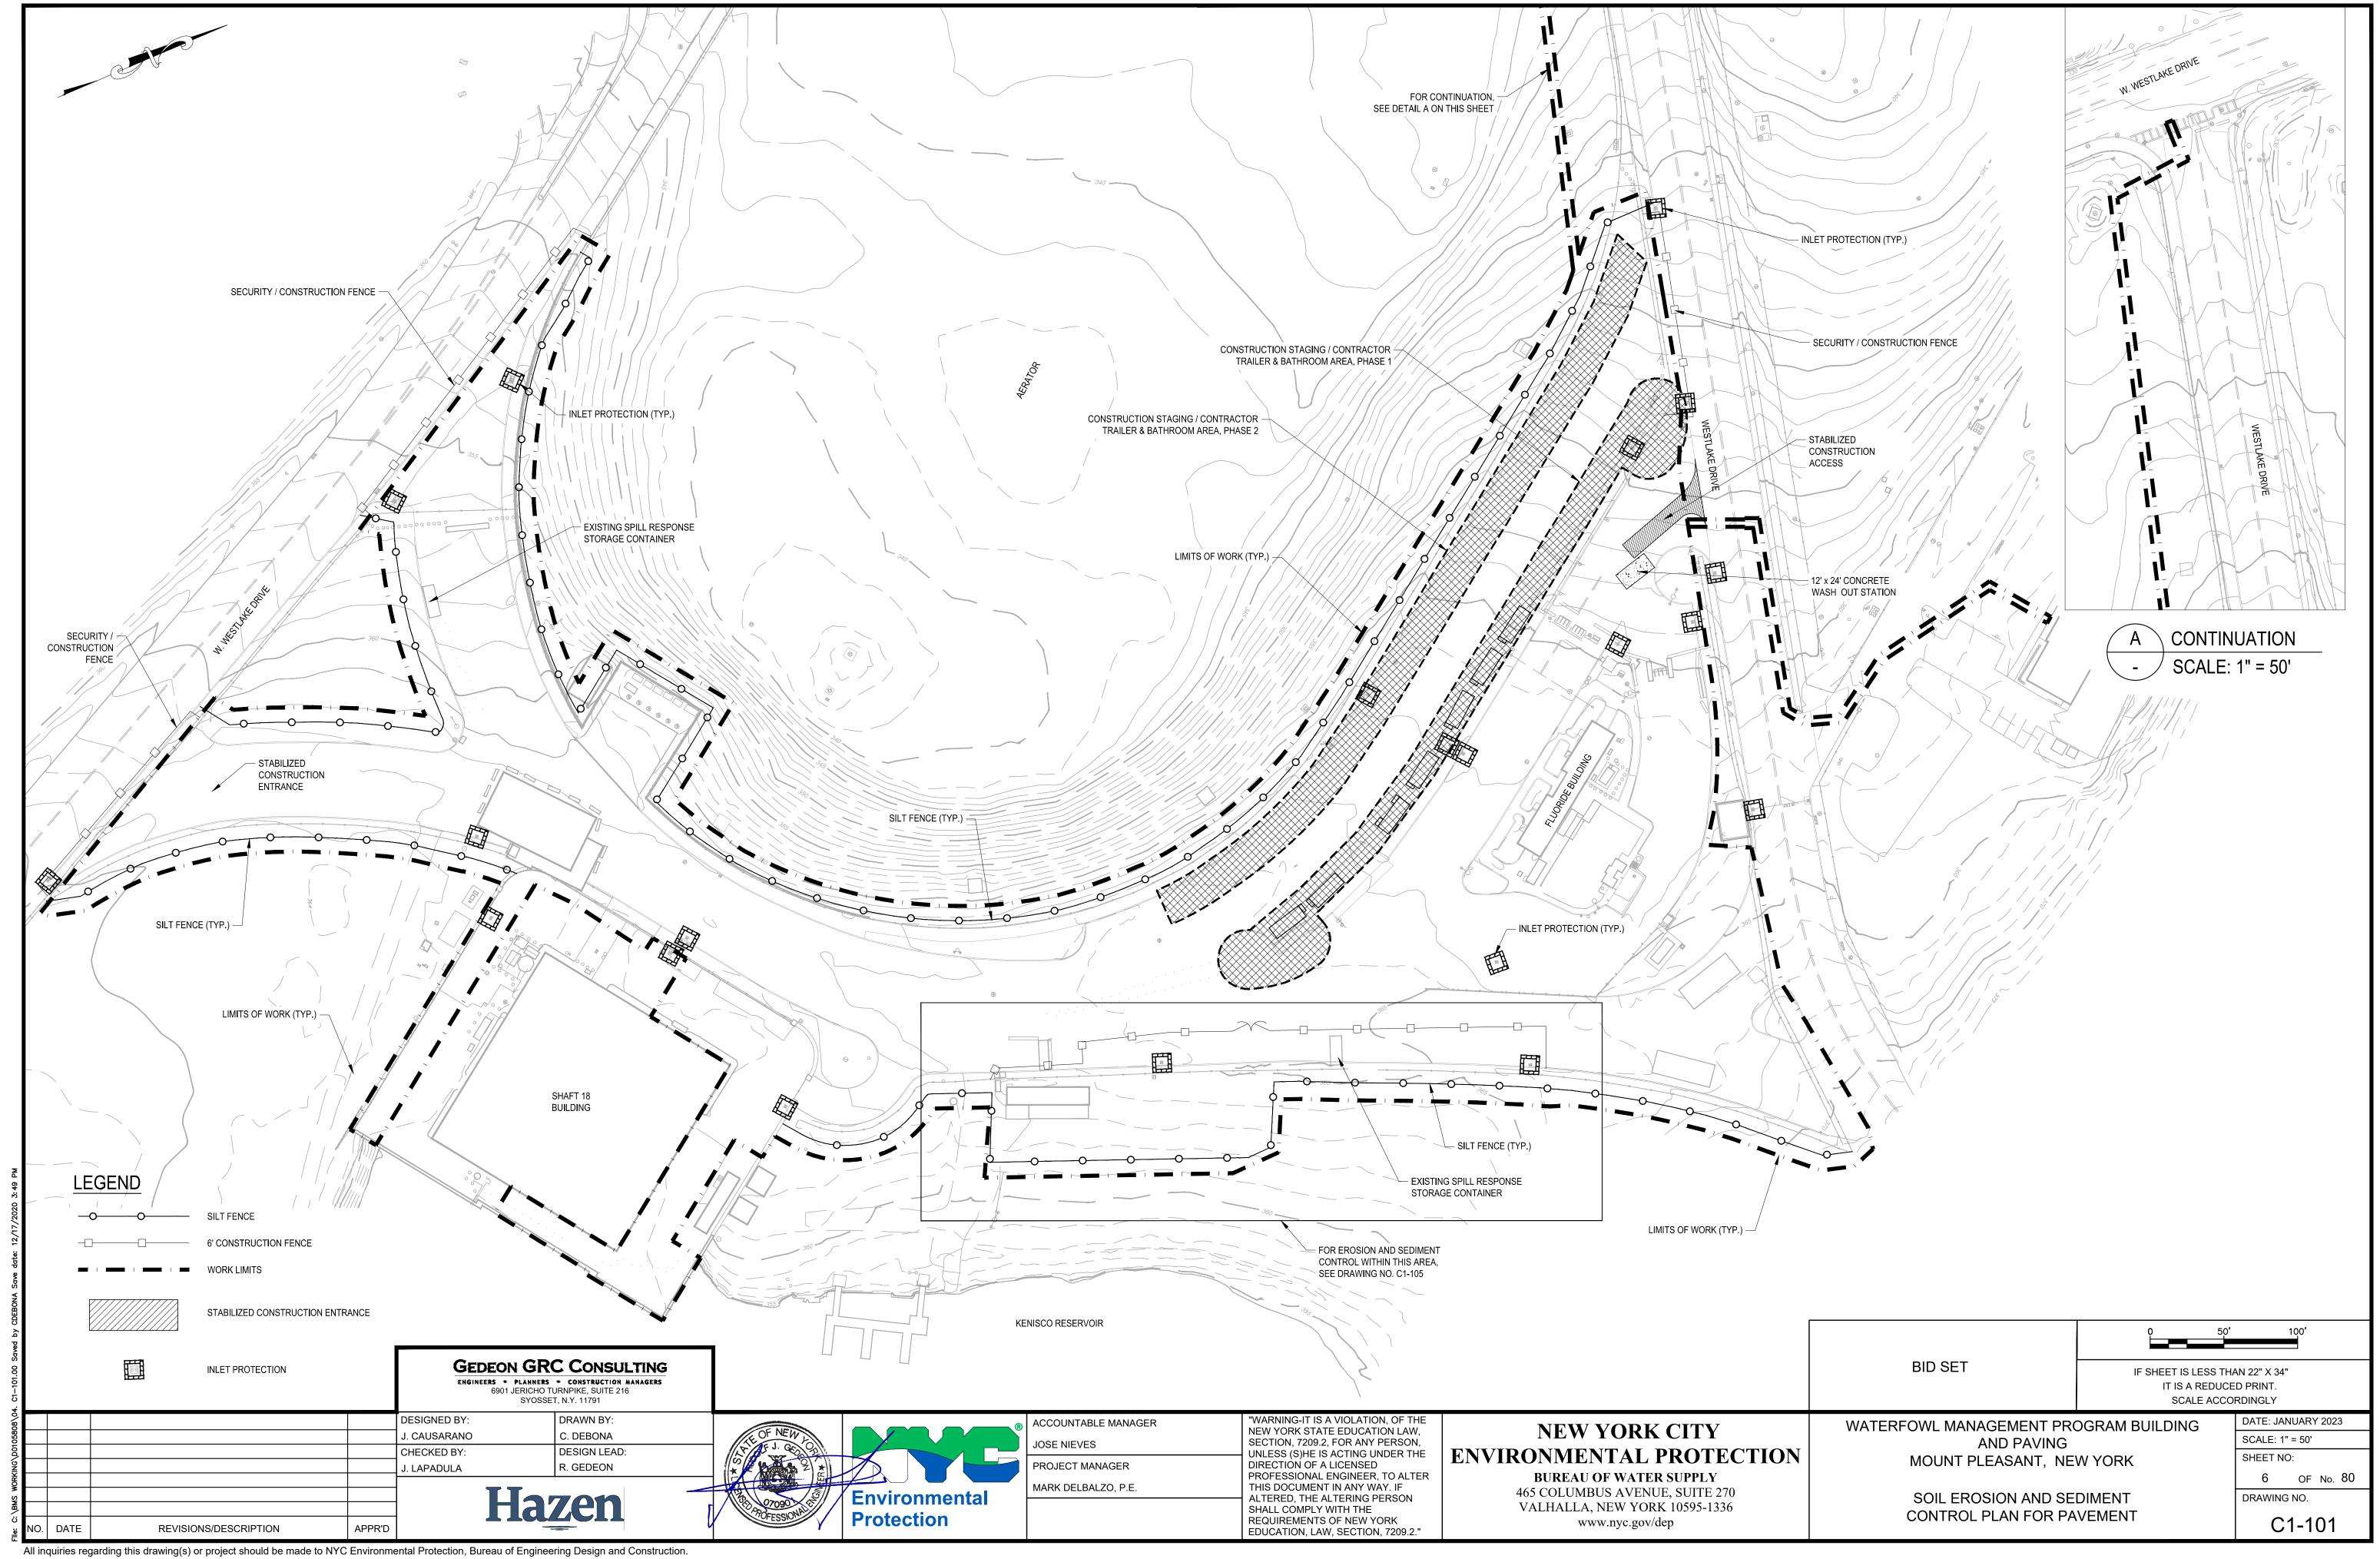
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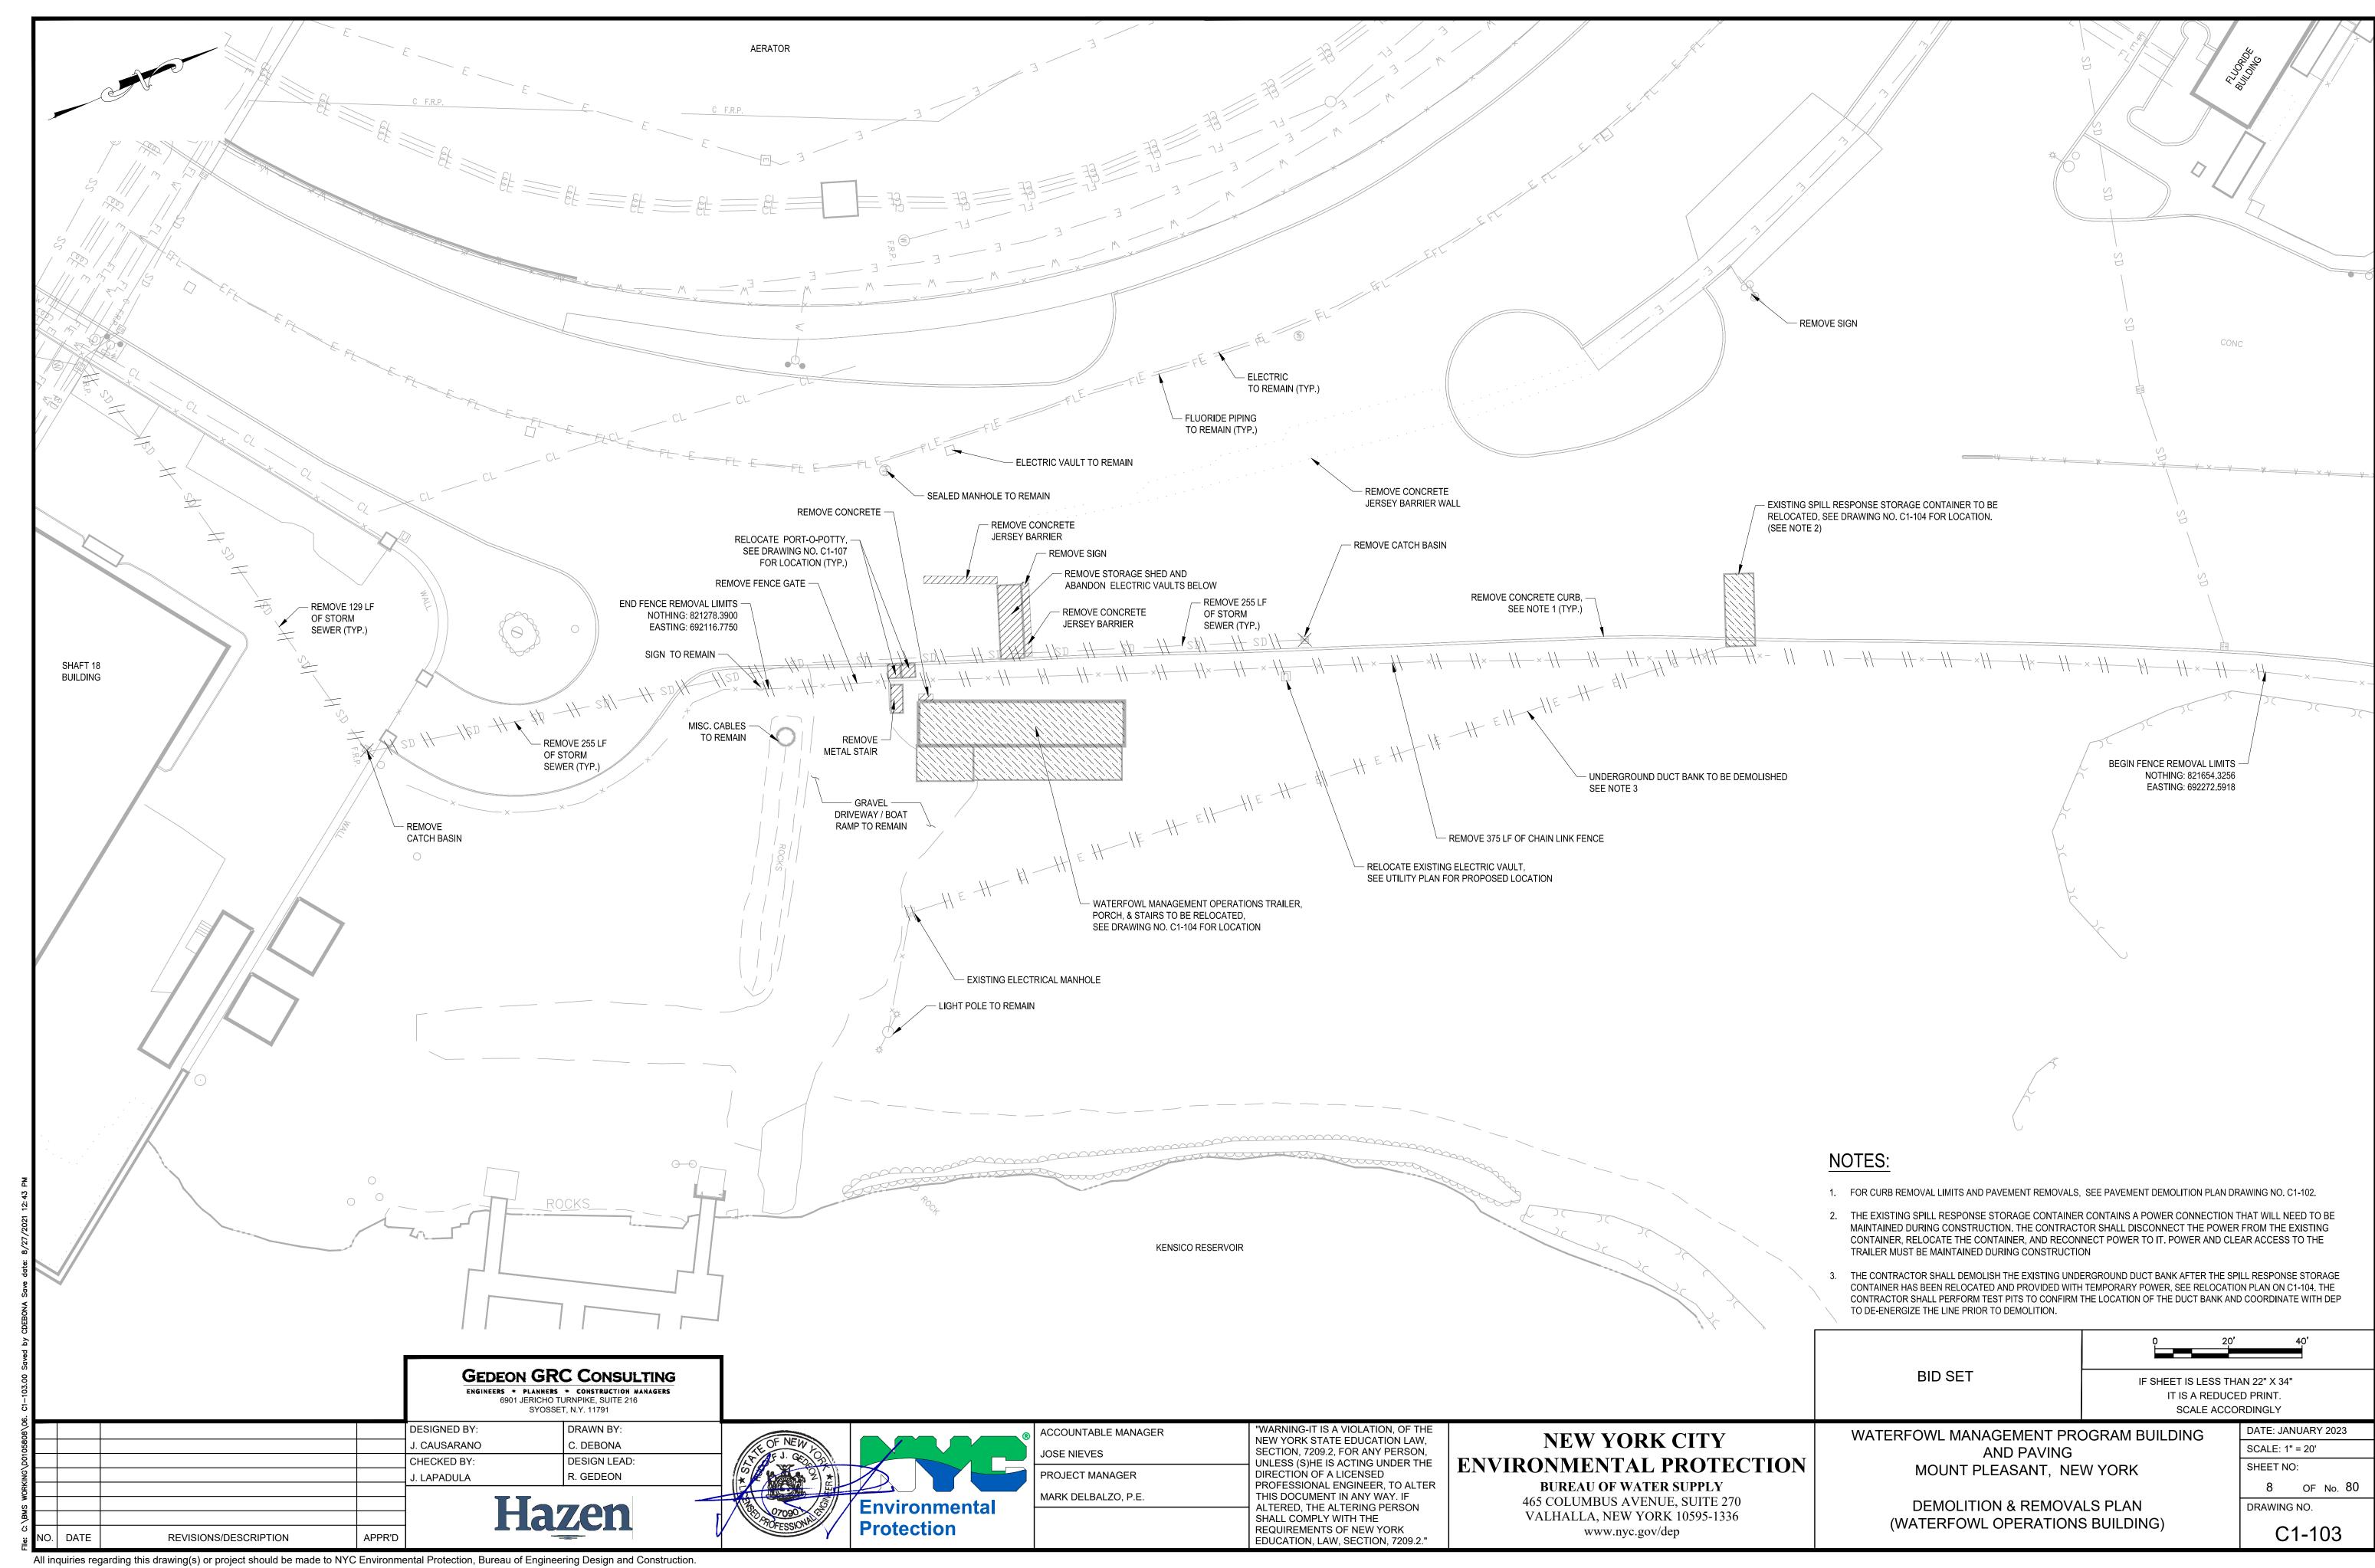
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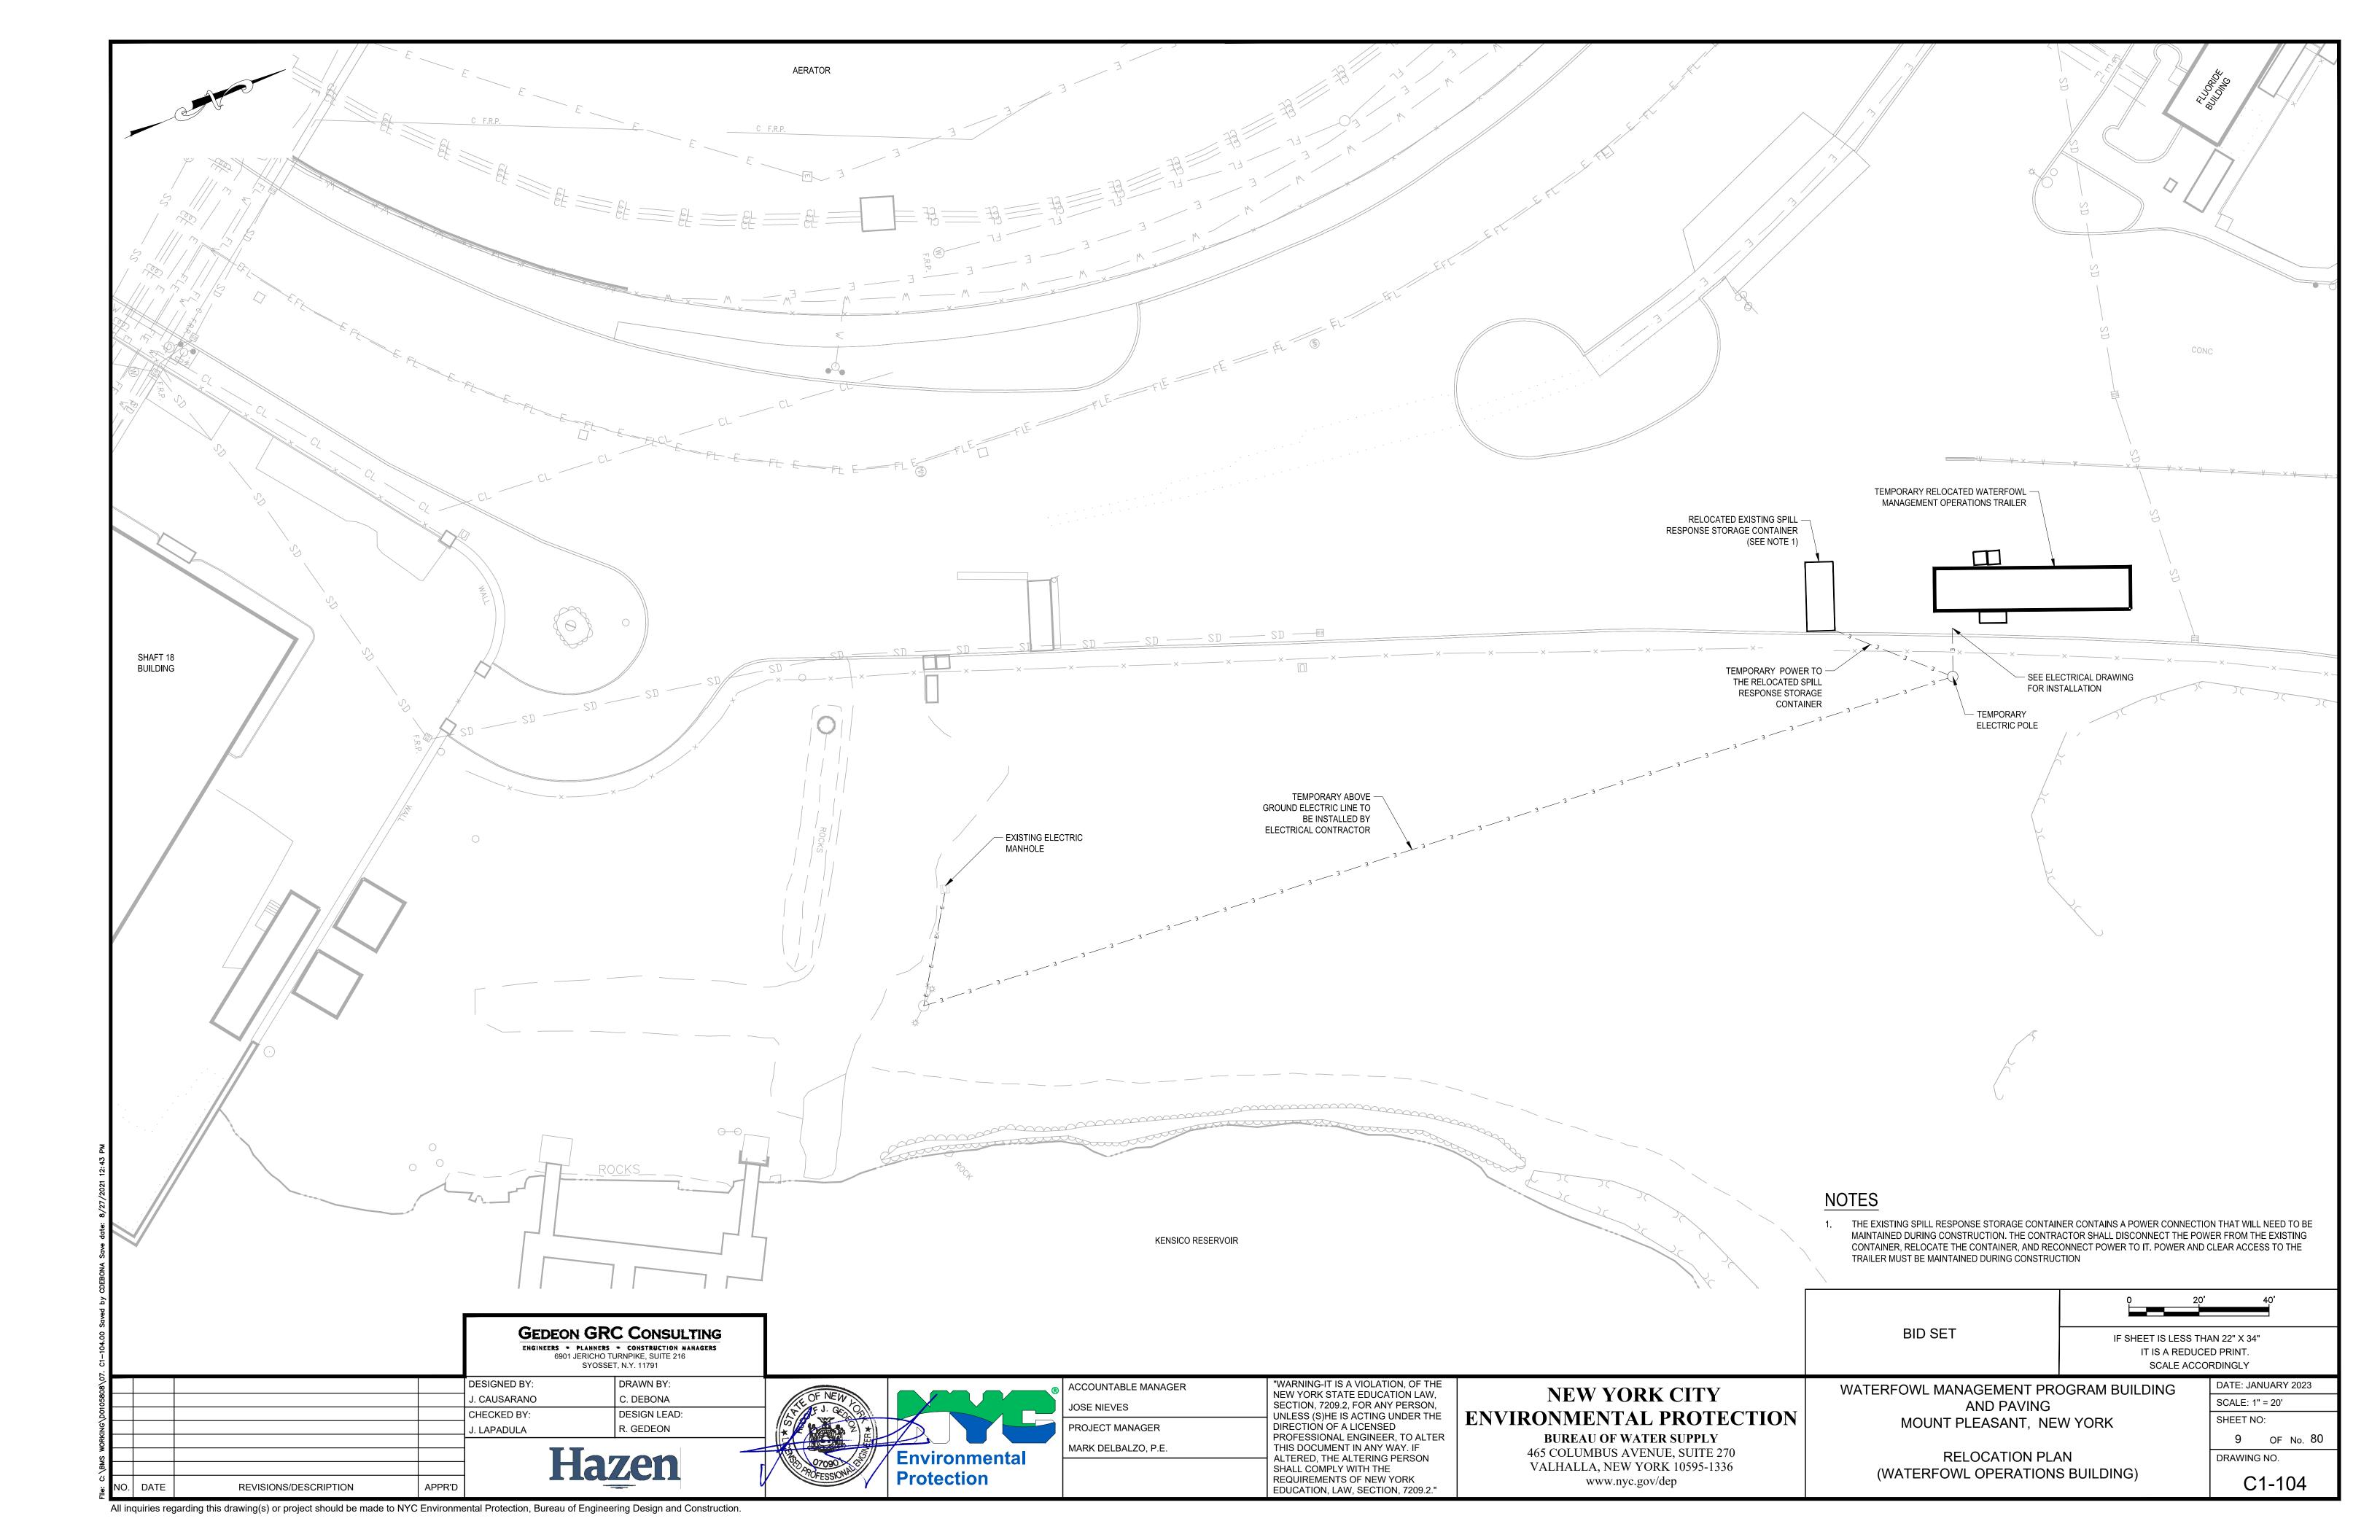









#### SOIL EROSION & SEDIMENT CONTROL NOTES: **LEGEND** DUE TO CONSTRUCTION AND DEMOLITION PHASE REQUIRED BY THIS CONTRACT, IT IS ANTICIPATED THAT THE LOCATION AND NATURE OF O SILT FENCE EROSION AND SEDIMENT CONTROL MEASURES WILL BE ADJUSTED AS REQUIRED TO REFLECT THE CURRENT PHASE OF WORK. THE CONSTRUCTION SCHEDULE ADOPTED BY THE CONTRACTOR WILL IMPACT ON THE PLACEMENT AND NEED FOR SPECIFIC DEVICES 6' CONSTRUCTION FENCE REQUIRED FOR THE CONTROL OF EROSION. THE LOCATION AND EXTENT OF EROSION AND SEDIMENT CONTROL MEASURES SHALL BE REVISED AT EACH PHASE OF CONSTRUCTION THAT RESULTS IN A CHANGE OF EITHER THE QUANTITY OR DIRECTION OF THE SURFACE RUNOFF FROM THE CONSTRUCTION AREAS. WORK LIMITS NO CONSTRUCTION OR LAND DISTURBANCE ACTIVITY MAY BEGIN UNTIL ALL PERIMETER EROSION CONTROL MEASURES HAVE BEEN INSTALLED AS SHOWN ON THE CONTRACT DRAWINGS. MEASURES SHALL INCLUDE BUT NOT LIMITED TO TEMPORARY DIVERSION SWALES, STABILIZED CONSTRUCTION ENTRANCE SILT FENCING, CATCH BASIN PROTECTION AND STABILIZED CONSTRUCTION ENTRANCE. IF CLEARING IS REQUIRED FOR INSTALLATION OF A PARTICULAR MEASURE, ALL MEASURES NOT REQUIRING CLEARING SHALL BE INSTALLED FIRST. CLEARING OF THE NECESSARY LAND FOR INSTALLATION OF THE PARTICULAR MEASURE MAY THEN PROCEED. 3. ALL EROSION CONTROL MEASURES SHALL BE IN PLACE BEFORE ANY LAND CLEARING OR CONSTRUCTION ACTIVITY. INLET PROTECTION CLEARING AND PAVEMENT DEMOLITION SHALL BE LIMITED AS MUCH AS POSSIBLE TO AREAS REQUIRED FOR CURRENT CONSTRUCTION ACTIVITIES. MASS CLEARING, GRADING AND PAVEMENT DEMOLITION SHALL BE AVOIDED. $-\cdot \rightarrow \cdot -\cdot \rightarrow \cdot -\cdot \rightarrow \cdot -$ SED**I**MENT DIKE ALL POINTS OF CONSTRUCTION INGRESS AND EGRESS SHALL BE PROTECTED TO PREVENT THE DEPOSITION OF MATERIALS ONTO TRAVERSED PUBLIC THOROUGHFARE(S) BY INSTALLING AND MAINTAINING A STABILIZED CONSTRUCTION ENTRANCE AND BY WASHING ALL SEDIMENT TRAP VEHICLES WHEELS IN A SAFE DISPOSAL AREA. ALL MATERIALS DEPOSITED ONTO PUBLIC THOROUGHFARE(S) SHALL BE REMOVED IMMEDIATELY. PROPER PRECAUTIONS SHALL BE TAKEN TO ENSURE THAT MATERIALS DEPOSITED ONTO PUBLIC THOROUGHFARE(S) ARE REMOVED SO THAT THEY DO NOT ENTER CATCH BASINS, STORM SEWERS, COMBINED SEWERS OR ROADSIDE SWALES. ALL EROSION CONTROL MEASURES SHALL BE INSPECTED FOLLOWING EVERY RAINFALL, BUT IN NO CASE LESS THAN ONCE EVERY WEEK. CONTROL MEASURES SHALL BE REPAIRED OR REPLACED IMMEDIATELY AS REQUIRED TO MAINTAIN PERFORMANCE OF MEASURE. REMOVED SEDIMENTS SHALL BE DISPOSED OF IN SUCH A MANNER AS TO ENSURE FURTHER SEDIMENT TRANSPORT DOES NOT OCCUR. 8. THE CONTRACTOR SHALL INITIATE STABILIZATION MEASURES AS SOON AS PRACTICABLE IN PORTIONS OF THE SITE WHERE CONSTRUCTION ACTIVITIES HAVE TEMPORARILY OR PERMANENTLY CEASED, BUT IN NO CASE MORE THAN 7 DAYS AFTER THE CONSTRUCTION ACTIVITY IN THAT PORTION OF THE SITE HAS TEMPORARILY OR PERMANENTLY CEASED. THIS REQUIREMENT DOES NOT APPLY IN THE FOLLOWING INSTANCES: THE INITIATION OF STABILIZATION MEASURES BY THE 7TH DAY AFTER CONSTRUCTION ACTIVITY TEMPORARILY OR PERMANENTLY CEASED IS PRECLUDED BY SNOW COVER OR FROZEN GROUND CONDITIONS, STABILIZATION MEASURES SHALL BE INITIATED AS SOON AS PRACTICABLE. LIMITS OF WORK (TYP.) WHERE CONSTRUCTION ACTIVITY ON A PORTION OF THE SITE IS TEMPORARILY CEASED. AND EARTH-DISTURBING ACTIVITIES WILL BE RESUMED WITHIN SEVEN (7) DAYS, TEMPORARY STABILIZATION MEASURES NEED NOT BE INITIATED ON THAT - GATE (LOCKABLE) ALL AREAS SHALL BE FERTILIZED, SEEDED AND MULCHED IN ACCORDANCE WITH THE SPECIFICATIONS, AND RE-SEEDED AS NECESSARY TO - 6' CONSTRUCTION ESTABLISH AND MAINTAIN A VIGOROUS DENSE VEGETATIVE COVER. 10. ALL WORK PERFORMED SHALL BE IN ACCORDANCE WITH THE "NEW YORK STANDARDS AND SPECIFICATIONS FOR EROSION AND SEDIMENT CONTROL" 2016, OR LATEST EDITION AND IN ACCORDANCE WITH THE CONTRACT DOCUMENTS. 11. THE CONTRACTOR SHALL TEMPORARILY REMOVE AND REPLACE REQUIRED SECTION OF FENCE DURING PROXIMITY EXCAVATION. - EXISTING SPILL 12' x 24' CONCRETE 12. THE CONTRACTOR SHALL PROVIDE EROSION CONTROL PROTECTION AGAINST SILT ACCUMULATION ON EXISTING DRAINAGE. RESPONSE STORAGE WASH OUT STATION CONTAINER 13. THE CONTRACTOR SHALL PROVIDE ADJUSTABLE CATCH BASIN DRAIN INSERTS ON THE AFFECTED CATCH BASIN SHOWN ON THE DRAWING AND AS DIRECTED BY THE ENGINEER. 14. ALL GRADED OR DISTURBED AREAS INCLUDING SLOPES SHALL BE PROTECTED DURING CLEARING AND CONSTRUCTION IN ACCORDANCE WITH THE APPROVED EROSION AND SEDIMENT CONTROL PLAN UNTIL THEY ARE PERMANENTLY STABILIZED. 15. ALL SEDIMENT CONTROL PRACTICES AND MEASURES SHALL BE CONSTRUCTED, APPLIED AND MAINTAINED IN ACCORDANCE WITH THE - INLET PROTECTION APPROVED EROSION AND SEDIMENT CONTROL PLAN. WATERFOWL MANAGEMENT 16. TOPSOIL REQUIRED FOR THE ESTABLISHMENT OF VEGETATION SHALL BE STOCKPILED IN AMOUNT NECESSARY TO COMPLETE FINISHED OPERATIONS TRAILER GRADING OF ALL EXPOSED AREAS. STABILIZED -17. AREAS TO BE FILLED SHALL BE CLEARED, GRUBBED, AND STRIPPED OF TOPSOIL TO REMOVE TREES, VEGETATION, ROOTS OR OTHER STAIRS PORCH CONSTRUCTION OBJECTIONABLE MATERIAL. **ENTRANCE** SEDIMENT TRAP, 18. AREAS WHICH ARE TO BE TOPSOILED SHALL BE SCARIFIED TO A MINIMUM DEPTH OF FOUR INCHES PRIOR TO PLACEMENT OF TOPSOIL. SEE DETAIL ON C1-111 - SEDIMENT DIKE 19. ALL FILLS SHALL BE COMPACTED AS REQUIRED TO REDUCE EROSION, SLIPPAGE, SETTLEMENT, SUBSIDENCE OR OTHER RELATED PROBLEMS, FILL INTENDED TO SUPPORT BUILDINGS, STRUCTURES AND CONDUITS, ETC, SHALL BE COMPACTED IN ACCORDANCE WITH DRIVEWAY / BOAT LOCAL REQUIREMENTS OR CODES. 20. ALL FILL SHALL BE PLACED AND COMPACTED IN LAYERS NOT TO EXCEED 9 INCHES IN THICKNESS. 21. FILL MATERIAL SHALL BE FREE OF FROZEN PARTICLES, BRUSH, ROOTS, SOD, OR OTHER FOREIGN OR OTHER OBJECTIONABLE MATERIALS THAT WOULD INTERFERE WITH OR PREVENT CONSTRUCTION OF SATISFACTORY FILLS. 22. FROZEN MATERIALS OR SOFT, MUCKY OR HIGHLY COMPRESSIBLE MATERIALS SHALL NOT BE INCORPORATED IN FILLS. 23. FILL SHALL NOT BE PLACED ON SATURATED OR FROZEN SURFACES. 24. ALL BENCHES SHALL BE KEPT FREE OF SEDIMENT DURING ALL PHASES OF DEVELOPMENT. 25. SEEPS OR SPRINGS ENCOUNTERED DURING CONSTRUCTION SHALL BE HANDLED IN ACCORDANCE WITH THE STANDARD AND SPECIFICATION FOR DEWATERING OR OTHER APPROVED METHOD. 26. ALL GRADED AREAS SHALL BE PERMANENTLY STABILIZED IMMEDIATELY FOLLOWING FINISHED GRADING. 27. STOCKPILES, BORROW AREAS AND SPOIL AREAS SHALL BE SHOWN ON THE PLANS AND SHALL BE SUBJECT TO THE PROVISIONS OF NYSDEC STANDARDS AND SPECIFICATIONS. 28. KENSICO RESERVOIR IS RECOGNIZED AS A REGULATED WATERCOURSE BY THE NEW YORK STATE DEPARTMENT OF ENVIRONMENTAL CONSERVATION AND A REGULATED WETLAND BY THE TOWN OF MOUNT PLEASANT. BOTH ENTITIES REQUIRE A 50 FOOT BUFFER FOR ALL CONSTRUCTION ACTIVITIES NEAR THE MAXIMUM RESERVOIR ELEVATION OF 357 FEET. THE CONTRACTOR SHALL NOT PERFORM ANY CONSTRUCTION ACTIVITIES WITHIN 50 FEET OF THE 357 FOOT CONTOUR WITHOUT EXPLICIT DIRECTION FROM THE ENGINEER. KENSICO RESERVOIR **GEDEON GRC CONSULTING BID SET** IF SHEET IS LESS THAN 22" X 34" ENGINEERS . PLANNERS . CONSTRUCTION MANAGERS IT IS A REDUCED PRINT. 6901 JERICHO TURNPIKE, SUITE 216 SCALE ACCORDINGLY SYOSSET, N.Y. 11791 **DESIGNED BY:** DRAWN BY: 'WARNING-IT IS A VIOLATION, OF THE DATE: JANUARY 2023 ACCOUNTABLE MANAGER WATERFOWL MANAGEMENT PROGRAM BUILDING **NEW YORK CITY** NEW YORK STATE EDUCATION LAW, J. CAUSARANO C. DEBONA SCALE: 1" = 20' SECTION, 7209.2, FOR ANY PERSON, AND PAVING JOSE NIEVES ENVIRONMENTAL PROTECTION CHECKED BY: **DESIGN LEAD:** UNLESS (S)HE IS ACTING UNDER THE SHEET NO: MOUNT PLEASANT, NEW YORK DIRECTION OF A LICENSED ROJECT MANAGER R. GEDEON J. LAPADULA PROFESSIONAL ENGINEER, TO ALTER **BUREAU OF WATER SUPPLY** 7 OF No. 80 MARK DELBALZO, P.E. THIS DOCUMENT IN ANY WAY. IF 465 COLUMBUS AVENUE, SUITE 270 Hazen **Environmental** SOIL EROSION AND SEDIMENT CONTROL PLAN DRAWING NO. ALTERED, THE ALTERING PERSON VALHALLA, NEW YORK 10595-1336 SHALL COMPLY WITH THE (WATERFOWL OPERATIONS BUILDING) **Protection** REQUIREMENTS OF NEW YORK C1-102 www.nyc.gov/dep REVISIONS/DESCRIPTION EDUCATION, LAW, SECTION, 7209.2."




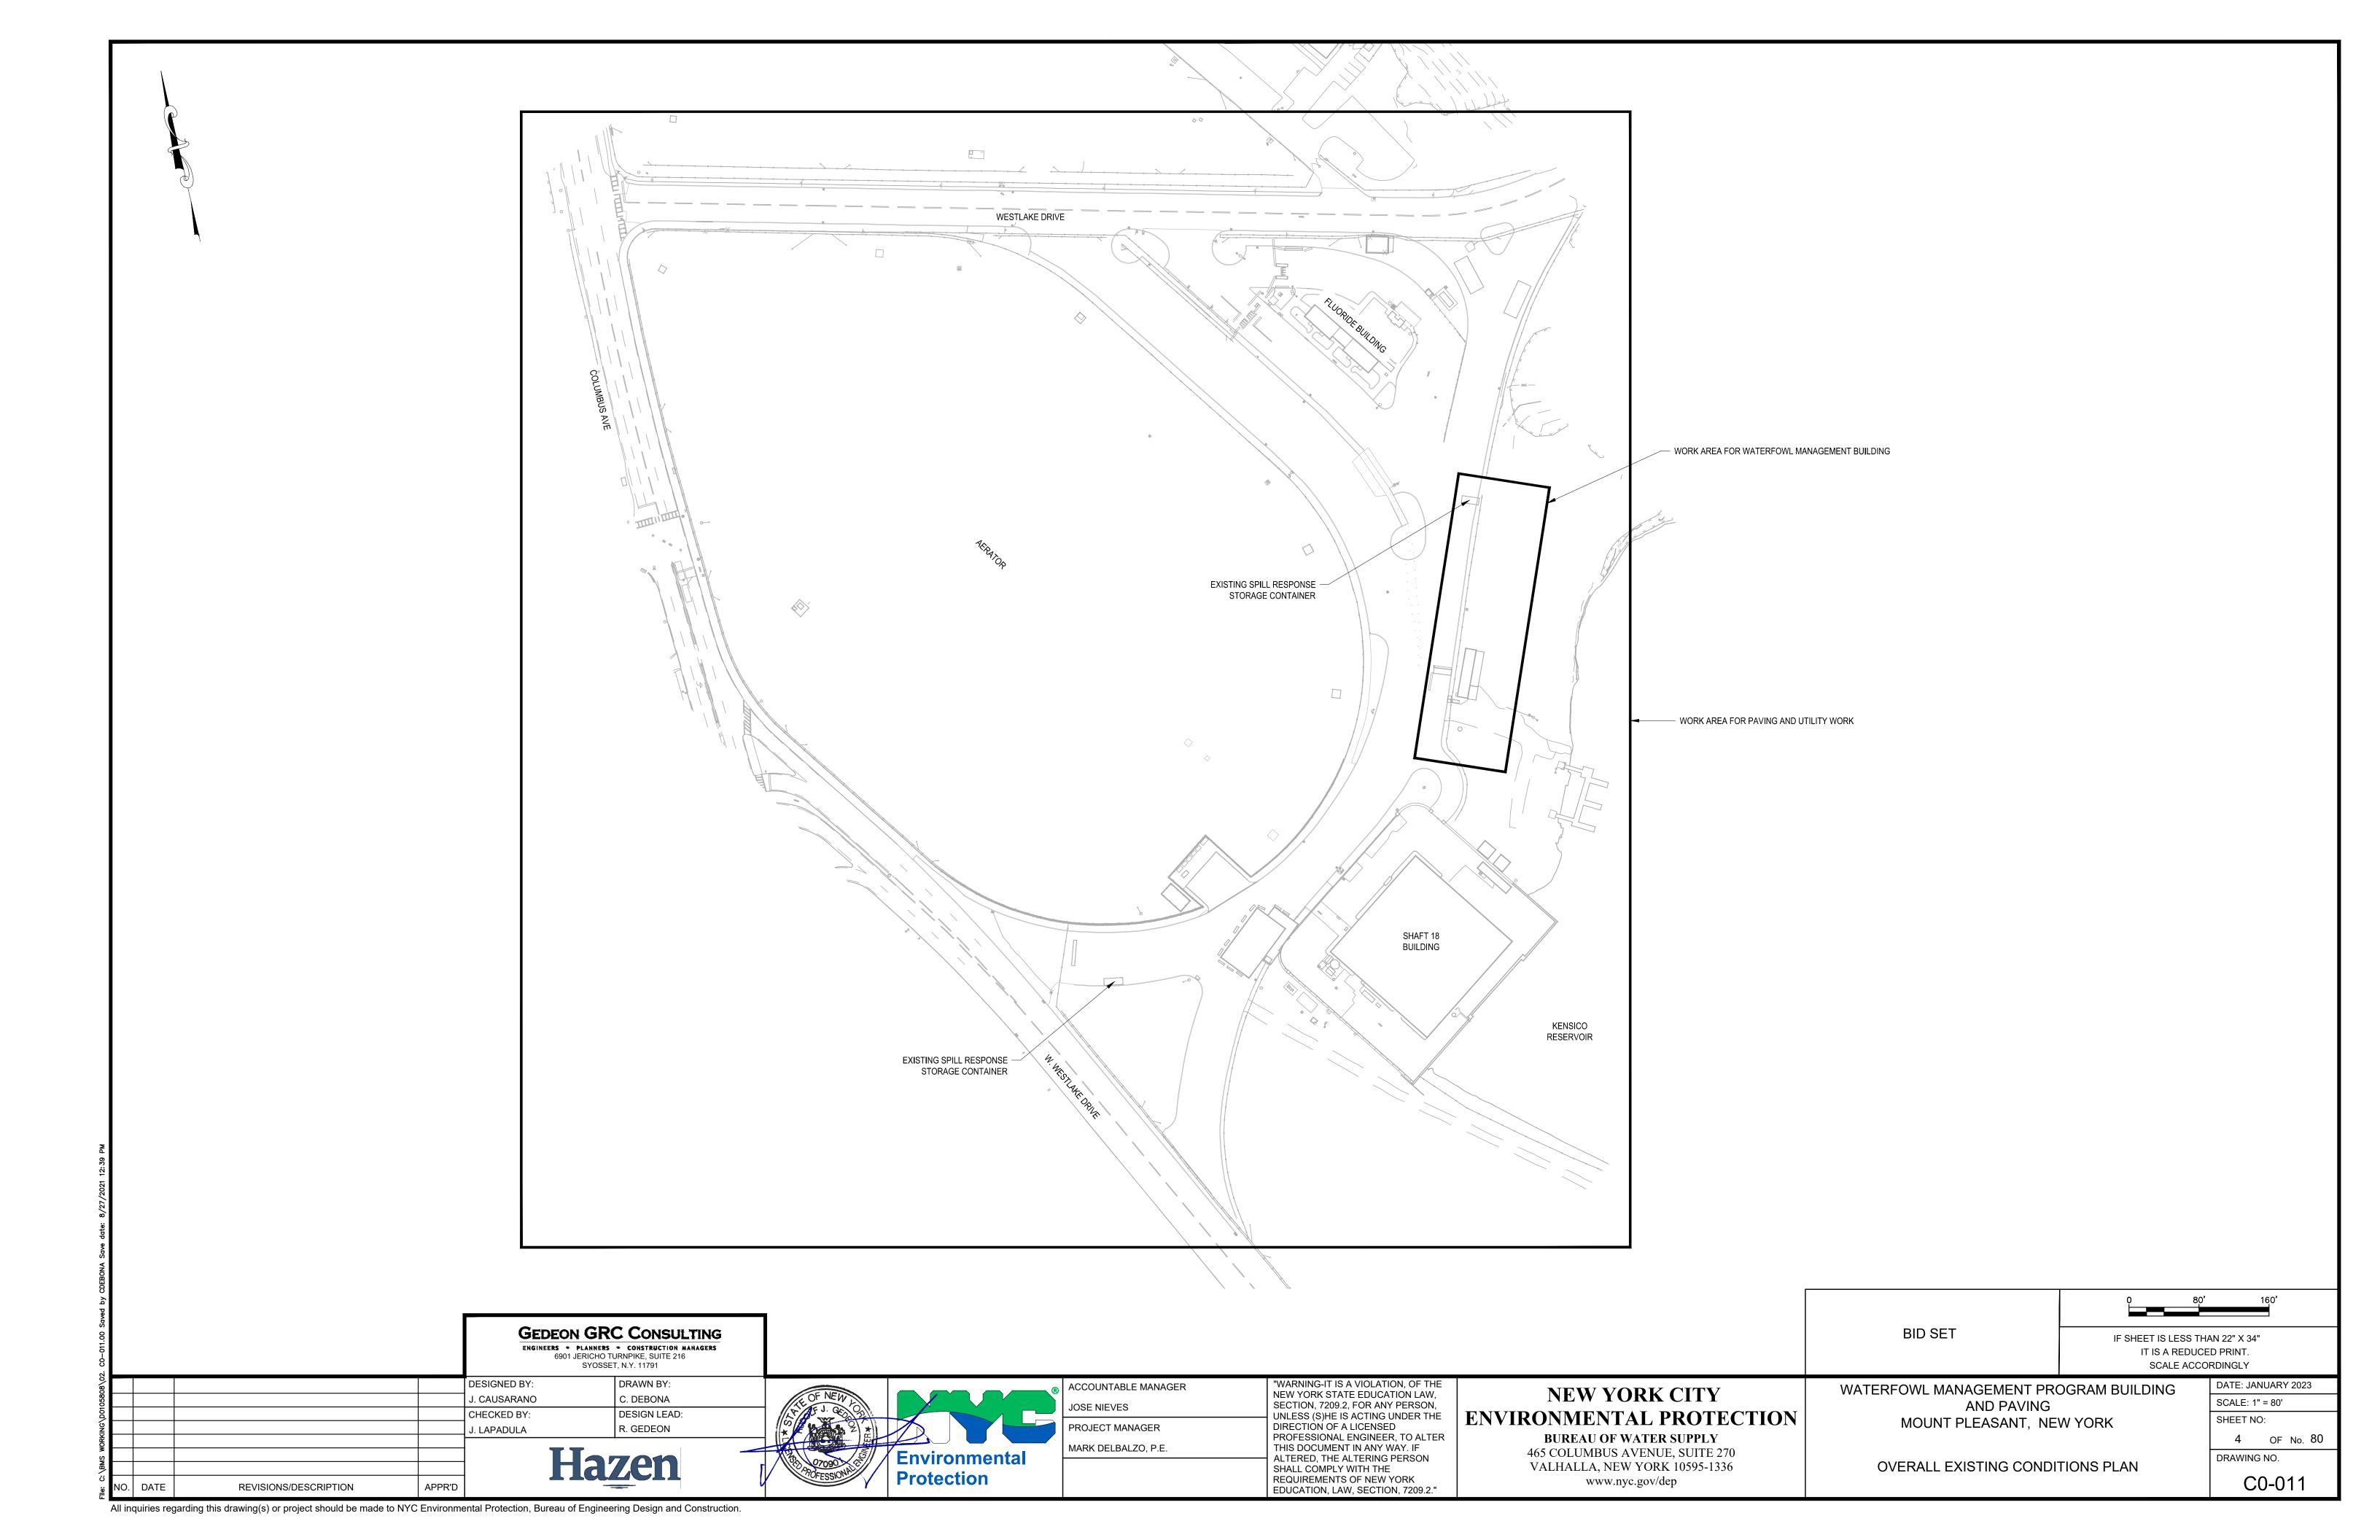


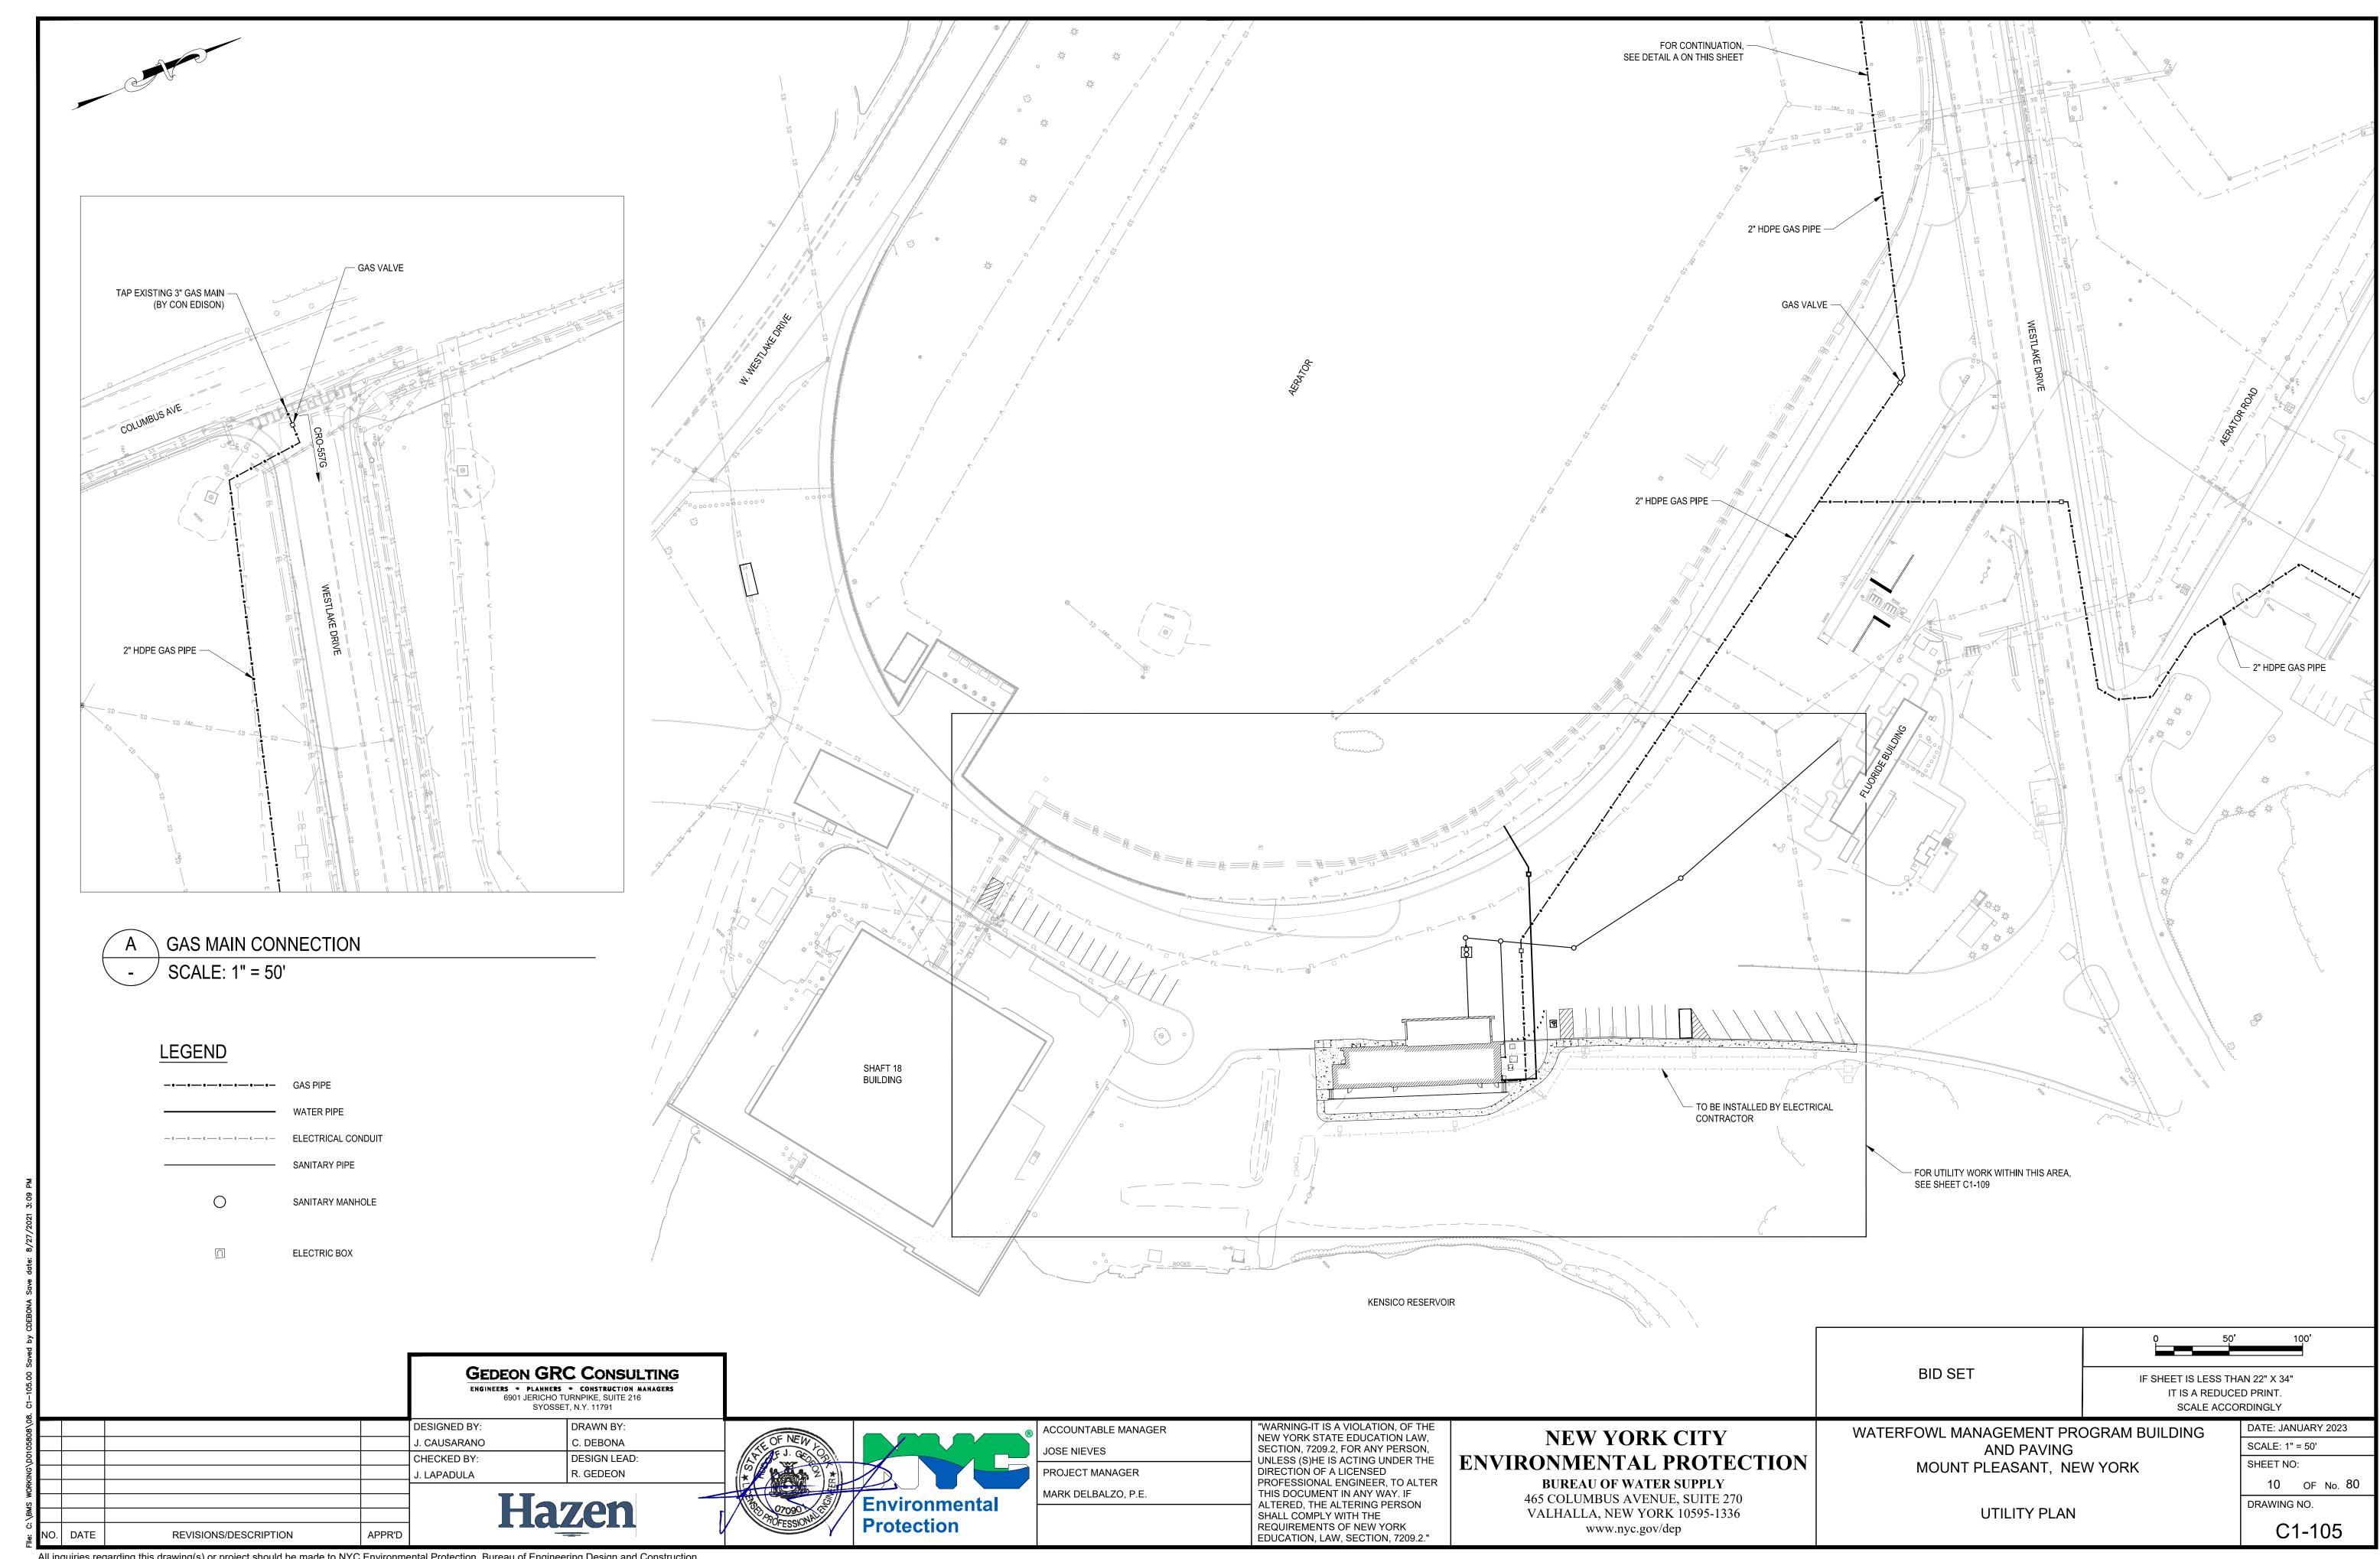


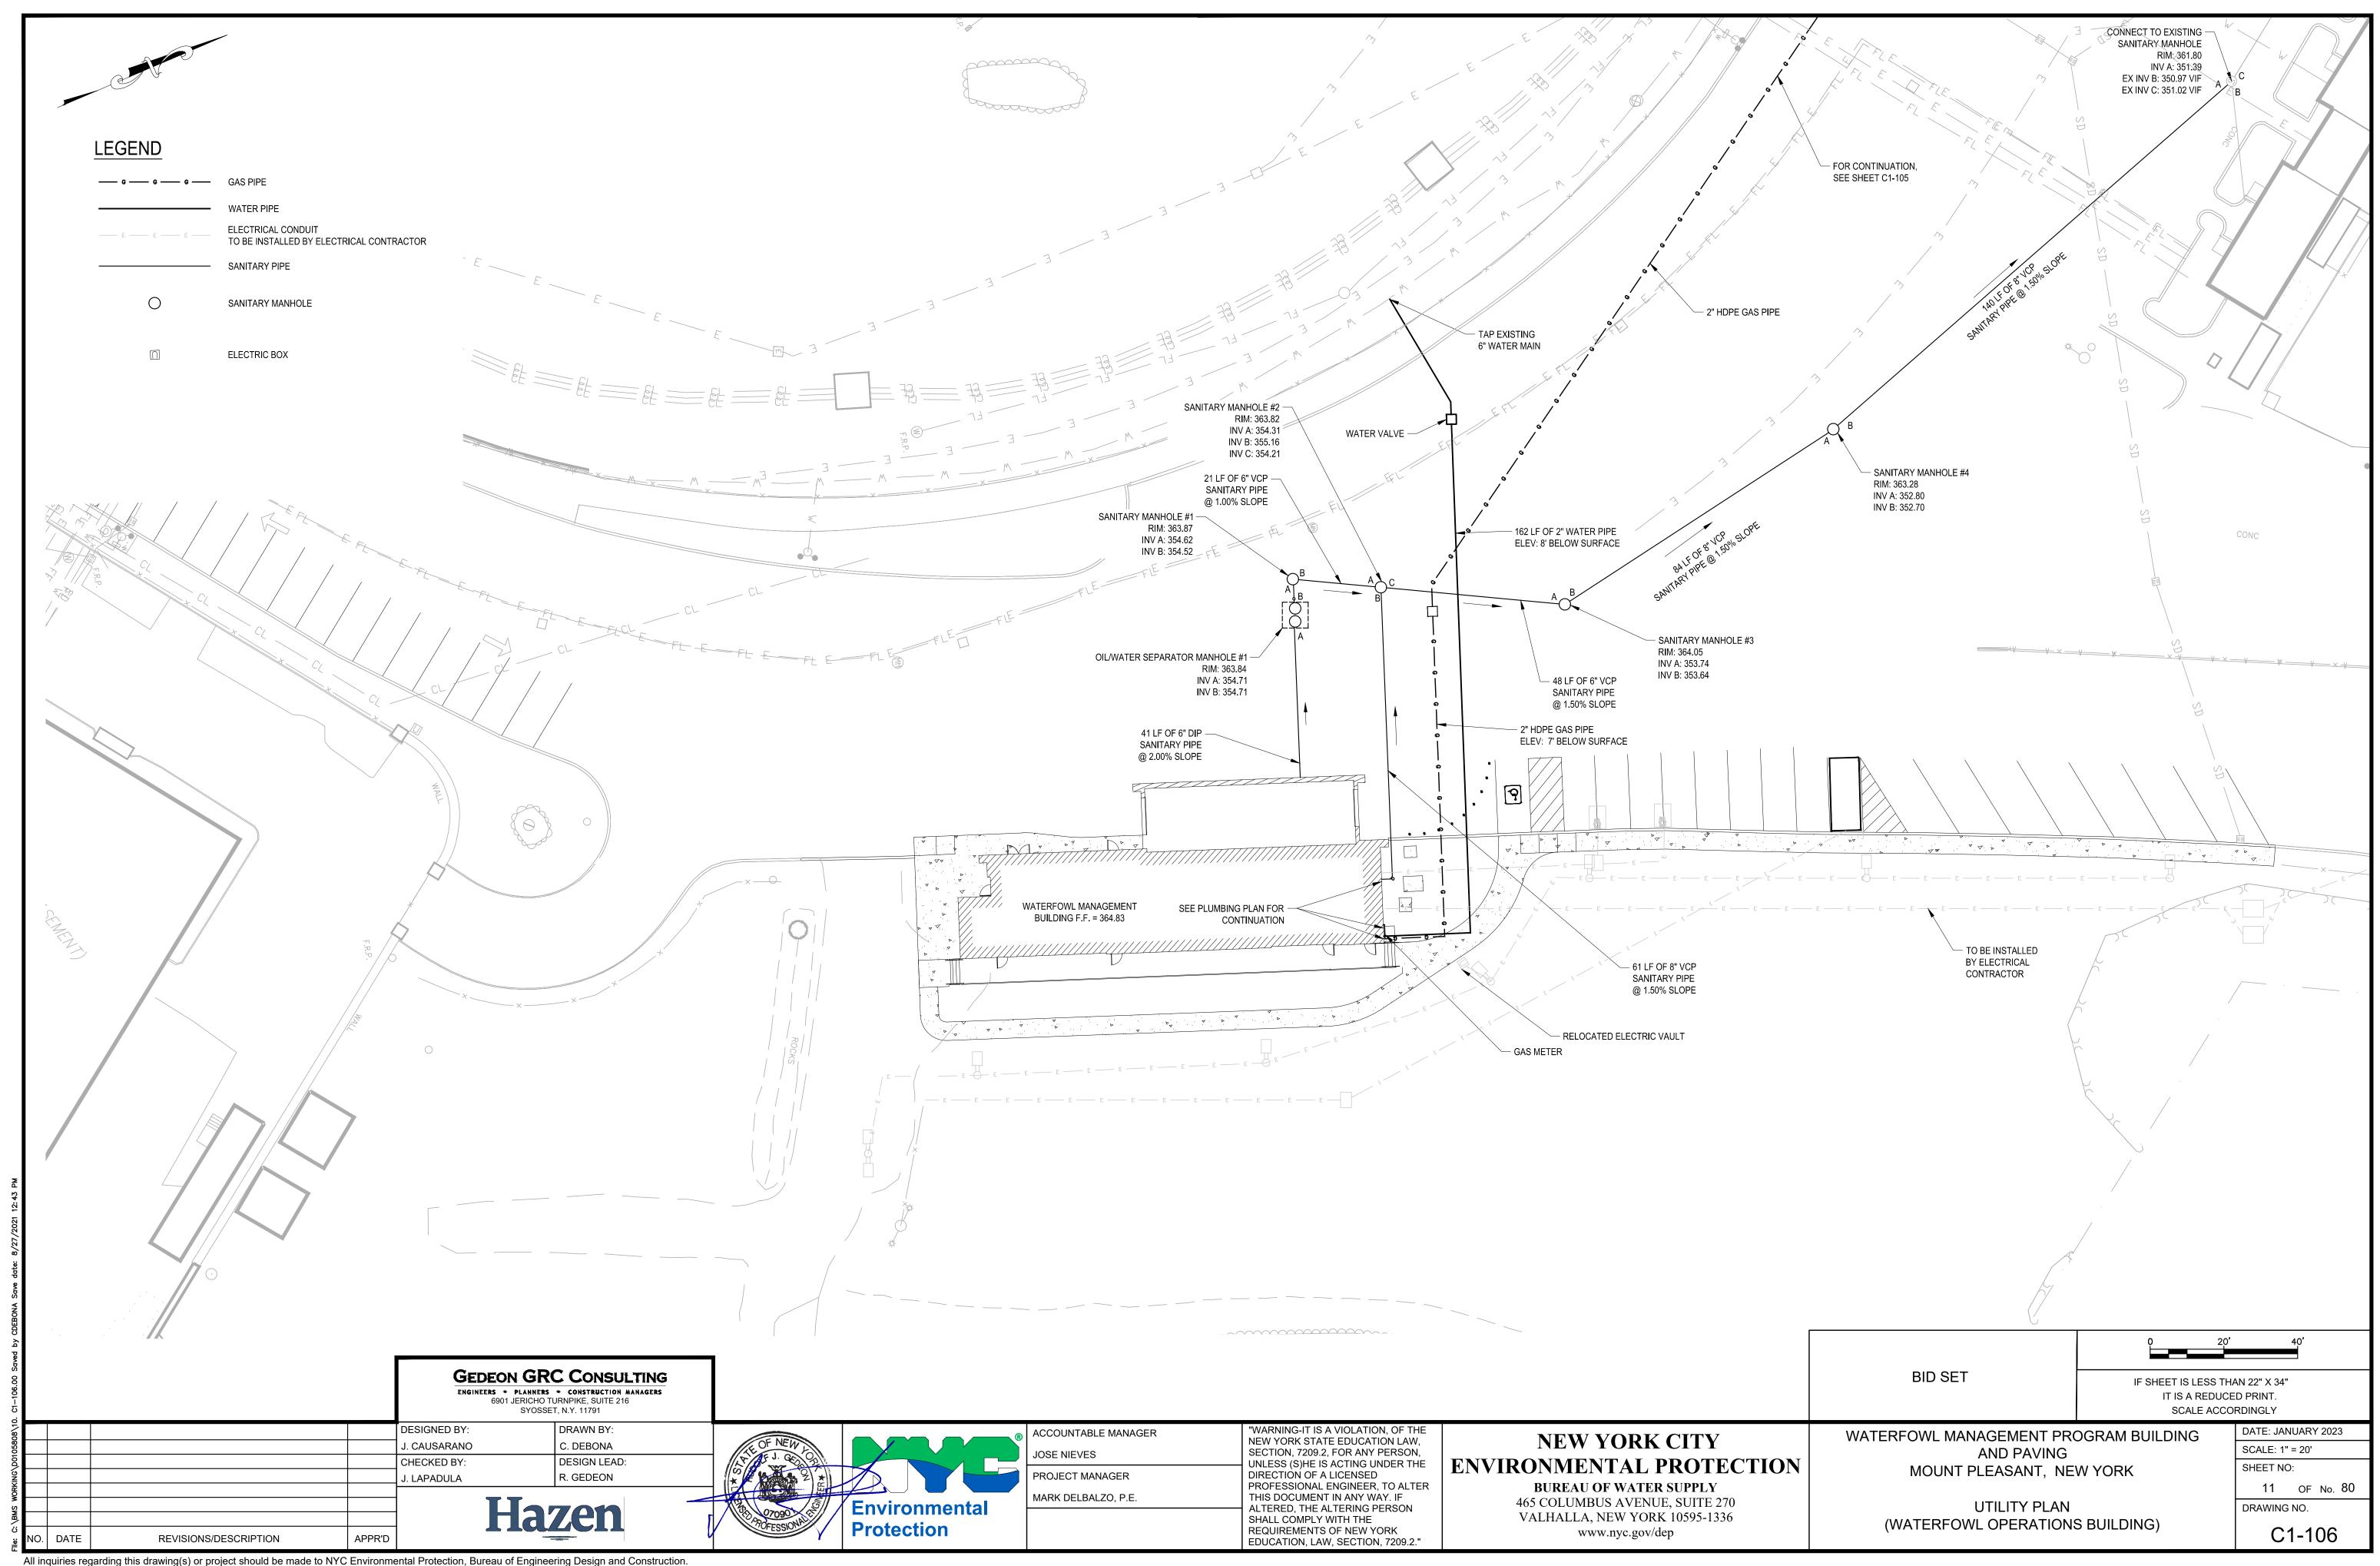


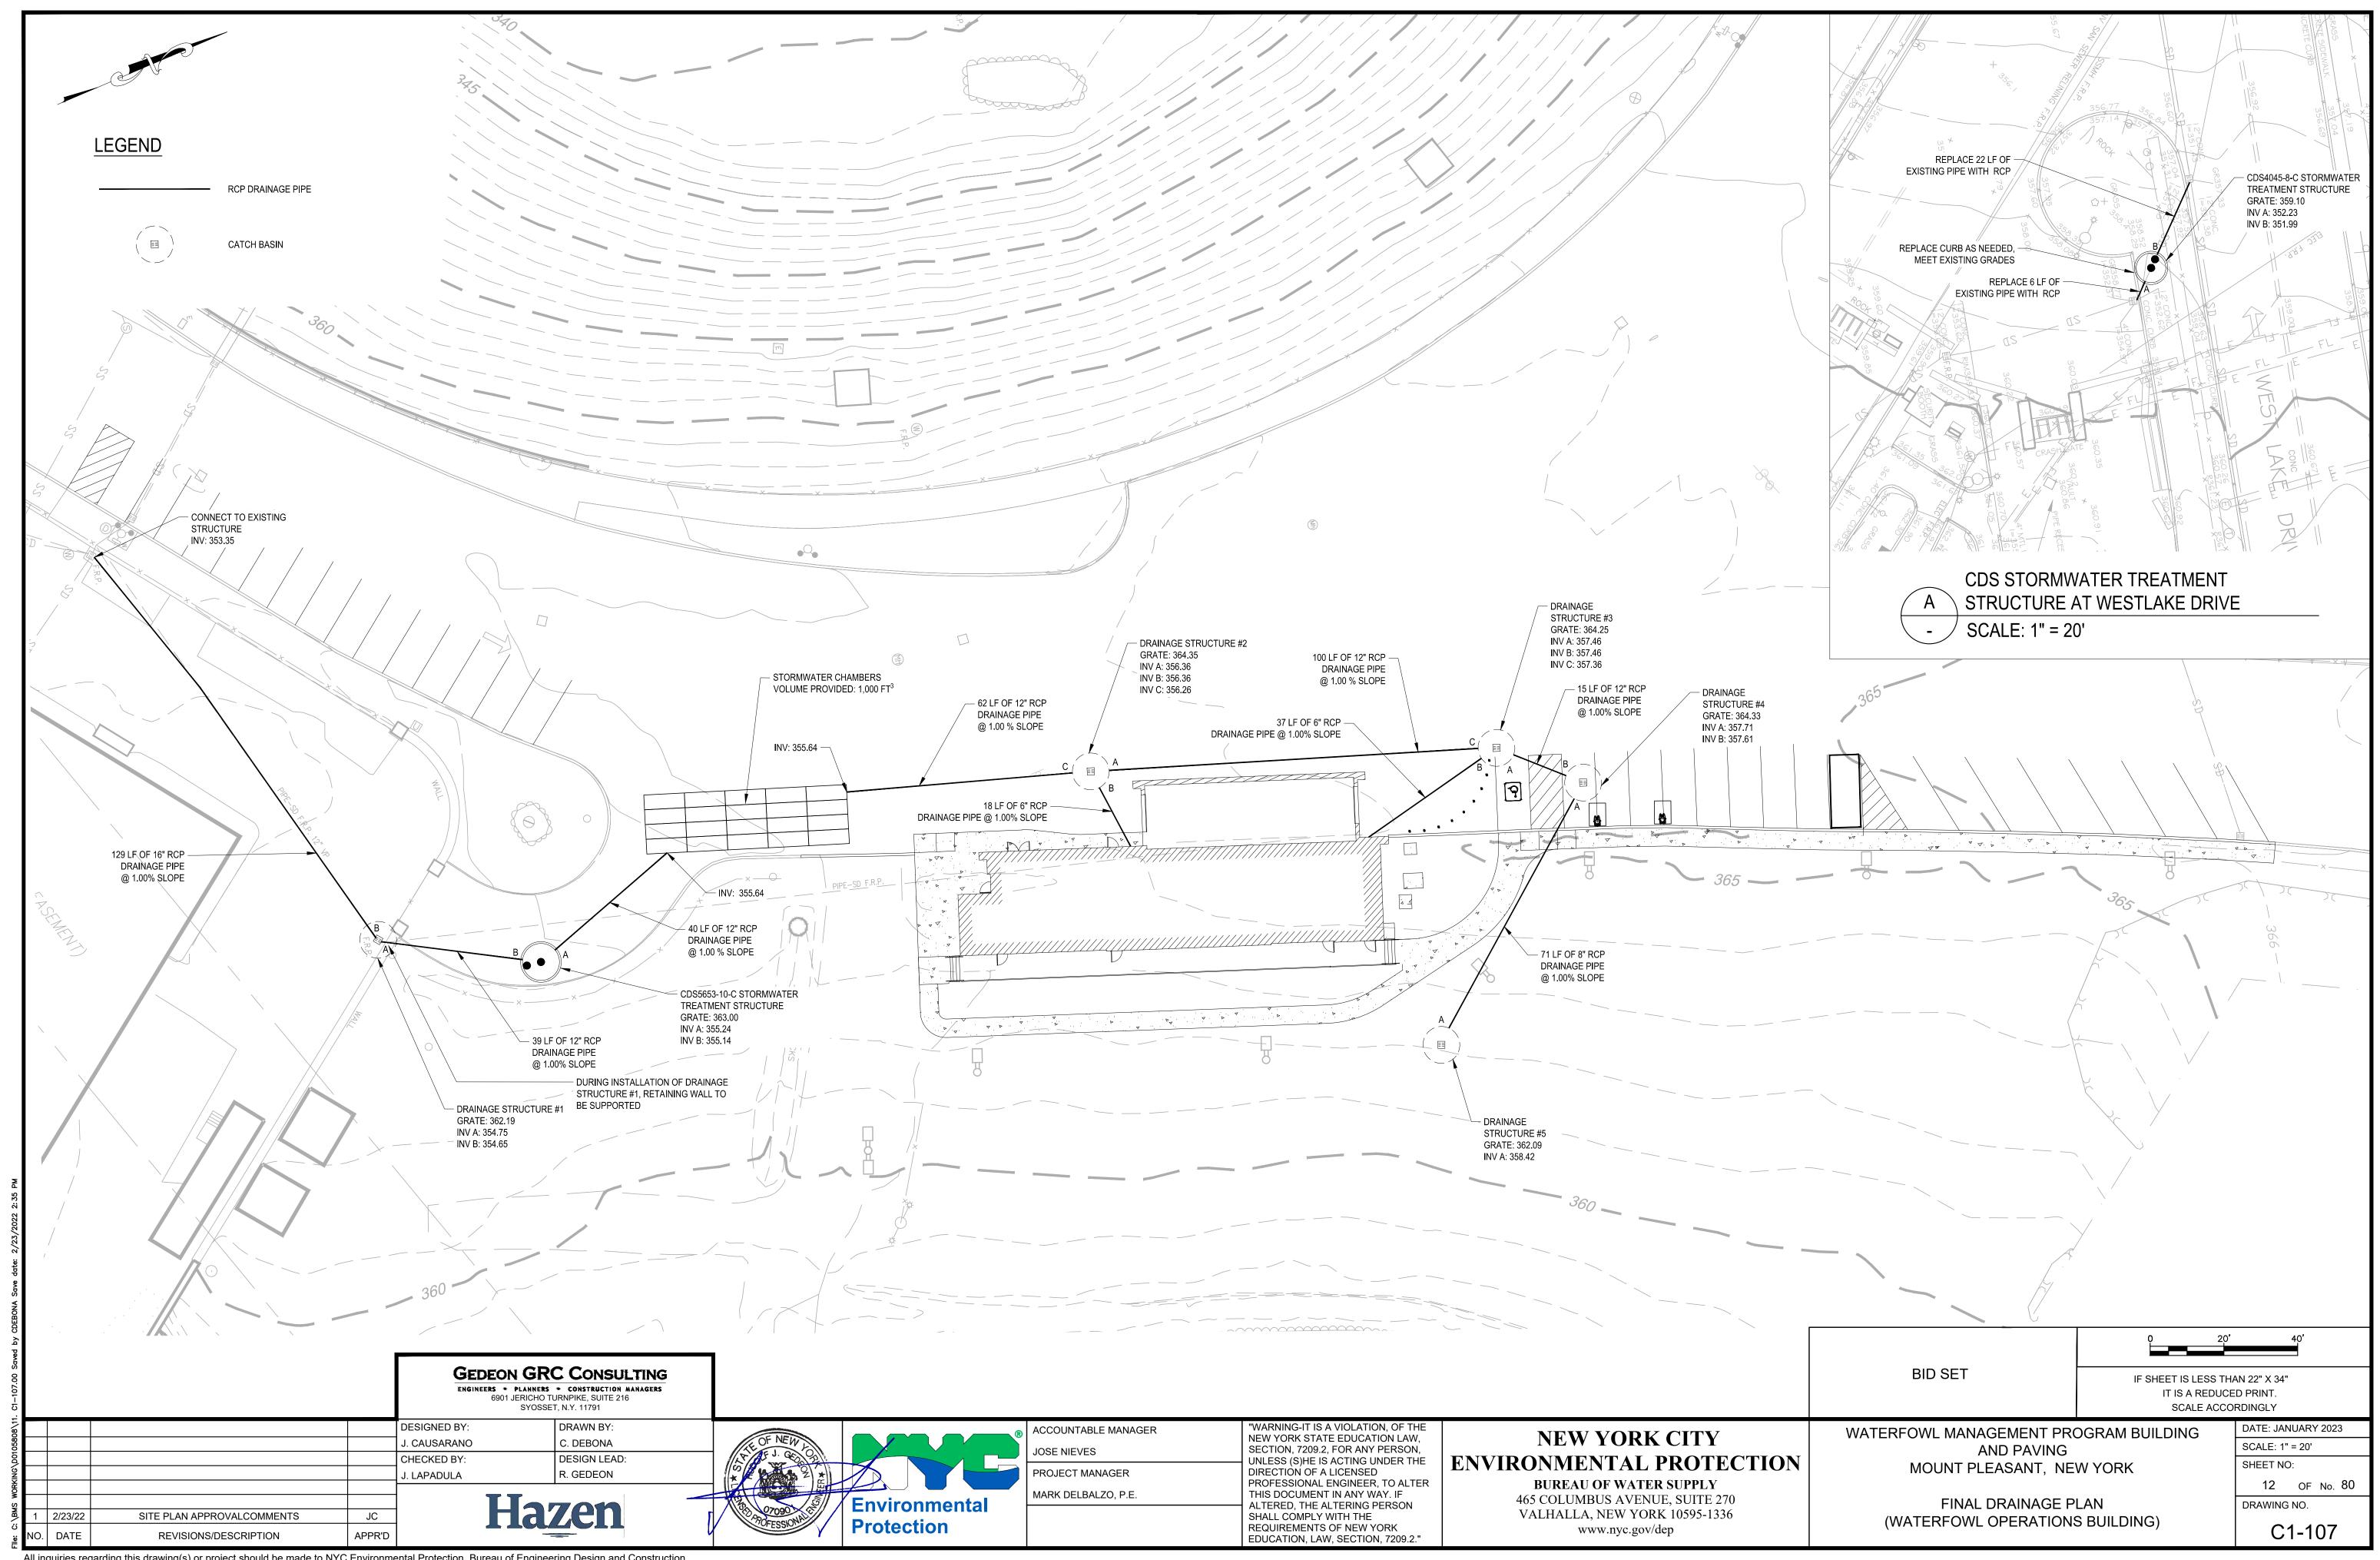


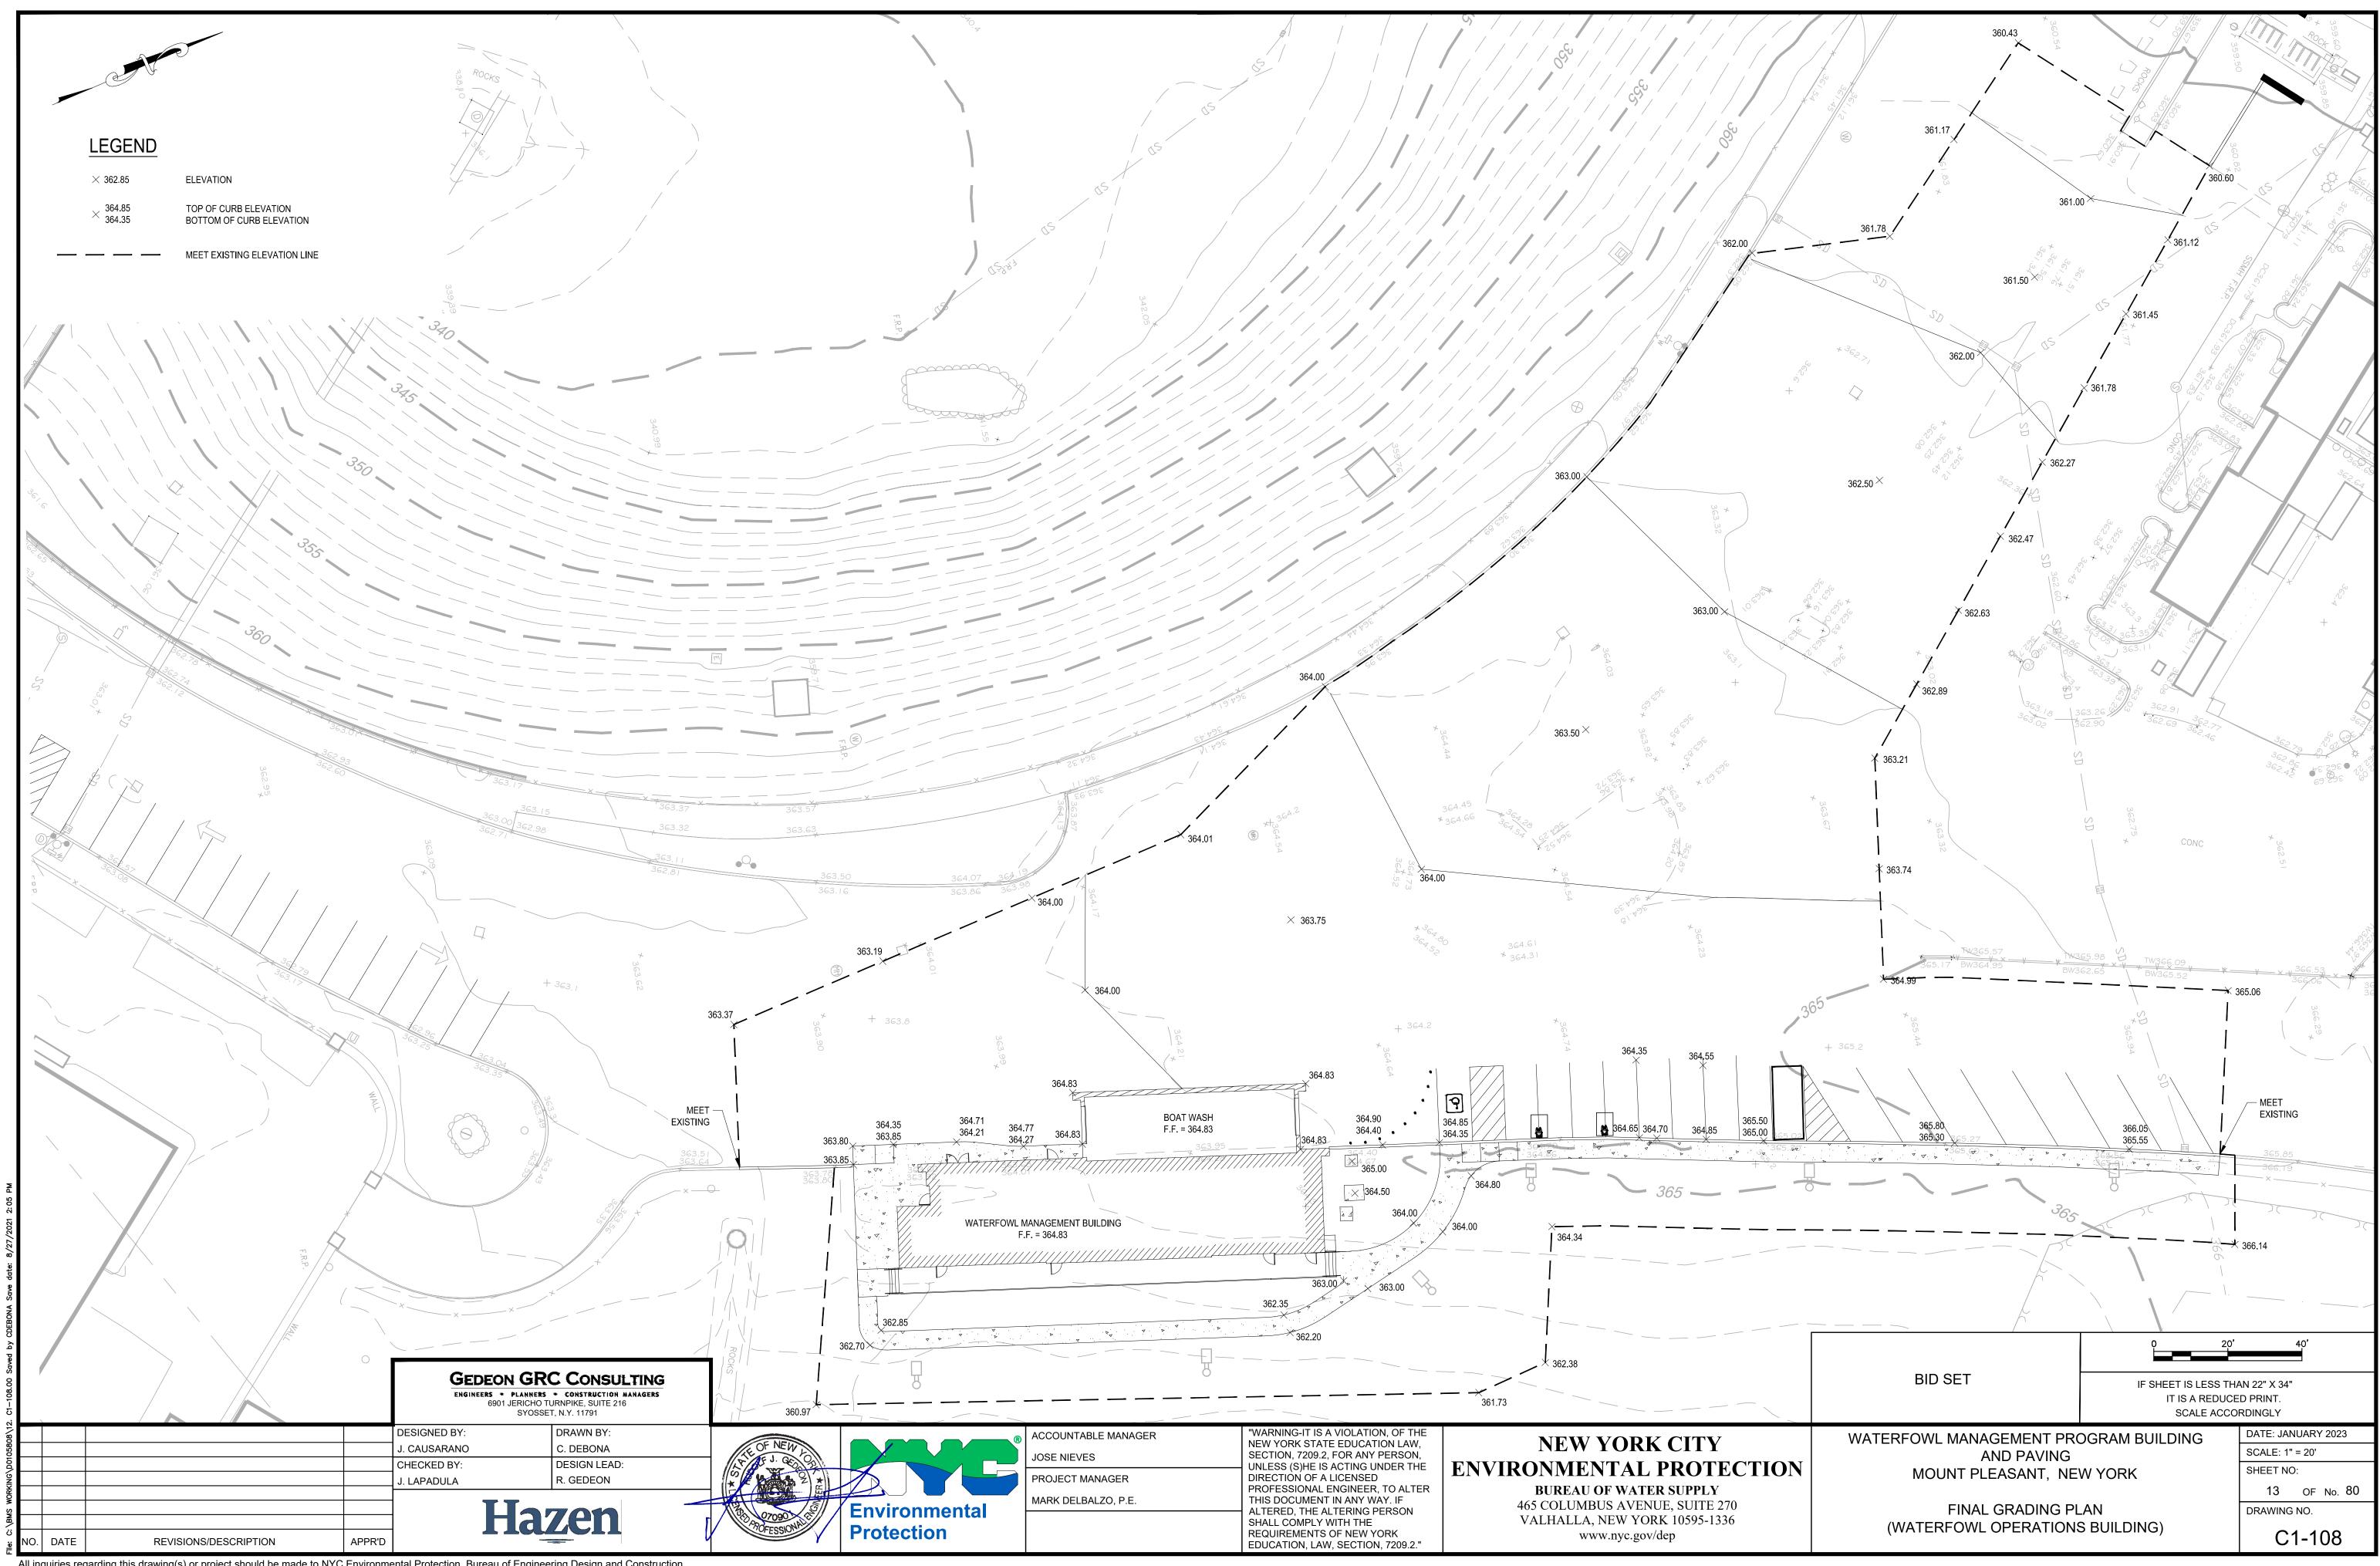


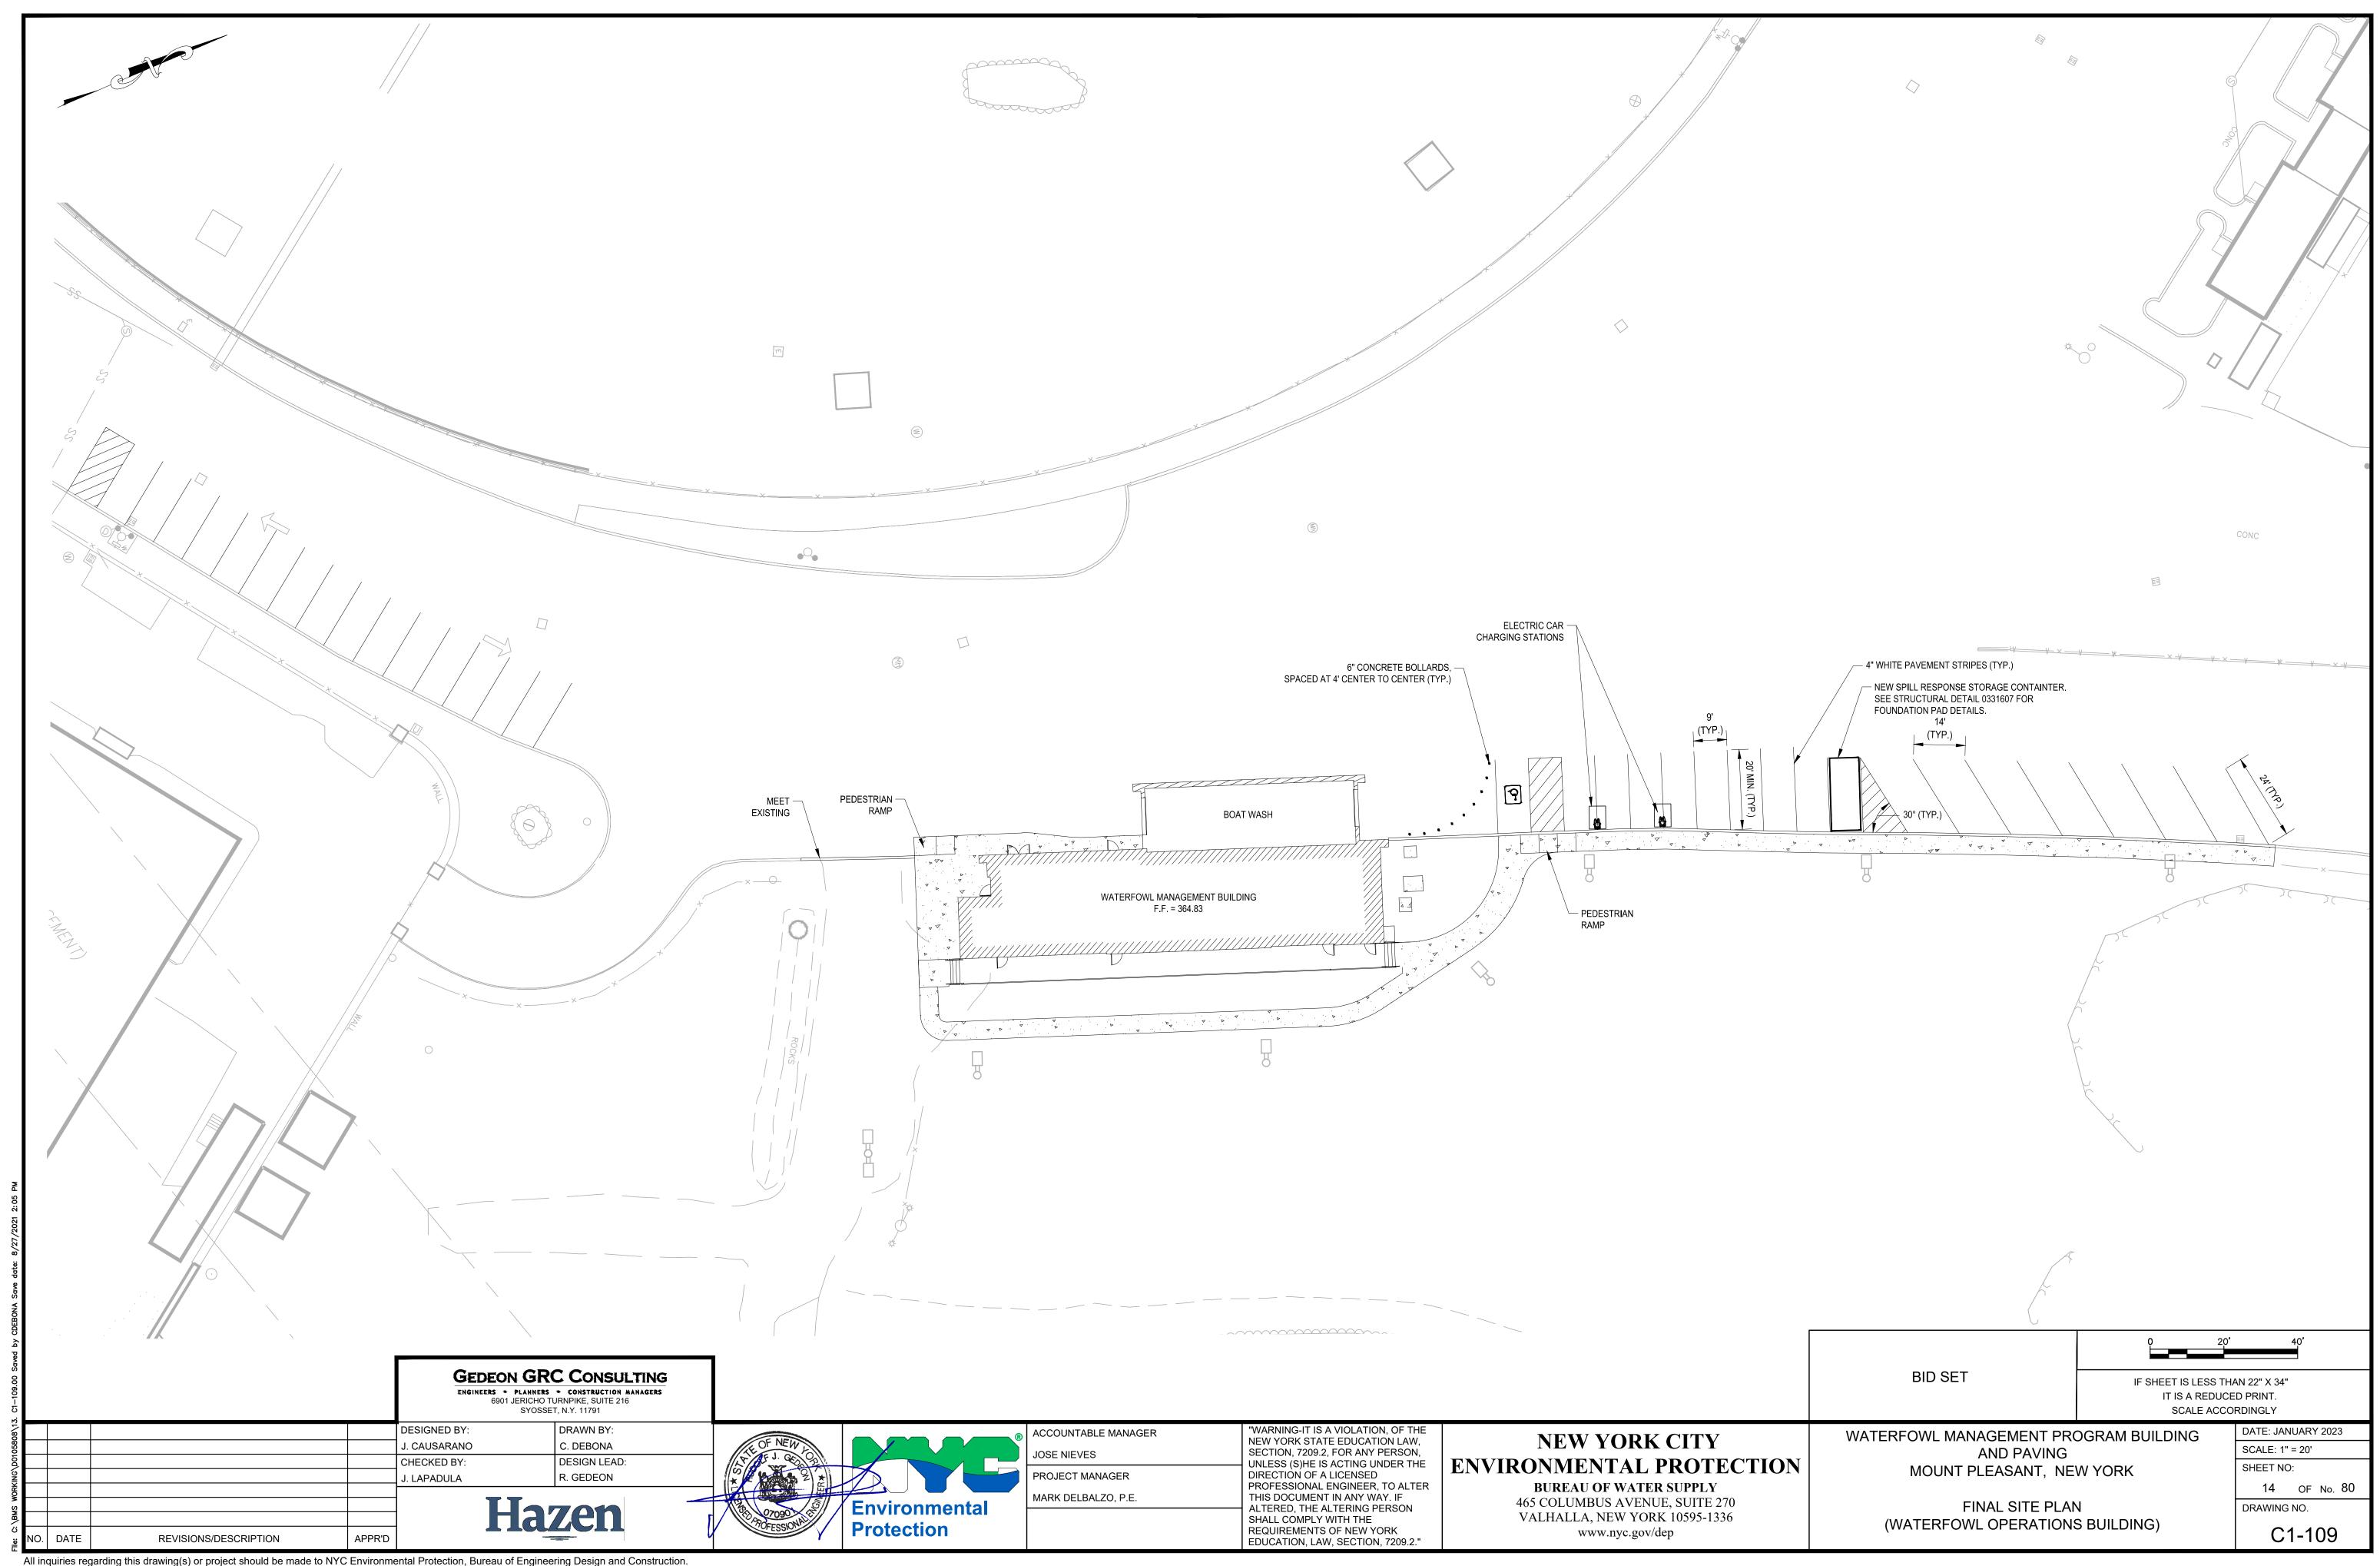


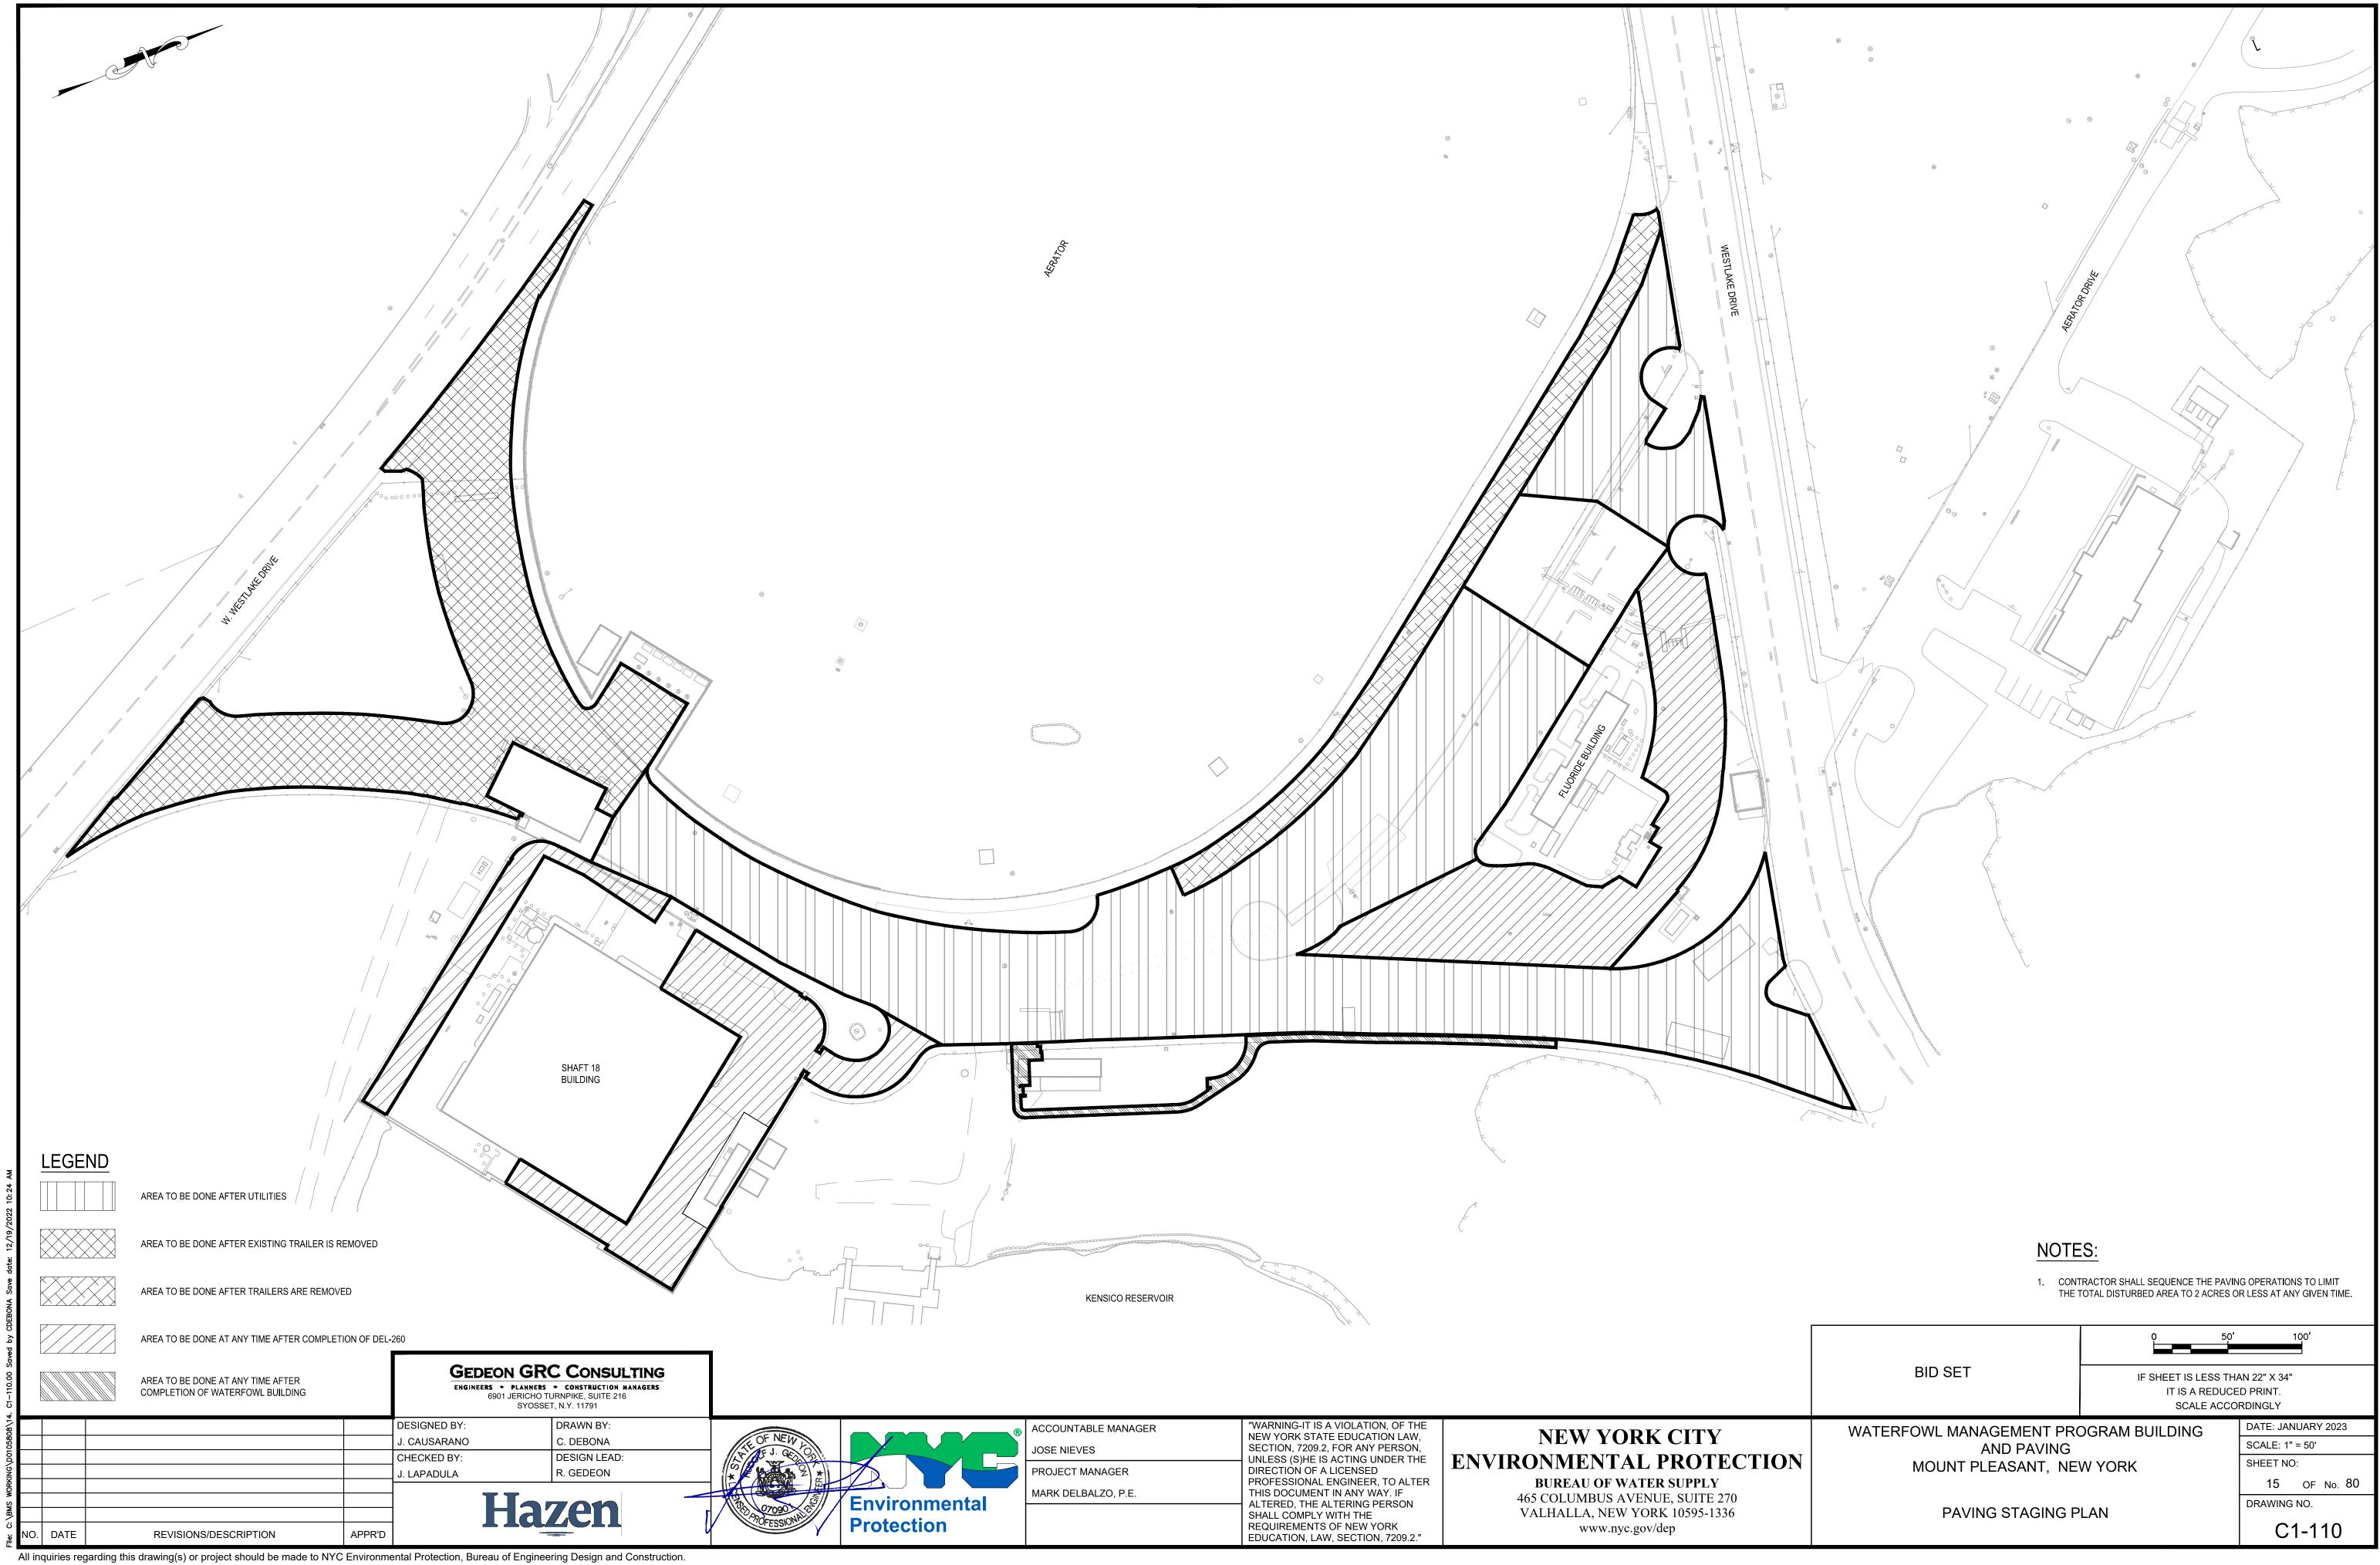


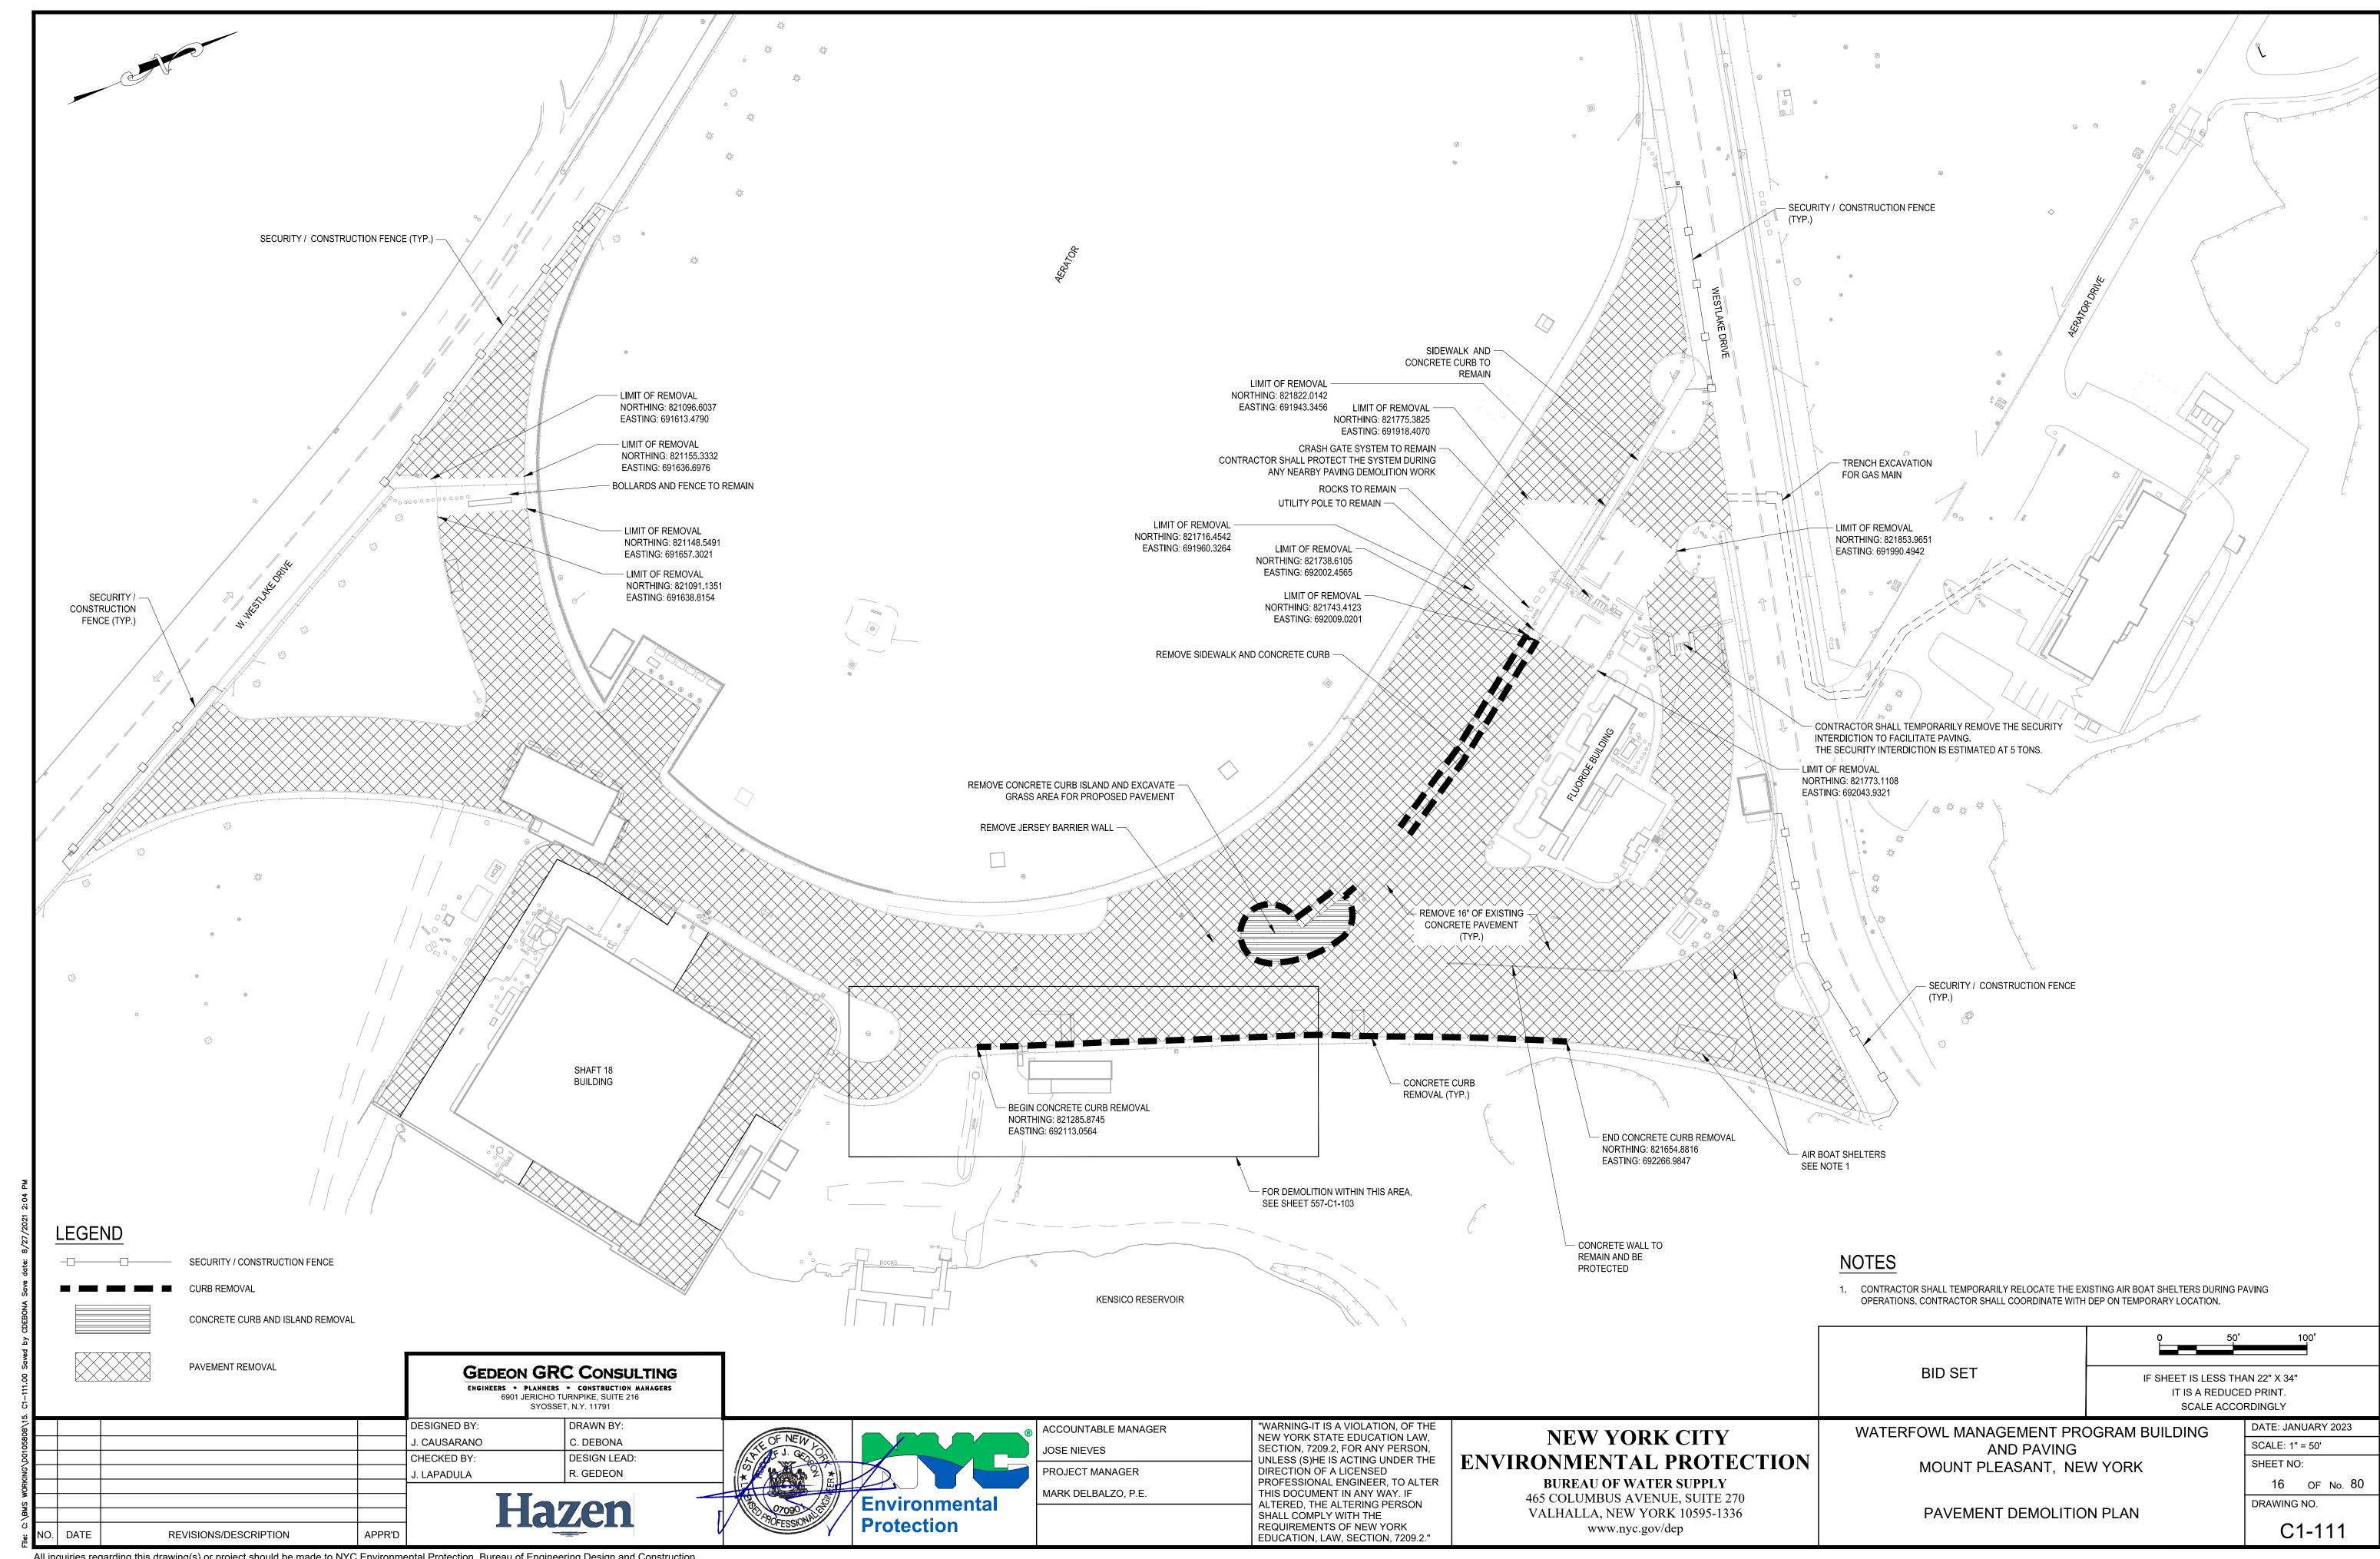

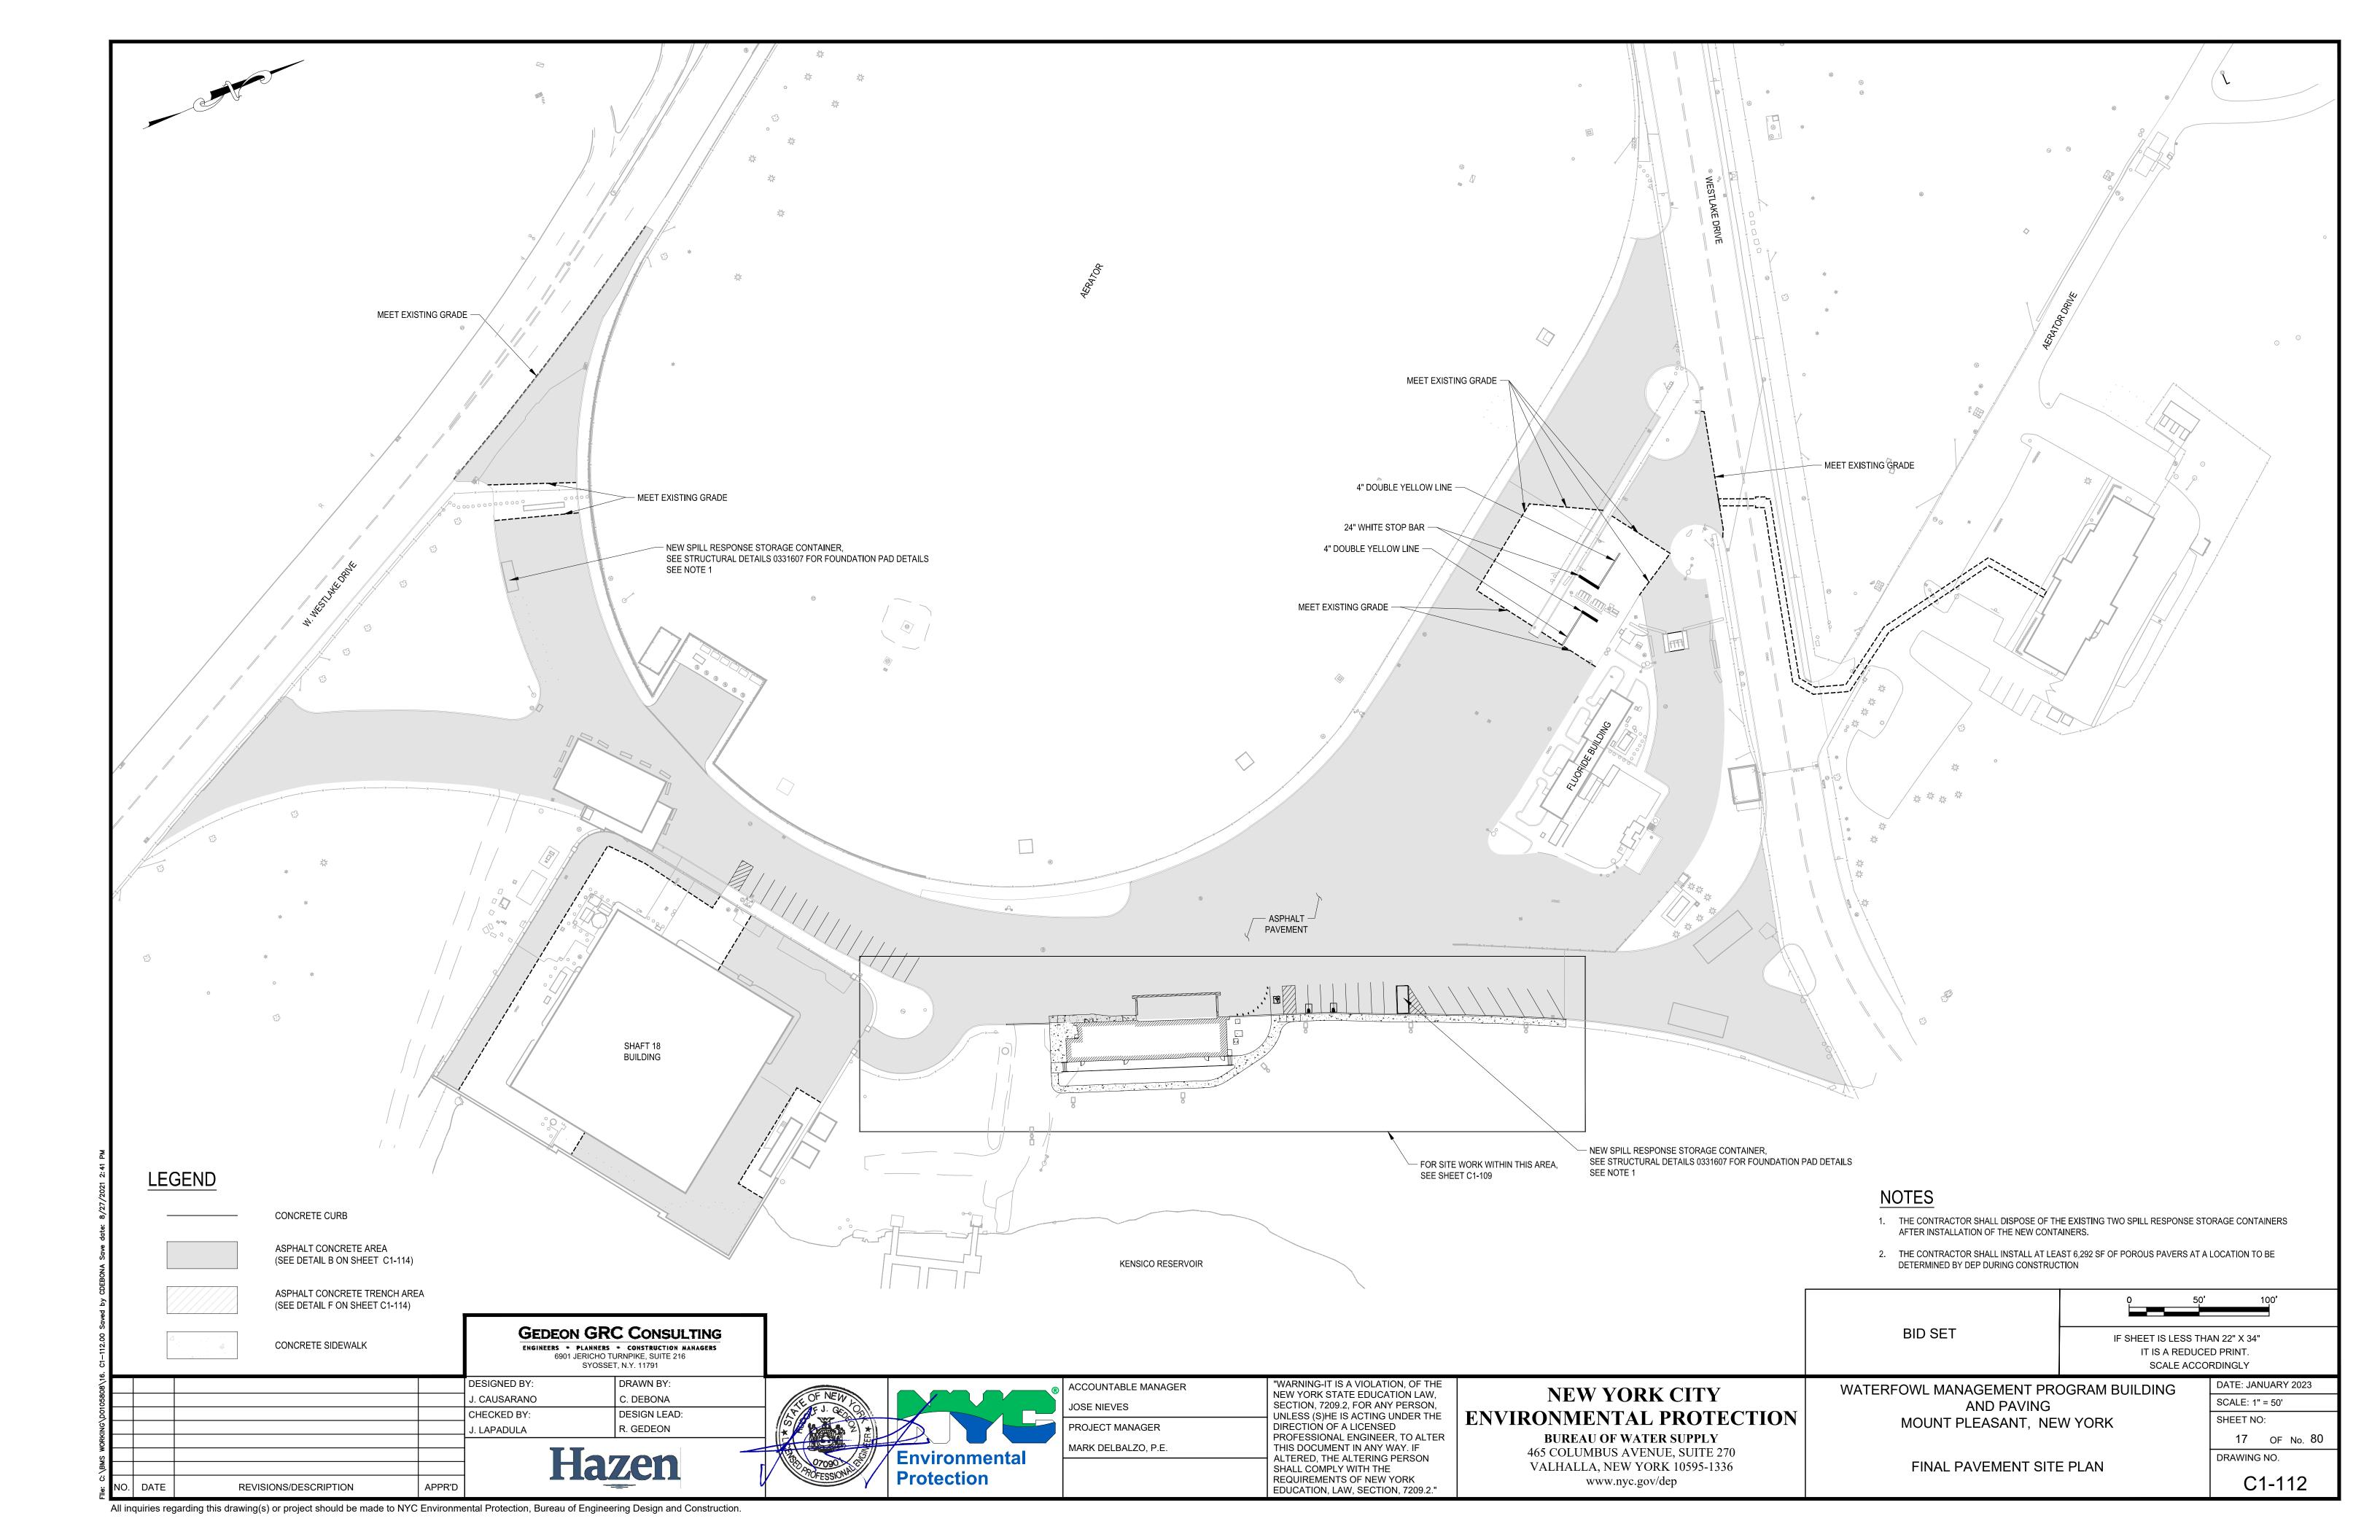

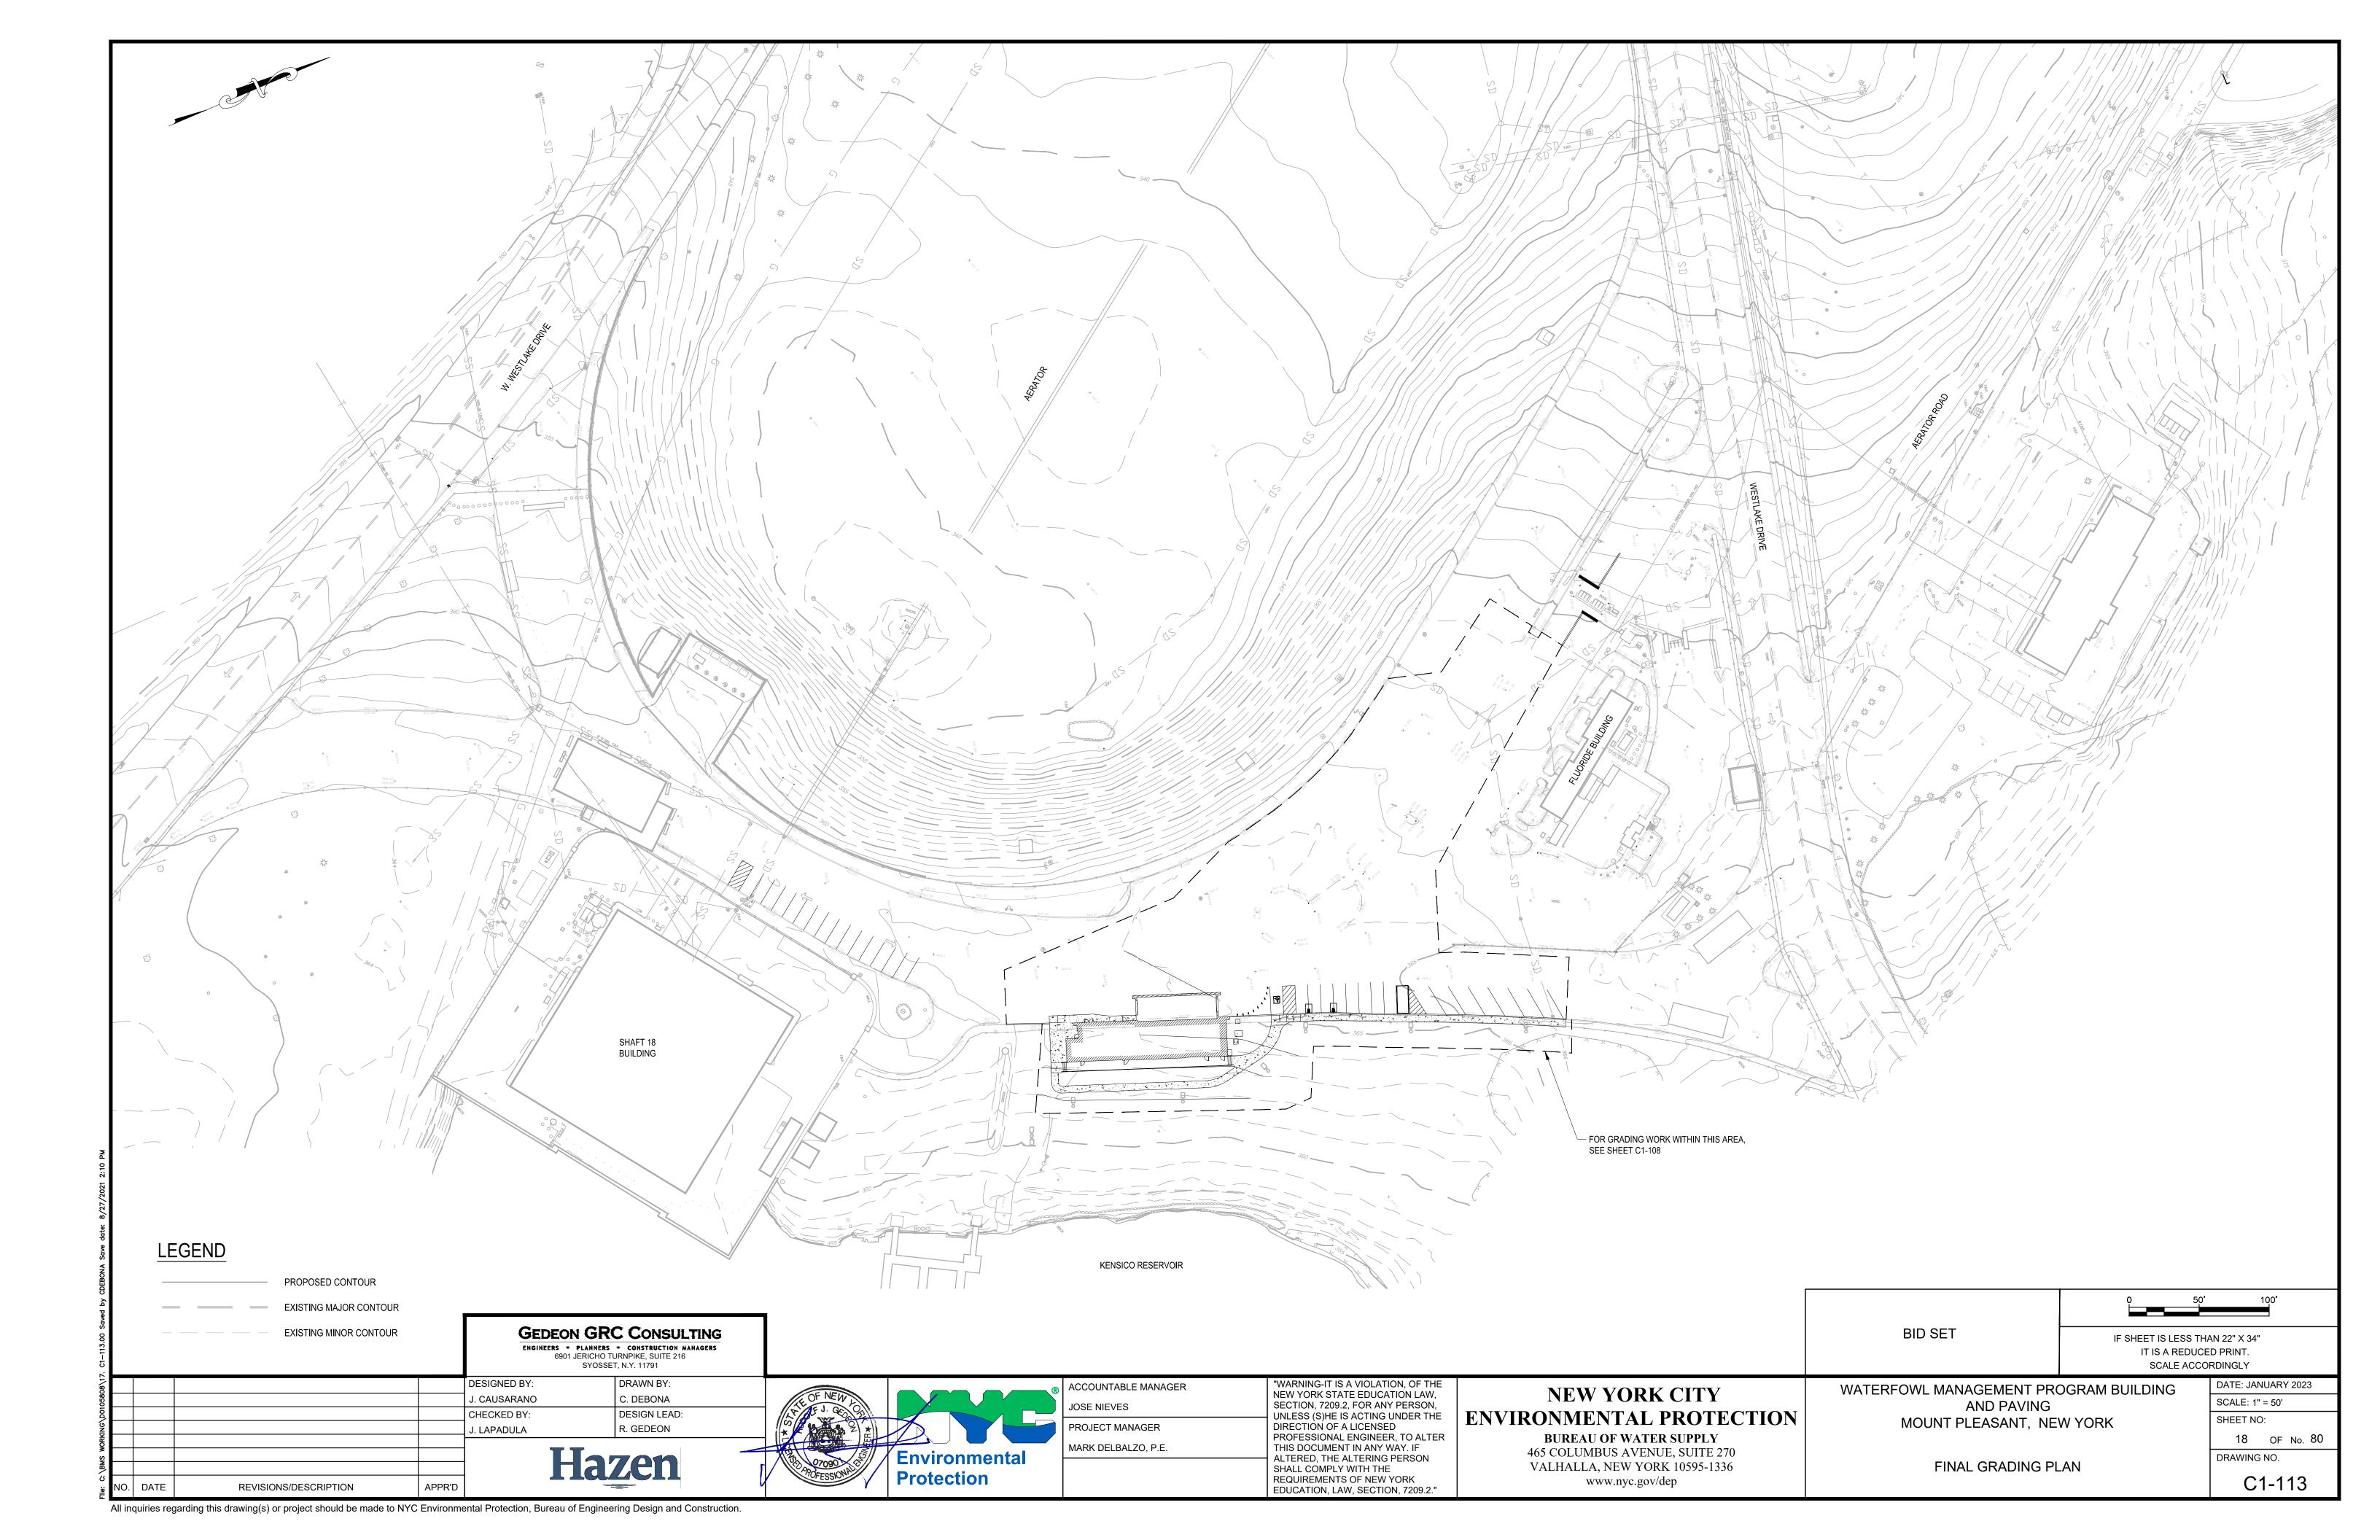

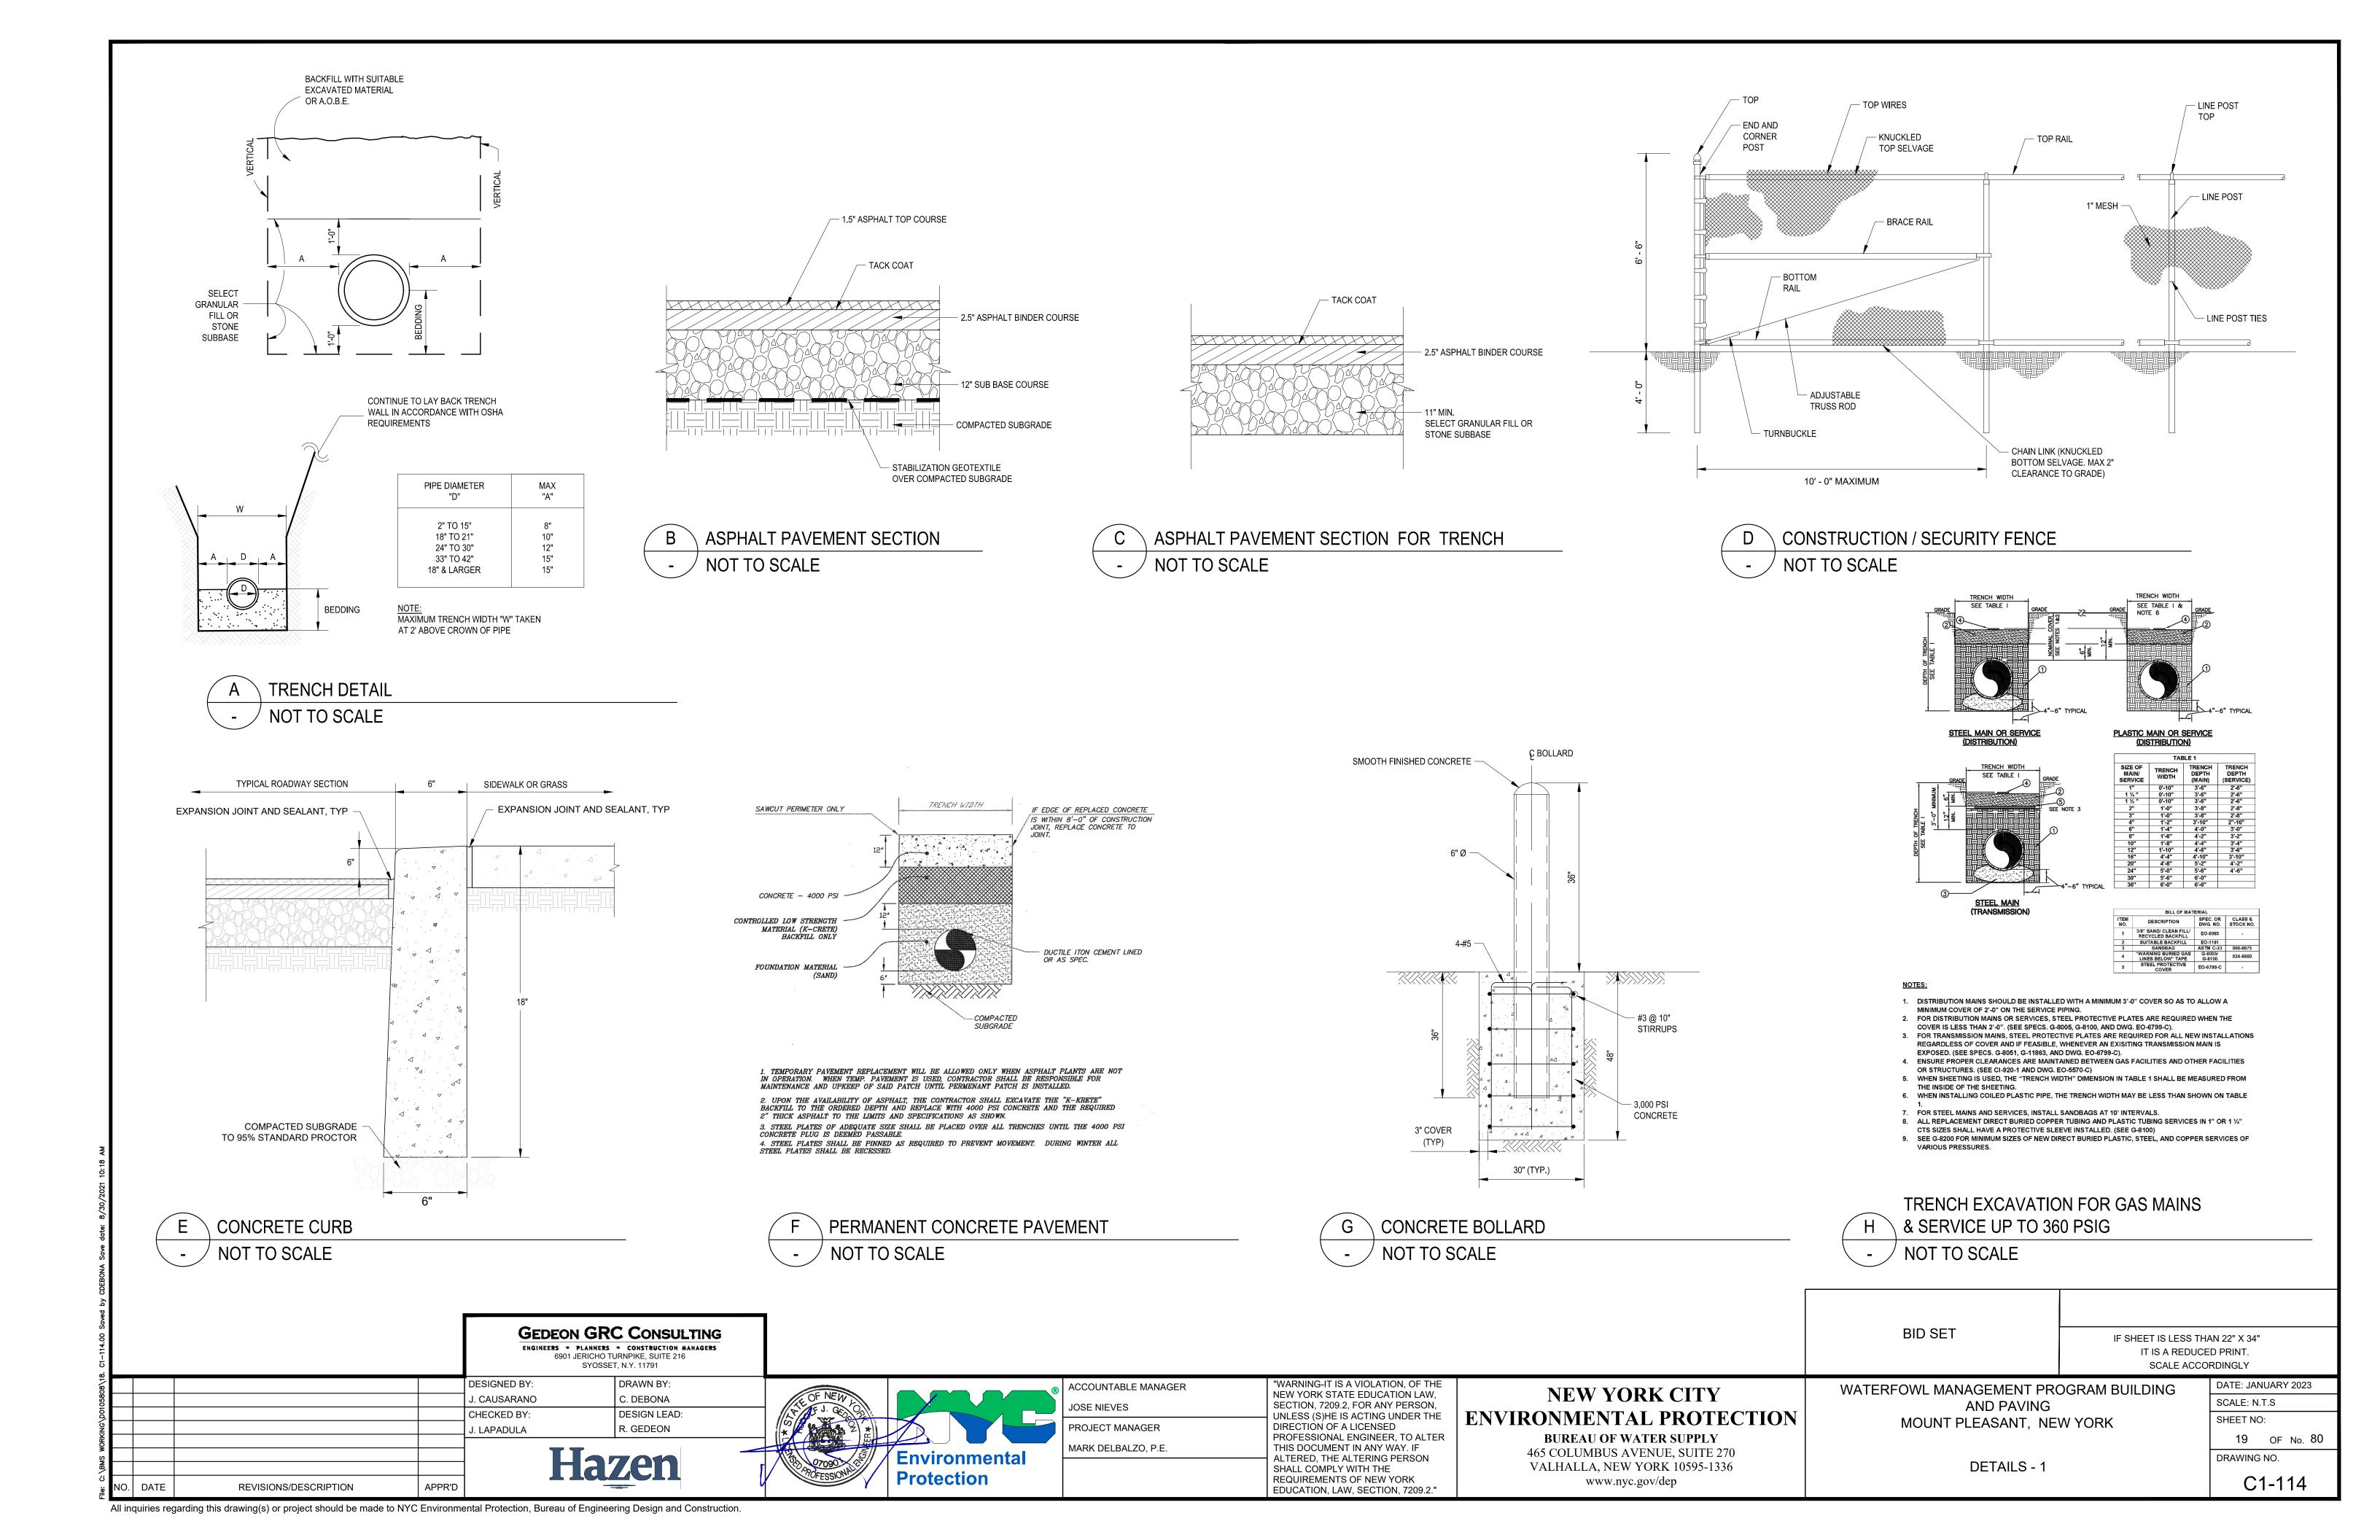

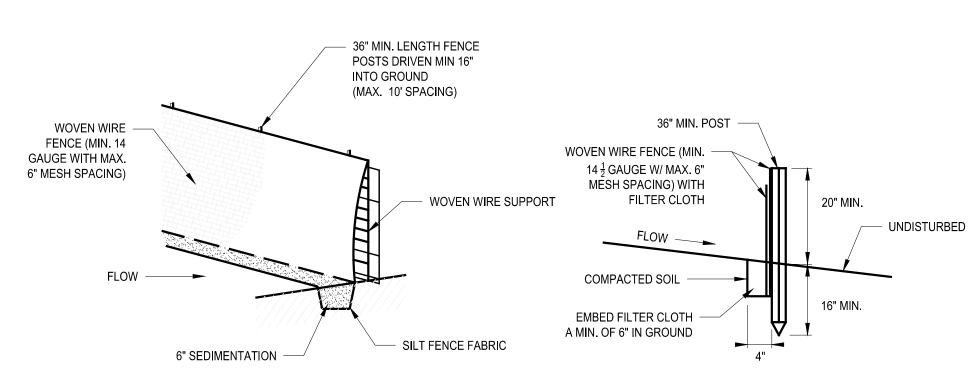

# **GENERAL NOTES**

- 1. STEEL POSTS WHICH SUPPORT THE SILT FENCE SHALL BE INSTALLED ON A SLIGHT ANGLE TOWARD THE ANTICIPATED RUNOFF SOURCE. THE TOE OF THE SILT FENCE SHALL BE TRENCHED IN WITH A SPADE OR MECHANICAL TRENCHER, SO THAT
- 2. THE DOWNSLOPE FACE OF THE TRENCH IS FLAT AND PERPENDICULAR TO THE LINE OF FLOW.


SILT FENCE

DITCH OR DIVERSION TO DIVERT SURFACE FLOW

NOT TO SCALE

CATCH BASIN

- 3. THE TRENCH SHALL BE A MINIMUM OF 6" DEEP AND 3" 4" WIDE TO ALLOW FOR THE SILT FENCE TO BE LAID IN THE GROUND AND BACKFILLED.
- 4. SILT FENCE SHALL BE SECURELY FASTENED TO EACH STEEL SUPPORT POST AND TO WOVEN WIRE, WHICH IS IN TURN ATTACHED TO THE STEEL FENCE POSTS.
- 5. INSPECTION SHALL BE FREQUENT AND REPAIR OR REPLACEMENT SHALL BE MADE PROMPTLY AS NEEDED, AS ORDERED BY THE CONSTRUCTION MANAGER.
- 6. SILT FENCE SHALL BE REMOVED WHEN IT HAS SERVED ITS USEFULNESS, SO AS NOT TO BLOCK OR IMPEDE STORM FLOW OR DRAINAGE.
- 7. SEDIMENT TRAPPED BY THIS PRACTICE SHALL BE LEGALLY DISPOSED OF IN AN APPROVED SITE IN A MANNER THAT WILL NOT CONTRIBUTE TO ADDITIONAL SILTATION.
- 8. ACCUMULATED SILT SHALL BE REMOVED WHEN IT REACHES A DEPTH OF 6" AND LEGALLY DISPOSED OF IN AN APPROVED SOIL SITE OR AS IN NOTE 7 ABOVE.

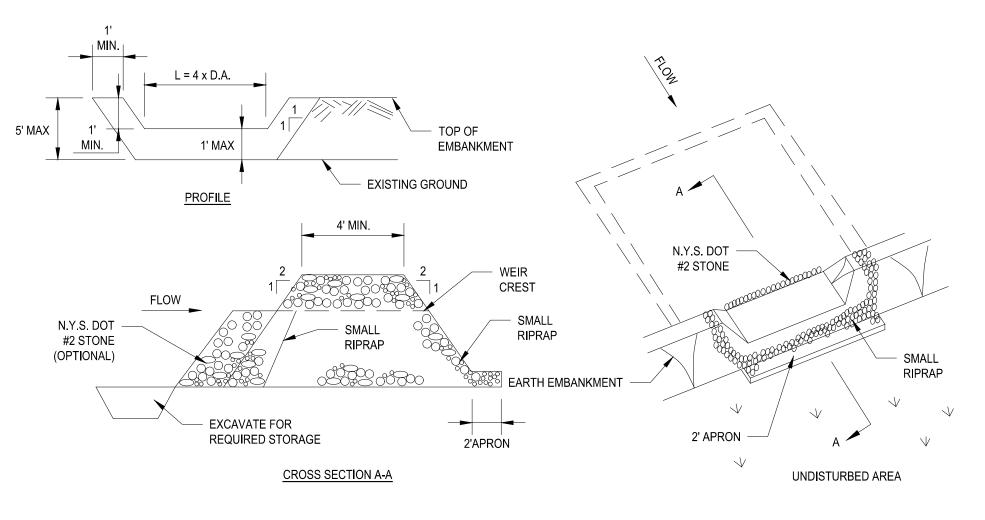

OPTION: A ONE FOOT LAYER OF N.Y.S. DOT #2 STONE MAY BE PLACED ON THE UPSTREAM SIDE OF THE RIPRAP INPLACE OF THE EMBEDDED FILTER CLOTH.

### CONSTRUCTION SPECIFICATIONS

- 1. AREA UNDER EMBANKMENT SHALL BE CLEARED, GRUBBED AND STRIPPED OF ANY VEGETATION AND ROOT MAT. THE POOL AREA SHALL BE CLEARED.
- THE FILL MATERIAL FOR THE EMBANKMENT SHALL BE FREE OF ROOTS AND OTHER WOODY VEGETATION AS WELL AS OVER-SIZED STONES, ROCKS, ORGANIC MATERIAL OR OTHER OBJECTIONABLE MATERIAL. THE EMBANKMENT SHALL BE COMPACTED BY TRAVERSING WITH EQUIPMENT WHILE IT IS BEING CONSTRUCTED.
- 3. ALL CUT AND FILL SLOPES SHALL BE 2:1 OR FLATTER.
- 4. THE STONE USED IN THE OUTLET SHALL BE SMALL RIPRAP 4"-8" ALONG WITH A 1' THICKNESS OF 2" AGGREGATE PLACED ON THE UP-GRADE SIDE ON THE SMALL RIPRAP OR EMBEDDED FILTER CLOTH IN THE RIPRAP.
- 5. SEDIMENT SHALL BE REMOVED AND TRAP RESTORED TO ITS ORIGINAL DIMENSIONS WHEN THE SEDIMENT HAS ACCUMULATED TO 1/2 THE DESIGN DEPTH OF THE TRAP. IT SHALL BE PLACED ON SITE AND STABILIZED.
- 6. THE STRUCTURE SHALL BE INSPECTED AFTER EACH RAIN AND REPAIRS MADE AS NEEDED.
- 7. CONSTRUCTION OPERATIONS SHALL BE CARRIED OUT IN SUCH A MANNER THAT EROSION AND SEDIMENT ARE CONTROLLED.
- 8. THE STRUCTURE SHALL BE REMOVED AND THE AREA STABILIZED WHEN THE DRAINAGE AREA HAS BEEN PROPERLY STABILIZED. MAXIMUM DRAINAGE AREA 5 ACRES


ACCOUNTABLE MANAGER

PROJECT MANAGER

MARK DELBALZO, P.E.

JOSE NIEVES




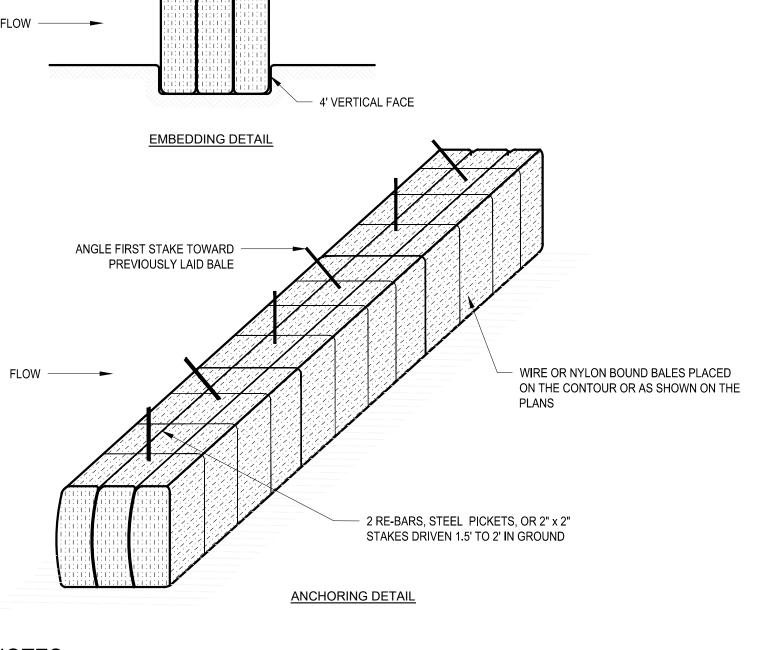

## **GENERAL NOTES**


- 1. BALES SHALL BE PLACED IN A ROW WITH ENDS TIGHTLY ABUTTING THE ADJACENT BALES.
- 2. EACH BALE SHALL BE EMBEDDED IN THE SOIL A MINIMUM OF FOUR INCHES.
- 3. BALES SHALL BE SECURELY ANCHORED IN PLACE BY STAKES OR RE-BARS DRIVEN THROUGH THE BALES. THE FIRST STAKE IN EACH BALE SHALL BE ANGLED TOWARD THE PREVIOUSLY LAID BALE TO FORCE BALES TOGETHER.
- 4. INSPECTION SHALL BE FREQUENT AND REPAIR OR REPLACEMENT SHALL BE MADE PROMPTLY AS NEEDED.
- 5. BALES SHALL BE REMOVED WHEN THEY HAVE SERVED THEIR USEFULNESS SO AS NOT TO BLOCK OR IMPEDE STORM FLOW OR DRAINAGE.
- 6. ACCUMULATED SILT SHALL BE REMOVED AND LEGALLY DISPOSED OF WHEN IT REACHES A DEPTH OF 6 INCHES.
- 7. CONTRACTOR SHALL REPLACE HAY BALE AND DIKE EVERY THREE (3) MONTHS.

**EMBEDDING DETAIL** 

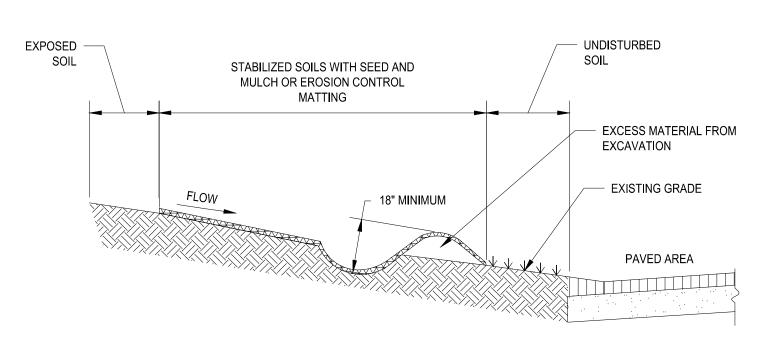

# CONSTRUCTION NOTES

- 1. ALL EARTH FILL SHALL BE PLACED ON A STRIPPED FOUNDATION, CONTAIN NO STUMPS OR WOODY MATERIAL, AND BE COMPACTED WITH THE WEIGHT OF THE EXCAVATOR BUCKET.
- 2. THE SYSTEM SHALL BE USED WITH A MINIMUM 5 FOOT VEGETATED BUFFER ON THE DOWN SLOPE TOE OF THE DIKE OR AN ARTIFICIAL BUFFER OF EROSION CONTROL MATTING.
- 3. THE ENDS OF THE DIKE SYSTEM SHALL TERMINATE WITH A 90 DEGREE RETURN OF NYS DOT #1A CRUSHED STONE TO FILTER ANY EXCESS
- 4. THE EARTHEN DIKE SHALL BE SEEDED AND MULCHED TO PREVENT EROSION USING AN ANNUAL RYE GRASS MIXTURE AT A RATE OF 1 LB. PER 1,000 SQUARE FEET.

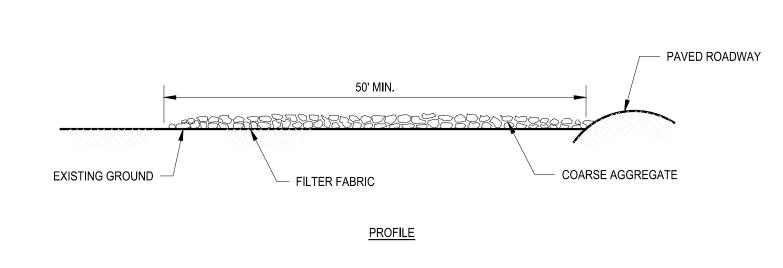


## **GENERAL NOTES**

NOT TO SCALE

- THE STONE SIZE WILL CONSIST OF COARSE AGGREGATE IN ACCORDANCE WITH THE SPECIFICATIONS. THE MATERIAL SHALL BE PLACED WITH A THICKNESS NOT LESS THAN 8", WILL NOT BE LESS THAN THE WIDTH OF THE INGRESS, AND NOT LESS THAN 50' IN LENGTH.
- 2. THE ENTRANCE SHALL BE MAINTAINED IN A CONDITION THAT WILL PREVENT TRACKING OR FLOWING OF SEDIMENT ONTO PAVED ROADWAY. THIS MAY REQUIRE PERIODIC TOP DRESSING WITH ADDITIONAL STONE AS CONDITIONS DEMAND AND REPAIR AND/OR CLEAN OUT OF ANY MEASURES USED TO TRAP SEDIMENT. ALL SEDIMENT SPILLED, DROPPED, WASHED OR TRACKED ONTO THE PUBLIC RIGHT-OF-WAY MUST BE REMOVED BY THE CONTRACTOR IMMEDIATELY.

STABILIZED CONSTRUCTION ENTRANCE

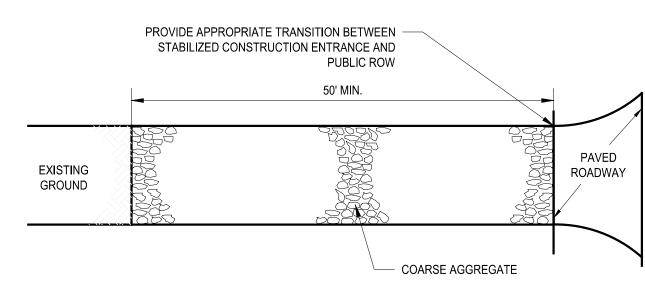



**GRADE 2-3%** 

STRAW BALES-BUTT BALES TIGHTLY, END TO END

LANDGRADING
NOT TO SCALE

X Y (MAX)
2 20'

3 30'

4 40'

**INLET PROTECTION** 

NOT TO SCALE

GEDEON GRC CONSULTING

ENGINEERS - PLANNERS - CONSTRUCTION MANAGERS
6901 JERICHO TURNPIKE, SUITE 216
SYOSSET, N.Y. 11791

DESIGNED BY:

DRAWN BY:

DESIGNED BY:
J. CAUSARANO
C. DEBONA
CHECKED BY:
J. LAPADULA
CHECKED BY:
LAPADULA
R. GEDEON

REVISIONS/DESCRIPTION
APPR'D

# F SEDIMENT DIKE - NOT TO SCALE

Énvironmental

**Protection** 

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SHALL COMPLY WITH THE

REQUIREMENTS OF NEW YORK

EDUCATION, LAW, SECTION, 7209.2."

# NEW YORK CITY ENVIRONMENTAL PROTECTION

BUREAU OF WATER SUPPLY 465 COLUMBUS AVENUE, SUITE 270 VALHALLA, NEW YORK 10595-1336 www.nyc.gov/dep BID SET

IF SHEET IS LESS THAN 22" X 34"
IT IS A REDUCED PRINT.
SCALE ACCORDINGLY

WATERFOWL MANAGEMENT PROGRAM BUILDING AND PAVING MOUNT PLEASANT, NEW YORK

DETAILS - 2

SCALE: N.T.S


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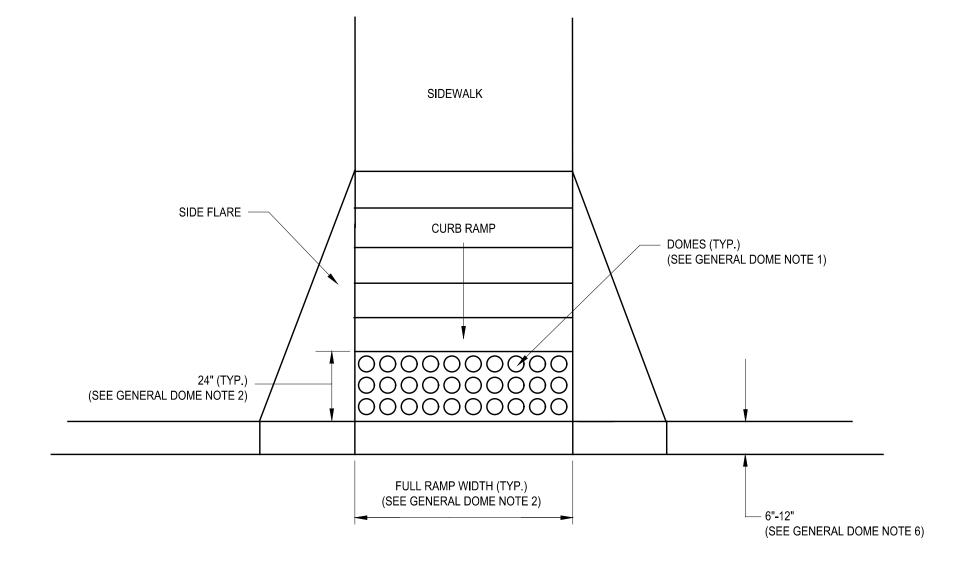
20 OF No. 80

DRAWING NO.

C1-115

DATE: JANUARY 2023



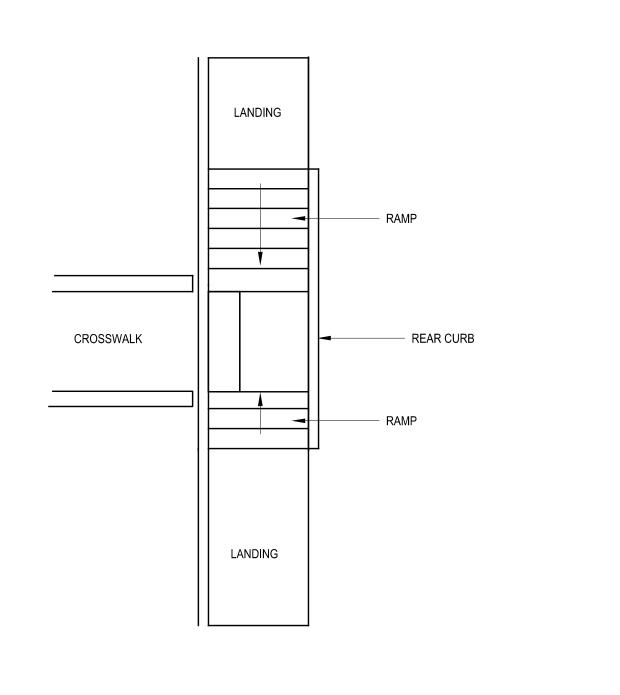

DOME (TYP.) (SEE GENERAL DOME NOTE 1)

1.6"-2.4"

DOME (TYP.) (SEE GENERAL DOME NOTE 1)

1.6"-2.4"

DOME (TYP.) (SEE GENERAL DOME NOTE 1)

DOME (TYP.) (SEE GENERAL DOME NOTE 1)

C DOME SECTION
- NOT TO SCALE


0.9" - 1.4"

50% - 60% OF BASE DIAMETER

D DOME SPACING
- NOT TO SCALE

## **GENERAL NOTES**

SEE NYSDOT DETAIL CURB RAMP CONFIGURATION: TYPE 9 MID BLOCK CROSSING

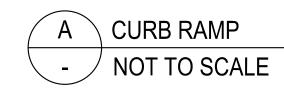



## **GENERAL DOME NOTES**

- 1. THE DETAILS PROVIDED ARE NOT DRAWN TO SCALE. THE QUANTITY OF DOMES DEPICTED ON THE DETECTABLE WARNING FIELD (THE DOMES AND THE ENTIRE 24"LEVEL SURFACE) IS FOR ILLUSTRATION ONLY.
- DETECTABLE WARNING FIELD DIMENSIONS
- 2. THE SIZE OF THE DETECTABLE WARNING FIELD SHALL BE 24" IN THE DIRECTION OF TRAVEL AND SHALL EXTEND THE FULL WIDTH OF THE CURB RAMP OR FLUSH SURFACE, EXCLUSIVE OF SIDE FLARES.

#### DOME ALIGNMENT


- 3. THE ROWS OF DOMES SHALL BE ALIGNED TO BE PERPENDICULAR OR RADIAL TO THE GRADE BREAK BETWEEN THE RAMP LANDING OR CURB RAMP AND THE STREET.
- 4. WHERE DOMES ARE ARRAYED RADIALLY THEY MAY DIFFER IN DOME DIAMETER AND CENTER-TO-CENTER SPACING WITHIN THE RANGES SPECIFIED ON THIS SHEET.

#### COLOR REQUIREMENTS

5. THE DETECTABLE WARNING FIELD SHALL BE THE COLOR SPECIFIED IN THE CONTRACT DOCUMENTS OR MEET THE REQUIREMENTS OF THE STANDARD SPECIFICATIONS.

#### DETECTABLE WARNINGS LOCATIONS

- 6. DETECTABLE WARNINGS SHALL BE LOCATED SO THAT THE EDGE OR ON CURB RAMP TYPE 1 AT LEAST ONE CORNER OF THE WARNING FIELD NEAREST TO THE ROADWAY IS 6" TO 8.9" FROM THE FRONT OF THE CURB OR THE EDGE (12" WHERE TRAVERSABLE CURB IS USED).
- 7. THE EDGE OF THE DETECTABLE WARNING FIELD NEAREST TO A RAILROAD CROSSING SHALL BE 5.9' MINIMUM AND 15' MAXIMUM FROM THE CENTERLINE OF THE NEAREST RAIL.

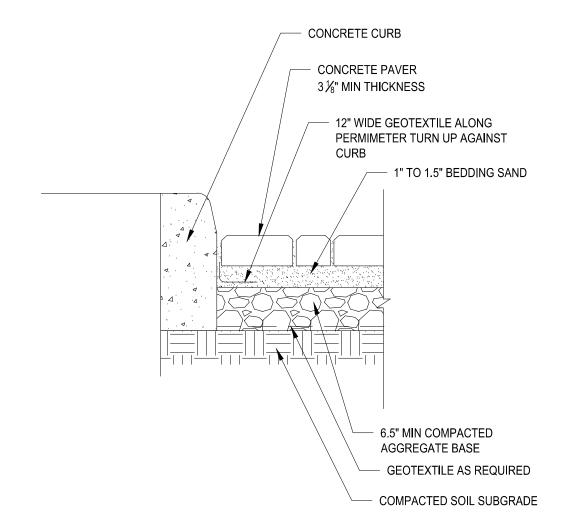

E CONCRETE PAVER
- NOT TO SCALE

ACCOUNTABLE MANAGER

PROJECT MANAGER

MARK DELBALZO, P.E.

JOSE NIEVES

/ Environmental

**Protection** 

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# NEW YORK CITY ENVIRONMENTAL PROTECTION

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IF SHEET IS LESS THAN 22" X 34"

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SCALE ACCORDINGLY

WATERFOWL MANAGEMENT PROGRAM BUILDING

DATE: JANUARY 2023

AND PAVING MOUNT PLEASANT, NEW YORK

DETAILS - 3

SCALE: N.T.S

SHEET NO:

21 OF No. 80


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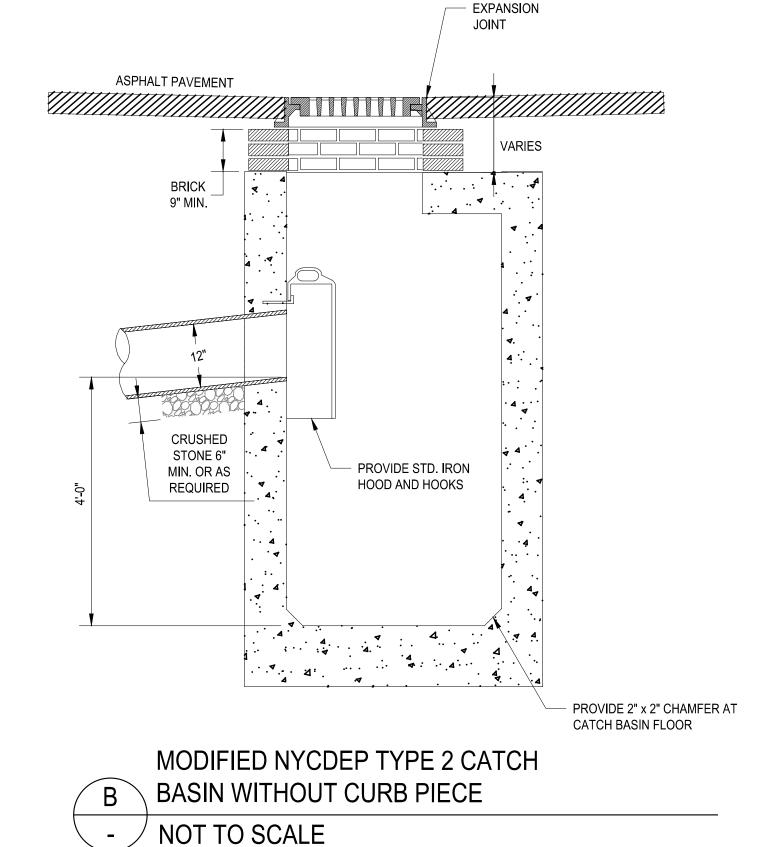
C1-116

0.3" MIN.

GEDEON GRC CONSULTING ENGINEERS - PLANNERS - CONSTRUCTION MANAGERS 6901 JERICHO TURNPIKE, SUITE 216 SYOSSET, N.Y. 11791 DESIGNED BY: DRAWN BY: J. CAUSARANO C. DEBONA CHECKED BY: DESIGN LEAD: R. GEDEON J. LAPADULA Hazen REVISIONS/DESCRIPTION APPR'D NO. DATE

All inquiries regarding this drawing(s) or project should be made to NYC Environmental Protection, Bureau of Engineering Design and Construction.



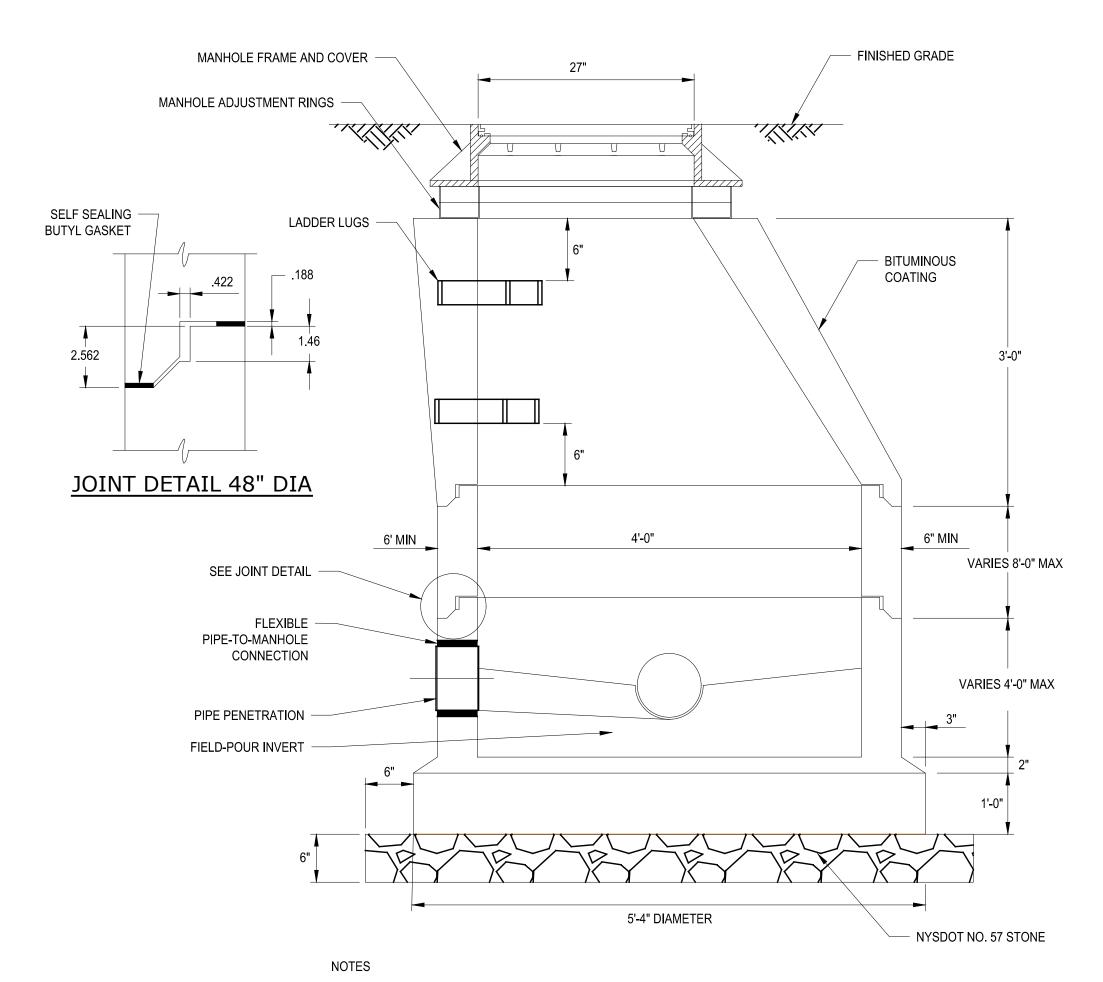

27" DIAMETER CAST IRON MANHOLE FRAME AND COVER

CITY OF NEW YORK
DEPARTMENT OF ENVIRONMENTAL PROTECTION

STANDARD FOR 27" DIAMETER CAST IRON MANHOLE FRAME AND COVER

(FOR ACCESS OR CLEANOUT)

SECTION OF FRAME

SECTION OF COVER

SE39

SECTION A-A

BOTTOM VIEW OF COVER

/ NOT TO SCALE

# SEAD STANDARD FOR 27" DIAMETER CAST IRON EXTENSION RING FOR 27" DIAMETER MANHOLE FRAME AND COVER SECTION E = 2" for 2" reliase E = 3" for 3" reliase E = 4" for 4" reliase Minimum Raises 2" Maximum Raises 2" Maximum Raises 4" I DATE NOTES: PLAN O DEBRILLANGE SIGNAL HAVE THE MANEYACTURERS (DEMPRICATION). CAST DATE (O) MANAPACTURER IS (DEMPRICATION). THE TOP STREEMED THE TABLE PE AND A COMMUNICATION OF STREEMED THE TABLE OF STREEMED THE TABLE PE AND A COMMUNICATION OF STREEMED THE TABLE OF STREEMED THE TABLE PE AND A COMMUNICATION OF STREEMED THE TABLE OF STREEMED THE TABLE PE AND A COMMUNICATION OF STREEMED THE TABLE OF STREEMED THE TABLE PE AND A COMMUNICATION OF STREEMED THE TABLE OF STREEMED THE TABLE PE AND A COMMUNICATION OF STREEMED THE TABLE OF STREEMED THE TABLE PE AND A COMMUNICATION OF STREEMED THE TABLE OF STREEMED THE TABL


27" DIAMETER CAST IRON EXTENSION RING FOR 27" DIAMETER FRAME AND COVER

- NOT TO SCALE

**BID SET** 

- 1. REINFORCING SHALL COMPLY WITH DEP SEWER DESIGN STANDARDS SE28A, STANDARD FOR 4'0" DIAMETER PRECAST MANHOLF
- 2. RISER SECTIONS SHALL COMPLY WITH ASTM C478-12, STANDARD SPECIFICATION FOR PRECAST REINFORCED CONCRETE MANHOLE SECTIONS.
- 3. ALL CONCRETE SHALL HAVE A MINIMUM COMPRESSIVE STRENGTH OF 4,000 PSI.
- 4. PRECAST CONCRETE MANHOLES GREATER THAN 4'-0" IN DIAMETER SHALL COMPLY WITH DRAWINGS SE29 AND/OR SE30 OF THE NYCDEP SEWER DESIGN STANDARDS, JANUARY 2009 OR LATEST EDITION.



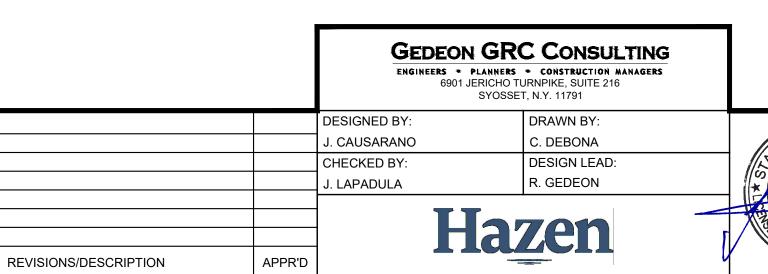

ACCOUNTABLE MANAGER
JOSE NIEVES
PROJECT MANAGER
MARK DELBALZO, P.E.

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EDUCATION, LAW, SECTION, 7209.2."

# NEW YORK CITY ENVIRONMENTAL PROTECTION

SE39

NOTES:

N.Y.C SEWER

| MADE IN XXXX

PLAN VIEW OF FRAME AND COVER

(1) FRAME MATERIAL: GRAY CAST IRON ASTM A-48 CLASS 35B. MINIMUM WEIGHT OF FRAME IS 345 LBS.

(3) DESIGN LOADING: HS20-44 HIGHWAY LOADING.

BUREAU OF WATER SUPPLY
465 COLUMBUS AVENUE, SUITE 270
VALHALLA, NEW YORK 10595-1336
www.nyc.gov/dep

WATERFOWL MANAGEMENT PROGRAM BUILDING AND PAVING MOUNT PLEASANT, NEW YORK

PLEASANT, NEW YORK

DETAILS - 4

SHEET NO:

22 OF No. 80

DRAWING NO.

C1-117

DATE: JANUARY 2023

SCALE: N.T.S


IF SHEET IS LESS THAN 22" X 34"


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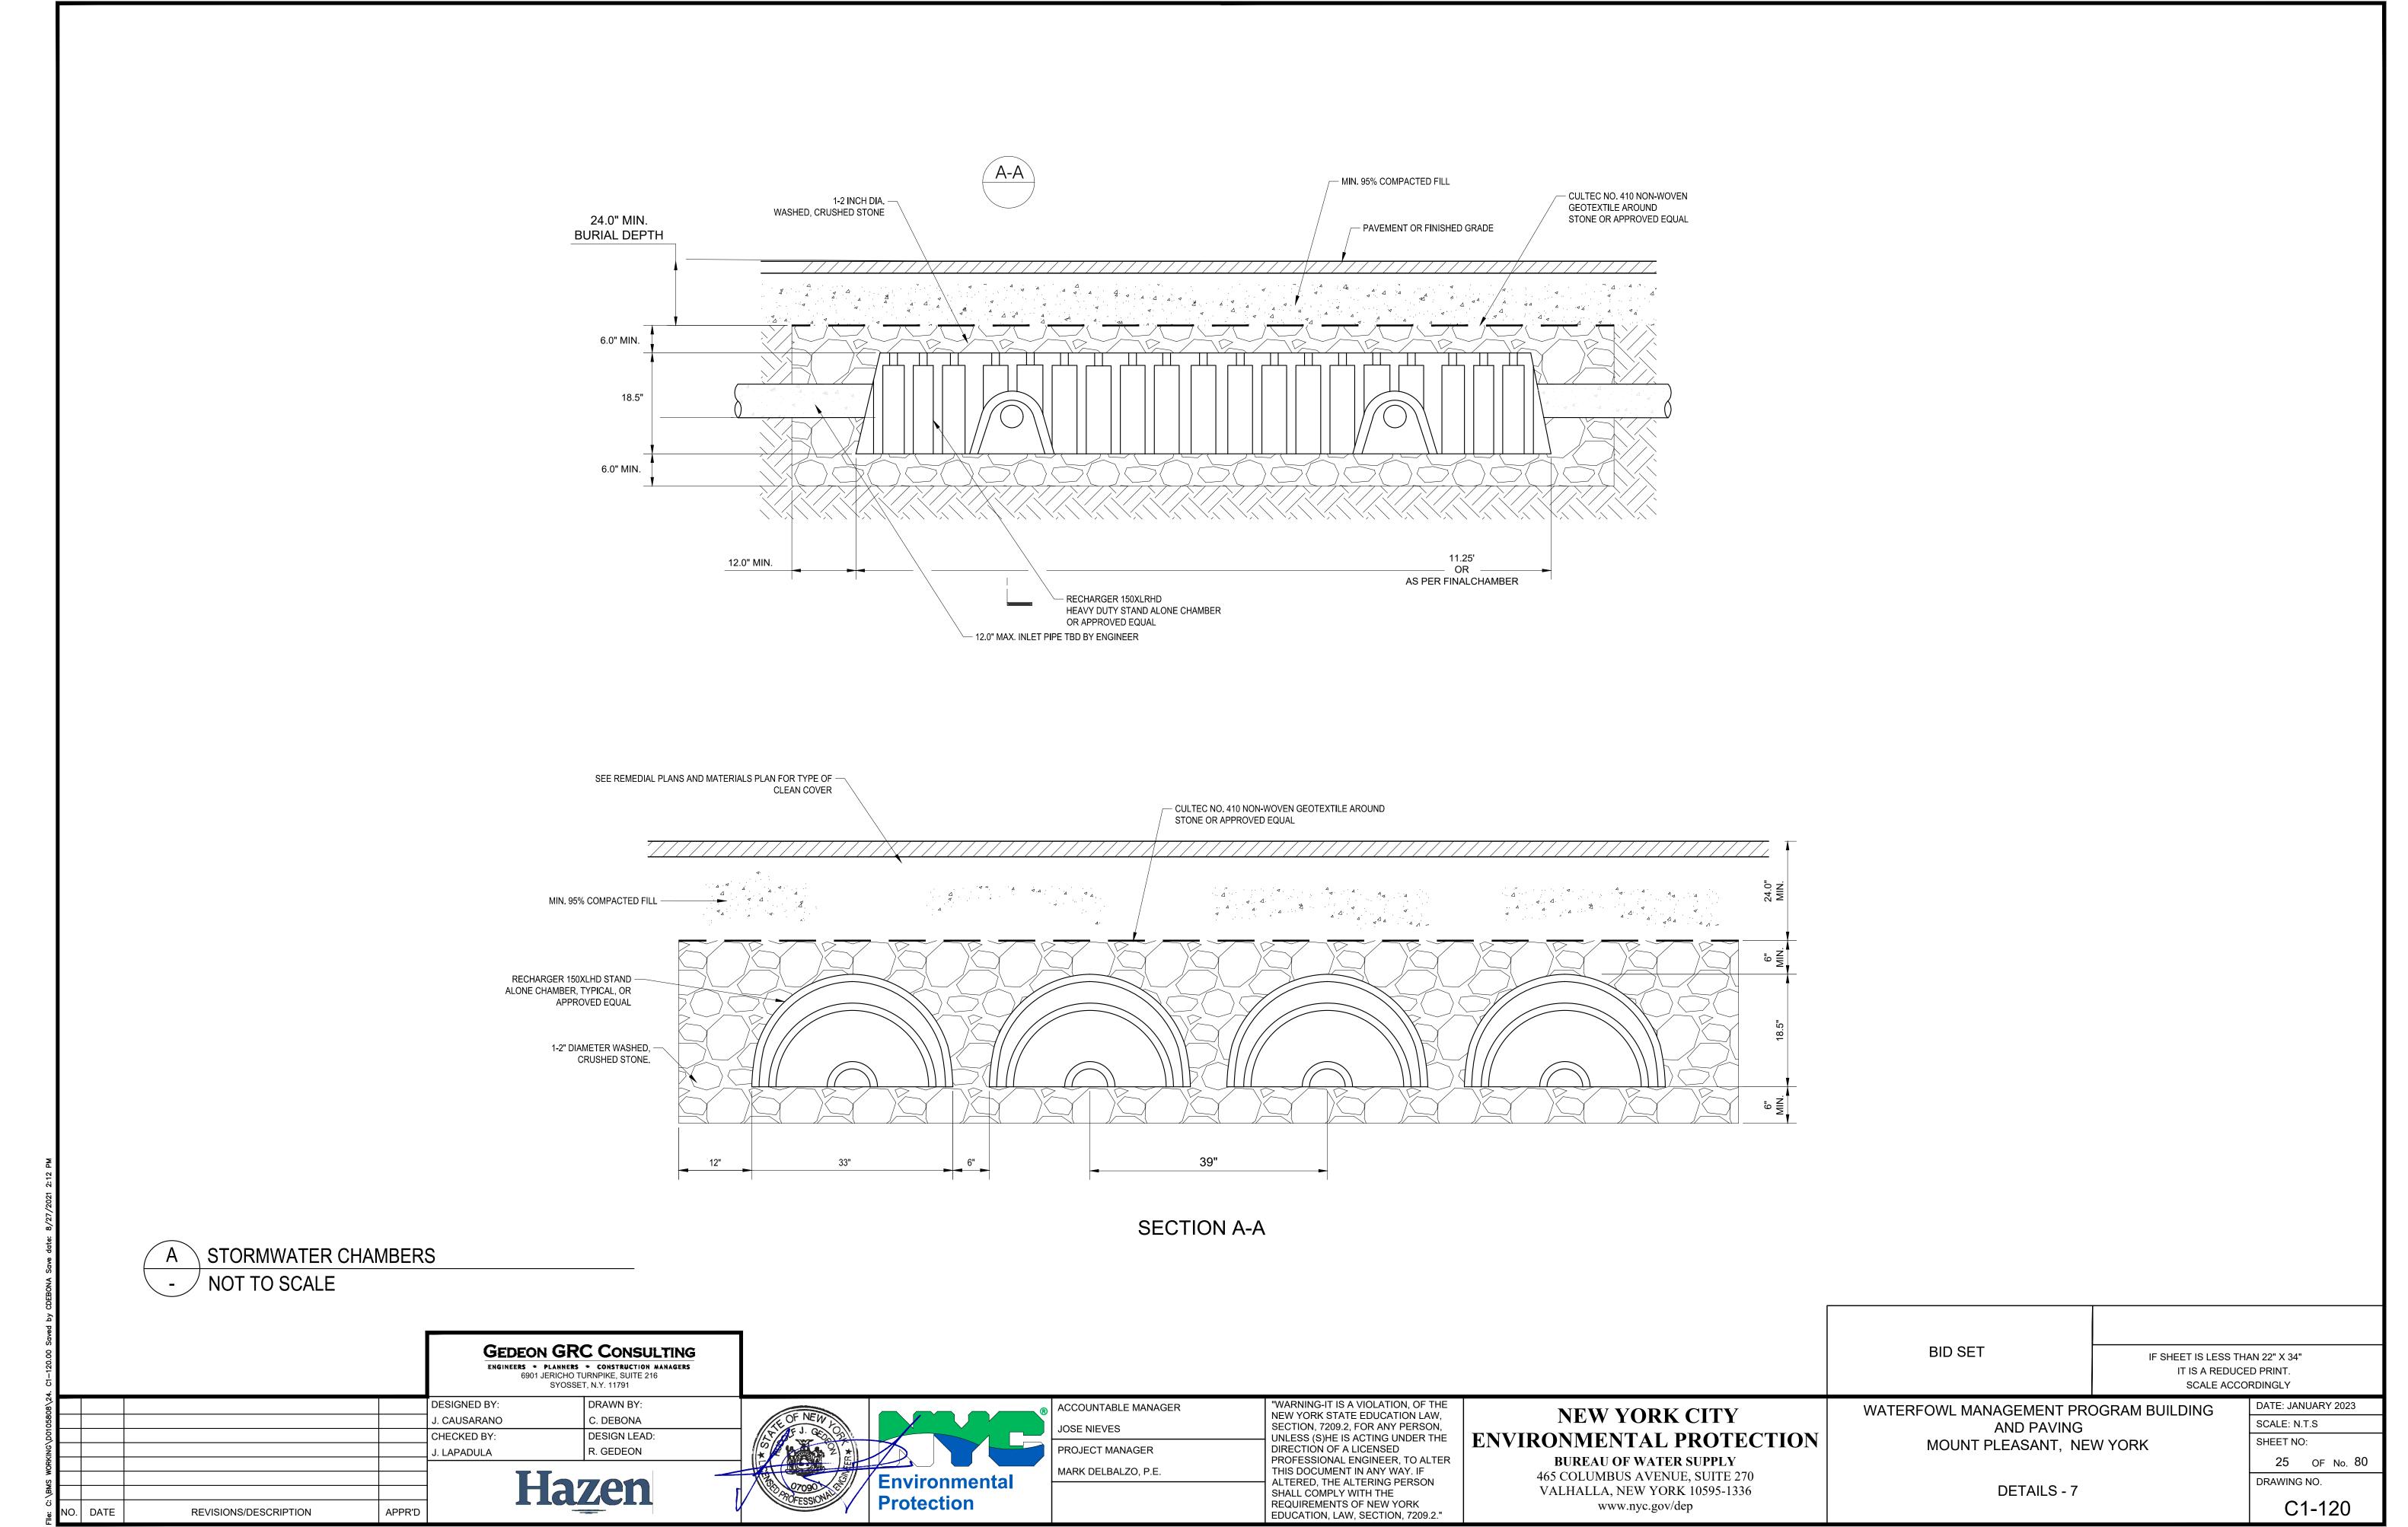
SCALE ACCORDINGLY

All inquiries regarding this drawing(s) or project should be made to NYC Environmental Protection, Bureau of Engineering Design and Construction.

NO. DATE



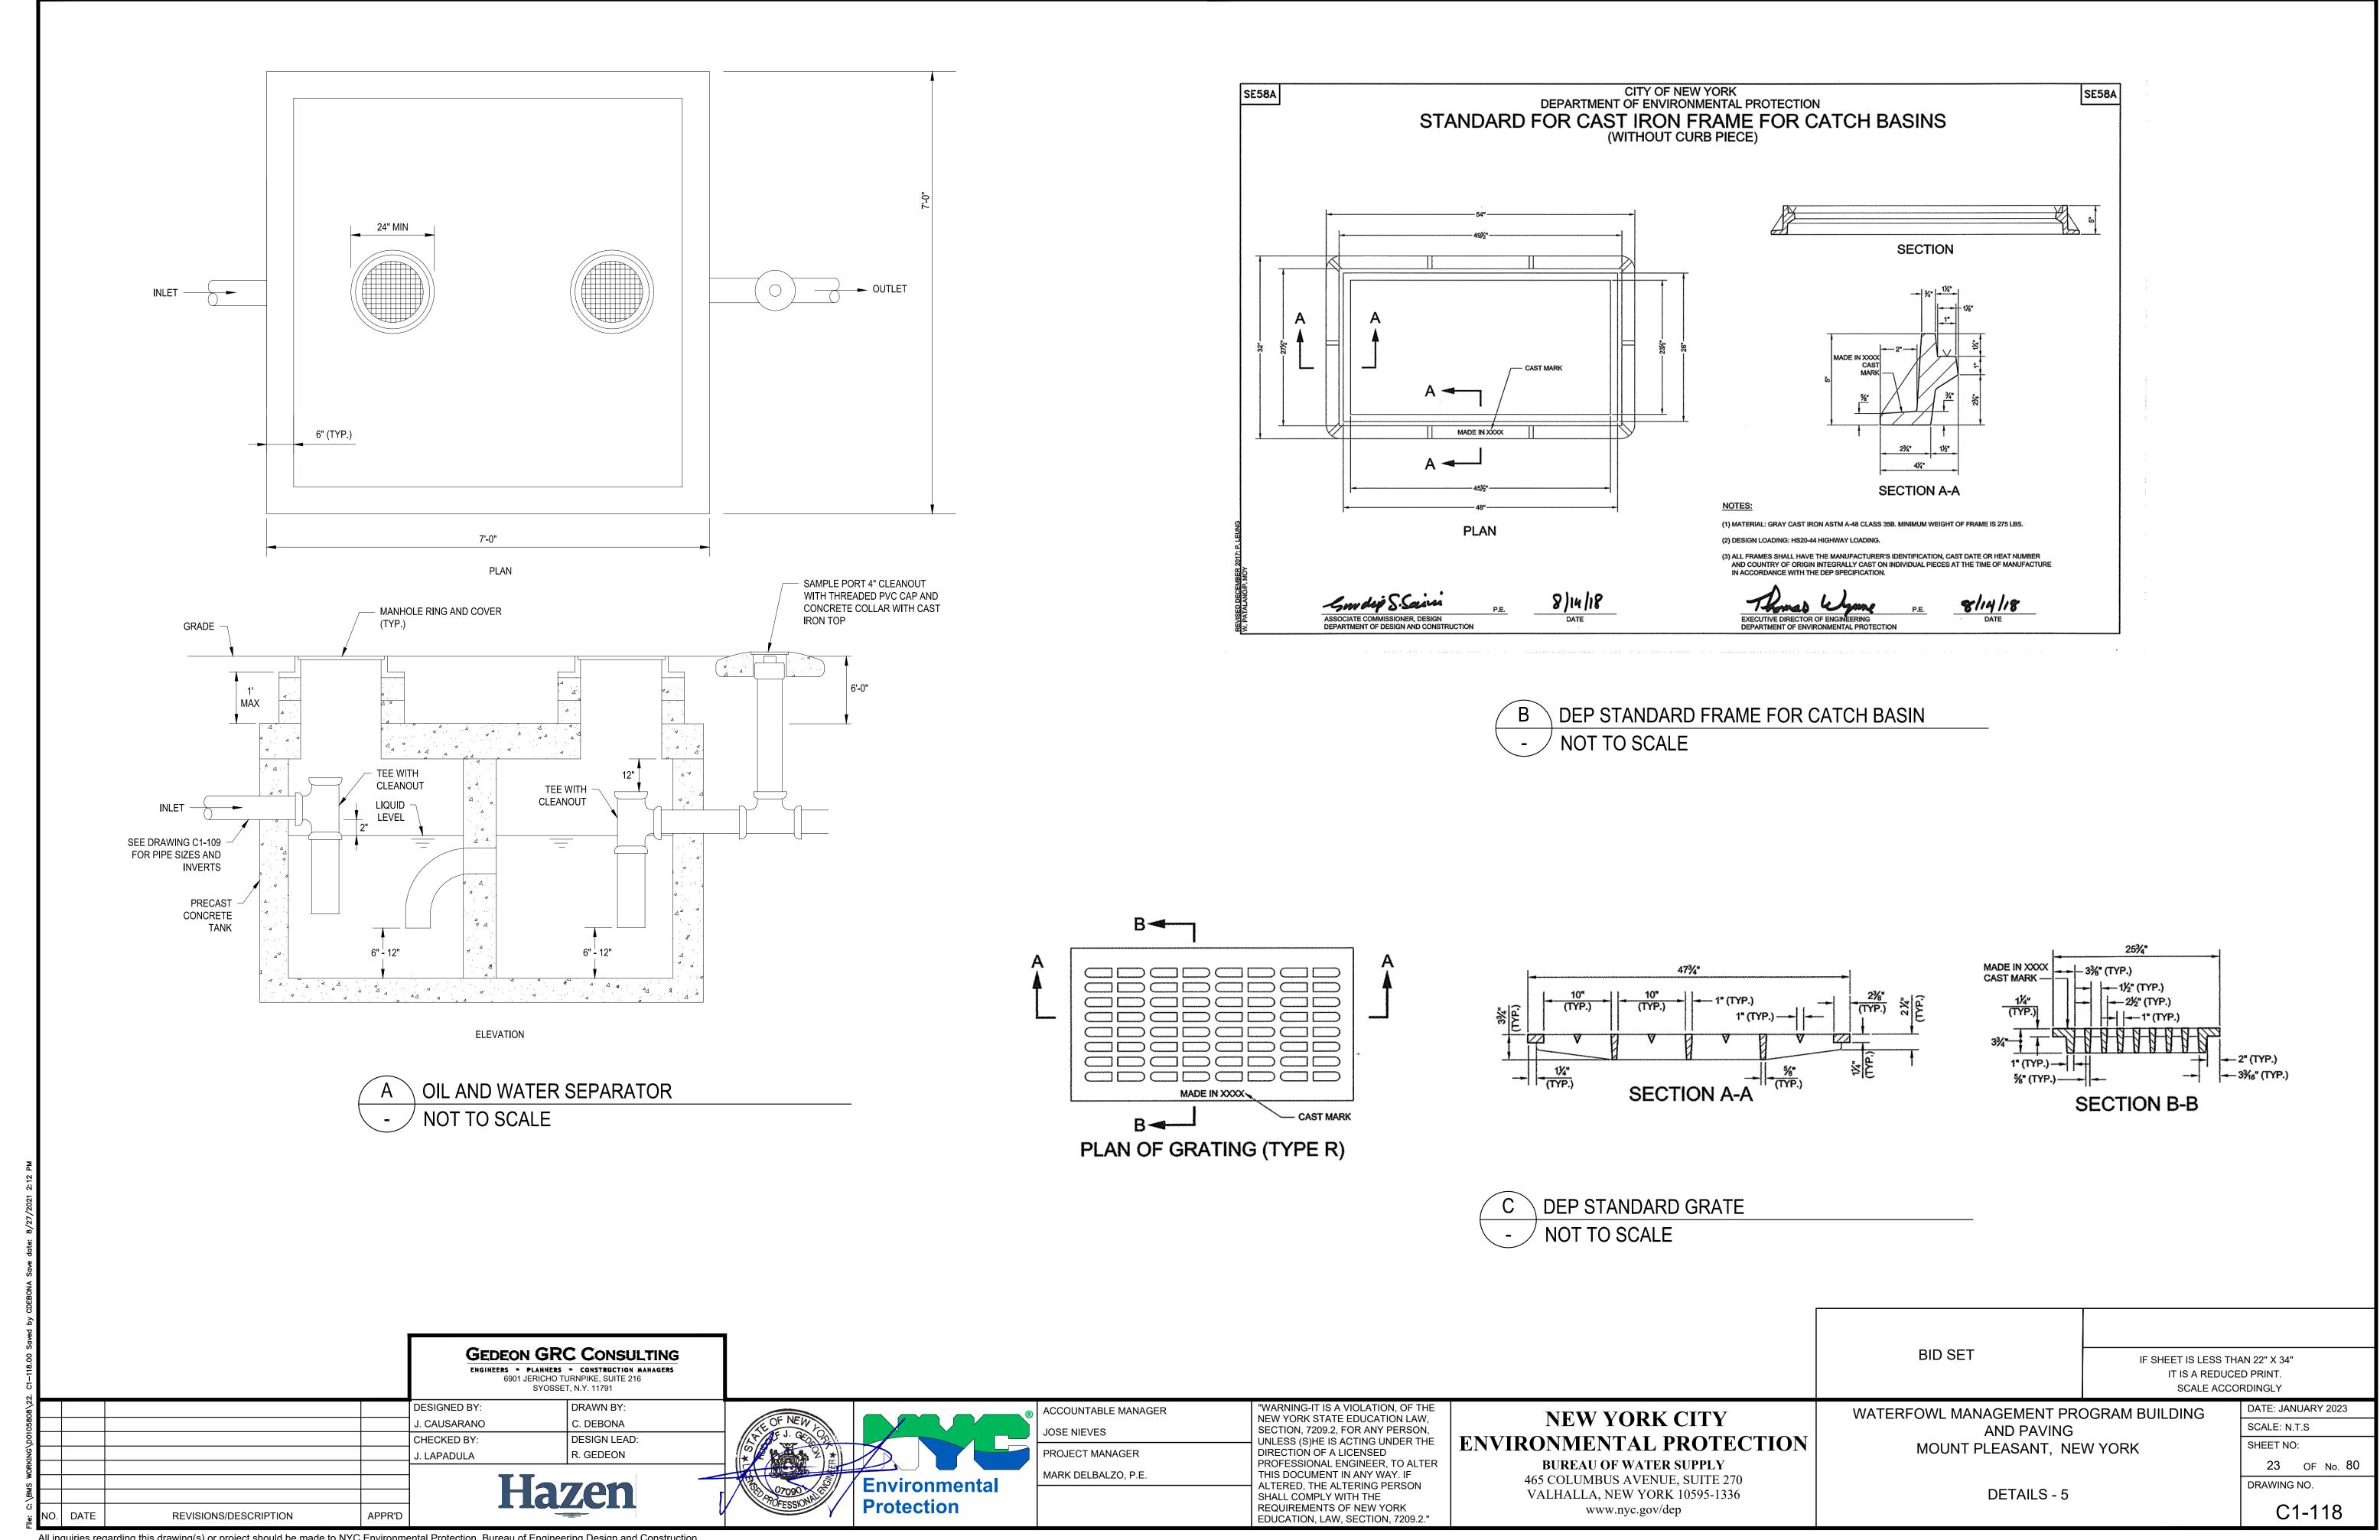

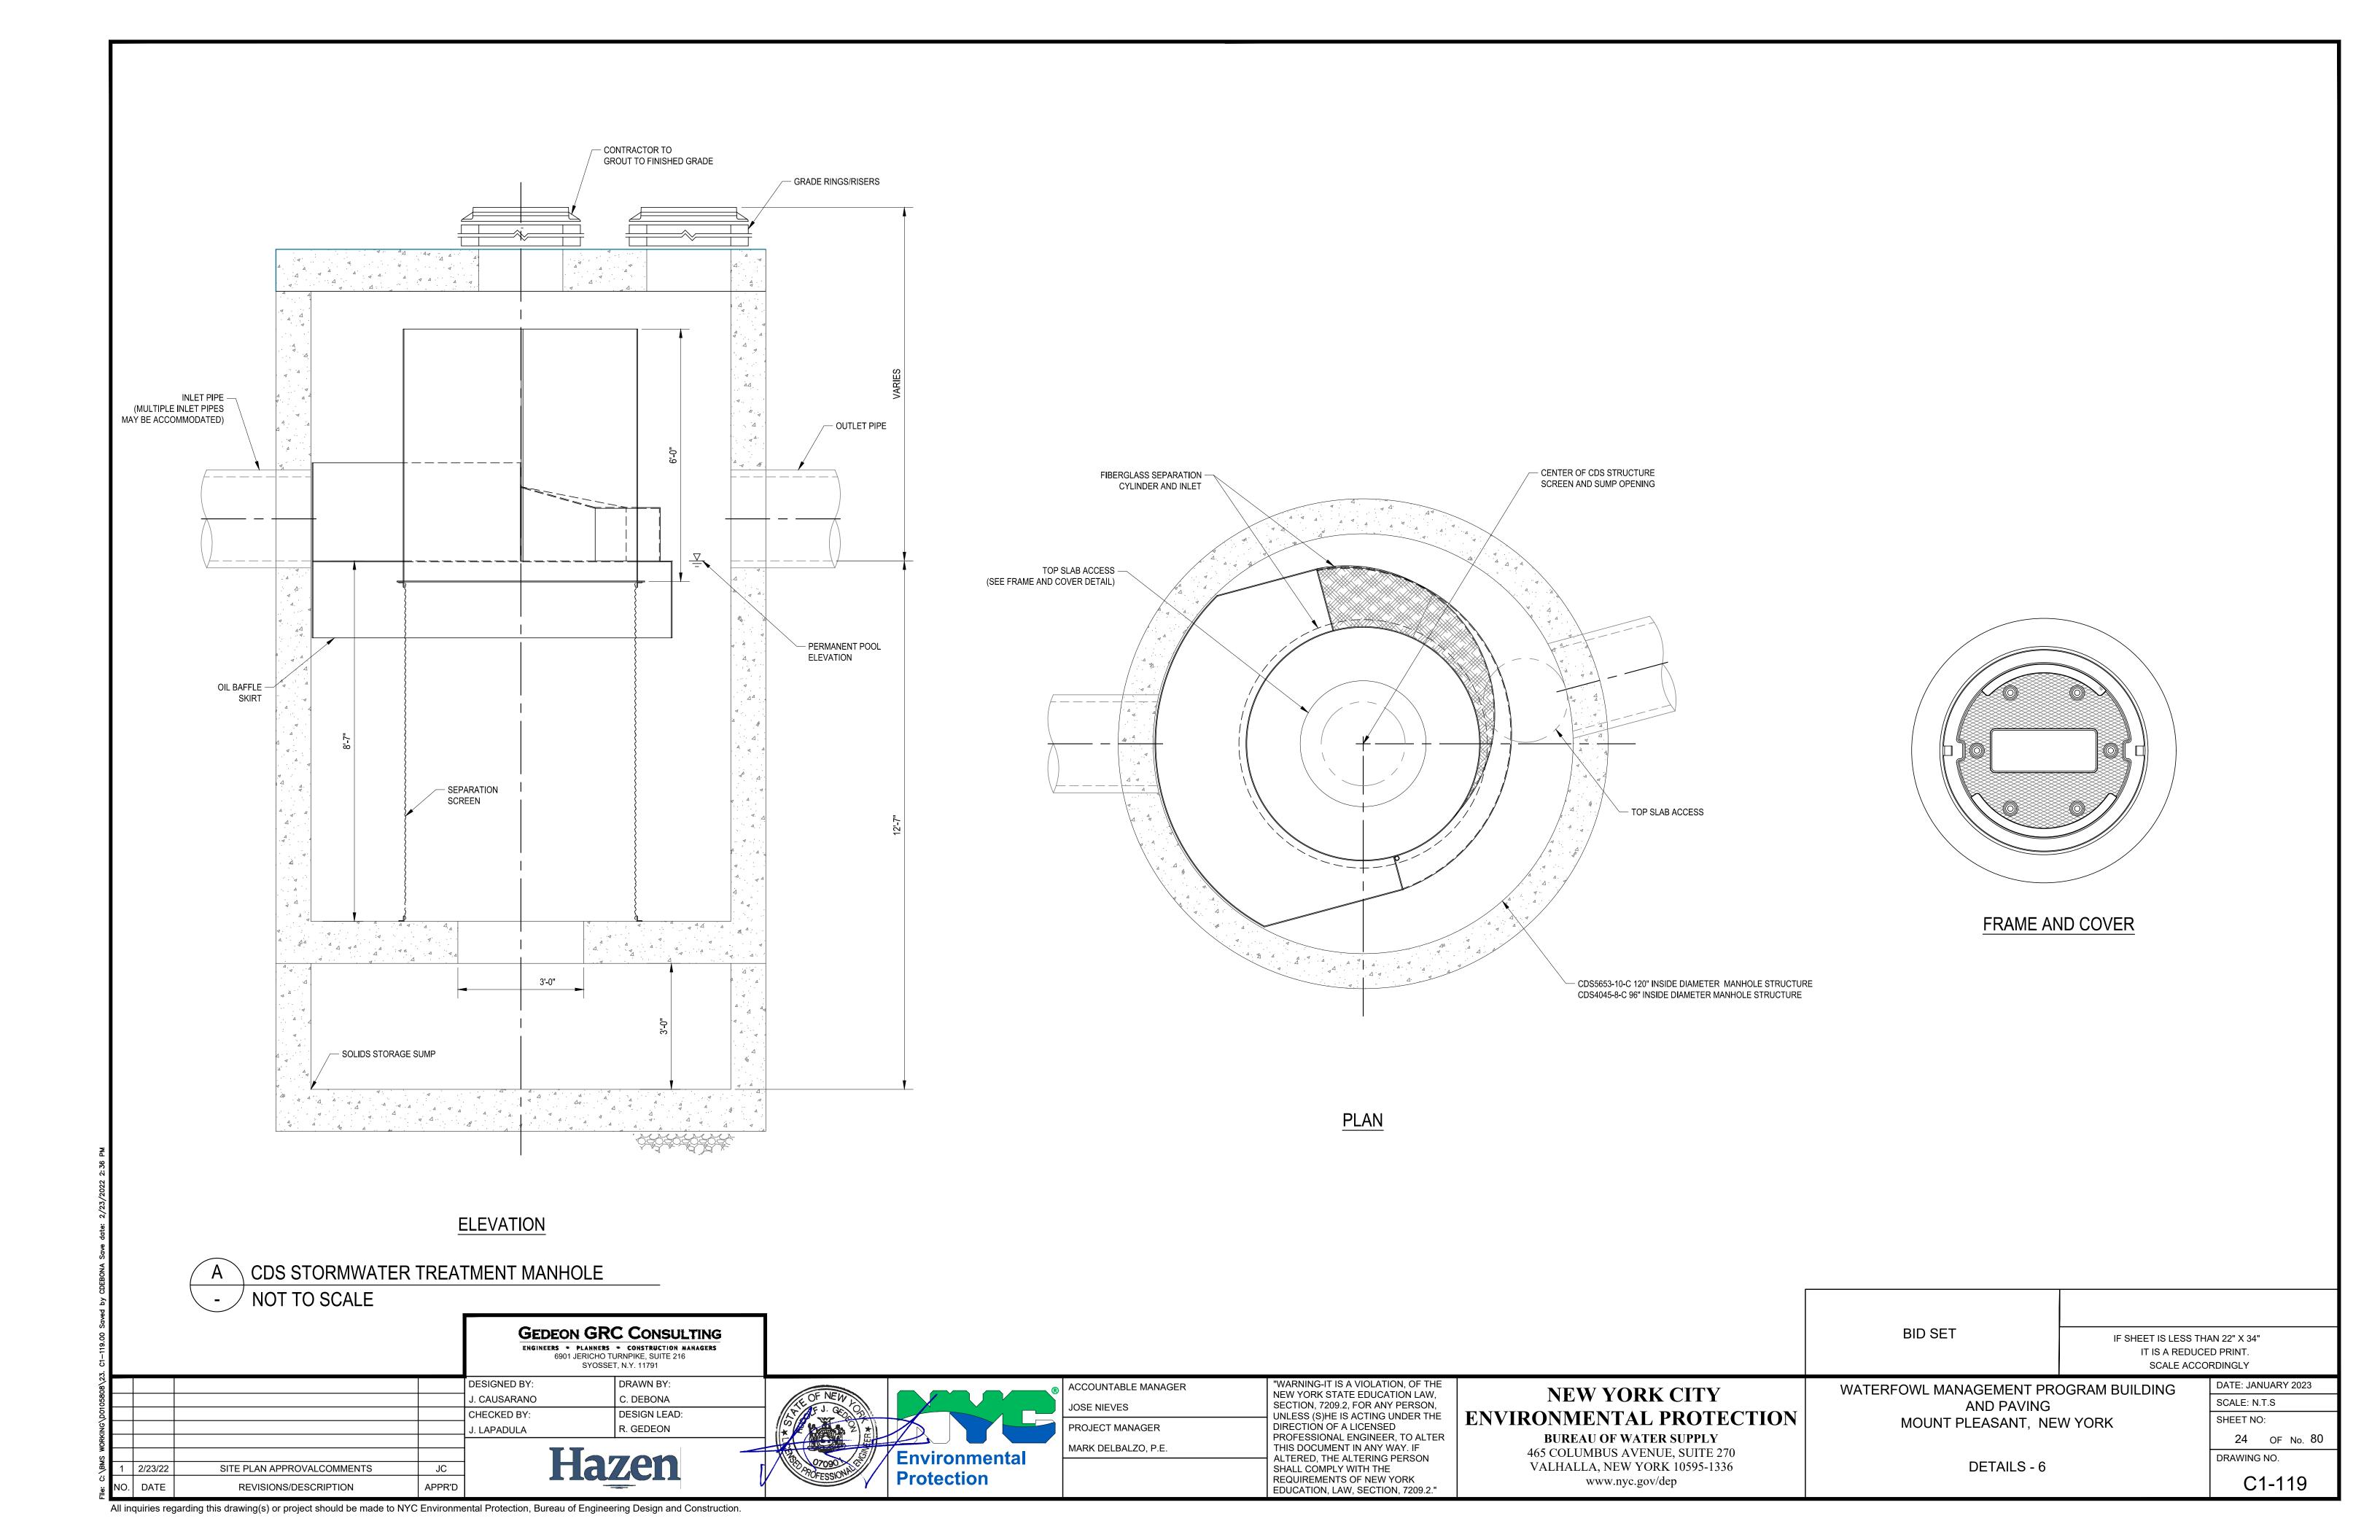

#### NOTES:

- 1. THE CONTRACTOR SHALL TAKE CARE TO AVOID DAMAGE TO EXISTING PAVEMENT, TREES, VEGETATION, STRUCTURES, AND UTILITIES THAT ARE NOT INDICATED TO BE DEMOLISHED OR REMOVED. ANY DAMAGE TO EXISTING PAVEMENT, TREES, VEGETATION, STRUCTURES, AND UTILITIES NOT INDICATED TO BE DEMOLISHED OR REMOVED SHALL BE REPAIRED AT THE CONTRACTOR'S EXPENSE. ANY TREES DAMAGED BY THE CONTRACTOR NOT SCHEDULED TO BE REMOVED SHALL BE REPLACED IN KIND WITH TREE OR TREES OF EQUAL CALIPER AND VARIETY.
- 2. ANY AREA OUTSIDE THE LIMITS OF DISTURBANCE IS NOT TO BE AFFECTED BY THE CONTRACT WITHOUT PRE-APPROVAL FROM THE ENGINEER. ANY AREA AFFECTED BY THE CONTRACTOR SHALL BE RESTORED AS PER THE DIRECTION OF THE ENGINEER AT THE CONTRACTOR'S EXPENSE.
- 3. THE CONTRACTOR SHALL NOT DRIVE ANY VEHICLE OR STORE ANY MATERIALS WITHIN THE DRIPLINE OF ANY EXISTING TREE OR SHRUB TO BE RETAINED. FURTHERMORE, ALL SOFTSCAPE AREAS WITHIN THE WORK LIMITS SHALL BE PROTECTED FROM COMPACTION. CORRECTIVE DECOMPACTION MEASURES SHALL BE TAKEN IN THE CASE OF ANY COMPACTION AT THE DIRECTION OF THE ENGINEER AND AT THE CONTRACTOR'S EXPENSE. ANY DAMAGE TO EXISTING TREES OR VEGETATION SHALL BE REPLACED AT THE CONTRACTOR'S EXPENSE. TREE PROTECTION SHALL BE IN ACCORDANCE WITH SPECIFICATION 02230 SITE CLEARING AND TREE PROTECTION DETAIL ON DWG L1-302.
- 4. REFER TO DWG L1-100 FOR LANDSCAPE PLAN.
- 5. REFER TO DWG L1-301 FOR LANDSCAPE DETAILS.
- 6. REFER TO DWG L1-302 FOR LANDSCAPE SCHEDULE, NO MOW LAWN SEED MIX, AND LANDSCAPE DETAILS.
- 7. UNLESS INDICATED OTHERWISE ON THE DRAWINGS ALL AREAS DISTURBED BY CONSTRUCTION ACTIVITIES SHALL BE SEEDED WITH GRASS SEED FOR LAWN AREAS AS INDICATED IN SPECIFICATION 02910 PLANTING.
- 8. NO HERBICIDES SHALL BE ALLOWED EXCEPT WHERE APPROVED IN ADVANCE BY LANDSCAPE ARCHITECT IN ADVANCE IN WRITING.

#### SEEDING:

- 1. ALL SCHEDULE, SUBMITTAL, PRODUCTS AND METHODS FOR SEEDING OPERATIONS SHALL BE IN ACCORDANCE WITH SPECIFICATION 02910 PLANTING AND SEED SCHEDULE ON DRAWINGS.
- 2. ALL SEED SHALL BE INTERAGENCY CERTIFIED UNDER THE AUSPICES OF A STATE SEED IMPROVEMENT COOPERATIVE AND SHALL BEAR THEIR SEALS OF CERTIFICATION ON EACH BAG. PERMANENT SEED SHALL BE 75% PURE LIVE SEED MINIMUM.
- 3. SEED BROUGHT TO THE PROJECT SITE SHALL BE IN UNOPENED BAGS SHOWING THE NET WEIGHT, COMPOSITION OF MIX, SUPPLIERS NAME AND GUARANTEE OF ANALYSIS. SEED SHALL BE STORED IN ORIGINAL UNOPENED PACKAGES, KEPT DRY, AND NOT OPENED UNTIL NEEDED FOR USE. DAMAGED OR FAULTY PACKAGES SHALL NOT BE USED AND WILL BE REJECTED. SEED SHALL BE FRESH, RECLEANED SEED OF THE LATEST CROP AND BE IN CONFORMANCE WITH THE PLANTING SPECIFICATION. ALL SEED MATERIALS SHALL BE PROTECTED FROM DRYING OUT AND FROM WIND DAMAGE DURING DELIVERY. SEED MIX FOR NOW MOW LAWN SEED MIX SHALL AND RATE OF APPLICATION SHALL BE AS SPECIFIED ON DWG L1-302 NO MOW LAWN SEED MIX. GRASS SEED FOR LAWN AREAS SHALL BE MIX AND RATE AS INDICATED IN SPECIFICATION 02910 PLANTING.
- 4. ALL SEED MIXES AND PLANT SOURCES SHALL BE SUBMITTED IN ADVANCE FOR REVIEW AS NOTED IN SPECIFICATION 02910 PLANTING.
- 5. SEED MIXTURE SHALL BE INSPECTED BY THE ENGINEER UPON ARRIVAL AT THE JOB SITE AND PRIOR TO INSTALLATION. ANY MATERIALS NOT IN COMPLIANCE WITH THE PLANTING SPECIFICATION WILL NOT BE ACCEPTED AND SHALL BE REMOVED FROM THE JOB SITE IMMEDIATELY.
- 6. SEEDBED PREPARATIONS AND SEEDING SHALL BE AS STATED IN THE SPECIFICATION 02910 PLANTING.
- 7. DO NOT BROADCAST SEED BY MECHANICAL APPLICATION WHEN THE WIND VELOCITY IS SUCH TO PREVENT UNIFORM SEED DISTRIBUTION.
- 8. ALL SEEDED AREAS SHALL BE COVERED WITH ECS-1B SINGLE NET STRAW BIODEGRADABLE ROLLED EROSION CONTROL PRODUCT AS PER PLANTING SPECIFICATION AND EROSION CONTROL MATTING DETAIL, DWG L1-302.
- 9. SEEDED AREAS SHALL BE WATERED AT A MINIMUM OF ONCE PER WEEK UNTIL SEED HAS GERMINATED AND BECOME ESTABLISHED.
- 10. ACCEPTABLE SEEDING ESTABLISHMENT WILL BE 85% COVERAGE OF THE OPEN AREA WITH THE SEEDED SPECIES. ANY AREA NOT MEETING THIS REQUIREMENT SHALL BE RESEEDED WITH THE ORIGINAL SEED MIX.

#### <u>PLANTING:</u>

- 1. ALL PLANTINGS SHALL BE IN ACCORDANCE WITH THE PLANS AND SPECIFICATIONS. IN THE EVENT THE ACTUAL LIMITS OF SITE CLEARING AND STAGING AREAS DIFFER FROM THOSE SHOWN IN THE PLANS, THE CONTRACTOR SHALL SUBMIT SHOP DRAWINGS FOR PLANTINGS IN CONFORMANCE WITH THE SPECIFICATIONS, SHOP DRAWINGS FOR REVISED PLANTINGS SHALL BE SUBMITTED A MINIMUM OF 90 DAYS IN ADVANCE OF THE PLANTING SEASON WHEN PLANTING IS SCHEDULED TO OCCUR.
- 2. ALL PLANTS SHALL BE CERTIFIED AND INSPECTED FREE OF ALL FUNGUS, GRUBS AND INSECTS THAT MAY HAVE DELETERIOUS EFFECT ON THE SURROUNDING FAUNA AND FLORA. ALL PLANT MATERIAL TO BE VIGOROUS, FREE OF INJURY OR DEFECTS. ALL PLANT MATERIAL SHALL BE STOCK FROM AN APPROVED NURSERY AS PER THE SPECIFICATION.
- 3. ALL B&B MATERIAL IS TO HAVE BALL/PLANT SIZE RELATIONSHIP AS SPECIFIED BY THE AMERICAN NURSERY AND LANDSCAPE ASSOCIATION, ANSI Z60.1 LATEST EDITION.
- 4. ALL SHRUB BEDS, UNLESS OTHERWISE NOTED, SHALL BE MULCHED AS SPECIFIED IN SPECIFICATION 02910 PLANTING AND IN DRAWINGS.
- 5. NO SUBSTITUTIONS WILL BE ACCEPTED UNLESS AUTHORIZED IN WRITING BY THE LANDSCAPE ARCHITECT.
- 6. ALL TREES TO BE PLANTED 5'-0" MIN FROM ALL DRAINAGE STRUCTURE, DRAINAGE LINES AND ALL UTILITIES. THE CONTRACTOR SHALL BE RESPONSIBLE FOR VERIFYING LOCATION OF DRAINAGE STRUCTURES ON SITE.
- 7. THE CONTRACTOR SHALL EXCAVATE AS NEEDED AND PROVIDE TOPSOIL TO ACHIEVE FINISHED GRADES IN ALL AREAS TO BE SEEDED OR OTHERWISE PLANTED. TOPSOIL SHALL BE SIX (6) INCHES MINIMUM IN SEEDED AREAS FOR ALL SEEDED AREAS AND DEEPER AS SPECIFIED FOR SHRUB AND TREES AS PER DETAILS.
- 8. THE ENGINEER MAY REJECT ANY MATERIAL NOT IN CONFORMANCE WITH THE PLANTING SCHEDULES AND THE PLANTING SPECIFICATION REQUIREMENTS.
- 9. THE CONTRACTOR SHALL EXCAVATE AS NEEDED AND PROVIDE TOPSOIL TO ACHIEVE FINISHED GRADES IN ALL AREAS TO BE SEEDED OR OTHERWISE PLANTED. TOPSOIL SHALL BE 6" MINIMUM IN SEEDED AREAS.
- 10. FERTILIZER SHALL BE APPLIED IN ACCORDANCE WITH SPECIFICATION 02910 PLANTING. FERTILIZER DELIVERED TO THE SITE SHALL BE IN ORIGINAL, UNOPENED CONTAINERS BEARING THE MANUFACTURER'S CHEMICAL ANALYSIS AND ESSENTIAL INFORMATION. FERTILIZER CONTAINERS SHALL BE PROTECTED FROM EXPOSURE TO PRECIPITATION AND DIRECT SUNLIGHT.
- 11. PLANTS SHALL BE INSTALLED IN "DRY" CONDITIONS AND NOT WHEN PLANTING LOCATIONS ARE WET OR FROZEN. PRIOR TO INSTALLATION, CONTRACTOR SHALL STAKE OUT AND RECEIVE APPROVAL FROM ENGINEER FOR LOCATIONS OF PLANTINGS.
- 12. INSTALL MULCH ACROSS ENTIRE PLANTING BEDS INCLUDING ALL AREAS OF TREE, SHRUB, ORNAMENTAL GRASS AND HERBACEOUS PLUG PLANTING AS PER PLANTING SPECIFICATION AND EACH ASSOCIATED PLANTING DETAIL ON DWG L1-302. NO MULCH SHALL BE APPLIED TO SEEDED AREAS.

DESIGNED BY:
E. MOSKALENKO, RLA
CHECKED BY:
K. WARD

DESIGNED BY:
E. MOSKALENKO, RLA
DESIGN LEAD:
E. BARBOE, PE

TO SET T



ACCOUNTABLE MANAGER

JOSE NIEVES

PROJECT MANAGER

MARK DELBALZO, P.E.

"WARNING-IT IS A VIOLATION, OF THE NEW YORK STATE EDUCATION LAW, SECTION, 7209.2, FOR ANY PERSON, UNLESS (S)HE IS ACTING UNDER THE DIRECTION OF A LICENSED PROFESSIONAL ENGINEER, TO ALTER THIS DOCUMENT IN ANY WAY. IF ALTERED, THE ALTERING PERSON SHALL COMPLY WITH THE REQUIREMENTS OF NEW YORK

EDUCATION, LAW, SECTION, 7209.2."

# NEW YORK CITY ENVIRONMENTAL PROTECTION

BUREAU OF WATER SUPPLY 465 COLUMBUS AVENUE, SUITE 270 VALHALLA, NEW YORK 10595-1336 www.nyc.gov/dep WATERFOWL MANAGEMENT PROGRAM BUILDING AND PAVING MOUNT PLEASANT, NEW YORK

**BID SET** 

LANDSCAPE GENERAL NOTES, SYMBOLS AND ABBREVIATIONS

DING

DATE: JANUARY 2023

SCALE:

SHEET NO:


26 OF No. 80


DRAWING NO.

L0-001

IF SHEET IS LESS THAN 22" X 34"
IT IS A REDUCED PRINT.


All inquiries regarding this drawing(s) or project should be made to NYC Environmental Protection, Bureau of Water Supply.

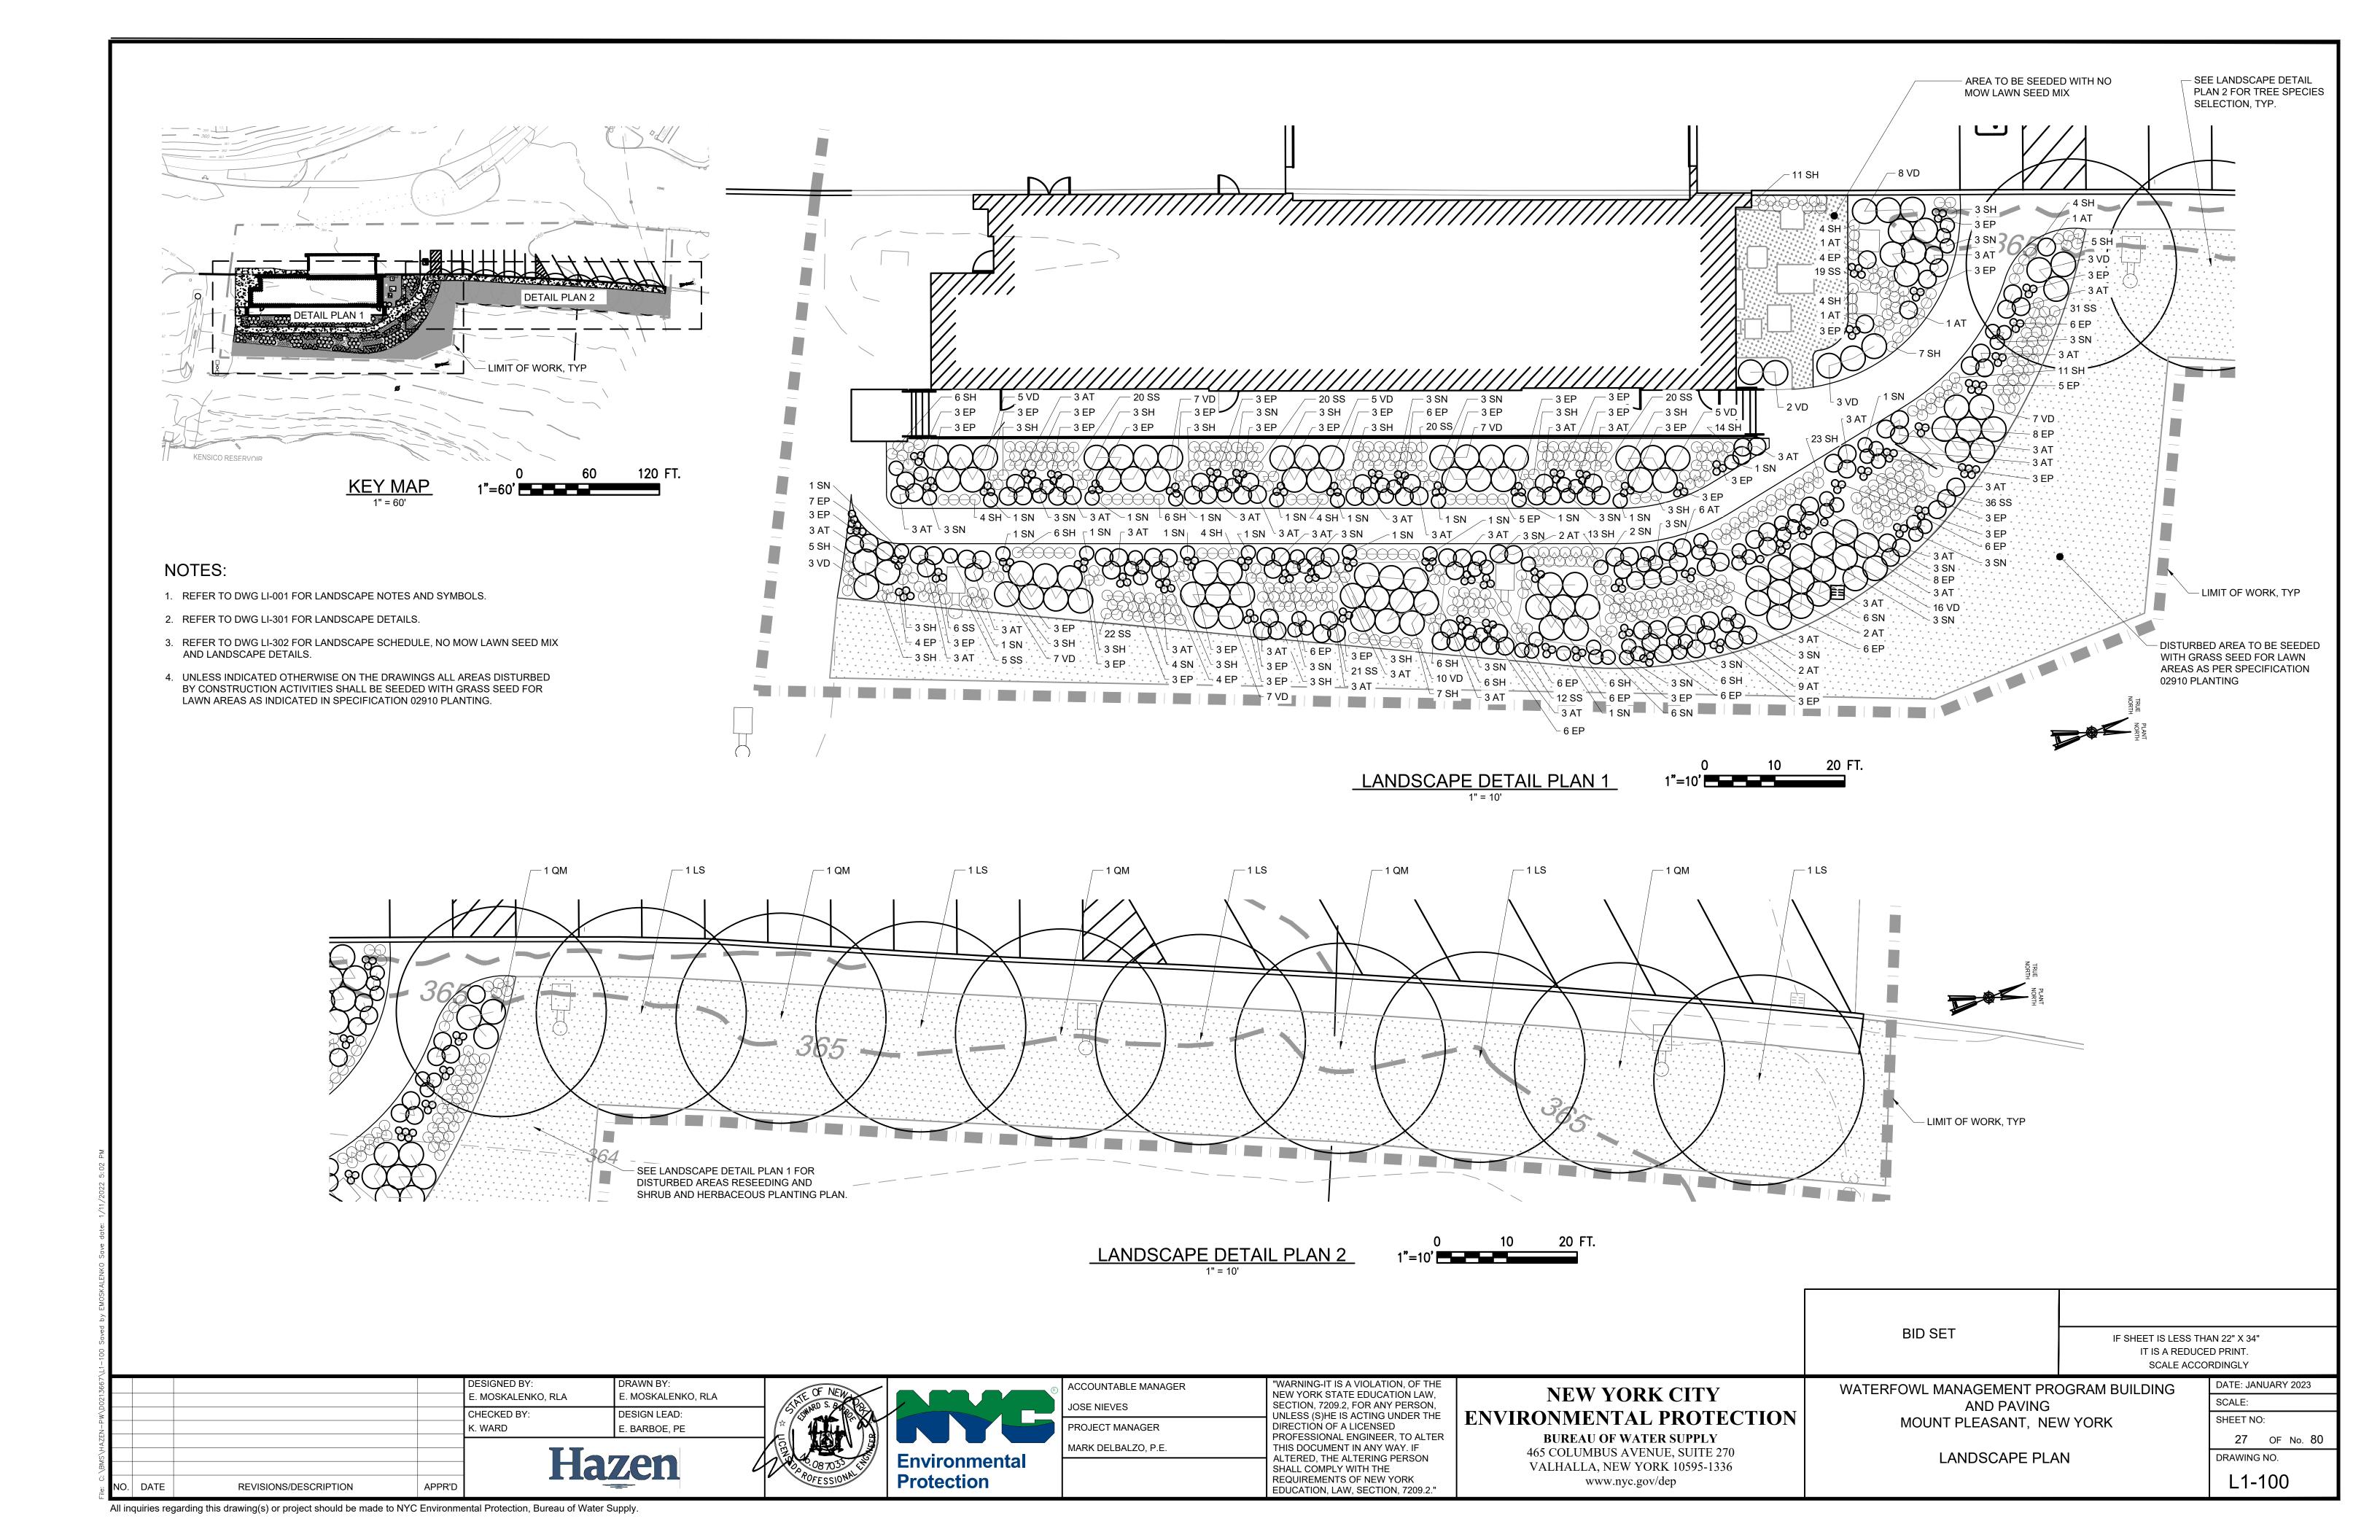

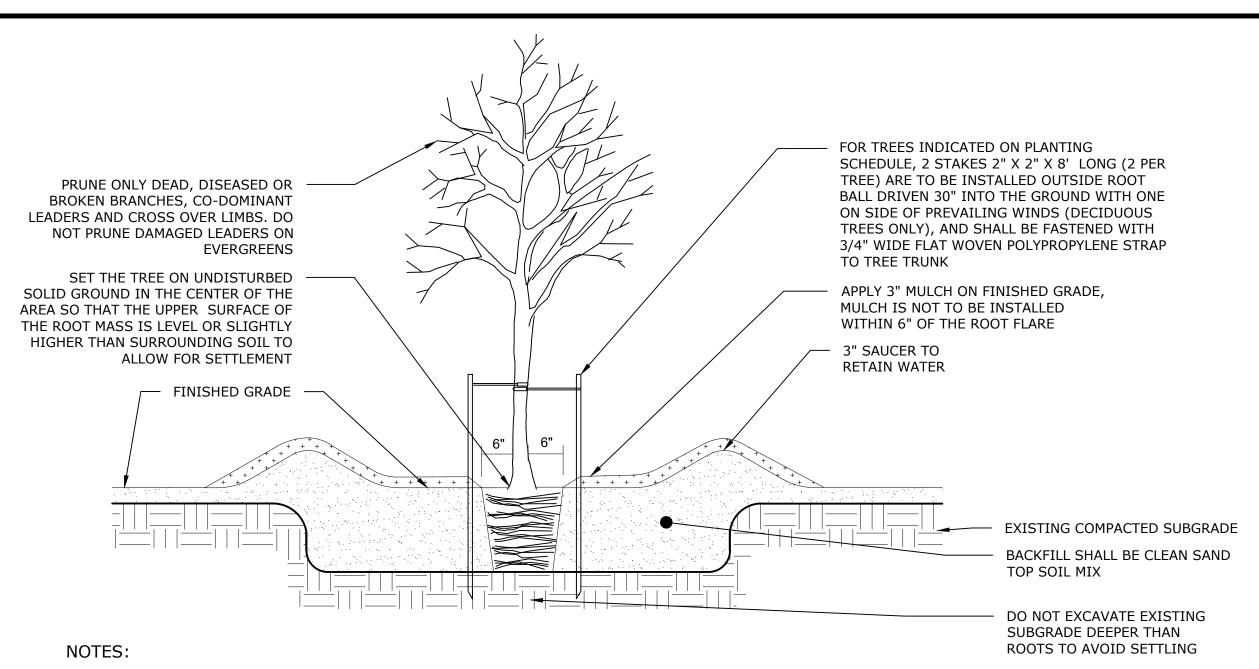

- 1. PRUNING, IF NECESSARY, SHALL BE DONE BY A CERTIFIED ARBORIST.
- 2. NOTIFY ENGINEER IF IMPERVIOUS OR UNACCEPTABLE NATIVE SOIL TO BE REMOVED IS ENCOUNTERED IN TREE PIT LOCATIONS.
- 3. ROTOTILL/CULTIVATE SOILS TO A DEPTH EQUAL TO THE DEPTH OF ROOT BALL AND TWO TIMES THE DIAMETER OF THE ROOT BALL.
- 4. APPLY FERTILIZER AND MYCORRHIZAL INOCULANT PER PLANTING SPECIFICATION. TAMP SOIL IN 6" LAYERS AROUND ROOT BALL AND WATER THOROUGHLY AFTER PLANTING. WATER THOROUGHLY AFTER EXCAVATION AND AFTER PLANT INSTALLATION.
- 5. COMPLETELY UNWRAP OR CUT GIRDLING ROOTS. DO NOT DAMAGE MAIN ROOTS OR ROOT BALL WHEN INSTALLING TREE.
- 6. FOR CONTAINER: REMOVE ROOT BALL FROM CONTAINER. LOOSEN POT- BOUND, SPIRALLY-GROWING ROOTS. FOR B&B: CUT TWINE AND REMOVE BURLAP AND WIRE BASKET.
- 7. REMOVE AND DISPOSE OF ALL NON-BIODEGRADABLES FROM PLANTING HOLES AND ROOT BALL.
- 8. REMOVE STAKES AFTER FIRST YEAR.

# TYPICAL TREE PLANTING DETAIL

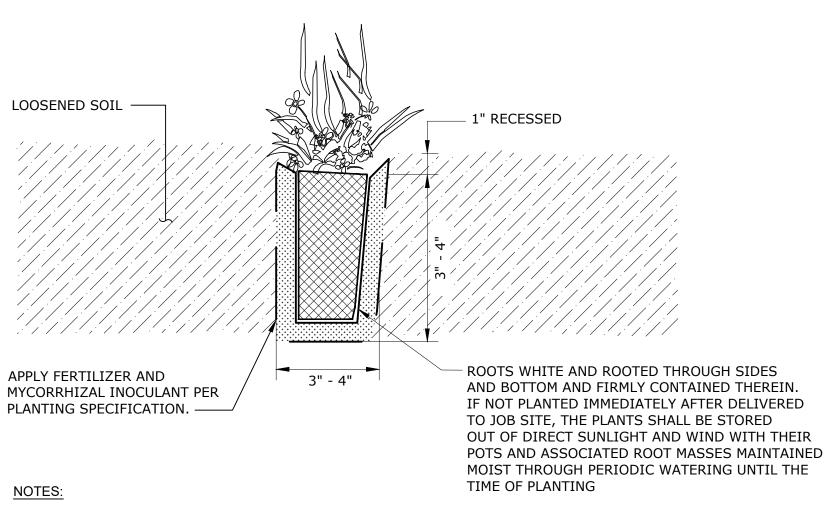

- 1. ALL PLASTIC WRAP SHALL BE REMOVED PRIOR TO PLANTING.
- 2. CAREFULLY FIRM PLUG INTO PLACE AFTER PLANTING BY LIGHTLY
- 3. INSTALL MULCH TO A DEPTH OF 3" ON TOP OF FINISHED GRADE. MULCH SHALL NOT BE WITHIN 6" OF INSTALLED PLUG.

# TYPICAL PLUG PLANTING DETAIL

**DESIGNED BY:** E. MOSKALENKO, RLA . MOSKALENKO, RLA CHECKED BY: **DESIGN LEAD:** E. BARBOE, PE K. WARD Hazen REVISIONS/DESCRIPTION APPR'D NO. DATE



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# **NEW YORK CITY ENVIRONMENTAL PROTECTION**

**BUREAU OF WATER SUPPLY** 465 COLUMBUS AVENUE, SUITE 270 VALHALLA, NEW YORK 10595-1336 www.nyc.gov/dep

WATERFOWL MANAGEMENT PROGRAM BUILDING AND PAVING MOUNT PLEASANT, NEW YORK

**BID SET** 

LANDSCAPE **DETAILS SHEET 1**  IF SHEET IS LESS THAN 22" X 34" IT IS A REDUCED PRINT. SCALE ACCORDINGLY DATE: JANUARY 2023 SCALE: SHEET NO: 28 OF No. 80

DRAWING NO.

L1-301

MASS IS LEVEL WITH THE WITHIN 6" OF THE STEM(S) SURROUNDING SOIL -FINISHED GRADE AROUND PLANT TO BE THE SAME AS ORIGINAL GRADE OF PLANT IN POT 3" SAUCER TO RETAIN WATER EXISTING COMPACTED SUBGRADE BACKFILL SHALL BE CLEAN SAND TOPSOIL MIX DO NOT EXCAVATE EXISTING

CLEAN PRUNE ONLY DAMAGED,

DISEASED AND DEAD BRANCHES

MULCH IS NOT TO BE INSTALLED

APPLY 3" MULCH ON FINISHED GRADE,

SUBGRADE DEEPER THAN ROOTS

TO AVOID SETTLING

#### NOTES:

SET THE PLANT MATERIAL ON

UNDISTURBED SOLID GROUND IN

THE CENTER OF THE AREA SO THAT

THE UPPER SURFACE OF THE ROOT


- 1. PRUNING, IF NECESSARY, SHALL BE DONE BY A CERTIFIED ARBORIST.
- 2. ROTOTILL/CULTIVATE SOILS TO A DEPTH EQUAL TO THE DEPTH OF ROOT BALL AND TWO TIMES THE DIAMETER OF THE ROOT BALL.
- 3. APPLY FERTILIZER AND MYCORRHIZAL INOCULANT PER PLANTING SPECIFICATION. TAMP SOIL IN 6" LAYERS AROUND ROOT BALL AND WATER THOROUGHLY AFTER PLANTING. WATER THOROUGHLY AFTER EXCAVATION AND AFTER PLANT INSTALLATION.
- 4. CONTAINER: REMOVE ROOT BALL FROM CONTAINER. LOOSEN POT- BOUND, SPIRALLY-GROWING AND GIRDLING ROOTS. B&B: CAREFULLY REMOVE TOP 1/3 OF BURLAP. CUT SEVERAL SLITS IN BURLAP TO FACILITATE ROOT PENETRATION
- 5. REMOVE AND DISPOSE OF ALL NON-BIODEGRADABLES FROM PLANTING HOLES AND ROOT

TYPICAL HERBACEOUS/GRASS/SHRUB PLANTING DETAIL

			PLANTING SC	HEDULE				
NO.	SYMBOL	BOTANICAL NAME	COMMON NAME	SIZE	FORM	SPACING	REMARKS	
		Herbaceous Plants						
122	AT	Amsonia taberaemontana	blue star	#1	cont	2.5' O.C.		
197	EP	Echinacea purpurea purple coneflower			plug	1.0' O.C.		
94 SN <i>S</i>		Symphyotrichum novi-belgii 'Raydon's Favorite'	Raydon's Favorite New York aster	#1	cont	2.0' O.C.		
		Grasses						
191	SH	Sporobolus heterolepsis 'Tara'	Tara prairie dropseed	#1	cont	1.5' O.C.		
213	SS	Schizachyrium scoparium 'Standing Ovation'	Standing Ovation little bluestem	#1	cont	1.5' O.C.		
		Shrubs						
87	VD	Viburnum dentatum 'Little Joe'	Little Joe arrowwood	#5	cont	3.5' O.C.		
		Canopy Trees						
5	AS	Liquidambar styraciflua	American sweetgum	2.5-3" cal	B&B	As shown		
5	QM	Quercus montana	chestnut oak	2.5-3" cal	в&в	As shown		

NO MOW LAWN SEED MIX				
BOTANICAL NAME	COMMON NAME	PERCENTAGE		
Festuca rubra	creeping red descue var. rubra	40		
Festuca brevipila var. Beacon	hard fescue var. Beacon	15		
Festuca brevipila var. Harpoon	hard fescue var. Harpoon	15		
Festuca ovina	sheep fescue	10		
Festuca rubra subsp. Fallax	chewings fescue	10		
Festuca rubra	red fescue	10		

Seed mix to be applied at a rate of 220 lbs/acre = 1.5 lbs of PLS.

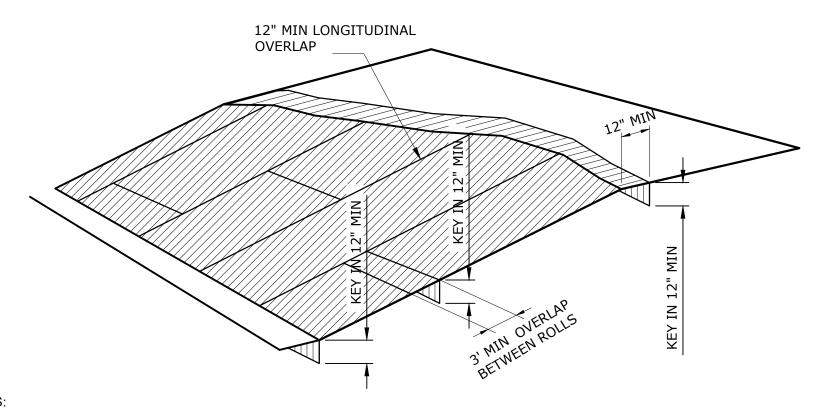

- 1. EROSION CONTROL MATTING BE INSTALLED AS SHOWN ON PLANS FOR ALL SEEDED AREAS AND FOR SLOPES 3:1 AND GREATER.
- 2. BEGIN AT TOP OF SLOPE AND/OR UPSTREAM AND ANCHOR FIBER MATTING IN A 12 INCH DEEP INITIAL ANCHOR TRENCH. BACKFILL TRENCH AND TAMP EARTH FIRMLY.
- 3. UNROLL FIBER MATTING DOWNSLOPE IN THE DIRECTION OF WATER FLOW.
- 4. OVERLAP EDGES OF ADJACENT PARALLEL ROLLS A MINIMUM 12 INCHES AND ANCHOR AT 12 INCHES O.C.
- 5. WHEN MATTING MUST BE SPLICED, PLACE END OVER END (SHINGLE STYLE) WITH 12 INCH OVERLAP AND ANCHOR USING TWO STAGGERED ROWS OF STAKES AT 6 INCHES O.C.
- 6. LAY MATTING LOOSELY AND ANCHOR SUFFICIENTLY TO MAINTAIN DIRECT CONTACT WITH THE SOIL. DO NOT STRETCH. 7. FOR SLOPES 2:1 AND STEEPER, USE A MINIMUM 3 STAKES PER SQUARE YARD AND FOR SLOPES FLATTER THAN 2:1, USE A
- MINIMUM OF 2 STAKES PER SQUARE YARD. 8. ANCHOR, FILL, AND COMPACT END OF MATTING IN A 12X6 INCH TERMINAL ANCHOR TRENCH (MIRROR IMAGE OF EXISTING

EROSION CONTROL MATTING DETAIL

NTS

				DESIGNED BY:	DRAWN BY:	
				E. MOSKALENKO, RLA	E. MOSKALENKO, RLA	
				CHECKED BY:	DESIGN LEAD:	l /.
				K. WARD	E. BARBOE, PE	\\\\\\\\\\\\\\\\\\\\\\\\\\\\\\\\\\\\\\
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NO.	DATE	REVISIONS/DESCRIPTION	APPR'D			



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# **NEW YORK CITY** ENVIRONMENTAL PROTECTION

BUREAU OF WATER SUPPLY 465 COLUMBUS AVENUE, SUITE 270 VALHALLA, NEW YORK 10595-1336 www.nyc.gov/dep

WATERFOWL MANAGEMENT PROGRAM BUILDING AND PAVING MOUNT PLEASANT, NEW YORK

**BID SET** 

LANDSCAPE DETAILS SHEET 2 SCALE ACCORDINGLY DATE: JANUARY 2023 SCALE: SHEET NO: 29 OF No. 80 DRAWING NO. L1-302

IF SHEET IS LESS THAN 22" X 34" IT IS A REDUCED PRINT.

#### GENERAL STRUCTURAL NOTES

- G-1 THESE NOTES ARE GENERAL AND SUPPLEMENT THE SPECIFICATIONS. THESE NOTES APPLY TO THE ENTIRE PROJECT UNLESS MODIFIED OR NOTED OTHERWISE IN THE CONTRACT DOCUMENTS.
- G-2 STANDARD DETAILS SHALL BE USED WHEN REFERRED TO OR WHEN NO MORE RESTRICTIVE OR DIFFERENT DETAILS ARE SHOWN ON THE
- G-3 DESIGN IS IN ACCORDANCE WITH AND CONSTRUCTION SHALL COMPLY WITH THE PROVISIONS OF THE NEW YORK STATE UNIFORM FIRE PREVENTION AND BUILDING CODE. THE DESIGN LOADS AND OTHER DESIGN VALUES GIVEN IN NOTES G-4 THROUGH G-7 WERE USED FOR DESIGN OF STRUCTURES UNLESS NOTED OTHERWISE ON THE DRAWINGS
- G-4 LIVE LOADS:

STRUCTURE	ROOF	BOTTOM / GROUND FLOOR
WATERFOWL BUILDING	20 PSF	150 PSF/H20

-ALL STAIRWAYS, LANDINGS AND PLATFORMS ARE DESIGNED FOR A LIVE LOAD = 100 PSF UNLESS NOTED OTHERWISE.

#### G-5 SNOW LOAD:

GROUND SNOW LOAD (Pg) = 30 PSF FLAT-ROOF SNOW LOAD (Pf) = 18.5 PSF SNOW EXPOSURE FACTOR (Ce) = 0.8 SNOW LOAD IMPORTANCE FACTOR (Is) = 1.0 THERMAL FACTOR (Ct) = 1.0 ADDITIONAL LOAD DUE TO DRIFTS AND SLIDING

#### G-6 WIND DESIGN CRITERIA:

ULTIMATE DESIGN WIND SPEED (Vult) = 115 MPH RISK CATEGORY = II WIND EXPOSURE = D

PARAMETER STRUCTURE	PRESSURE COEFFICIEN T GCpi	WIND DESIGN PRESSURE	COMPONENTS AND CLADDING	LATERAL LOAD RESISTING SYSTEM
WATERFOWL BUILDING	± 0.55	40 PSF	50 PSF	STEEL MOMENT AND BRACED FRAME

#### G-7 SEISMIC LOAD:

RISK CATEGORY = II SEISMIC IMPORTANCE FACTOR (Ie) = 1.0 SITE CLASS = D MAPPED SPECTRAL RESPONSE ACCELERATIONS (Ss/S1) = 0.268/0.072

SPECTRAL RESPONSE ACCELERATIONS (SMS/SM1) = 0.425/0.172 SPECTRAL RESPONSE COEFFICIENTS (SDS/SD1) = 0.283/0.115 SEISMIC DESIGN CATEGORY = B

PARAMETER STRUCTURE	BASIC STRUCTURAL SYSTEM	DESIGN BASE SHEAR	SEISMIC RESPONSE COEFFICIENT Cs	RESPONSE MODIFICATION COEFFICIENT R	ANALYSIS PROCEDURE
WATERFOWL BUILDING	STEEL MOMENT FRAME	25 K	0.1	3	EQUIVALENT LATERAL FORCE

- G-8 ALL DIMENSIONS INDICATED FOR EXISTING STRUCTURES SHALL BE VERIFIED BY FIELD MEASUREMENT. ALL DIMENSIONS THAT ARE CONTROLLED BY OR RELATED TO EQUIPMENT SHALL BE VERIFIED BY THE CONTRACTOR WITH THE MANUFACTURER SHOP DRAWINGS PRIOR TO CONSTRUCTION.
- G-9 THE CONTRACTOR IS RESPONSIBLE FOR VERIFYING ALL EXISTING INFORMATION IN THE FIELD AS REQUIRED FOR NEW WORK.
- G-10 IF A CONFLICT IS FOUND BETWEEN DIFFERENT PORTIONS OF THE CONTRACT DOCUMENTS. THE CONTRACTOR SHALL NOTIFY THE ENGINEER IMMEDIATELY. CONTINUED CONSTRUCTION OF THE AREA IN CONFLICT SHALL BE AT THE CONTRACTOR'S OWN RISK UNTIL THE CONFLICT IS RESOLVED.
- G-11 EQUIPMENT ANCHOR BOLT SIZES, TYPES, EMBEDMENT AND PATTERNS SHALL BE VERIFIED WITH THE MANUFACTURER. ALL BOLT PATTERNS SHALL BE TEMPLATED TO ENSURE ACCURACY OF PLACEMENT.
- G-12 STRUCTURAL DRAWINGS SHALL BE USED IN COORDINATION WITH THE DRAWINGS OF ALL OTHER DISCIPLINES AND MANUFACTURER'S SHOP DRAWINGS.
- G-13 STRUCTURES HAVE BEEN DESIGNED FOR OPERATIONAL LOADS ON THE COMPLETED STRUCTURE. DURING CONSTRUCTION, THE STRUCTURES SHALL BE PROTECTED BY BRACING AND TEMPORARY SUPPORTS WHEREVER EXCESSIVE CONSTRUCTION LOADS MAY OCCUR. OVERSTRESSING OF ANY STRUCTURAL ELEMENT IS PROHIBITED.
- G-14 IF CONTRACTOR DESIRES TO TEMPORARILY PLACE OR MOVE LOADS ON OR ADJACENT TO EXISTING STRUCTURES OR UTILITIES DURING CONSTRUCTION PROCESS, CONTRACTOR IS EXCLUSIVELY RESPONSIBLE FOR MAINTAINING STRUCTURAL INTEGRITY AND AVOIDING OVERSTRESSING AND DAMAGING EXISTING STRUCTURES AND UTILITIES. CONTRACTOR SHALL SUBMIT STRUCTURAL CALCULATIONS AND DRAWINGS VERIFYING PROPOSED CONSTRUCTION INCLUDING APPLICATION OF TEMPORARY CONSTRUCTION LOADS WILL NOT OVERSTRESS OR DAMAGE EXISTING STRUCTURES AND UTILITIES. DRAWINGS AND CALCULATIONS SHALL BE SEALED BY A PROFESSIONAL ENGINEER CURRENTLY REGISTERED IN THE STATE OF NEW YORK.

#### CONCRETE (CAST-IN-PLACE)

- C-1 DESIGN OF CONCRETE ELEMENTS INCLUDING WALLS, FORMED SLABS, BEAMS, AND COLUMNS IS IN ACCORDANCE WITH ACI 318 (CODE REQUIREMENTS FOR STRUCTURAL CONCRETE).
- C-2 FOR CONCRETE MIX DESIGN SEE SPECIFICATION SECTION 03300.
- C-3 CONCRETE STRENGTH CLASSES (28-DAY COMPRESSIVE STRENGTH):
  - A. CLASS 25 USE FOR LEAN CONCRETE.
  - B. CLASS B-32 USE NYCDOT SPECIFICATION SIDEWALKS, HEADERS AND CURB.
- C. CLASS 45 USE FOR ALL CONCRETE UNLESS INDICATED OTHERWISE
- C-4 ALL BAR REINFORCING SHALL CONFORM TO ASTM A615, GRADE 60. WHERE REINFORCEMENT IS TO BE WELDED IN ACCORDANCE WITH AWS D1.4, ASTM A706 GRADE 60 SHALL BE USED. WELDED WIRE FABRIC SHALL CONFORM TO ASTM A185.
- C-5 CONCRETE COVER FOR REINFORCING (UNLESS NOTED OTHERWISE ON THE DRAWINGS):

A.	CONCRETE DEPOSITED DIRECTLY AGAINST SOIL:	3"
B.	CONCRETE EXPOSED TO WEATHER (#5 OR SMALLER):	1 1/2"
	CONCRETE EXPOSED TO WEATHER (#6 OR LARGER):	2"
C.	SLABS:	1 1/2"
	AT SURFACES CONTACTING FLUID:	2"
D.	BEAMS AND COLUMNS (TO MAIN REINFORCEMENT):	2"
	BEAMS AND COLUMNS (TO COLUMN TIES OR STIRRUPS):	1 1/2"
E.	WALLS 12" OR MORE:	2"
	WALLS LESS THAN 12" (#5 OR SMALLER):	1 1/2"
	WALLS LESS THAN 12" (#6 OR LARGER):	2"
F.	FOR SURFACES EXPOSED TO FLUID IN BEAMS, COLUMNS AND WALLS:	ADD 1/2" TO ABOVE VALUES

- C-6 SPLICES SHALL BE CLASS "B" CONFORMING TO THE PROVISIONS OF ACI 318 UNLESS NOTED OTHERWISE. SPLICE LENGTH FOR TWO DIFFERENT SIZED BARS TO BE LAP SPLICED TOGETHER SHALL BE THE LENGTH OF THE LARGER BAR UNLESS NOTED
- C-7 CONSTRUCTION JOINTS SHALL BE LOCATED AS SHOWN ON THE DRAWINGS. CONSTRUCTION JOINTS NOT SHOWN SHALL BE SUBMITTED BY THE CONTRACTOR FOR THE APPROVAL OF THE ENGINEER PRIOR TO SUBMITTING REBAR SHOP DRAWINGS. VERTICAL CONSTRUCTION JOINTS IN WALLS AND HORIZONTAL JOINTS IN SLABS SHALL BE PROVIDED AT A SPACING NOT GREATER THAN 45 FEET ON CENTER. FOR EXPOSED WALLS WITH FLUID OR EARTH ON THE OPPOSITE SIDE. THE SPACING BETWEEN VERTICAL AND HORIZONTAL JOINTS SHALL BE A MAXIMUM OF 25 FEET.
- C-8 WHERE HORIZONTAL CONSTRUCTION JOINTS, LOCATED ABOVE THE FOUNDATION SLAB, EXTEND BEYOND WHERE NEEDED, THEY SHALL BE TERMINATED AT A VERTICAL CONSTRUCTION JOINT APPROVED BY THE ENGINEER.
- C-9 ALL JOINTS WHICH ARE IN MEMBERS IN CONTACT WITH LIQUID OR BELOW GRADE SHALL HAVE A WATERSTOP. CONSTRUCTION JOINTS SHALL HAVE A 6" PVC RIBBED WATERSTOP. EXPANSION JOINTS SHALL HAVE A 9" PVC CENTER BULB RIBBED WATERSTOP. IN VERTICAL JOINTS, WATERSTOPS SHALL TERMINATE NO LESS THAN 18" ABOVE THE MAXIMUM WATER SURFACE OR 18" ABOVE GRADE, WHICHEVER IS HIGHER.
- C-10 ALL EXPOSED CORNERS SHALL HAVE A 3/4" CHAMFER OR A 1/2" RADIUS TOOLED CORNER.
- C-11 EQUIPMENT SUPPORTS, ANCHORAGES, OPENINGS, RECESSES AND REVEALS NOT SHOWN ON THE STRUCTURAL DRAWINGS BUT REQUIRED BY OTHER CONTRACT DOCUMENTS, SHALL BE PROVIDED FOR PRIOR TO PLACING CONCRETE.
- C-12 REINFORCING BARS AND ACCESSORIES SHALL NOT BE IN CONTACT WITH ANY METAL PIPE, PIPE FLANGE, METAL CONDUIT, OR OTHER METAL PARTS EMBEDDED IN CONCRETE. A MINIMUM CLEARANCE OF 2" SHALL BE PROVIDED.
- C-13 DOWELS, ANCHOR BOLTS, PIPES, WATERSTOPS AND OTHER EMBEDDED ITEMS SHALL BE HELD SECURELY IN POSITION WHILE CONCRETE IS BEING PLACED.
- C-14 CONDUITS AND OTHER SIMILAR ITEMS EMBEDDED IN OR PENETRATING THROUGH CONCRETE SHALL BE SPACED ON CENTER NOT LESS THAN 3 TIMES THEIR OUTSIDE DIMENSION, BUT NOT LESS THAN 2 1/2" CLEAR. WHEN SUCH ITEMS ARE EMBEDDED IN WALLS OR SLABS, THEY SHALL NOT OCCUPY MORE THAN 1/3 OF THE MEMBER THICKNESS.
- C-15 AT ALL TYPICAL CURBS, EQUIPMENT PADS, AND PIPE SUPPORT PIERS, REINFORCING DOWELS SHOWN MAY BE REPLACED WITH MATCHING DOWELS SET IN EPOXY IN DRILLED HOLES AS SPECIFIED. DOWELS LOCATED CLOSER THAN 3" FROM ANY EDGE OF CONCRETE SHALL NOT BE REPLACED WITH DRILLED DOWELS.
- C-16 DRILLED ADHESIVE DOWELS (WHERE DOWELS ARE SHOWN TO BE PLACED INTO HARDENED CONCRETE):
  - A. THE HOLE DIAMETER SHALL BE NO LARGER THAN 1/8" GREATER THAN THE DIAMETER OF THE REINFORCING BAR AT THE DEFORMATIONS.
- B. THE DEPTH OF EMBEDMENT SHALL BE 12 BAR DIAMETERS. UNLESS NOTED OTHERWISE. C. ADJUST THE DOWEL LOCATIONS AS NEEDED TO AVOID DRILLING THROUGH ANY REINFORCING BARS. IF THE LOCATION NEEDS TO BE MODIFIED, CONTACT THE ENGINEER. CONTRACTOR SHALL USE NON-DESTRUCTIVE MEANS TO FIELD LOCATE
- C-17 CLEAR DISTANCE FROM ANCHOR BOLTS TO ANY CONCRETE EDGE SHALL BE 4" MINIMUM UNLESS NOTED OTHERWISE.
- C-18 CONCRETE COMPRESSIVE STRENGTH TESTS SHALL BE AVAILABLE ON THE JOB SITE FOR REVIEW BY THE ENGINEER.
- C-19 ALL COMPONENTS INDICATED AS AESS SHALL COMPLY WITH THE INDICATED CATEGORY IN ACCORDANCE WITH AISC CODE OF STANDARD PRACTICE FOR STEEL BUILDING AND BRIDGES.

#### **FOUNDATIONS**

F-1 CONCRETE (CAST-IN-PLACE) NOTES APPLY TO FOUNDATIONS.

REINFORCEMENT PRIOR TO DRILLING HOLES FOR DOWELS.

ALLOWABLE SOIL BEARING PRESSURE

PARAMETER	ALLOWABLE SOIL
STRUCTURE	BEARING PRESSURE
WATERFOWL BUILDING	2000 PSF

F-3 MINIMUM DEPTH FROM ADJACENT FINISHED GRADE TO BOTTOM OF FOUNDATION = 48 INCHES.

#### NONSTRUCTURAL COMPONENT ANCHORAGE

- ALL ARCHITECTURAL, MECHANICAL, AND ELECTRICAL COMPONENTS SHALL BE DESIGNED AND INSTALLED TO RESIST THE CONTROLLING CONDITION OF OPERATIONAL FORCES OR SEISMIC FORCES IN ACCORDANCE WITH THE GOVERNING BUILDING CODE. SEISMIC FORCES SHALL ALSO BE AS PER ASCE 7. COMPONENT SEISMIC ATTACHMENTS SHALL BE BOLTED, WELDED, OR OTHERWISE POSITIVELY FASTENED WITHOUT CONSIDERATION OF FRICTIONAL RESISTANCE PRODUCED BY THE EFFECTS OF GRAVITY. A CONTINUOUS LOAD PATH OF SUFFICIENT STRENGTH AND STIFFNESS BETWEEN THE COMPONENT AND THE SUPPORTING STRUCTURE SHALL BE PROVIDED. CONNECTIONS FOR BOTH ORTHOGONAL DIRECTIONS (TRANSVERSE AND LONGITUDINAL) SHALL BE DESIGNED BY THE CONTRACTOR'S ENGINEER CURRENTLY REGISTERED IN THE STATE OF NEW YORK.
- COMPONENT REACTION FORCES AT THE POINT OF ATTACHMENT TO THE STRUCTURE SHALL BE SUBMITTED TO AND COORDINATED WITH THE ENGINEER FOR CONFIRMATION SUPPORTING STRUCTURE CAN WITHSTAND REACTION FORCES.
- CONTRACTOR SHALL PROVIDE SPECIAL SEISMIC CERTIFICATION (SSC) FROM MANUFACTURER OF EQUIPMENT FOR ALL SYSTEMS DEEMED NECESSARY BY SPECIFICATIONS. SPECIAL SEISMIC CERTIFICATION SHALL BE IN COMPLIANCE WITH ASCE 7.

#### STRUCTURAL METALS

- M-1 DETAIL, FABRICATE, AND ERECT STRUCTURAL STEEL IN ACCORDANCE WITH ANSI/AISC 360 SPECIFICATION FOR STRUCTURAL STEEL BUILDINGS, LATEST EDITION.
- M-2 STEEL MATERIAL A. STRUCTURAL HSS:

B. STRUCTURAL PIPE:

F. STRUCTURAL HP

G. ANCHOR RODS

C. PLATES, BARS AND ANGLES:

E. STRUCTURAL M & S SHAPES:

D. STRUCTURAL W, C, & MC SHAPES:

ASTM A500, GRADE C (46/50 KSI) OR A1085 GRADE A (50 KSI) ASTM A53, GRADE B (35 KSI)

ASTM A36 UNO (36 KSI) ASTM A992 (50 KSI)

ASTM A36 (36 KSI) ASTM A572 GRADE 50 (50 KSI) ASTM F1554 GRADE 36 (36 KSI)

- PROVIDE MINIMUM 3/4" DIAMETER ASTM F3125 GRADE A325 TYPE 1 OR GRADE F1852 TYPE 1 HIGH STRENGTH BOLTS WITH SNUG TIGHTENED TYPE N CONNECTIONS FOR STRUCTURAL STEEL UNLESS NOTED OTHERWISE. HOLES FOR BOLTS SHALL BE STANDARD SIZE UNLESS NOTED OTHERWISE.
- PROVIDE TYPICAL STEEL BEAM CONNECTIONS FOR A CAPACITY OF NOT LESS THAN THE TOTAL UNIFORM LOAD CAPACITY TABULATED IN THE AISC TABLES FOR ALLOWABLE LOADS OF BEAMS UNLESS NOTED OTHERWISE.
- M-5 DO NOT PAINT STEEL SURFACES WHICH ARE TO BE WELDED OR ARE TO BE ENCASED IN CONCRETE.
- M-6 ALL GROOVE AND BUTT WELDS SHALL BE FULL PENETRATION.
- M-7 FILLET WELD SIZES SHALL NOT BE LESS THAN THE MINIMUM SIZE REQUIRED BY AISC CODE FOR PLATE SIZES TO BE CONNECTED AND SHALL BE APPLIED TO THE ENTIRE JOINT CONTACT LENGTH, AND NOT LESS THAN 3/16".
- ALL WELDS SHALL BE PERFORMED IN THE SHOP UNLESS NOTED BY A FIELD WELD SYMBOL OR APPROVED BY THE ENGINEER.
- BOTTOM SURFACES OF BASE PLATES SHALL BE GROUTED TO ENSURE FULL BEARING CONTACT WITH CONCRETE SLAB.
- M-10 WHENEVER ONE MEMBER IS FASTENED TO ANOTHER WITH FASTENINGS (BOLTS, WELDS, ETC.) SET AT A UNIFORM SPACING, THERE SHALL BE A MINIMUM OF TWO FASTENINGS PER PIECE CONNECTED AND THE FIRST AND LAST FASTENINGS SHALL BE LOCATED NOT TO EXCEED 0.25 OF FASTENER SPACING FROM EACH END.
- M-11 GRATING PANELS SHALL BE CONFINED TO PREVENT MOVEMENT PER STANDARD DETAIL 0553004. SOLE USE OF GRATING CLIP ATTACHMENT IS NOT ACCEPTABLE TO PREVENT GRATING MOVEMENT.

ABBREVIATIONS					
ADDL	ADDITIONAL	GALV	GALVANIZED	R	RADIUS/ RISER
ADH	ADHESIVE	GR	GRADE	REF	REFERENCE
AL ARCH	ALUMINUM ARCHITECTURAL	- 11	LIFICLIT	REINF REQD	REINFORCING REQUIRED
AESS	ARCHITECTURAL  ARCHITECTURALLY EXPOSED	H HORZ	HEIGHT HORIZONTAL	REQU	REQUIRED
ALGG	STRUCTURAL STEEL	HPT	HIGH POINT	S	SOUTH
	OTTOO TOTAL OTELL	HSS	HOLLOW STRUCTURAL SECTION	SECT	SECTION
BLDG	BUILDING	1100	HOLLOW OTHOUTON'S CEOTION	SHT	SHEET
BOT	BOTTOM	IN	INCH	SQ	SQUARE
	20110			SST	STAINLESS STEEL
CL	CENTER LINE/CHLORINE	JT	JOINT	STIR	STIRRUP
CLR	CLEAR			STL	STEEL
CMU	CONCRETE MASONRY UNIT	L	ANGLE	STR	STRUCTURAL
COL	COLUMN	LB	POUND		
CONC	CONCRETE	LF	LINEAR FEET	Т	TREAD
CONST	CONSTRUCTION	LG	LONG	T&B	TOP AND BOTTOM
CONT	CONTINUOUS	LL	LIVE LOAD	THK	THICKNESS
l DET	DETAIL	LLH	LONG LEG HORIZONTAL	TOC	TOP OF CONCRETE
DET	DETAIL	LLV LPT	LONG LEG VERTICAL	TOG TOS	TOP OF GRATING TOP OF STEEL
DIA (Ø) DIM	DIAMETER DIMENSION	LPI	LOW POINT	TOW	TOP OF STEEL TOP OF WALL
DIW	DEAD LOAD	MAX	MAXIMUM	TYP	TYPICAL
DWG	DRAWING	MIN	MINIMUM	111	TITIOAL
DWL	DOWEL	MISC	MISCELLANEOUS	UNO	UNLESS NOTED OTHERWISE
EA	EACH	N	NORTH	VERT	VERTICAL
EF EL	EACH FACE	NA NTS	NOT APPLICABLE	W	MECT/MIDTH
ENGR	ELEVATION ENGINEER	NIS NS	NOT TO SCALE NEAR SIDE	W/	WEST/ WIDTH WITH
EQ	EQUAL	NS	NEAR SIDE	WF	WITH WIDE FLANGE
EQPT	EQUIPMENT	ОС	ON CENTER	WT	WEIGHT
EW	EACH WAY	OPNG	OPENING	WP	WORK POINT
EX	EXISTING	OPP	OPPOSITE	***	Worker Shirt
EXP	EXPANSION	<b>.</b> .	S S S		
EXT	EXTERIOR	PL PSF	PROPERTY LINE/ PLATE POUNDS PER SQUARE FOOT		
FD	FLOOR DRAIN				
FDN	FOUNDATION				
FT	FEET				
FTG	FOOTING/ FITTING				
FS	FAR SIDE				

**BID SET** 

GRAPHIC SCALES CHECK BEFORE USE

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WATERFOWL MANAGEMENT PROGRAM BUILDING AND PAVING MOUNT PLEASANT, NEW YORK

DATE: JANUARY 2023 SCALE: NONE SHEET NO: 30 OF No. 80 DRAWING NO. S0-001

Hazen NO. DATE REVISIONS/DESCRIPTION APPR'D

**Environmental Protection** 

ACCOUNTABLE MANAGER OSE NIEVES PORTFOLIO MANAGER MARK DELBALZO, P.E.

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GENERAL STRUCTURAL NOTES

DESIGNED BY

CHECKED BY:

C. PHILLIPS


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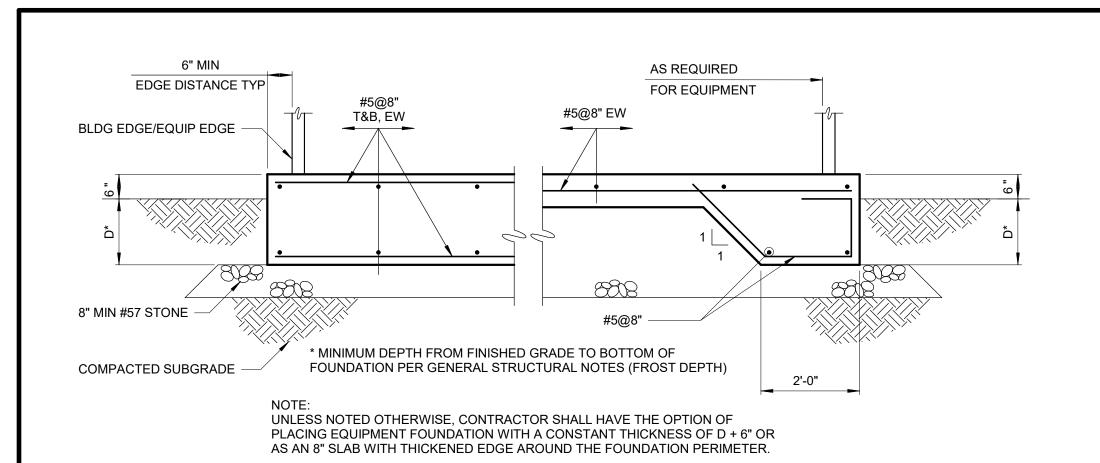
**PRAWN BY:** 

R. KANDILAH

DESIGN LEAD:

EDWARD BARBOE, P.E.




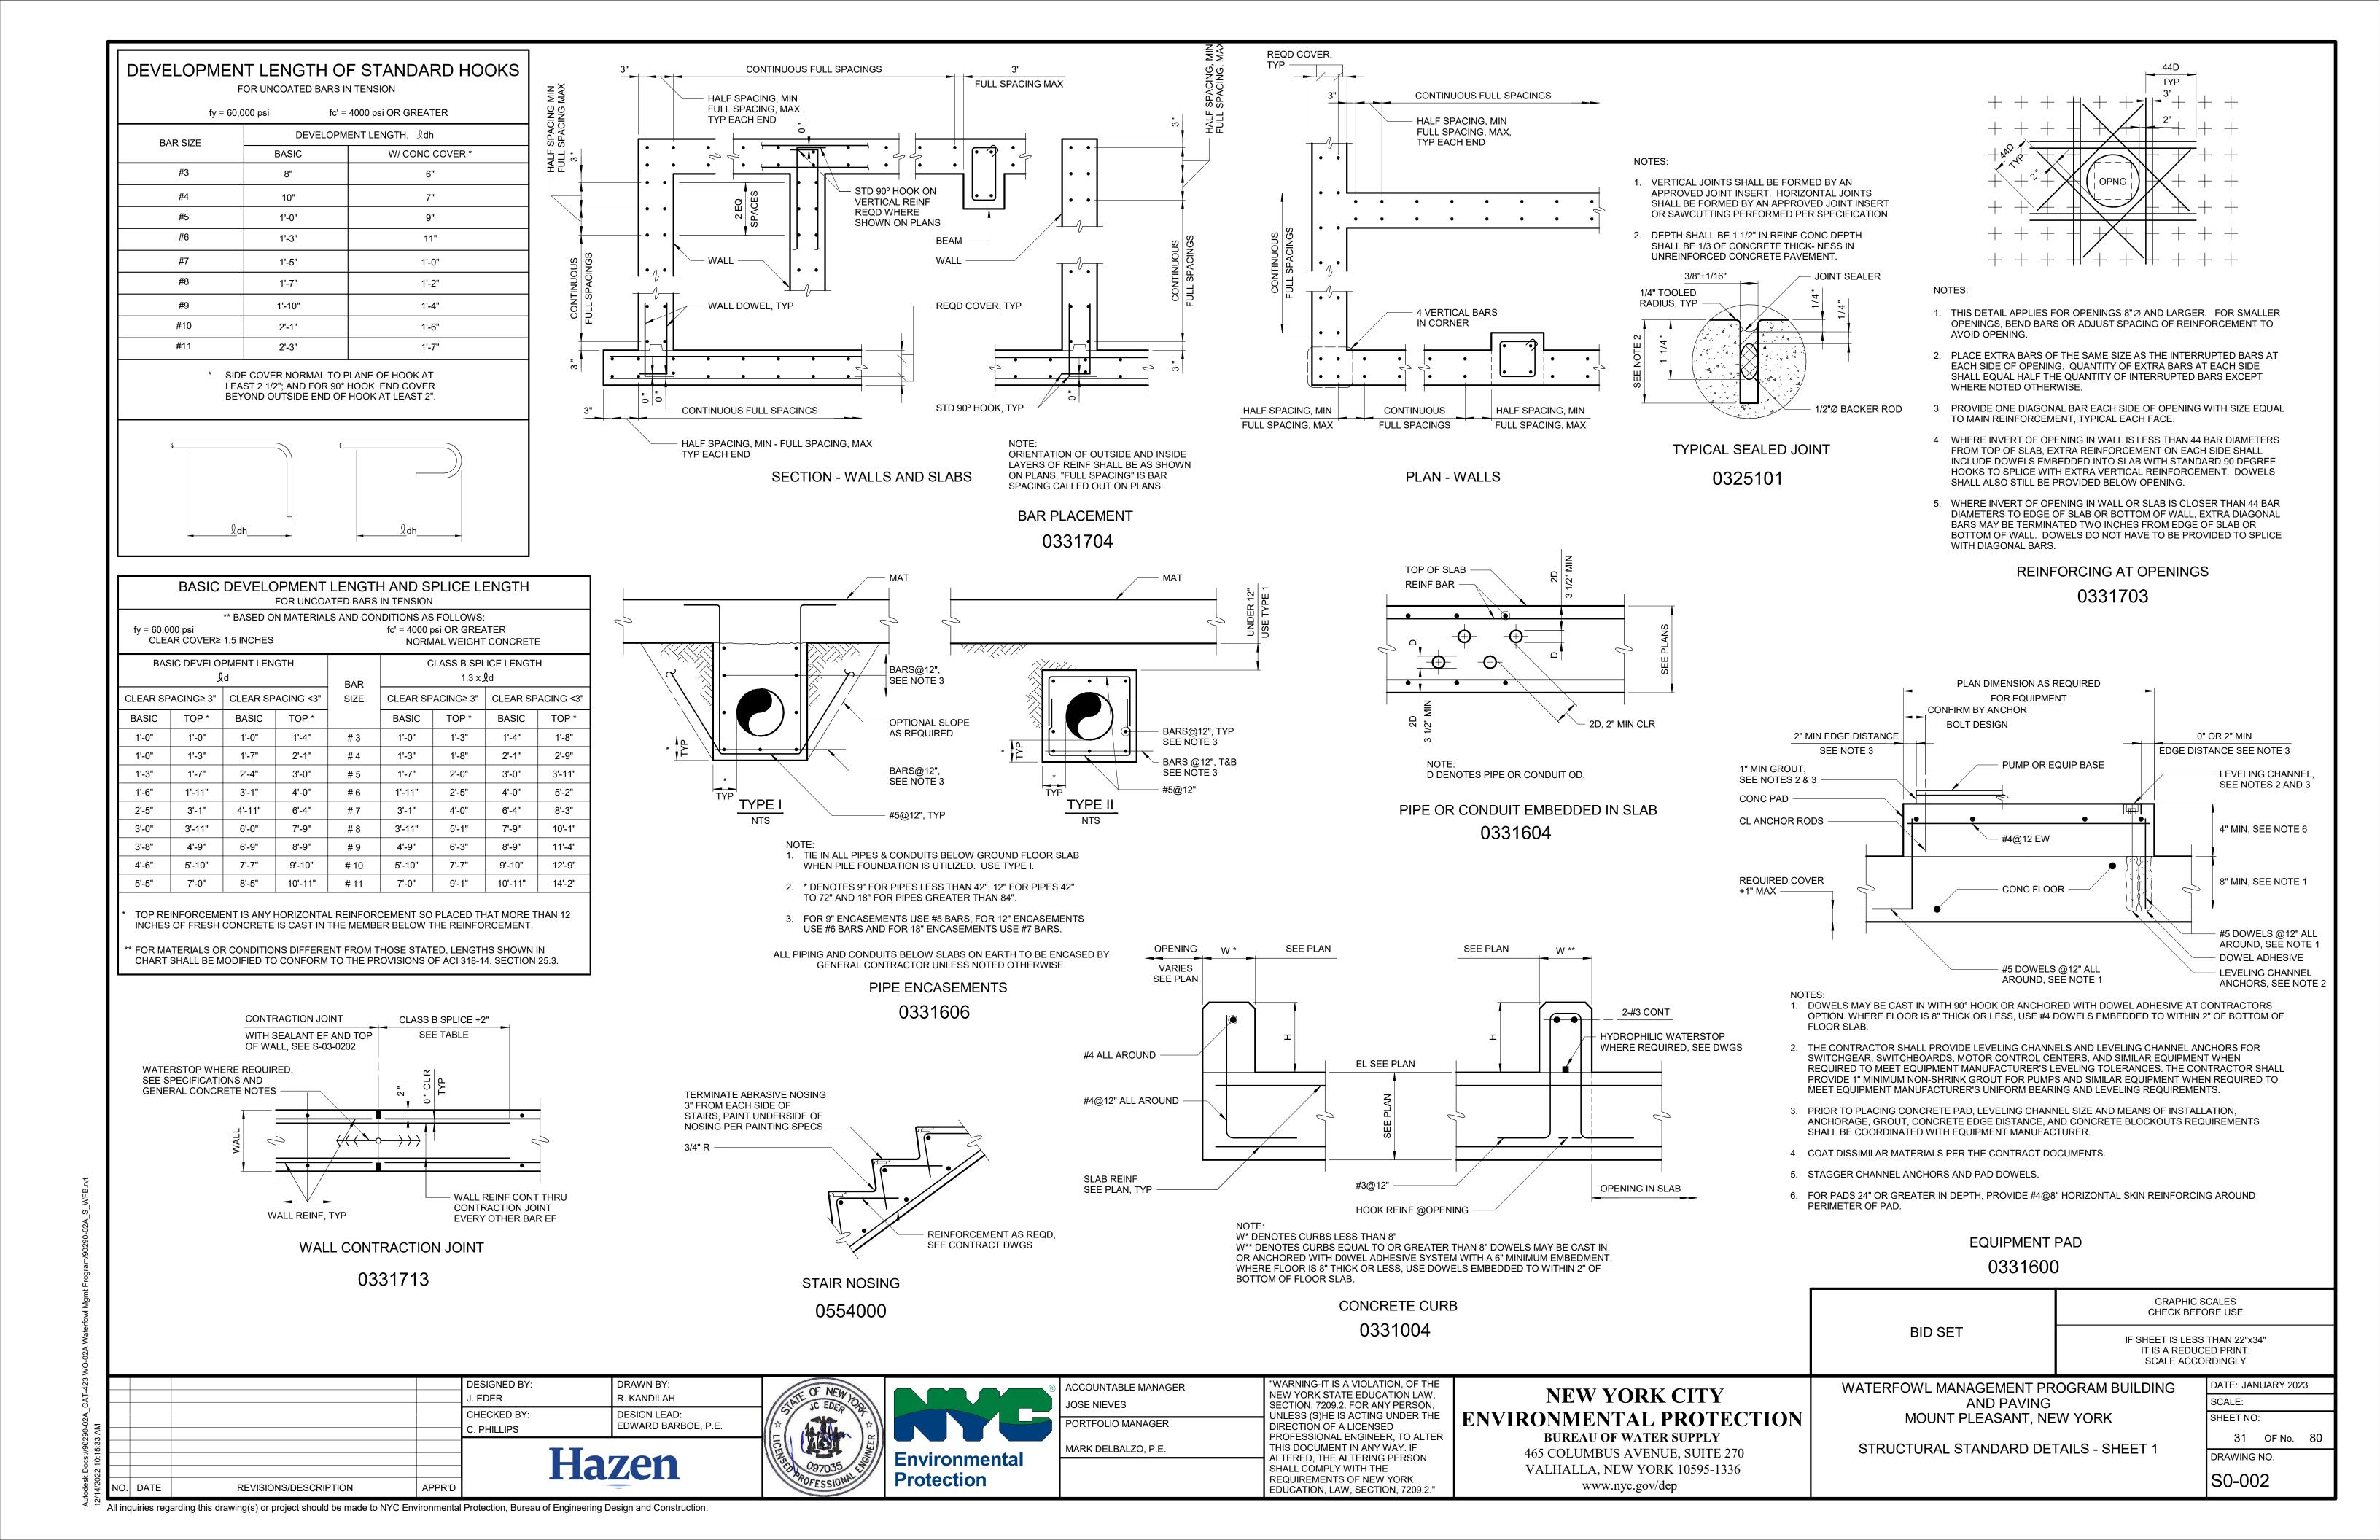

EXTERIOR EQUIPMENT FOUNDATION 0331607


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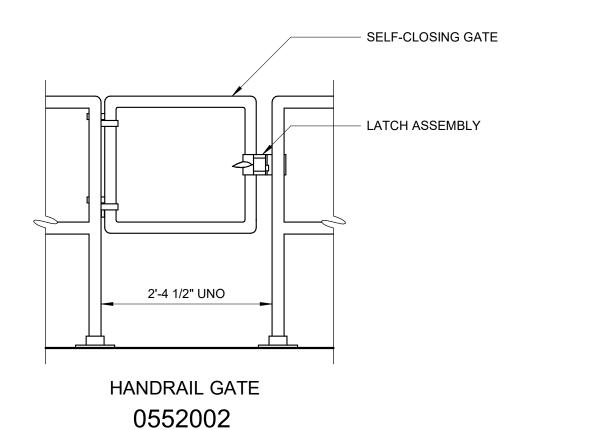
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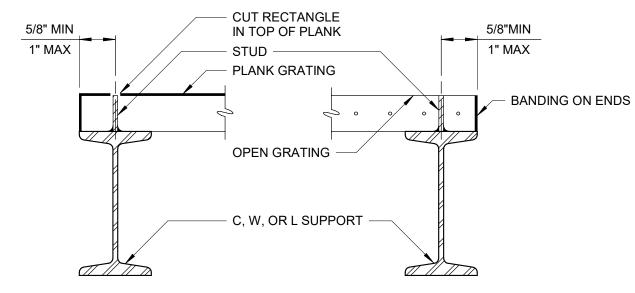



**ALUMINUM GRATING** 

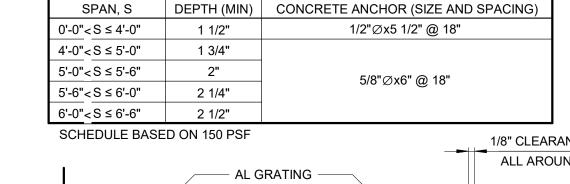0553000





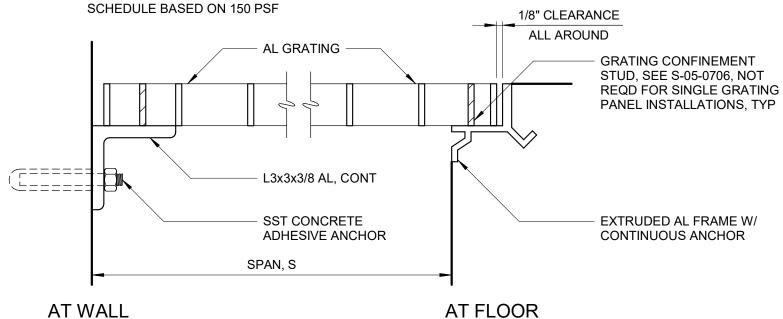

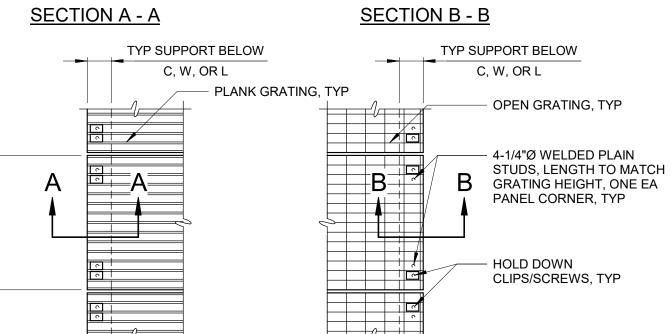

PLAN - PLANK GRATING

**PLAN - OPEN GRATING** 

NOTES: 1. STUDS SHALL BE:

METAL GRATING - 1/4" Ø WELDED PLAIN STUD OF SAME MATERIAL AS SUPPORT, WITH STUDS WELDED PER AWS REQUIREMENTS.

RP GRATING - #14 SST TEK SCREWS, SELF-DRILLED INTO THE BASE MATERIAL.


2. INSTALLED STUD SHALL MATCH GRATING HEIGHT.

3. STUD SHALL BE PLACED BETWEEN CROSS BAR(S) AND/OR BEARING BARS.


, ,

GRATING CONFINEMENT USING STUDS

0553004

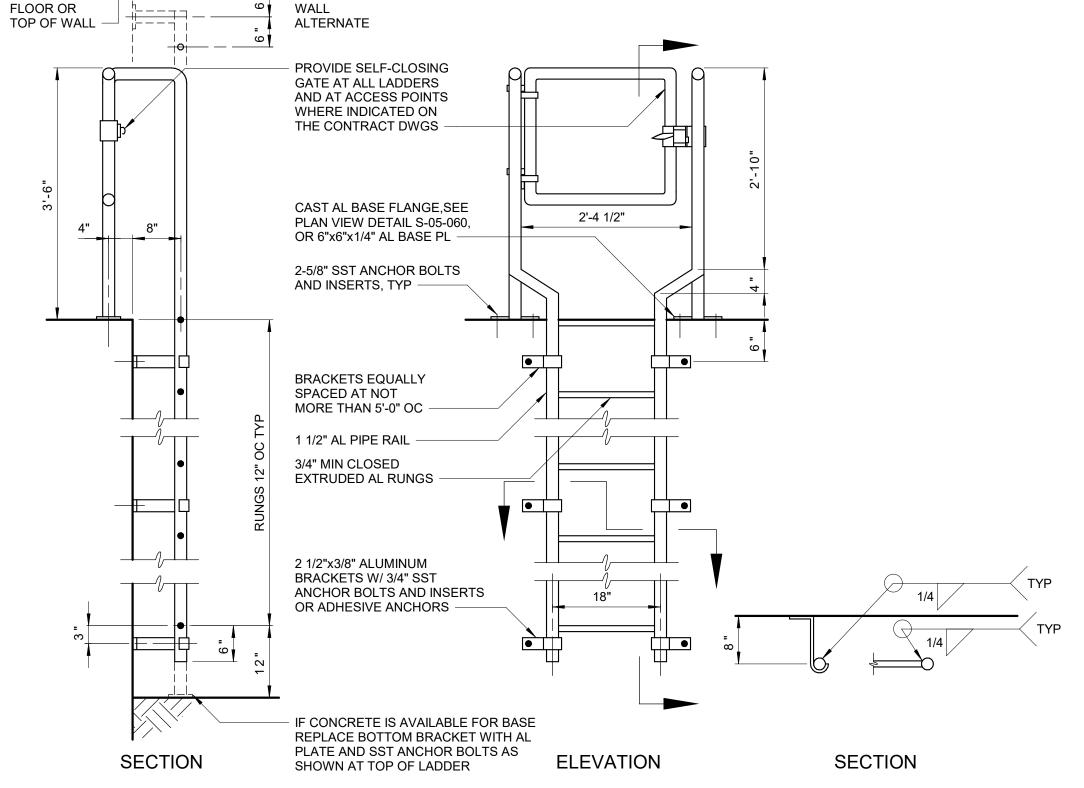

ALUMINUM LADDER 0551500

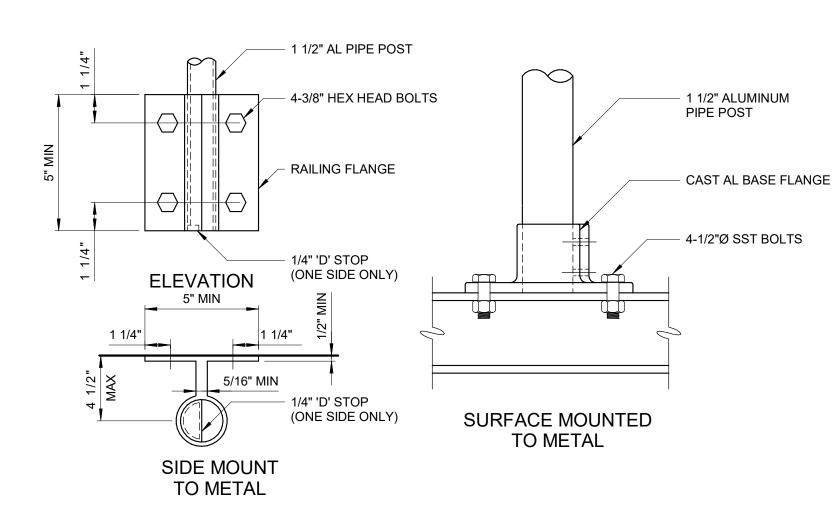

6'-0" MAX

1 1/2" AL
PIPE RAILING

TOEBOARD, TYPICAL
ALL HANDRAILS

WALKING SURFACE

ALUMINUM HANDRAILS

0552000

BID SET

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DATE: JANUARY 2023

DESIGNED BY:
J. EDER

CHECKED BY:
C. PHILLIPS

CHARAGE

CHARACTER

CHECKED BY:
C. PHILLIPS

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R	ACCOUNTABLE MANAGER	"WARNI NEW YO
	JOSE NIEVES	SECTIO
	PORTFOLIO MANAGER	DIRECT
4-1	MARK DELBALZO, P.E.	THIS DO
tal		SHALL

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# NEW YORK CITY ENVIRONMENTAL PROTECTION

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www.nyc.gov/dep

WATERFOWL MANAGEMENT PROGRAM BUILDING AND PAVING MOUNT PLEASANT, NEW YORK

MOUNT PLEASANT, NEW YORK

STRUCTURAL STANDARD DETAILS - SHEET 2

DRAWING NO.


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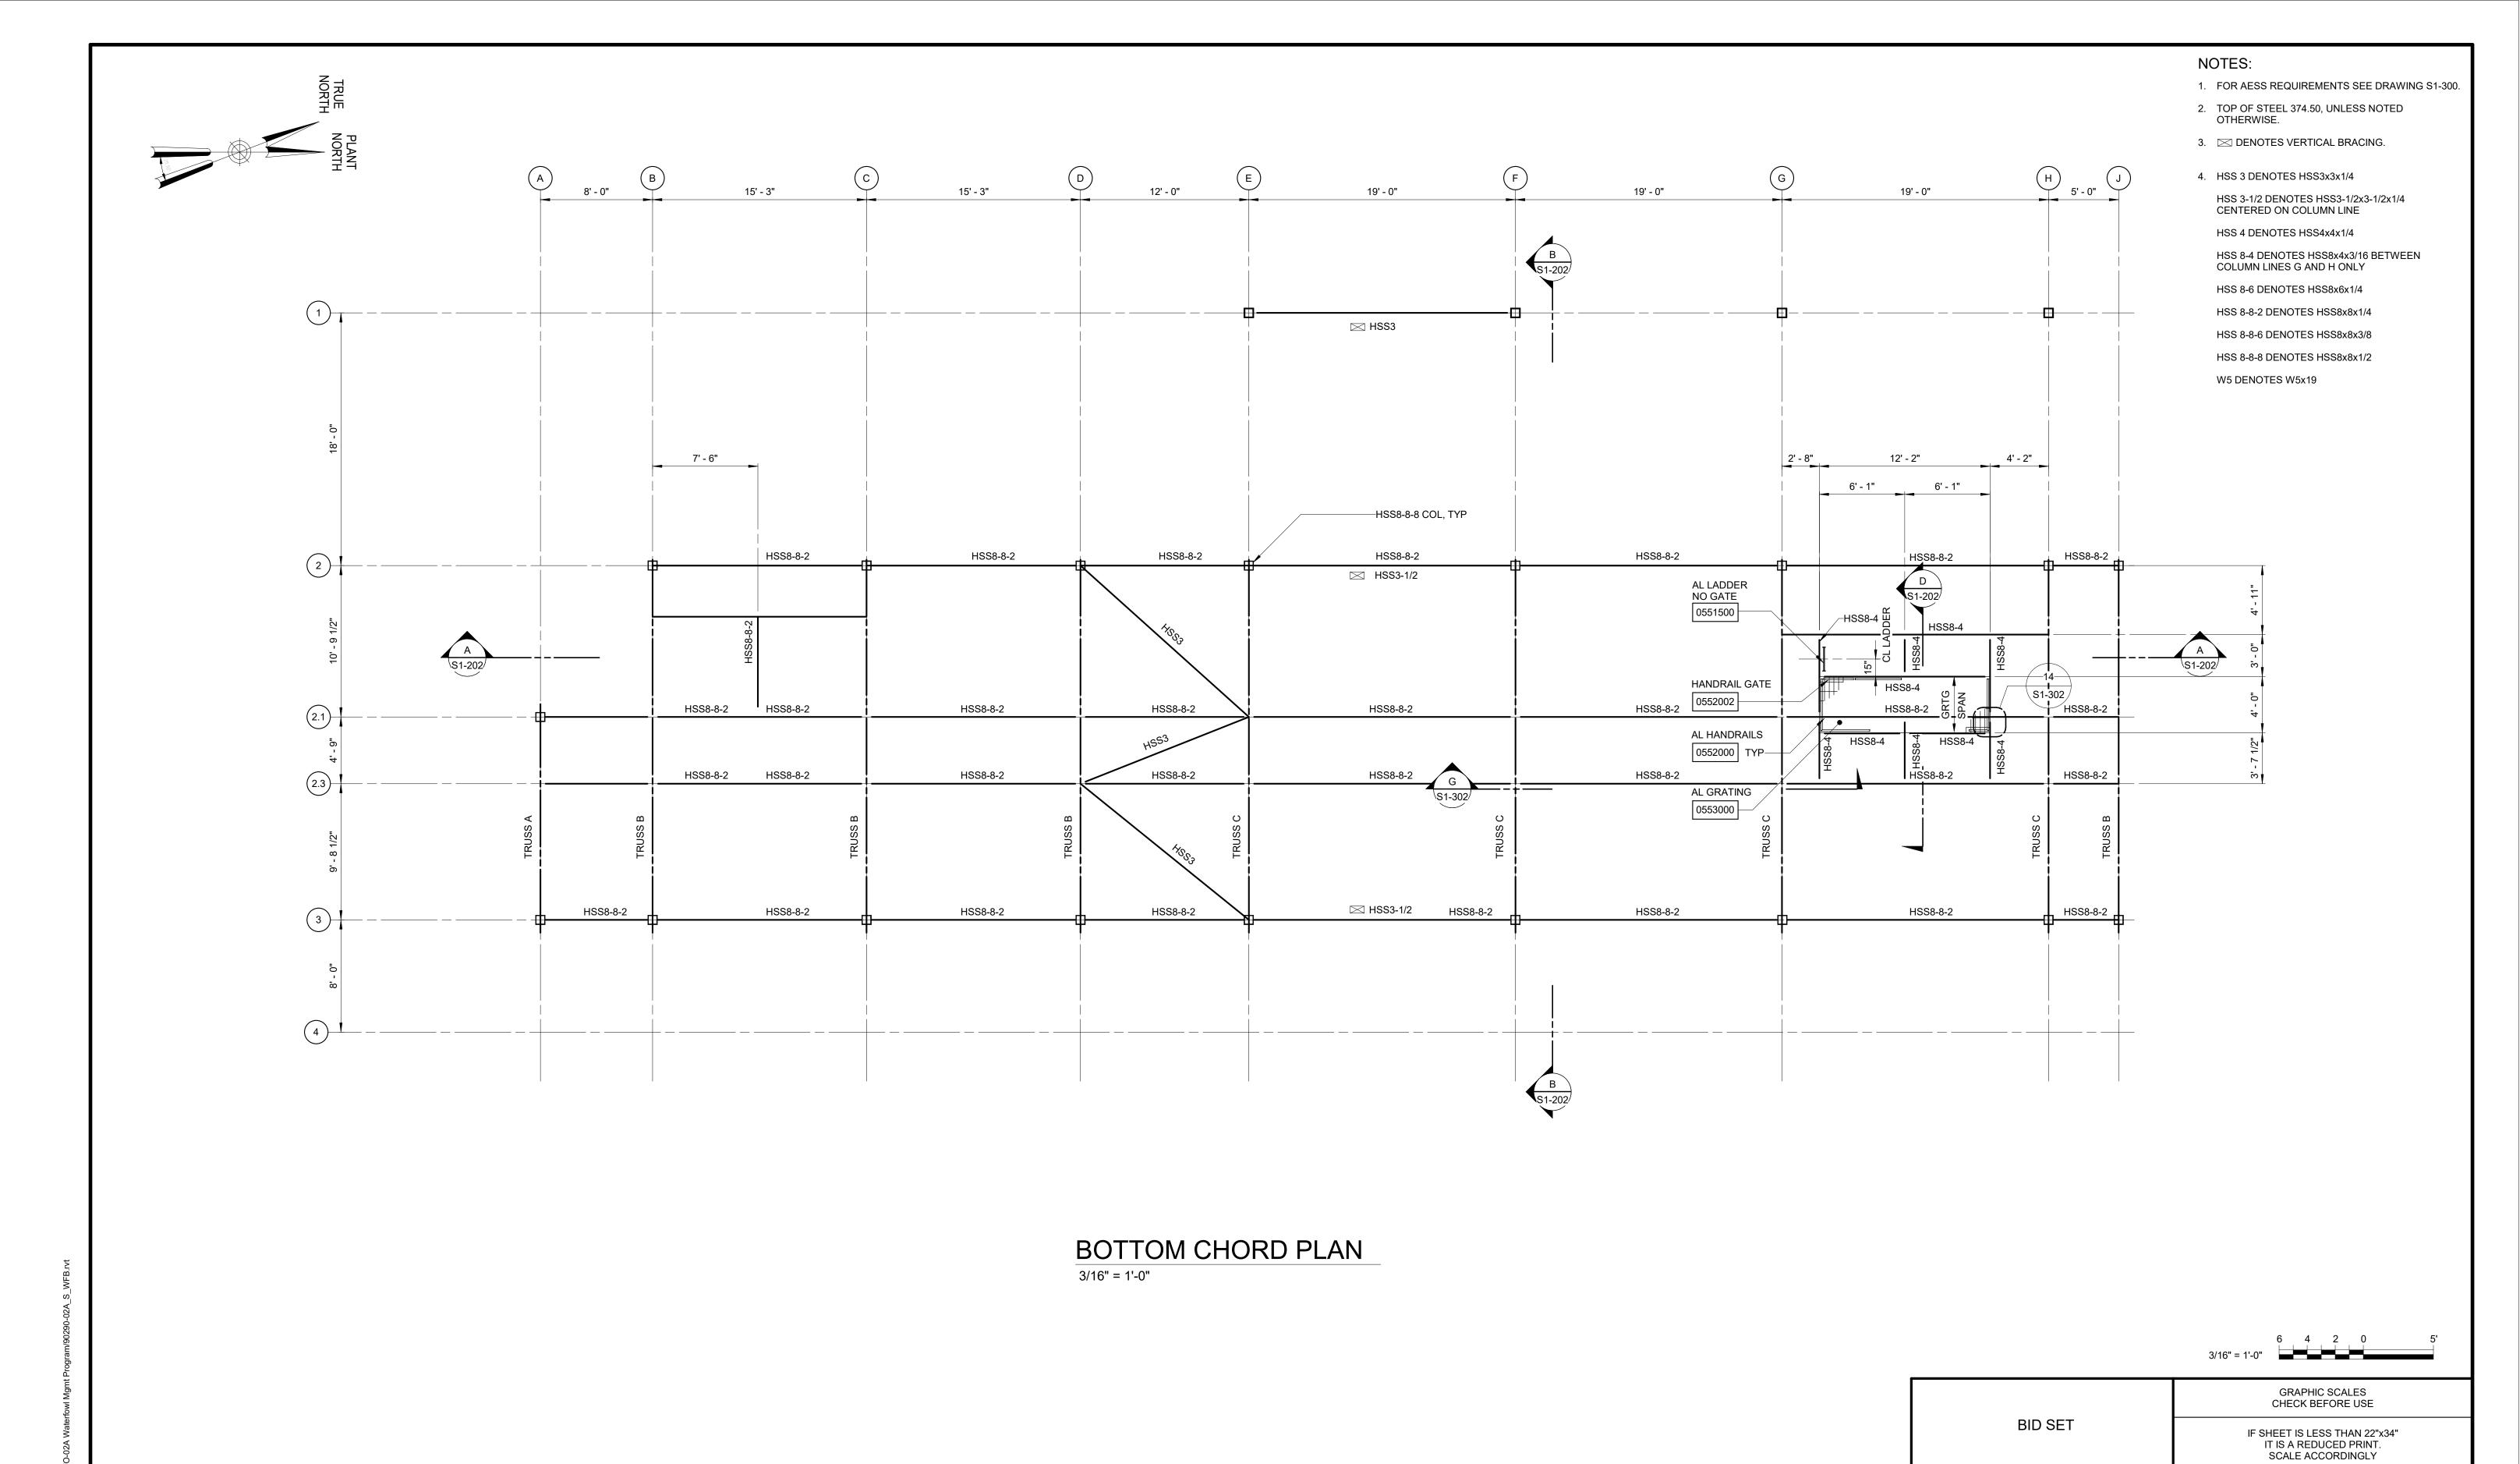
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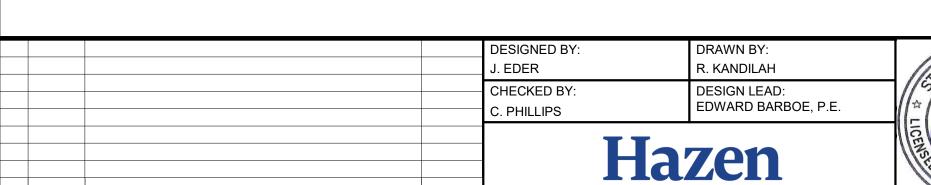
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APPR'D

REVISIONS/DESCRIPTION





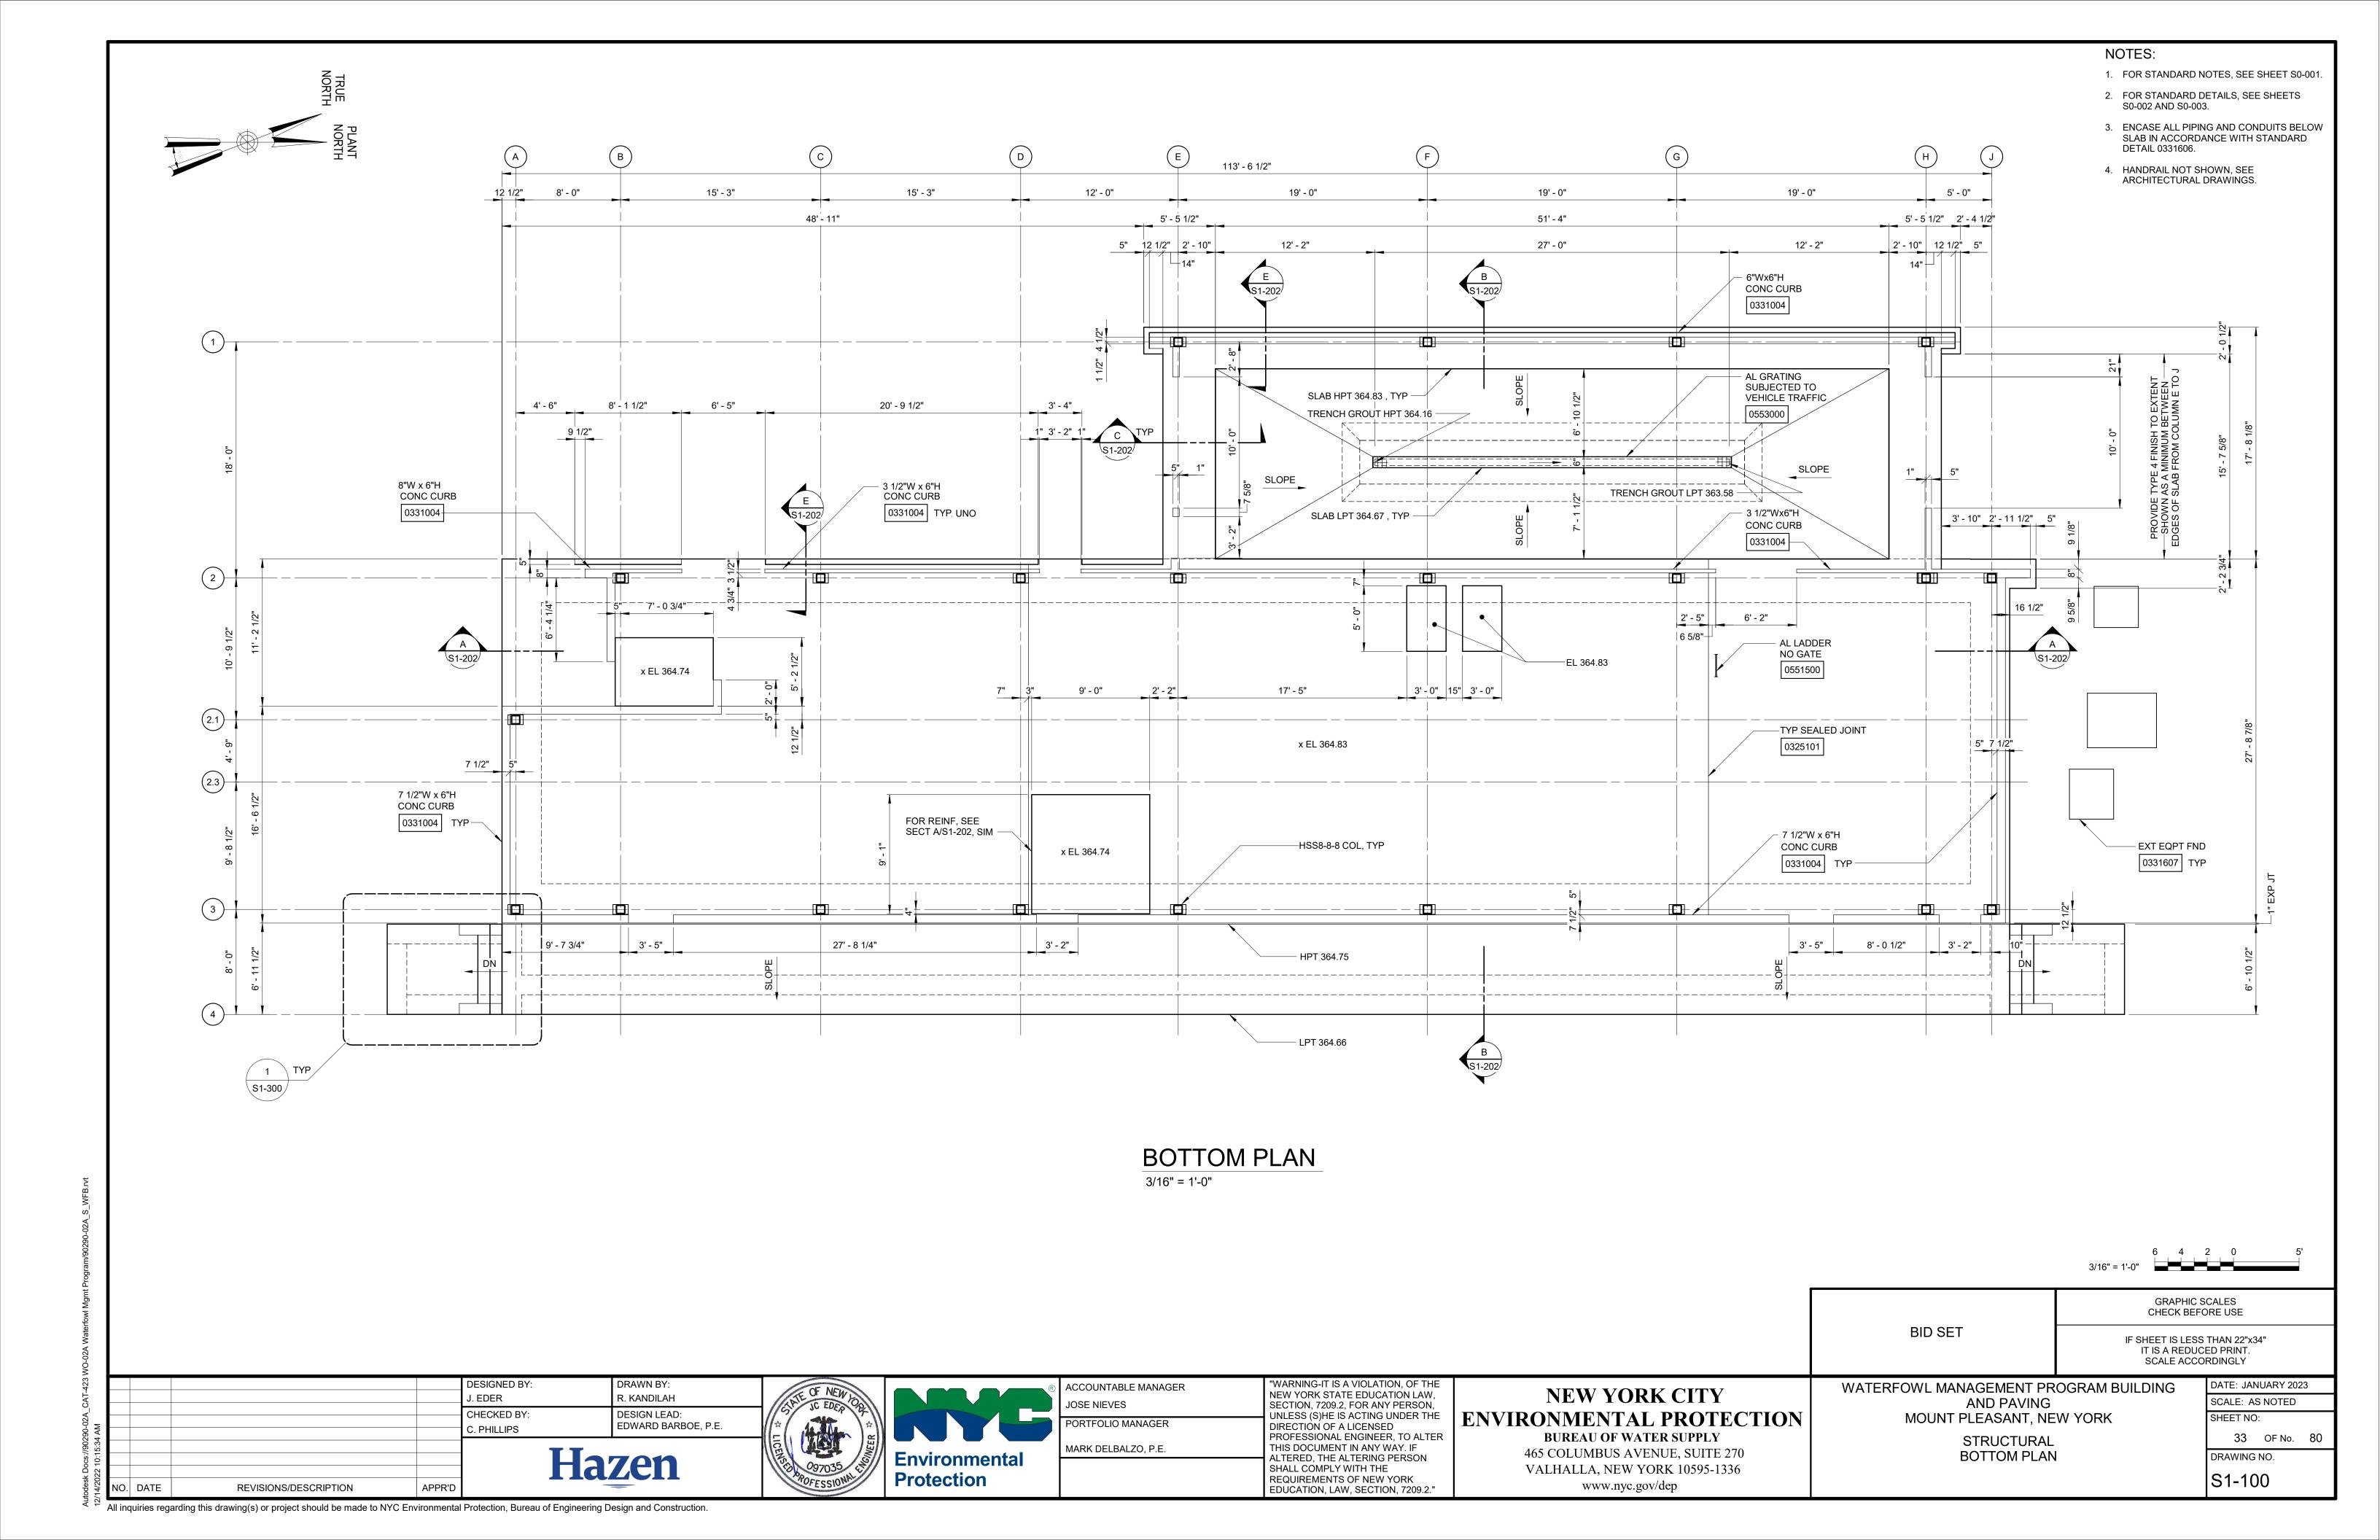

NO. DATE

REVISIONS/DESCRIPTION

**Environmental Protection** 

JOSE NIE\ MARK DE

NTABLE MANAGER EVES	"WARNING-IT IS A VIOLATION, OF THE NEW YORK STATE EDUCATION LAW, SECTION, 7209.2, FOR ANY PERSON, UNLESS (S)HE IS ACTING UNDER THE			
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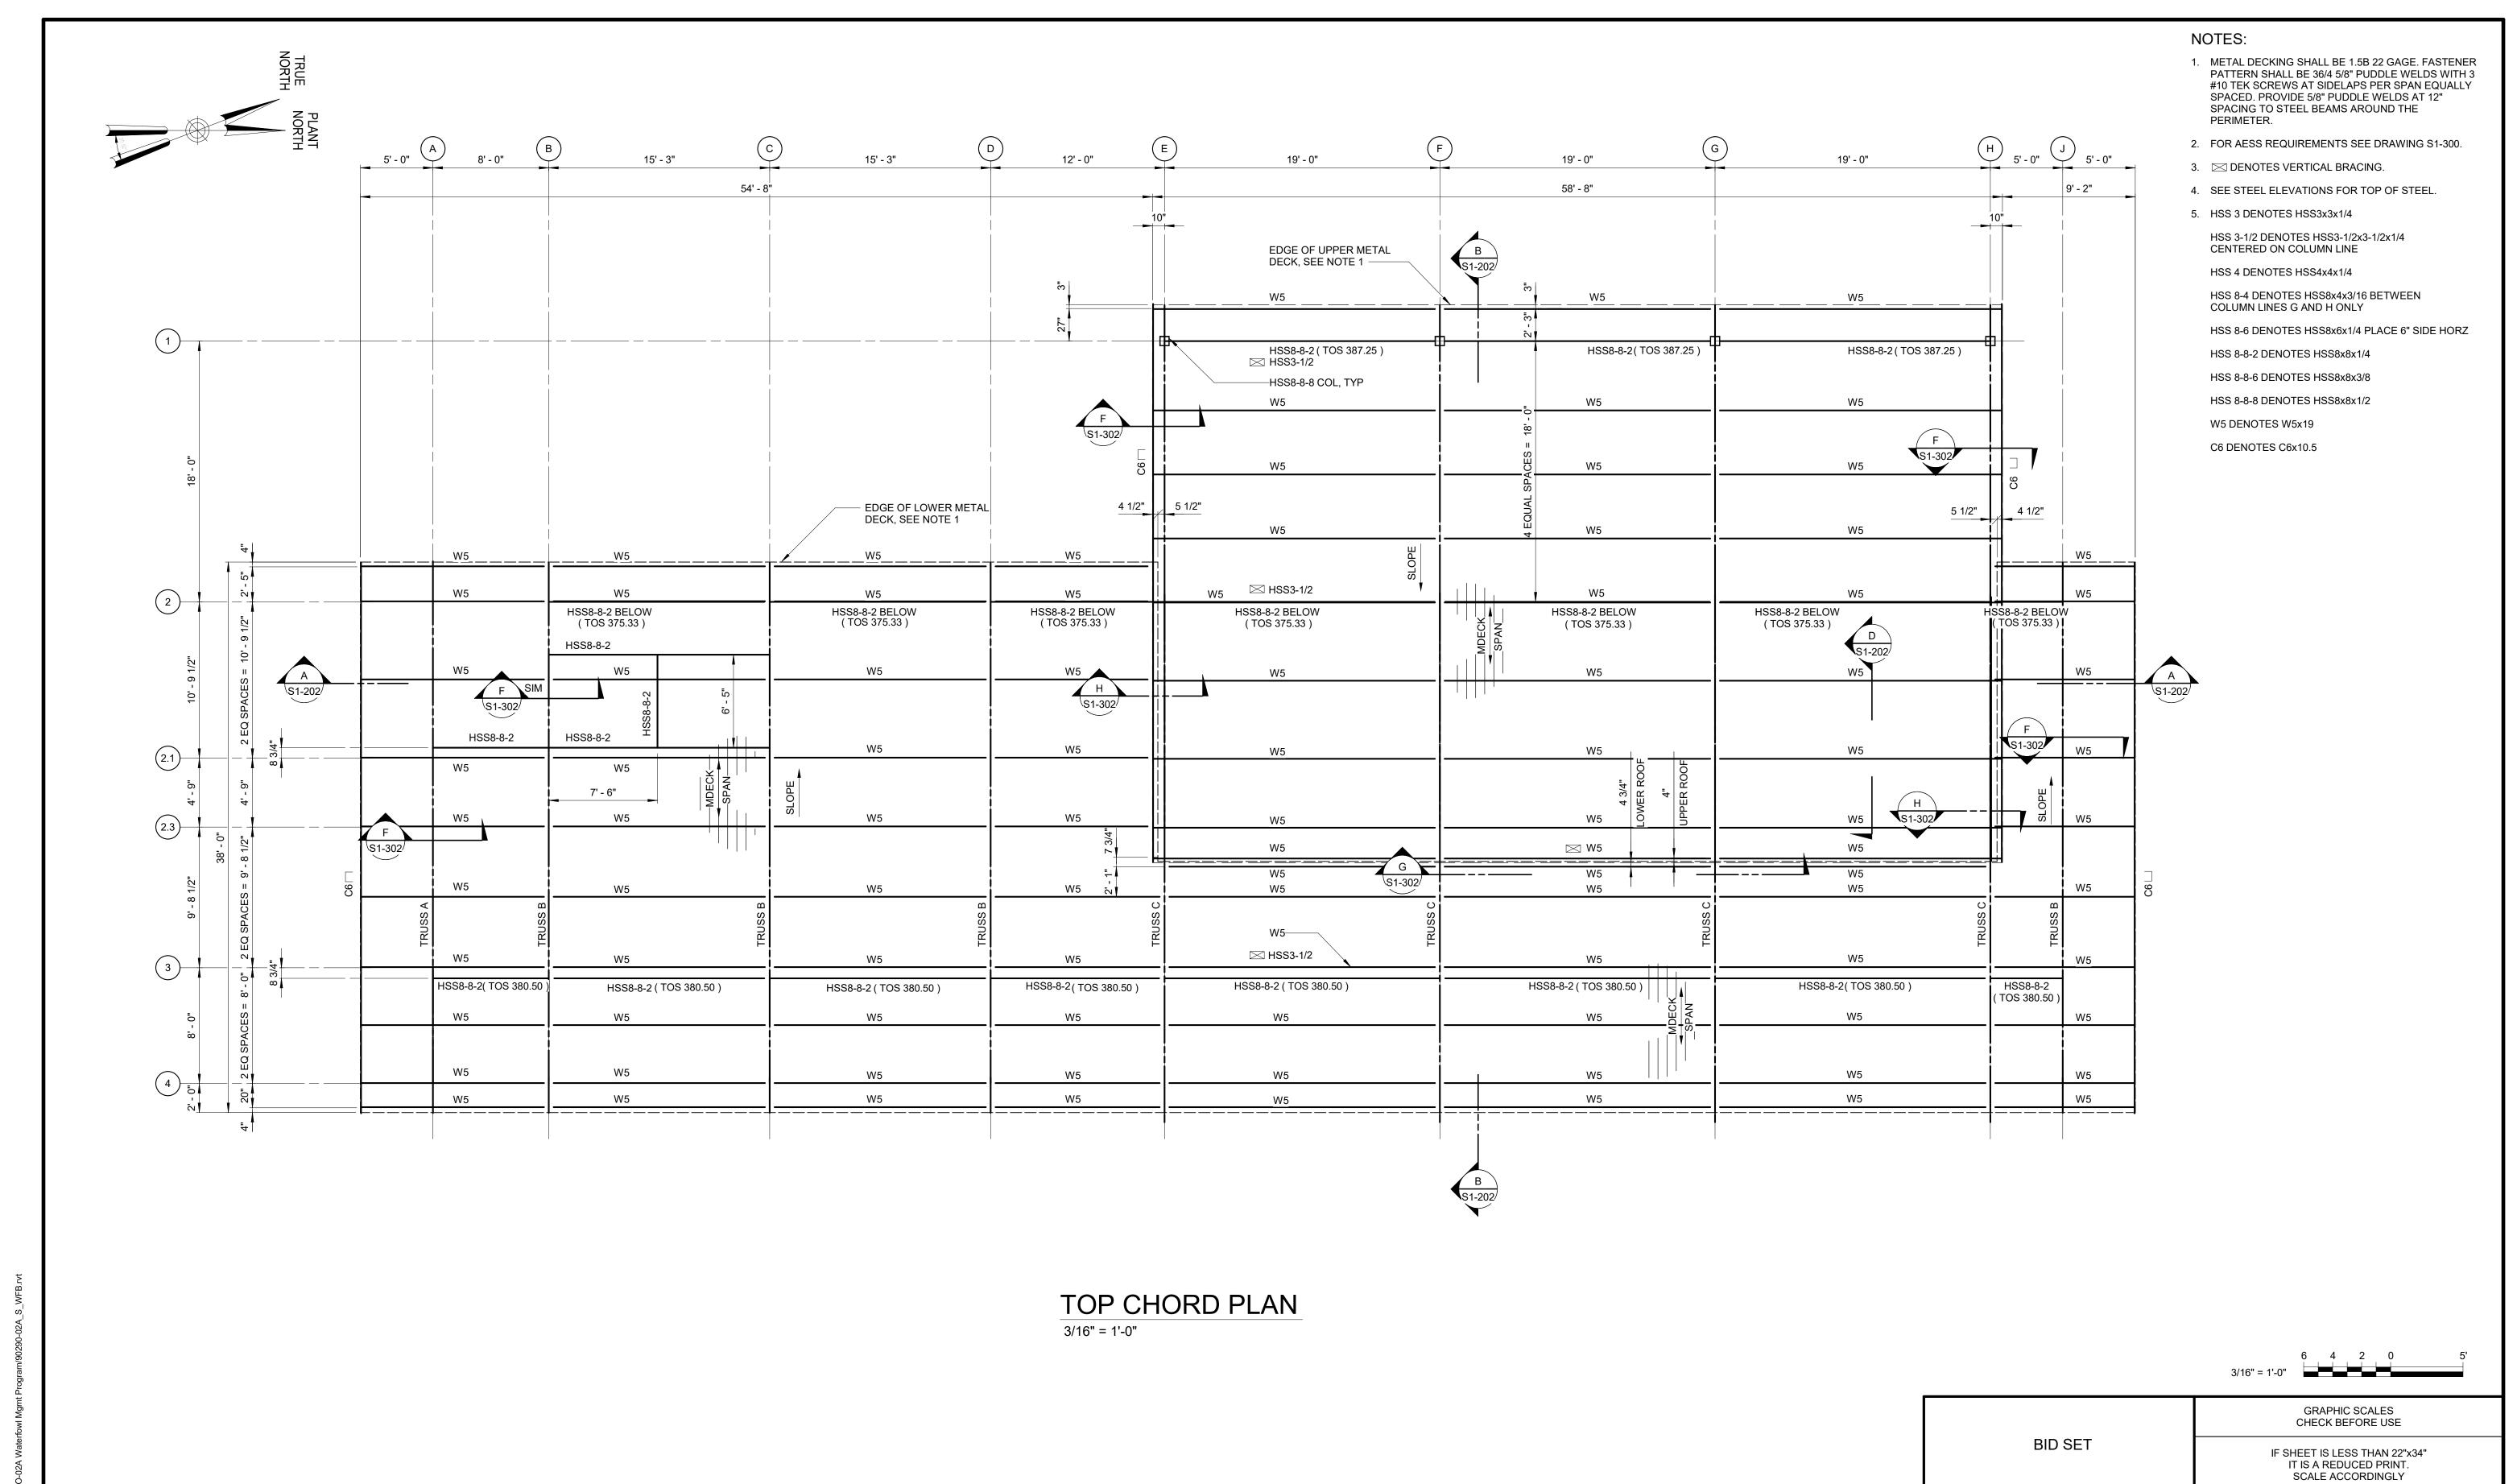
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WATERFOWL MANAGEMENT PROGRAM BUILDING AND PAVING MOUNT PLEASANT, NEW YORK STRUCTURAL BOTTOM CHORD PLAN

DATE: JANUARY 2023		
SCALE: AS NOTED		
SHEET NO:		
34	OF No.	80
DRAWING	G NO.	

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S1-101



DESIGNED BY DRAWN BY: J. EDER R. KANDILAH CHECKED BY: DESIGN LEAD: EDWARD BARBOE, P.E. C. PHILLIPS Hazen

APPR'D

NO. DATE

REVISIONS/DESCRIPTION



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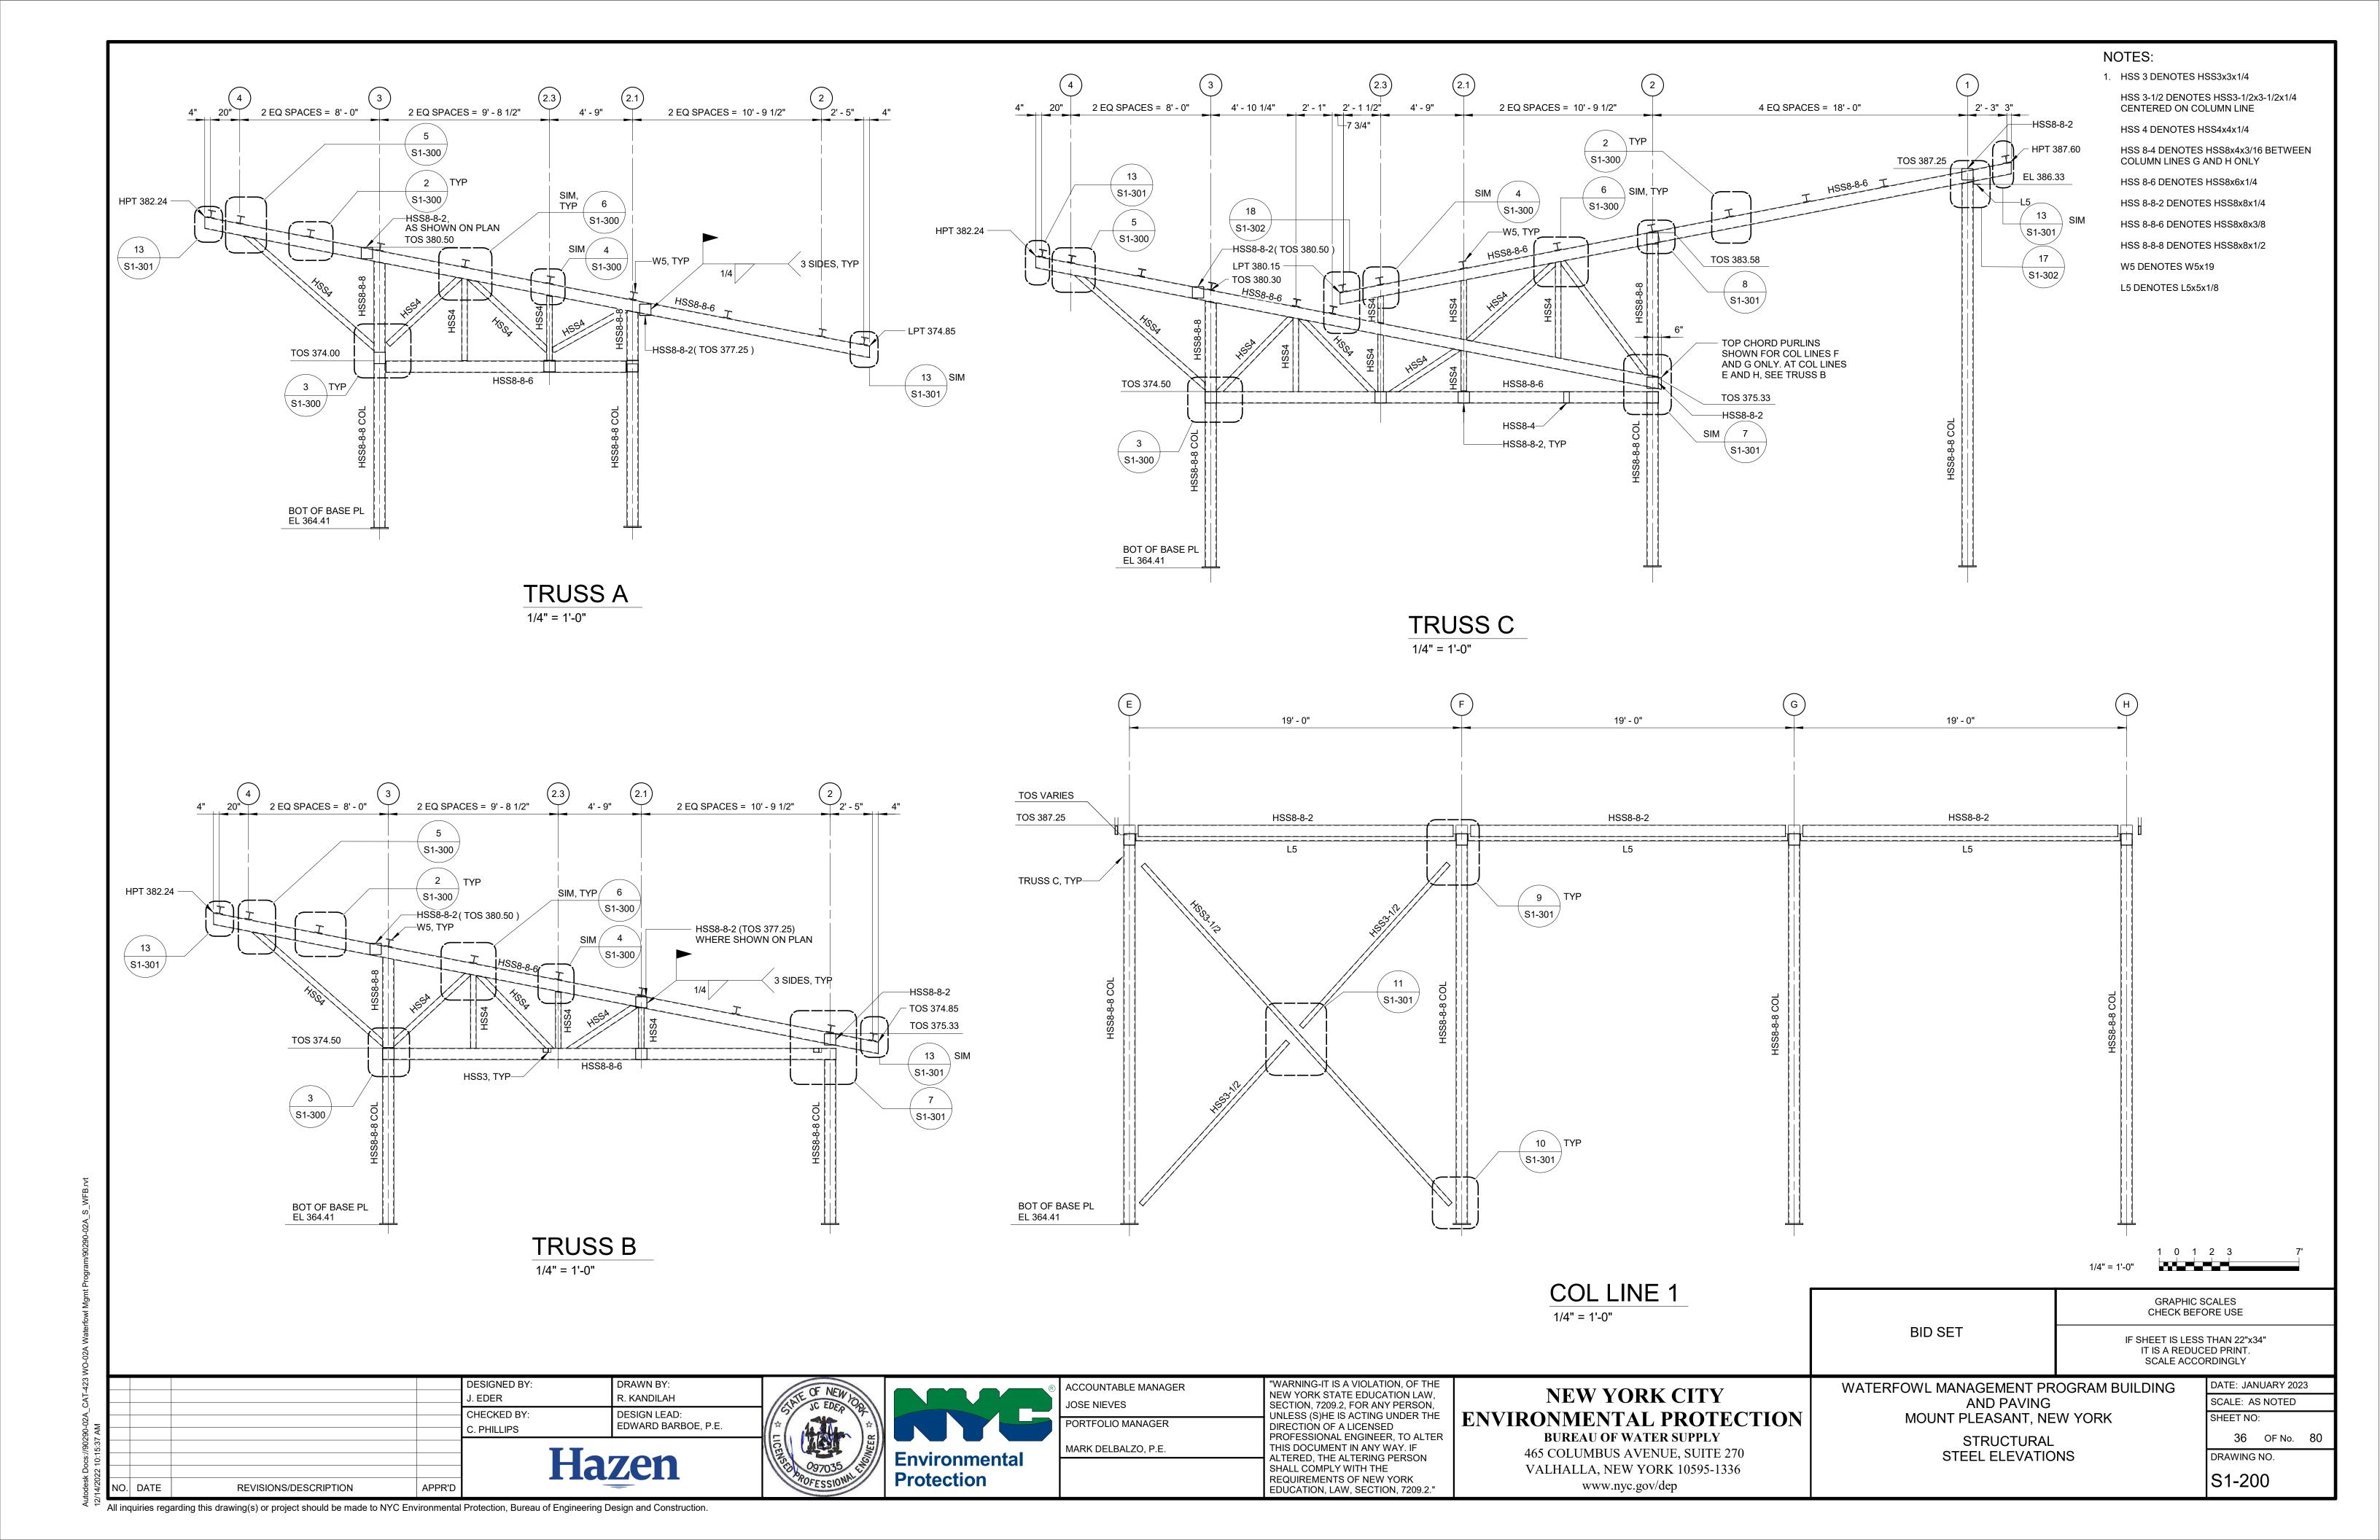
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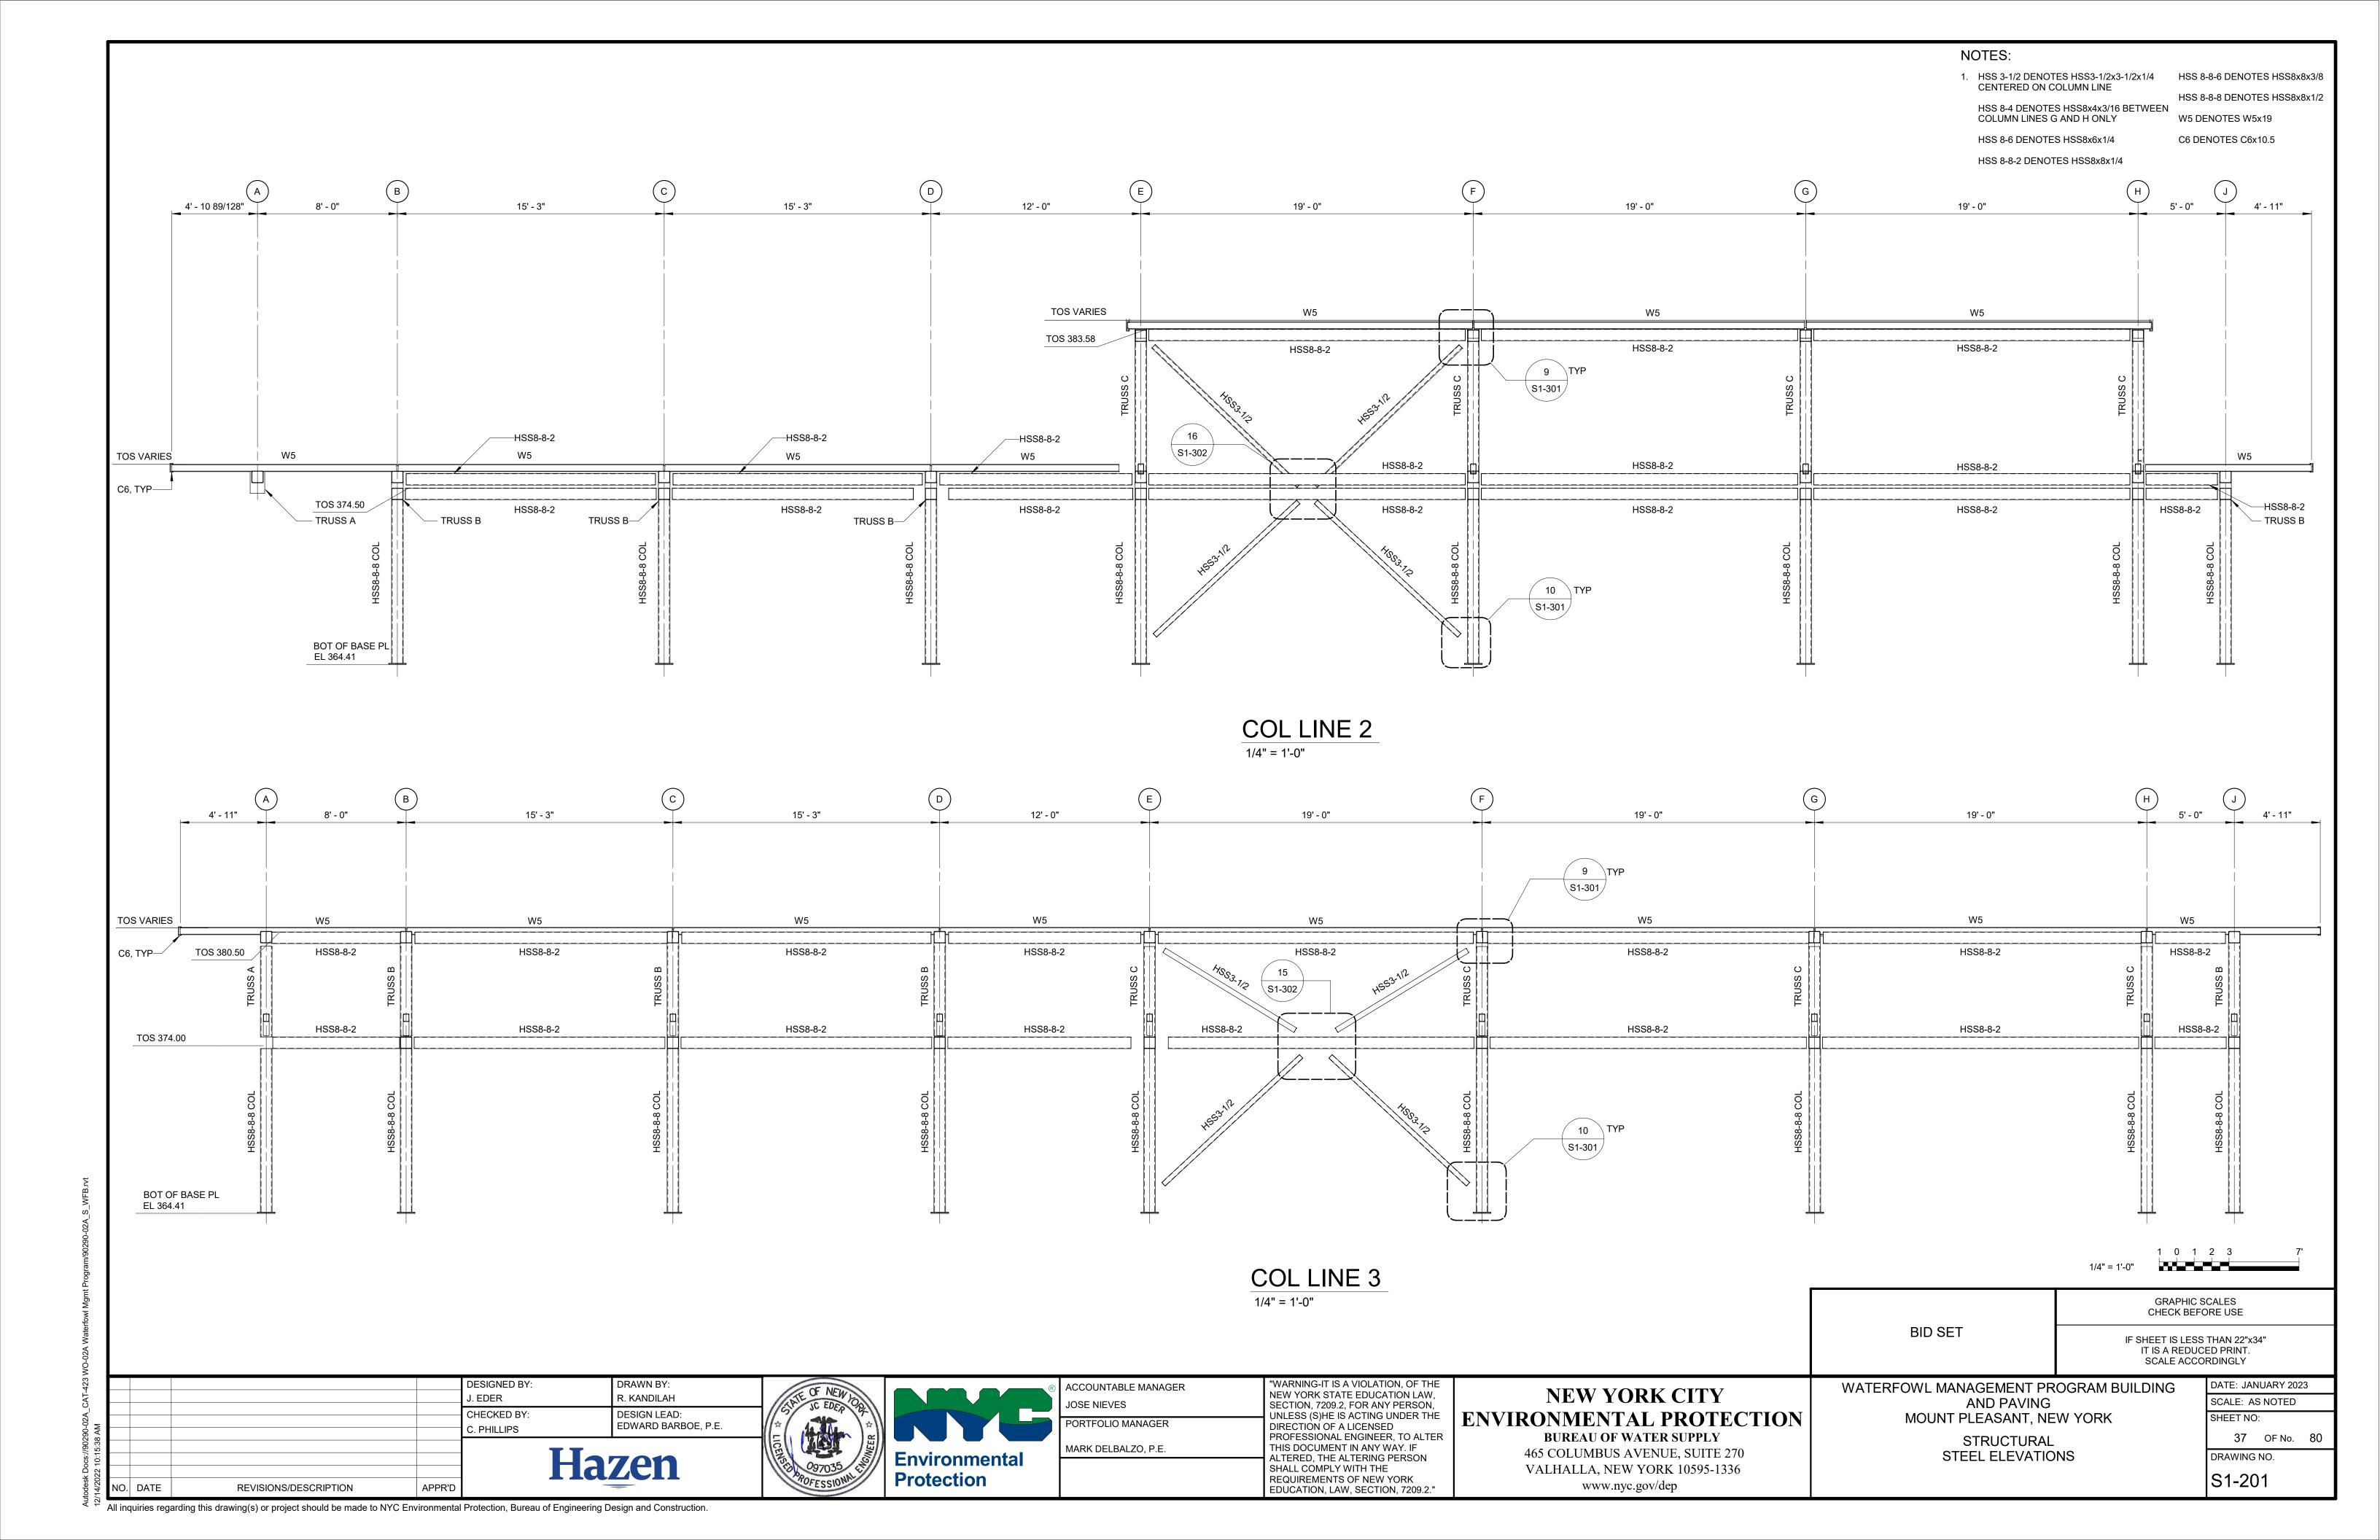
WATERFOWL MANAGEMENT PROGRAM BUILDING AND PAVING MOUNT PLEASANT, NEW YORK STRUCTURAL


TOP CHORD PLAN


DATE: JANUARY 2023 SCALE: AS NOTED SHEET NO: 35 OF No. 80 DRAWING NO. S1-102

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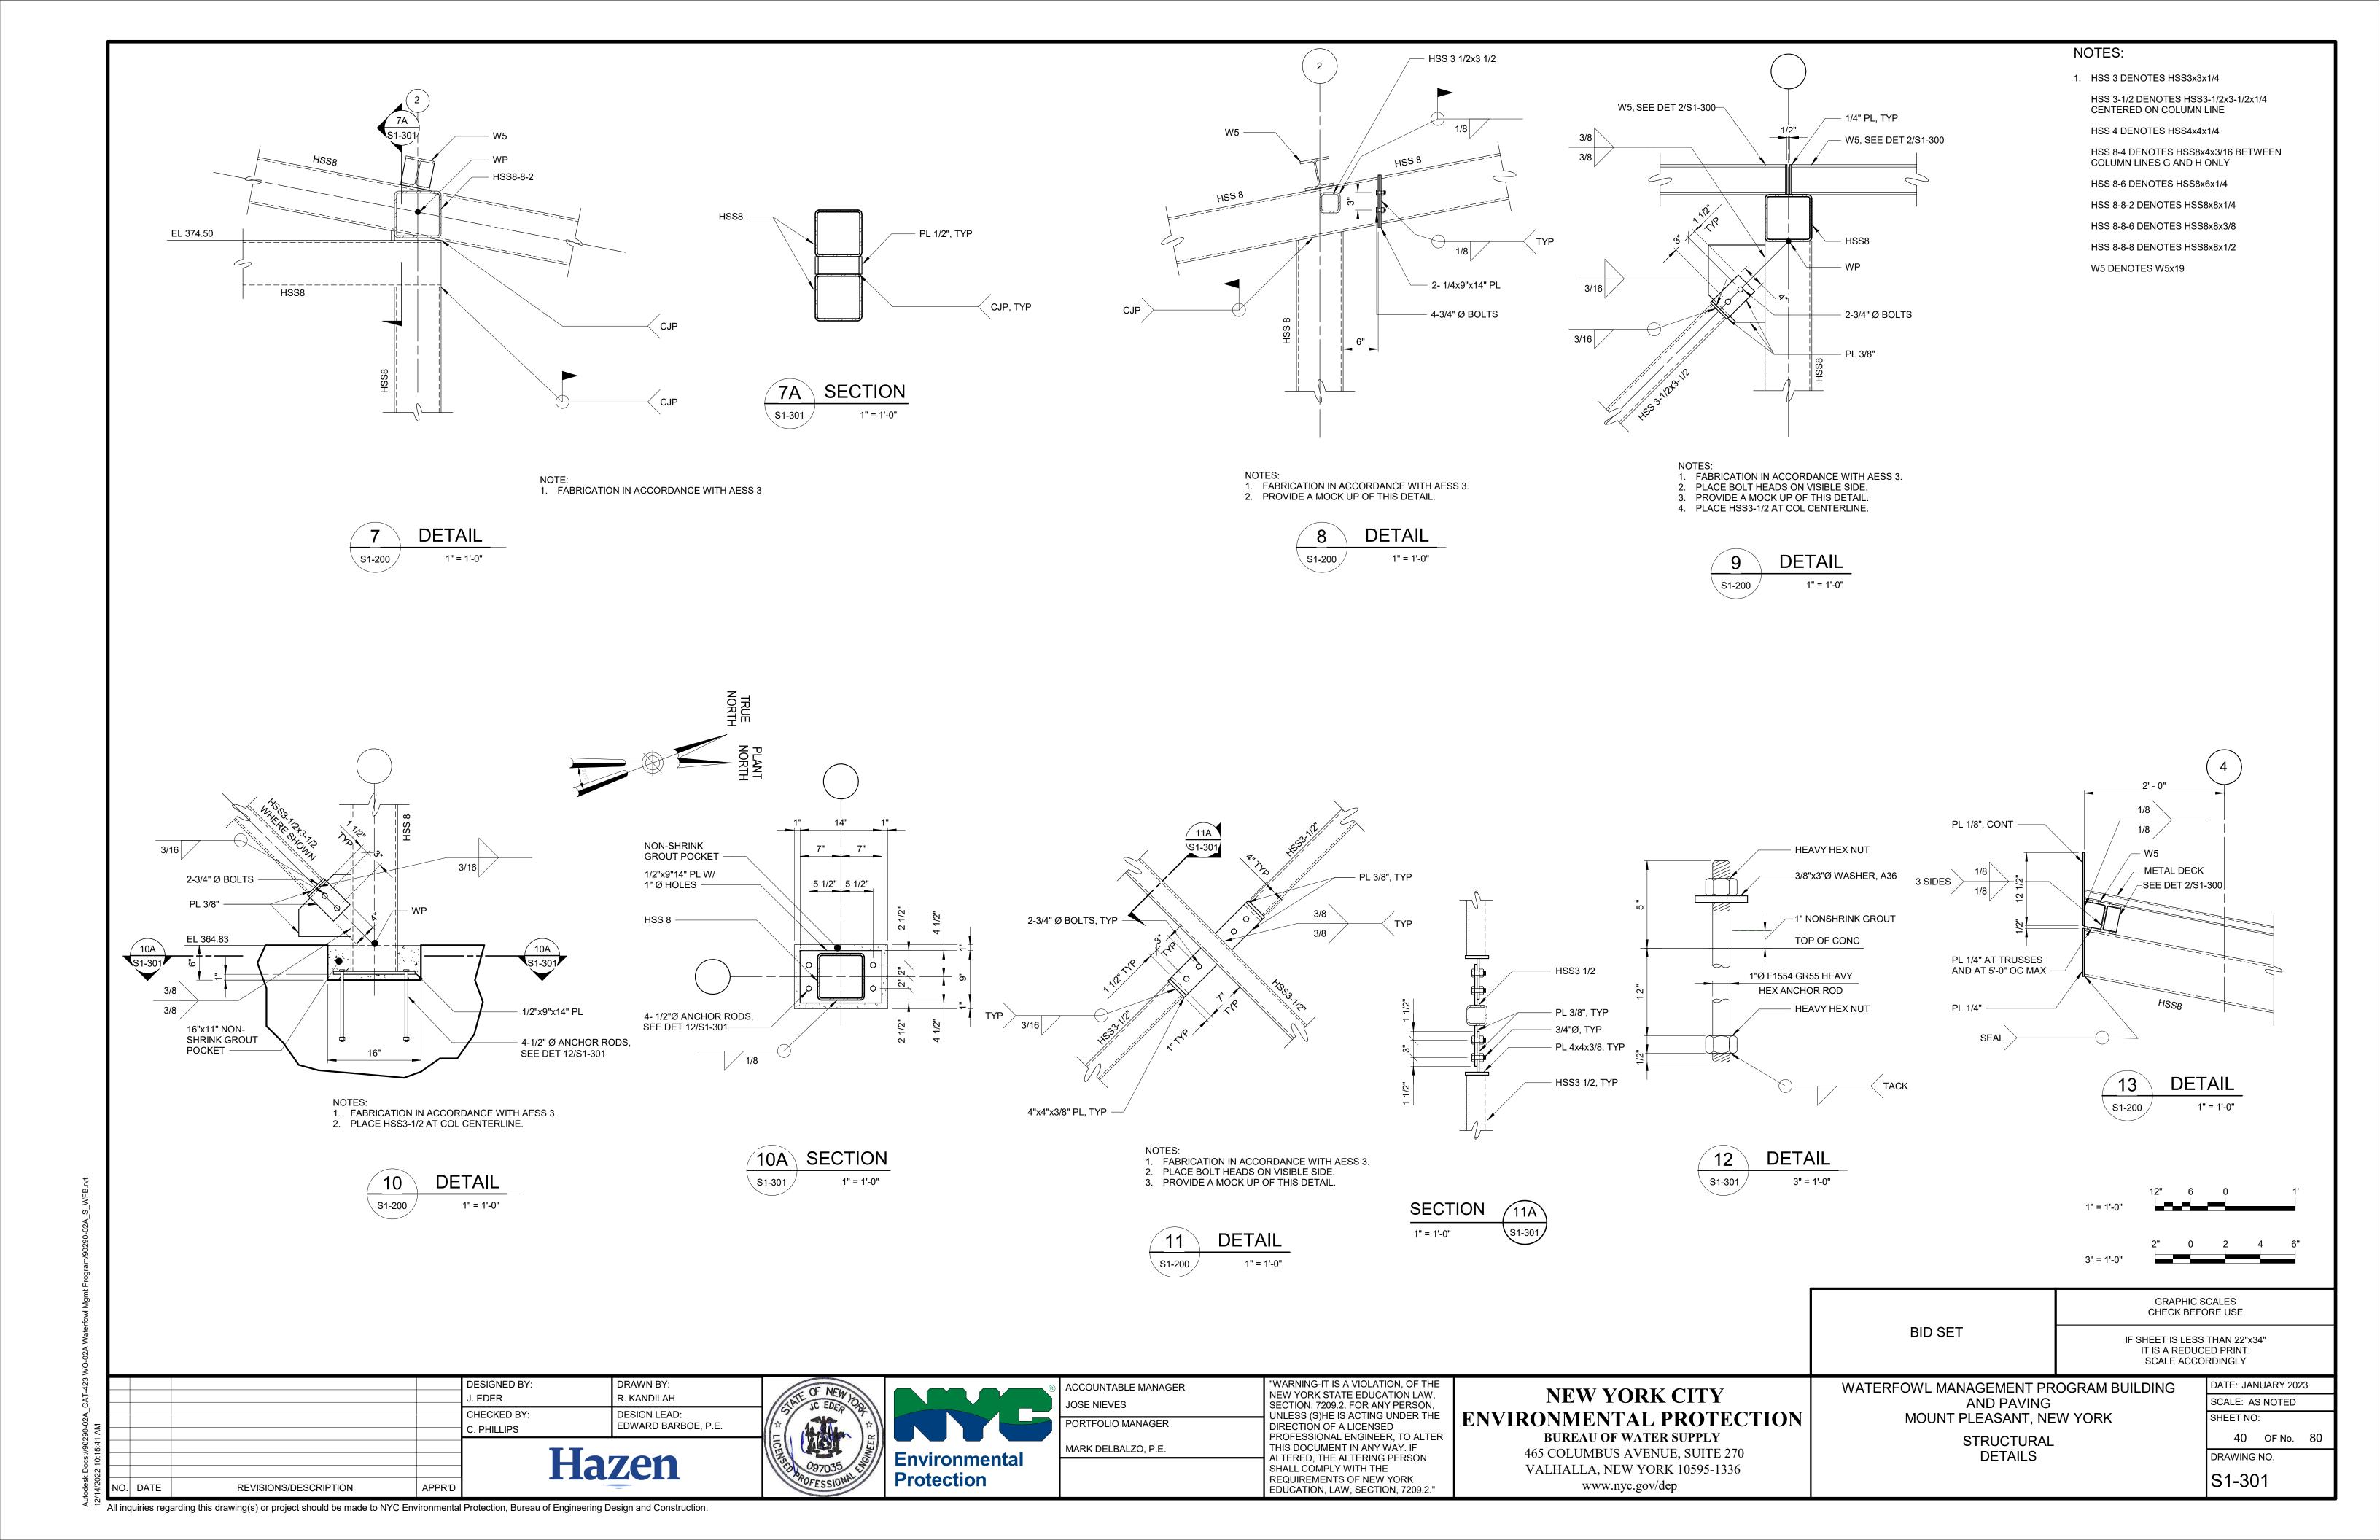







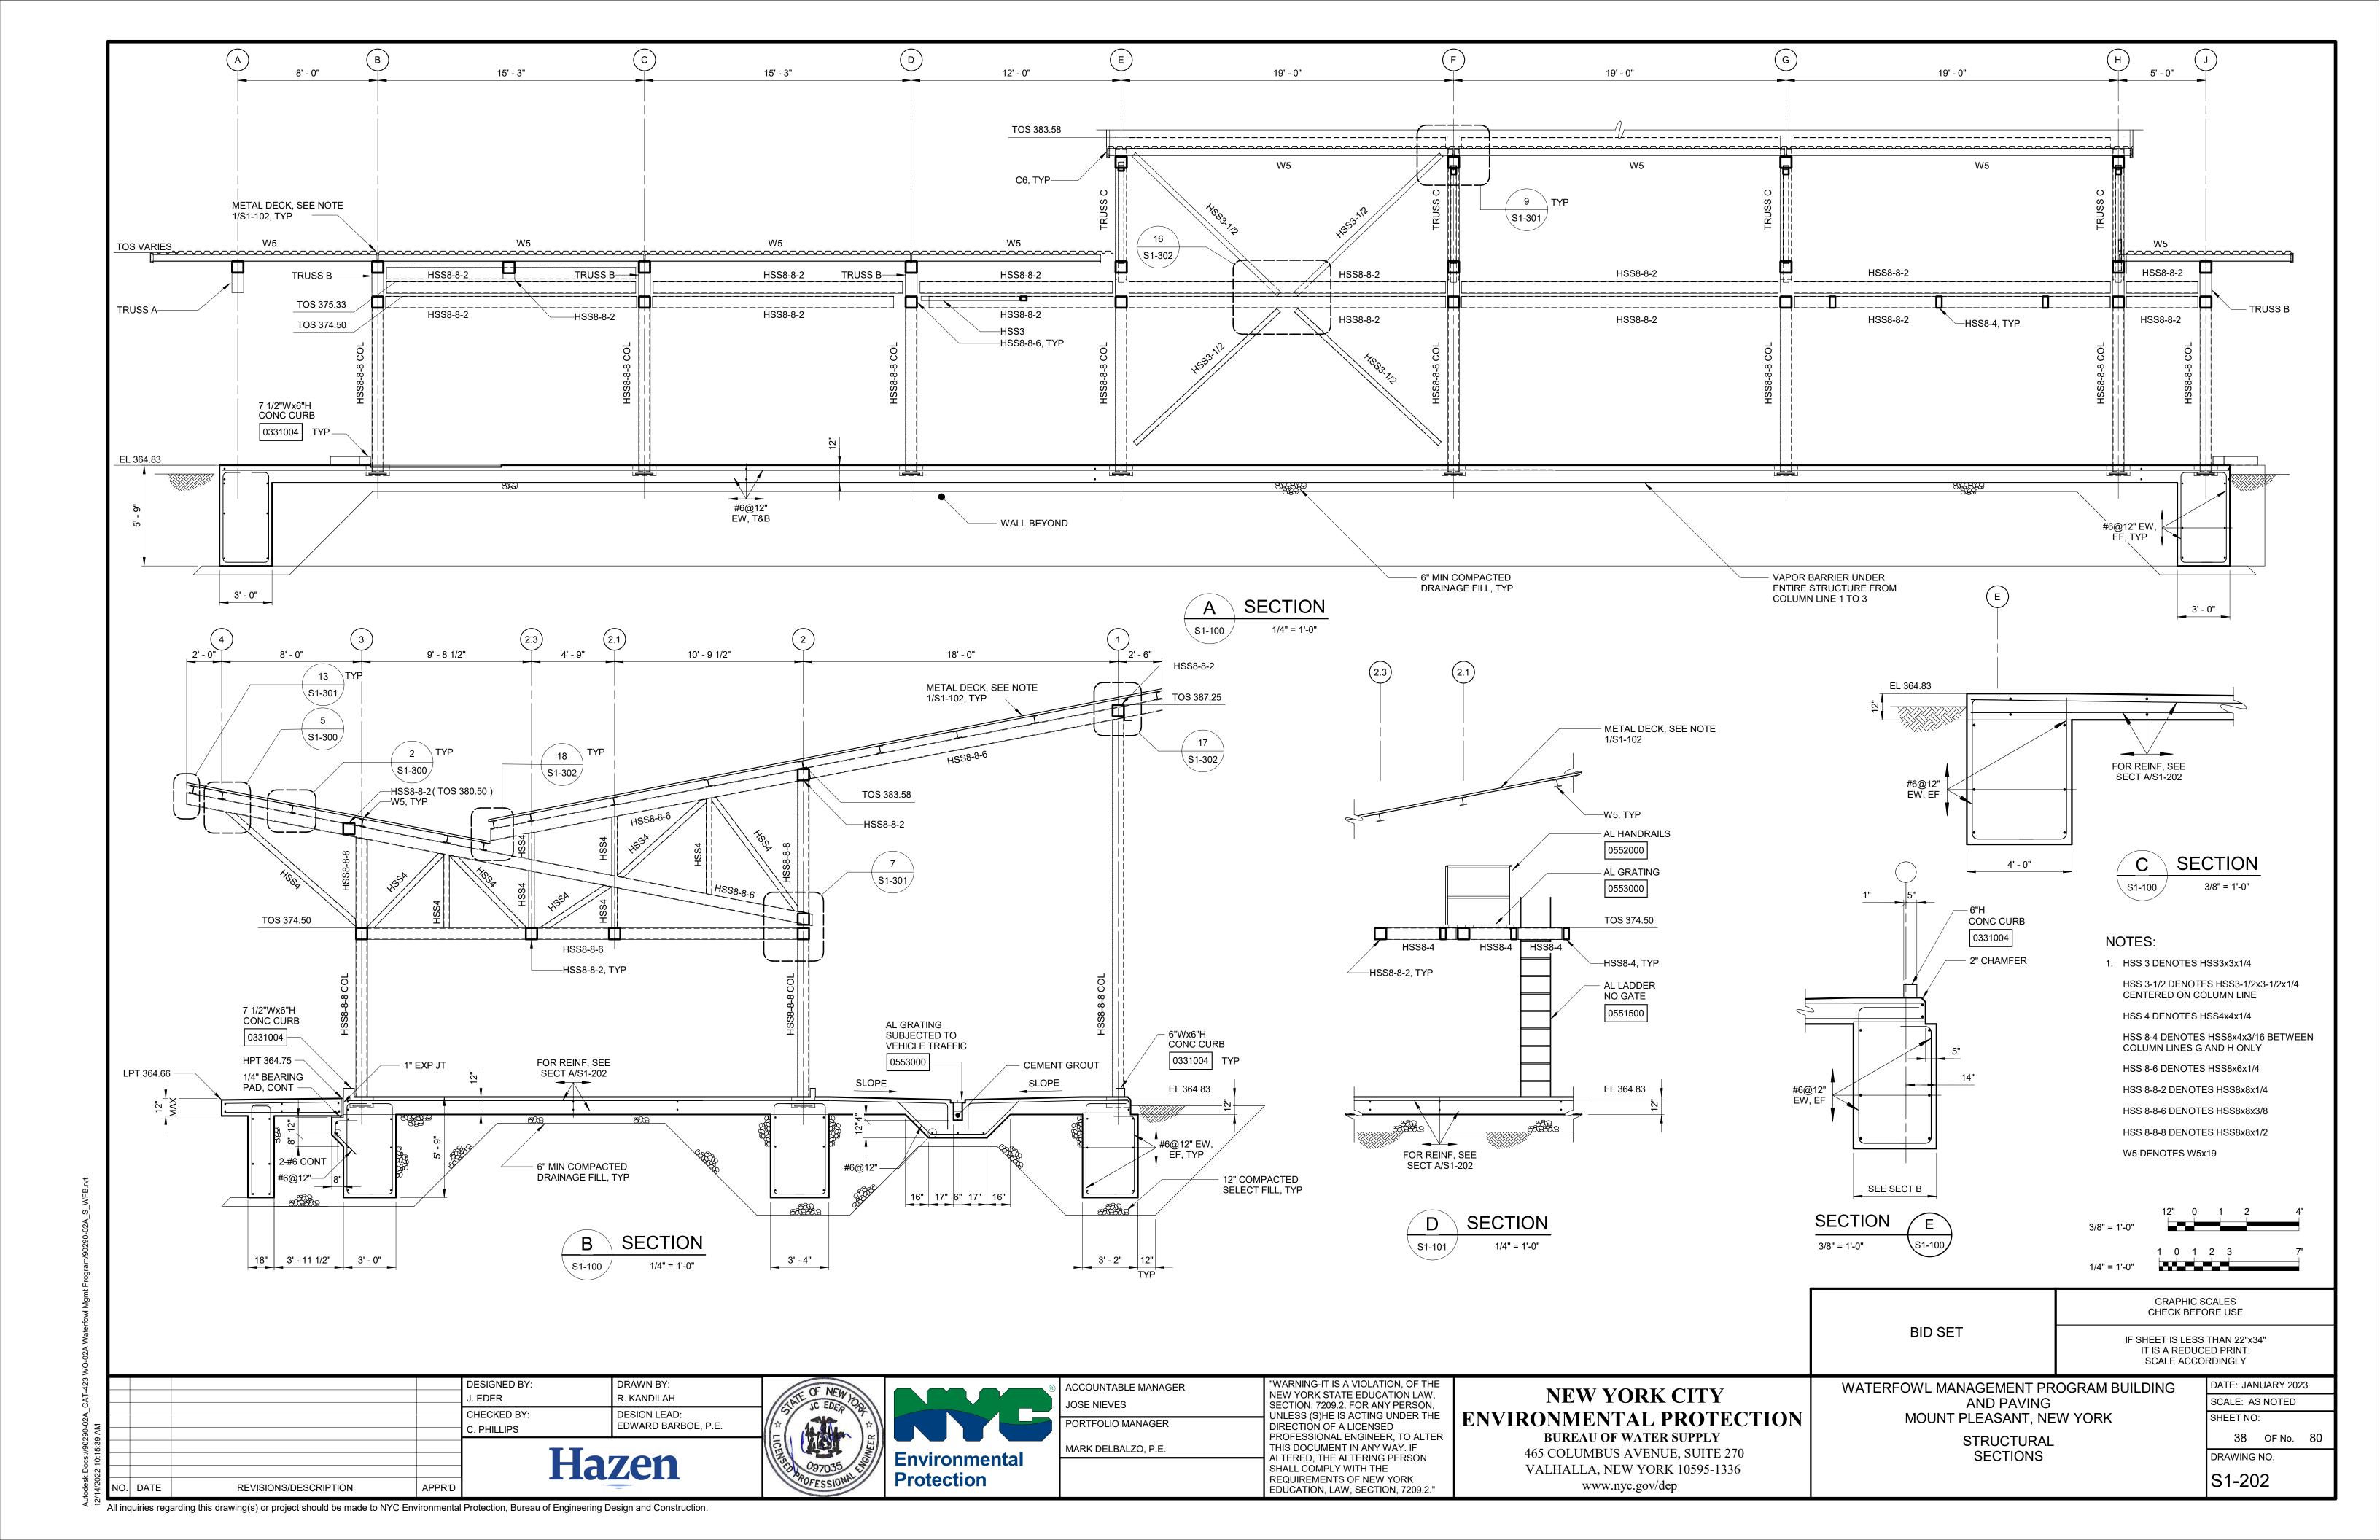
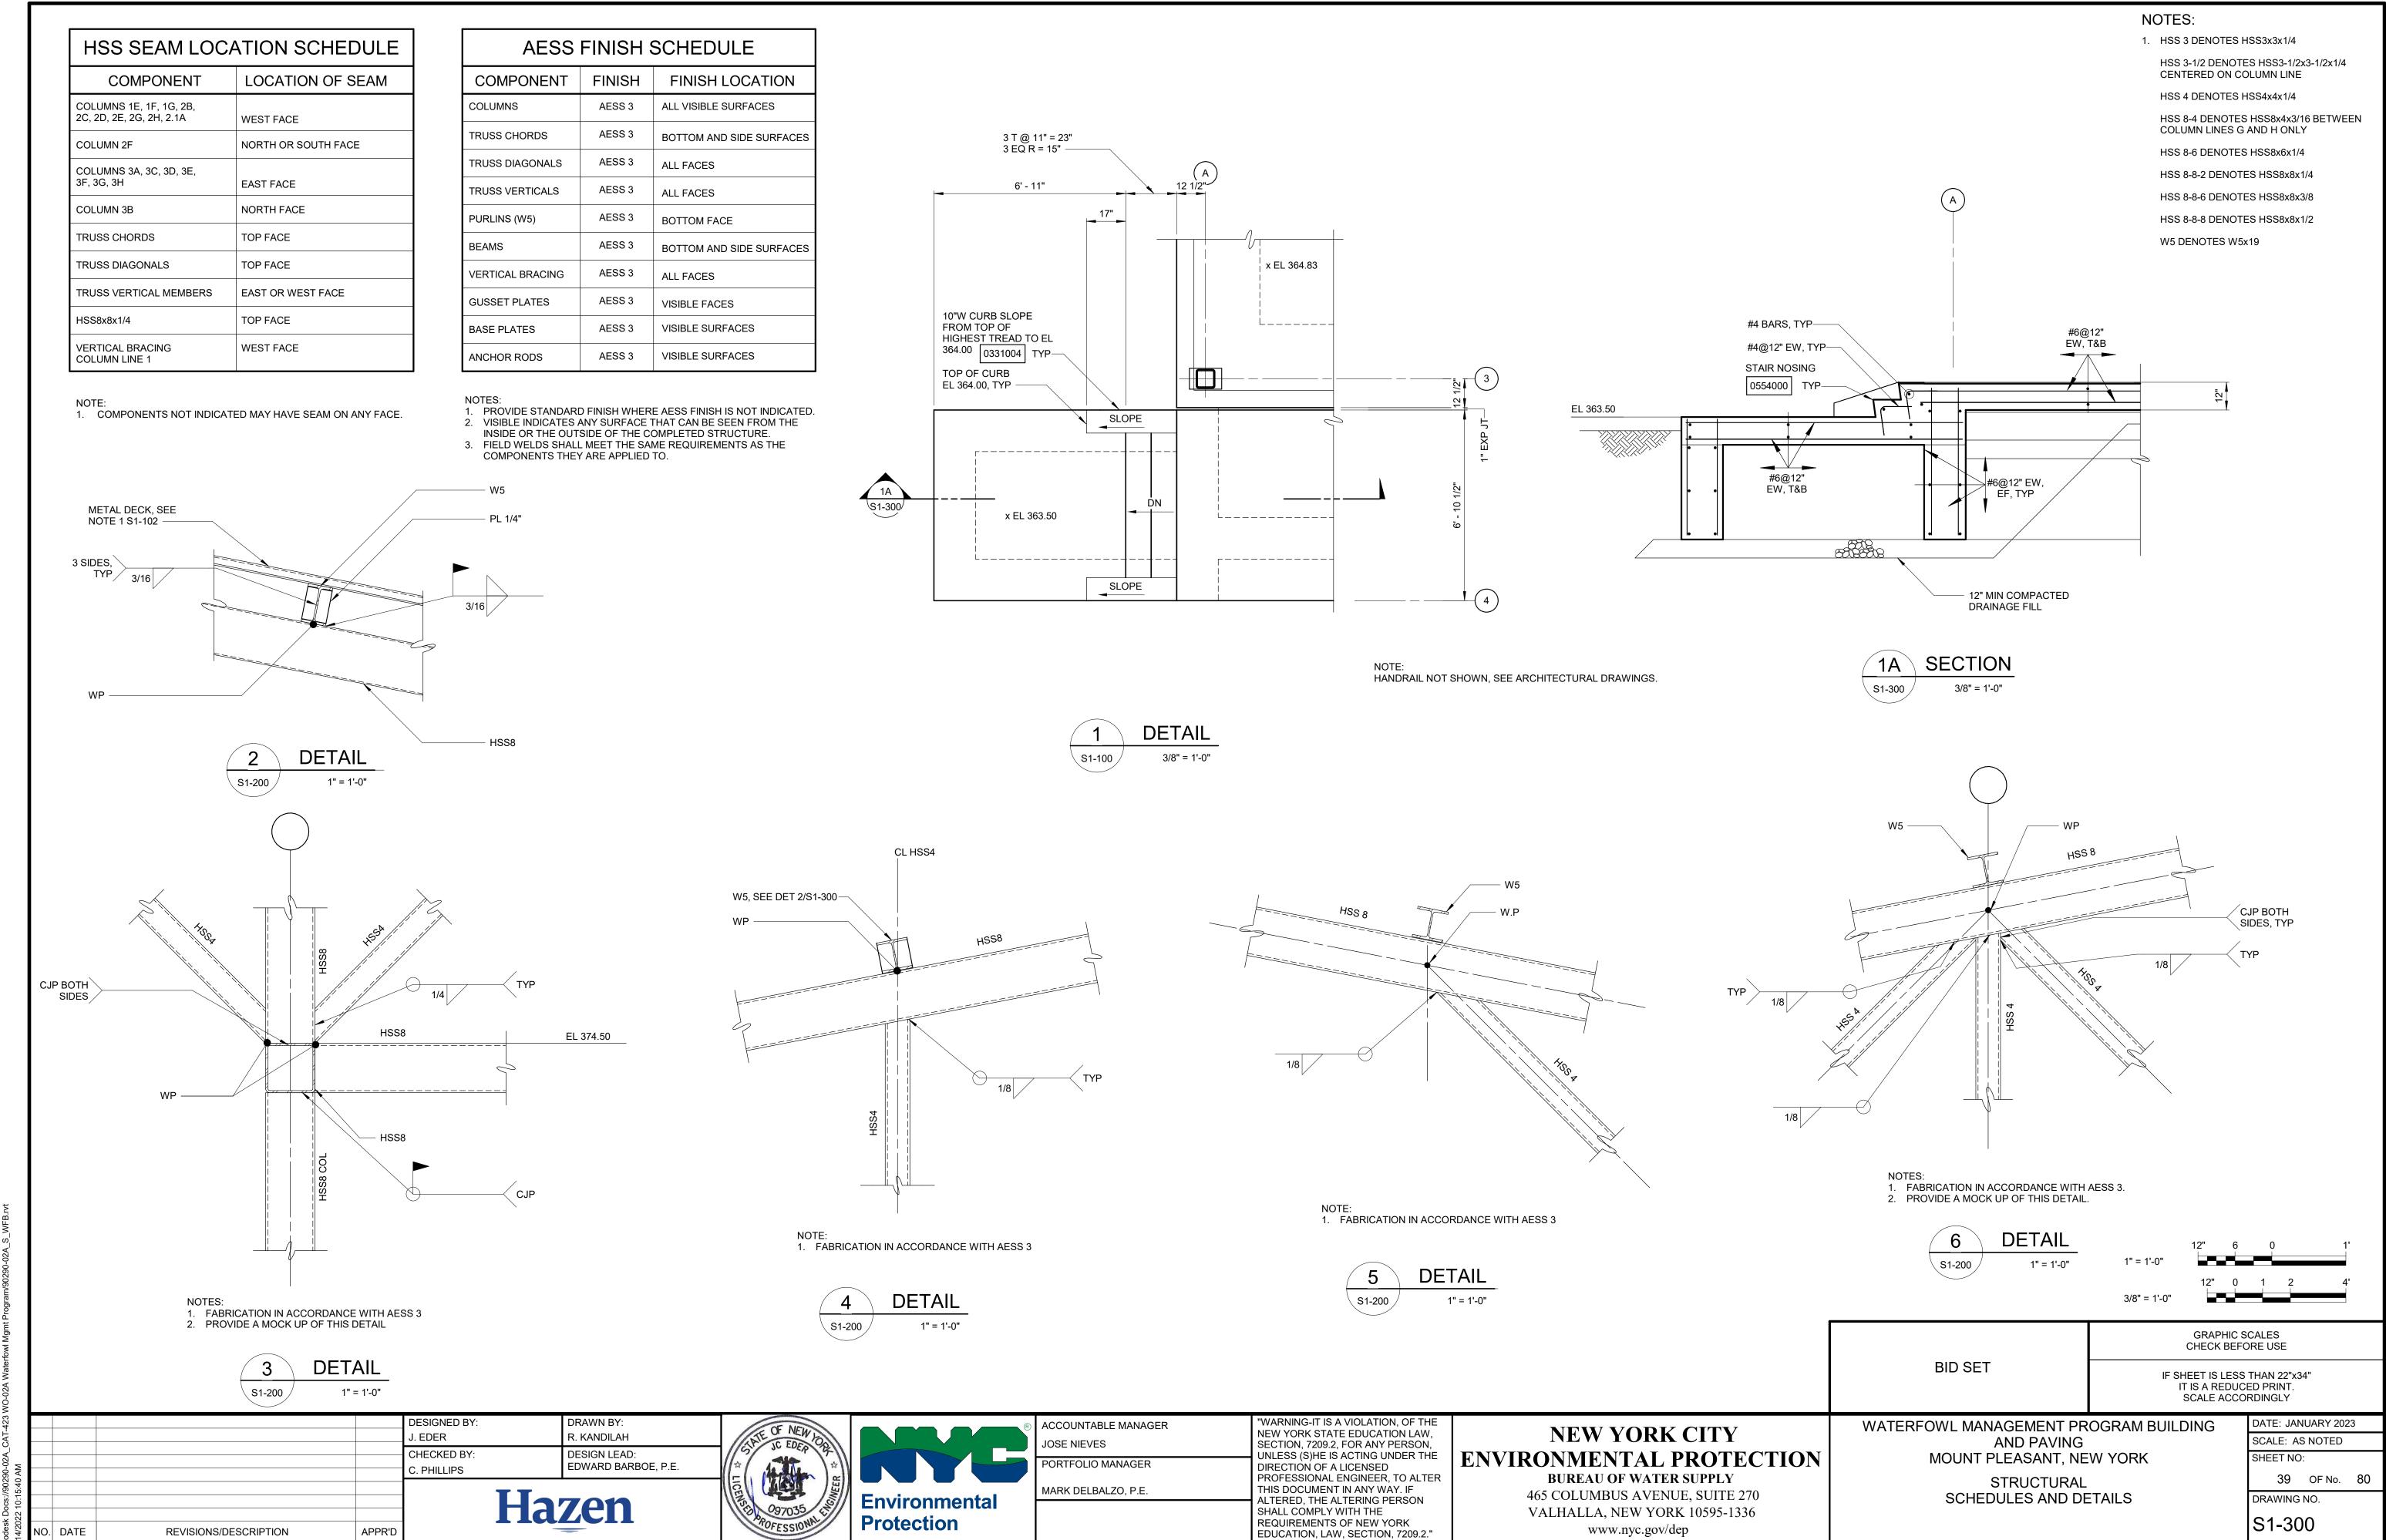
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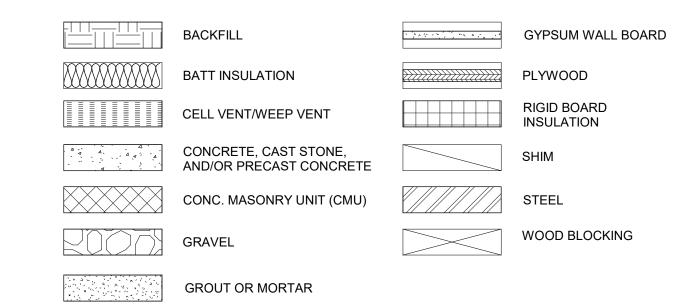
## **GENERAL NOTES**

- 1. WORK SHALL BE IN CONFORMANCE WITH APPLICABLE REQUIREMENTS OF LOCAL GOVERNING CODES, INCLUDING BUT NOT LIMITED TO N.Y.S DEPT. OF LABOR, HEALTH CODE, FIRE DEPARTMENT REGULATIONS, NFPA, OSHA CODES, ICC A117.1 (2009), AND NEW YORK STATE UNIFORM FIRE PREVENTION (2020 EDITION) & BUILDING CODE (2020 EDITION).
- 2. WORK SHALL BE EXECUTED IN FULL COMPLIANCE WITH THE APPLICABLE PROVISIONS OF ALL LAWS, BY-LAWS, STATUTES, ORDINANCES, CODES, RULES, REGULATIONS AND LAWFUL ORDERS OF PUBLIC AUTHORITIES BEARING ON THE PERFORMANCE AND EXECUTION OF THE WORK.
- 3. CONTRACTOR SHALL PROMPTLY NOTIFY THE ARCHITECT OF ANY PORTIONS OF THE WORK, IN THE CONTRACT DOCUMENTS THAT ARE AT VARIANCE WITH THE ABOVE.
- 4. ALL PERMITS ISSUED SHALL BE POSTED IN A CONSPICUOUS PLACE OPEN TO THE PUBLIC INSPECTION UNTIL THE COMPLETION OF THE WORK OR THE USE AND THE OPERATION OF THE EQUIPMENT OR UNTIL THE EXPIRATION OF THE PERMIT.
- DRAWINGS ARE NOT TO BE SCALED. USE DIMENSIONS ONLY. ALL DIMENSIONS AND CONDITIONS SHOWN ON THE DRAWINGS MUST BE VERIFIED AT THE SITE BEFORE ORDERING ANY MATERIAL OR DOING ANY WORK. WHERE DISCREPANCIES OCCUR AND/OR WHERE THERE ARE CONFLICTS OR OMISSIONS IN THE DRAWINGS, SPECIFICATIONS AND APPLICATIONS, THE CONTRACTOR SHALL NOTIFY THE ARCHITECT IMMEDIATELY AND REFRAIN FROM STARTING AND COMPLETING SUCH WORK, OR DEPENDENT WORK, UNTIL DIRECTED BY ARCHITECT TO PROCEED. NO CHANGE IN DRAWINGS OR SPECIFICATIONS IS PERMISSIBLE WITHOUT THE WRITTEN CONSENT OF THE ARCHITECT.
- EXTERIOR DIMENSIONS ARE TO THE FACE OF STRUCTURE UNLESS OTHERWISE NOTED.
- 7. MECHANICAL AND ELECTRICAL INDICATIONS ON ARCHITECTURAL DRAWINGS ARE FOR LOCATION PURPOSES ONLY.
- 8. THE HARDWARE AND FIXTURES SHOWN IN DRAWINGS IS FOR GRAPHIC PURPOSES ONLY. REFER TO THE FINISH HARDWARE SCHEDULE IN SPECIFICATIONS.
- 9. ADDITIONAL NOTES APPLICABLE TO THIS PROJECT MAY BE FOUND THROUGHOUT THE CONSTRUCTION DOCUMENTS.
- 10. WHERE MANUFACTURER'S NAMES AND PRODUCT NUMBERS ARE INDICATED ON THE DRAWINGS IT SHALL BE CONSTRUED TO MEAN THE ESTABLISHING OF QUALITY AND PERFORMANCE STANDARDS OF SUCH ITEMS. ALL PRODUCTS MUST BE SUBMITTED TO THE ARCHITECT FOR REVIEW AND APPROVAL BEFORE THEY SHALL BE DEEMED FOLIAL
- 11. THE WORD "PROVIDE" MEANS TO FURNISH AND INSTALL NEW ITEM(S) AND/OR SYSTEM(S).
- CONTRACTOR SHALL KEEP WORK SITE FREE FROM DEBRIS AND ACCUMULATED REFUSE, AND SHALL HAVE SOLE RESPONSIBILITY FOR PROTECTING ALL DANGEROUS AREAS FROM ENTRY BY UNAUTHORIZED PARTIES. SITE WILL BE LEFT BROOM CLEAN AT THE END OF EACH WORKING DAY.
- 13. UNLESS OTHERWISE SHOWN ON THE CONTRACT DRAWINGS, REMOVE DEBRIS FROM THE CONSTRUCTION SITE AND DISPOSE OF DEBRIS, RUBBISH AND OTHER MATERIALS RESULTING FROM ALL CONSTRUCTION OPERATIONS.
- 14. CONTRACTOR SHALL BE RESPONSIBLE FOR ADEQUATELY BRACING AND PROTECTING WORK AGAINST DAMAGE, BREAKAGE, COLLAPSE, DISTORTIONS, AND OFF ALIGNMENTS ACCORDING TO CODES AND STANDARDS OF GOOD PRACTICE.
- 15. CONTRACTOR SHALL LAY OUT HIS OWN WORK, AND SHALL PROVIDE ALL DIMENSIONS REQUIRED FOR OTHER TRADES.
- 16. CONTRACTOR SHALL PERFORM ALL CUTTING AND PATCHING REQUIRED TO COMPLETE THE WORK OR TO MAKE ITS PARTS FIT TOGETHER PROPERLY WITH ADJACENT CONSTRUCTION WITHOUT COMPROMISING THE QUALITY OF THE WORK.
- 17. CONTRACTOR SHALL PATCH AND REPAIR FLOORS, WALLS CEILINGS, ETC., DAMAGED OR EXPOSED DUE TO MEP WORK AND FINISH TO MATCH ADJOINING SURFACES TO THE SATISFACTION OF THE ARCHITECT AND OWNER. COORDINATE WORK WITH MEP DRAWINGS.
- 18. WORK SHALL BE INSTALLED SO THAT ALL PARTS REQUIRED ARE READILY ACCESSIBLE FOR INSPECTION, OPERATION, MAINTENANCE AND REPAIR.
- CONTRACTOR SHALL BE RESPONSIBLE FOR COORDINATING ALL ASPECTS OF WORK UNDER THIS CONTRACT IN ORDER TO ENSURE THE QUALITY AND TIMELY COMPLETION OF THE WORK.
- 20. CONTRACTOR SHALL GUARANTEE MATERIALS AND WORKMANSHIP IN THIS CONTRACT FOR A PERIOD OF 1 (ONE) YEAR FOLLOWING ARCHITECT'S CERTIFICATION OF SUBSTANTIAL COMPLETION, AND SHALL REMEDY ANY DEFECTS IN SUCH WORK THAT ARISE DURING THAT TIME AT NO COST TO THE OWNER.
- 21. CONTRACTOR SHALL PROVIDE CONCEALED BLOCKING AND/OR GROUNDS WHERE REQUIRED BY NEW CONSTRUCTION AND OWNER SUPPLIED FURNISHINGS AND EQUIPMENT.
- 22. FIRE STOPPING IS REQUIRED AT ALL WALL, FLOOR AND CEILING PENETRATIONS. FIRE STOPPING SHALL MEET THE REQUIRED FIRE RATING OF THE CONSTRUCTION.
- 23. CONTRACTOR'S EQUIPMENT AND MATERIALS TO REMAIN ON SITE DURING THE COURSE OF WORK SHALL AT THE END OF EACH DAY BE STORED IN THE PROVIDED STAGING AREA.

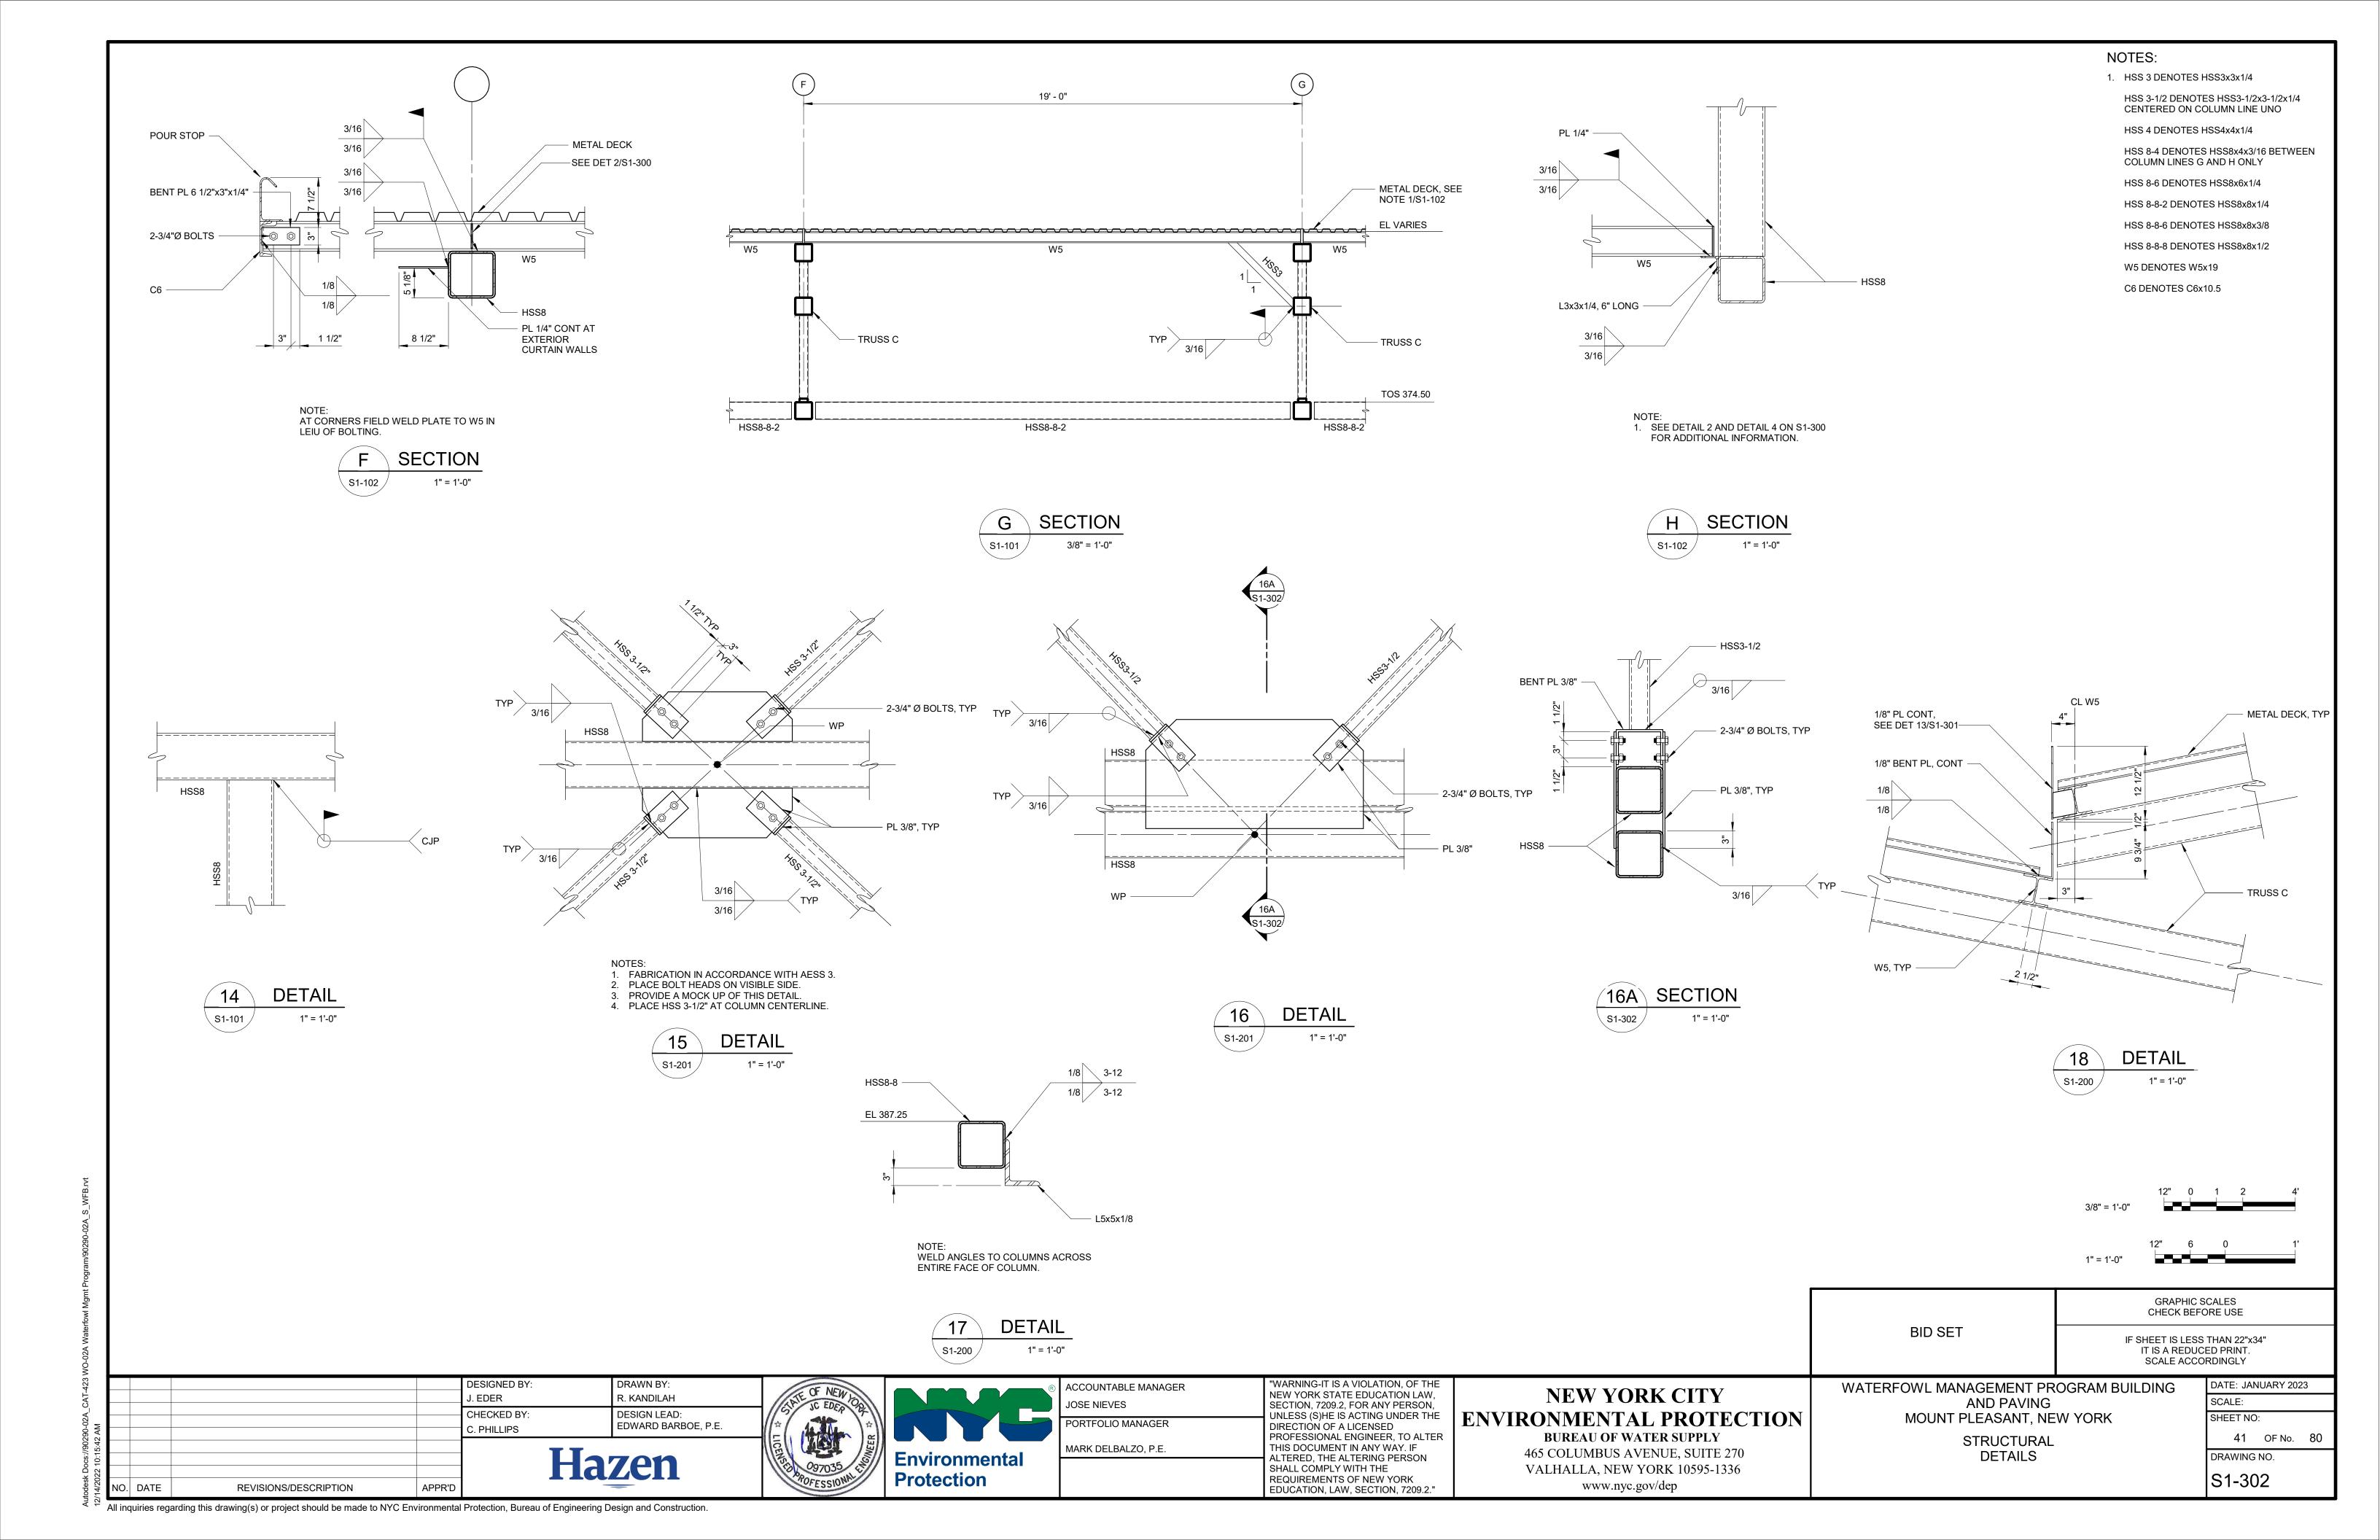
# **ARCHITECTURAL ABBREVIATIONS**

"A"		"G"		"P"	
& @	AND AT	GA GALV	GAGE / GAUGE GALVANIZED	PAR PART.	PARALLEL PARTITION
<i>₩</i> AB	ANCHOR BOLTS	GALV	GRADE BEAM / GRAB BAR	PERF	PERFORATED
\BR	ABRASIVE	GL	GLASS	PF	PURGE FAN
ACT	ACOUSTICAL CEILING TILE	GR	GRADE	PJ	PANEL JOINT
ADD'L	ADDITIONAL	GRD	GROUND	PL	PLATE
ADJ	ADJUSTABLE	GS CV#	GALVANIZED STEEL	PLWD	PLYWOOD
AFF ALT	ABOVE FINISHED FLOOR ALTERNATE	GVL GWB	GRAVEL GYPSUM WALL BOARD	PLUMB. PNL	PLUMBING PANEL
LUM	ALUMINUM	GWB	GTF30W WALL BOARD	PR	PAIR
APPD	APPROVED			PRE	POWER ROOF EXHAUSTER
ARRROX	APPROXIMATE	"H"		PREFAB	PREFABRICATED
ARCH	ARCHITECTURAL	НВ	HOSE BIBB	PREFIN	PRE FINISHED
ASPH	ASPHALT	HD	HEAD	PRI PRMLD	PRIMARY PRE MOLDED
B"		HDW	HARDWARE	P.T.	PRESSURE TREATED
		HGT	HEIGHT	PT	PAINT / PAINTED
B OR BOT B/ OR BO	BOTTOM BOTTOM OF	HM HMD	HOLLOW METAL HOLLOW METAL DOOR	PVC	POLYVINYL CHLORIDE
3D	BOARD	HMF	HOLLOW METAL FRAME	PVT	PAVEMENT
BFF	BELOW FINISHED FLOOR	HORIZ	HORIZONTAL	PWE "Q"	POWER WALL EXHAUSTER
3IT	BITUMINOUS	HP	HIGH POINT		
BLDG	BUILDING	HVAC	HEATING, VENTILATING AND AIR CONDITIONING	QUAL	QUALITY
BLK BM	BLOCK / BLOCKING BEAM		AIR CONDITIONING	QTY	QUANTITY
BOD	BOTTOM OF DUCT				
BOL	BOTTOM OF LOUVER	" "		"R"	
BOP	BOTTOM OF PIPE		MOIDE 54.05	DAD	DADILIS
BRG	BEARING	I.F. INCL	INSIDE FACE	RAD RB	RADIUS ROOF BEAM
		INCL IND	INCLUDED / INCLUDING INDUSTRIAL	RD	ROOF DRAIN
'C"		INFO	INFORMATION	RECT	RECTANGLE / RECTANGULA
J		INSUL	INSULATION / INSULATED	REF	REFERENCE
CJ	CONTROL JOINT	INT	INTERIOR	REINF	REINFORCE
CANTIL	CANTILEVER	INV	INVERT	REQ'D REV	REQUIRED REVISION / REVISED
CEM	CEMENT			RFG	ROOFING
CHAN CHEM	CHANNEL CHEMICAL RESISTANT	"J"		RM	ROOM
CL	CENTERLINE	-		RO	ROUGH OPENING
CLG	CEILING	JST	JOIST	<b></b>	
CLR	CLEAR	JT	JOINT	"S"	
CMU	CONCRETE MASONRY			S	SOUTH
COL COMBO	UNITS COLUMN COMBINATION	"K"		S/C	SITE/CIVIL
CONC	CONCRETE	1.75	101001/ 501111	SCH	SCHEDULE
CONST	CONSTRUCTION	KD	KNOCK DOWN	SEC	SECOND
CONST JT		KFS KFT	KIPS PER SQUARE FOOT KIP FOOT	SECT	SECTION SOLIABE FOOT
CONT	CONTINUE /	KP	KICK PLATE	SF SIM	SQUARE FOOT SIMILAR
CONT'D CONTR	CONTINUOUS CONTINUED CONTRACT / CONTRACTOR			SHT	SHEET
COORD	COORDINATE	"L"		SIM REV	SIMILAR REVERSED
CORR	CORRIDOR			SJ	STEEL JOIST
CORRUG	CORRUGATED	L	ANGLE	SPEC	SPECIFICATION
CSK CSKSCR	COUNTERSINK COUNTERSUNK SCREW	LAM LB	LAMINATE POUND	SQ SS	SQUARE STAINLESS STEEL
CTR	COUNTERSUNK SCREW CENTER	LB LBS	POUNDS	STA	STATION
'D"		LF	LINEAR FEET	STD	STANDARD
ט		LG	LENGTH / LONG	STIFF	STIFFENER
DEG	DEGREE	LLH	LONG LEG HORIZONTAL	STL	STEEL
DET	DETAIL	LLV	LONG LEG VERTICAL	STOR STRU	STORAGE STRUCTURE / STRUCTURA
DEMO	DEMOLISH / DEMOLITION	LP LV	LOW POINT LOUVER	SUSP	SUSPEND / SUSPENDED
DIA	DIAMETER PLACE AND ADDRESS OF THE PROPERTY OF	∟V	LOUVER	SYM	SYMMETRICAL / SYMMETRI
DIAG	DIAGONAL / DIAGRAM				
DIM DIV	DIMENSION DIVISION	"M"		"T"	
DL DL	DEAD LOAD	MAN.	MANUAL	Т	TOP
N	DOWN	MAN. MATL	MANUAL MATERIAL	T/ OR T.O.	TOP OF
)R	DOOR	MAX	MAXIMUM	TBD	TO BE DETERMINED
DWG	DRAWING	MCP	METAL CLAD PANEL	TEMP	TEMPERATURE
DWL	DOWEL	MD	METAL DECK	TH THRD	THICK THREAD / THREADED
E"		MECH MET	MECHANICAL METAL	TOB	TOP OF BLOCK
-		MFG	METAL MANUFACTURING	TOD	TOP OF DUCT
EL	EXPANSION JOINT	MFR	MANUFACTURER	TOF	TOP OF FOOTING
EA -	EACH	MIN	MINIMUM	TOL	TOP OF SLAP / TOP OF STE
EF EL	EACH FACE ELEVATION	MISC	MISCELLANEOUS	TOS TOT	TOP OF SLAB / TOP OF STE
ELEC	ELECTRIC / ELECTRICAL	MOD MP	MODIFICATION METAL PANEL	TOW	TOP OF WALL
ENGR	ENGINEER	MP MS	METAL PANEL METAL STUD	TYP	TYPICAL
ΕP	ESCAPE PIPING	MTD	MOUNTED		
EQ.	EQUAL	MTL	METAL	"∪"	
EQUIP EQUIV	EQUIPMENT FOLINALENT			LION	LINI ESS OTHERWISE NOTE
EQUIV ES	EQUIVALENT EXPOSED STRUCTURE	"N"		UON U/S	UNLESS OTHERWISE NOTE UNDERSIDE
EW	EACH WAY	N	NORTH	0/0	OHDEINOIDE
EXC	EXCAVATION	N N/A	NOT APPLICABLE	" <b>\</b> "	
EXF	EXHAUST FAN	NC	NOT AFFEICABLE NON COMBUSTIBLE	<del>-</del>	
EXS	EXHAUST STACK	NF	NEAR FACE	VCT	VINYL COMPOSITION TILE
EXH EXP STR	EXHAUST EXPOSED STRUCTURE	NIC OF "	NOT IN CONTRACT	VERT	VENT DIDE
	EXPOSED STRUCTURE EX EXISTING	NO. OR #	NUMBER	VP	VENT PIPE
EXP	EXPANSION / EXPOSED	NOM NS	NOMINAL NEAR SIDE	"W"	
EXT	EXTERIOR	NTS	NOT TO SCALE	v v	
<b>-</b> "		. =		W/O	WITHOUT
F"		"O"		W/	WITH
FAC	FACTORY			W	WEST
-AC -D	FLOOR DRAIN / FOOTING DRAIN	OC	ON CENTER	WD WF	WOOD WATER FOUNTAIN
_	FOUNDATION	O.F.	OUTSIDE FACE	WF WLD	WATER FOUNTAIN WELD / WELDED
		OH	OVERHEAD OPENING	WP	WATER PROOFING
FDN FE	FIRE EXTINGUISHER	( )PN(:	OPENING	-	· · · · · -
FDN FE FF	FACTORY FINISH	OPNG OPP	OPPOSITE	WT	WEIGHT
FDN FE FF FFE	FACTORY FINISH FINISH FLOOR ELEVATION				WEIGHT
FDN FE	FACTORY FINISH				WEIGHT

### ARCHITECTURAL GRAPHIC CONVENTIONS




## **ARCHITECTURAL SYMBOLS**

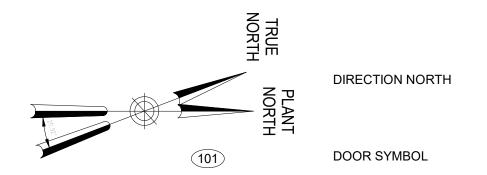

Room name
ROOM NAME AND ROOM NUMBER

DATUM

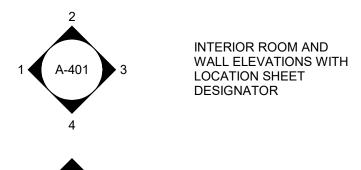

A1-401

**EXTERIOR ELEVATIONS** 

FIRE EXTINGUISHER

SECTION CUT

DETAIL INDICATOR

1
A-5

A STRUCTURAL COLUMN OR BUILDING LINES; GRID LINES AND INDICATOR

BID SET

GRAPHIC SCALES
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SCALE ACCORDINGLY

WATERFOWL MANAGEMENT PROGRAM BUILDING
AND PAVING

MOUNT PLEASANT, NEW YORK

ARCHITECTURAL
GENERAL NOTES AND SYMBOLS

DATE: JANUARY 2023			
SCALE:			
SHEET NO	):		
42	OF No.	80	
DRAWING NO.			
A0-001			

GoshowArchitects
20 W 22nd St, Suite 901 | New York, NY 10010
P 212.242.3735

DESIGNED BY:
J. HYUN
S. KINARD

CHECKED BY:
E. CLAASSEN

CHAVE BY:
E. CLAASSEN

CHECKED BY:
EDWARD BARBOE, P.E.



FS

FT

FTG

FEET

FOOTING

FLUE STACK

FIELD VERIFY

FL OR FLR FLOOR

R ACCOUNTABLE MANAGER
JOSE NIEVES

PORTFOLIO MANAGER
MARK DELBALZO, P.E.

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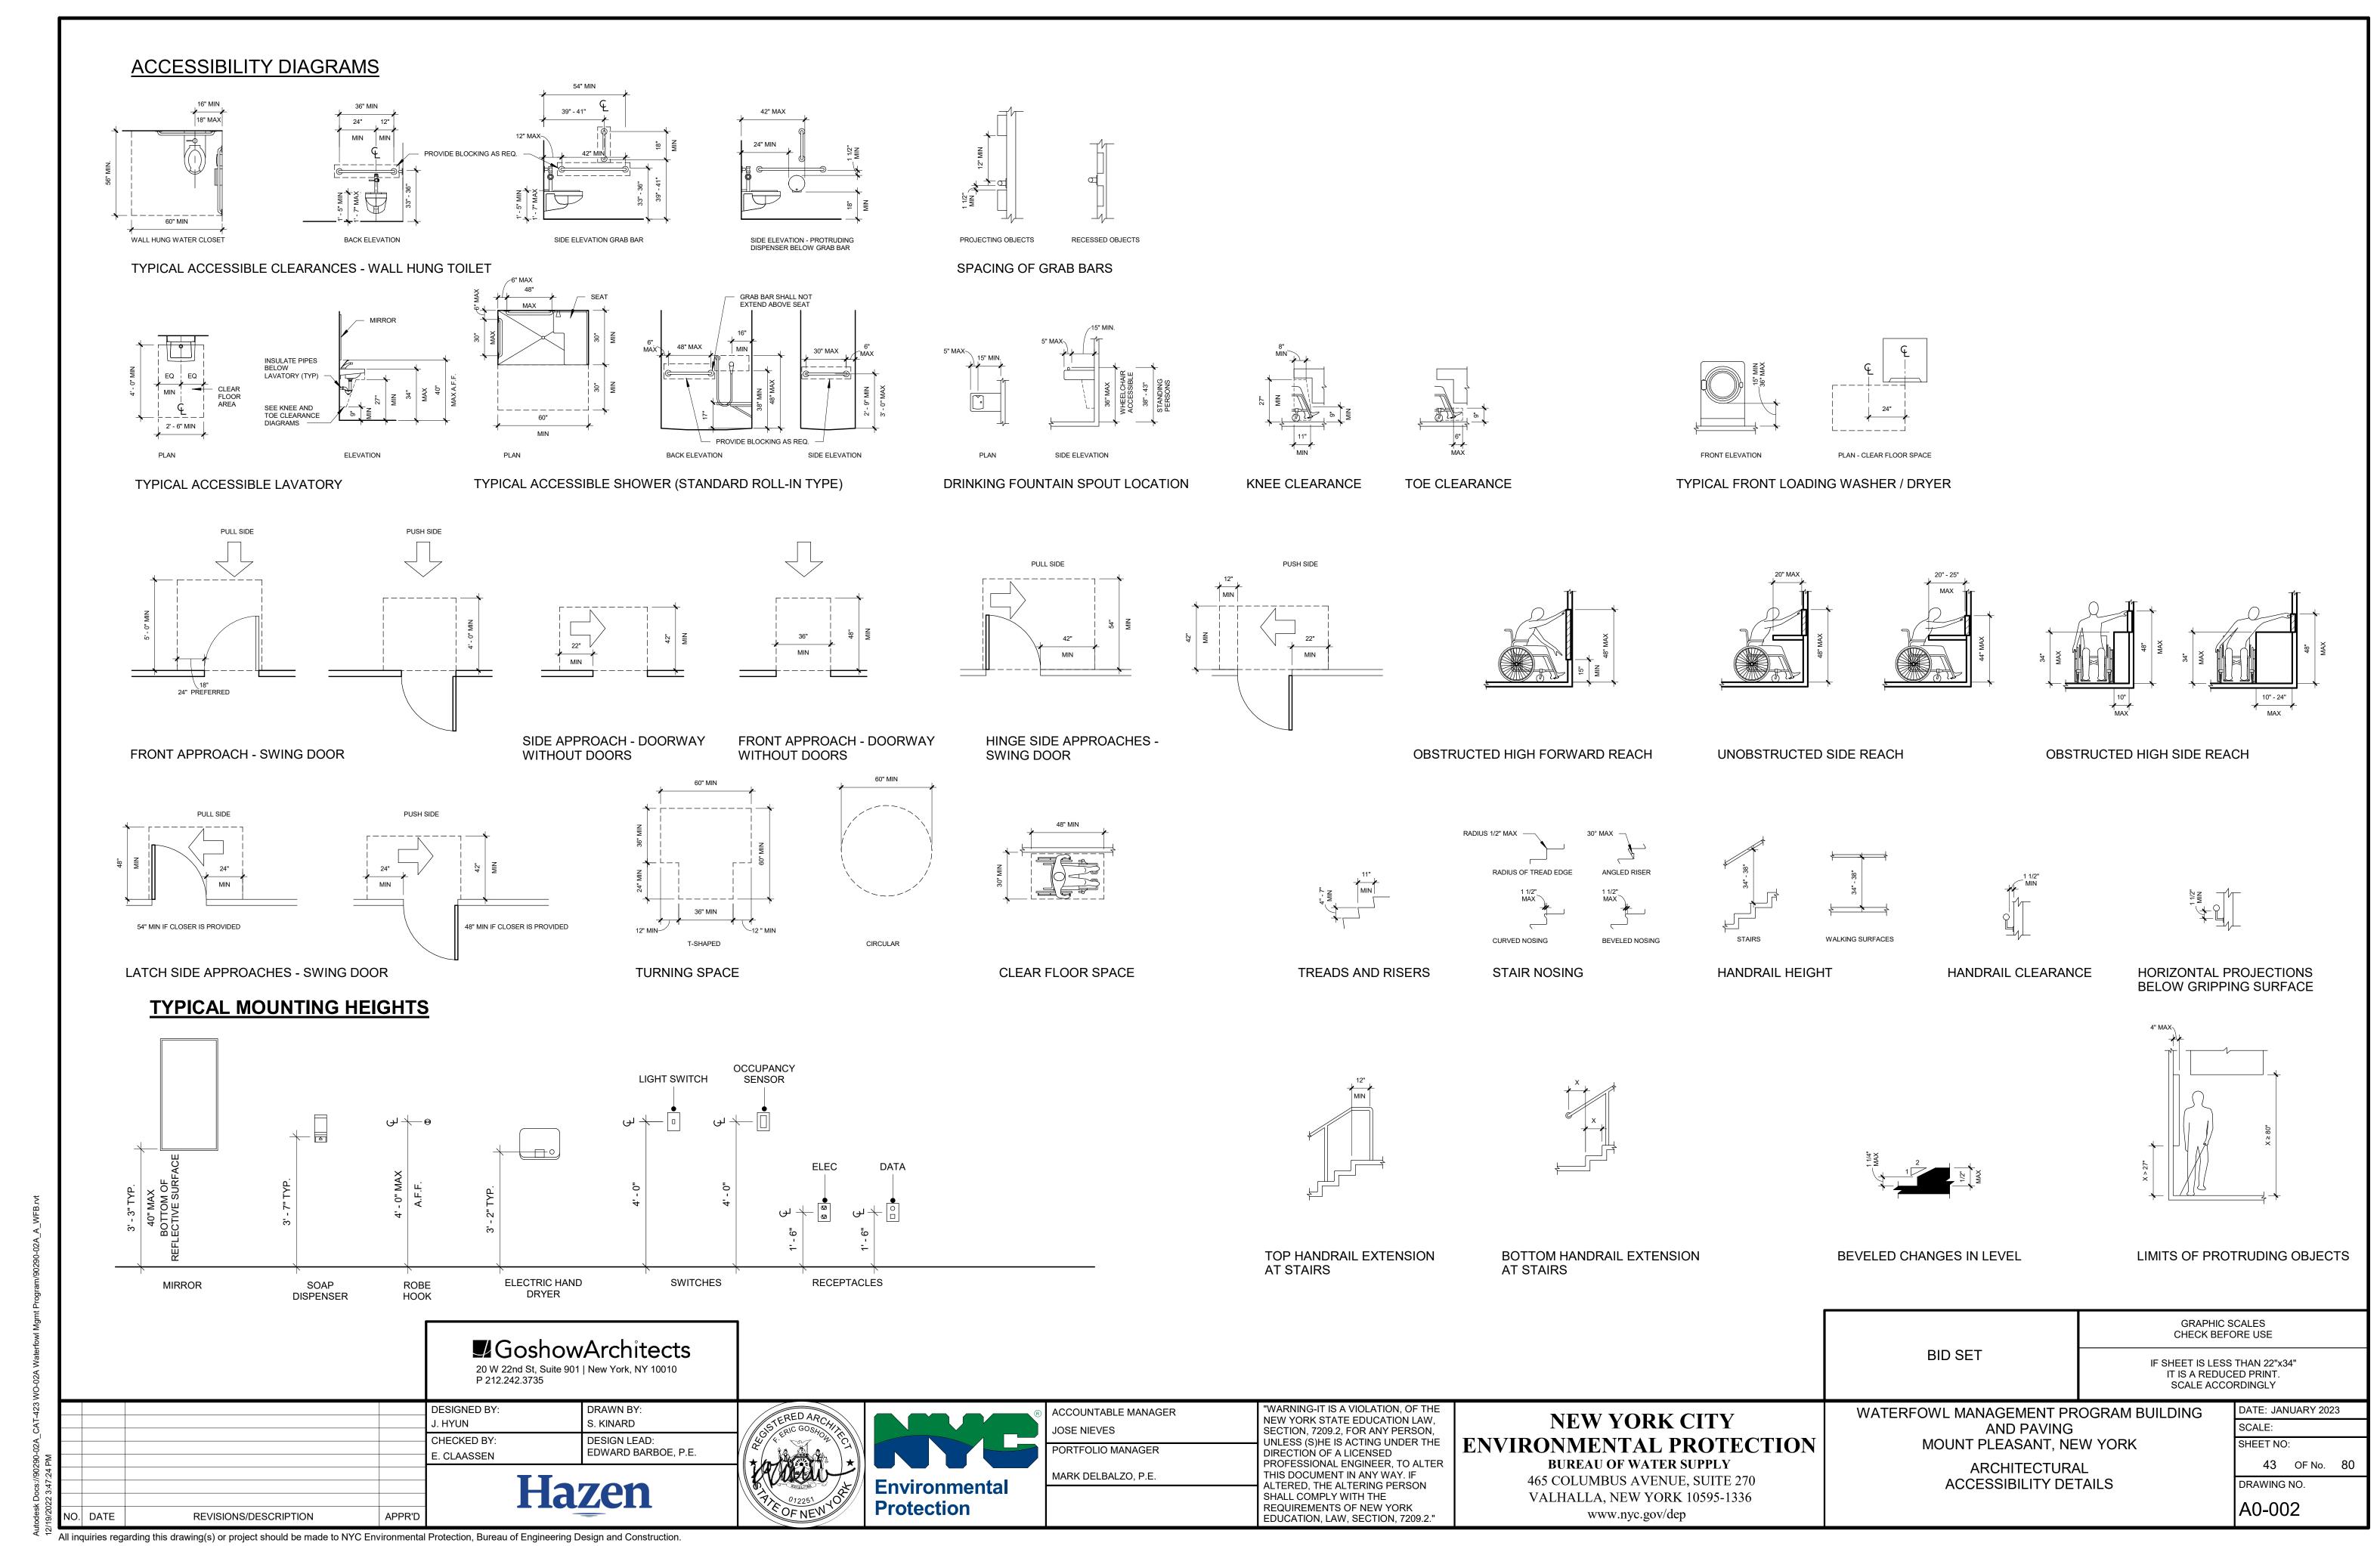
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NEW YORK CITY ENVIRONMENTAL PROTECTION

BUREAU OF WATER SUPPLY
465 COLUMBUS AVENUE, SUITE 270
VALHALLA, NEW YORK 10595-1336
www.nyc.gov/dep

REVISIONS/DESCRIPTION

NO. DATE



VITH THE 2017 NEW YORK STATE UNIFORM CODE SUPPLEMENT		
CODE REFERENCE	REQUIREMENT	PROVIDED
JSE AND OCCUPANCY CLASSIFICATION / CHAPTER 3		
DCCUPANCY CLASSIFICATION NYSBC-302		MIXED OCCUPANCY: GROUP B - BUSINESS GROUP S-1 - MODERATE HAZARD STORAGE GROUP S-2 - LOW HAZARD STORAGE
SPECIAL DETAILED REQUIREMENTS BASED ON USE AND OCCUPANCY / CHAPTER 4		
CONTROL AREAS / NYSBC TABLE 414.2.2		
	FLOOR LEVEL ABOVE GRADE PLANE 1	FLOOR LEVEL ABOVE GRADE PLANE 1
14.2.1 CONSTRUCTION REQUIREMENTS	FLOOR 0 HR (IIB: NYSBC 601) ROOF 0 HR (IIB: NYSBC 601) FIRE BARRIER SEE 414.2.4 BELOW	FLOOR 0 HR (IIB: NYSBC 601) ROOF 0 HR (IIB: NYSBC 601) FIRE BARRIER SEE 414.2.4 BELOW
14.2.2 PERCENTAGE OF MAXIMUM ALLOWABLE QUANITY	PERCENTAGE PER 100% CONTROL AREA	PERCENTAGE PER 100% CONTROL AREA
14.2.3 NUMBER	NUMBER OF CONTROL 4 AREAS PER FLOOR	NUMBER OF CONTROL 2 AREAS PER FLOOR
14.2.4 FIRE-RESTISTANCE-RATING REQUIREMENTS	FIRE RESISTANCE RATING 1 HOUR RATING FOR FIRE BARRIER	FIRE RESISTANCE RATING 1 HOUR RATING FOR FIRE BARRIER
ENERAL BUILDING HEIGHTS AND AREAS / CHAPTER 5		
LLOWABLE HEIGHT ABOVE GRADE PLANE / NYSBC-TABLE 504.3		
NYSBC 504.2 MIXED OCCUPANCY. IN A BUILDING CONTAINING MIXED OCCUPANCIES IN ACCORDANCE WITH SECTION 508, NO INDIVIDUAL OCCUPANCY SHALL EXCEED THE HEIGHT AND NUMBER OF STORY LIMITS SPECIFIED IN THIS SECTION FOR THE APPLICABLE OCCUPANCIES.	TYPE IIB, NON-SPRINKLERED GROUP B: 55 FEET GROUP S: 55 FEET	TYPE IIB, NON-SPRINKLERED  22 FEET
ALLOWABLE NUMBER OF STORIES ABOVE GRADE PLANE / NYSBC-TABLE 504.4		
NYSBC 504.2 MIXED OCCUPANCY. IN A BUILDING CONTAINING MIXED OCCUPANCIES IN ACCORDANCE WITH SECTION 508, NO INDIVIDUAL OCCUPANCY SHALL EXCEED THE HEIGHT AND NUMBER OF STORY LIMITS SPECIFIED IN THIS SECTION FOR THE APPLICABLE OCCUPANCIES.	TYPE IIB, NON-SPRINKLERED GROUP B: 3 STORIES GROUP S-1: 2 STORIES GROUP S-2: 3 STORIES	TYPE IIB, NON-SPRINKLERED  1 STORY
ALLOWABLE AREA FACTOR / NYSBC-TABLE 506.2		
	TYPE IIB, NON-SPRINKLERED GROUP B: 23,000 SF GROUP S-1: 17,500 SF GROUP S-2: 26,000 SF	TYPE IIB, NON-SPRINKLERED GROUP B: 1,831 SF GROUP S-1: 146 SF GROUP S-2: 2,051 SF
MIXED USE AND OCCUPANCY / NYSBC-SECTION 508		
NYSBC 508.3 NONSEPARATED OCCUPANCIES SHALL BE INDIVIDUALLY CLASSIFIED IN ACCORDANCE WITH SECTION 302.1. THE REQUIREMENTS OF THIS CODE SHALL APPLY TO EACH PORTION OF THE BUILDING BASED ON THE OCCUPANCY CLASSIFICATION OF THAT SPACE. IN ADDITION, THE MOST RESTRICTIVE PROVISIONS OF CHAPTER 9 THAT APPLY TO THE NONSEPARATED OCCUPANCIES SHALL APPLY TO THE TOTAL NONSEPARATED OCCUPANCY AREA.		
YPES OF CONSTRUCTION / CHAPTER 6		1
IRE-RESISTANCE RATING REQUIREMENTS FOR BUILDING ELEMENTS / NYSBC-TABLE 601	TYPE IIB - NONCOMBUSTIBLE	TYPE IIB - NONCOMBUSTIBLE
RIMARY STRUCTURAL FRAME	FIRE RESISTANCE (0) HOURS	FIRE RESISTANCE (0) HOURS
	(0) 110010	(0)11001(3
EARING WALLS XTERIOR ITERIOR	(0) HOURS (0) HOURS	(0) HOURS (0) HOURS
IONBEARING WALLS AND PARTITIONS EXTERIOR NTERIOR	(0) HOURS (0) HOURS	(0) HOURS (0, 1) HOURS
LOOR CONSTRUCTION	(0) HOURS	(0) HOURS
OOF CONSTRUCTION	(0) HOURS	(0) HOURS
ITERIOR FINISHES / CHAPTER 8		
	NON-SPRINKLERED	NON-SPRINKLERED
03.13	GROUP B: CLASS A	CLASS A
NTERIOR EXIT STAIRWAYS AND RAMPS AND EXIT PASSAGEWAYS	GROUP S: CLASS B	
CORRIDORS AND ENCLOSURE FOR EXIT ACCESS STAIRWAYS AND RAMPS	GROUPS B, S: CLASS B	CLASS B
OOMS AND ENCLOSED SPACES	GROUPS B, S: CLASS C	CLASS C
IRE PROTECTION SYSTEMS / CHAPTER 9		1
UTOMATIC SPRINKLER SYSTEMS / NYSBC 903.2		
GROUP B - NOT REQUIRED) 03.2.9 GROUP S-1 GROUP S-2 - NOT REQUIRED) GROUP U - NOT REQUIRED)	REQUIRED WHERE S-1 FIRE AREA EXCEEDS 12,000 SF; OR IS LOCATED MORE THAN THREE STORIES ABOVE GRADE PLANE	NOT REQUIRED
MEANS OF EGRESS / CHAPTER 10	2701112712072 OIVIDET LANE	<u> </u>
OCCUPANT LOAD / NYSBC TABLE 1004.5		
BUSINESS AREAS 150 GROSS ACCESSORY STORAGE / MECH 300 GROSS ASSEMBLY UNCONCENTRATED 15 NET	AREAS WITH DIRECT EXIT TO EXTERIOR: FUEL STORAGE S-1 OUTDOOR STORAGE S-2 MECH. ROOM S-2 BOAT WASH S-2	88 SF / 300 1 OCC 77 SF / 300 1 OCC 133 SF / 300 1 OCC 1014 SF / 300 4 OCC
	AREAS WITH INTERIOR EGRESS:  BUSINESS B  BUSINESS (BREAK RM) B  PYRO. STORAGE S-1  WORKSHOP S-2  LAUNDRY / PPE S-2	1584 SF / 150

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CODE REFERENCE	REQUIREMENT	PROVIDED
MEANS OF EGRESS SIZING / NYSBC-SECTION 1005		
STAIRWAYS	0.3" / OCC (0.3" X 59 OCC = 18") 44" MINIMUM (NYSBC 1011.2)	6'-0" WIDTH
OTHER EGRESS COMPONENTS	0.2" / OCC (0.2" X 59 = 12") DOORS - 32" MIN. CLEAR (IBC 1010.1.1) CORRIDORS - 44" MIN. (NYSBC TABLE 1020.2)	32" MIN. CLEAR 54" MIN.
MINIMUM NUMBER OF EXITS / NYSBC-SECTION 1006		
NYSBC 1006.3.3.1 MIXED OCCUPANCIES IN EACH STORY OF A MIXED OCCUPANCY BUILDING, THE MAXIMUM NUMBER OF OCCUPANTS SERVED BY A SINGLE EXIT SHALL BE SUCH THAT THE SUM OF THE RATIOS OF THE CALCULATED NUMBER OF OCCUPANTS OF THE SPACE DIVIDED BY THE ALLOWABLE NUMBER OF OCCUPANTS INDICATED IN TABLE 1006.3.3(2)	STORIES WITH ONE EXIT: TABLE 1006.3.3(2) B - 49 OCCUPANTS MAX S - 29 OCCUPANTS MAX	B - CALCULATED / ALLOWABLE 28 OCC / 49 OCC = 0.57 S - CALCULATED / ALLOWABLE 5 OCC / 29 OCC = 0.17 0.57 + 0.17 = 0.74  0.74< 1.0 ONE EXIT REQUIRED
MAXIMUM COMMON PATH OF EGRESS TRAVEL / NYSBC-TABLE 1006.3.3(2)		
	B - 75 FEET MAX S - 75 FEET MAX	65 FEET
EXIT ACCESS TRAVEL DISTANCE / NYSBC-TABLE 1017.2		
	B, S-1 - 200 FEET MAX S-2 - 300 FEET MAX	115 FEET

## **ENERGY CODE COMPLIANCE NOTES**

#### REFERENCED CODES:

2020 NEW YORK STATE ENERGY CONSERVATION CODE (NYCECC)

• ASHRAE 90.1-2013

CLIMATE ZONE: 4A (NYSECC C301.1)

OPAQUE THERMAL ENVELOPE INSULATION COMPONENT MINIMUM REQUIREMENTS (NYSECC TABLE C402.1.3)

INSULATION ENTIRELY ABOVE ROOF DECK

METAL FRAMED

ROOFS R-30 ci WALLS, ABOVE GRADE R-13 + R-7.5ci

WALLS, BELOW GRADE R-7.5 ci R-10 ci SLAB-ON-GRADE R-10, 24" UNHEATED SLAB


BUILDING ENVELOPE FENESTRATION MAXIMUM U-FACTOR AND SHGC REQUIREMENTS (NYSECC TABLE C402.4)

SEE SPECIFICATION SECTION 08800

PROFESSIONAL STATEMENT:

TO THE BEST OF MY KNOWLEDGE, BELIEF, AND PROFESSIONAL JUDGEMENT, THE SUBMITTED PLANS AND SPECIFICATIONS ARE IN COMPLIANCE WITH THE 'ENERGY CODE.'

TO ALL PLANS, SPECIFICATIONS, AND REPORTS TO WHICH THE SEAL OF AN ARCHITECT HAS BEEN APPLIED, THERE SHALL ALSO BE APPLIED A STAMP WITH APPROPRIATE WORDING WARNING THAT IT IS A VIOLATION OF THE LAW FOR ANY PERSON, UNLESS ACTING UNDER THE DIRECTION OF A LICENSED ARCHITECT, TO ALTER AN ITEM IN ANY WAY. IF AN ITEM BEARING THE SEAL OF AN ARCHITECT IS ALTERED, THE ALTERING ARCHITECT SHALL AFFIX TO HIS ITEM THE SEAL AND THE NOTATION "ALTERED BY" FOLLOWED BY HIS SIGNATURE AND THE DATE OF SUCH ALTERATION, AND A SPECIFIC DESCRIPTION OF THE ALTERATION.

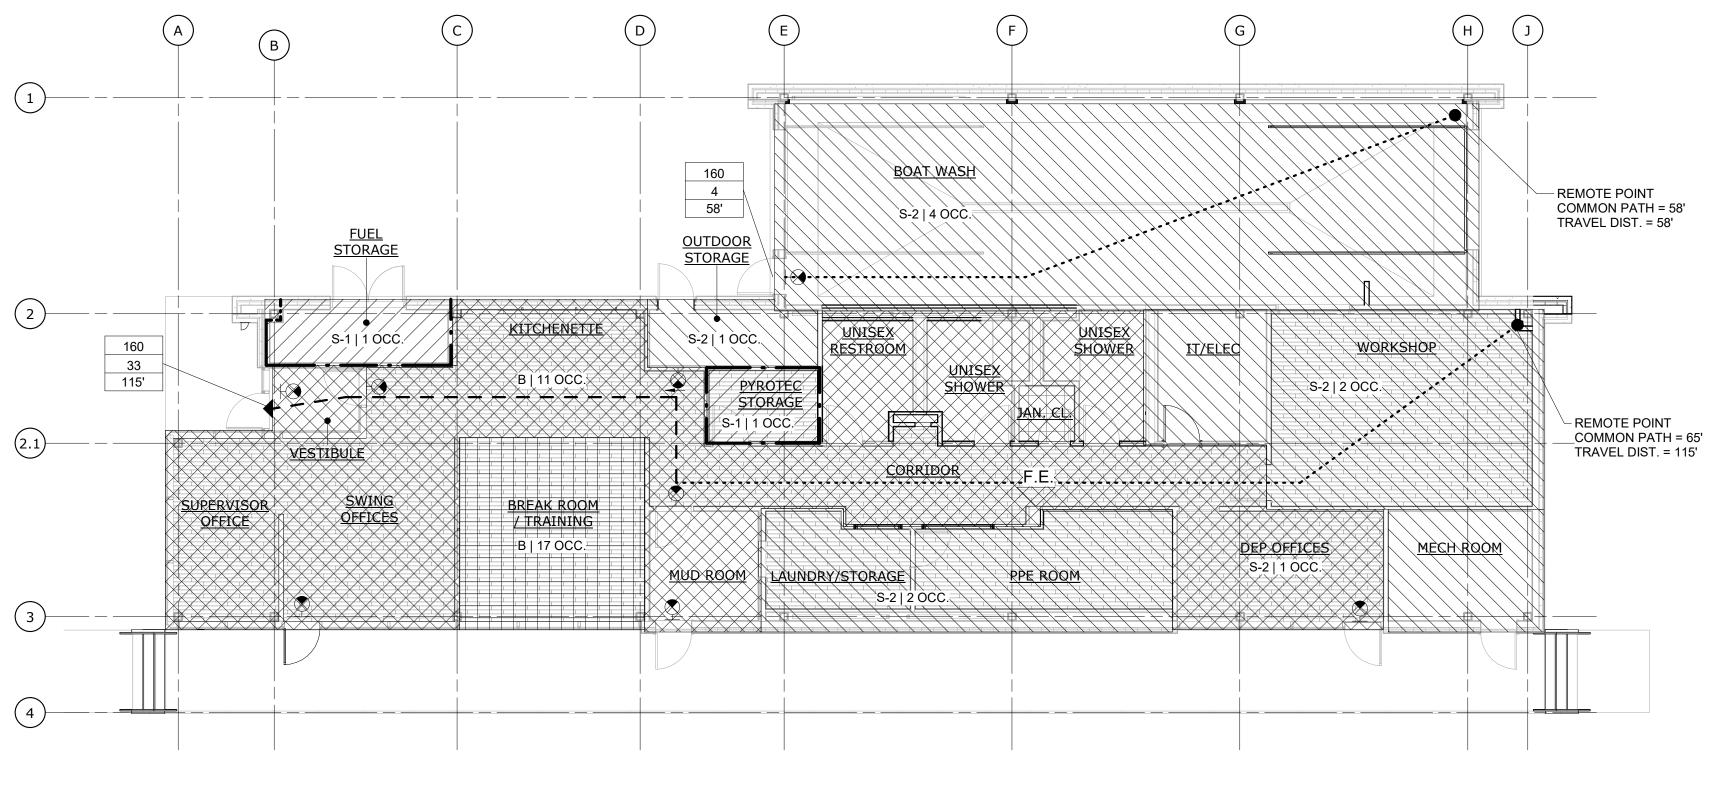

CODE ANALYSIS PLAN SCALE: 1/8" = 1'-0"

### <u>LEGEND</u>

1 HR FIRE RATING COMMON PATH OF EGRESS TRAVEL

EGRESS PATH TRAVEL DISTANCE

**EXIT SIGN** 

XXX — ALLOWABLE OCCUPANTS

XXX — CALCULATED OCCUPANTS XXX TRAVEL DISTANCE

FIRE EXTINGUISHER

B OCCUPANCY 150 SF GROSS

S-2 OCCUPANCY 300 SF GROSS

B OCCUPANCY 15 SF NET

S-1 OCCUPANCY 300 SF GROSS

GRAPHIC SCALES CHECK BEFORE USE **BID SET** 

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P 212.242.3735 DESIGNED BY: DRAWN BY: J. HYUN S. KINARD CHECKED BY: DESIGN LEAD: EDWARD BARBOE, P.E. E. CLAASSEN Hazen

NO. DATE

REVISIONS/DESCRIPTION



ACCOUNTABLE MANAGER JOSE NIEVES PORTFOLIO MANAGER MARK DELBALZO, P.E.

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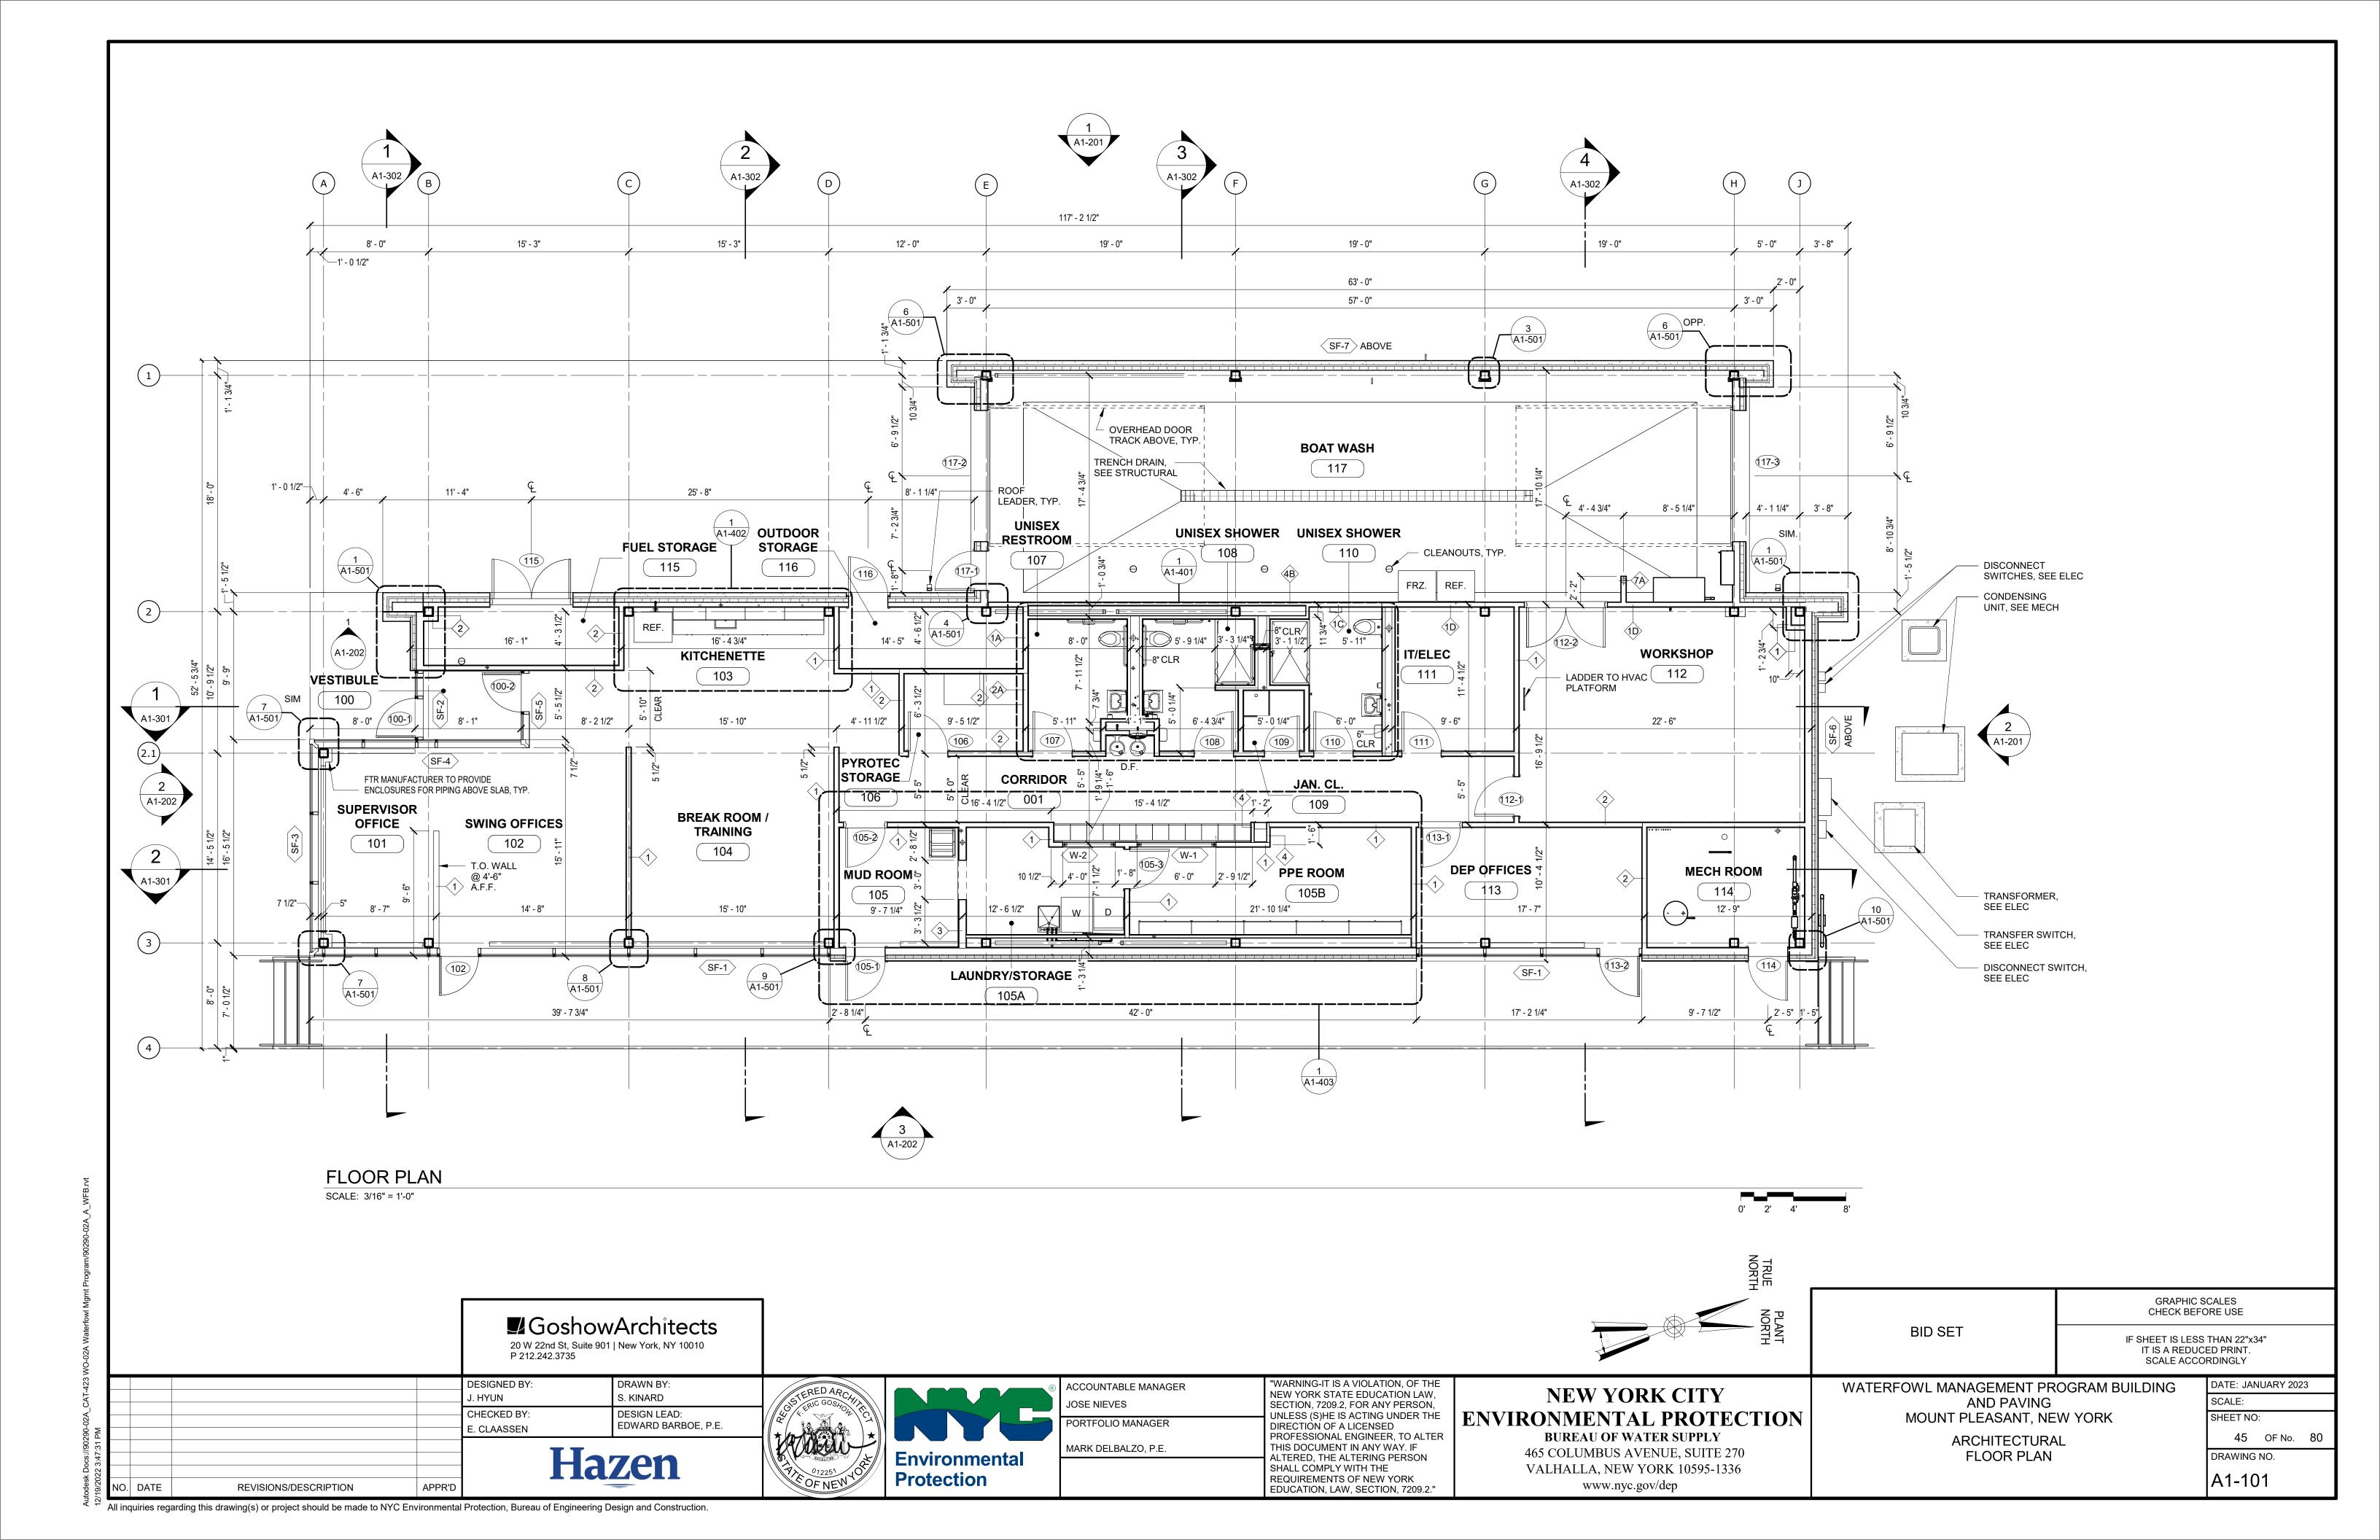
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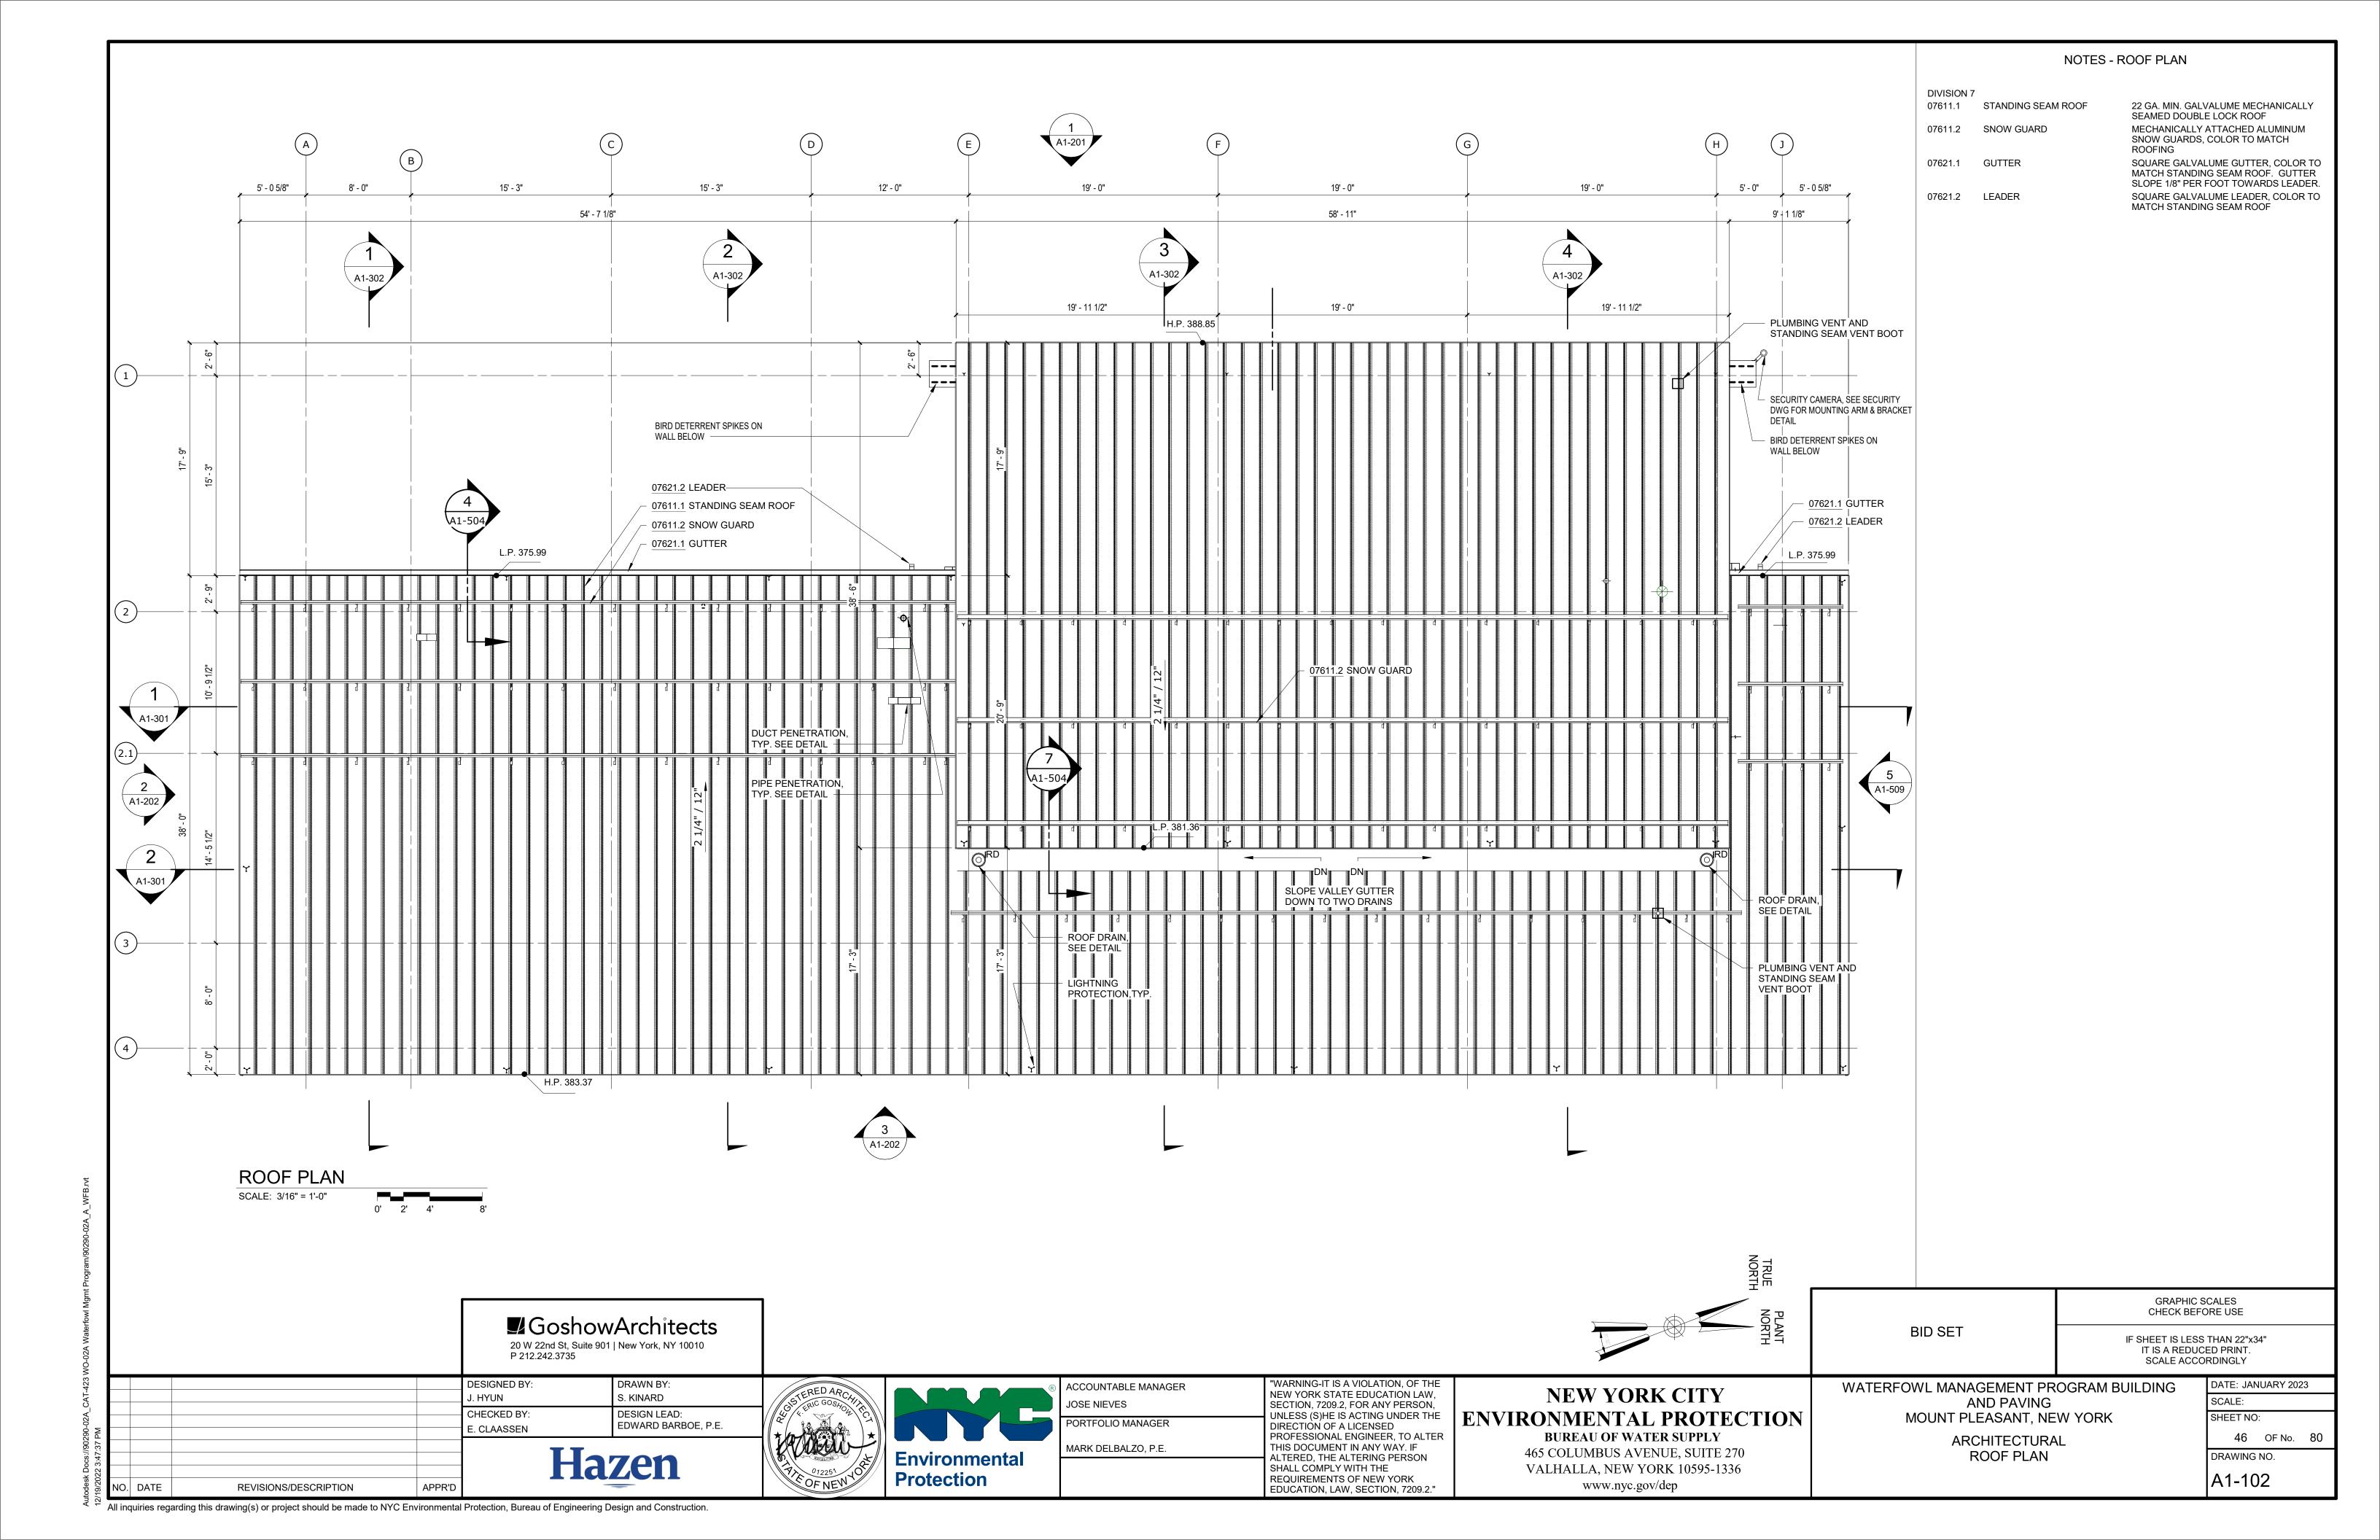
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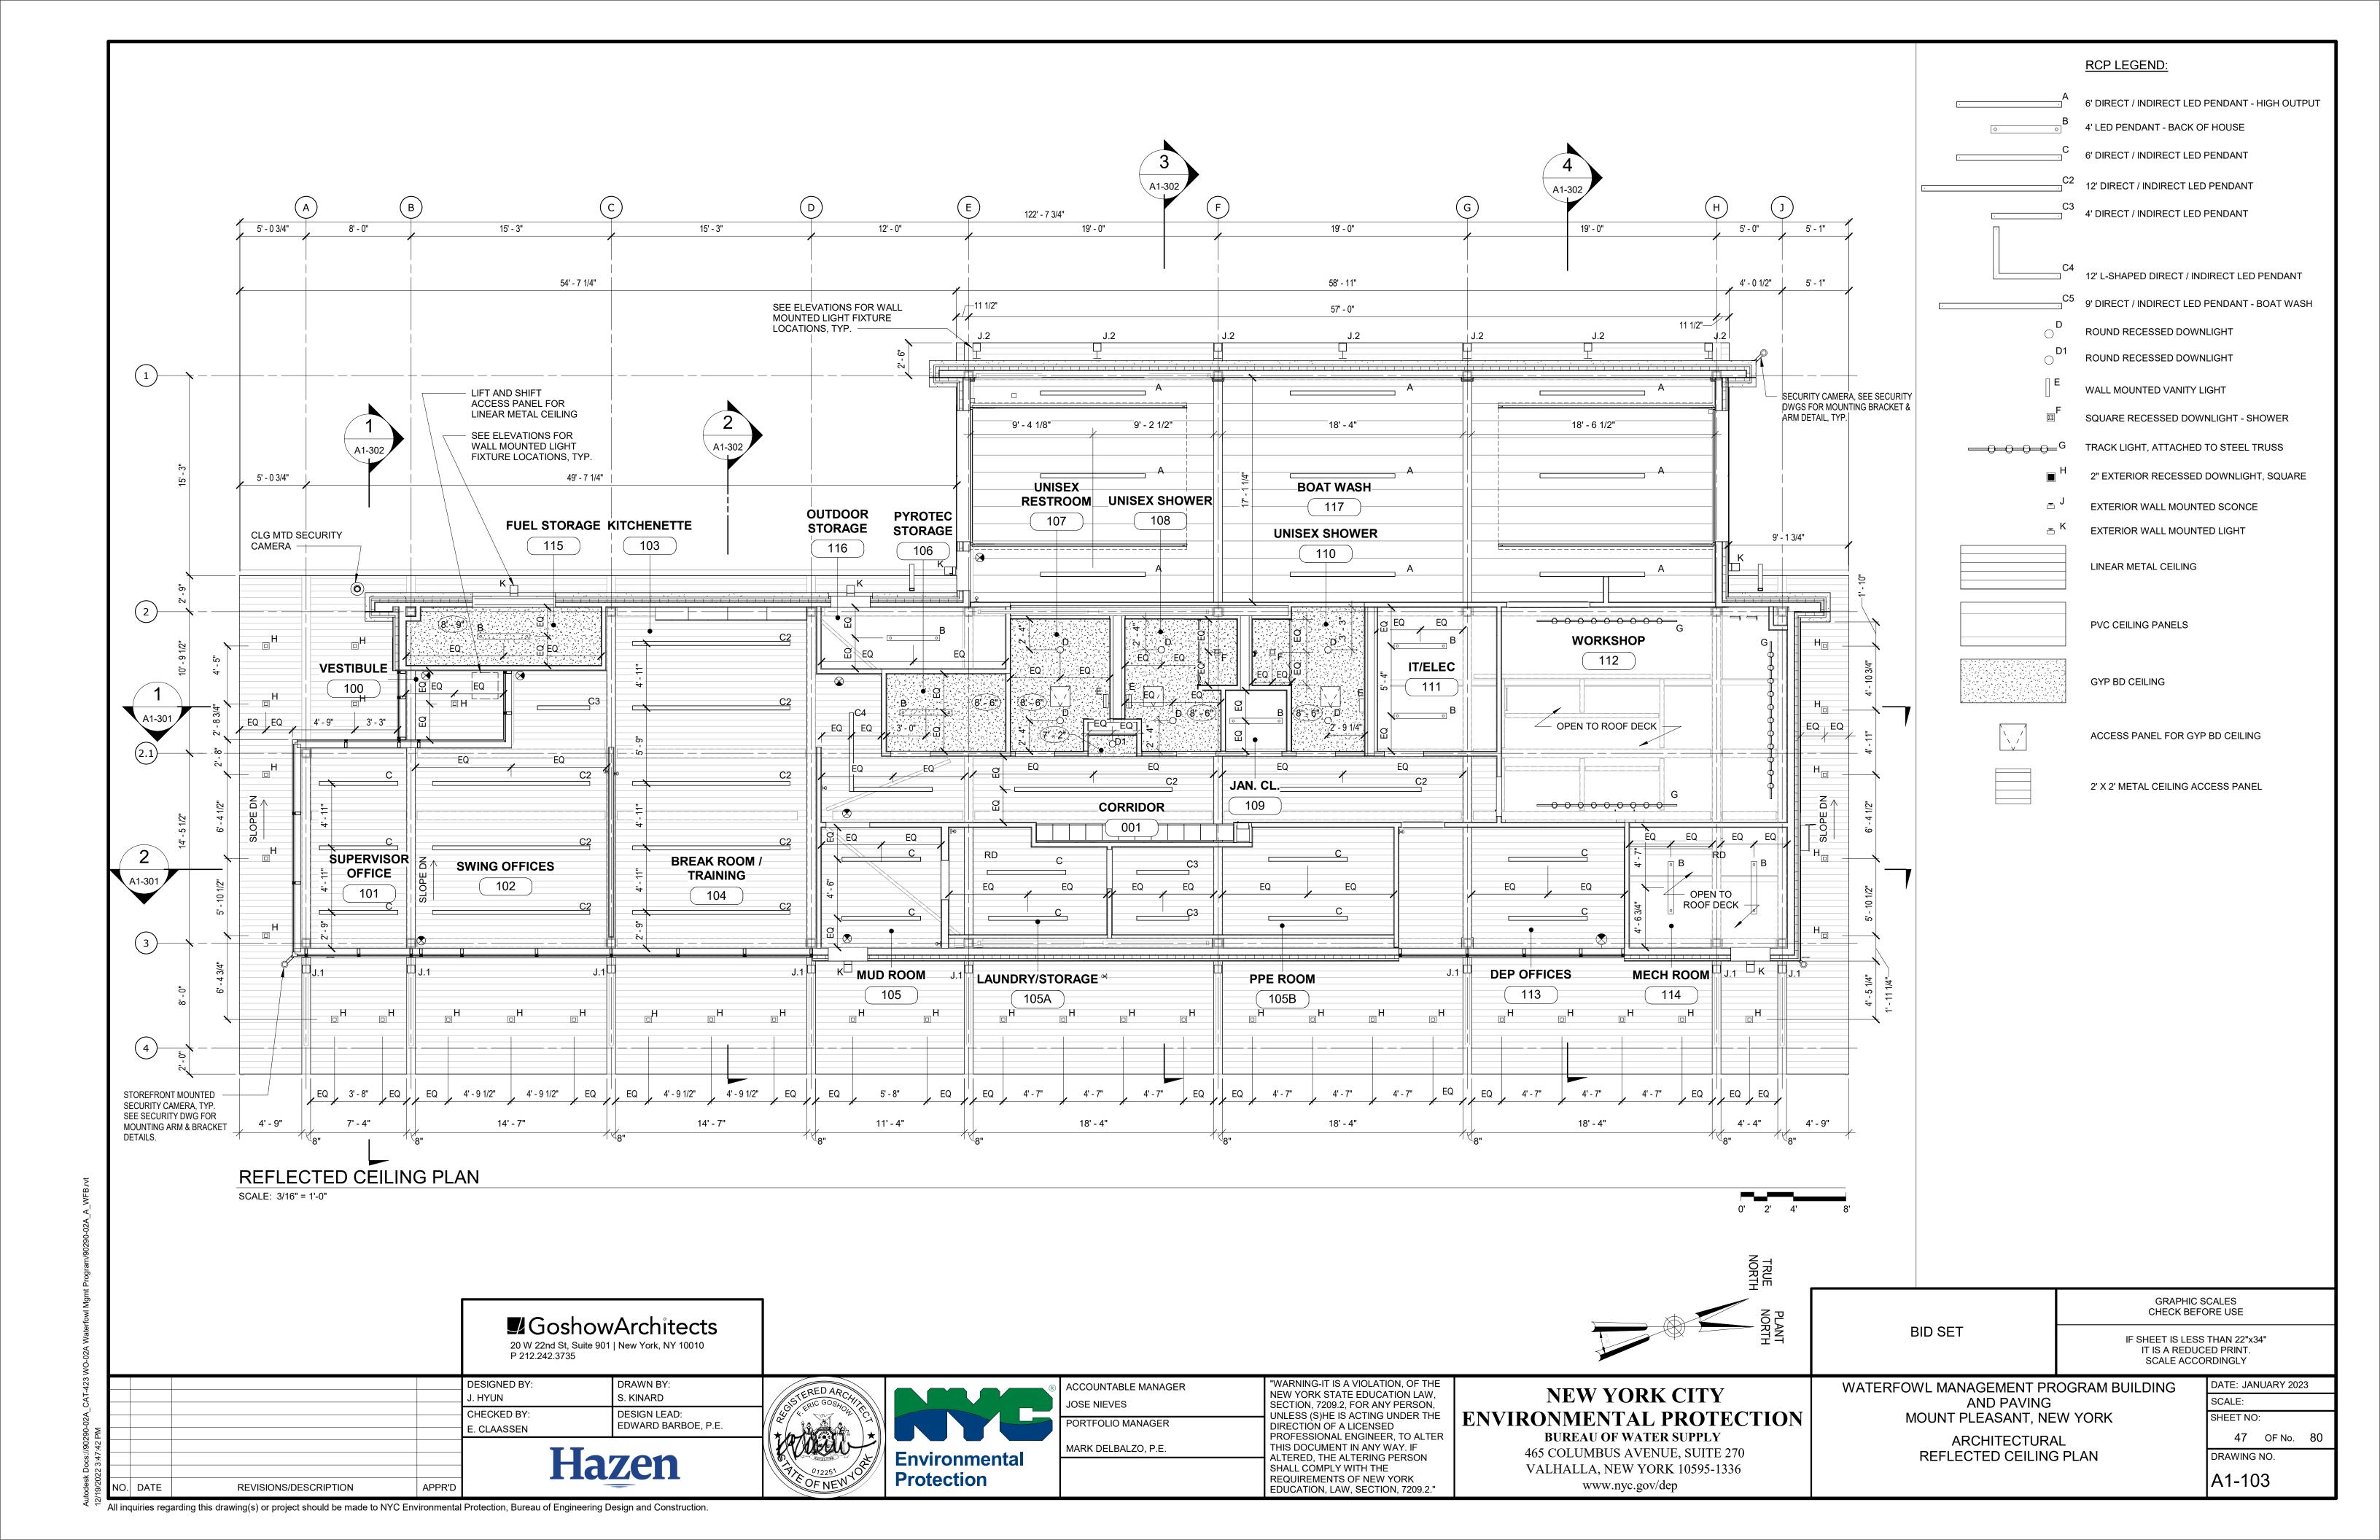
WATERFOWL MANAGEMENT PROGRAM BUILDING AND PAVING MOUNT PLEASANT, NEW YORK


ARCHITECTURAL CODE ANALYSIS


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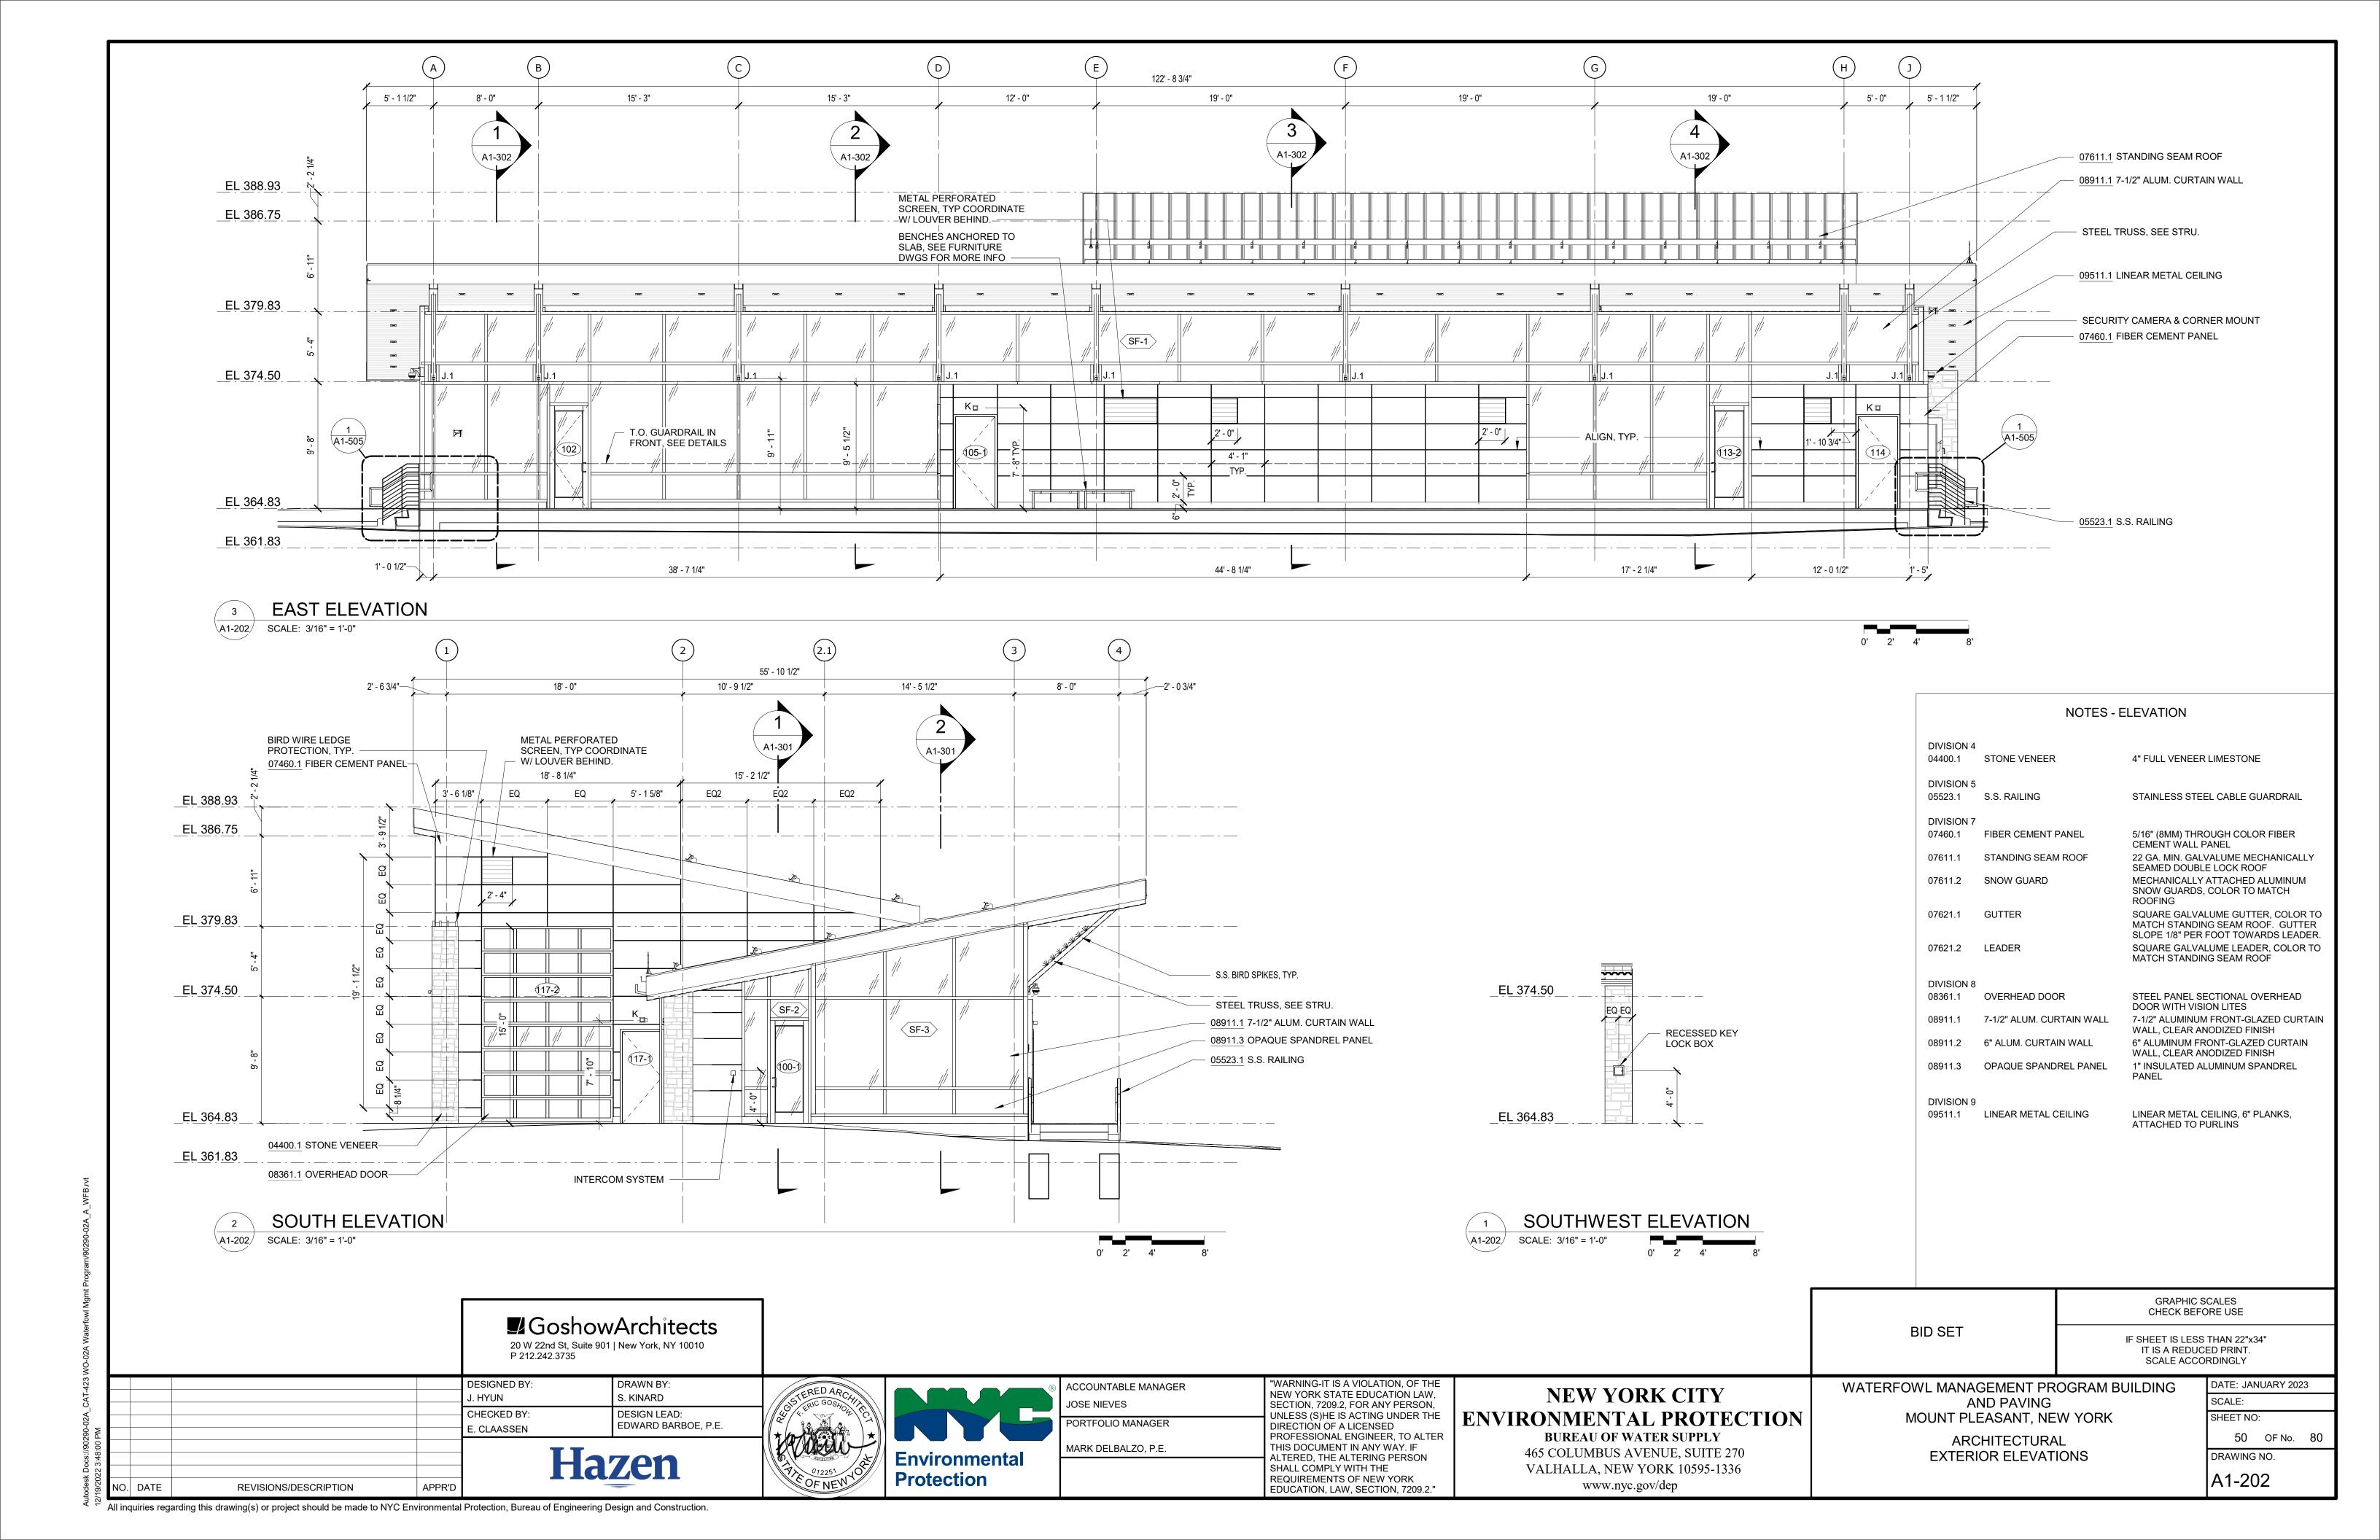











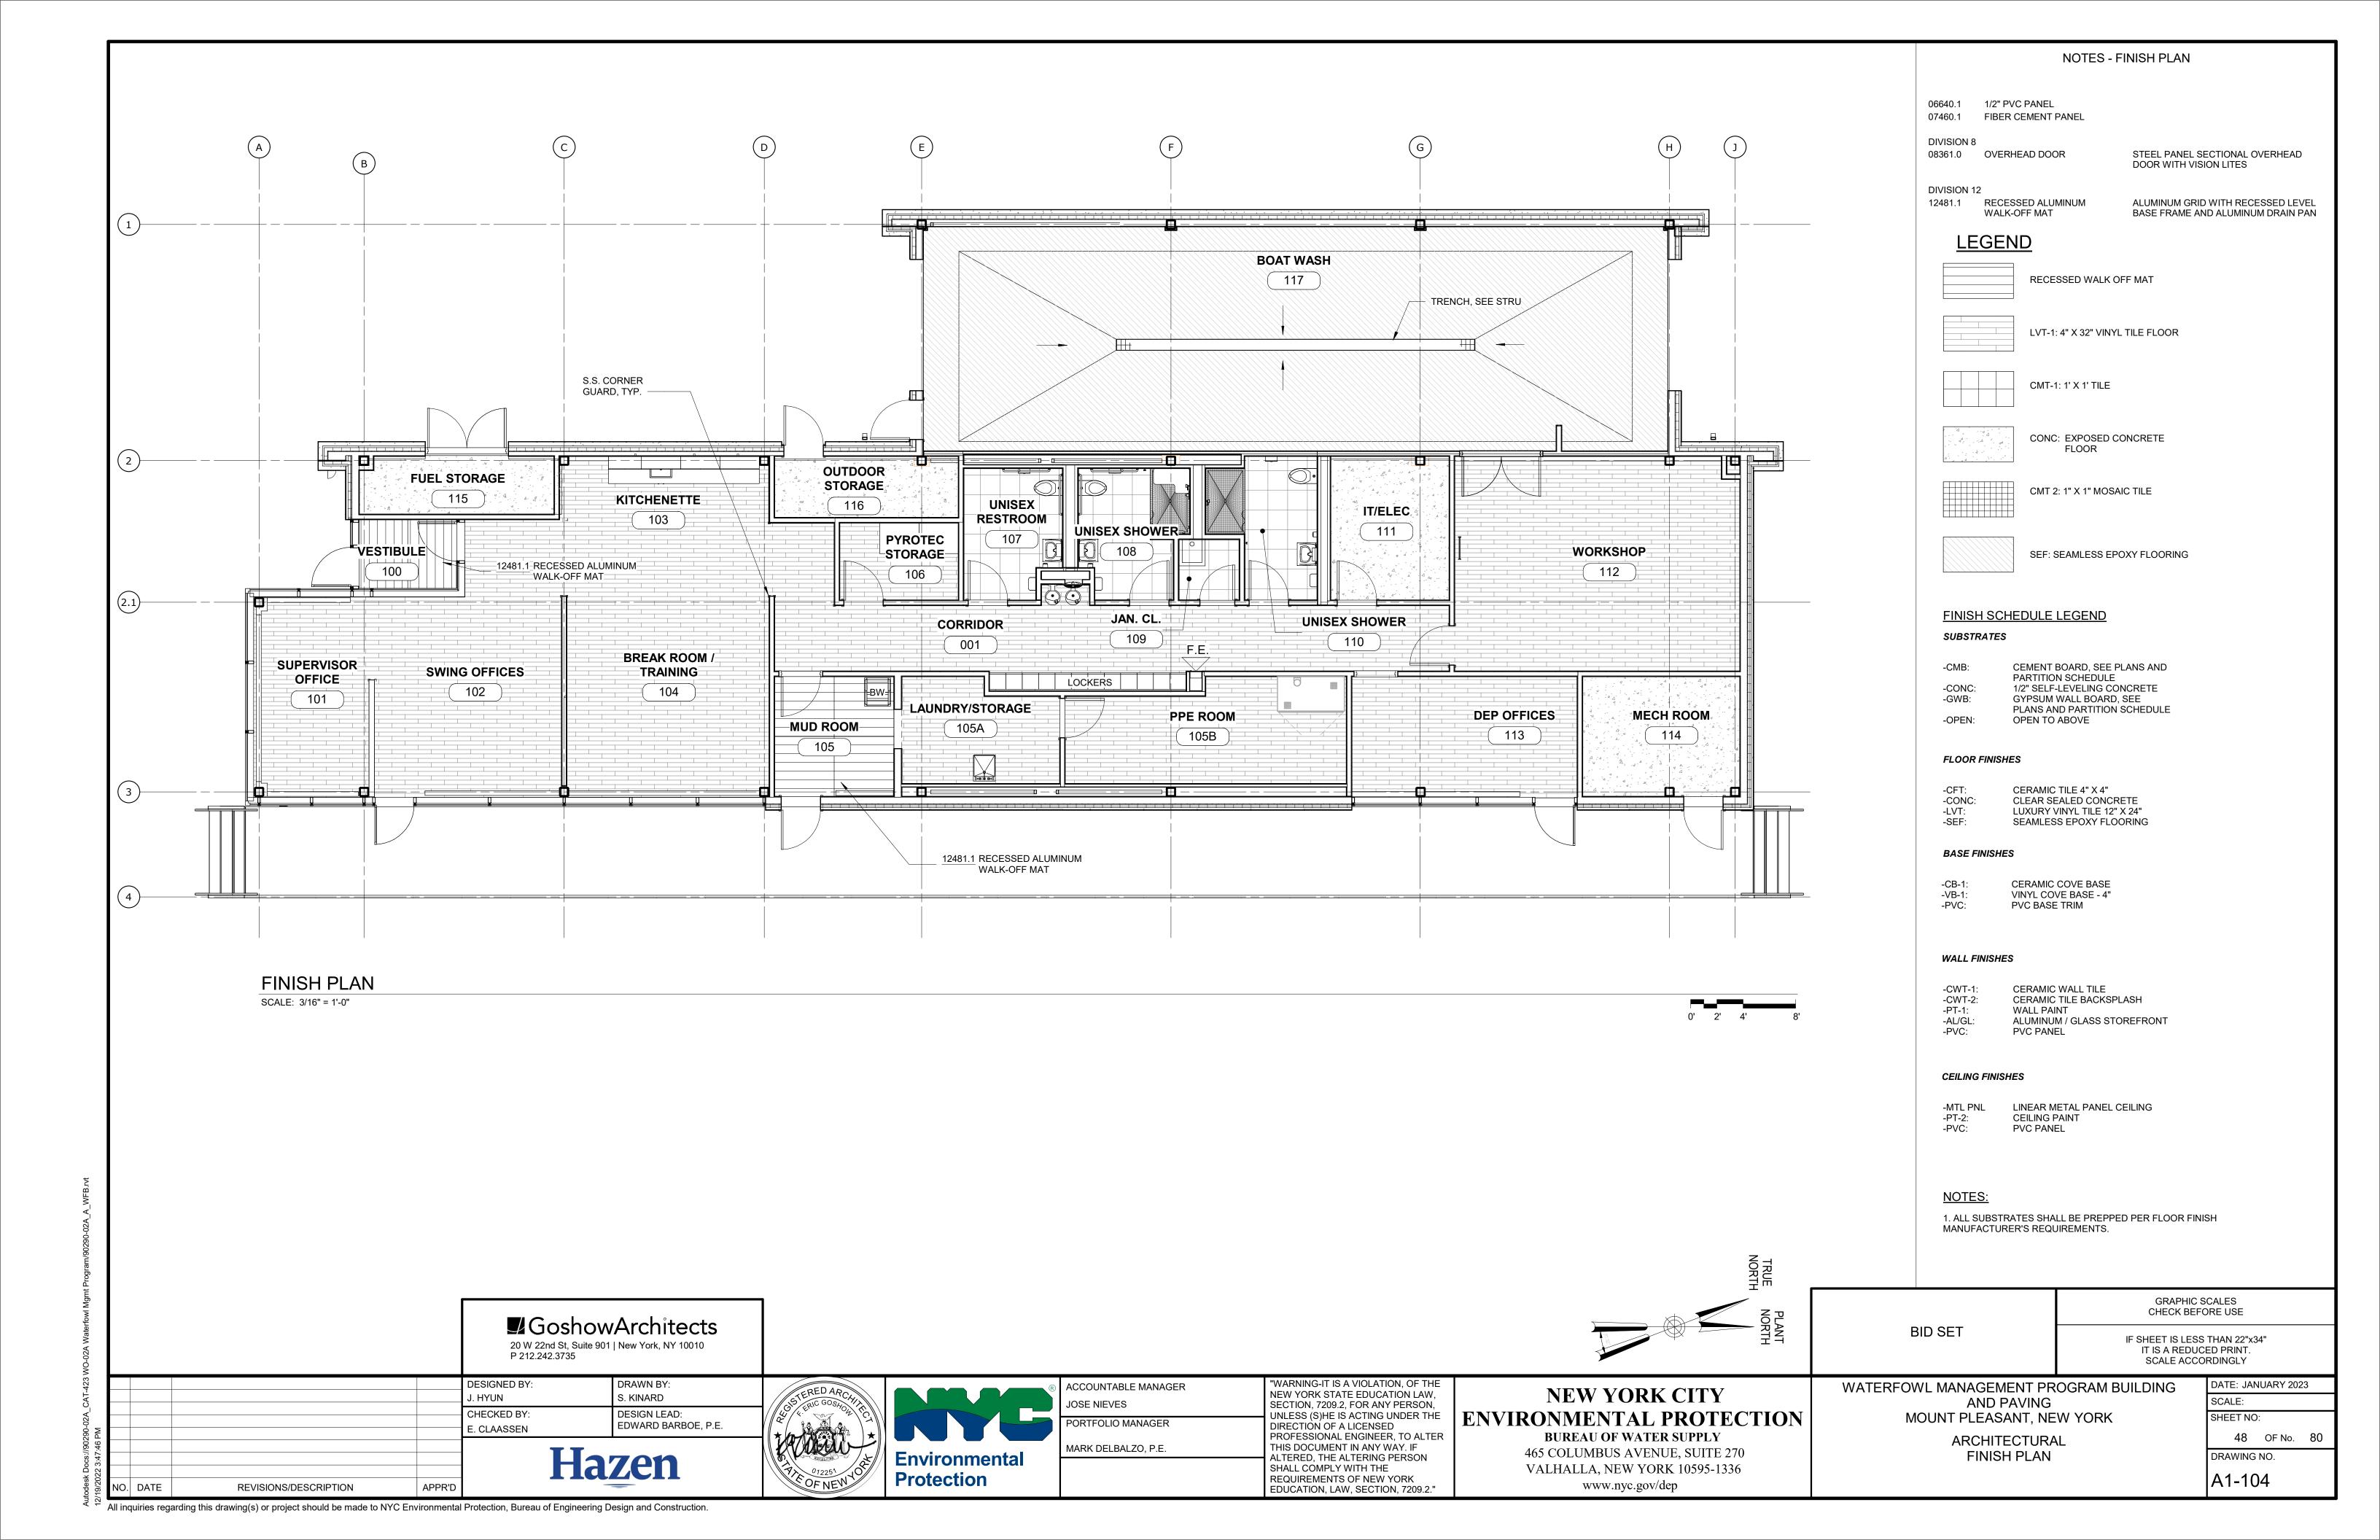


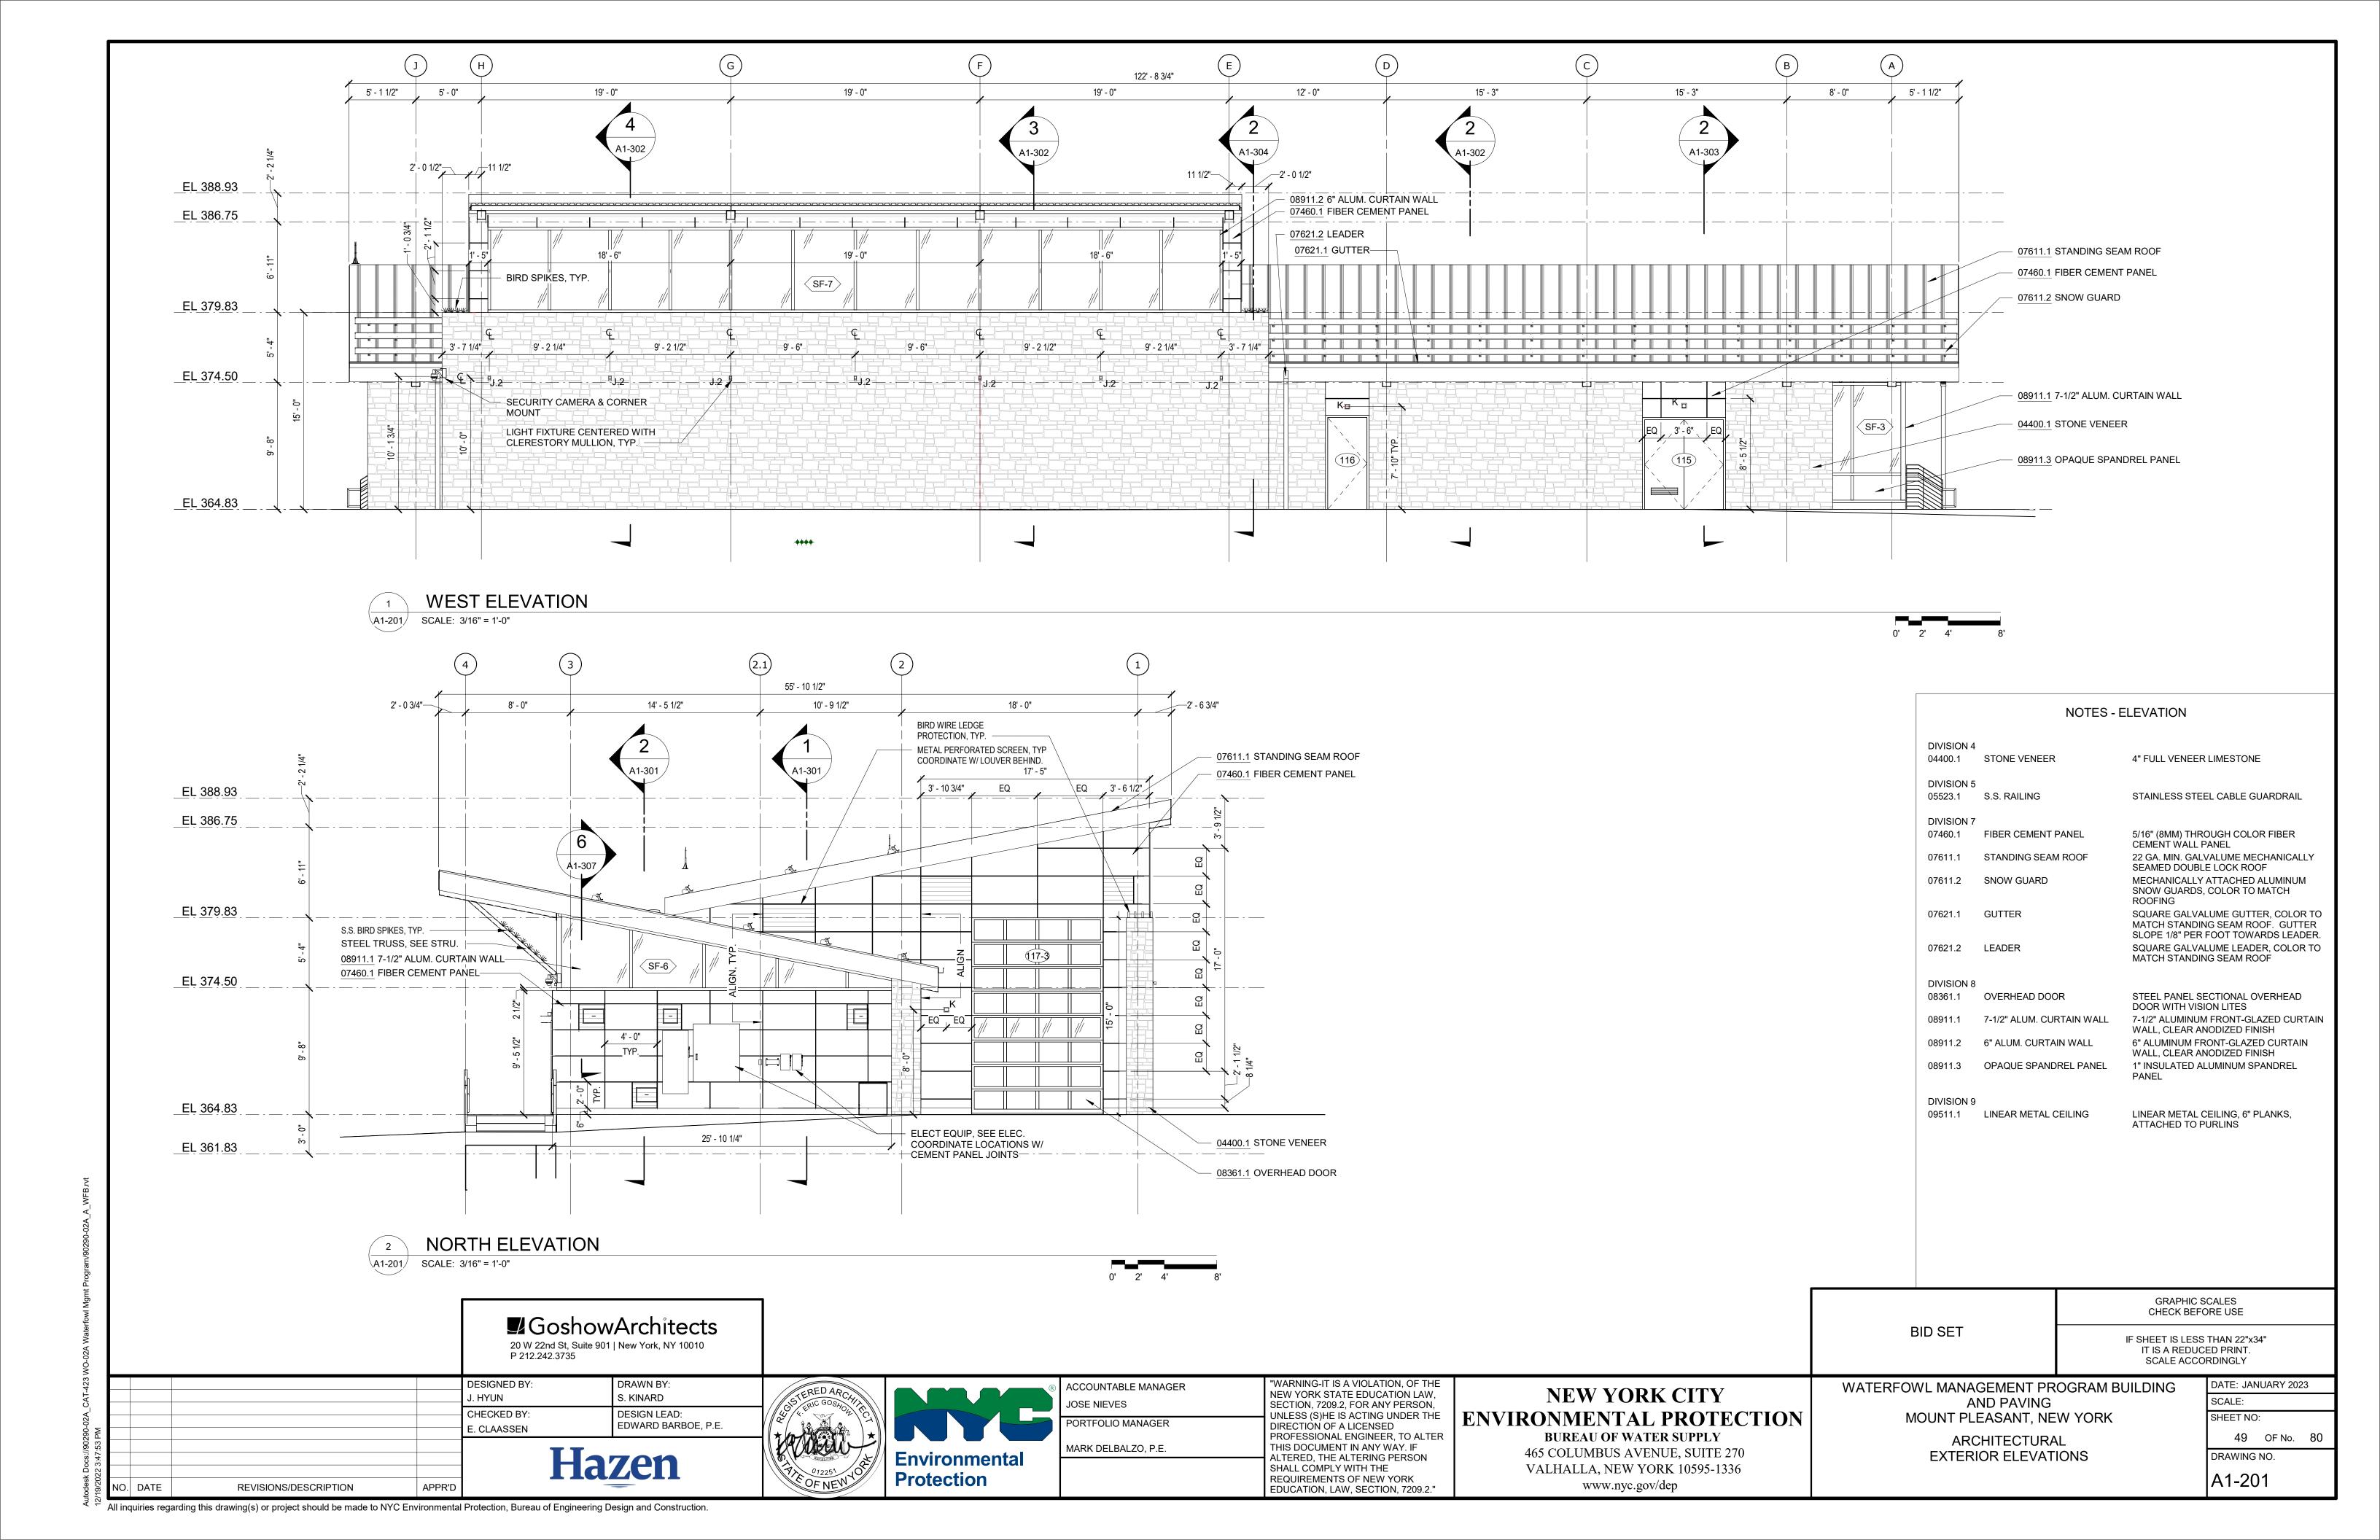


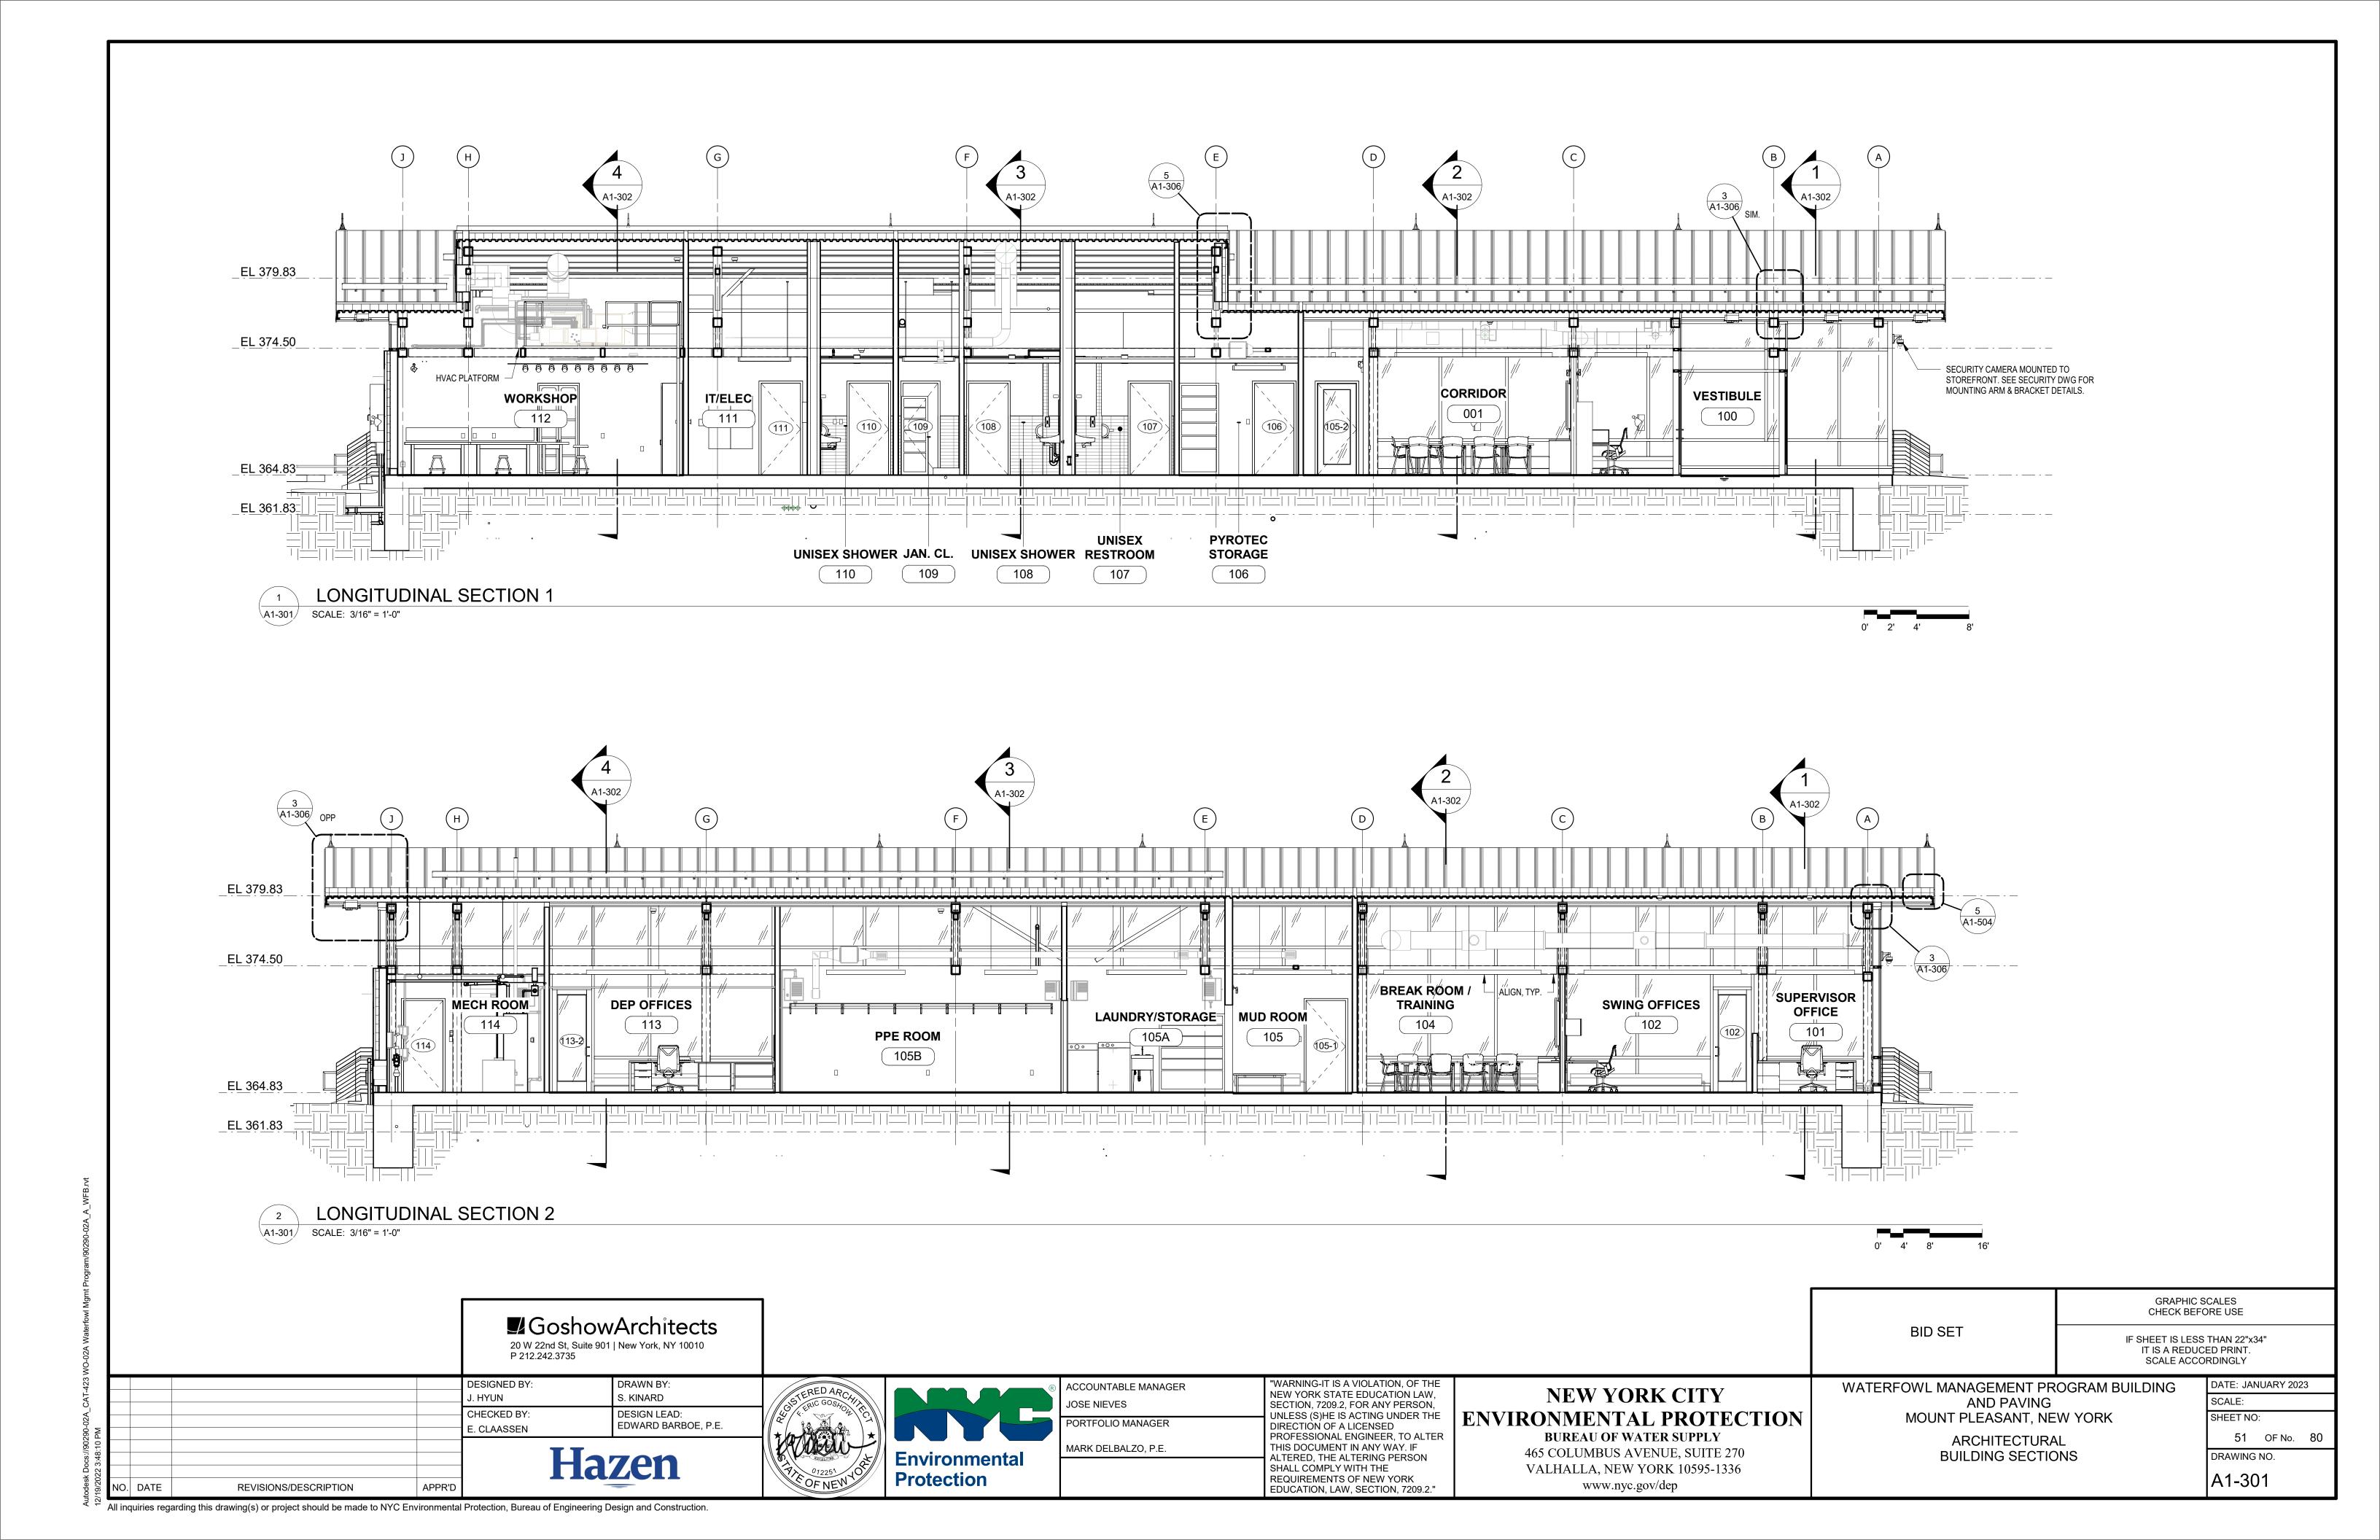


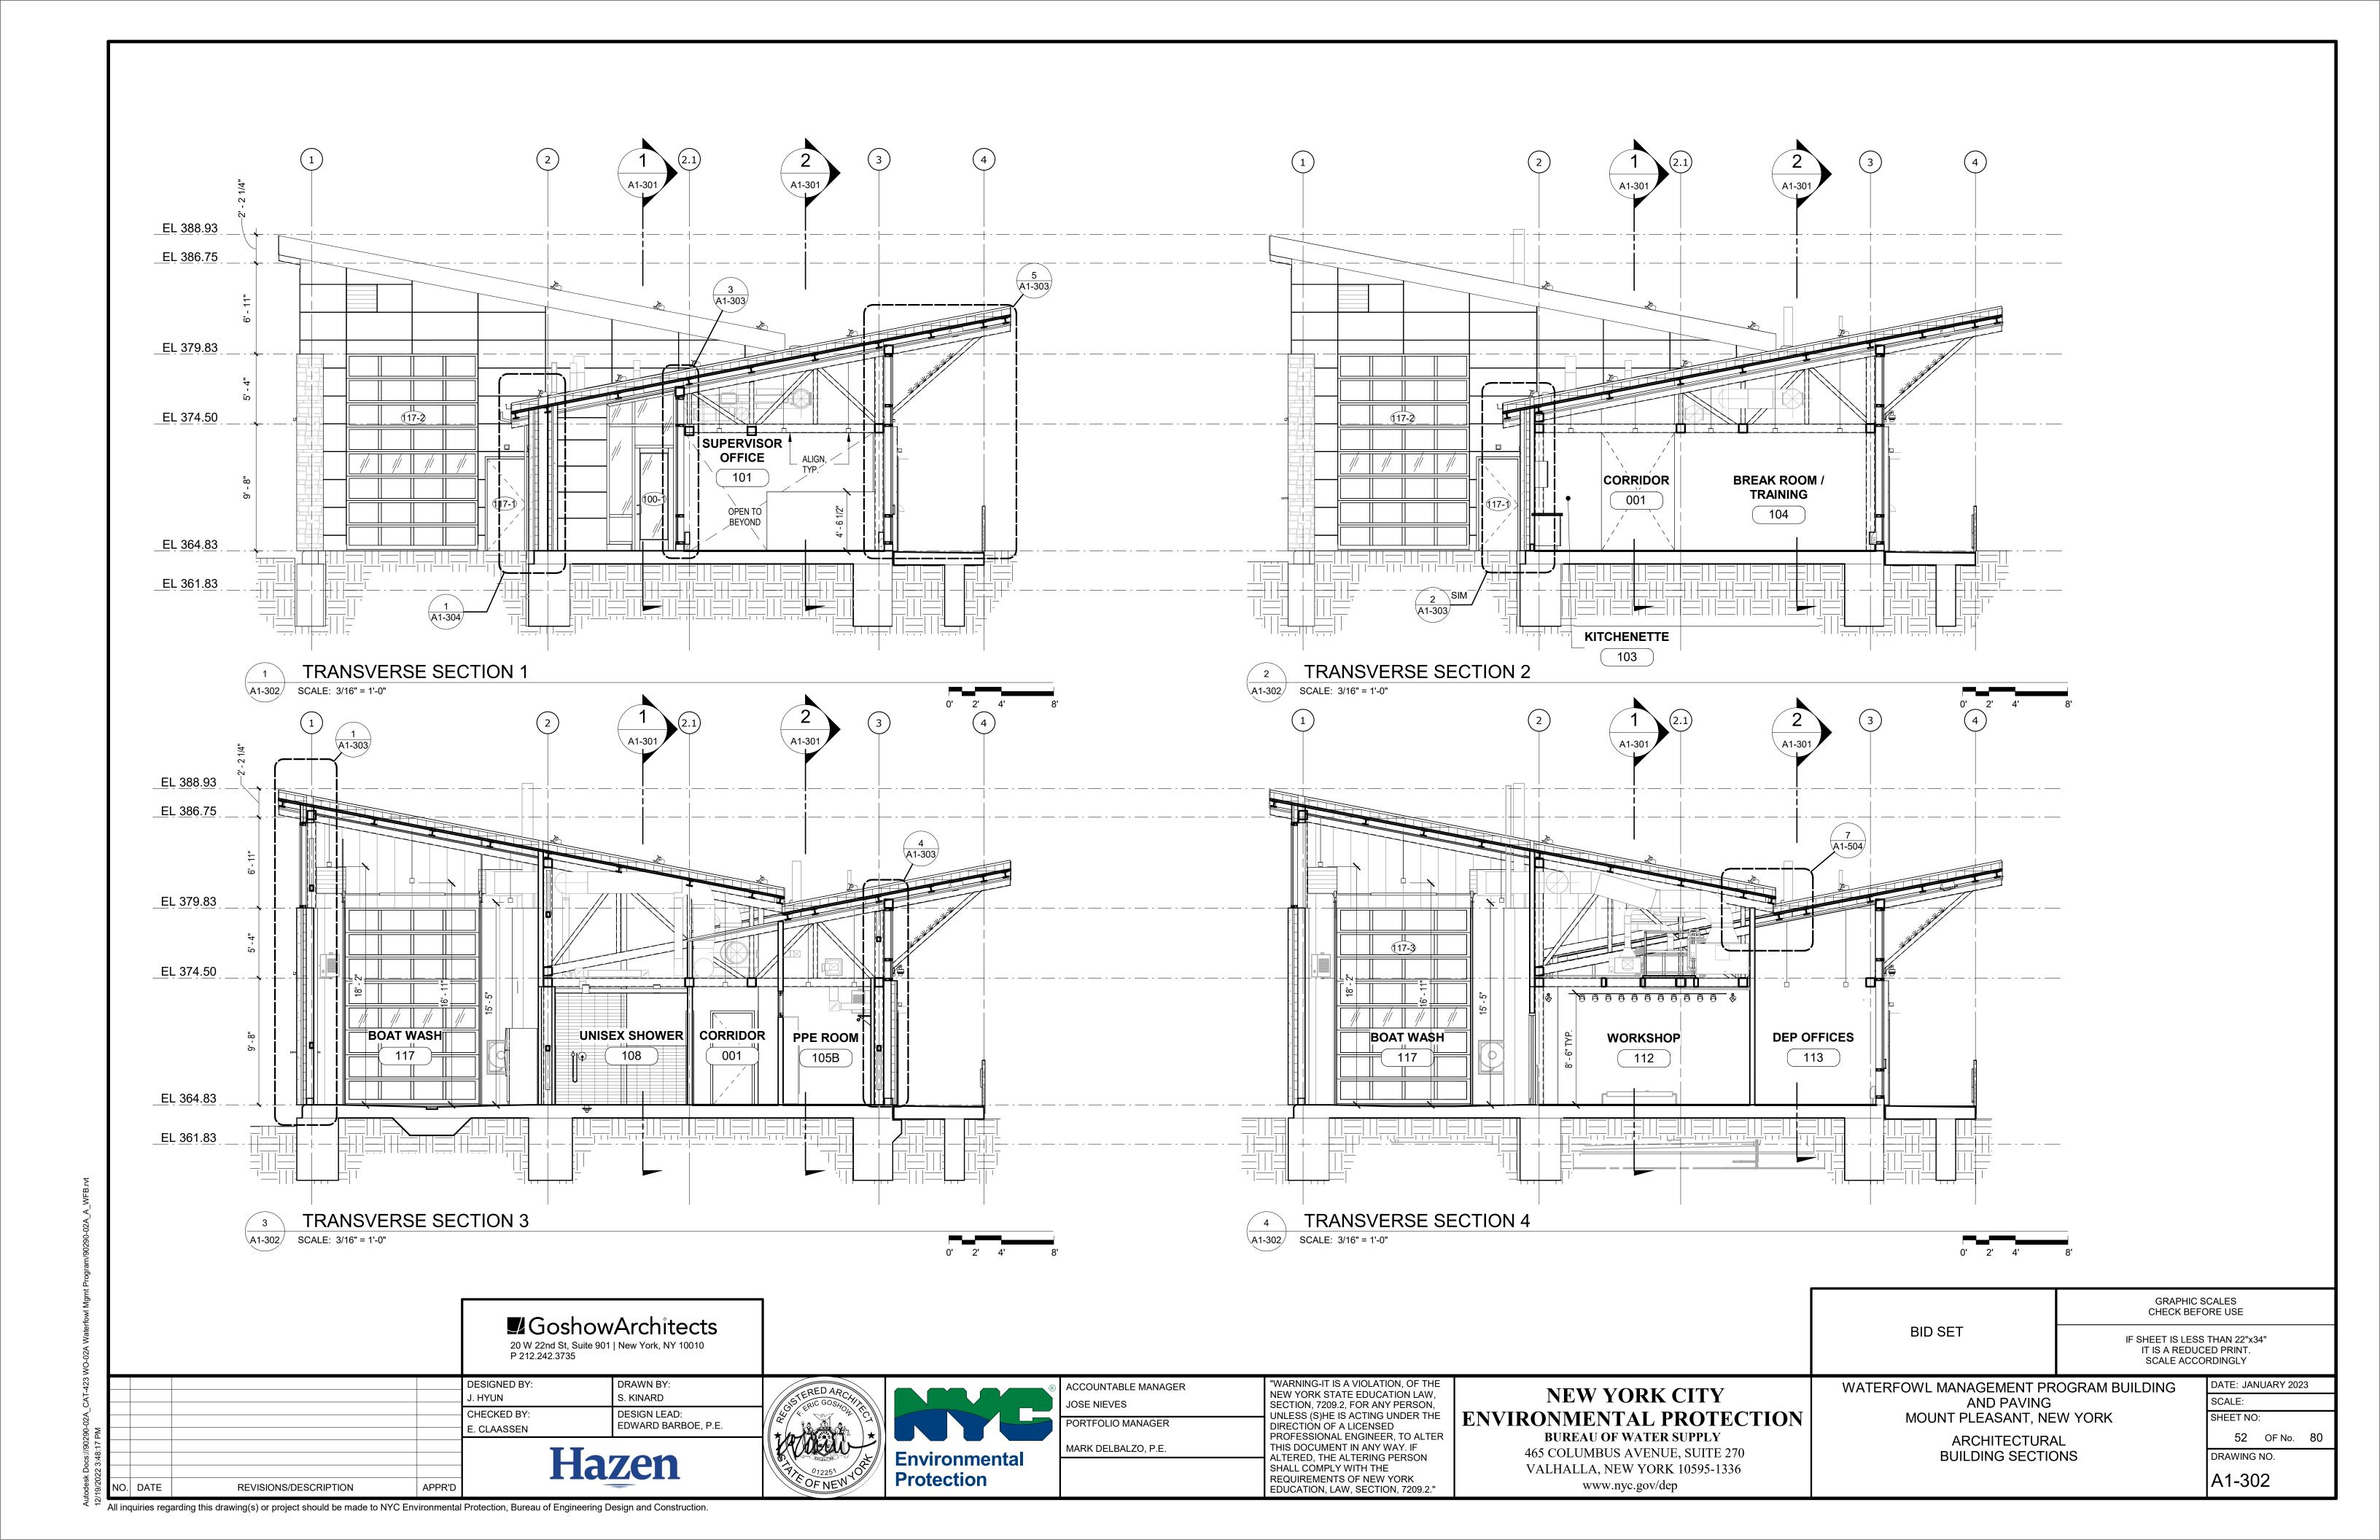


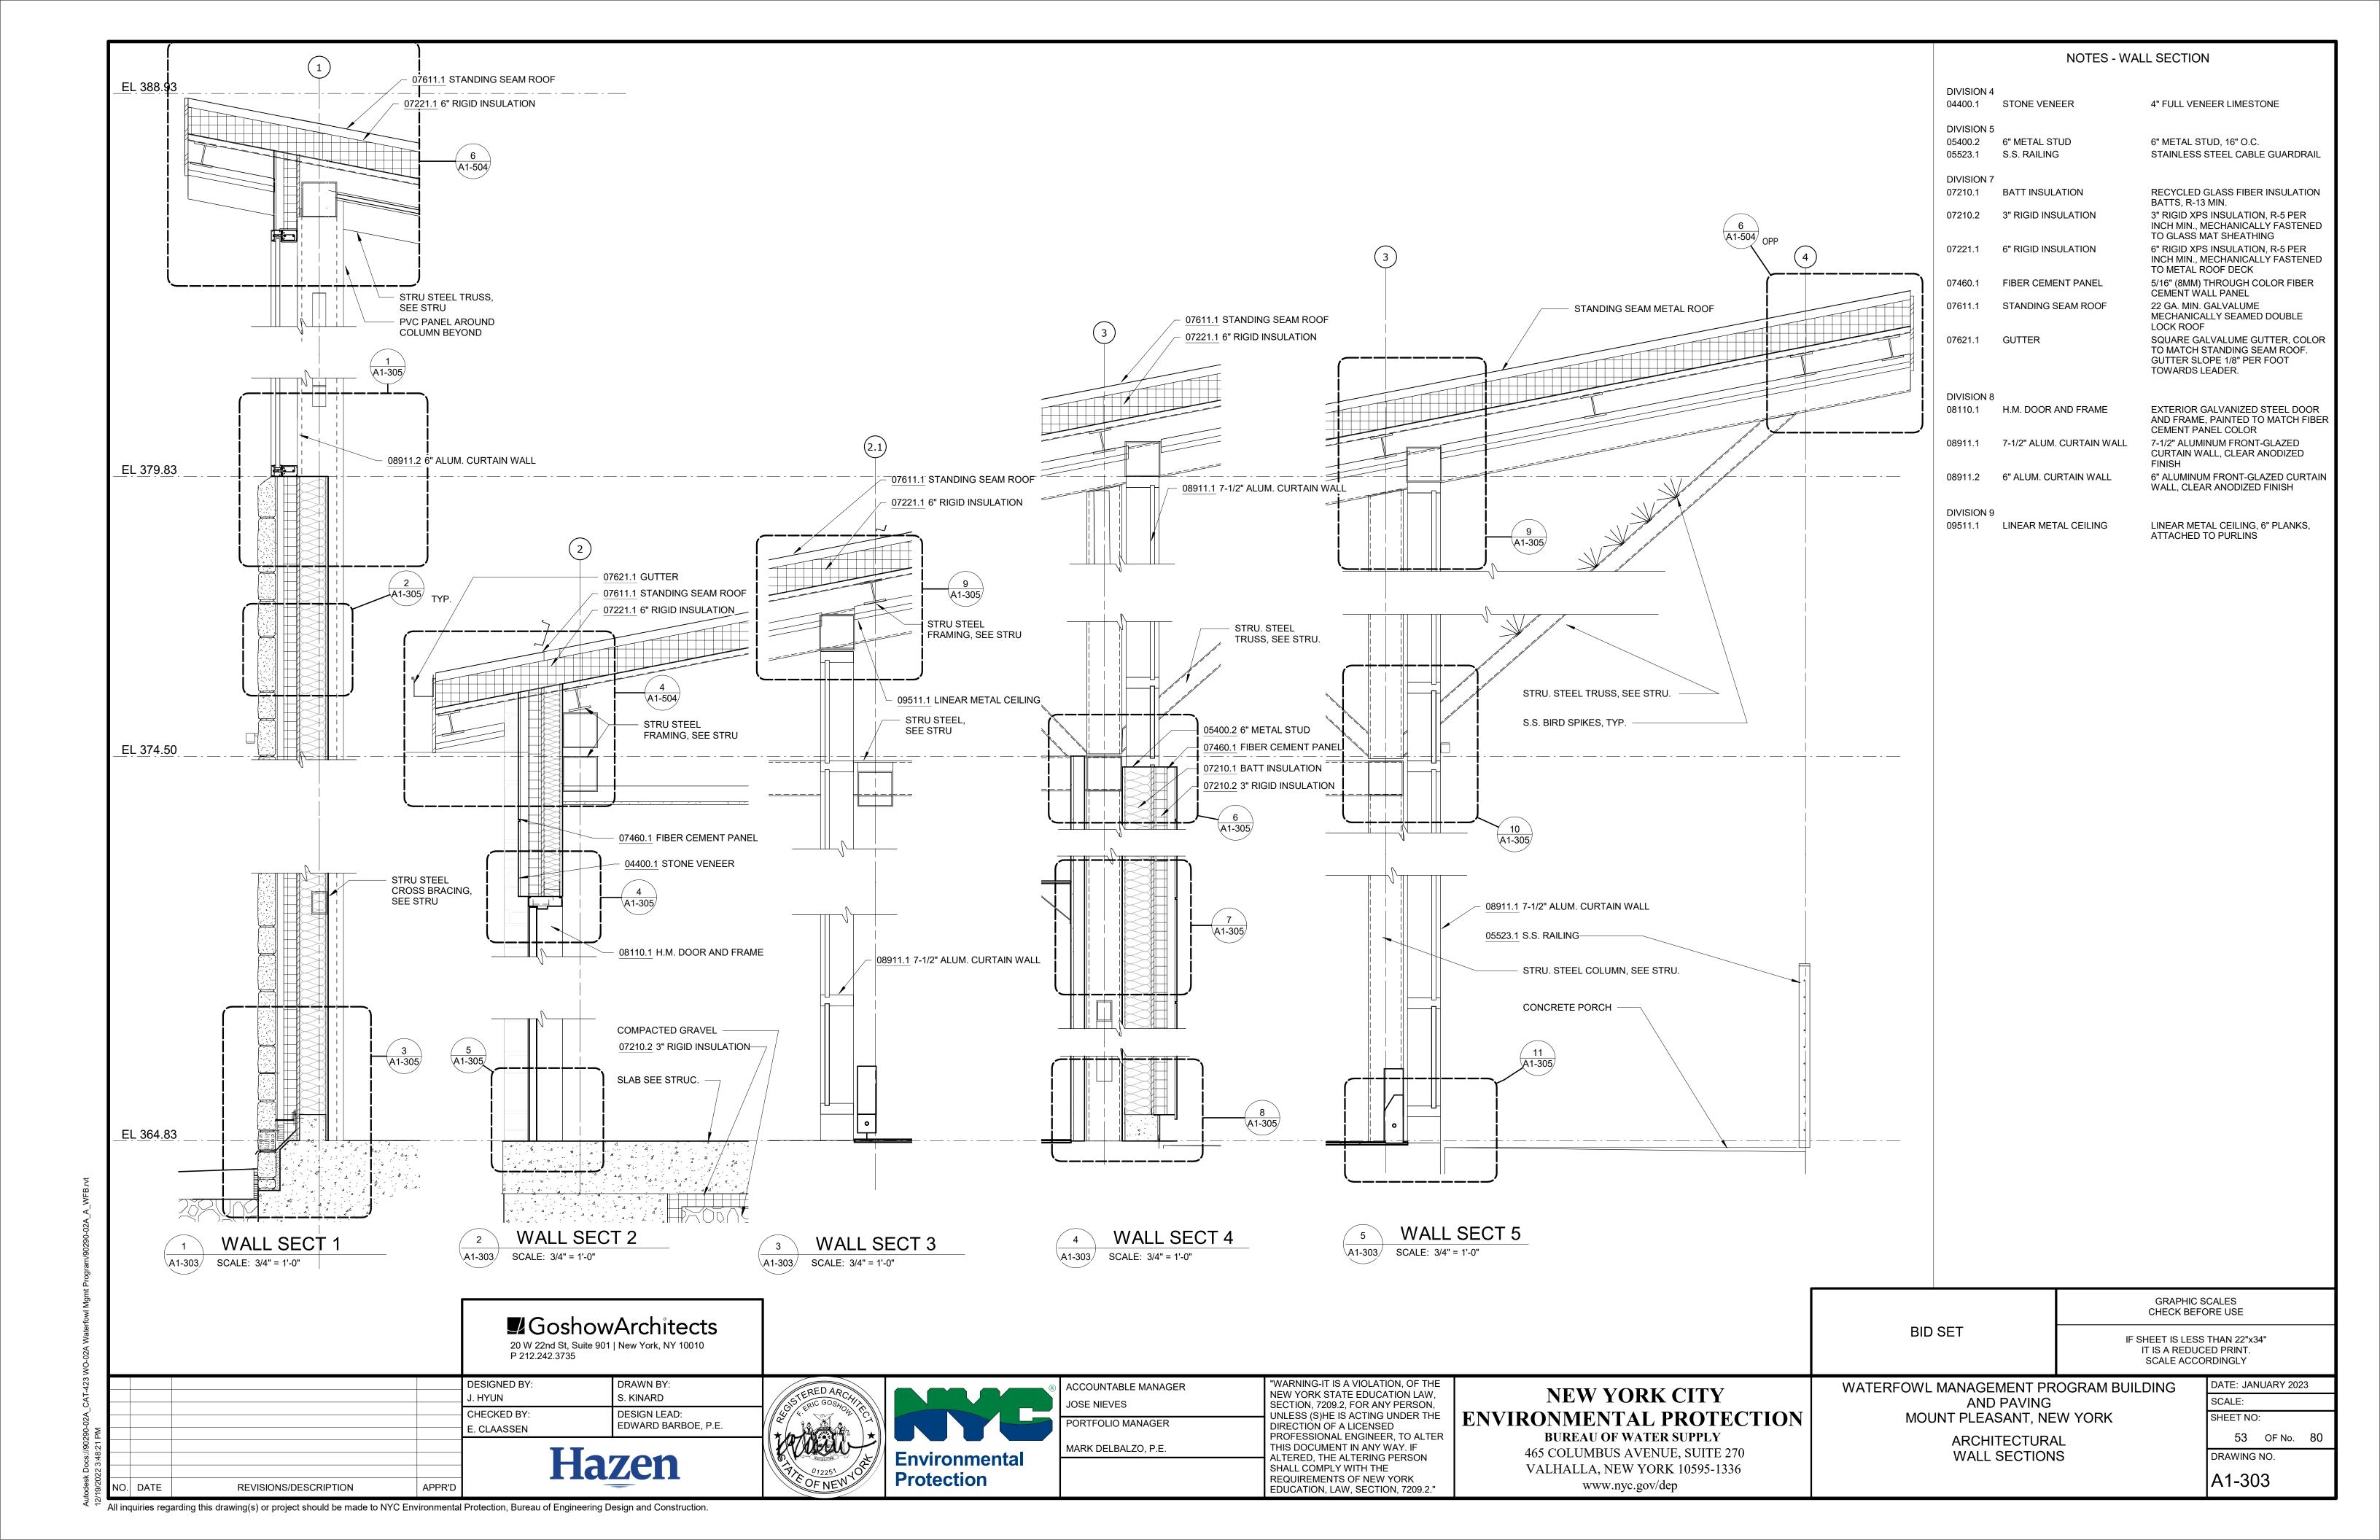


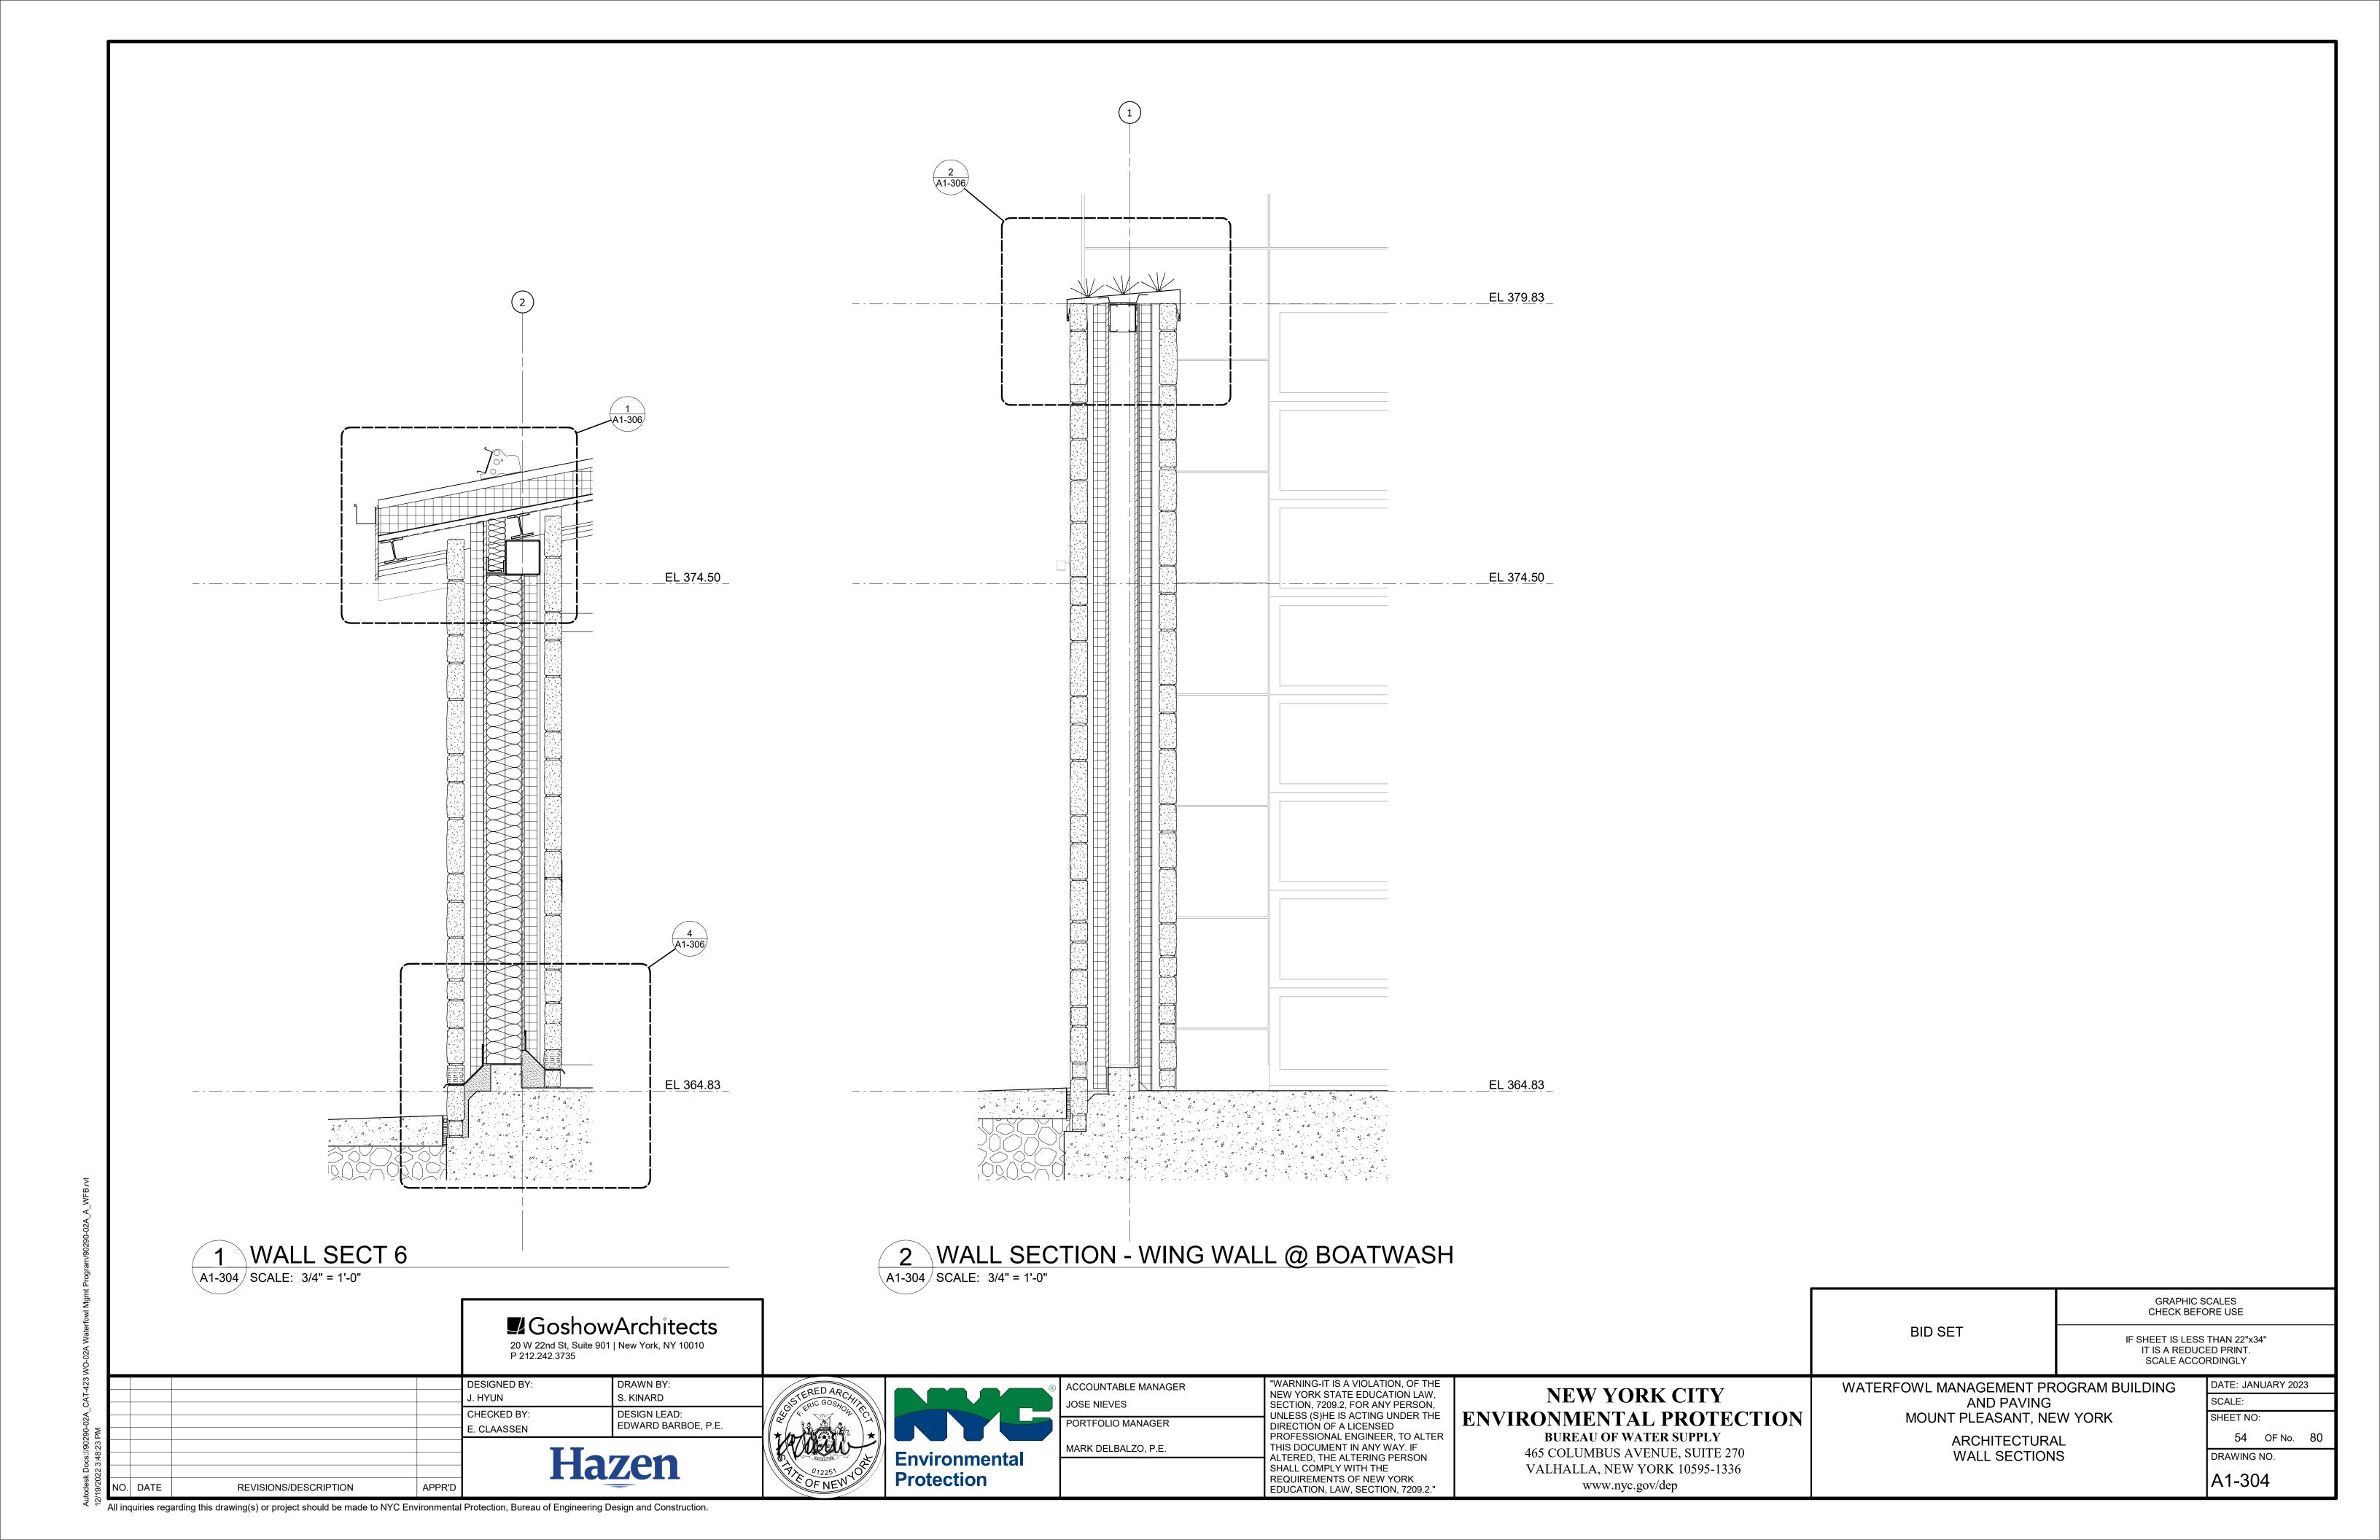

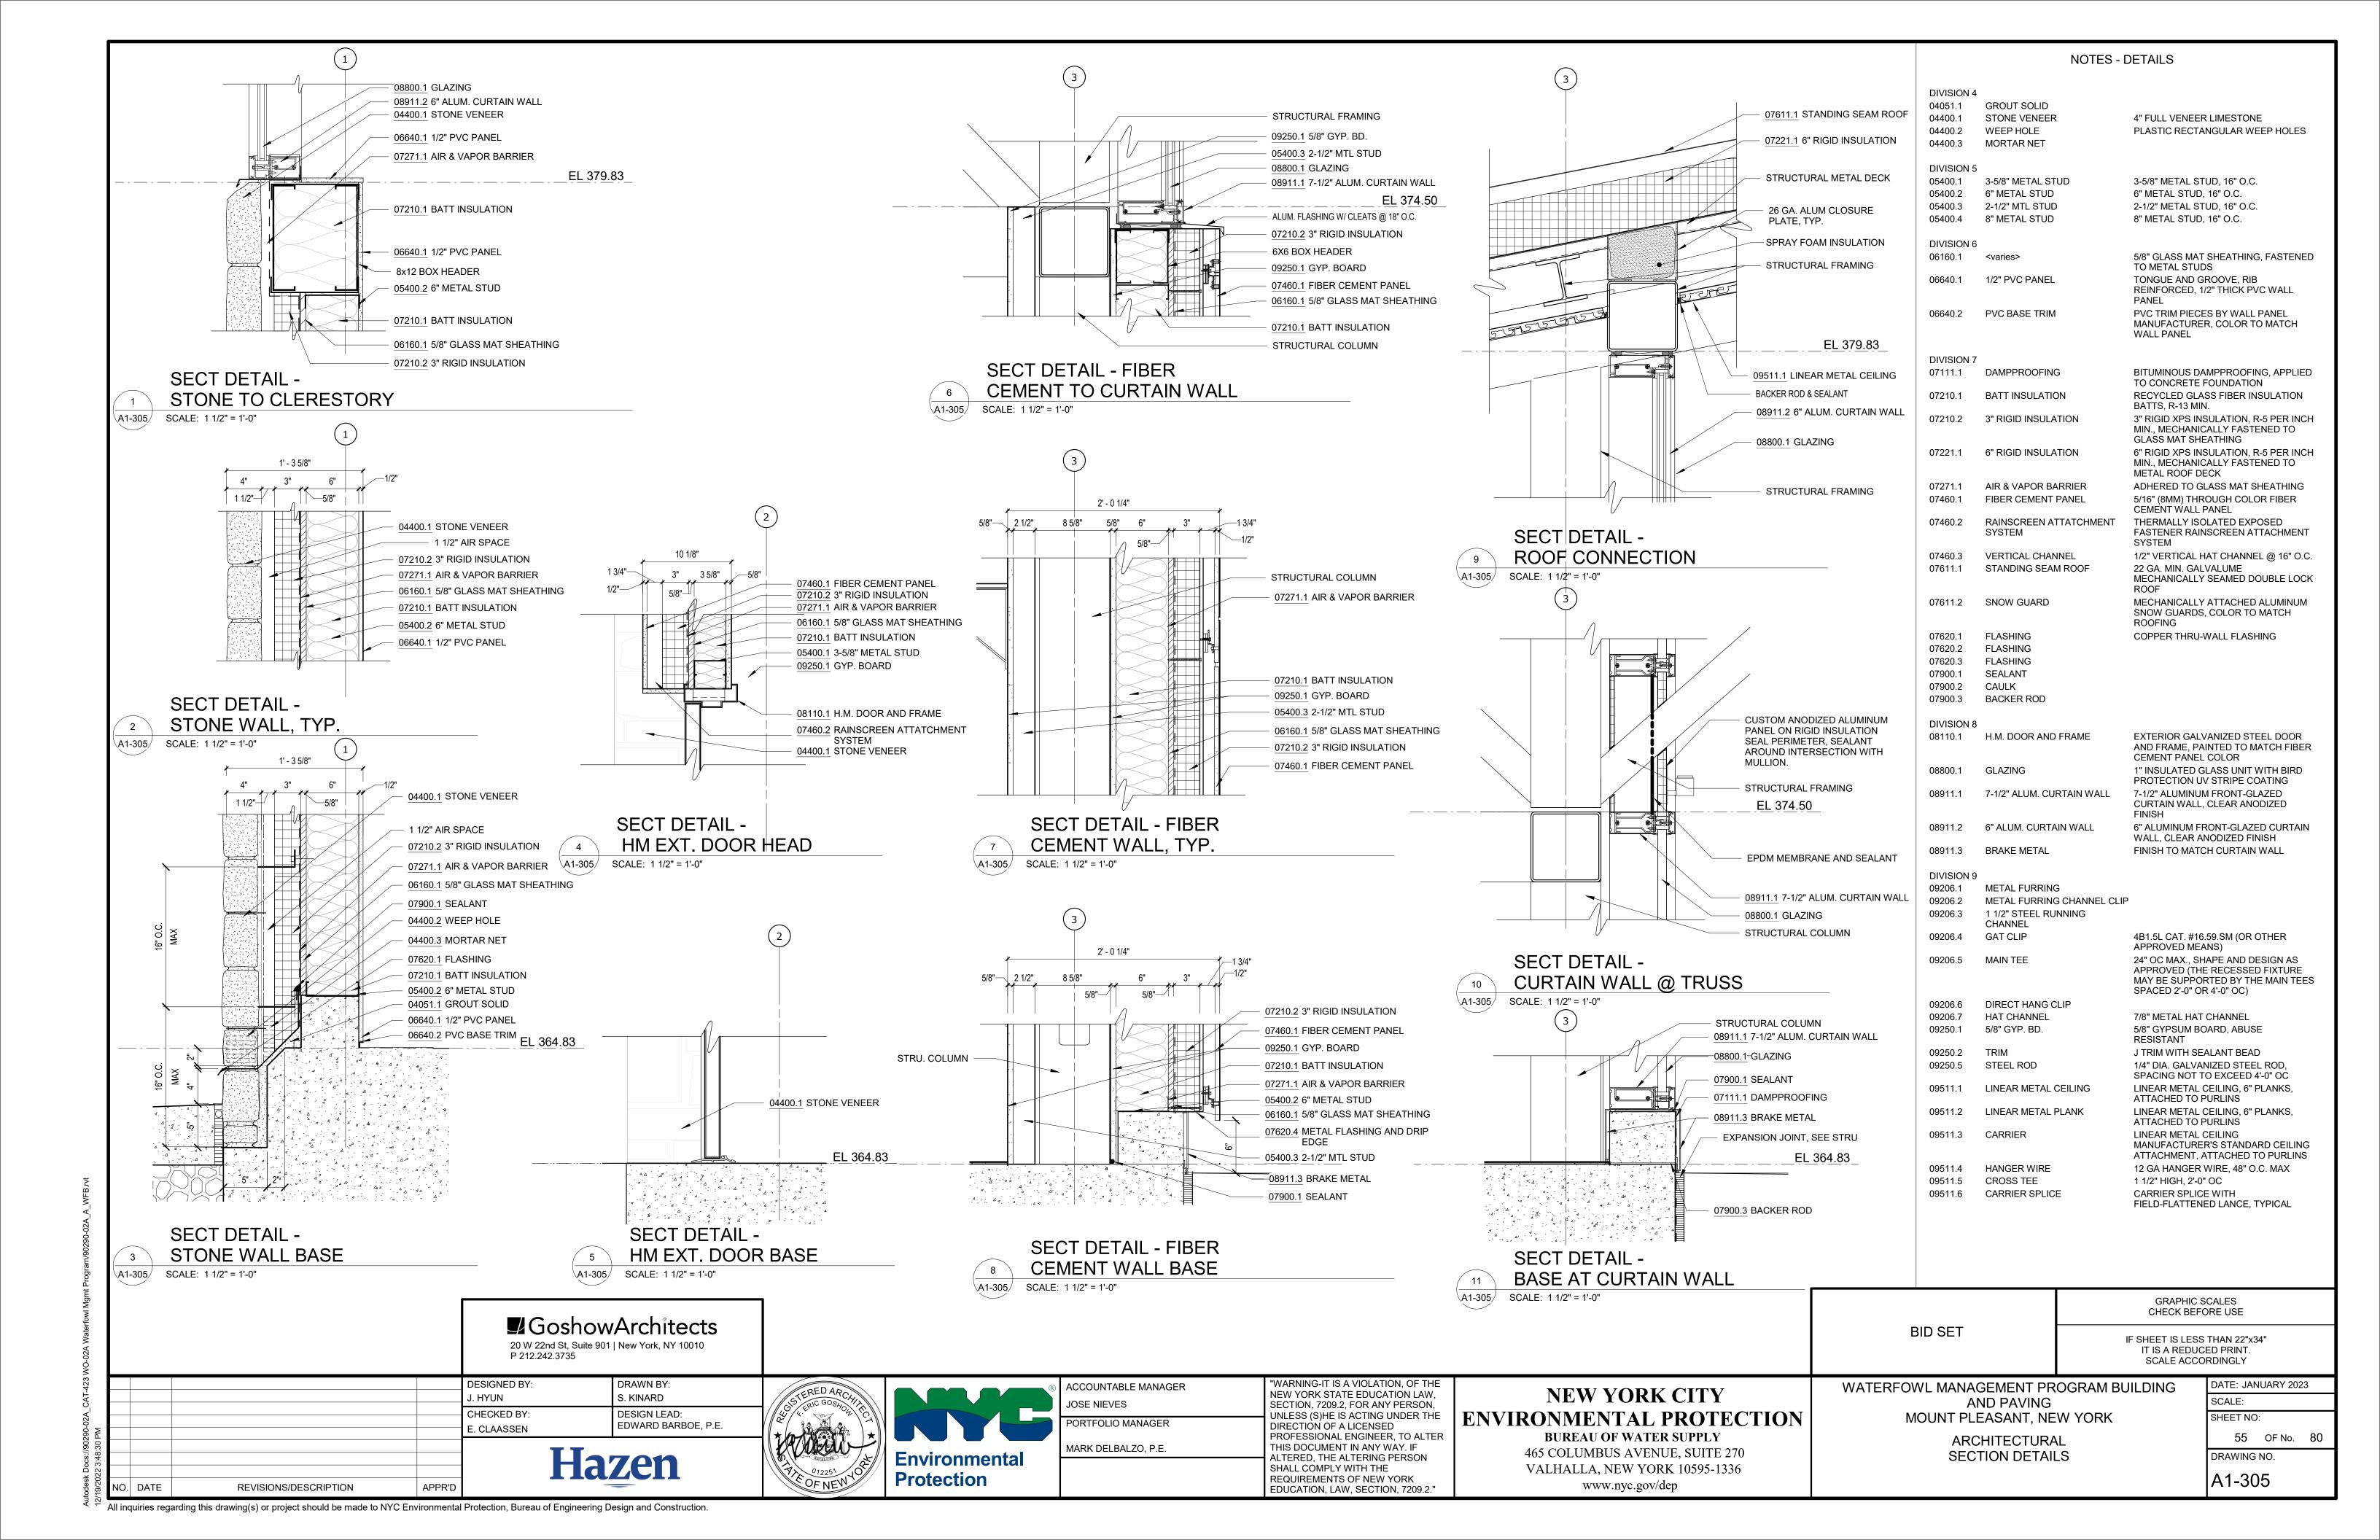

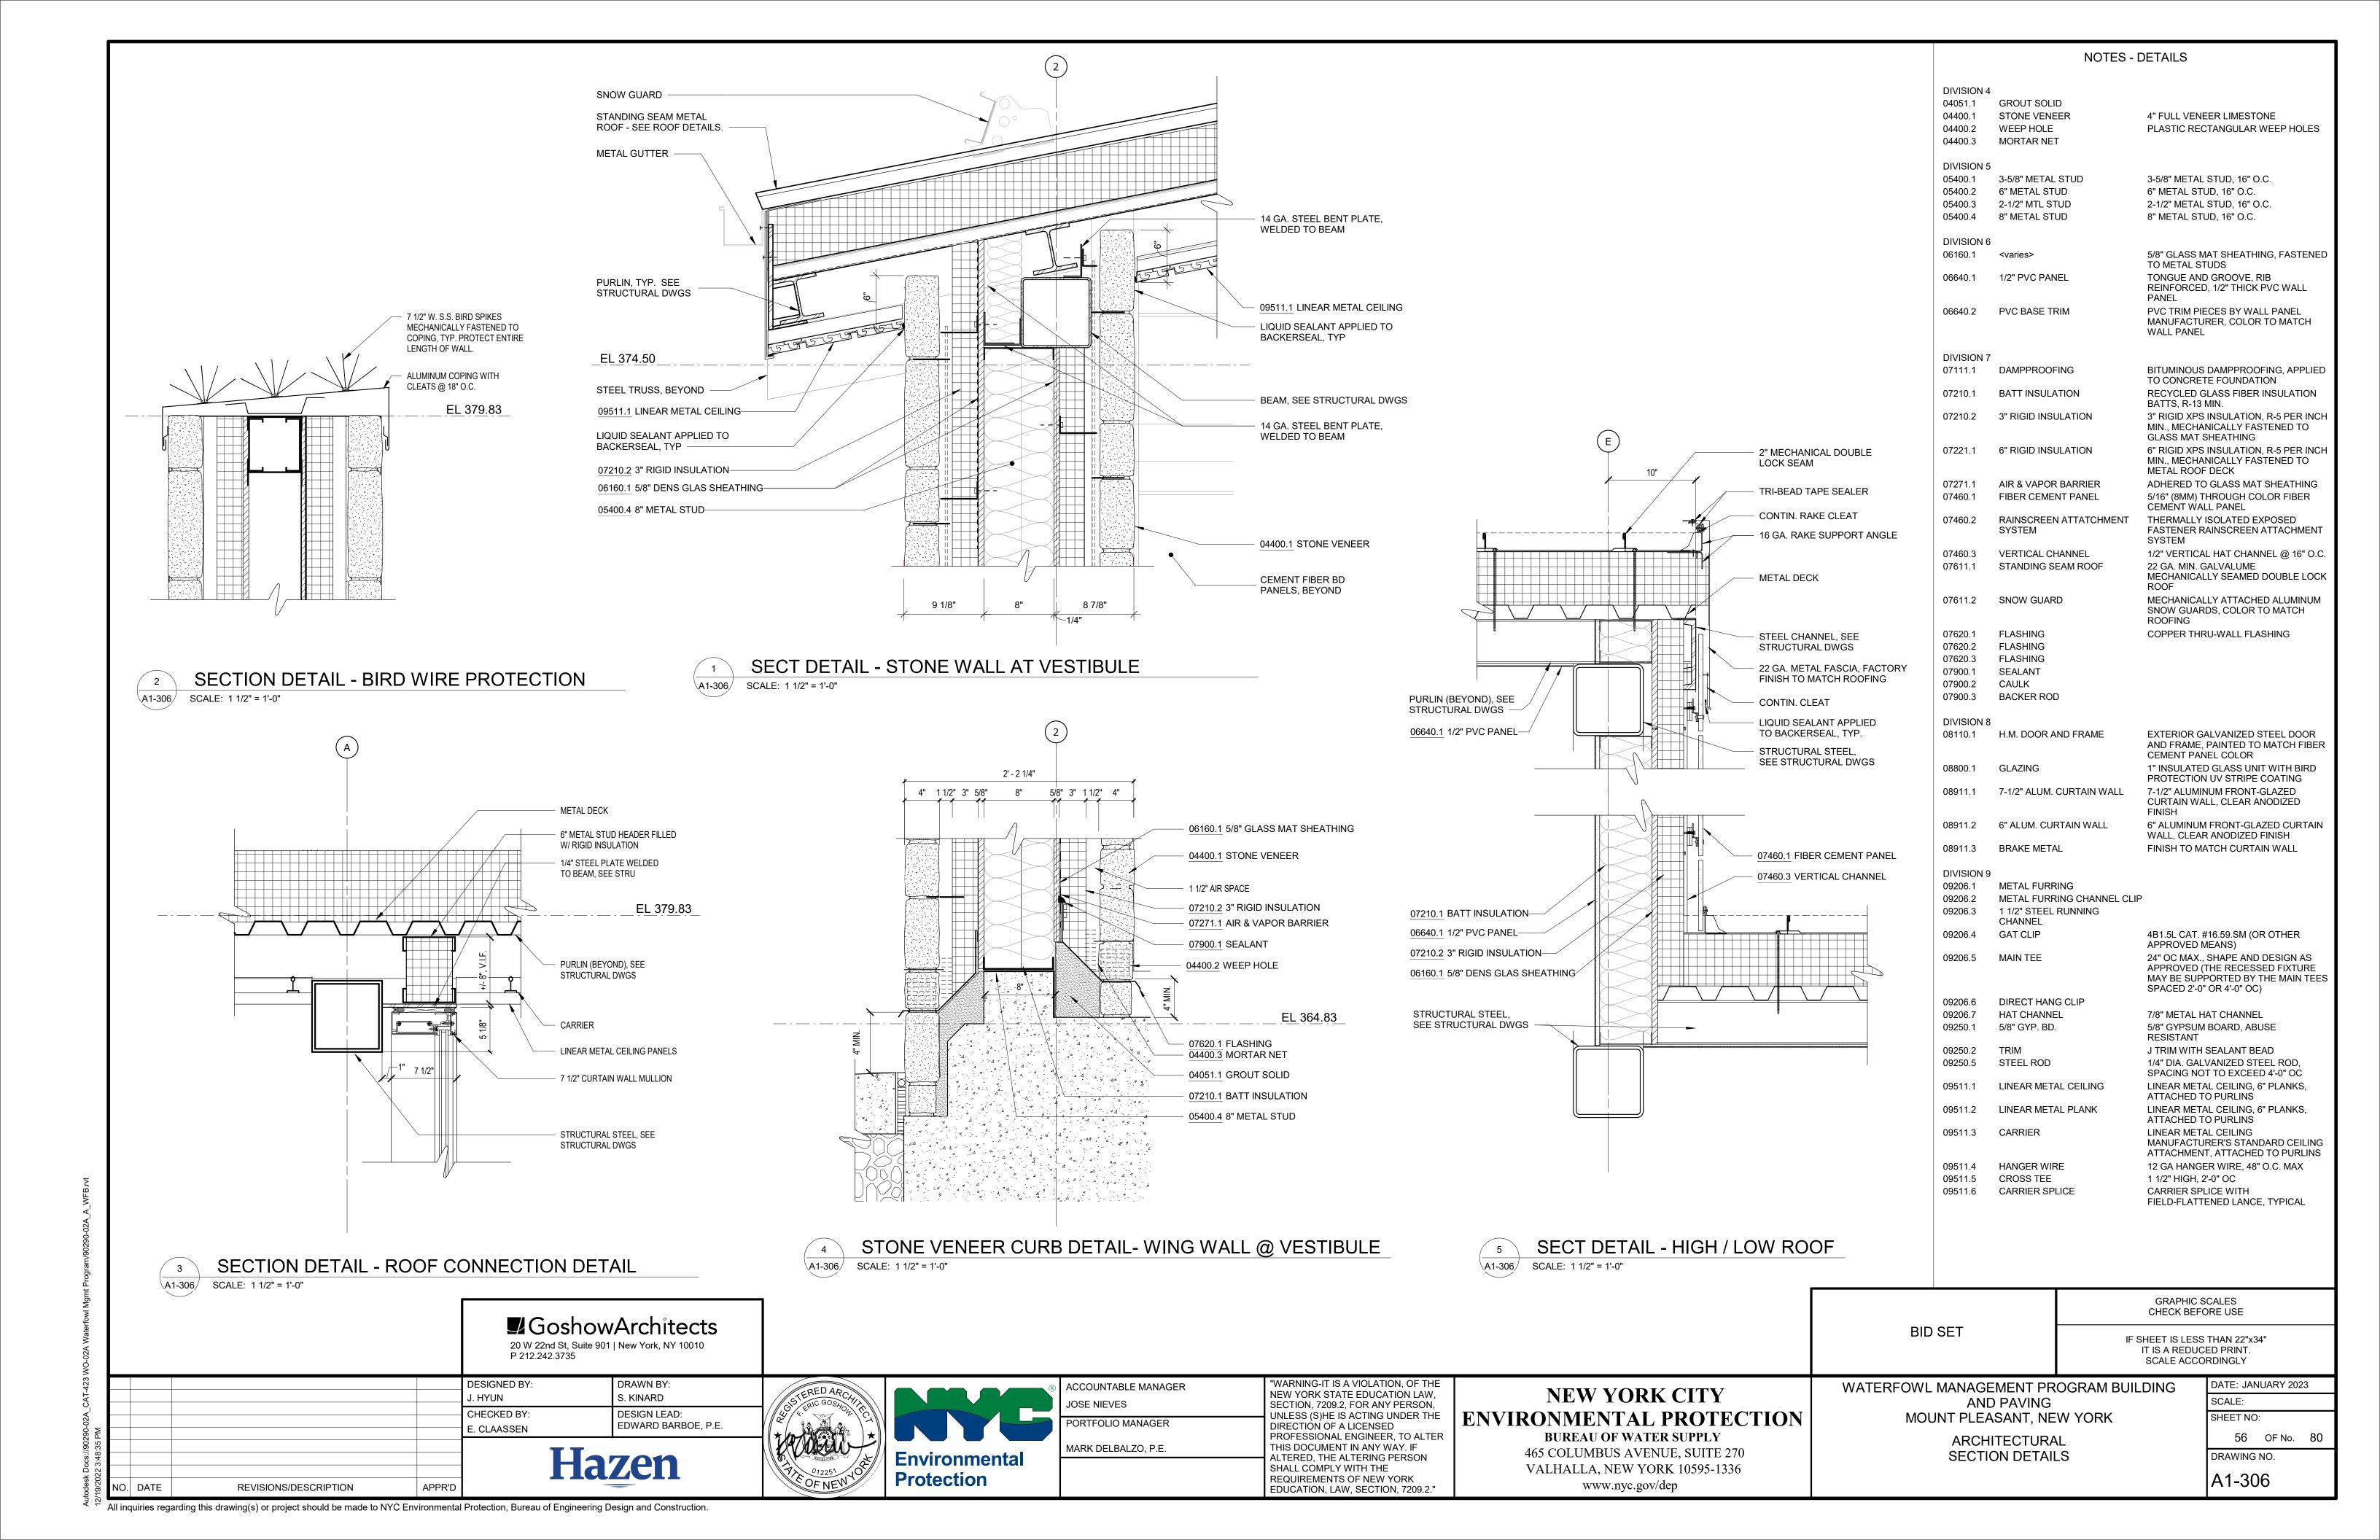

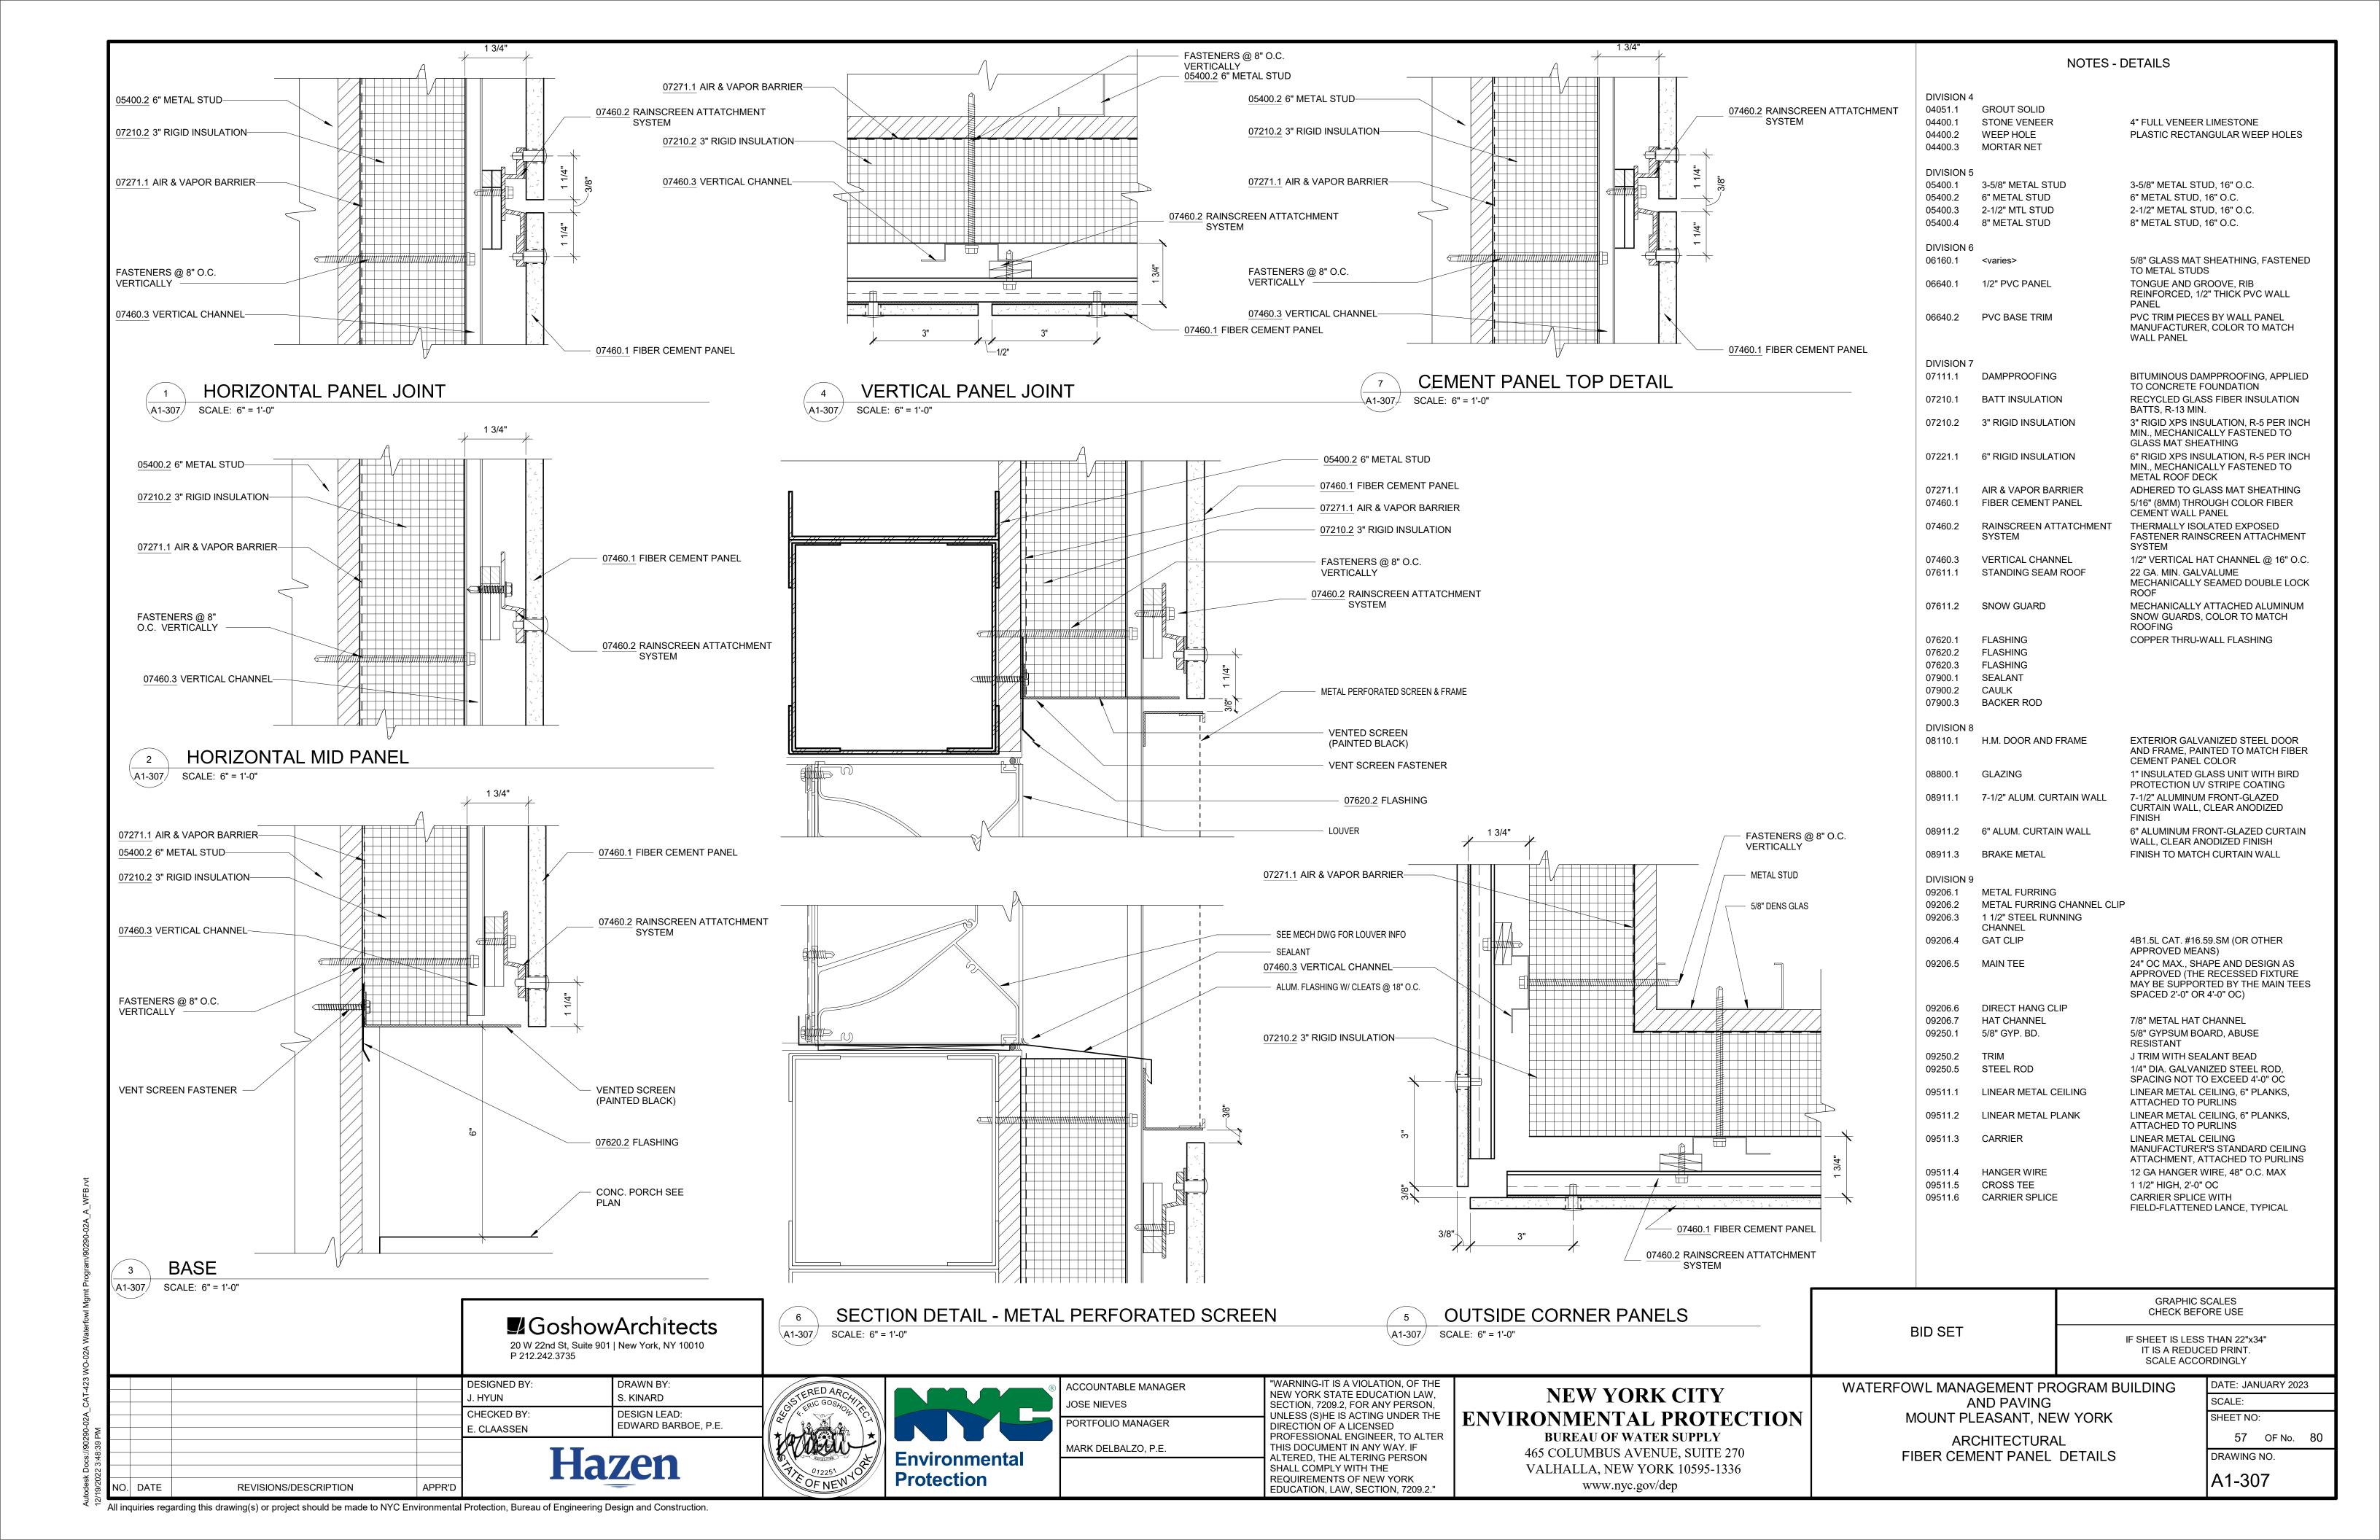

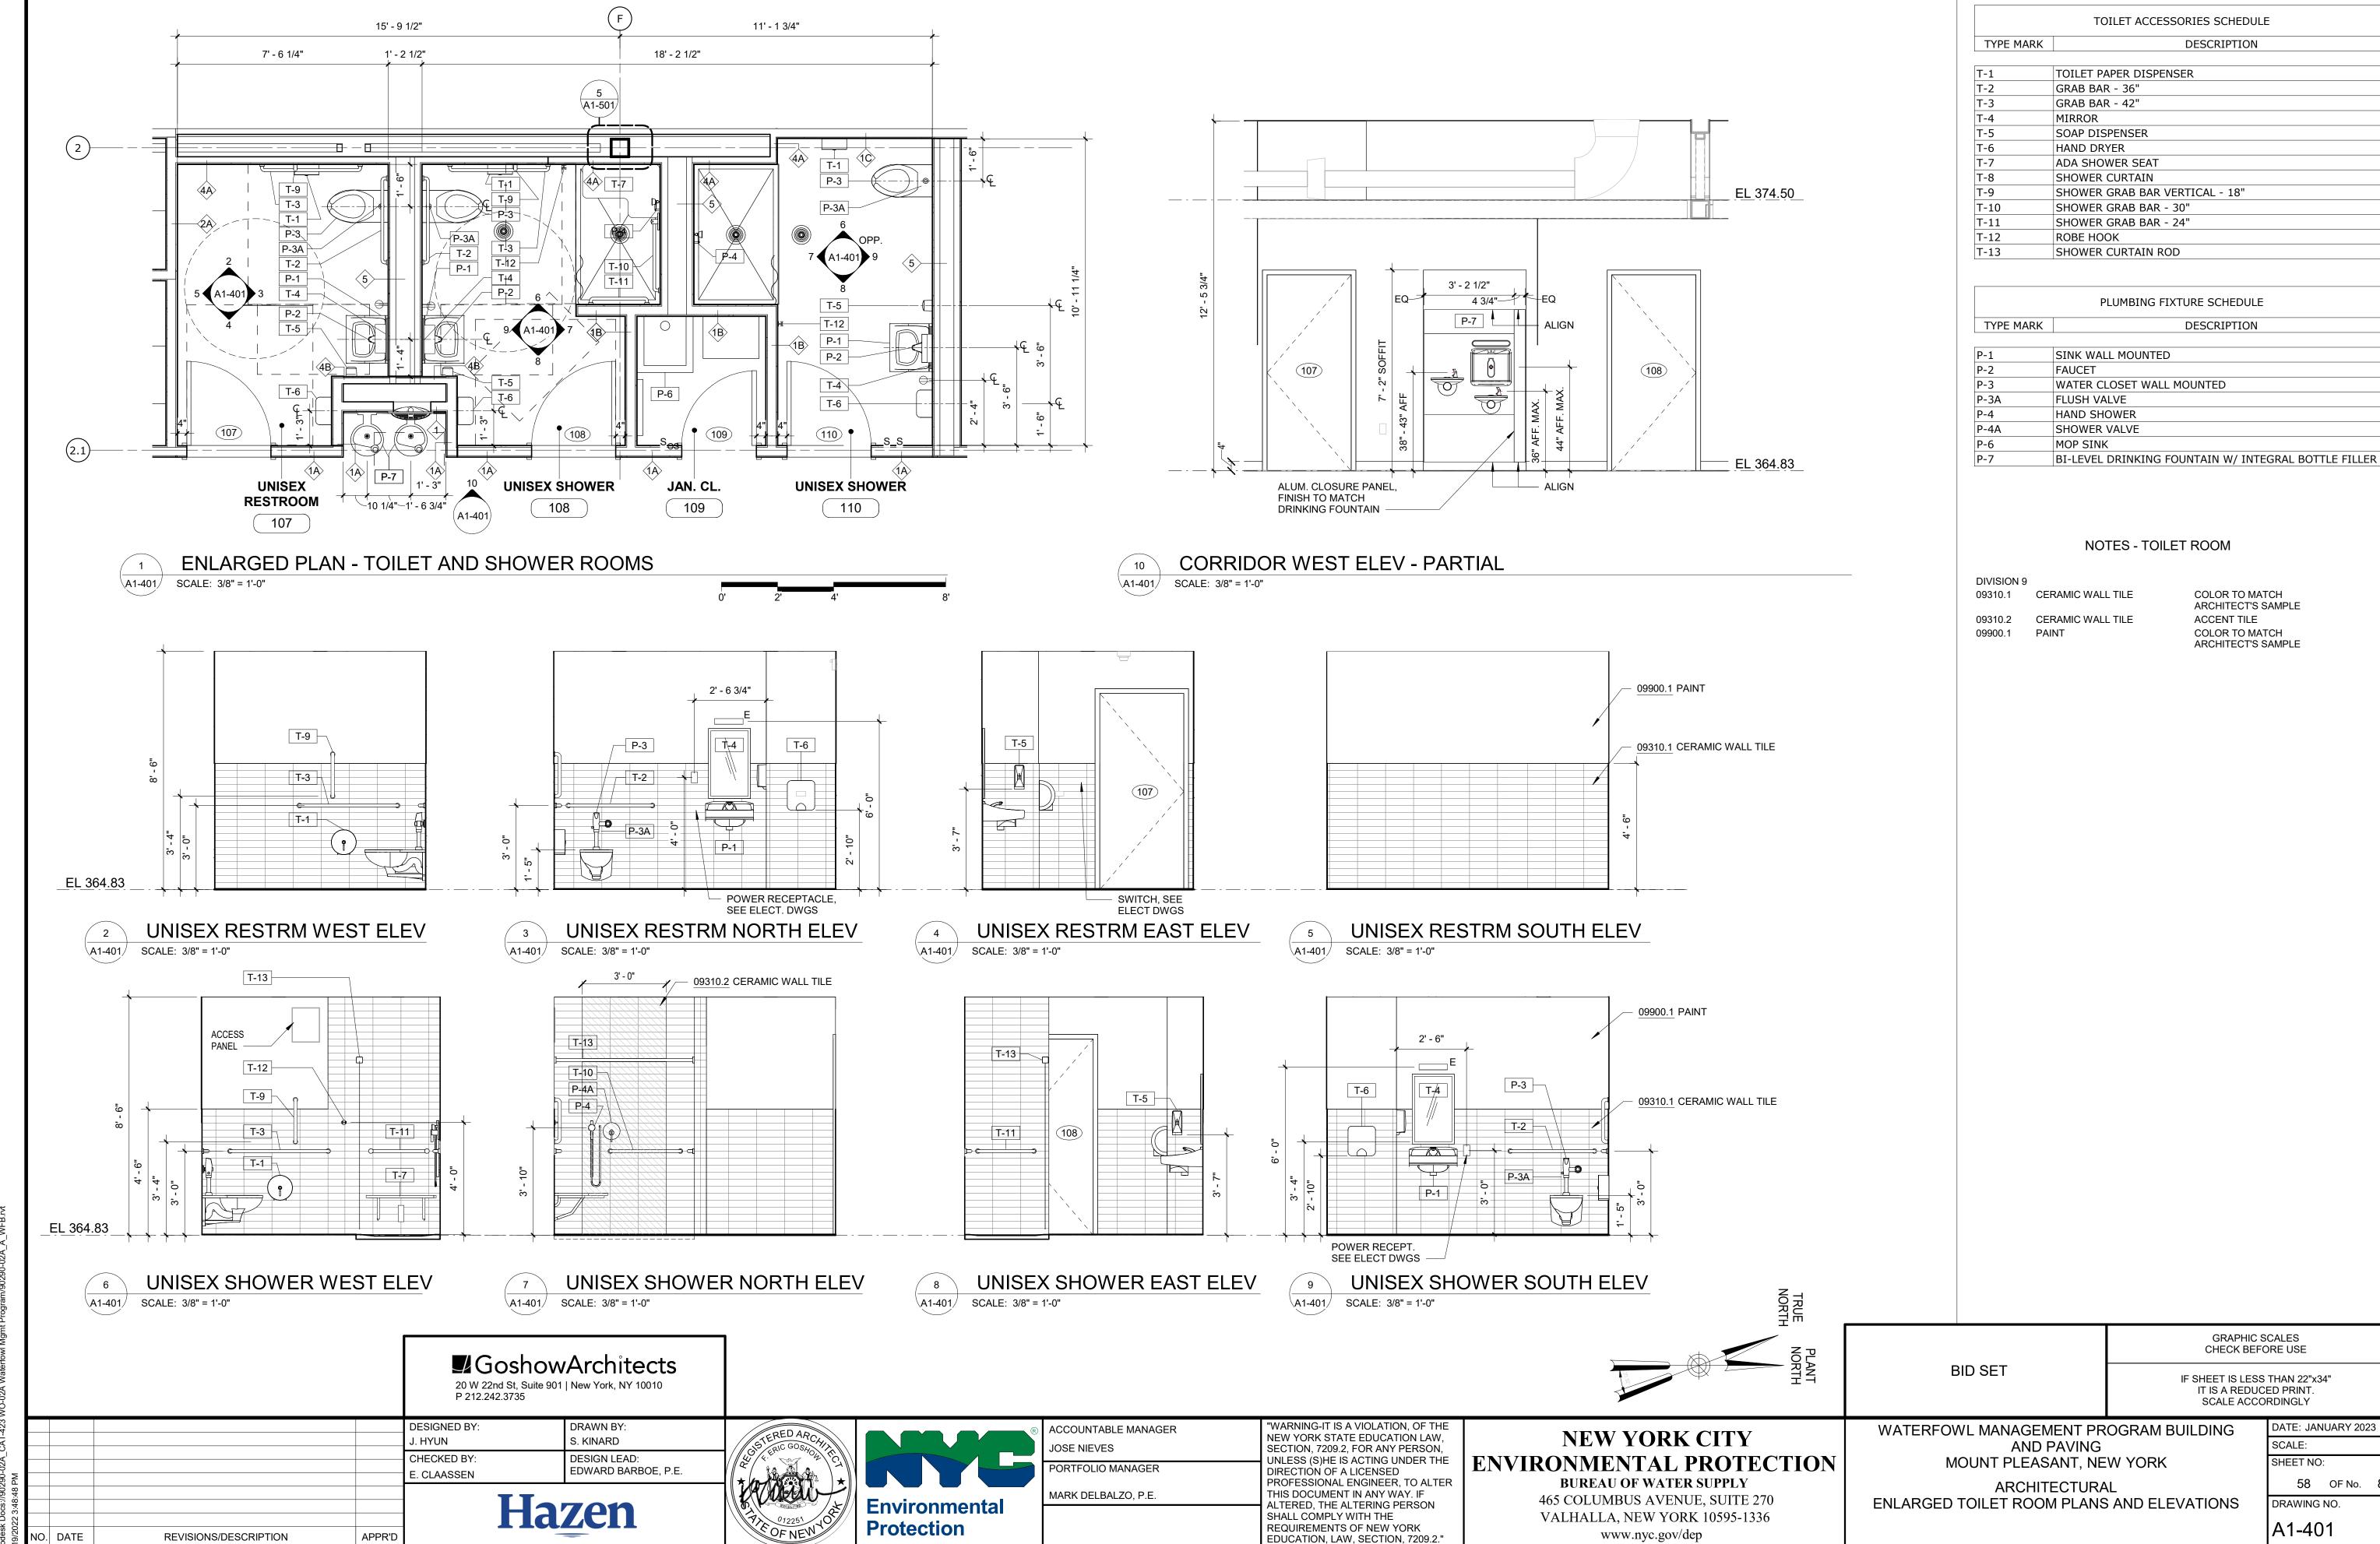

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TOILET ACCESSORIES SCHEDULE DESCRIPTION SHOWER GRAB BAR VERTICAL - 18"

	PLUMBING FIXTURE SCHEDULE				
TYPE MARK	DESCRIPTION				
P-1	SINK WALL MOUNTED				
P-2	FAUCET				
P-3	WATER CLOSET WALL MOUNTED				
P-3A	A FLUSH VALVE				
P-4	P-4 HAND SHOWER				
P-4A	P-4A SHOWER VALVE				
P-6	P-6 MOP SINK				


SION 9		
0.1	CERAMIC WALL TILE	COLOR TO MATCH
		ARCHITECT'S SAMPL
0.2	CERAMIC WALL TILE	ACCENT TILE
0.1	PAINT	COLOR TO MATCH


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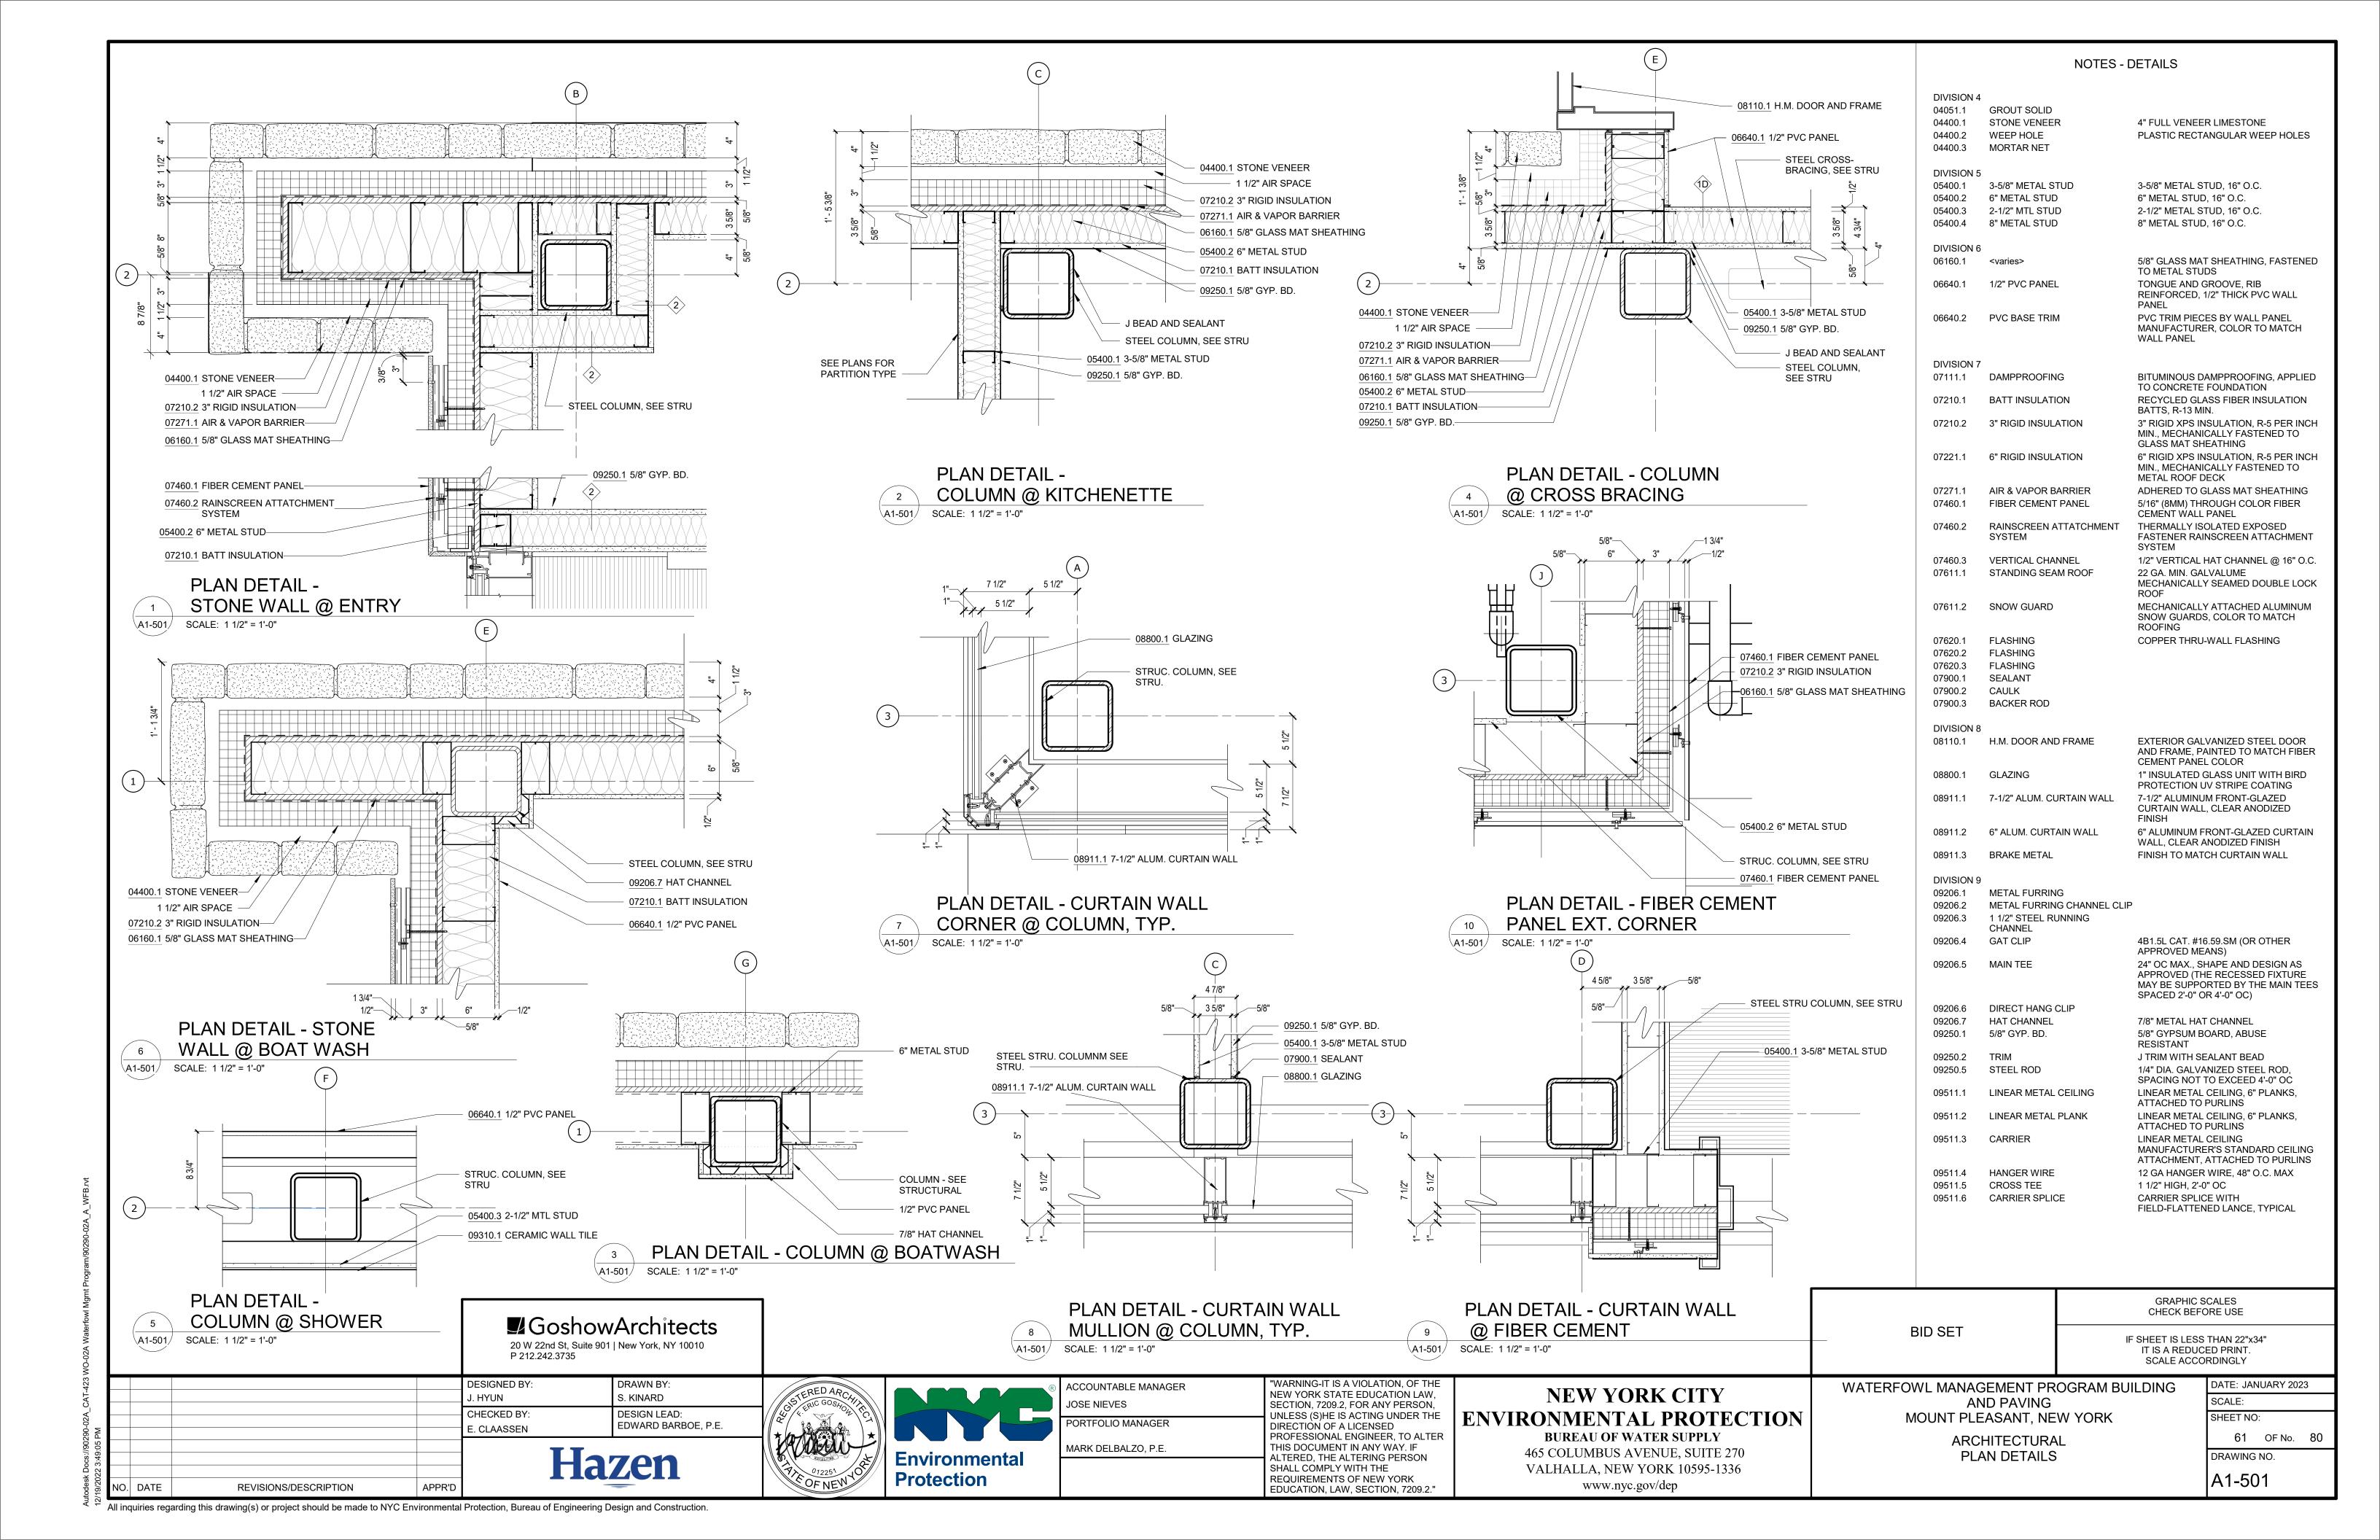
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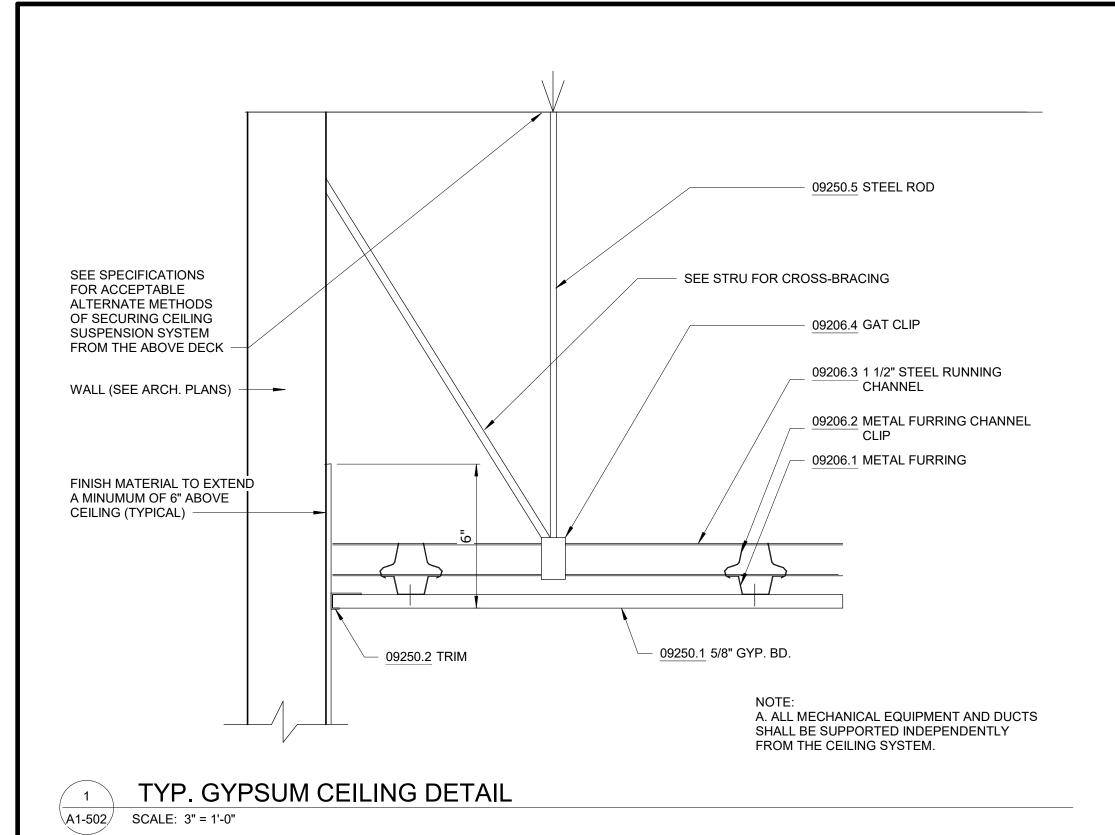
A1-401





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09250.5 STEEL ROD SEE SPECIFICATIONS SEE STRU FOR CROSS-BRACING FOR ACCEPTABLE ALTERNATE METHODS OF SECURING CEILING - 09206.4 GAT CLIP SUSPENSION SYSTEM FROM THE ABOVE DECK 09206.3 1 1/2" STEEL RUNNING CHANNEL WALL (SEE ARCH. PLANS) -09206.2 METAL FURRING CHANNEL 09206.1 METAL FURRING FINISH MATERIAL TO EXTEND A MINUMUM OF 6" ABOVE CEILING (TYPICAL) 09250.2 TRIM (2) LAYERS 5/8" GYP. BD. A. ALL MECHANICAL EQUIPMENT AND DUCTS

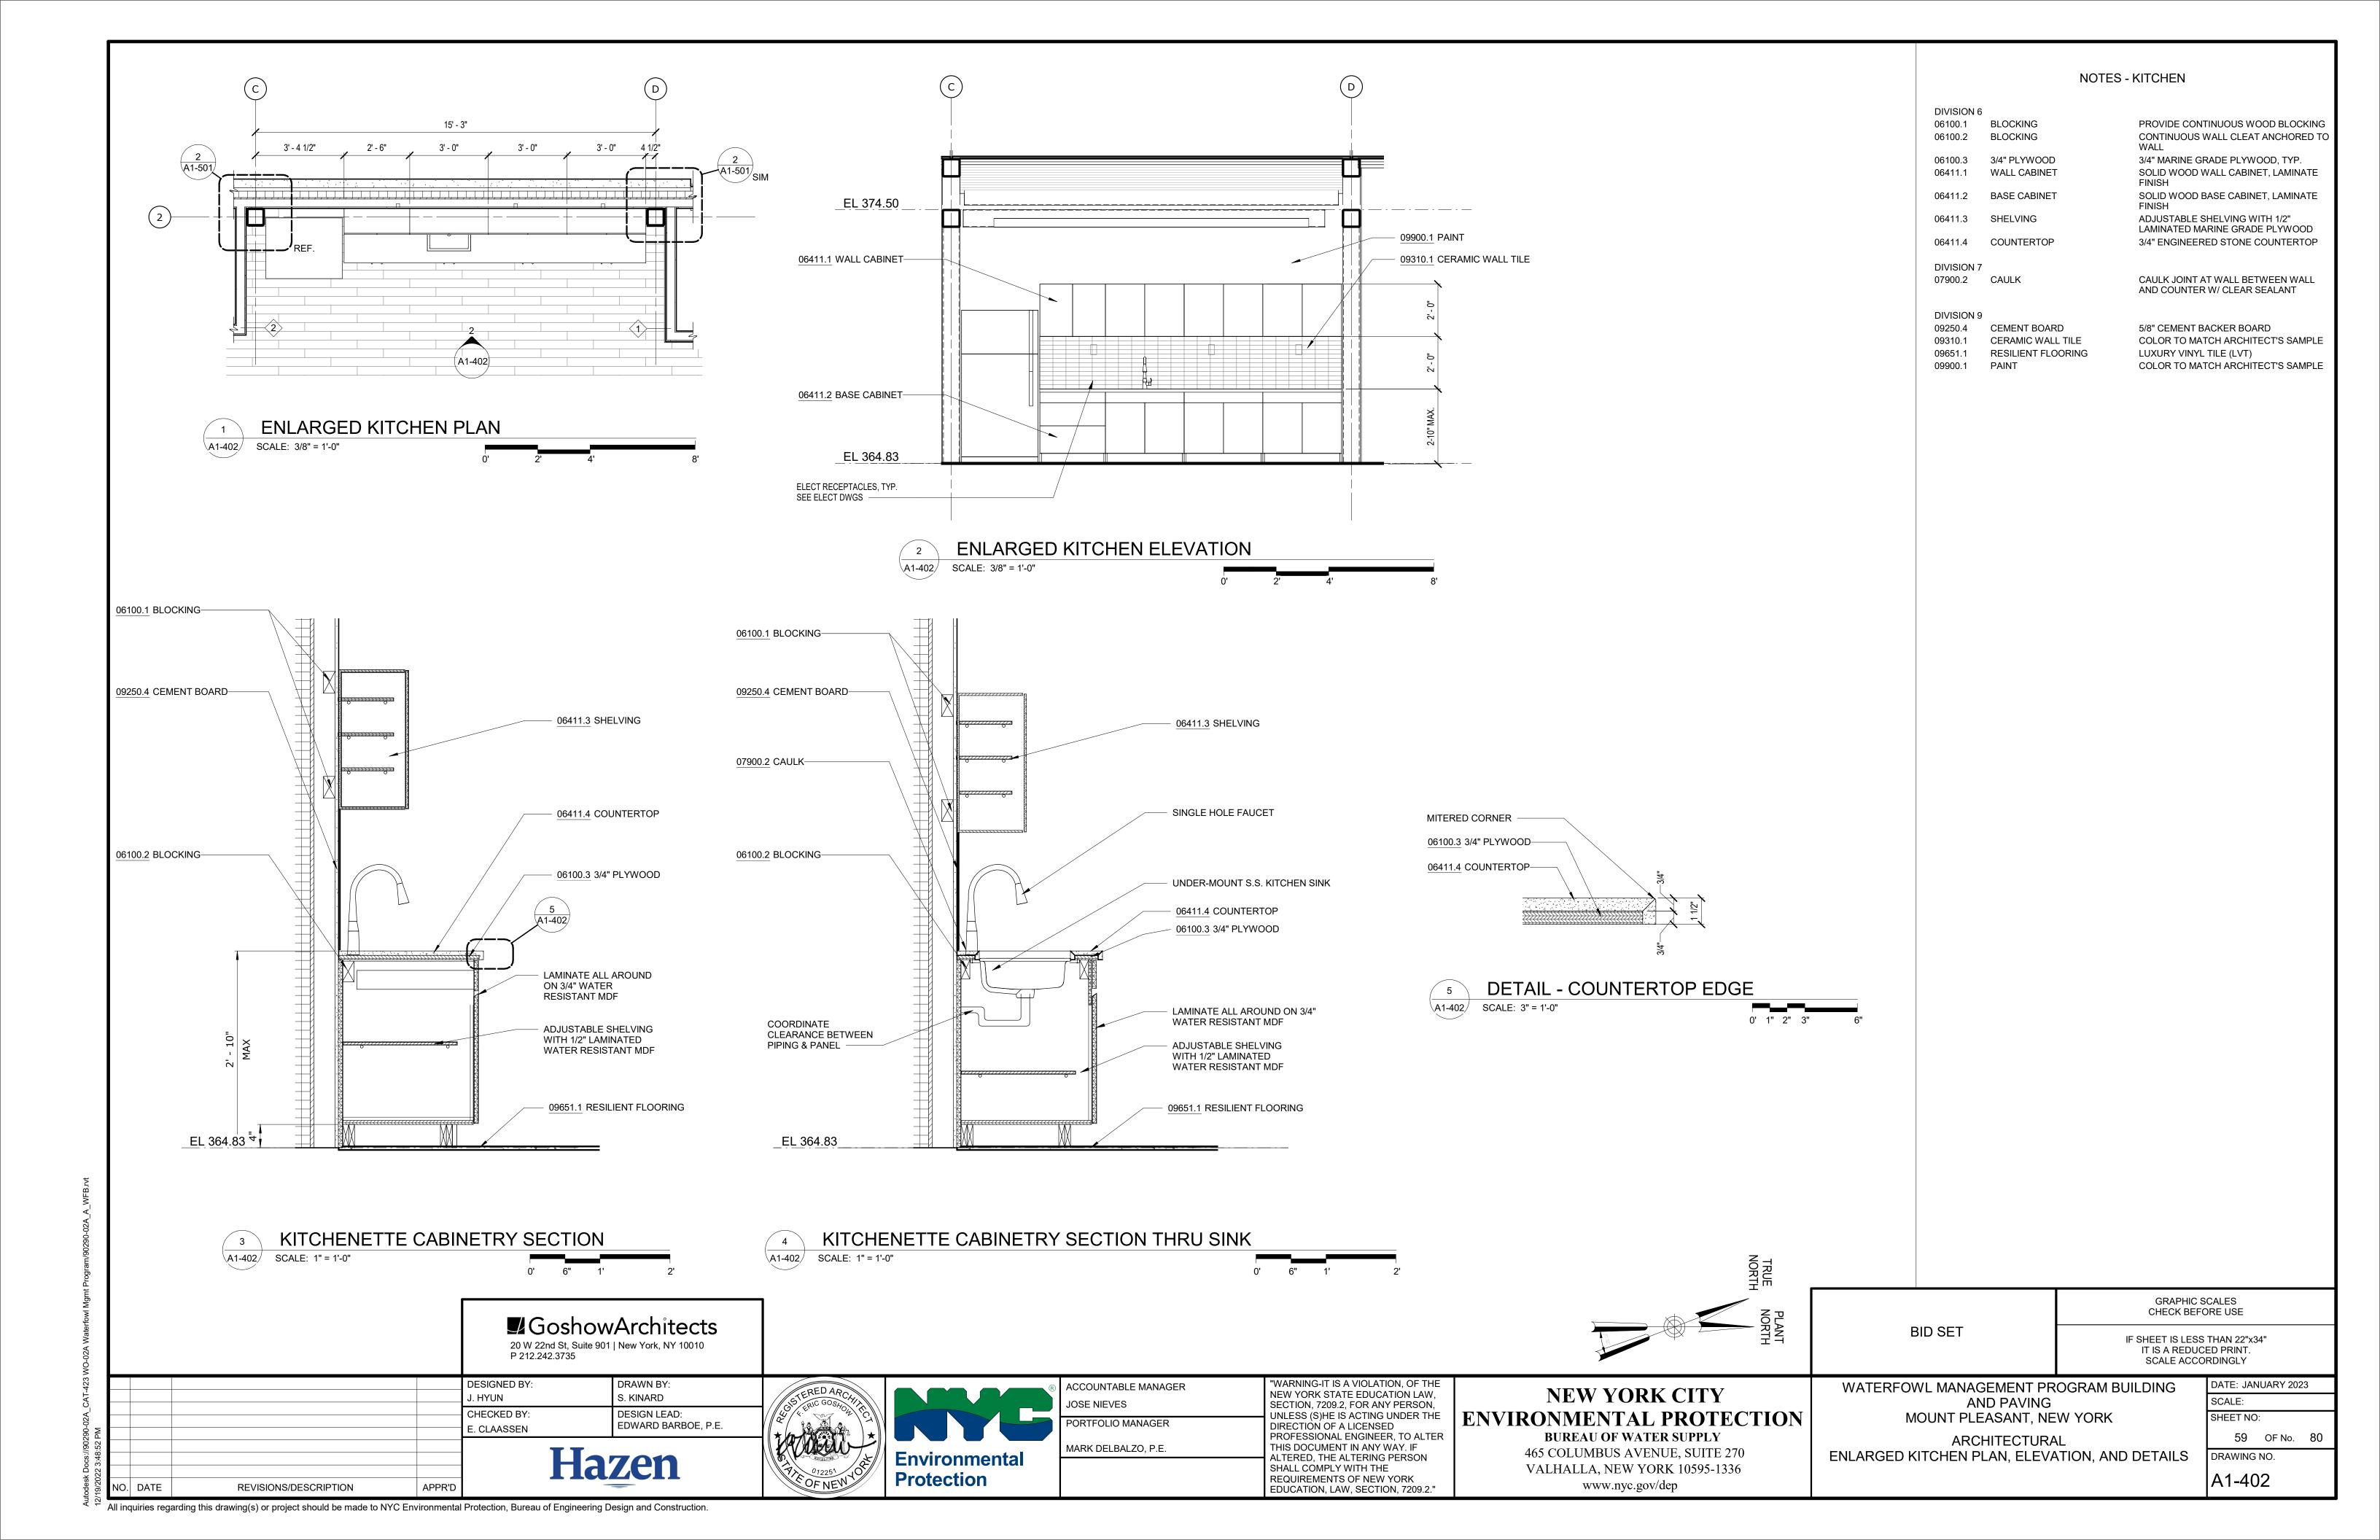GYPSUM CEILING DETAIL - 1 HOUR RATED (BASED ON GA FILE NOS. FC 5406 AND RC 2601) \A1-502\ SCALE: 3" = 1'-0"
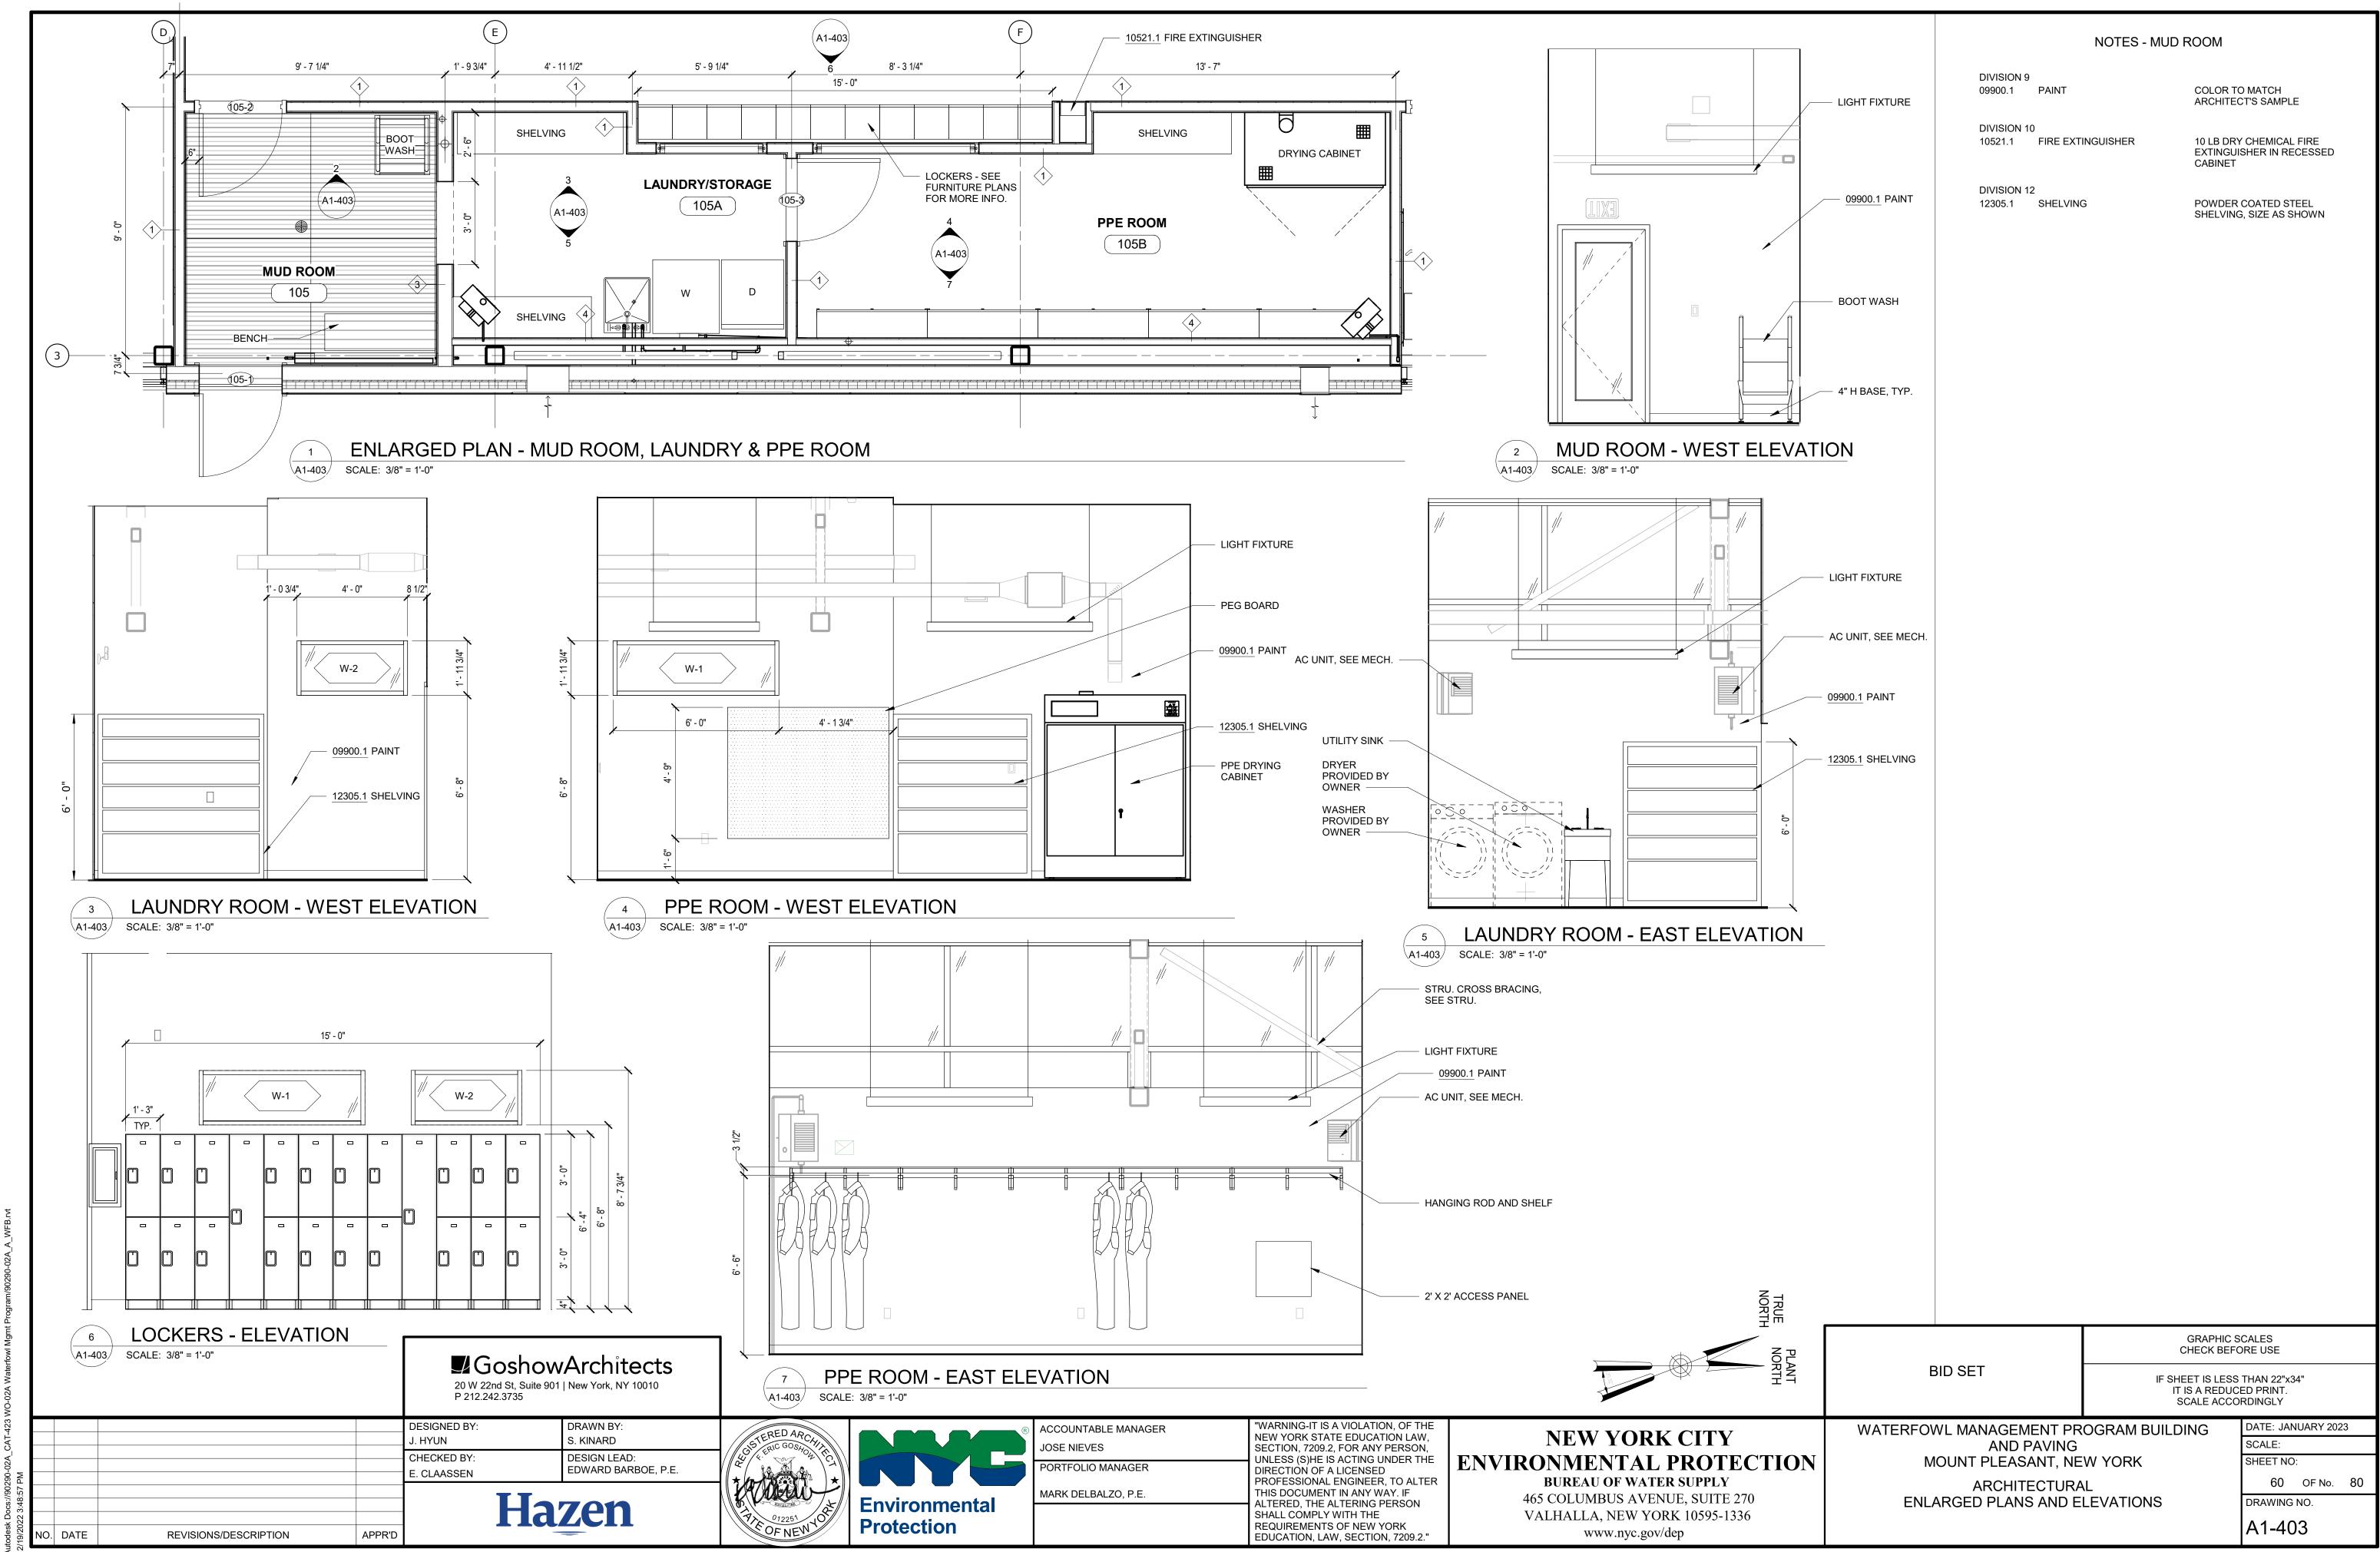
> **■** GoshowArchitects 20 W 22nd St, Suite 901 | New York, NY 10010 DRAWN BY: S. KINARD DESIGN LEAD: EDWARD BARBOE, P.E. Hazen

SHALL BE SUPPORTED INDEPENDENTLY

FROM THE CEILING SYSTEM.



ACCOUNTABLE MANAGER IOSE NIEVES PORTFOLIO MANAGER MARK DELBALZO, P.E.

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# **NEW YORK CITY ENVIRONMENTAL PROTECTION**

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WATERFOWL MANAGEMENT PROGRAM BUILDING AND PAVING MOUNT PLEASANT, NEW YORK

DATE: JANUARY 2023 SCALE: SHEET NO: 62 OF No. 80 DRAWING NO.

A1-502

09206.6 DIRECT HANG CLIP 09250.5 STEEL ROD 09206.4 GAT CLIP **VARIES TO SUIT** INSTALLATION CLEARANCE & LIGHT FIXTURE HEIGHT 09511.5 CROSS TEE 09206.5 MAIN TEE 09206.3 1 1/2" STEEL RUNNING CHANNEL

PROVIDE RESTRAINTS IN

ACCORDANCE TO CODE

**DIVISION 5** 05400.1 3-5/8" METAL STUD 05400.2 6" METAL STUD 05400.3 2-1/2" MTL STUD 05400.4 8" METAL STUD **DIVISION 6** 06160.1 <varies> 1/2" PVC PANEL 06640.1 PVC BASE TRIM 06640.2 **DIVISION** 07111.1 DAMPPROOFING BATT INSULATION 3" RIGID INSULATION 6" RIGID INSULATION 07221.1 07271.1 AIR & VAPOR BARRIER FIBER CEMENT PANEL 07460.1 07460.2 RAINSCREEN ATTATCHMENT SYSTEM 07611.1 07611.2 07620.1 07620.2 07620.3 07900.1 07900.2 07900.3 DIVISION 8 08110.1 08800.1 08911.1 BRAKE METAL

09206.1

09206.2

09206.3

09206.4

09206.5

09206.6

09511.5

**BID SET** 

**DIVISION 4** 04051.1

04400.1

04400.2

04400.3

**GROUT SOLID** 

WEEP HOLE

MORTAR NET

STONE VENEER

FASTENER RAINSCREEN ATTACHMENT SYSTEM VERTICAL CHANNEL 1/2" VERTICAL HAT CHANNEL @ 16" O.C. STANDING SEAM ROOF 22 GA. MIN. GALVALUME MECHANICALLY SEAMED DOUBLE LOCK MECHANICALLY ATTACHED ALUMINUM SNOW GUARD SNOW GUARDS, COLOR TO MATCH ROOFING FLASHING COPPER THRU-WALL FLASHING FLASHING FLASHING SEALANT CAULK BACKER ROD H.M. DOOR AND FRAME EXTERIOR GALVANIZED STEEL DOOR AND FRAME, PAINTED TO MATCH FIBER CEMENT PANEL COLOR 1" INSULATED GLASS UNIT WITH BIRD GLAZING PROTECTION UV STRIPE COATING 7-1/2" ALUM. CURTAIN WALL 7-1/2" ALUMINUM FRONT-GLAZED **CURTAIN WALL, CLEAR ANODIZED** FINISH 6" ALUM. CURTAIN WALL 6" ALUMINUM FRONT-GLAZED CURTAIN WALL, CLEAR ANODIZED FINISH

METAL FURRING

METAL FURRING CHANNEL CLIP 1 1/2" STEEL RUNNING **CHANNEL** GAT CLIP 4B1.5L CAT. #16.59.SM (OR OTHER APPROVED MEANS) 24" OC MAX., SHAPE AND DESIGN AS APPROVED (THE RECESSED FIXTURE MAIN TEE MAY BE SUPPORTED BY THE MAIN TEES SPACED 2'-0" OR 4'-0" OC) DIRECT HANG CLIP

**NOTES - DETAILS** 

4" FULL VENEER LIMESTONE

3-5/8" METAL STUD, 16" O.C.

2-1/2" METAL STUD, 16" O.C.

TONGUE AND GROOVE, RIB

TO CONCRETE FOUNDATION

GLASS MAT SHEATHING

METAL ROOF DECK

CEMENT WALL PANEL

6" METAL STUD, 16" O.C.

8" METAL STUD, 16" O.C.

TO METAL STUDS

PANEL

WALL PANEL

BATTS, R-13 MIN.

PLASTIC RECTANGULAR WEEP HOLES

5/8" GLASS MAT SHEATHING, FASTENED

REINFORCED, 1/2" THICK PVC WALL

PVC TRIM PIECES BY WALL PANEL

MANUFACTURER, COLOR TO MATCH

BITUMINOUS DAMPPROOFING, APPLIED

RECYCLED GLASS FIBER INSULATION

3" RIGID XPS INSULATION, R-5 PER INCH MIN., MECHANICALLY FASTENED TO

6" RIGID XPS INSULATION, R-5 PER INCH

MIN., MECHANICALLY FASTENED TO

ADHERED TO GLASS MAT SHEATHING

5/16" (8MM) THROUGH COLOR FIBER

THERMALLY ISOLATED EXPOSED

FINISH TO MATCH CURTAIN WALL

7/8" METAL HAT CHANNEL

HAT CHANNEL 09206.7 09250.1 5/8" GYP. BD. 5/8" GYPSUM BOARD, ABUSE RESISTANT 09250.2 TRIM J TRIM WITH SEALANT BEAD 1/4" DIA. GALVANIZED STEEL ROD, 09250.5 STEEL ROD SPACING NOT TO EXCEED 4'-0" OC LINEAR METAL CEILING, 6" PLANKS, 09511.1 LINEAR METAL CEILING ATTACHED TO PURLINS 09511.2

LINEAR METAL PLANK LINEAR METAL CEILING, 6" PLANKS, ATTACHED TO PURLINS LINEAR METAL CEILING MANUFACTURER'S STANDARD CEILING 09511.3 CARRIER ATTACHMENT, ATTACHED TO PURLINS HANGER WIRE

12 GA HANGER WIRE, 48" O.C. MAX CROSS TEE 1 1/2" HIGH, 2'-0" OC CARRIER SPLICE WITH 09511.6 CARRIER SPLICE FIELD-FLATTENED LANCE, TYPICAL

> GRAPHIC SCALES CHECK BEFORE USE

> > IF SHEET IS LESS THAN 22"x34" IT IS A REDUCED PRINT. SCALE ACCORDINGLY

**ARCHITECTURAL** GYPSUM CEILING DETAILS

NO. DATE

REVISIONS/DESCRIPTION

SHALL COMPLY WITH THE REQUIREMENTS OF NEW YORK

**GYPSUM CEILING DETAIL** 

SCALE: 1" = 1'-0"

\A1-502/

P 212.242.3735


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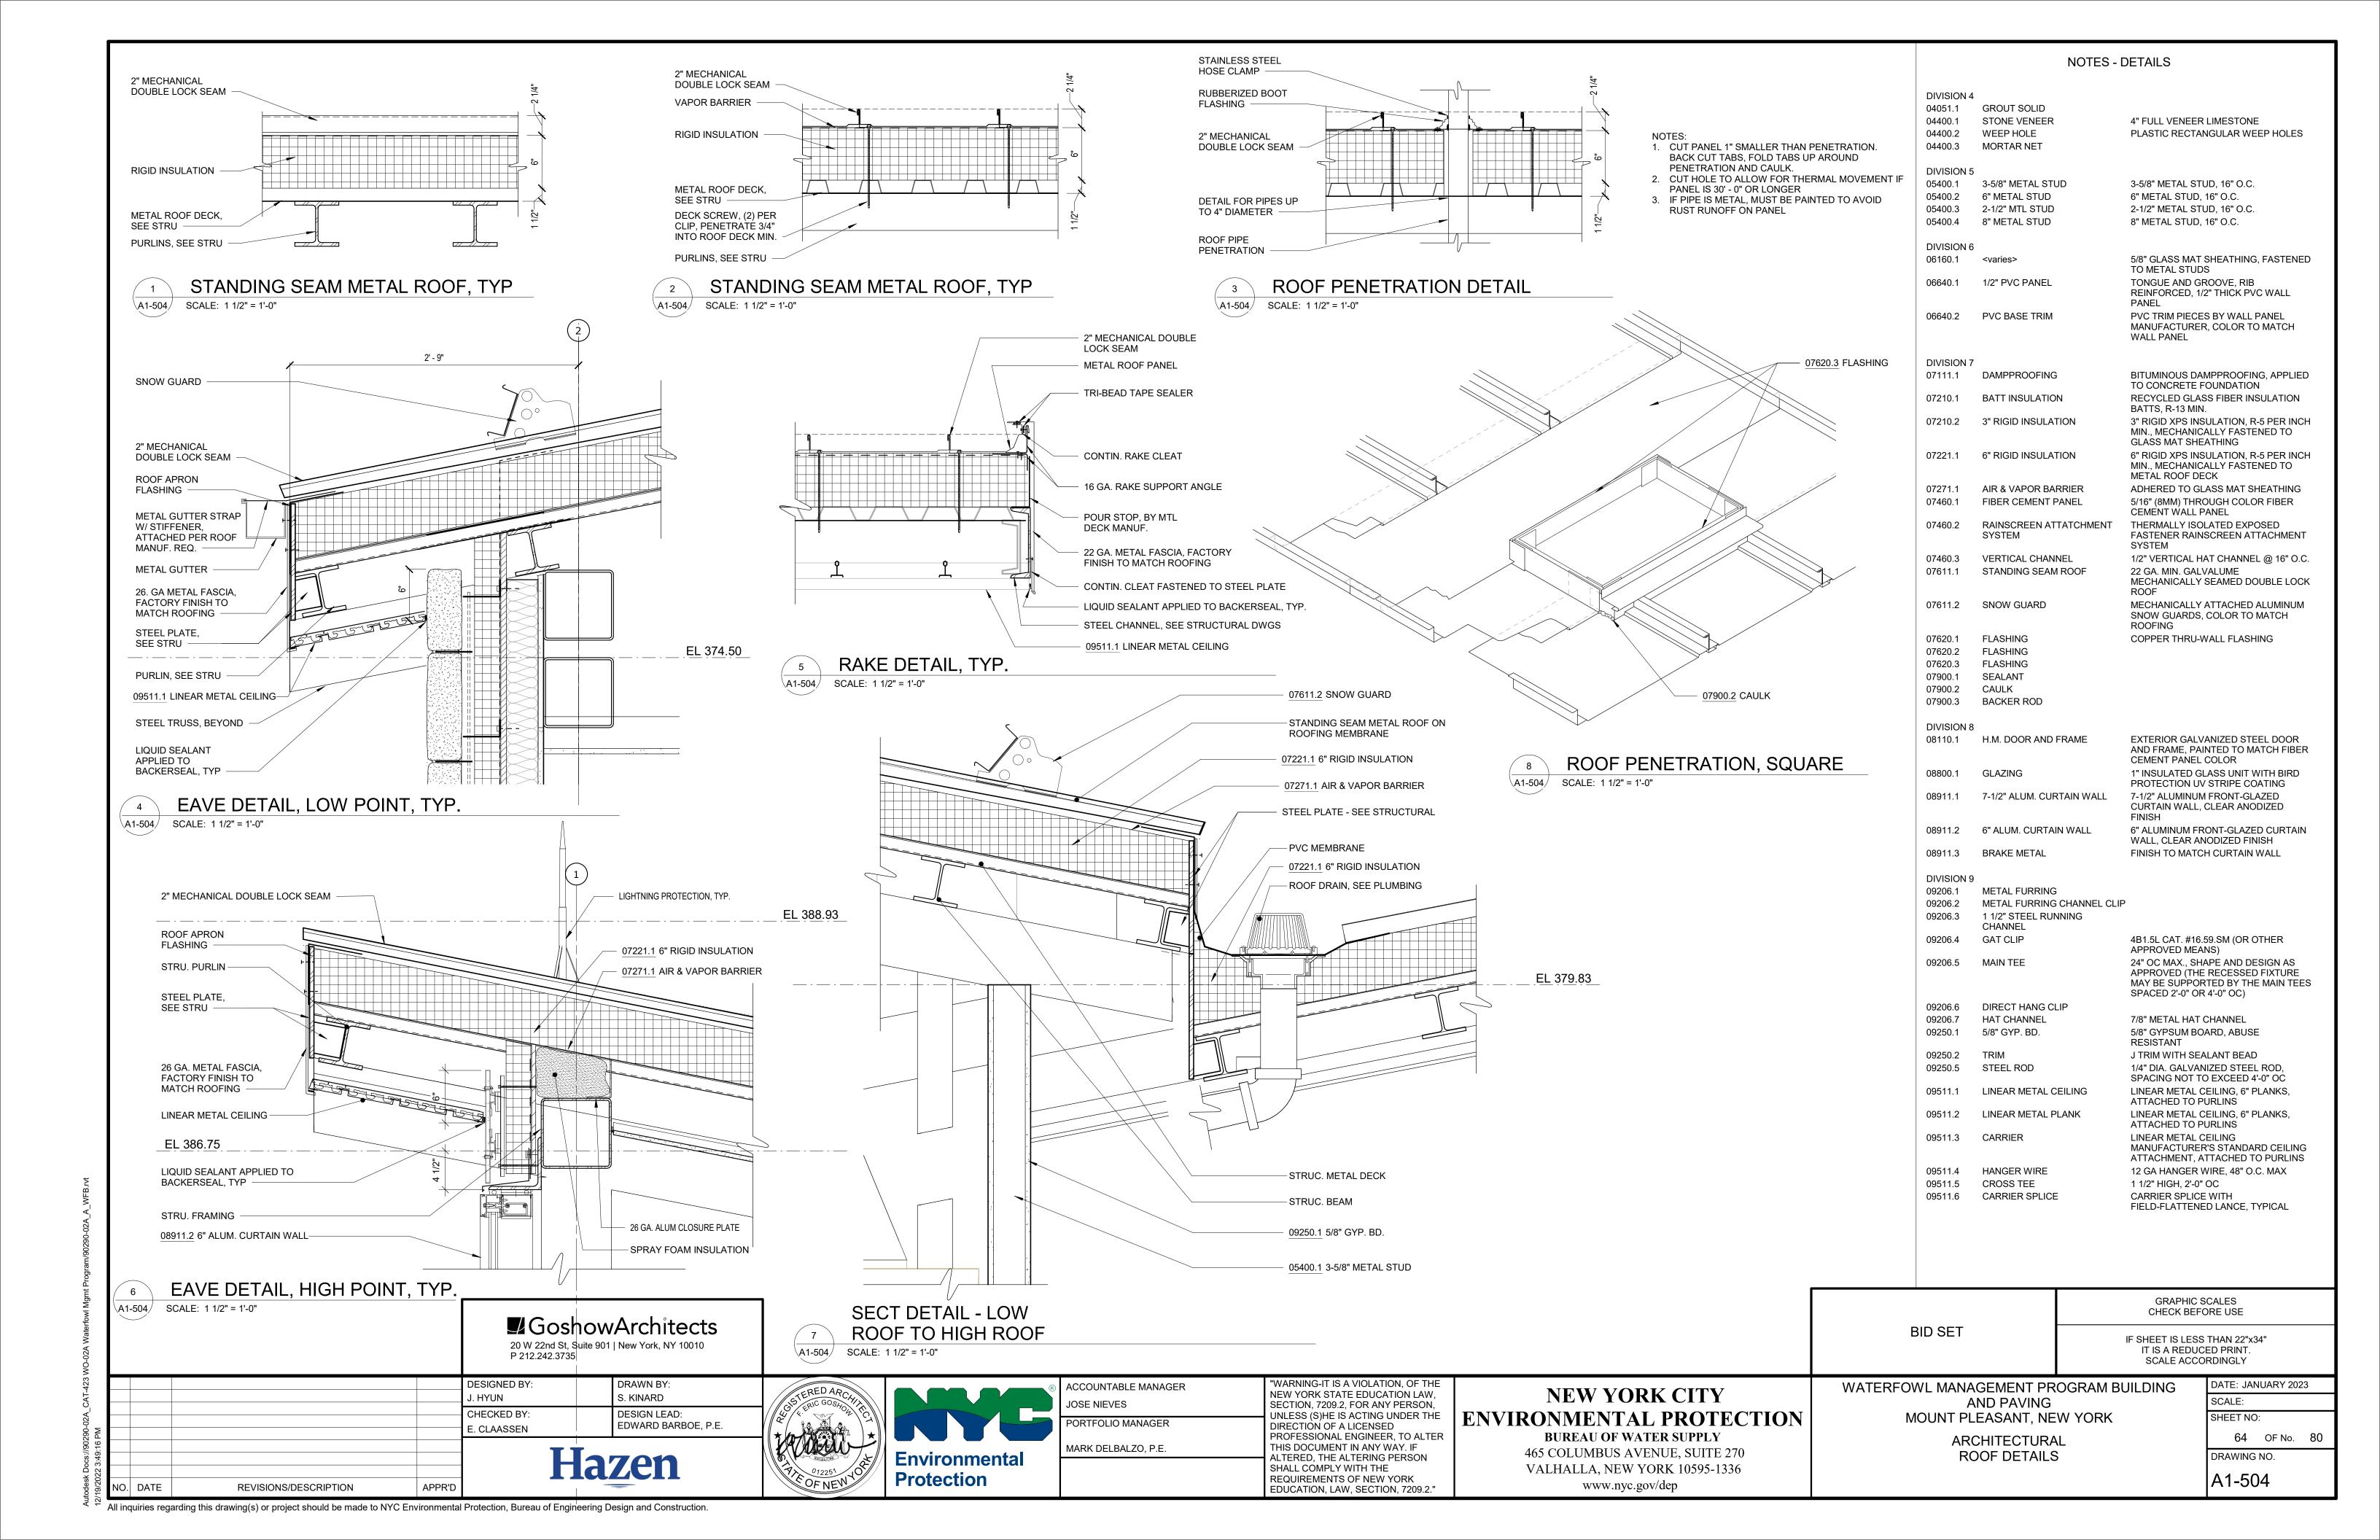
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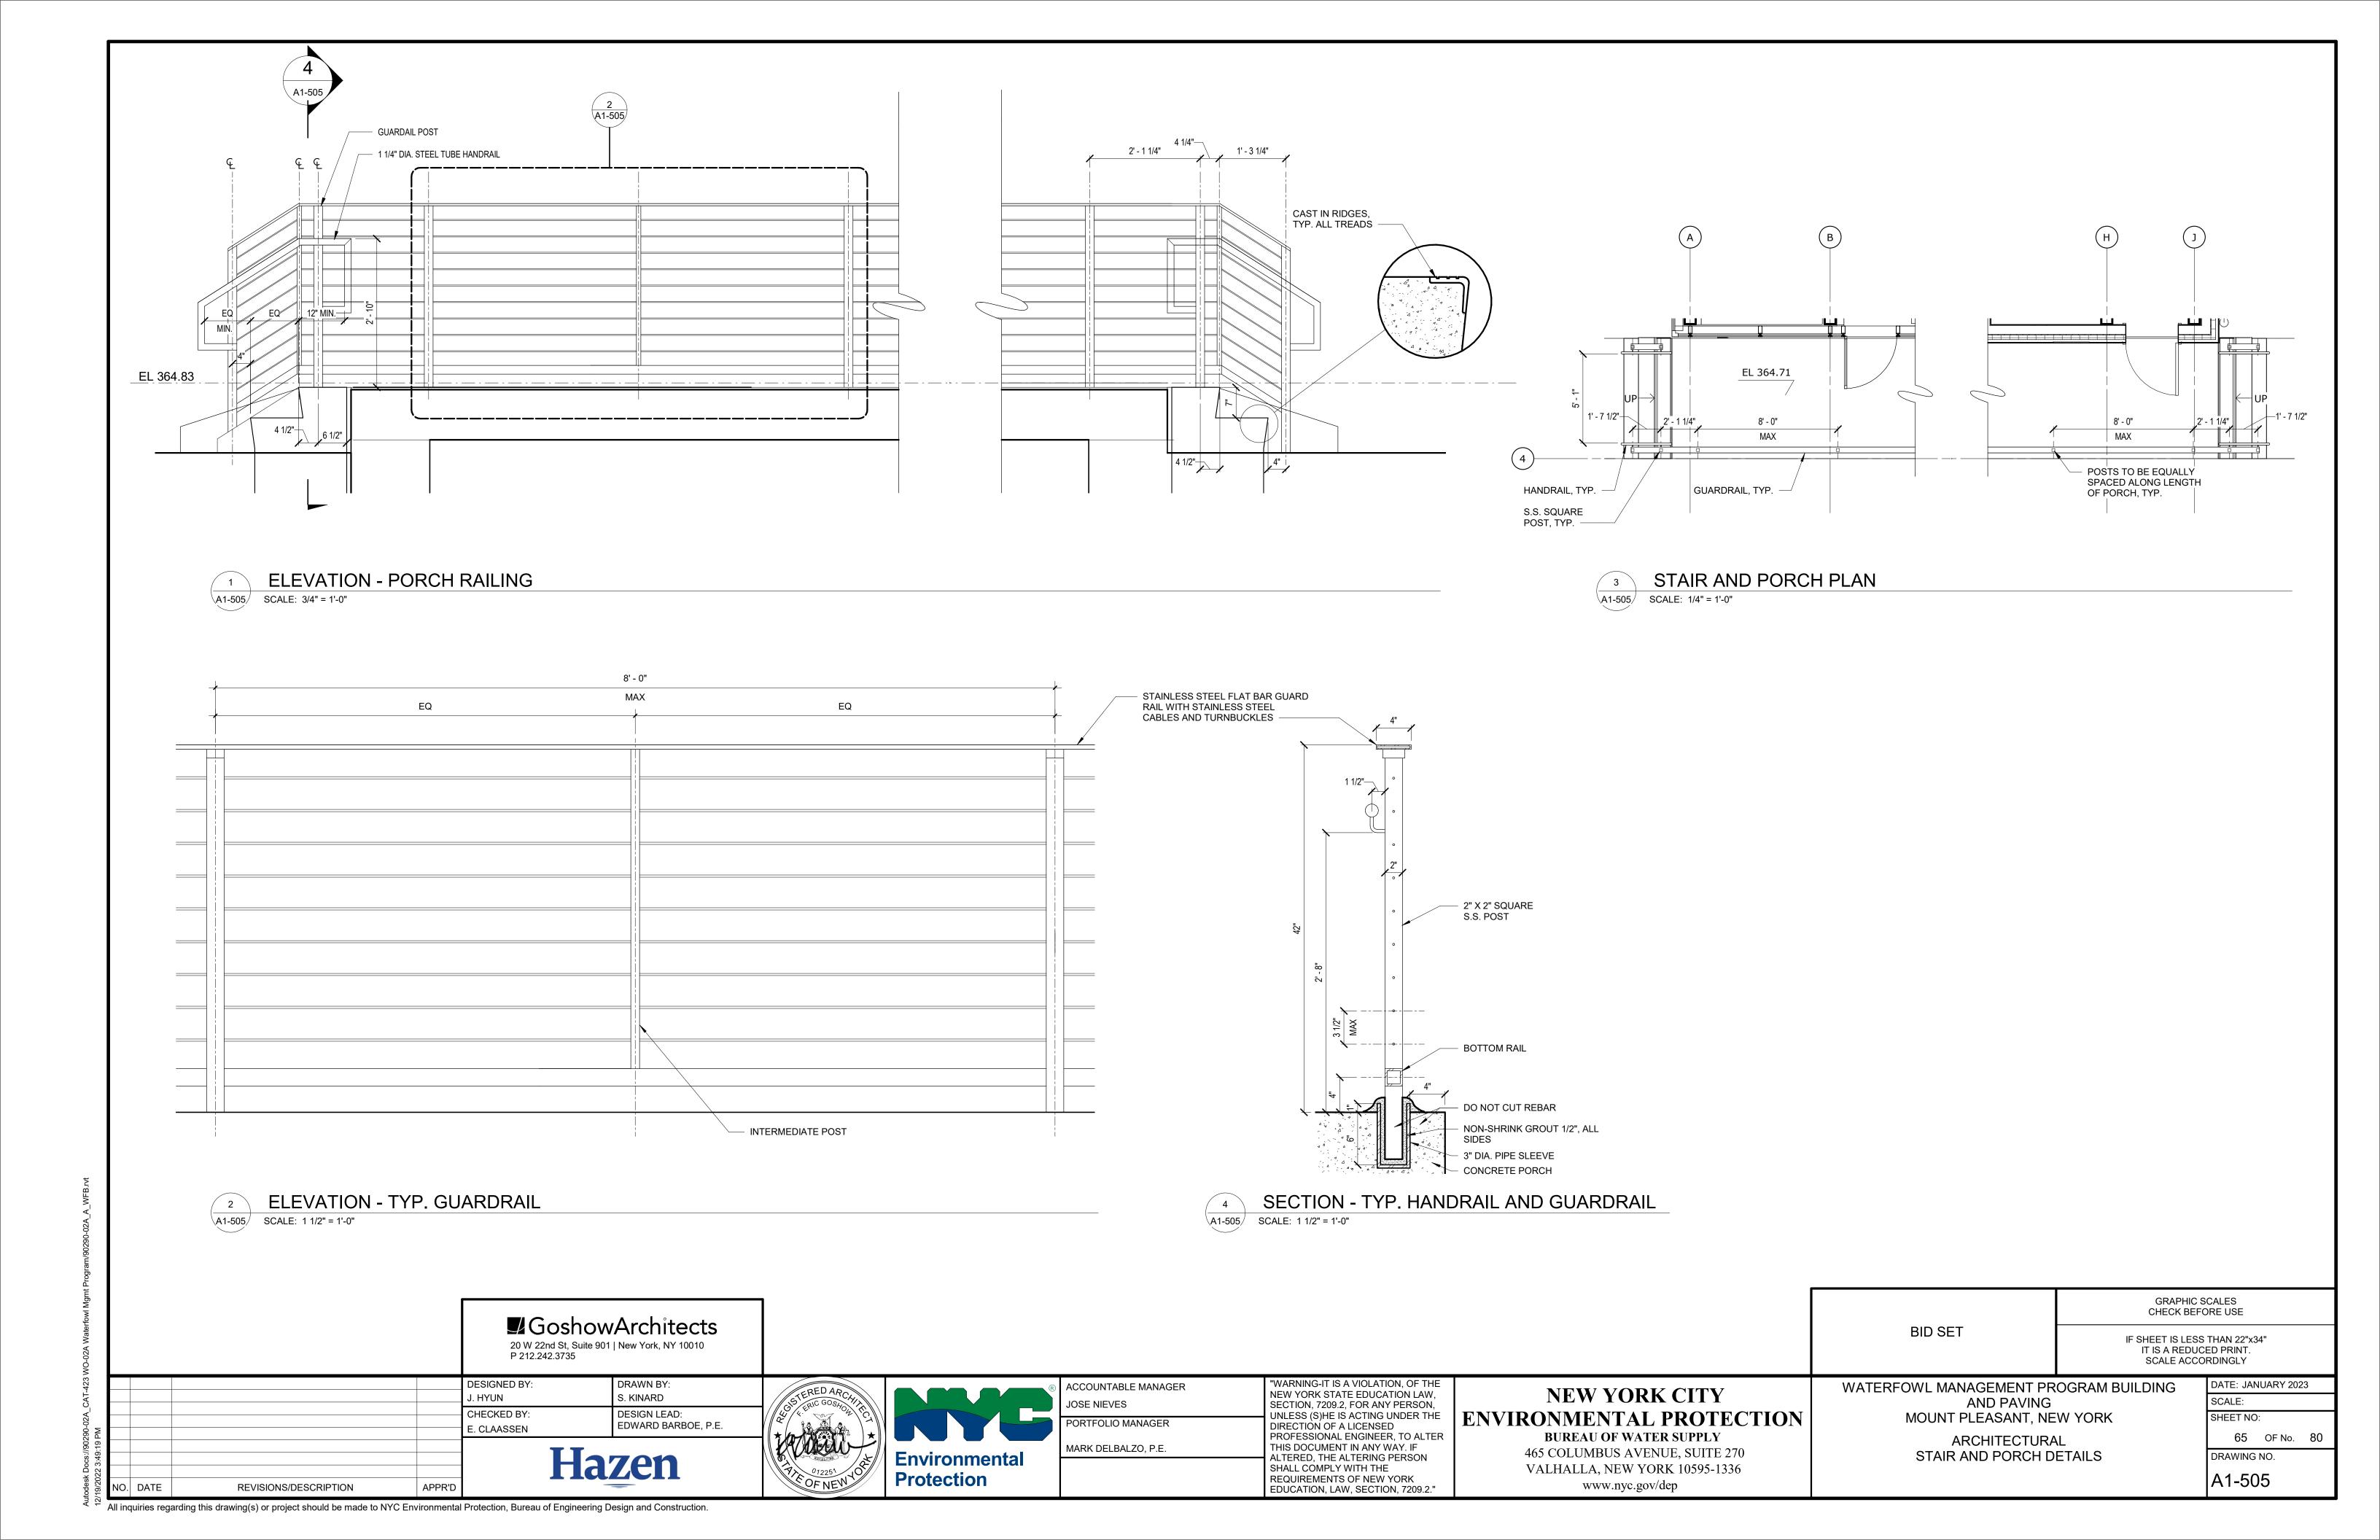
E. CLAASSEN


J. HYUN


APPR'D







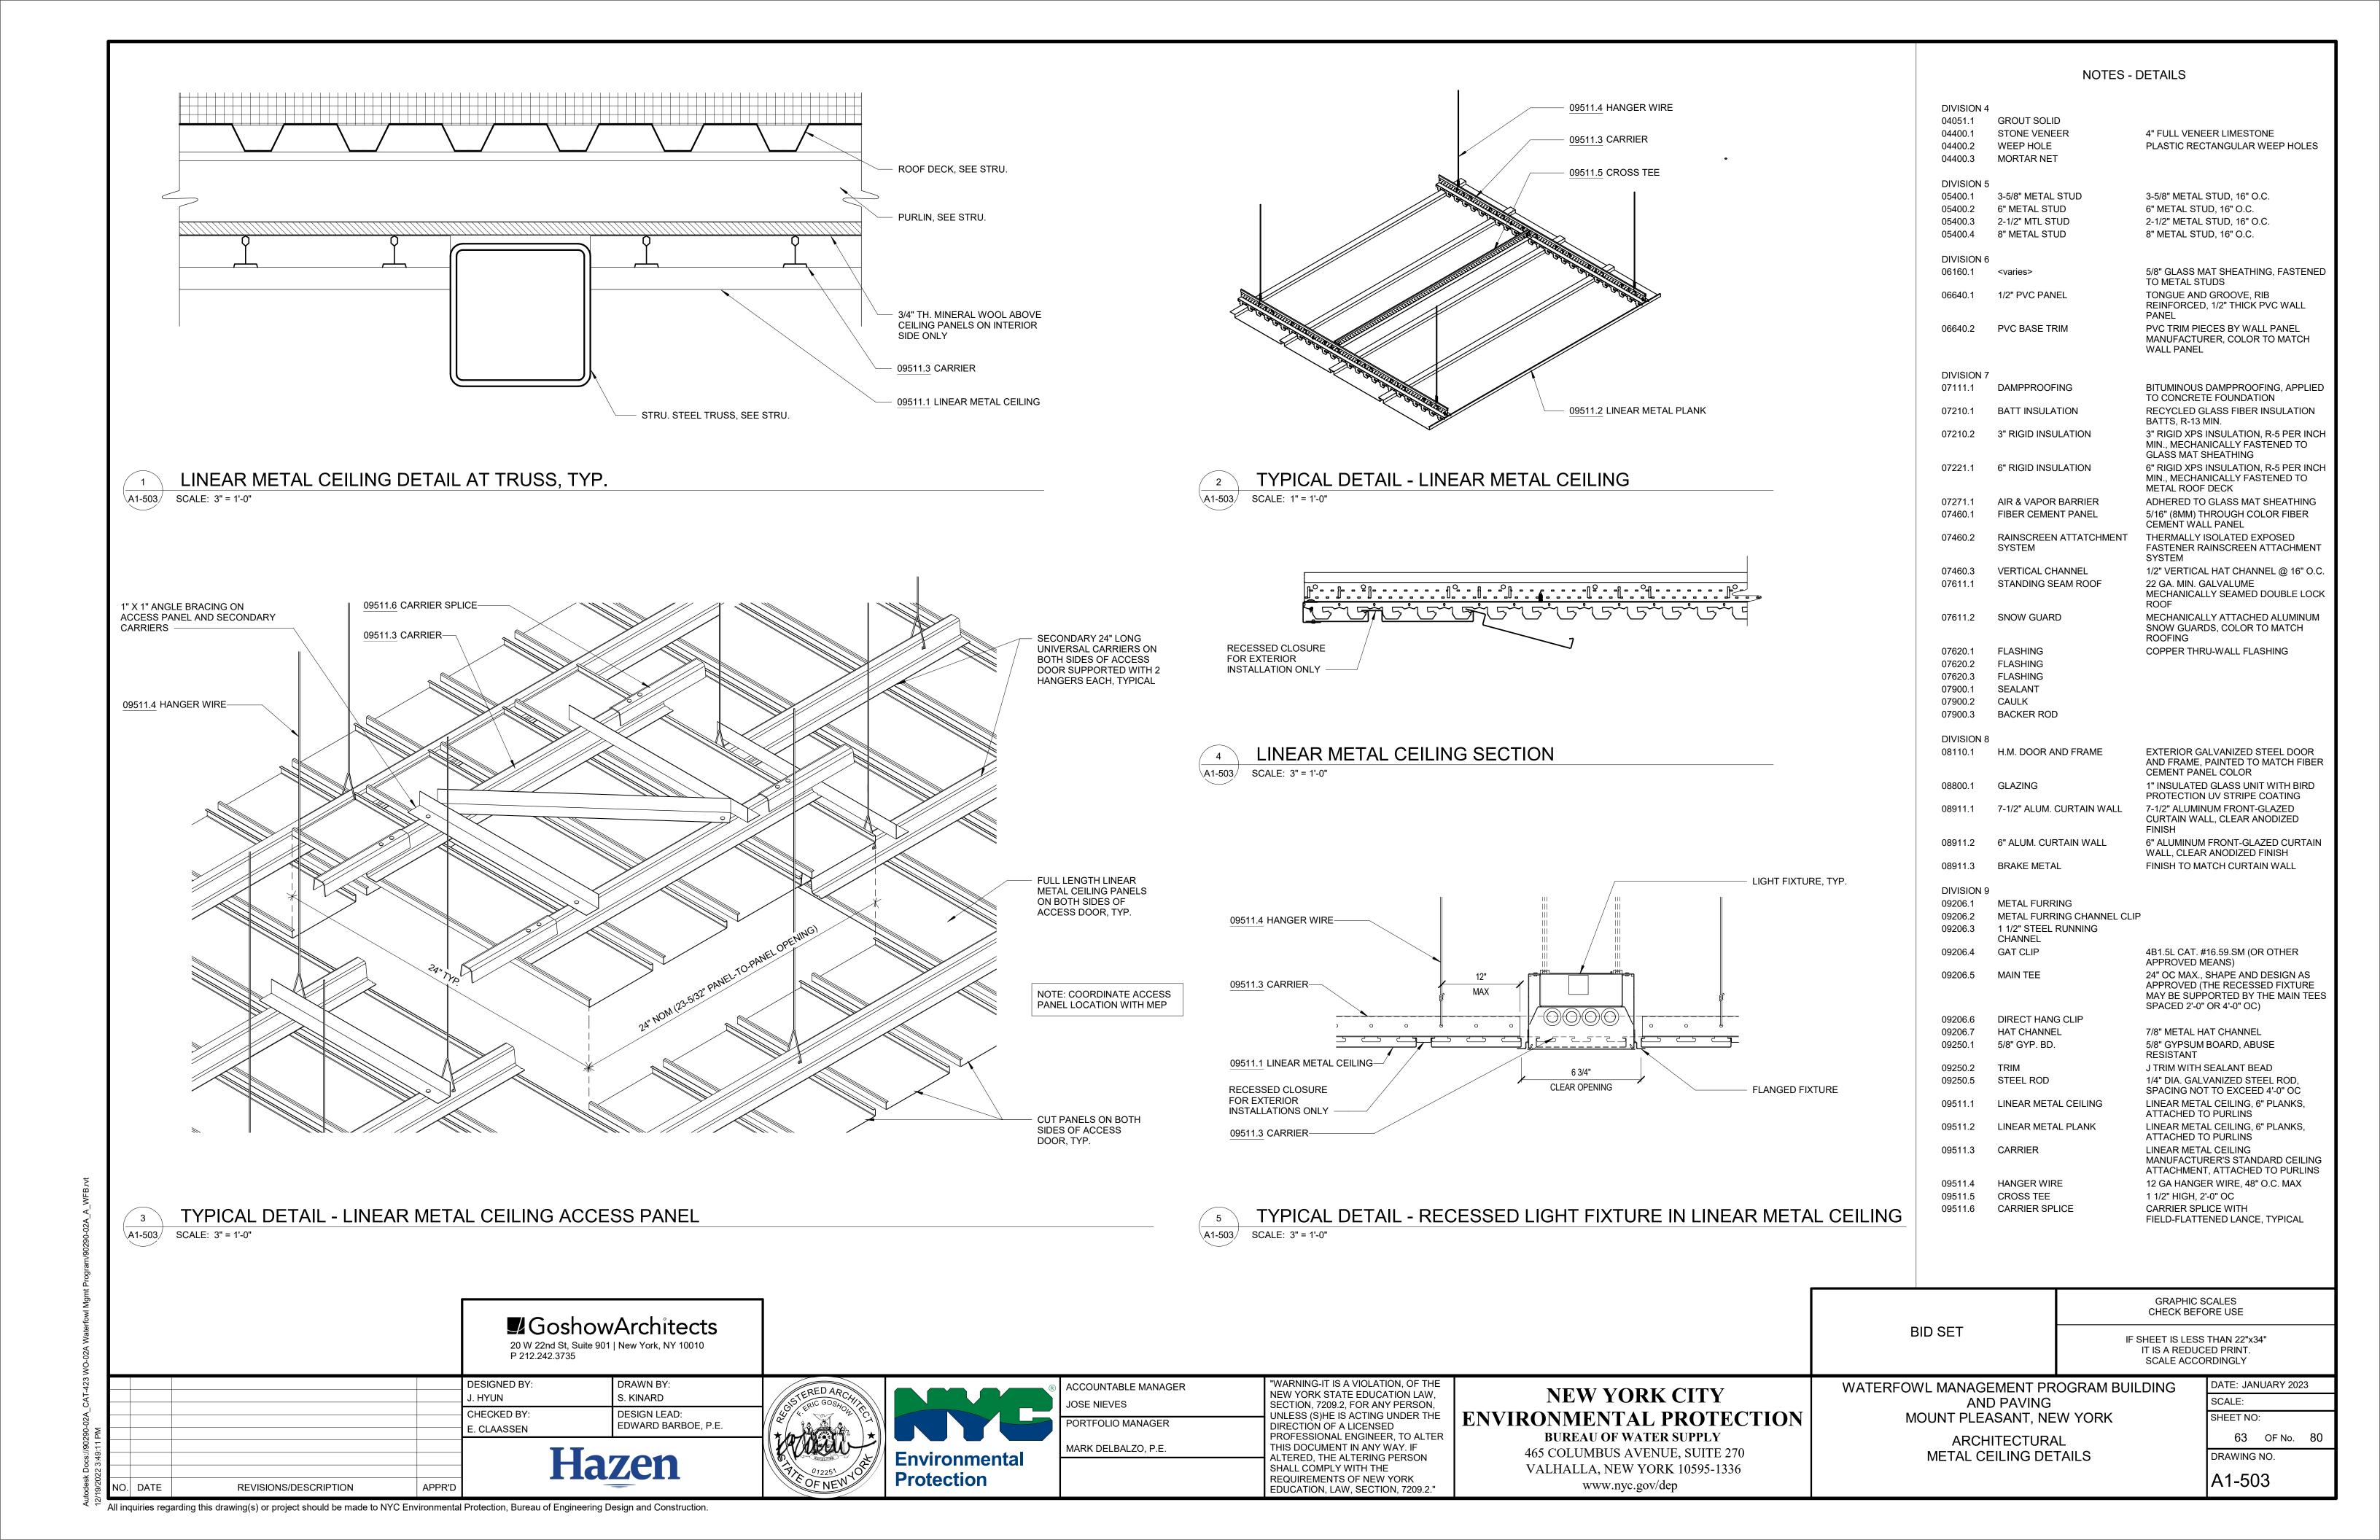


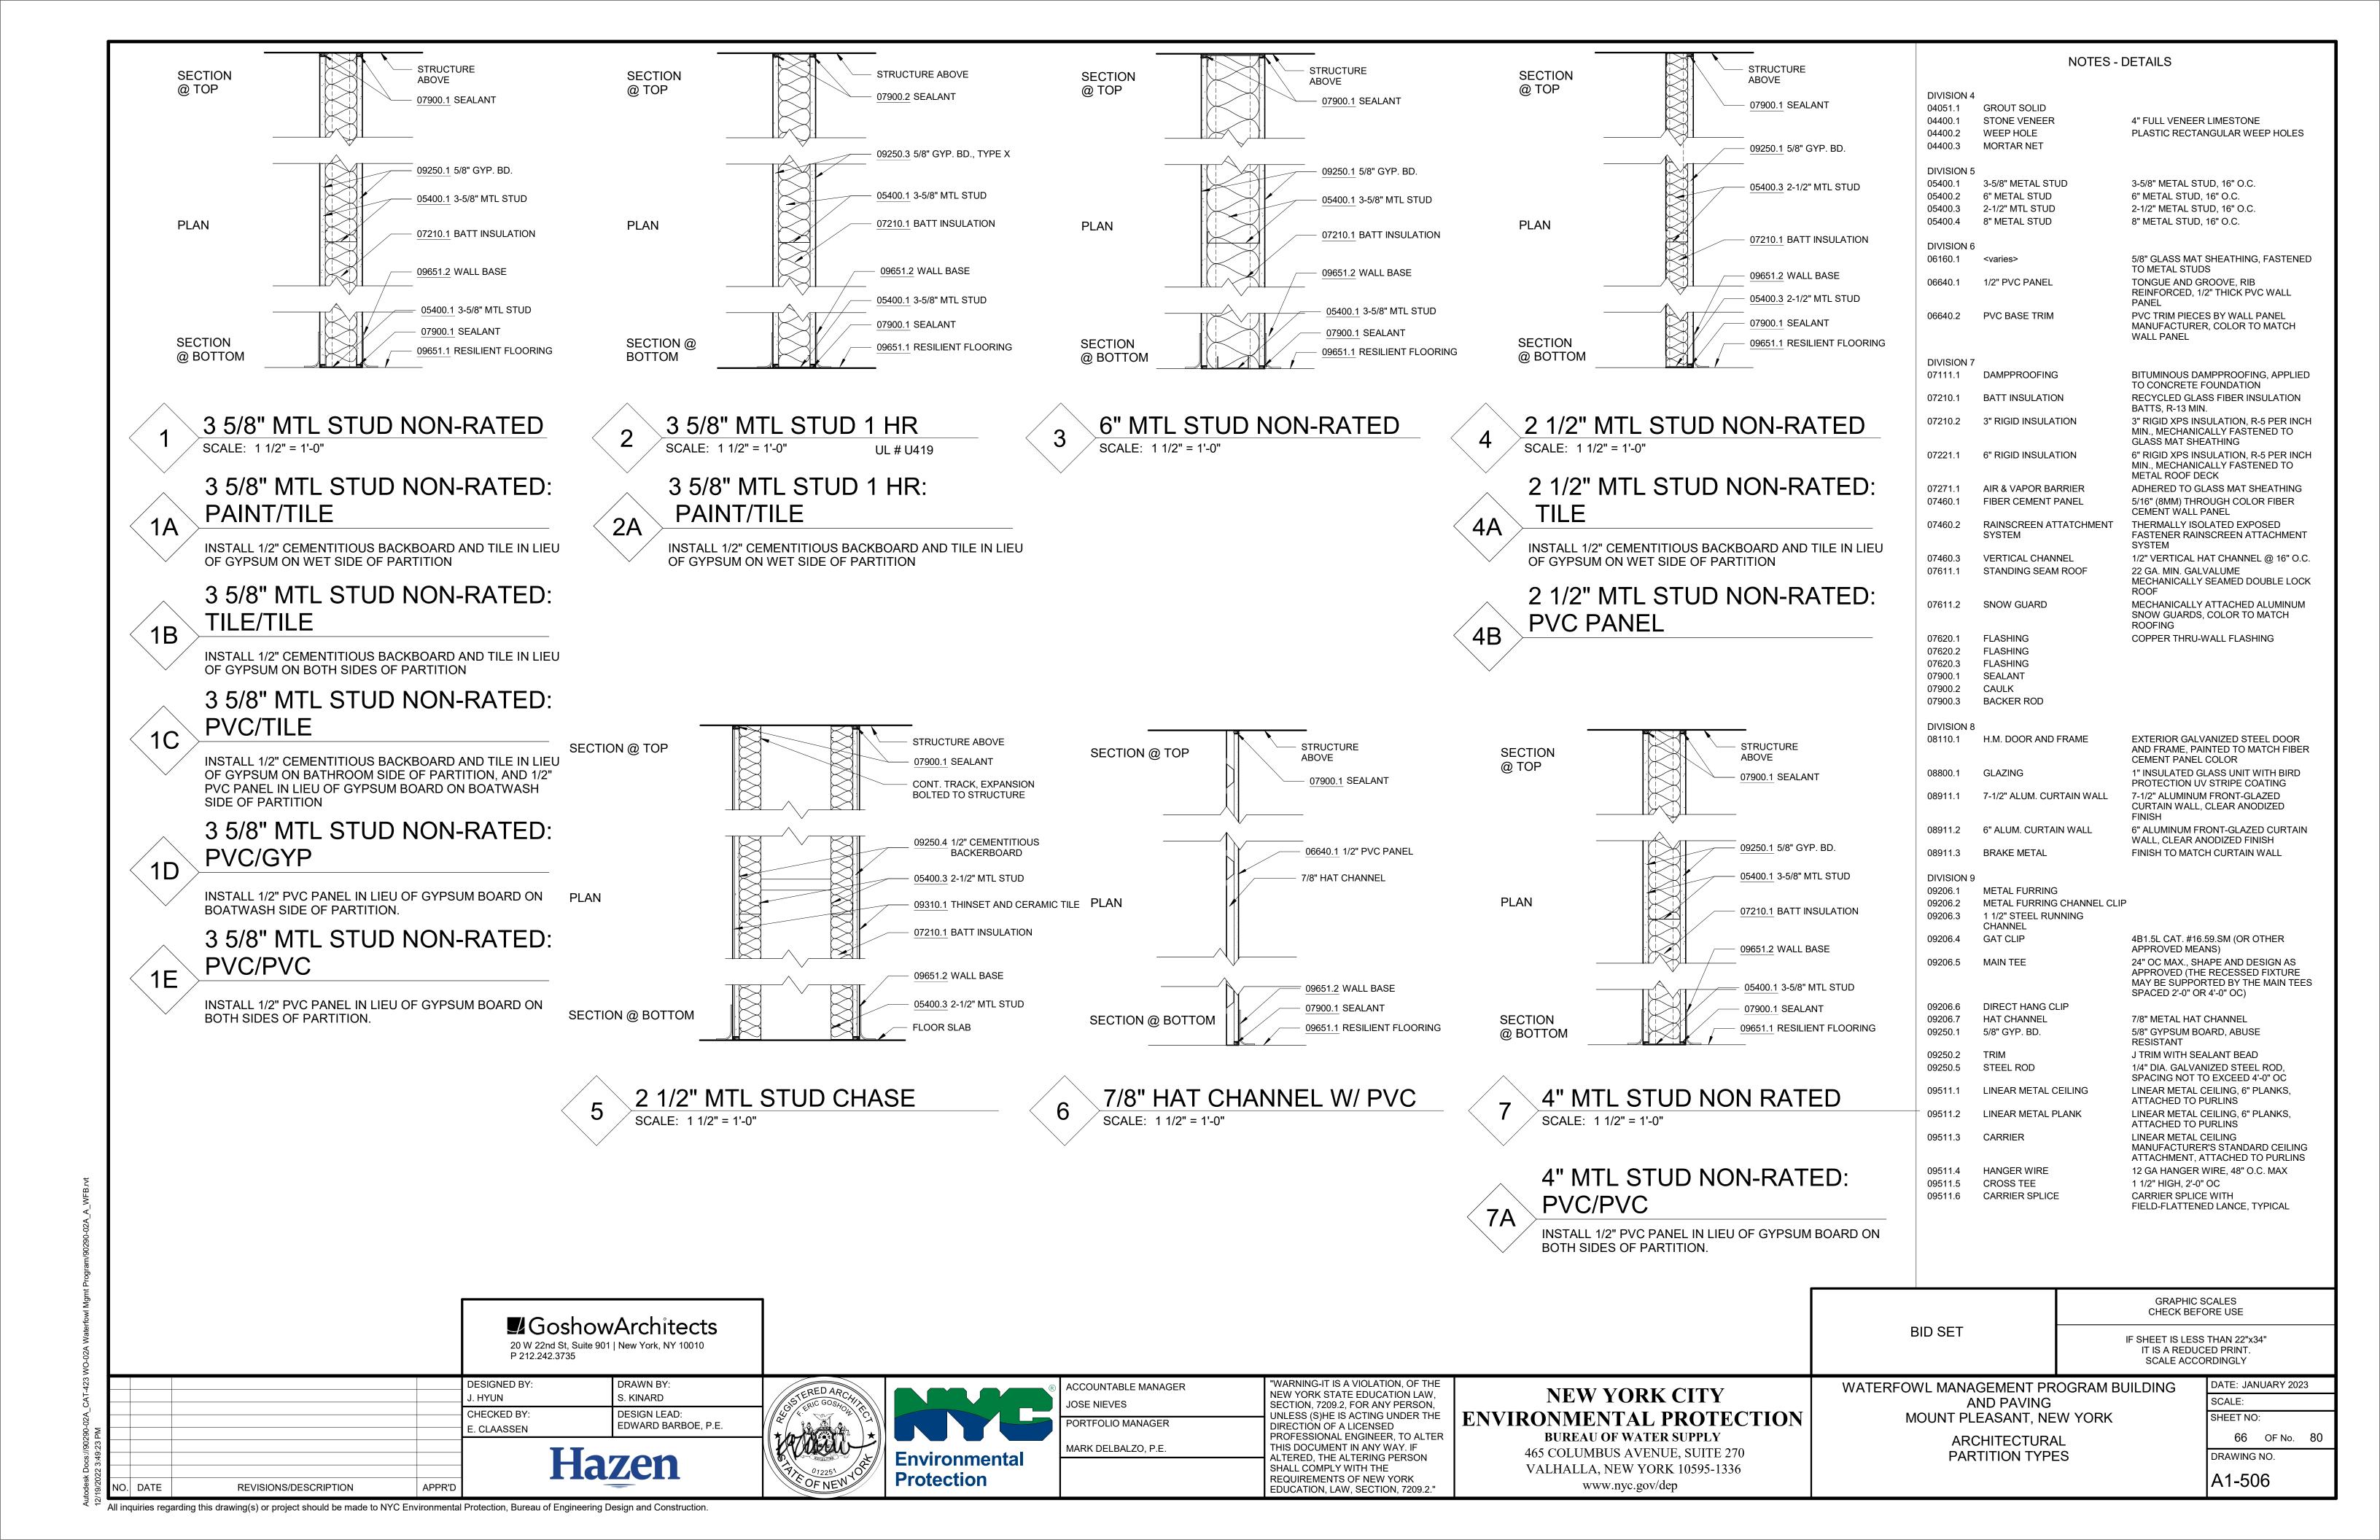

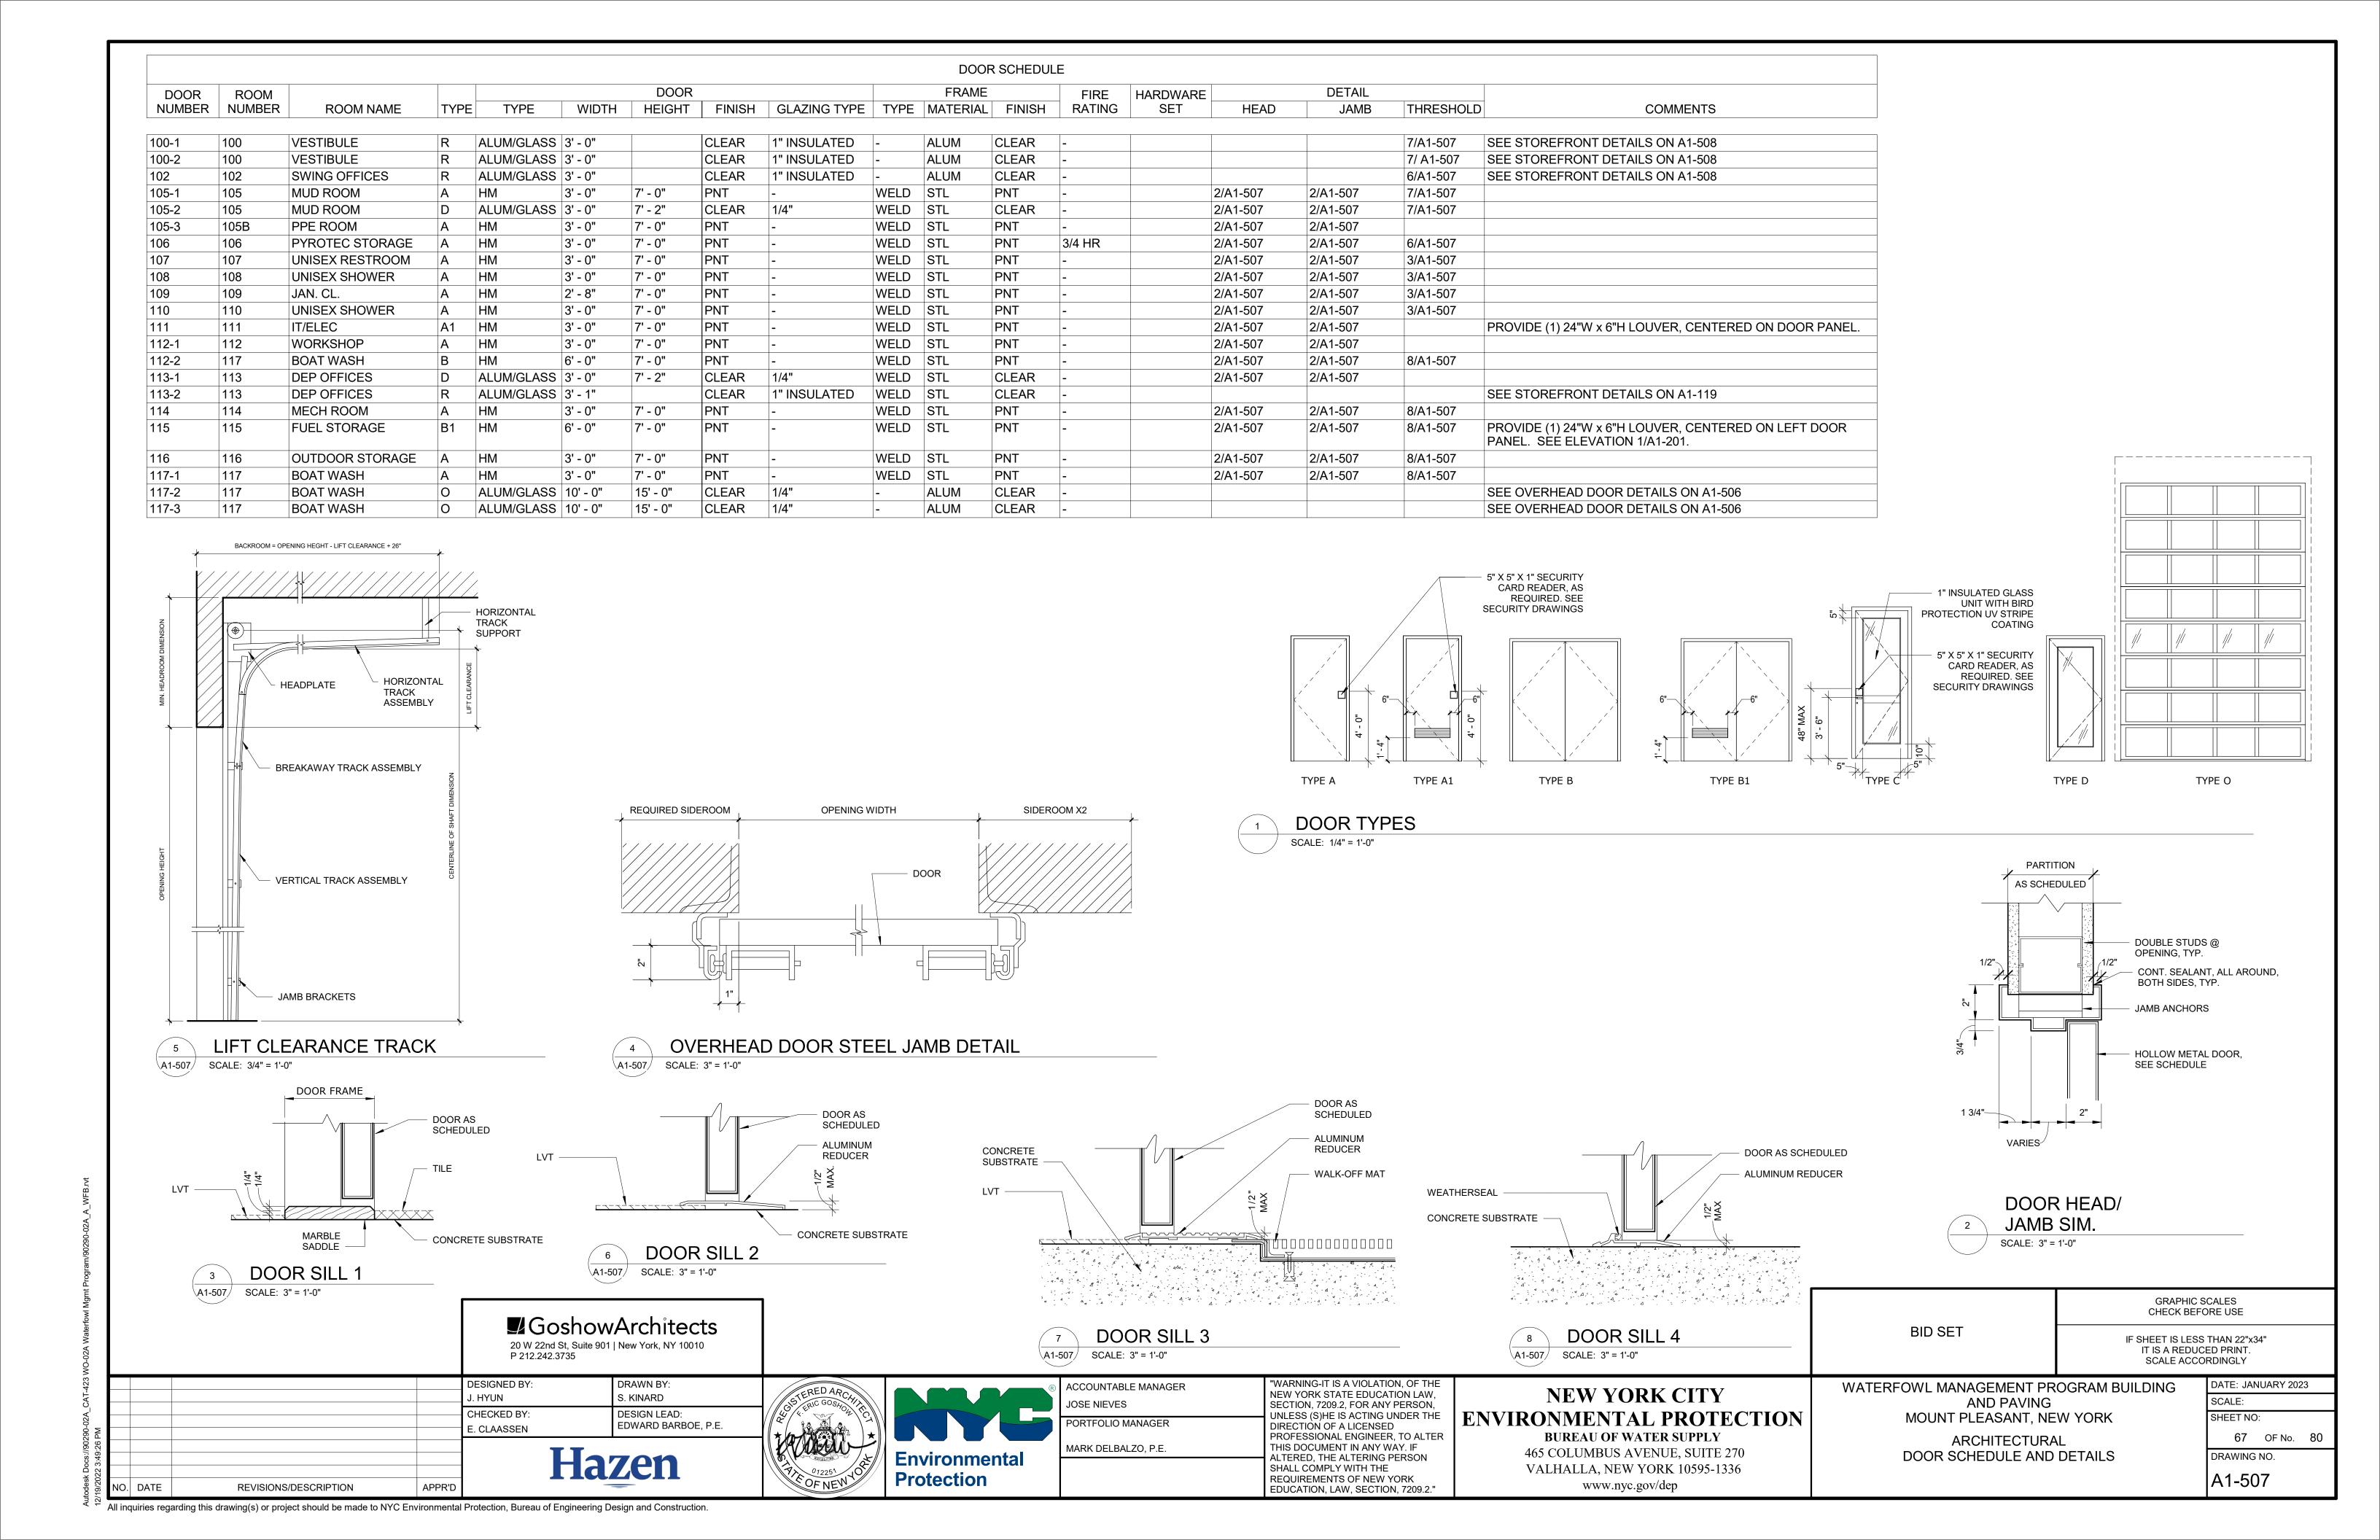


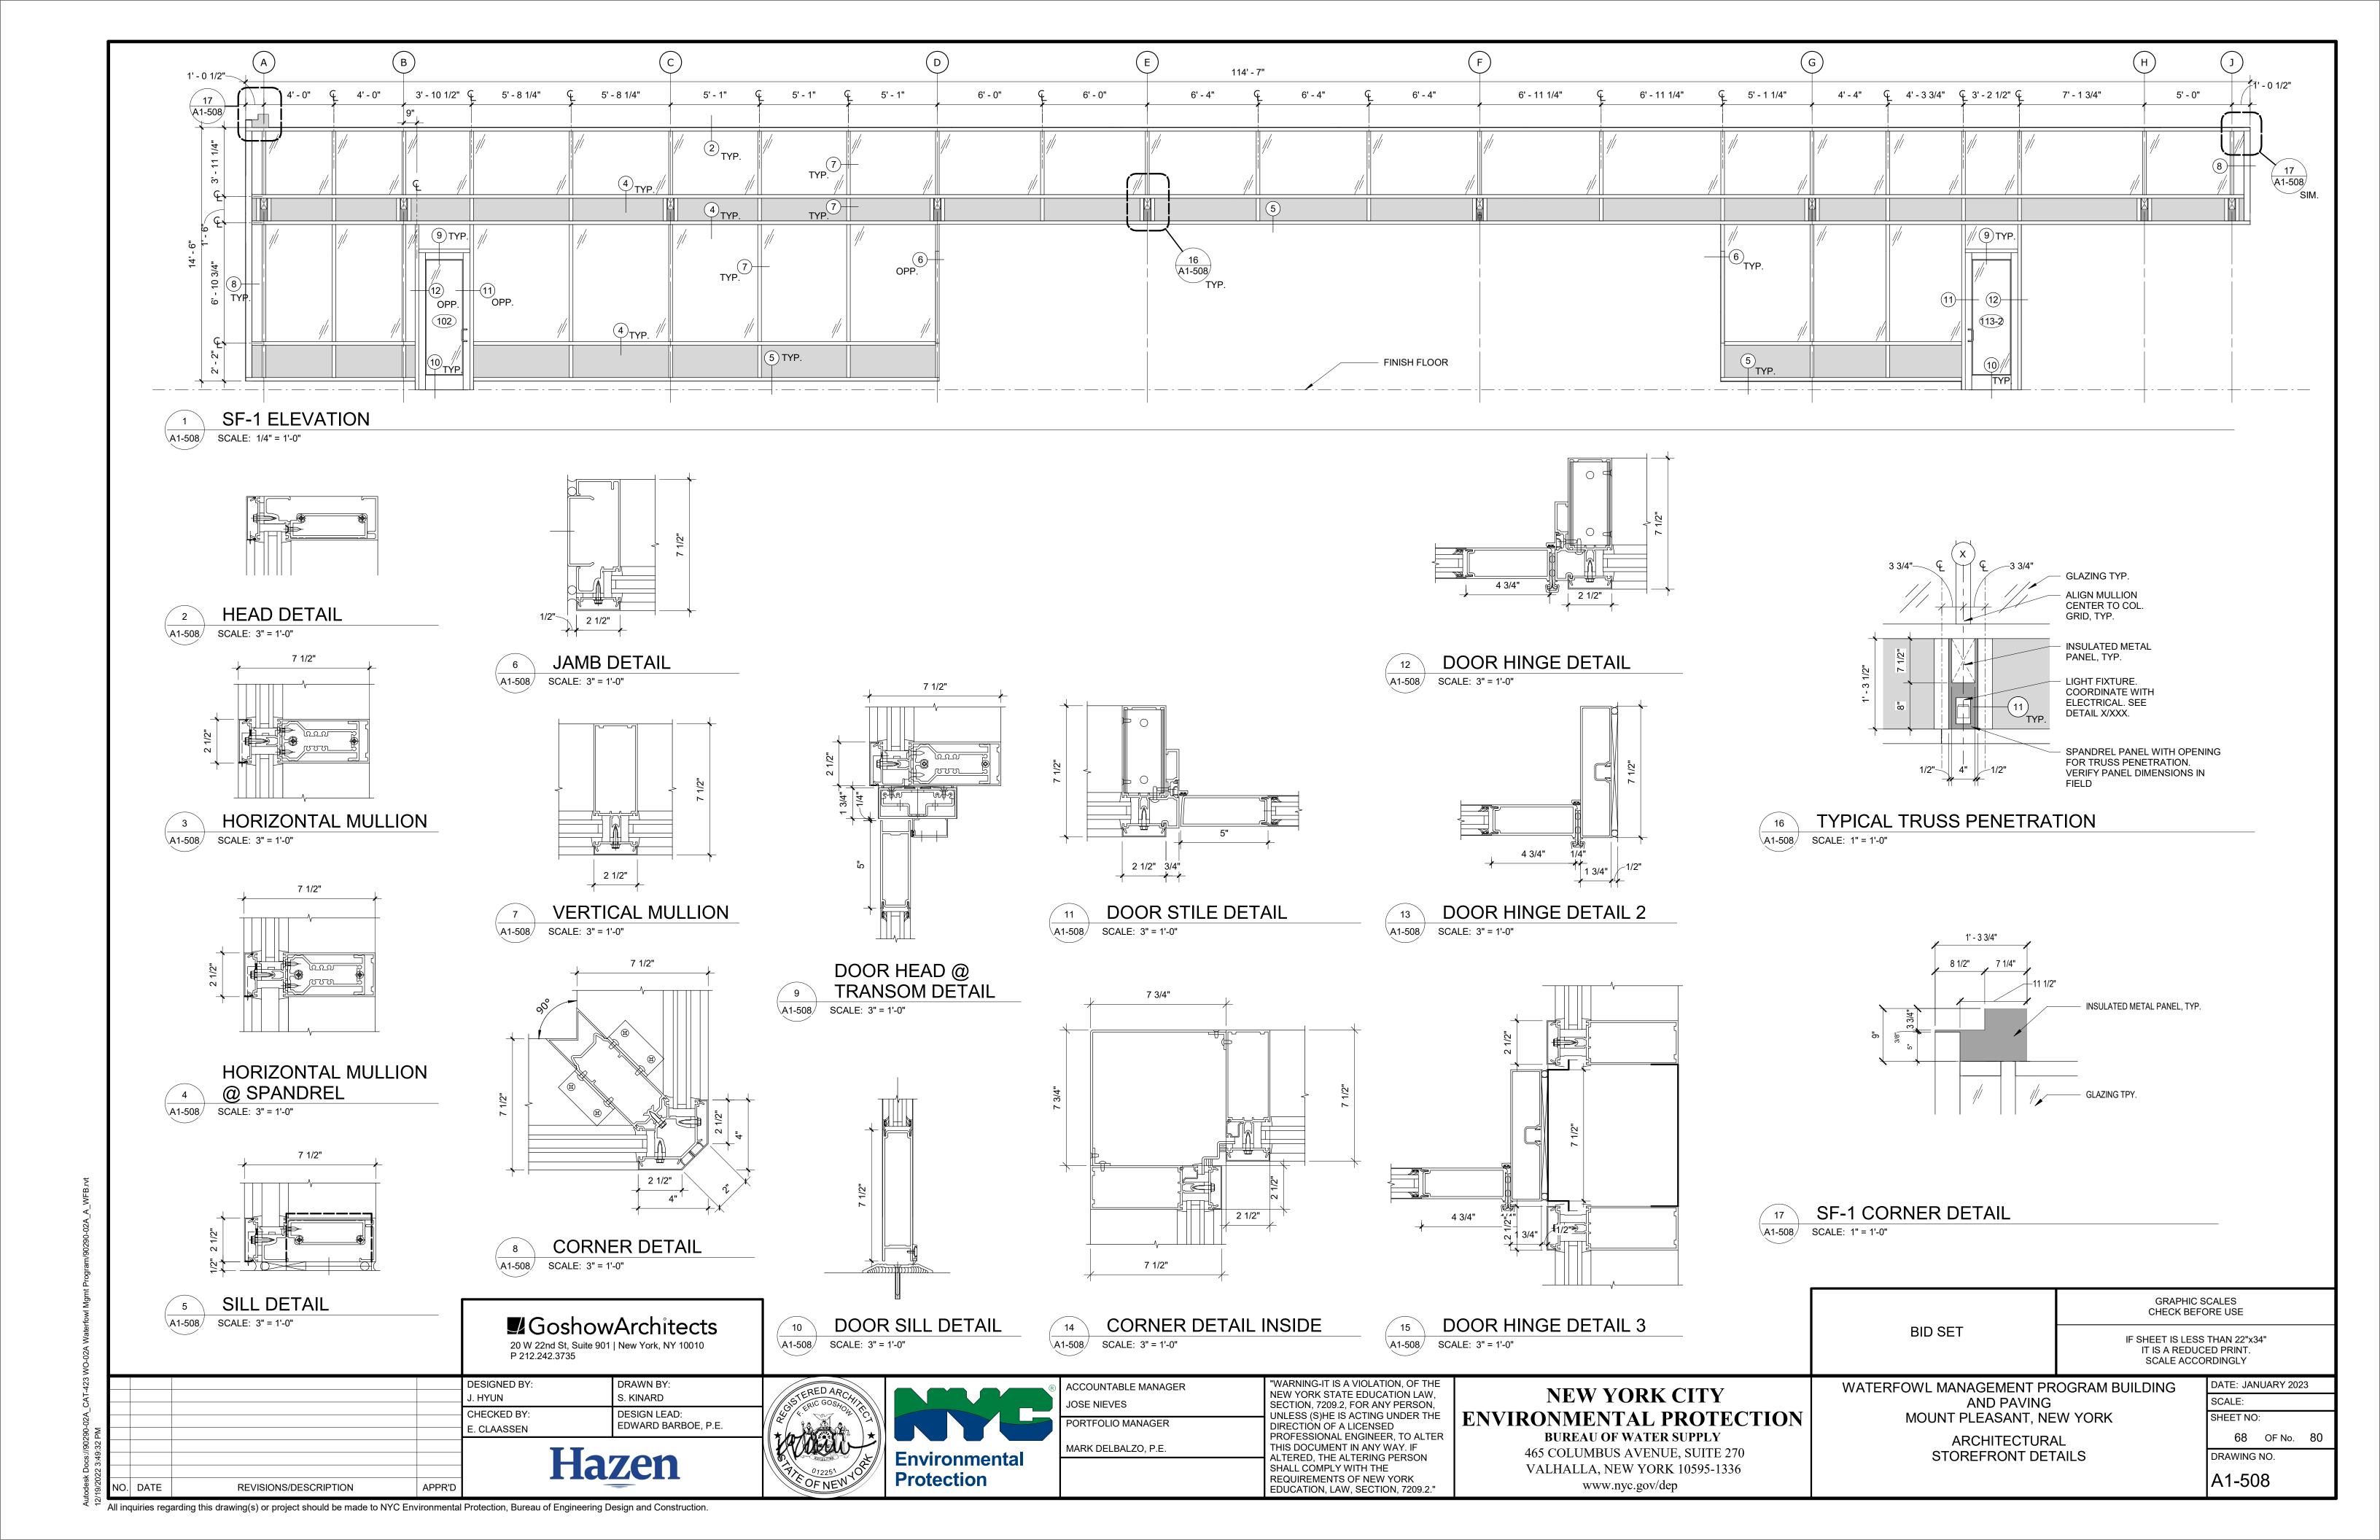

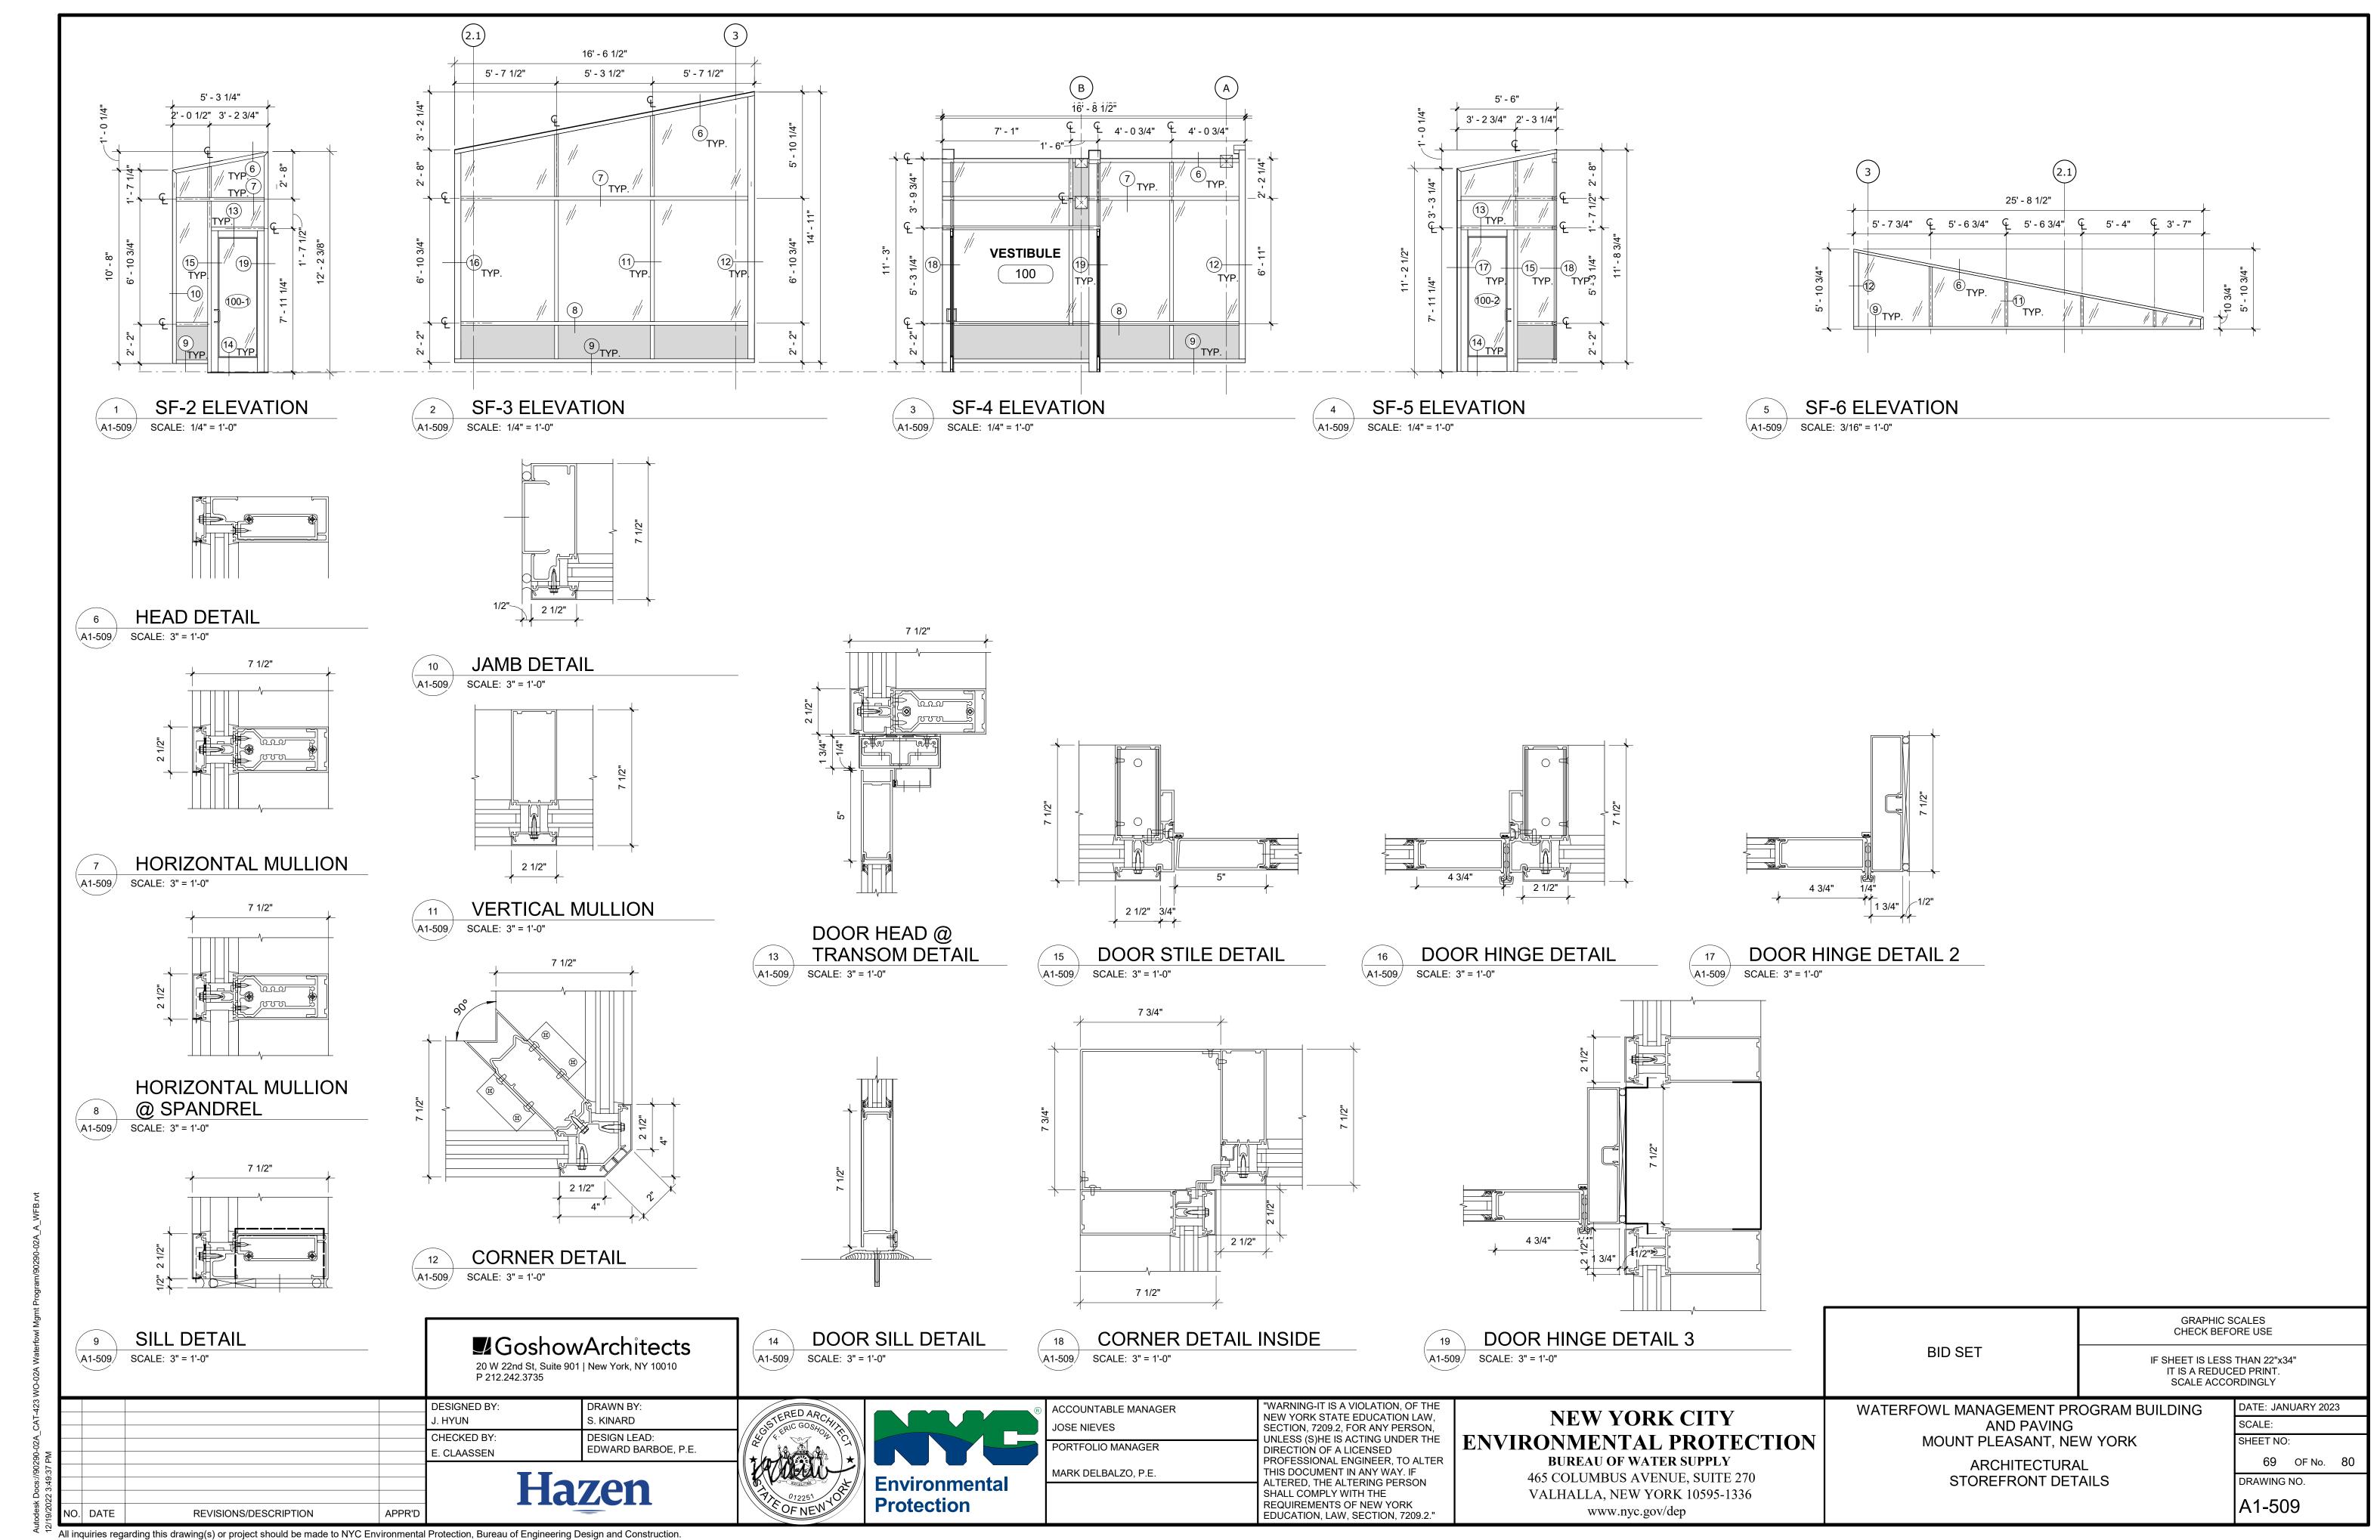


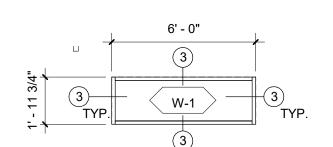


WINDOW 1 ELEVATION A1-510 SCALE: 1/4" = 1'-0"

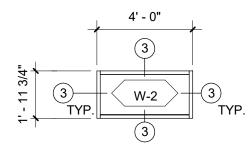


WINDOW 2 ELEVATION A1-510 SCALE: 1/4" = 1'-0"

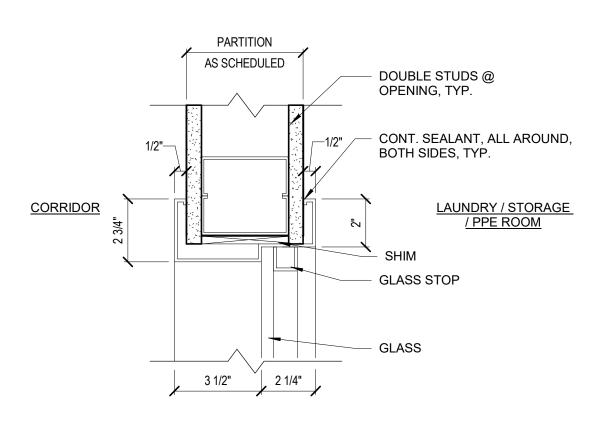


WINDOW HEAD / JAMB / SILL SIM. A1-510 SCALE: 3" = 1'-0"

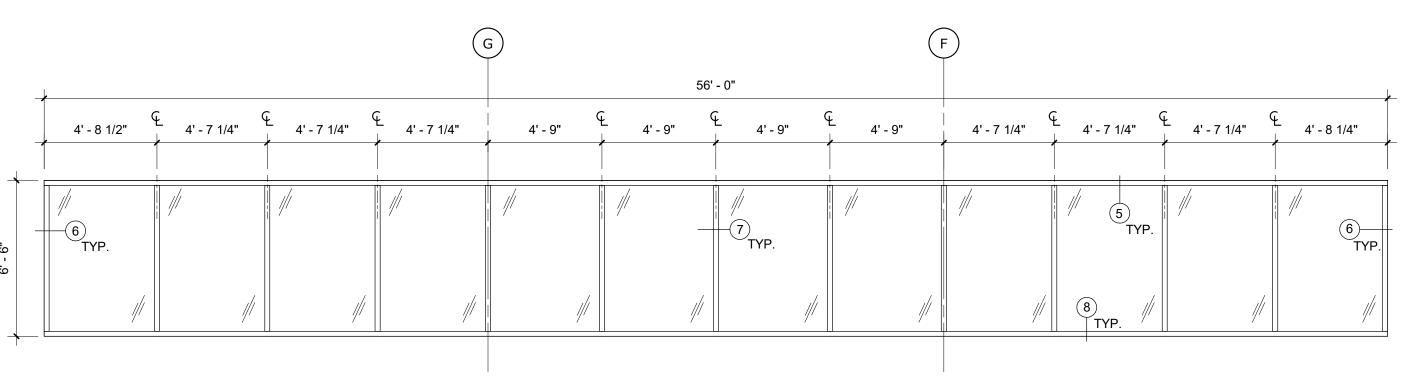


SF-7 ELEVATION 4 SF-7 ELEV A1-510 SCALE: 1/4" = 1'-0"

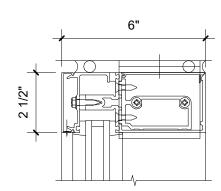


CLERESTORY HEAD DETAIL 5 CLERES 7 A1-510 SCALE: 3" = 1'-0"

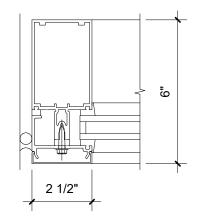

CLERESTORY JAMB DETAIL 6 CLERES 7 SCALE: 3" = 1'-0"

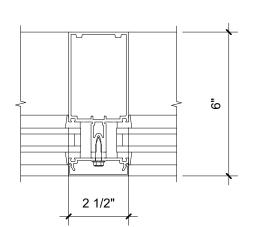

CLERESTORY **VERTICAL MULLION** A1-510 SCALE: 3" = 1'-0"

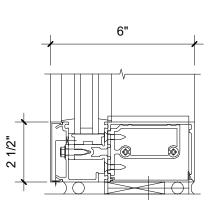

CLERESTORY SILL DETAIL A1-510 SCALE: 3" = 1'-0"

**NEW YORK CITY** 

**ENVIRONMENTAL PROTECTION BUREAU OF WATER SUPPLY** 465 COLUMBUS AVENUE, SUITE 270 VALHALLA, NEW YORK 10595-1336 www.nyc.gov/dep

WATERFOWL MANAGEMENT PROGRAM BUILDING AND PAVING MOUNT PLEASANT, NEW YORK ARCHITECTURAL
INTERIOR WINDOWS AND CLERESTORY ELEVATIONS

& DETAILS

**BID SET** 

DATE: JANUARY 2023 SCALE: SHEET NO: 70 OF No. 80 DRAWING NO. A1-510

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				DESIGNED BY: J. HYUN	DRAWN BY: S. KINARD	
 ∑				CHECKED BY: E. CLAASSEN	DESIGN LEAD: EDWARD BARBOE, P.E.	
19/2022 3:49:40 F	. DATE	REVISIONS/DESCRIPTION	APPR'D	Н	azen	


**Environmental Protection** 

ACCOUNTABLE MANAGER JOSE NIEVES


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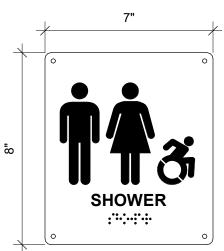
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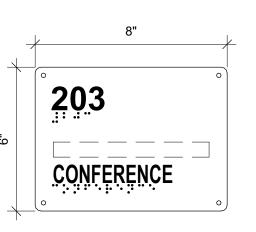




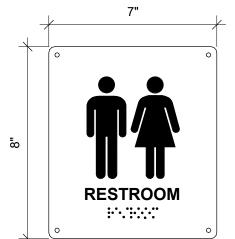


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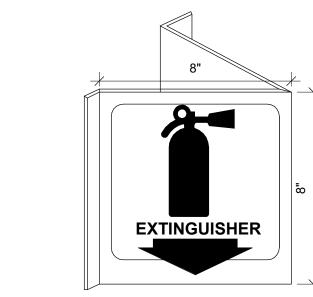


**ROOM NAME & NUMBER** 

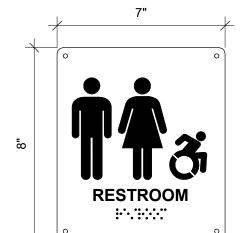TYPE B:




TYPE B-1: ROOM NUMBER

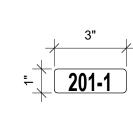


TYPE C: FIRE EXTINGUISHER





TYPE D: EXIT

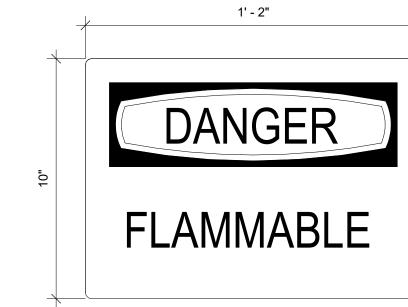

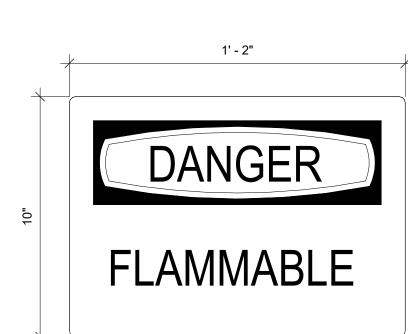

NOTE:
1. PROVIDE EQUIVALENT INFORMATION IN TACTILE **TEXT DESCRIPTOR COMPLYING WITH ICC A117.1.** 

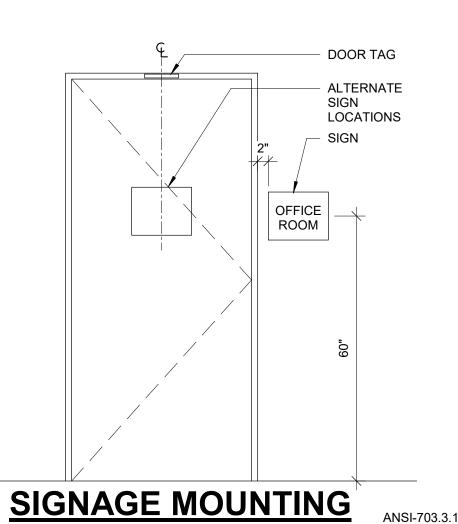

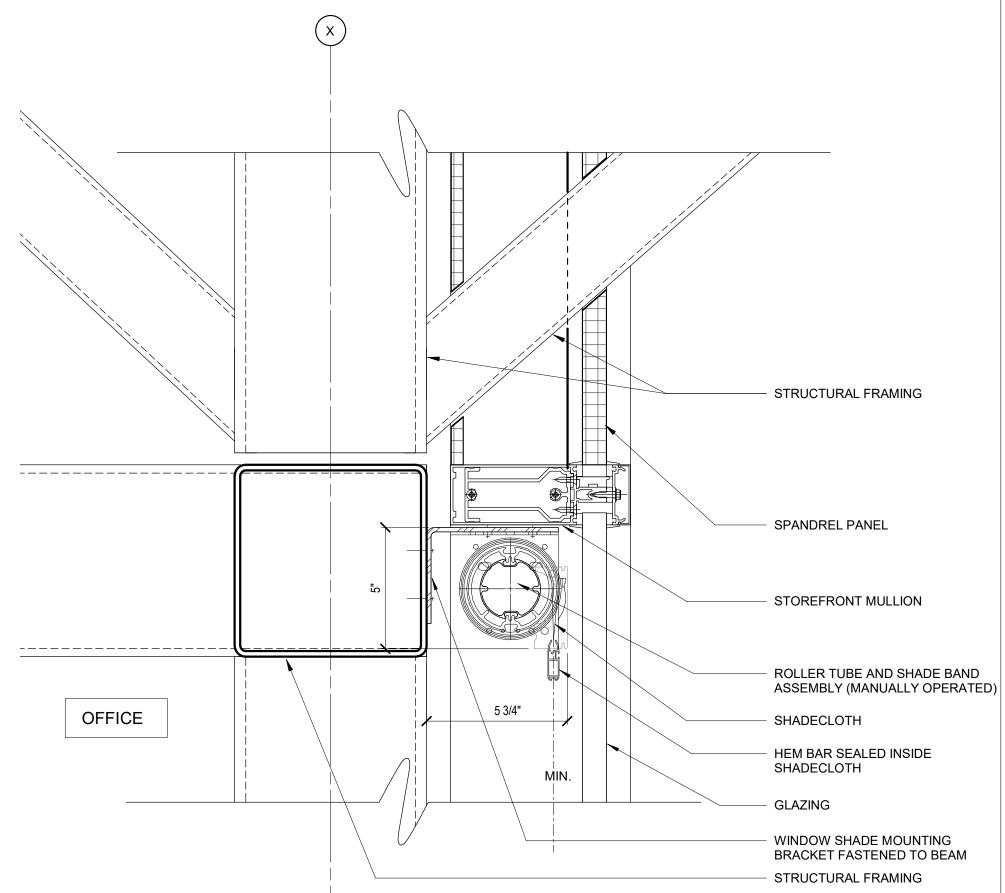

CURTAIN WALL @ TRUSS

\A1-511\/ SCALE: 3" = 1'-0"

FINISH SCHEDULE LEGEND

#### SUBSTRATES

CEMENT BOARD, SEE PLANS AND PARTITION SCHEDULE -CONC: 1/2" SELF-LEVELING CONCRETE GYPSUM WALL BOARD, SEE -GWB: PLANS AND PARTITION SCHEDULE OPEN TO ABOVE

#### **FLOOR FINISHES**

CERAMIC TILE 4" X 4" CLEAR SEALED CONCRETE -CONC: LUXURY VINYL TILE 12" X 24" -LVT: -SEF: SEAMLESS EPOXY FLOORING

#### **BASE FINISHES**

CERAMIC COVE BASE VINYL COVE BASE - 4" -PVC: PVC BASE TRIM

#### **WALL FINISHES**

CERAMIC WALL TILE CERAMIC TILE BACKSPLASH WALL PAINT -PT-1: ALUMINUM / GLASS STOREFRONT -AL/GL: -PVC: **PVC PANEL** 

#### **CEILING FINISHES**

LINEAR METAL PANEL CEILING -PT-2: **CEILING PAINT PVC PANEL** 

### NOTES:

1. ALL SUBSTRATES SHALL BE PREPPED PER FLOOR FINISH MANUFACTURER'S REQUIREMENTS.

SECT DETAIL - TYP. WINDOW SHADE

**■** GoshowArchitects

TYPE E: DANGER

20 W 22nd St, Suite 901 | New York, NY 10010 P 212.242.3735

	Ha	zen
	E. CLAASSEN	EDWARD BARBOE, P.E.
	CHECKED BY:	DESIGN LEAD:
	J. HYUN	S. KINARD
	DESIGNED BY:	DRAWN BY:



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WATERFOWL MANAGEMENT PROGRAM BUILDING AND PAVING MOUNT PLEASANT, NEW YORK

FINISH SCHEDULE, SIGNAGE AND DETAILS

DATE: JAN	NUARY 202	:3	
SCALE:			
SHEET NO	):		
71	OF No.	80	
DRAWING	NO.		
A1-511			

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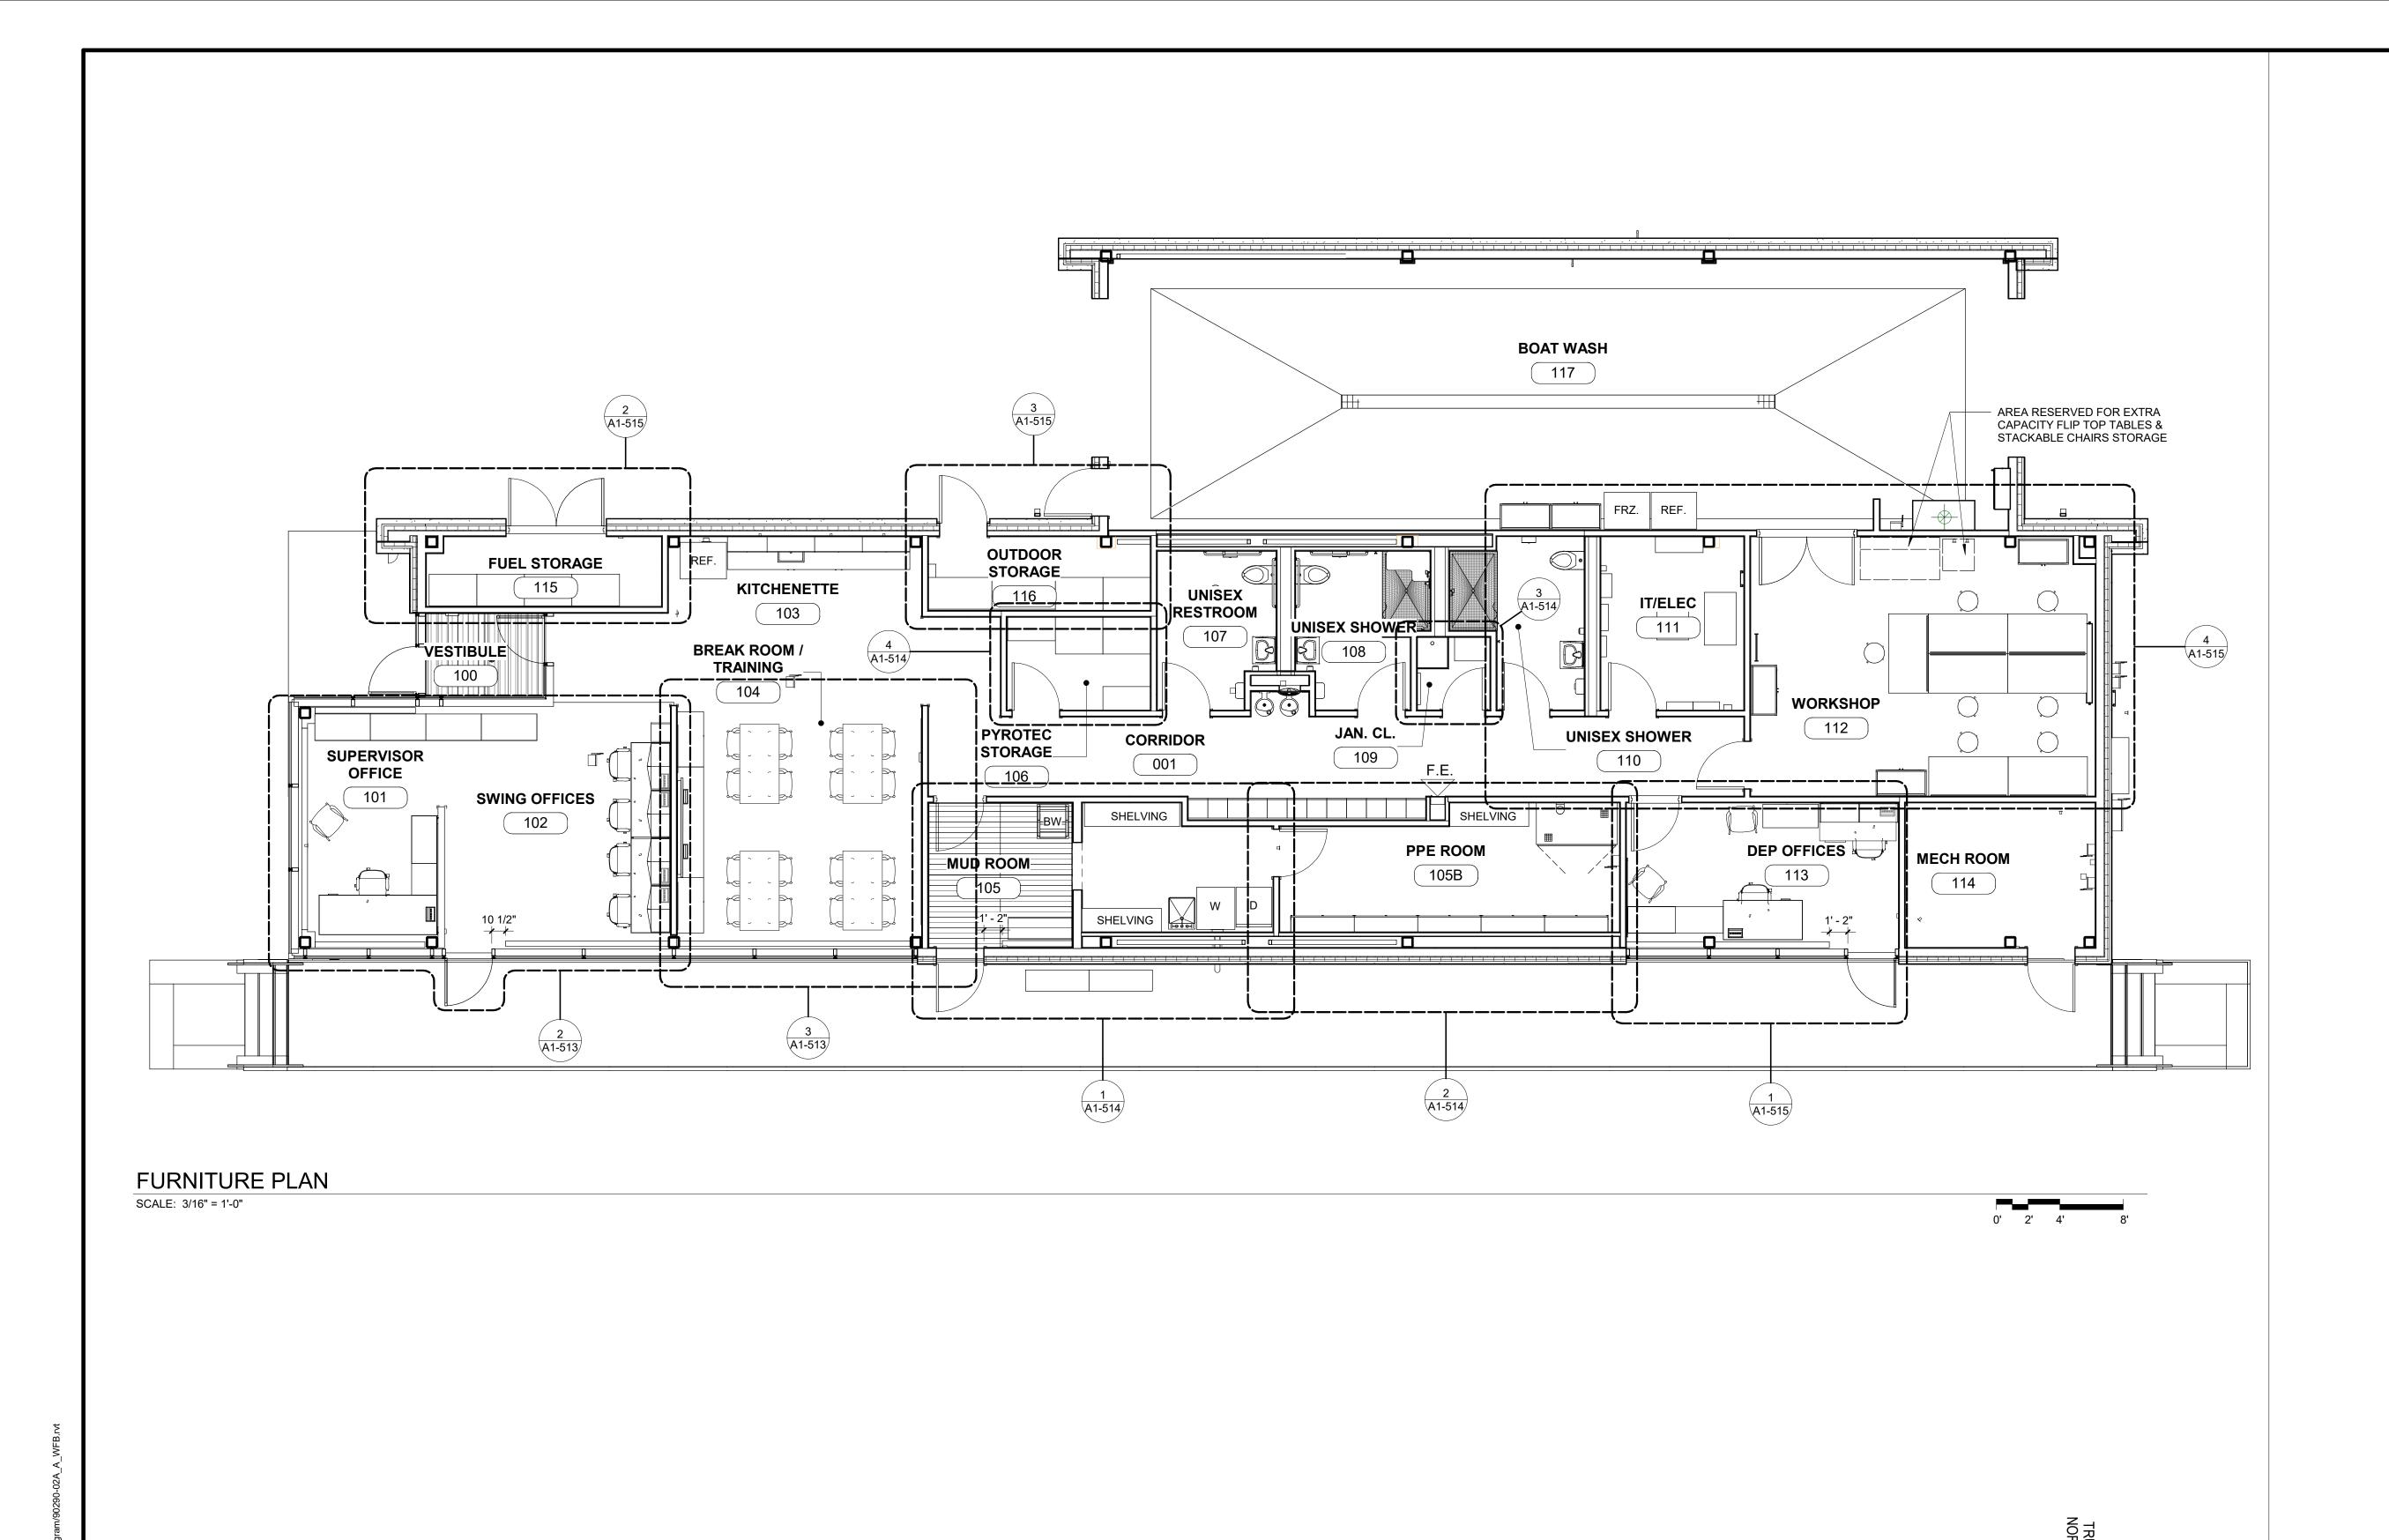
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REVISIONS/DESCRIPTION APPR'D NO. DATE

**BID SET** 

ARCHITECTURAL



■ GoshowArchitects 20 W 22nd St, Suite 901 | New York, NY 10010 P 212.242.3735 DESIGNED BY: DRAWN BY: J. HYUN S. KINARD

DESIGN LEAD:

EDWARD BARBOE, P.E.



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WATERFOWL MANAGEMENT PROGRAM BUILDING AND PAVING MOUNT PLEASANT, NEW YORK ARCHITECTURAL

FURNITURE PLAN

DATE: JANUARY 2023		
SCALE:		
SHEET NO	:	
72	OF No.	80
DRAWING NO.		
A1-51	2	

Hazen NO. DATE REVISIONS/DESCRIPTION All inquiries regarding this drawing(s) or project should be made to NYC Environmental Protection, Bureau of Engineering Design and Construction.

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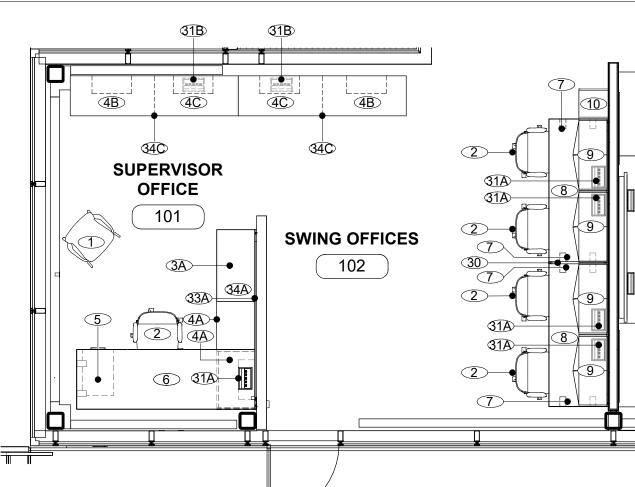
E. CLAASSEN

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CORRIDOR 001 FURNITURE & EQUIPMENT SCHEDULE				
ITEM NO.	DESCRIPTION	SIZE	QUANTITY	NOTES
001				
13A	SINGLE TIER LOCKER	15" W x 15" D x 72" H	1	ASI STORAGE SOLUTIONS - TRADITIONAL PLUS COLLECTION (PROVIDE 4" BASE AND TRIM PIECES)
13B	SINGLE TIER ADA LOCKER	15" W x 15" D x 72" H	1	ASI STORAGE SOLUTIONS - TRADITIONAL PLUS COLLECTION (PROVIDE 4" BASE AND TRIM PIECES)
14	DOUBLE TIER LOCKERS	15" W x 15" D x 72" H	10	ASI STORAGE SOLUTIONS - TRADITIONAL PLUS COLLECTION (PROVIDE 4" BASE AND TRIM PIECES)

# **CORRIDOR LOCKERS - FURNITURE PLAN**

A1-513 SCALE: 1/4" = 1'-0"



ITEM NO	DESCRIPTION	SIZE	QUANTITY	NOTES
101				
1	CHAIR 4-LEG BASE		1	HERMAN MILLER - KNN4SPFSG989898, RIVET LAGOON
2	WORK CHAIR		1	HERMAN MILLER - CQ5-1-M-A-G1-L7-HCC-NNN
3A	MODULAR STORAGE UNITS	30" W x18" D x 27" H	1	HERMAN MILLER - 24-30-20-2N-SS-8Q-TL-8Q-8Q-B3-CB-9P
4A	OPEN SHELVING UNITS	30" W x 18" D x 27" H	2	HERMAN MILLER - PSC-30-20-B-N
4B	OPEN SHELVING UNITS	42" W x 20" D x 29.5" H	1	HERMAN MILLER - PSC-42-20-B-N
4C	OPEN SHELVING UNITS POWERED	42" W x 20" D x 29.5" H	1	HERMAN MILLER - PSC-42-20-B, PROVIDE ALL FURNITURE MOUNTED ELECTRICAL CONNECTIONS
5	PEDESTAL STORAGE UNIT	15" W x 18" D x 27" H	1	HERMAN MILLER - FF10-K-24-BBF-2-L-NT
6	ADJUSTABLE STANDING DESK	84" W x 30" D x 29" H	1	HERMAN MILLER - DU6AT-S-30-84-L-E
7	SQUARE OPEN SUPPORT LEG	30" W x 27 1/4" H	1	HERMAN MILLER - FVD2D-S-30-F-L-R-G1
31A	DESKTOP MOUNTED MOUNTED POWER / DATA HUB	8" W x 3" H x 4 1/2" D	1	HERMAN MILLER - Y1325-3-A-10-G-OK
31B	DESKTOP MOUNTED MOUNTED POWER / DATA HUB	8" W x 3" H x 4 1/2" D	1	HERMAN MILLER - Y1329-3-H-04-OJ
33A	GLASS BACK PANEL	90" W x 23 1/2" H	1	FV-970-WM-G-23A-90
34A	FILE TOP	60" W x 20" D x 1" H	1	TP-L-60-20-98
34C	FILE TOP	84" W x 20" x 1" H	1	TP-L-84-20-98
102				
2	WORK CHAIR		4	HERMAN MILLER - CQ5-1-M-A-G1-L7-HCC-NNN
4B	OPEN SHELVING UNITS	42" W x 20" D x 29.5" H	1	HERMAN MILLER - PSC-42-20-B-N
4C	OPEN SHELVING UNITS POWERED	42" W x 20" D x 29.5" H	1	HERMAN MILLER - PSC-42-20-B, PROVIDE ALL FURNITURE MOUNTED ELECTRICAL CONNECTIONS
7	SQUARE OPEN SUPPORT LEG	30" W x 27 1/4" H	4	HERMAN MILLER - FVD2D-S-30-F-L-R-G1
8	FIXED SEATED DESKS	72" W x 30" D x 29" H	2	HERMAN MILLER - FT-S10-30-72-L-F-91
9	OVERHEAD STORAGE UNITS	36" W x 15" D x 15" H	4	HERMAN MILLER - FV43P-WM-15-36-L-L-KA
10	VERTICAL SHELVING UNIT	15" W x 15" D x 68" H	1	HERMAN MILLER - FF54M-68-15-2-ND-L-L-N
30	PRIVACY PANEL	30" W x 12 1/2" H	1	HERMAN MILLER - GN-SP-N-T-BK-G1
31A	DESKTOP MOUNTED MOUNTED POWER / DATA HUB	8" W x 3" H x 4 1/2" D	4	HERMAN MILLER - Y1325-3-A-10-G-OK
31B	DESKTOP MOUNTED MOUNTED POWER / DATA HUB	8" W x 3" H x 4 1/2" D	1	HERMAN MILLER - Y1329-3-H-04-OJ
34C	TABLE TOP	84" W x 20" x 1" H	1	TP-L-84-20-98

# SUPERVISOR OFFICE & SWING OFFICES - FURNITURE PLAN

A1-513 SCALE: 1/4" = 1'-0"

**■** GoshowArchitects 20 W 22nd St, Suite 901 | New York, NY 10010 P 212.242.3735 DESIGNED BY: DRAWN BY: J. HYUN S. KINARD CHECKED BY: DESIGN LEAD: EDWARD BARBOE, P.E. E. CLAASSEN Hazen



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	Protection	

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HERMAN MILLER - Y7231-91

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SCALE ACCORDINGLY WATERFOWL MANAGEMENT PROGRAM BUILDING DATE: JANUARY 2023

MOUNT PLEASANT, NEW YORK

SCALE:		
SHEET NO	):	
73	OF No.	80
DRAWING	NO.	
A1-51	3	

BREAK ROOM / TRAINING 104 FURNITURE & EQUIPMENT SCHEDULE ITEM NO DESCRIPTION SIZE QUANTITY NOTES CHAIR 4-LEG BASE HERMAN MILLER - KNN4SPFSG989898, RIVET LAGOON HERMAN MILLER - PSC-42-20-B, PROVIDE ALL FURNITURE MOUNTED 4C OPEN SHELVING UNITS POWERED 42" W x 20" D x 29.5" H **ELECTRICAL CONNECTIONS** RECTANGULAR TABLE 42" W x 30" D x 29.5" H HERMAM MILLER - DT5A-S-30-60-L-98, (TWO TABLES NOW SHOWN IN PLAN) 12 BEVEL PULL STORAGE CASE 42" W x 30" D x 29.5" H HERMAN MILLER - 46-42-20-29 17A BACK PAINTED GLASS 36" W x 48" H Y7232-S-48-36-M 17B TACK BOARDS 24" W x 24" H HERMAN MILLER - FV980-WM-24-24-T 17C TACK BOARDS 36" W x 24" H HERMAN MILLER - FV980-WM-24-36-T DESKTOP MOUNTED MOUNTED 31B HERMAN MILLER - Y1329-3-H-04-OJ 8" W x 3" H x 4 1/2" D POWER / DATA HUB FILE TOP 84" W x 20" x 1" H TP-L-84-20-98

**BREAK ROOM /** 

**TRAINING** 

104


# BREAK ROOM / TRAINING - FURNITURE PLAN

7" W x 1 7/8" D x 2 1/2" H

MARKER ERASER HOLDER


TV EQUIPMENT PROVIDED BY OWNER. SHOWN FOR REFERENCE ONLY

\A1-513/ SCALE: 1/4" = 1'-0"

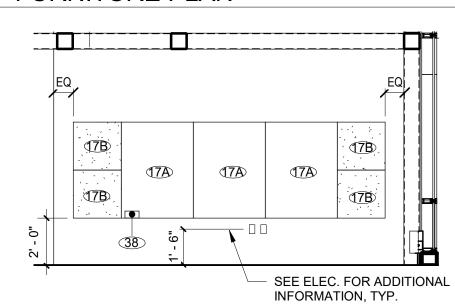

## **BREAKROOM - INTERIOR ELEVATION**

A1-513 SCALE: 1/4" = 1'-0"

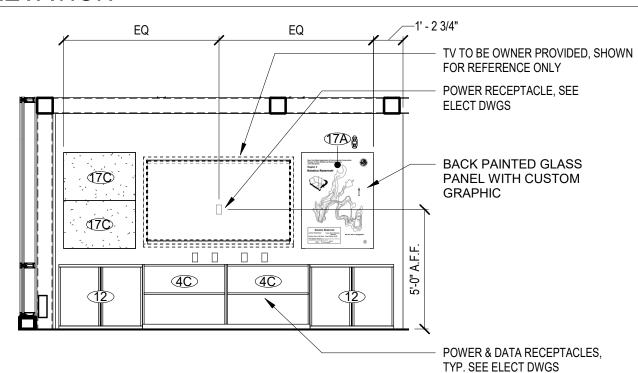

# **BREAKROOM - INTERIOR ELEVATION** A1-513 SCALE: 1/4" = 1'-0"


BASIS OF DESIGN. CONTRACTOR TO PROVDE

**AND PAVING** 

ARCHITECTURAL ENLARGED FURNITURE PLANS & SCHEDULES

NO. DATE


REVISIONS/DESCRIPTION All inquiries regarding this drawing(s) or project should be made to NYC Environmental Protection, Bureau of Engineering Design and Construction.

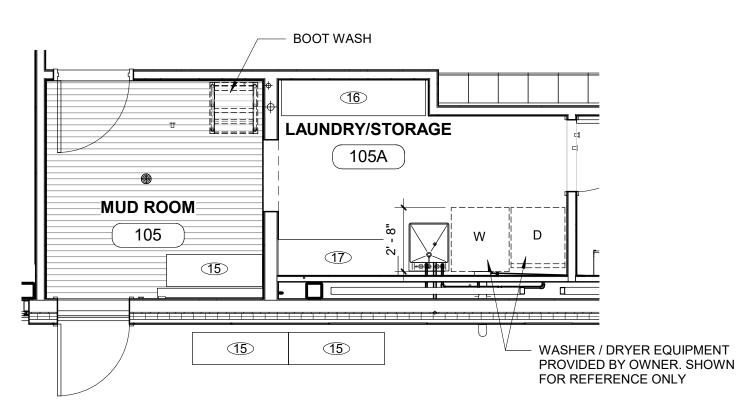

	MUDROOM 1	05 & LAUNDRY / STORAGE	105A FURNITU	RE & EQUIPMENT SCHEDULE
ITEM NO	DESCRIPTION	SIZE	QUANTITY	NOTES
105				
15	SKYLINE 4FT STAINLESS STEEL BENCH	50" W x 22" D x 22" H	3	COMMERCIAL ZONE PRODUCTS: 725229 (2 BENCHES OUTSIDE ON PORCH)
105A				
16	BULK STORAGE RACK	72" W x 18" D x 72" H	1	LYON - SHELVING PRODUCTS - 63518-63183-62172-65818 (DECKING TO BE CUSTOM TO 18" D)
17	BULK STORAGE RACK	60" W x 18" D x 72" H	1	LYON - SHELVING PRODUCTS - 63518-63183-62160-65818 (DECKING TO BE CUSTOM TO 18" D)

# MUD ROOM & LAUNDRY / STORAGE - FURNITURE PLAN

A1-514 SCALE: 1/4" = 1'-0"

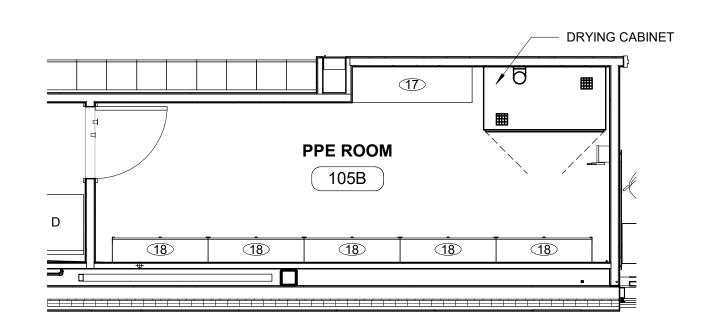

	PPE ROOM 105B FURNITURE & EQUIPMENT SCHEDULE						
ITEM NO	DESCRIPTION	SIZE	QUANTITY	NOTES			
105B							
17	BULK STORAGE RACK	60" W x 18" D x 72" H	1	LYON - SHELVING PRODUCTS - 63518-63183-62160-65818 (DECKING TO BE CUSTOM TO 18" D)			
18	WALL MOUNTED CLOSET ROD & SHELF UNITS	48" W x 13" D	5	ULINE - H-2515			

**■**GoshowArchitects

DRAWN BY:

S. KINARD

DESIGN LEAD:

EDWARD BARBOE, P.E.

20 W 22nd St, Suite 901 | New York, NY 10010

P 212.242.3735


DESIGNED BY:

CHECKED BY:

E. CLAASSEN


J. HYUN

## PPE - FURNITURE PLAN A1-514 SCALE: 1/4" = 1'-0"

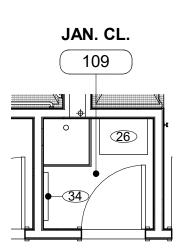

JAN. CLO. 109 FURNITURE & EQUIPMENT SCHEDULE							
ITEM NO	ITEM NO DESCRIPTION SIZE QUANTITY NOTES						
109							
26	HEAVY DUTY WIRE SHELVING	24" W x 18" D x 72" H	1	ULINE: H-2423-72			
34	BROOM / MPOP HOLDERS	24" W x 3" D x 4" H	1	ULINE: H-2840			

## JAN. CLO. FURNITURE PLAN A1-514 SCALE: 1/4" = 1'-0"

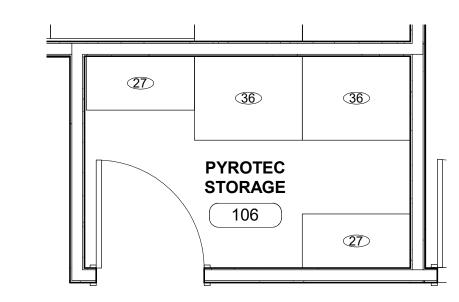

	PYROTECH	I STORAGE. 106 FURNITURE & EQUI	PMENT SCH	EDULE
ITEM NO	DESCRIPTION	SIZE	QUANTITY	NOTES
106			•	
27	SHELVES	36" W x 18" D x 84" H	2	LYON SHELVING PRODUCTS - 8038SM
36	PYROTECHNIC MAGAZINE	36"W x 28"D x 42"H	2	

PYROTEC STORAGE - FURNITURE PLAN A1-514 SCALE: 3/8" = 1'-0"

> NOTE: FURNITURE MODEL NO. PROVIDED AS BASIS OF DESIGN. CONTRACTOR TO PROVDE AS SPECIFIED OR APPROVED EQUAL

**BID SET** 

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WATERFOWL MANAGEMENT PROGRAM BUILDING AND PAVING MOUNT PLEASANT, NEW YORK

SCALE: SHEET NO: 74 OF No. 80

ENVIRONMENTAL PROTECTION **BUREAU OF WATER SUPPLY** 465 COLUMBUS AVENUE, SUITE 270 VALHALLA, NEW YORK 10595-1336 www.nyc.gov/dep

**NEW YORK CITY** 

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ACCOUNTABLE MANAGER JOSE NIEVES PORTFOLIO MANAGER MARK DELBALZO, P.E. **Environmental** 

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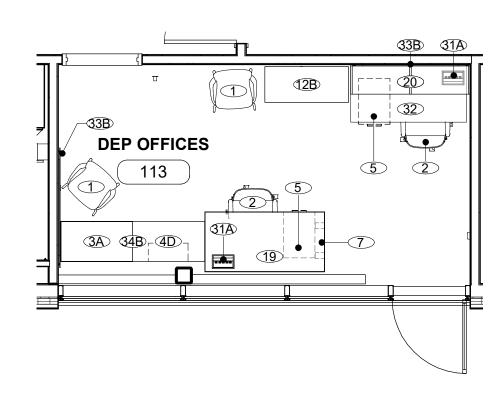
EDUCATION, LAW, SECTION, 7209.2."

REQUIREMENTS OF NEW YORK

ARCHITECTURAL ENLARGED FURNITURE PLANS & SCHEDULES

DRAWING NO. A1-514


DATE: JANUARY 2023



	DEP OFFICES 113 FURNITURE & E	QUIPMENT SO	CHEDULE
DESCRIPTION	SIZE	QUANTITY	NOTES
CHAIR 4-LEG BASE		2	HERMAN MILLER - KNN4SPFSG989898, RIVET LAGOON
WORK CHAIR		2	HERMAN MILLER - CQ5-1-M-A-G1-L7-HCC-NNN
MODULAR STORAGE UNITS	30" W x18" D x 27" H	1	HERMAN MILLER - 24-30-20-2N-SS-8Q-TL-8Q-8Q-B3-CB-9P
OPEN SHELVING UNITS	30" W x 18" D x 27" H	1	HERMAN MILLER - PSC-30-20-B-N
PEDESTAL STORAGE UNIT	15" W x 18" D x 27" H	2	HERMAN MILLER - FF10-K-24-BBF-2-L-NT
SQUARE OPEN SUPPORT LEG	30" W x 27 1/4" H	1	HERMAN MILLER - FVD2D-S-30-F-L-R-G1
STANDARD PULL STORAGE CASE	42" W x 20" x 52 1/2" H	1	HERMAN MILLER - PS6-42-20-K-N
FIXED SEATED DESKS	60" W x 30" D x 29" H	1	HERMAN MILLER - FT-S10-30-60-L-F-91
OVERHEAD STORAGE UNITS	60" W x 15" D x 15" H	1	HERMAN MILLER - FV43P-WM-15-60-L-L-KA
DESKTOP MOUNTED MOUNTED POWER / DATA HUB	8" W x 3" H x 4 1/2" D	2	HERMAN MILLER - Y1325-3-A-10-G-OK
ADJUSTABLE STANDING DESK	60" W x 30" D	1	HERMAN MILLER - DU6AT-S-30-60-L-E
GLASS BACK PANEL	60" W x 23 1/2" H	2	HERMAN MILLER - FV970-WM-G-23A-60
FILE TOP	60" W x 20" D x 1" H	1	TP-L-60-20-98
	WORK CHAIR  MODULAR STORAGE UNITS  OPEN SHELVING UNITS  PEDESTAL STORAGE UNIT  SQUARE OPEN SUPPORT LEG  STANDARD PULL STORAGE CASE  FIXED SEATED DESKS  OVERHEAD STORAGE UNITS  DESKTOP MOUNTED MOUNTED POWER / DATA HUB  ADJUSTABLE STANDING DESK  GLASS BACK PANEL	CHAIR 4-LEG BASE WORK CHAIR MODULAR STORAGE UNITS OPEN SHELVING UNITS PEDESTAL STORAGE UNIT SQUARE OPEN SUPPORT LEG STANDARD PULL STORAGE CASE FIXED SEATED DESKS OVERHEAD STORAGE UNITS OVERHEAD STORAGE OF W X 30" D OVERHEAD STORAGE UNITS OVERHEAD STORA	CHAIR 4-LEG BASE       2         WORK CHAIR       2         MODULAR STORAGE UNITS       30" W x18" D x 27" H       1         OPEN SHELVING UNITS       30" W x 18" D x 27" H       1         PEDESTAL STORAGE UNIT       15" W x 18" D x 27" H       2         SQUARE OPEN SUPPORT LEG       30" W x 27 1/4" H       1         STANDARD PULL STORAGE CASE       42" W x 20" x 52 1/2" H       1         FIXED SEATED DESKS       60" W x 30" D x 29" H       1         OVERHEAD STORAGE UNITS       60" W x 15" D x 15" H       1         DESKTOP MOUNTED MOUNTED POWER / DATA HUB       8" W x 3" H x 4 1/2" D       2         ADJUSTABLE STANDING DESK       60" W x 30" D       1         GLASS BACK PANEL       60" W x 23 1/2" H       2

## DEP OFFICES - FURNITURE PLAN


\A1-515\ SCALE: 1/4" = 1'-0"

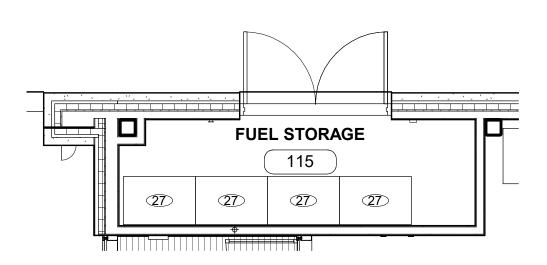

		FUEL STORAGE 115 FURNITURE & EG	QUIPMENT S	CHEDULE
ITEM NO	DESCRIPTION	SIZE	QUANTITY	NOTES
115				
27	STARTER SHELVING UNIT	36" W x 24" D x 84" H	4	LYON SHELVING PRODUCTS - 8039SM

## FUEL STORAGE - FURNITURE PLAN


A1-515 SCALE: 1/4" = 1'-0"

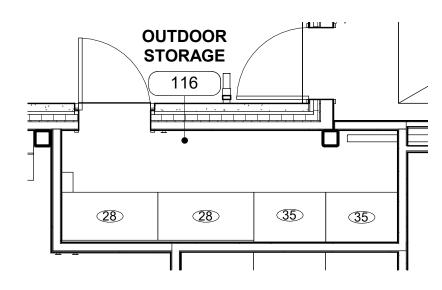

	OUTE	OOR STORAGE 116 FURNITUR	RE & EQUIPMEN	TSCHEDULE
ITEM NO	DESCRIPTION	SIZE	QUANTITY	NOTES
16				
28	STARTER SHELVING UNIT	48" W x 24" D x 84" H	2	LYON SHELVING PRODUCTS - 8336SH
35	VERTICAL BAR RACKS	36" W x 24" D x 84" H	2	GLOBAL INDUSTRIAL - 258298

# OUTDOOR STORAGE - FURNITURE PLAN

\A1-515\/ SCALE: 1/4" = 1'-0"

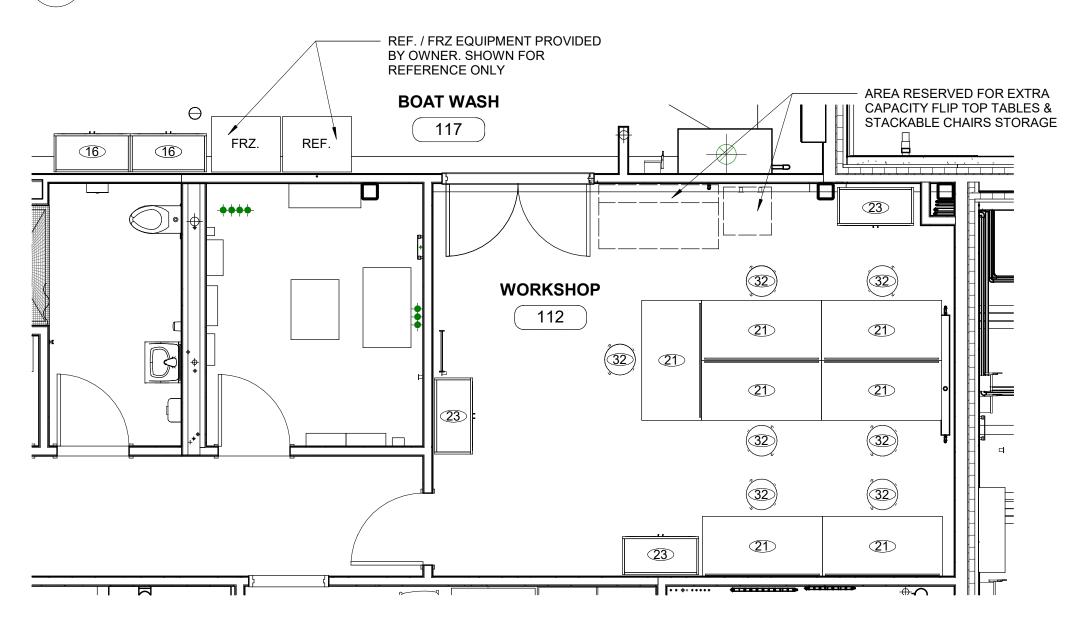

	WO	INSTICE TIZ & BOAT WASI	I I I I I OKNIT	URE & EQUIPMENT SCHEDULE
ITEM NO	DESCRIPTION	SIZE	QUANTITY	NOTES
112				
21	WORKBENCH W/ STORAGE	60" W x 30" D x 42" H	7	ULINE - H-6341 ( BOTTOM SHELF IS HALF DEPTH, NOT FULL DEPTH)
22	PEGBOARD PANEL	18" W x 19" H	7	ULINE - H-5768
23	RADIUS EDGE CLEAR VIEW STORAGE	36" W x 18" D x 72" H	3	SANDUSKYLEE - ER4V 361872-00
32	SHOP STOOLS	14" D x 25-33" H	7	ULINE - H-2506
117			'	
16	STAINLESS STEEL CABINETS	36" W x 18" D x 72" H	2	SANDUSKYLEE - SA4V 361872-XX

WORKSHOP & BOAT WASH - FURNITURE PLAN A1-515/ SCALE: 1/4" = 1'-0"

**■**GoshowArchitects 20 W 22nd St, Suite 901 | New York, NY 10010 P 212.242.3735

DESIGNED BY: DRAWN BY: J. HYUN S. KINARD CHECKED BY: DESIGN LEAD: EDWARD BARBOE, P.E. E. CLAASSEN Hazen

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# **NEW YORK CITY** ENVIRONMENTAL PROTECTION

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BASIS OF DESIGN. CONTRACTOR TO PROVDE

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DATE: JANUARY 2023 SCALE: SHEET NO: 75 OF No. 80 DRAWING NO. A1-515

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