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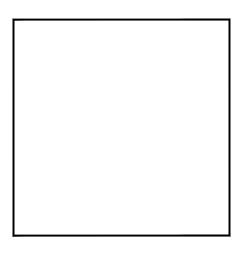
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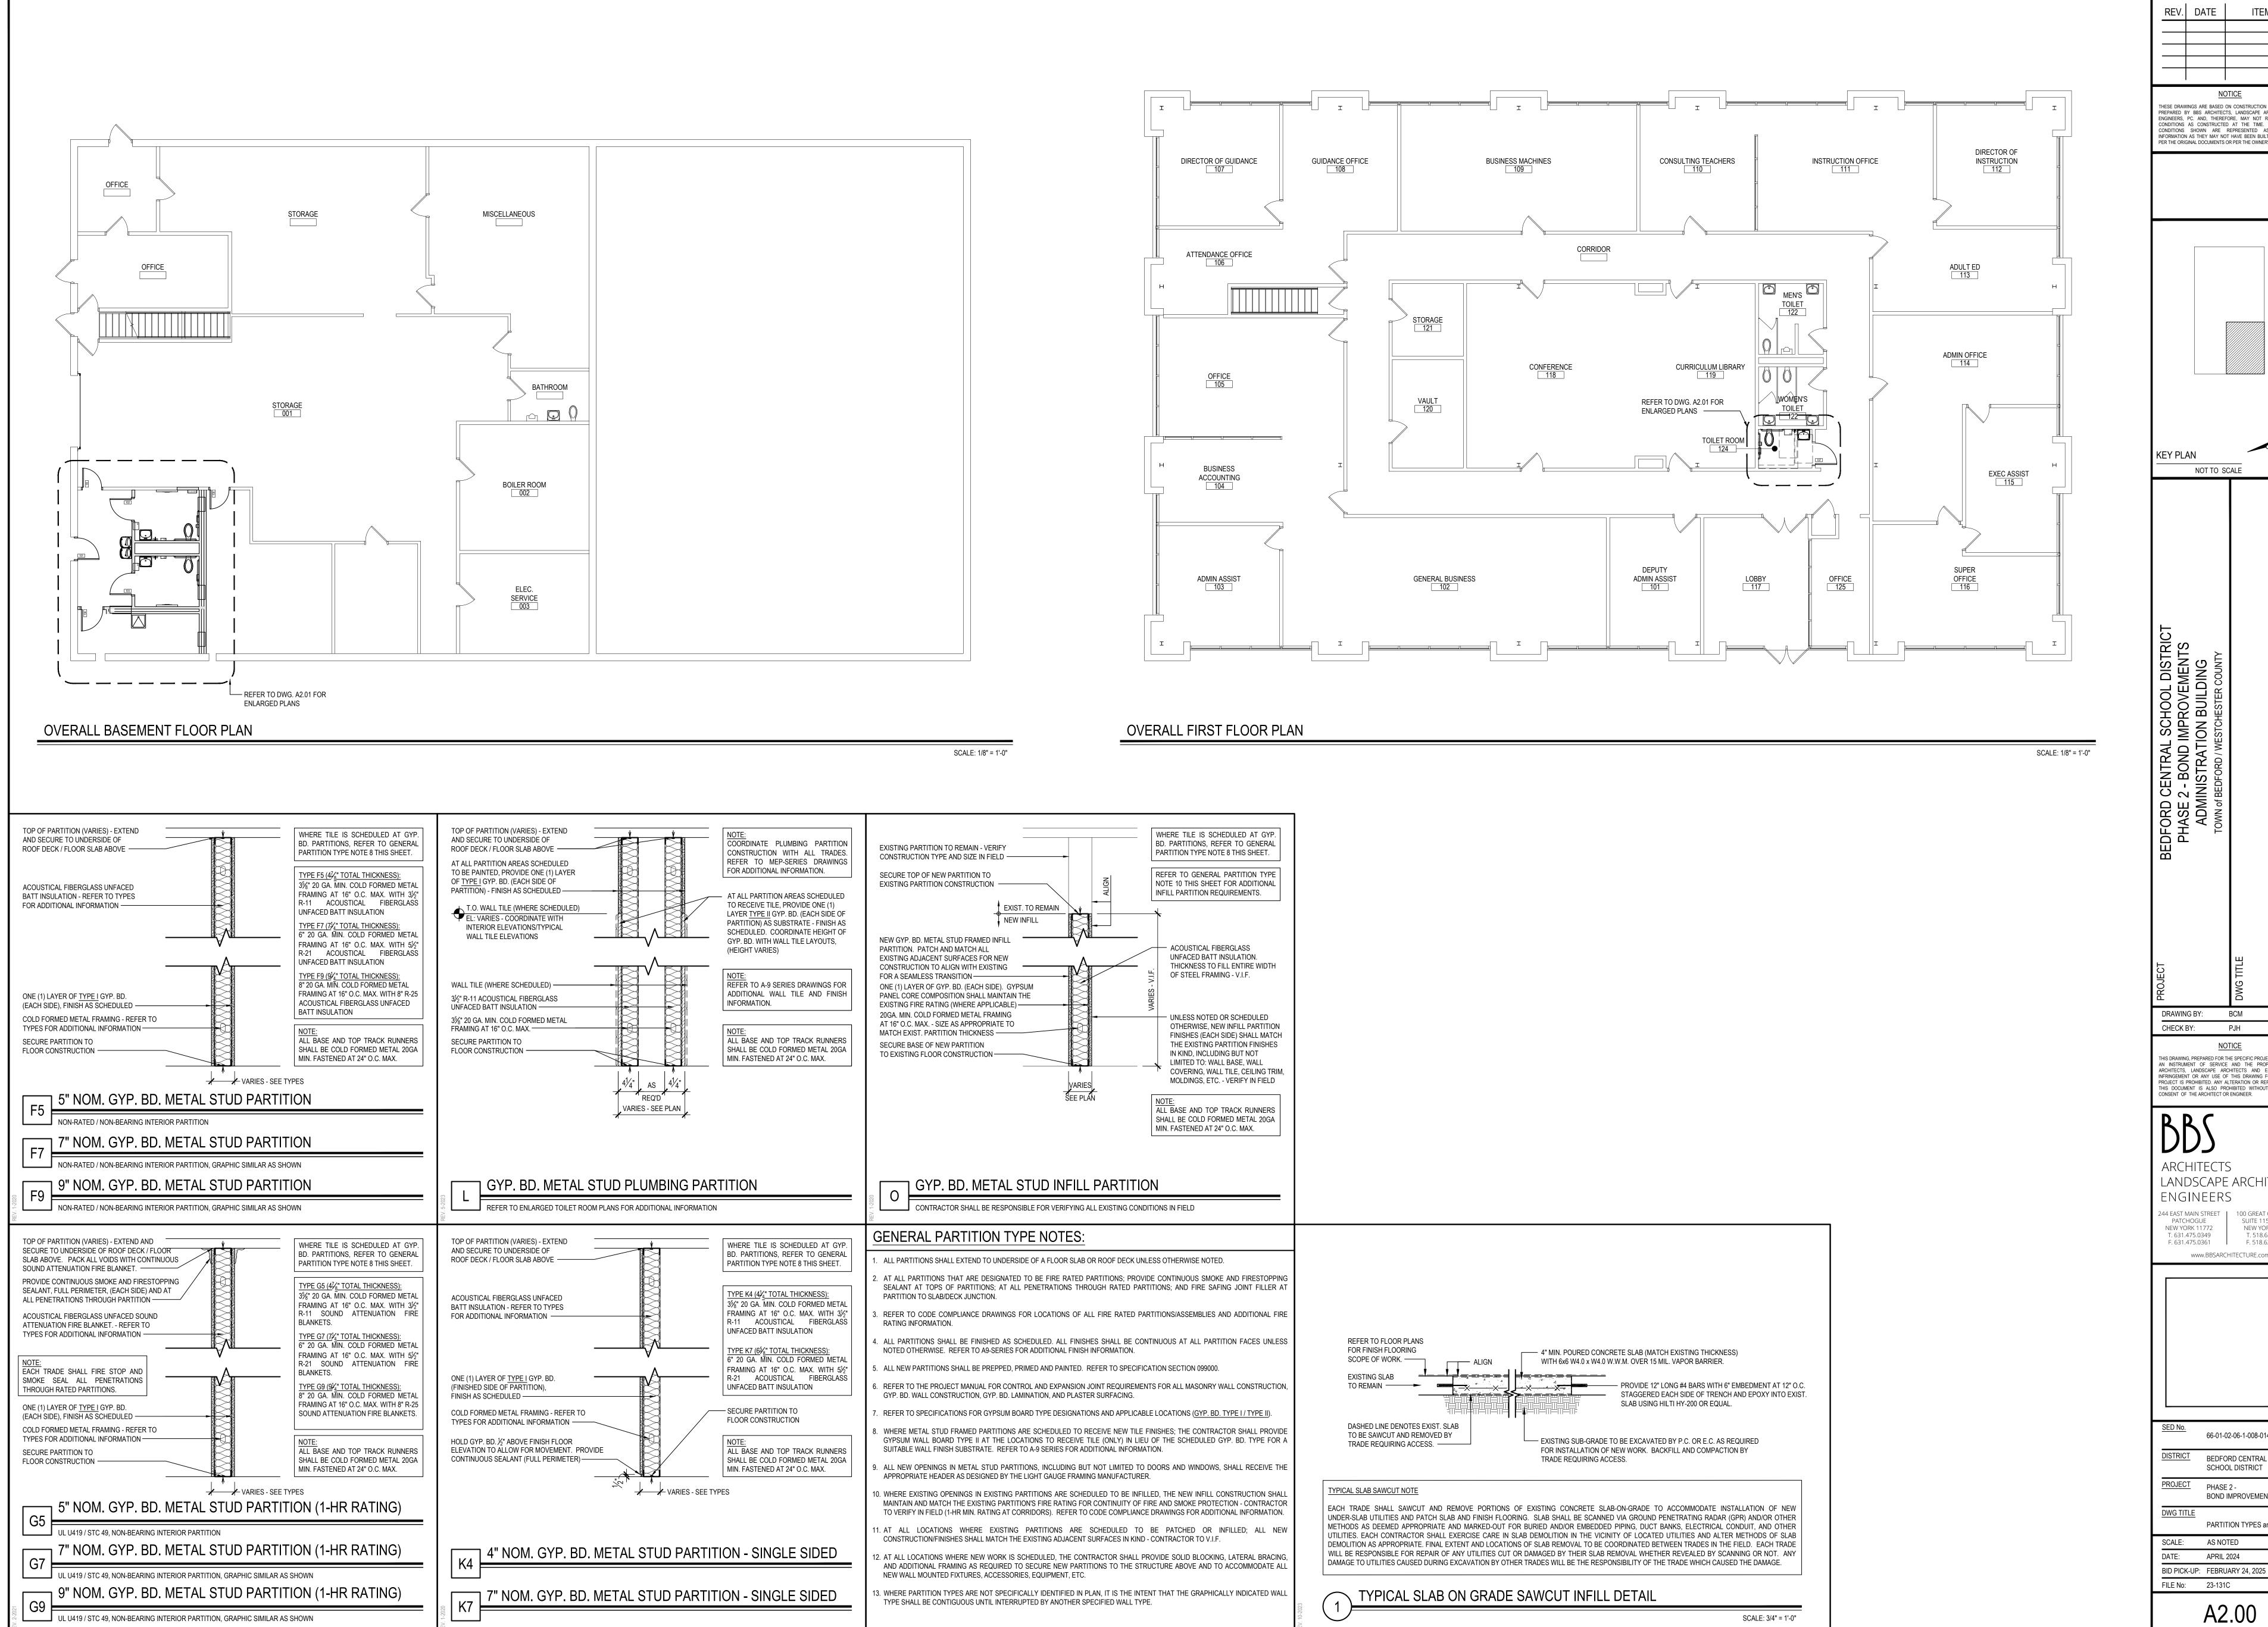
66-01-02-06-1-008-014 DISTRICT BEDFORD CENTRAL SCHOOL DISTRICT

PROJECT PHASE 2 -BOND IMPROVEMENTS

<u>DWG TITLE</u> SITE SEWER PLAN


BID PICK-UP: FEBRUARY 24, 2025 FILE No: 23-131C

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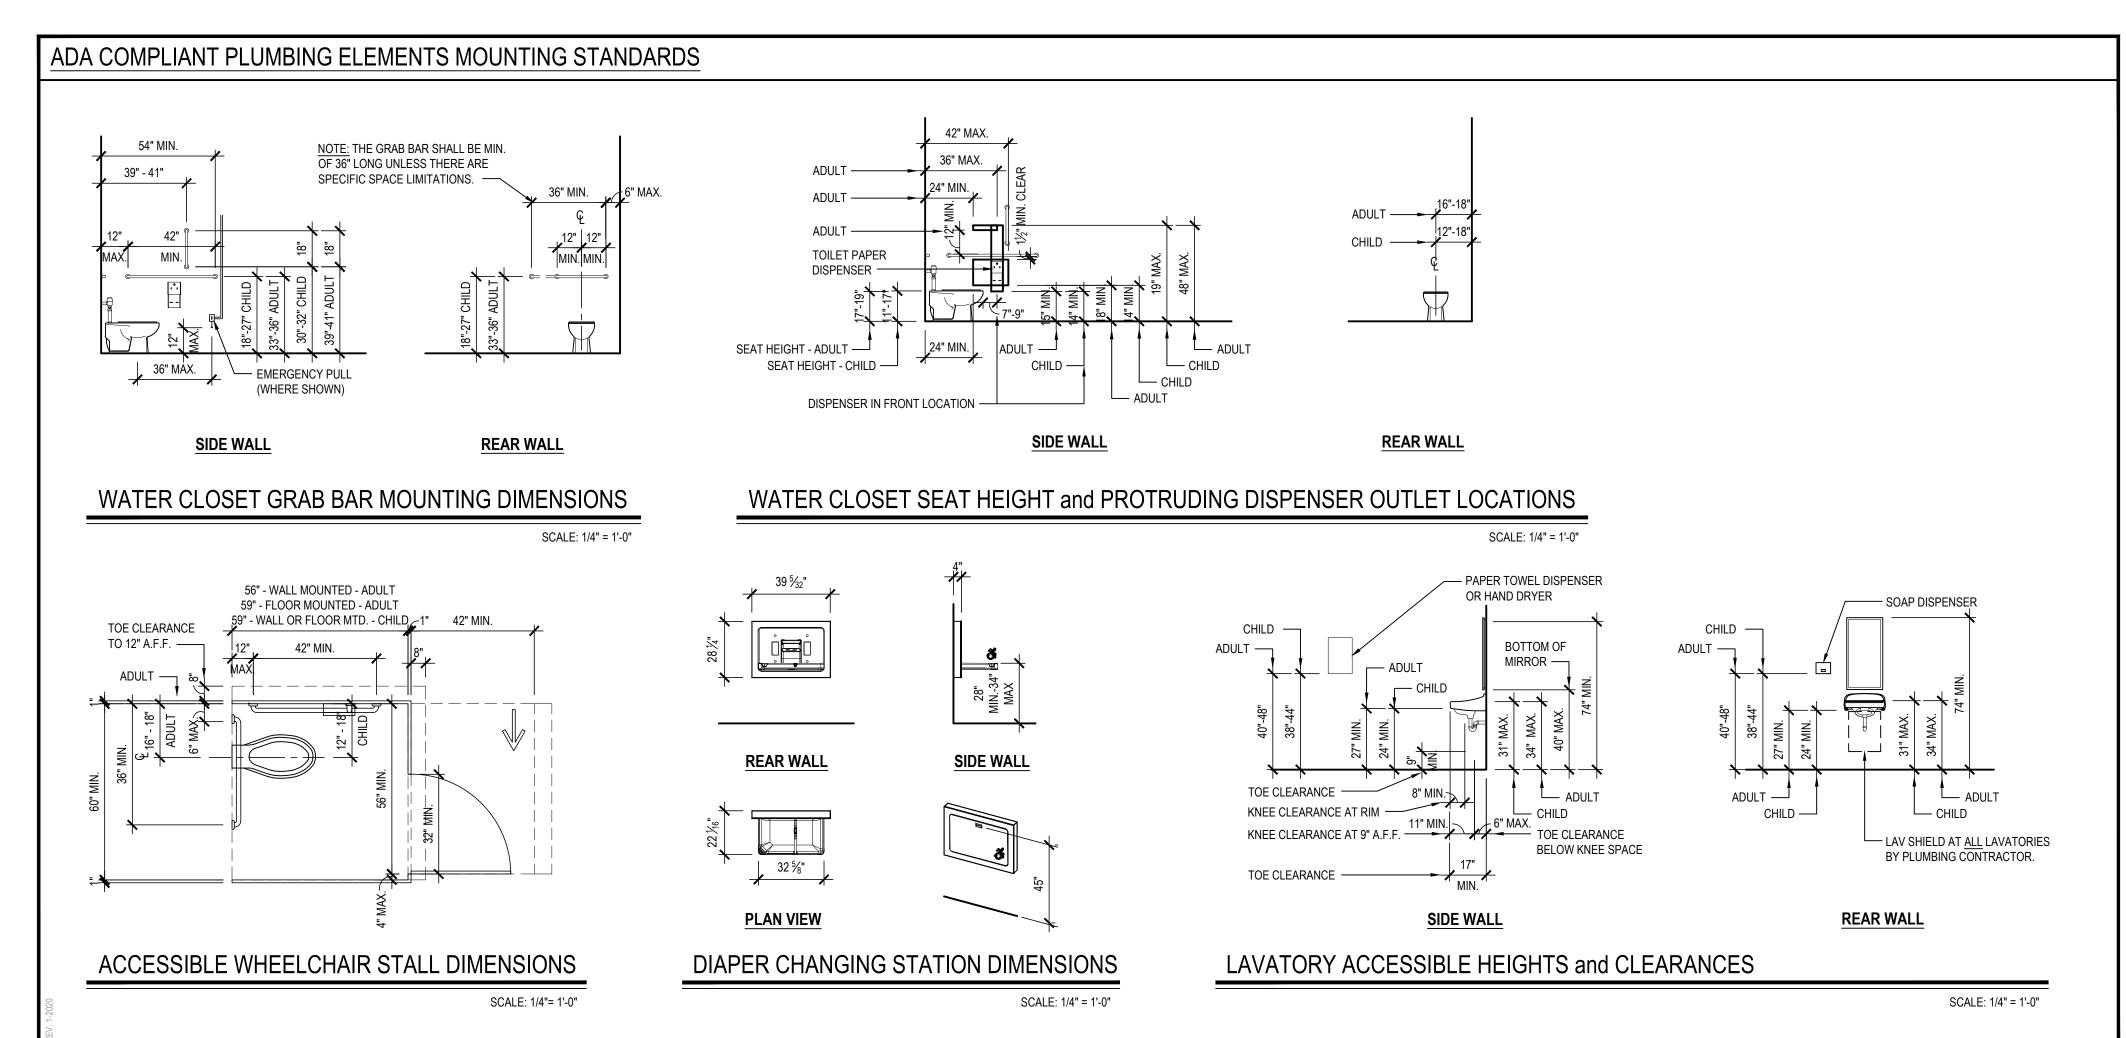
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A2.00





DEMOLITION PLAN PROPOSED TOILET ROOM PLAN SCALE: 1/4" = 1'-0" SCALE: 1/4" = 1'-0" NOTE: USE ADULT HEIGHT FIXTURES.

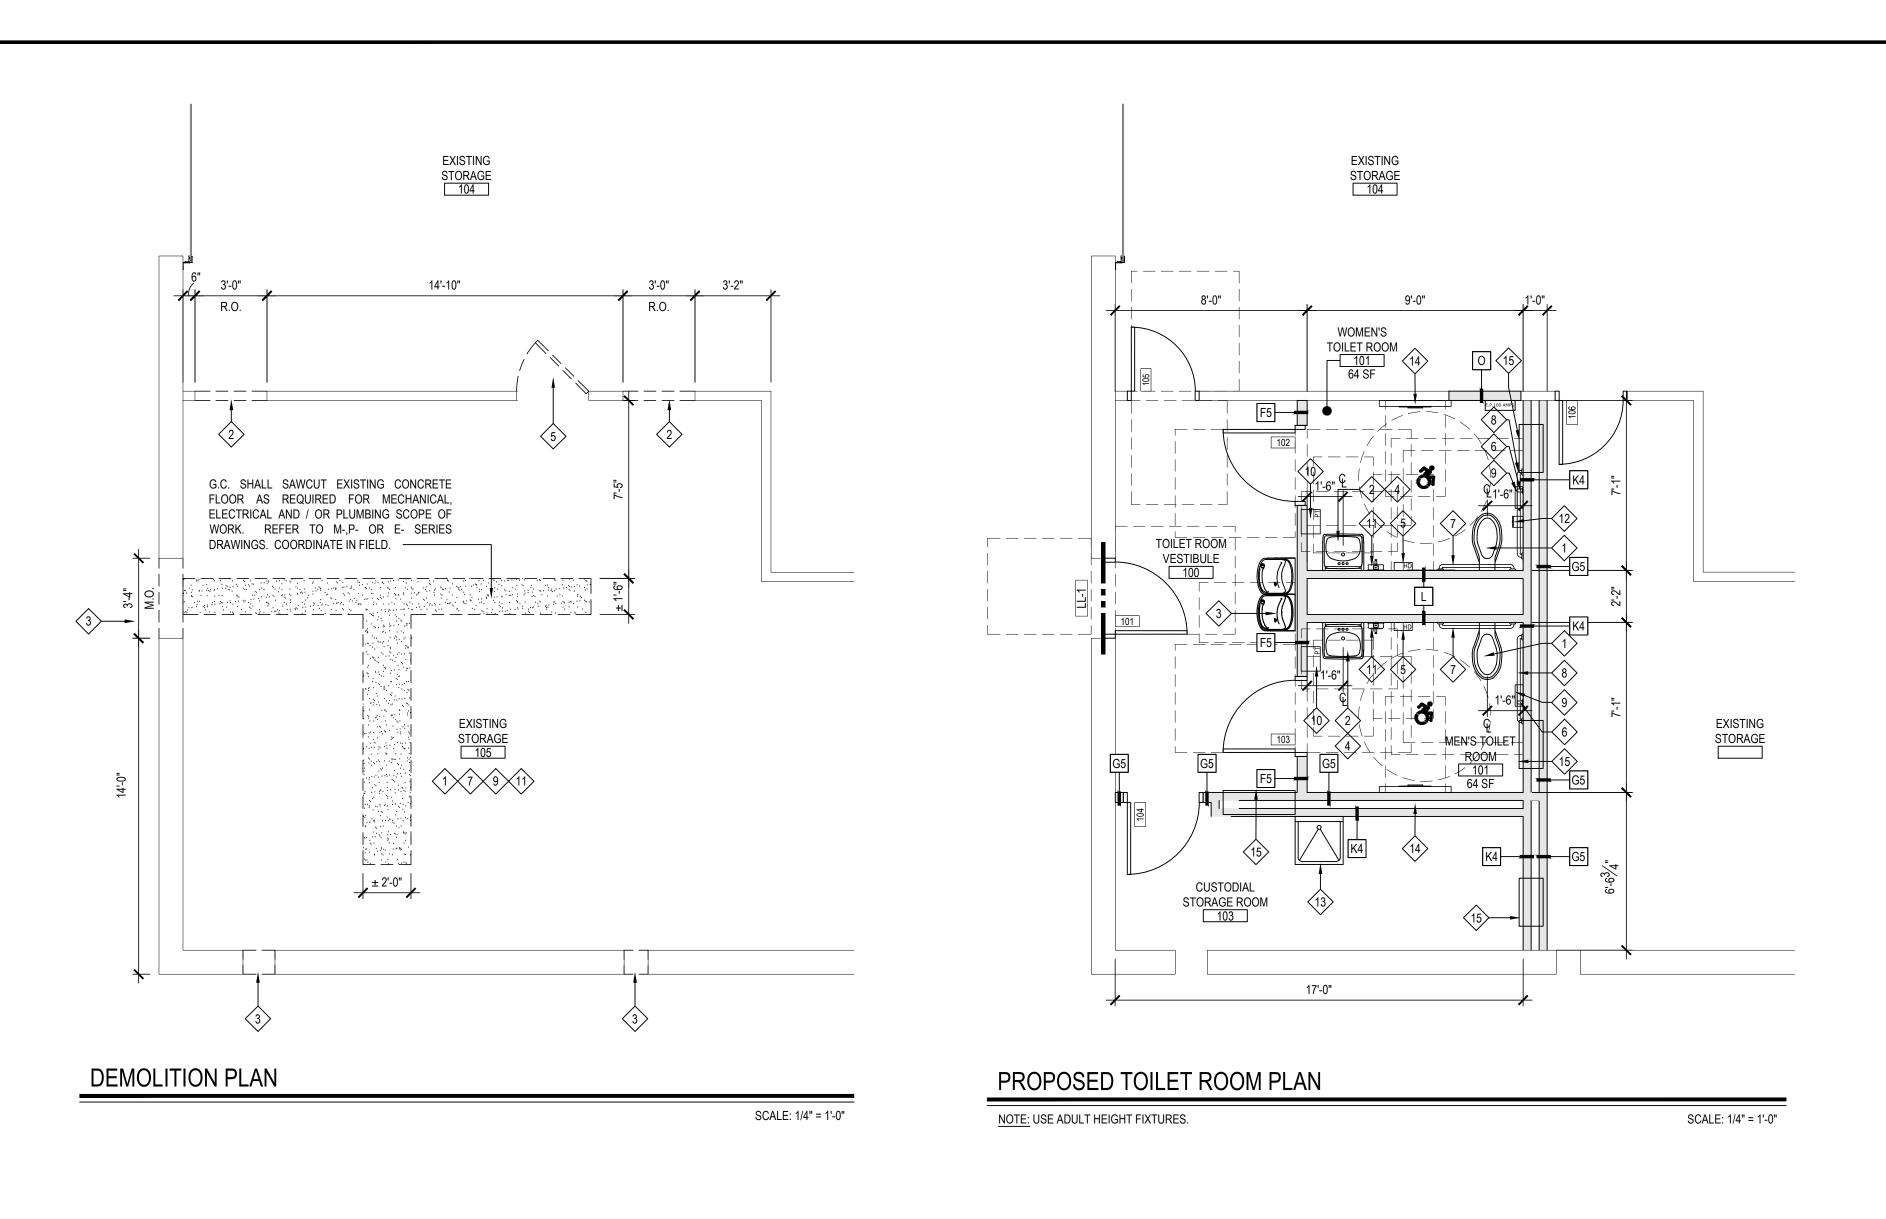

HAZARDOUS MATERIALS NOTES

- DESIGN-PHASE INSPECTION AND TESTING FOR ASBESTOS, LEAD AND / OR PCBs. SUCH REPORTS ARE CONTAINED IN THE PROJECT MANUAL AND MAY CONTAIN ADDITIONAL REQUIREMENTS BEYOND THOSE SHOWN IN THE CONSTRUCTION DRAWINGS AND DIVISION 1 RELATED SPECIFICATIONS.
- CONTRACTOR SHALL EMPLOY A PROPERLY CREDENTIALED HAZARDOUS MATERIALS
- REMOVAL OF LEAD CONTAINING CONSTRUCTION MATERIALS SHALL BE PERFORMED IN ACCORDANCE WITH FEDERAL HUD REGULATIONS AND THE EPA'S RRP RULE. THE WORK OF THIS PROJECT IS NOT INTENDED TO BE A LEAD ABATEMENT.
- WILL BE PERFORMED UPON FINAL CLEANING. FAILURE WILL REQUIRE RE-CLEANING BY THE CONTRACTOR.
- REGULATIONS AS ENFORCED BY NYS DEC. IF SUCH MATERIALS ALSO CONTAIN ASBESTOS, THEN SUCH MATERIALS SHALL BE HANDLED AND DISPOSED OF PER BOTH NYS DEC AND NYS ICR 56.
- CONTRACTOR SHALL COORDINATE HAZARDOUS MATERIALS REMOVAL ACTIVITIES WITH THE OWNER'S ENVIRONMENTAL CONSULTANT FOR APPROPRIATE PROJECT MONITORING.
- REMOVAL AND NOTIFY THE ARCHITECT.
- CONSTRUCTION DRAWINGS:
- (A1) ASBESTOS CONTAINING FLOOR TILE.

CONSTRUCTION DRAWINGS INDICATE EXTENT OF HAZARDOUS MATERIALS REMOVALS, WHICH MAY BE ASSUMED OR CONFIRMED POSITIVE. CONTRACTOR SHALL VERIFY QUANTITIES OF SUCH MATERIALS AND ACCOUNT FOR THEM IN THE BID.

OWNER HAS EMPLOYED AN ENVIRONMENTAL CONSULTANT TO PERFORM

- SUBCONTRACTOR AS REQUIRED FOR THE SCOPE OF WORK AT HAND.
- ASBESTOS ABATEMENT SHALL BE PERFORMED IN ACCORDANCE WITH NYS INDUSTRIAL CODE RULE 56.
- WHERE WORK INVOLVES LEAD CONTAINING CONSTRUCTION MATERIALS, WIPE TESTS
- PCB REMOVALS SHALL BE PERFORMED IN ACCORDANCE WITH FEDERAL EPA
- IF ANY SUSPECT MATERIALS ARE DISCOVERED DURING DEMOLITION THAT ARE OUTSIDE OF THE IDENTIFIED SCOPE OF WORK, THE CONTRACTOR SHALL CEASE
- THE FOLLOWING HAZARDOUS MATERIAL REMOVAL KEY NOTES CORRESPOND TO THE

DEMOLITION KEY NOTES

DEMOLITION SYMBOL LEGEND

SURFACES)

INFORMATION.

KEYED NOTE

DETAIL NUMBER

DRAWING NUMBER

XX DETAIL NUMBER

DRAWING NUMBER

XXXX - ROOM NAME

XXX SF ROOM AREA

IT'S ENTIRETY.

XXX ROOM NUMBER

 $\langle x \rangle$

X EXISTING WALL MOUNTED EMERGENCY LIGHTING, CONDUIT, WIRE MOLD, SPEAKERS, ETC. TO BE REMOVED AND DISPOSED OF IN THEIR ENTIRETY BY E.C.

REVISION CLOUD AND KEYED DESIGNATION. REFER TO DRAWING

TITLEBLOCK FOR ADDITIONAL INFORMATION.

EXISTING CONSTRUCTION TO BE REMOVED (PATCH ALL REMAINING

EXISTING FLOOR SLAB TO BE SAWCUT TO ACCOMMODATE NEW UNDER

SLAB UTILITIES. REFER TO SAWCUT DETAIL FOR ADDITIONAL

- PORTION OF EXISTING PLASTER / GYPSUM BD. WALL TO BE REMOVED. PREP OPENING
- PORTION OF EXISTING EXTERIOR WALL CONSTRUCTION TO BE SAWCUT, REMOVED AND DISPOSED OF FOR NEW MASONRY OPENING. PROVIDE NEW LINTEL. TOOTH-IN
- EXISTING DOOR TO BE REMOVED AND DISPOSED OF. EXISTING FRAME TO REMAIN. MODIFY FOR NEW DOOR HARDWARE. PREP, PRIME AND PAINT. COLOR AS SELECTED
- EXISTING DOOR AND HOLLOW METAL FRAME TO BE REMOVED AND DISPOSED OF. PREP OPENING FOR NEW INFILL.
- EXISTING WALL MOUNTED TOILET ROOM ACCESSORIES TO BE REMOVED AND TURNED OVER TO THE DISTRICT.
- EXISTING CEILING MOUNTED EMERGENCY LIGHTING, CONDUIT, WIRE MOLD,
- SPEAKERS, ETC. TO BE REMOVED AND DISPOSED OF IN THEIR ENTIRETY BY E.C. EXISTING ACOUSTICAL CEILING TILE AND GRID TO BE REMOVED AND DISPOSED OF IN
- EACH TRADE SHALL SAWCUT EXISTING CONCRETE FLOOR AS REQUIRED FOR MECHANICAL, ELECTRICAL AND / OR PLUMBING SCOPE OF WORK. REFER TO M-,P- OR
- EXISTING VINYL ASBESTOS TILE AND MASTIC TO BE REMOVED AND DISPOSED OF. PREP FLOOR AS REQUIRED FOR SELF-LEVELING FOR NEW FINISH FLOORING.
- PREP FLOOR AS REQUIRED FOR SELF-LEVELING FOR NEW FINISH FLOORING.
- 2 P.C. TO DISCONNECT. G.C. TO DISPOSE OF EXISTING PLUMBING FIXTURES
- E.C. TO REMOVE AND RELOCATE EXISTING ELECTRICAL PANELS. REFER TO E.- SERIES DRAWINGS. G.C. TO REMOVE WOOD CABINET.
- 14> WALL PANELING TO BE REMOVED. PREP WALL FOR NEW FINISH. 5> RECESSED CABINET HEATER MY M.C. SEE M- SERIES DRAWINGS.

E- SERIES DRAWINGS. COORDINATE IN FIELD.

TOILET FIXTURE MOUNTING HEIGHTS


- AT ALL <u>STUDENT USE TOILET FACILITIES</u>, ALL TOILET FIXTURES, URINALS, LAVATORIES, GRAB BARS, ACCESSORIES, ETC. SHALL BE MOUNTED EITHER AT ADULT HEIGHT OR CHILD HEIGHT AS INDICATED ON THE PLANS AND 'TYPICAL ADA PLUMBING ELEMENTS MOUNTING STANDARDS.'
- AT ALL <u>ADULT USE TOILET</u> <u>FACILITIES</u>, ALL TOILET FIXTURES, URINALS, LAVATORIES, GRAB BARS, ACCESSORIES, ETC. SHALL BE MOUNTED AT ADULT HEIGHT AS INDICATED ON THE PLANS AND 'TYPICAL ADA PLUMBING ELEMENTS
- MOUNTING STANDARDS.' THE HEIGHT OF ALL GRAB BAR MUST BE THE SAME WITHIN EACH STALL / ROOM.
- THE CHILD MOUNTING HEIGHT LIMITS APPLY FOR ADA AND NON-ADA LOCATIONS.

TOILET ROOM KEY NOTES

- P.C. TO FURNISH AND INSTALL NEW ADA ACCESSIBLE WATER CLOSET AND 1> FLUSHOMETER.
- P.C. TO FURNISH AND INSTALL NEW ADA ACCESSIBLE LAVATORY, FAUCET AND LAV SHIELD.
- P.C. TO PROVIDE AND INSTALL NEW DRINKING FOUNTAIN. E.C. TO PROVIDE FINAL POWER CONNECTIONS. COORDINATE IN FIELD.
- 4 G.C. TO FURNISH AND INSTALL NEW MIRROR.
- G.C. TO PROVIDE AND INSTALL NEW ADA COMPLIANT SURFACE MOUNTED HAND DRYER. E.C. TO CONNECT TO NEW OR EXISTING POWER.
- 6 G.C. TO FURNISH AND INSTALL NEW VERTICAL 18" GRAB BAR.
- (7) G.C. TO FURNISH AND INSTALL NEW HORIZONTAL 36" GRAB BAR.
- (8) G.C. TO FURNISH AND INSTALL NEW HORIZONTAL 42" GRAB BAR.
- (9) OWNER TO PROVIDE, G.C. TO FURNISH AND INSTALL NEW TOILET PAPER
- OWNER TO PROVIDE, G.C. TO FURNISH AND INSTALL NEW RECESSED C-FOLD PAPER TOWEL DISPENSER
- OWNER TO PROVIDE, G.C. TO FURNISH AND INSTALL NEW WALL MOUNTED SOAP
- DISPENSER.
- (12) G.C. TO FURNISH AND INSTALL NEW SANITARY NAPKIN WASTE RECEPTACLE. (13) P.C. TO FURNISH AND INSTALL NEW SERVICE SINK
- (14) G.C. TO FURNISH AND INSTALL NEW DIAPER CHANGING STATION.


DEMOLITION and REMOVAL NOTES

- THE GENERAL CONTRACTOR IS RESPONSIBLE FOR ALL DEMOLITION AND REMOVALS, UNLESS NOTED OTHERWISE. MECHANICAL, PLUMBING AND ELECTRICAL CONTRACTORS SHALL BE RESPONSIBLE FOR ALL DISCONNECTS. G.C. TO COORDINATE DEMOLITION WITH M.C., P.C., AND E.C. REFER TO M.E.P. SERIES DEMOLITION DRAWINGS FOR ADDITIONAL INFORMATION AND DEMOLITION SCOPE BY GENERA CONTRACTOR NOT SHOWN THIS DRAWING. TYPICAL FOR ALL AREAS OF INTERIOR DEMOLITION AND / OR RECONSTRUCTION.
- ALL OPENINGS IN EXISTING INTERIOR AND EXTERIOR WALLS SHALL BE PATCHED AS REQUIRED AND MASONRY TOOTHED-IN TO MATCH ADJACENT.
- G.C. SHALL PATCH, REPLACE, OR REPAIR DAMAGE CAUSED TO EXIST. FLOOR, WALLS ROOF, ETC. SHOWN TO REMAIN AS A RESULT OF DEMOLITION TO PRIOR CONDITION OR MATCH ADJACENT NEW CONSTRUCTION.
- G.C. SHALL VERIFY ALL REMOVALS W/ OWNERS REPRESENTATIVE/OWNER, AND M.C P.C., OR E.C. PRIOR TO COMMENCEMENT.
- NOTED WALL REMOVALS SHALL INCLUDE ALL DOORS, WINDOWS AND FRAMES WHERE
- REFER TO STRUCTURAL DRAWINGS FOR LINTEL SCHEDULE.
- THROUGHOUT ALL AREAS OF WORK, E.C. SHALL ORGANIZE ALL EXISTING WIRES T REMAIN AT UNDERSIDE OF ROOF DECK ABOVE NEW FINISHED CEILING. SECURE T BOTTOM OF EXISTING ROOF DECK, STEEL JOISTS, ETC. REFER TO E-SERIES

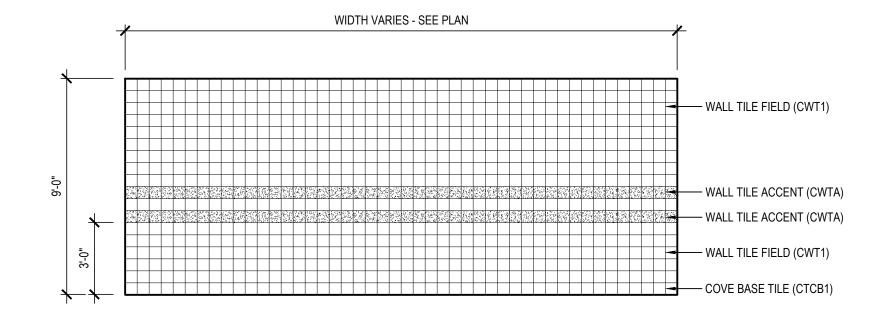

TYPICAL TOILET ROOM ELEVATION

SCALE: 1/4" = 1'-0"

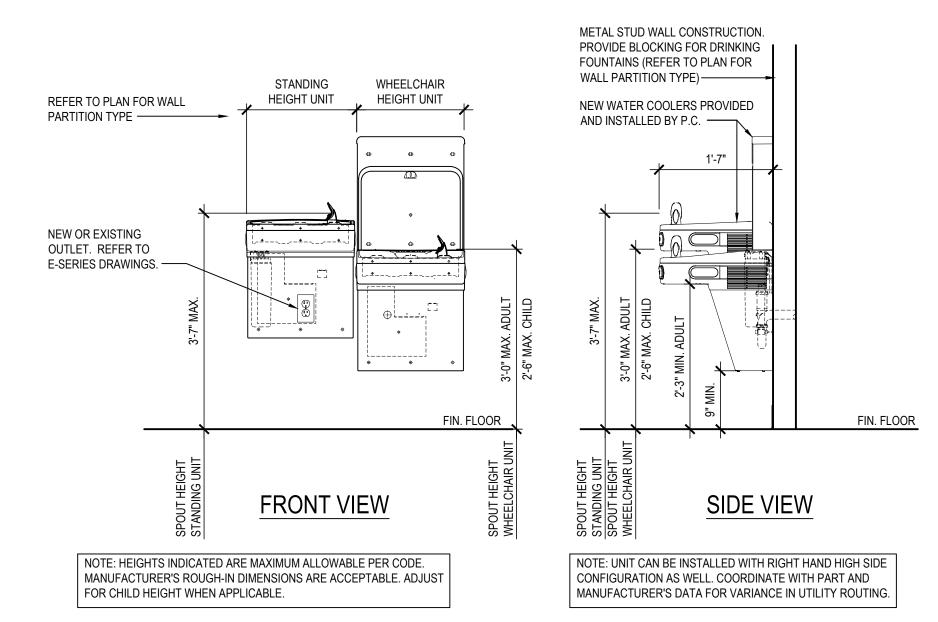


ADA COMPLIANT DRINKING FOUNTAIN/BOTTLE FILL STATION DETAIL

'EZH20' BOTTLE FILLING STATION WITH FILTERED BI-LEVEL LZ COOLER BY 'ELKAY' OR APPROVED EQUAL. SCALE: 3/4"= 1'-0" SHOWN WITH LEFT HAND HIGH SIDE CONFIGURATION.

REV. DATE

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KEY PLAN
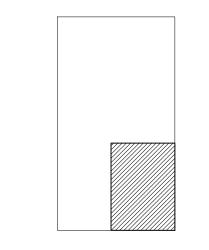
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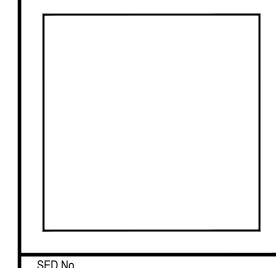
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66-01-02-06-1-008-014 DISTRICT BEDFORD CENTRAL SCHOOL DISTRICT PROJECT PHASE 2 -BOND IMPROVEMENTS


PLANS and DETAILS SCALE: AS NOTED APRIL 2024 BID PICK-UP: FEBRUARY 24, 2025

DWG TITLE TOILET ROOM


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										DO	OR SCI	HEDULI	E						
DOOR NO.	LOCATION	SIGNAGE	DOOR							FRAME			HARDWARE	DETAIL				FIRE RATING PENABLY	DOOR NO
	LOCATION	SIGNAGE	LEAVES WIDTH		HEIGHT THICKNE		ELEV. TYPE	E MAT.	GLAZING	TYPE.	YPE. MAT. GLAZING	SET HEAD	JAMB	JAMB SILL	T'HOLD	REMARKS			
101	EXTERIOR		1	3'-0"	7'-0"	1 3/4"	В	FRP	INSUL.	F1	ALUM.		3	H1	J1		T1		101
102	WOMEN'S TOILET ROOM	D	1	3'-0"	7'-0"	1 3/4"	А	SCLCOV		F1	H.M.		2	H2	J2		T2	20 MIN.	102
103	MEN'S TOILET ROOM	D	1	3'-0"	7'-0"	1 3/4"	А	SCLCOV		F1	H.M.		2	H2	J2		T2	20 MIN.	103
104	CUSTODIAL STORAGE ROOM	В	1	3'-0"	7'-0"	1 3/4"	А	SCLCOV		F1	H.M.		1	H3	J3		T3	45 MIN.	104
105	TOILET ROOM VESTIBULE	В	1	3'-0"	7'-0"	1 3/4"	В	SCLCOV	TEMP.	F1	H.M.		1	H3 SIM.	J3		T3 SIM.	20 MIN.	105
106	STORAGE ROOM	В	1	3'-0"	7'-0"	1 3/4"	А	SCLCOV		F1	H.M.		1	H3 SIM.	J3 SIM.		T3 SIM.	45 MIN.	106
107	TOILET ROOM	D	1	3'-0"	7'-0"	1 3/4"	А	SCLCOV		F1	E.T.R.							20 MIN. EXISTING FRAME TO REMAIN. MODIFY FOR NEW DOOR HARDWARE	107



FRAME TYPE ELEVATIONS NOTE: REFER TO DOOR SCHEDULE FOR DOOR FRAME MATERIAL.

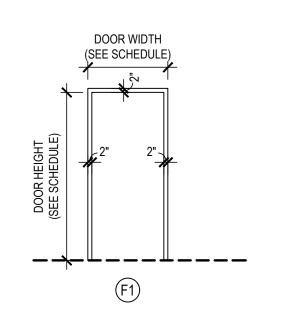


DOOR TYPE ELEVATIONS

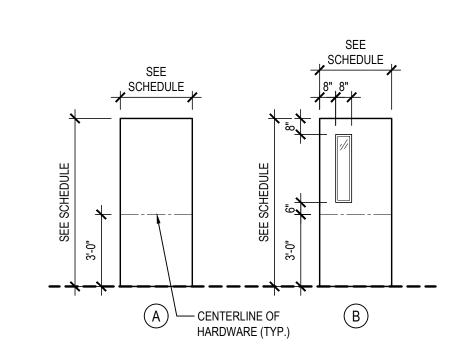
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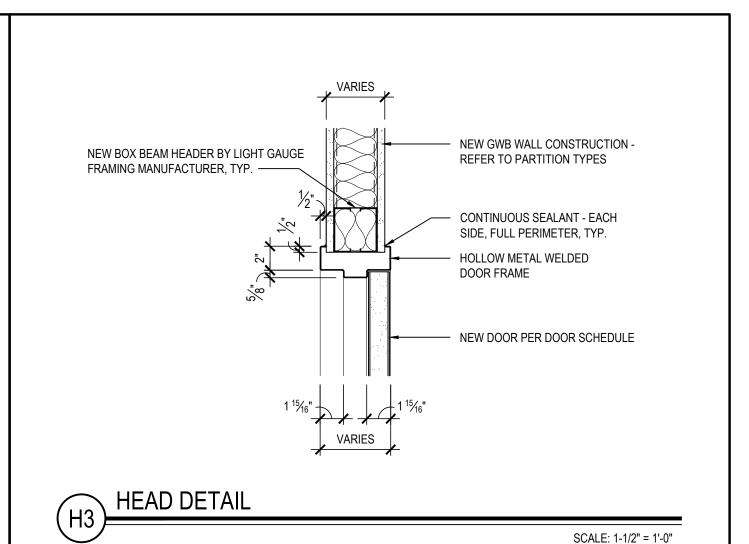
NOTE: REFER TO DOOR SCHEDULE FOR DOOR MATERIAL AND GLAZING.


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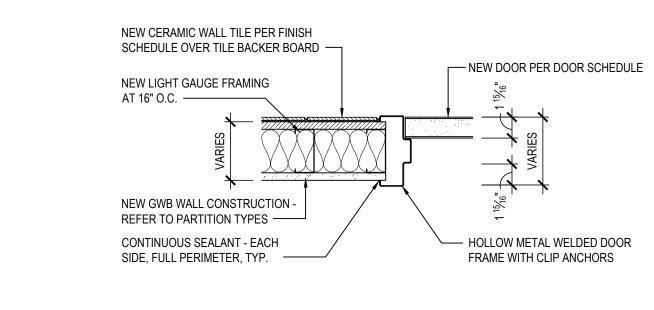
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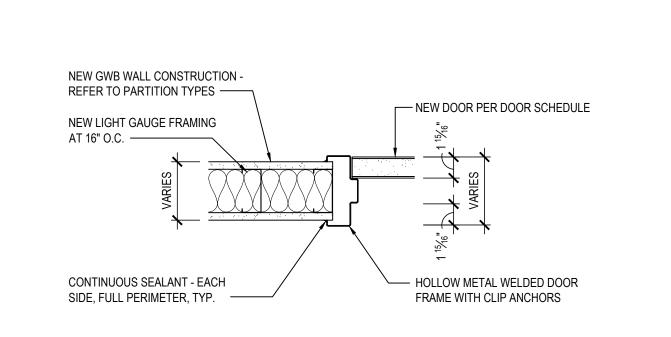







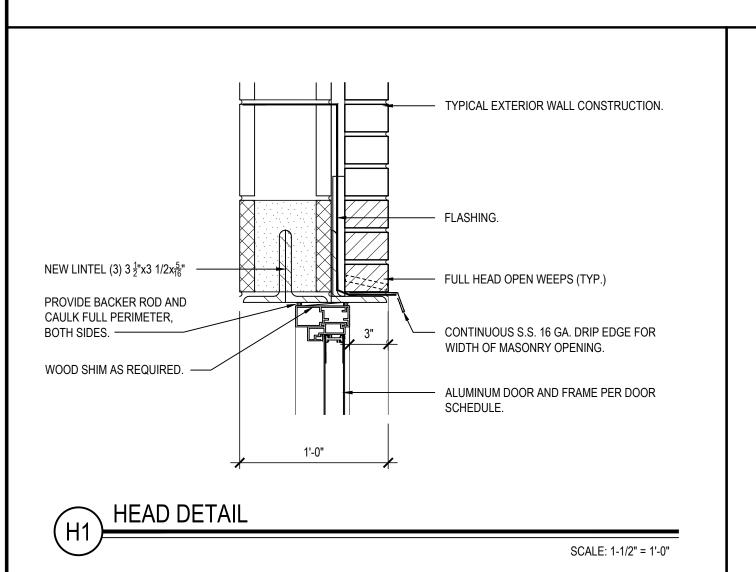


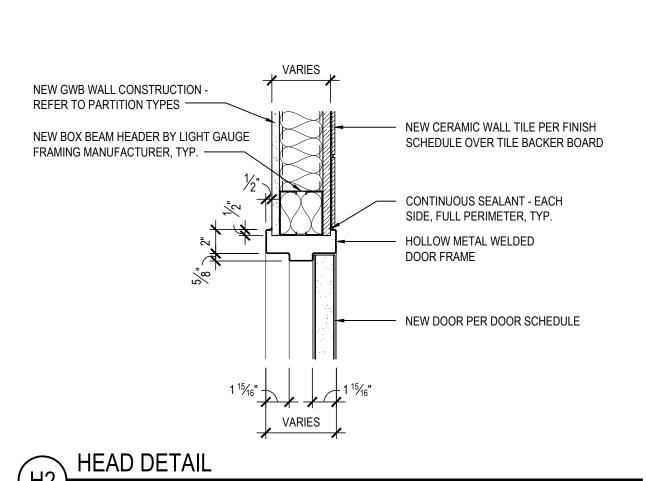


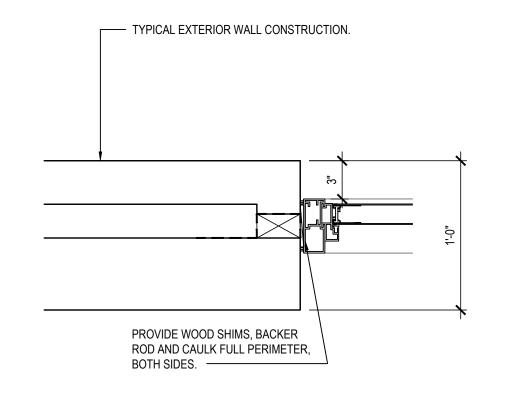


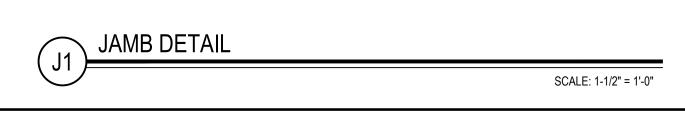





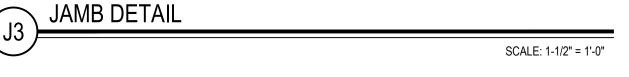

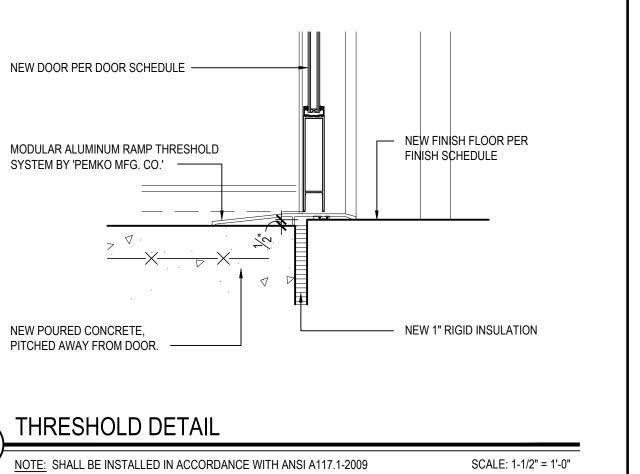

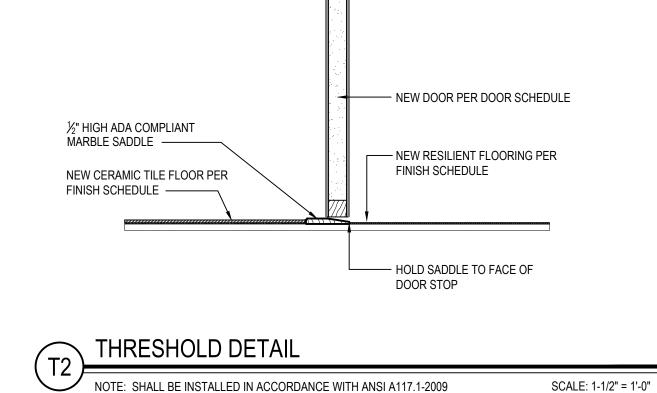

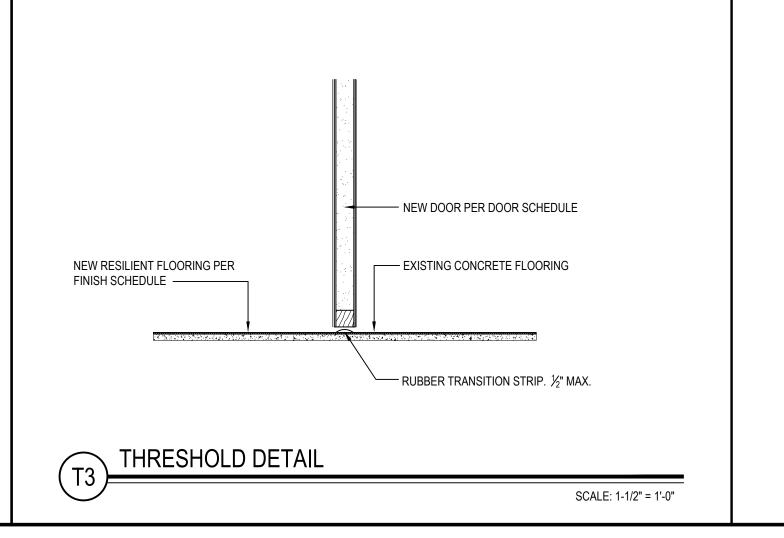

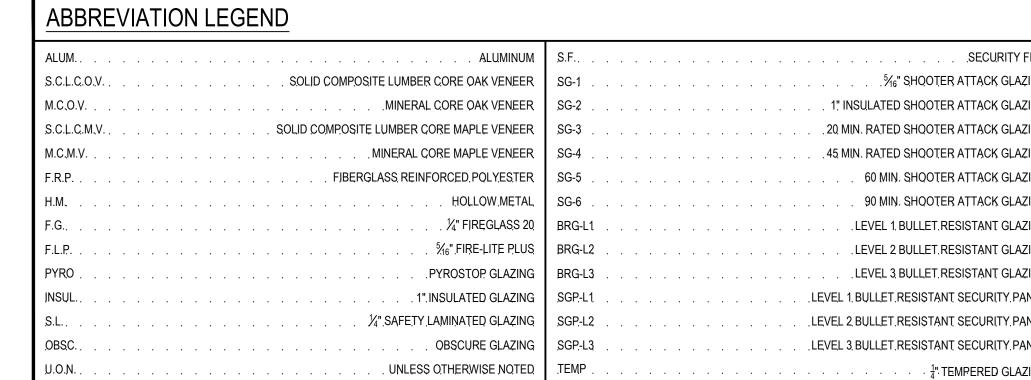

5/16" SHOOTER ATTACK GLAZING . 45 MIN. RATED SHOOTER ATTACK GLAZING 60 MIN. SHOOTER ATTACK GLAZING 90 MIN. SHOOTER ATTACK GLAZING

DOOR NOTES

ALL DOORS, FRAMES AND HARDWARE SHALL BE PROVIDED AND INSTALLED BY GENERAL CONTRACTOR UNLESS OTHERWISE NOTED.

GENERAL CONTRACTOR SHALL COORDINATE ALL KEYING WITH OWNER.


- FIRE RATED WOOD DOORS (60 MIN. AND ABOVE ONLY) SHALL HAVE SOLID MINERAL CORE, ALL OTHER WOOD DOORS SHALL HAVE SOLID COMPOSITE LUMBER CORE.
- FLUSH WOOD DOORS SHALL BE 5 PLY LAMINATED FACE SHEETS WITH 2 PLY FINISH VENEER OVER SPECIFIED CORE. AT FIRE RATED DOORS, TOP AND BOTTOM RAILS AND STILES SHALL BE FIRE RESISTANT COMPOSITION MATERIAL BONDED TO CORE. PROVIDE SOLID BLOCKING FOR CLOSER AND HARDWARE. REFER TO SPECIFICATION SECTION 081416.
- ALL GLAZING IN DOORS SHALL BE INSTALLED IN METAL VISION KIT TO MATCH FIRE LABEL. VISION KIT COLOR SHALL BE AS SELECTED BY ARCHITECT. INTERIOR GLAZING TYPES AND SIZES SHALL CONFORM TO NFPA 80 AND/OR ASTM E119. WHERE SECURITY GLAZING IS INDICATED, VISION KIT SHALL BE THROUGH BOLT TYPE.
- ALL NEW H.M. FRAMES SHALL BE FULLY WELDED WRAP AROUND TYPE (UNLESS OTHERWISE NOTED OR DETAILED). THROATS SHALL BE SIZED ACCORDING TO WALL THICKNESS AND FINISH, REFER TO FLOOR PLAN AND ENLARGED DETAILS FOR ADDITIONAL INFORMATION.
- FOR DOOR REPLACEMENTS IN KIND, GENERAL CONTRACTOR SHALL MODIFY AND PATCH EXISTING WOOD OR H.M. DOOR FRAMES (DESIGNATED TO REMAIN) TO ACCOMMODATE NEW DOOR OPERATOR, LOCKSET, LATCH, HINGES, DOOR SWING AND/OR CLOSER, ETC. AS REQUIRED FOR COMPLETE AND FUNCTIONAL OPERATION.
- GENERAL CONTRACTOR IS RESPONSIBLE FOR VERIFYING HEIGHT AND WIDTH OF PROPOSED DOORS TO BE INSTALLED IN EXISTING FRAMES (PRIOR TO SHOP DRAWING SUBMITTAL) TO ENSURE PROPER FIT AND DOOR FUNCTION.
- ALL NEW HOLLOW METAL FRAMES AND HOLLOW METAL DOORS SHALL BE FINISH PAINTED. REFER TO SPECIFICATION SECTION 099000 FOR PAINT TYPE. COLOR AS SELECTED BY
- GENERAL CONTRACTOR SHALL PROVIDE AND INSTALL A.D.A. COMPLIANT SIGNAGE AT ALL DOORS WHERE SPECIFIED IN DOOR SCHEDULE AND/OR SHOWN ON FLOOR PLANS. INSTALL IN CONFORMANCE WITH ALL ADA HEIGHT AND PLACEMENT REQUIREMENTS.
- ▲ A. WHERE DENOTED IN SCHEDULE, PROVIDE 4"x4" SIGNAGE WITH BRAILLE INDICATING ROOM NUMBER (COORD. WITH OWNER), MODEL No. E-BTCUST.
- ▲ B. WHERE DENOTED IN SCHEDULE, PROVIDE 4"x12" SIGNAGE WITH BRAILLE INDICATING ROOM NAME AND NUMBER (COORD. WITH OWNER), MODEL No. E-BTCUST. ▲ C. WHERE DENOTED IN SCHEDULE, PROVIDE 8"x8" SIGNAGE WITH BRAILLE INDICATING GENDER AND WHEELCHAIR PICTOGRAMS AND ROOM NAME AT MULTI-USE TOILET ROOMS. - AT MULTI-USE TOILET ROOMS, PROVIDE AND INSTALL MODEL No. X-5687 (WOMEN), X-5672 (MEN), X-7095 (BOY'S), X-7096 (GIRL'S). - AT MULTI-USE ACCESSIBLE TOILET ROOMS, PROVIDE AND INSTALL MODEL No. X-5688 (WOMEN), X-5671 (MEN), X-7108 (BOY'S), X-7107 (GIRL'S).
- ▲ D. WHERE DENOTED IN SCHEDULE, PROVIDE 6"x9" SIGNAGE WITH BRAILLE INDICATING GENDER AND WHEELCHAIR PICTOGRAMS AND ROOM NAME AT SINGLE-USE TOILET ROOMS. - AT SINGLE-USE TOILET ROOMS, PROVIDE AND INSTALL MODEL No. E-BTCUST. SIGN SHALL SPECIFY STAFF OR STUDENT USE AS REQUIRED. - AT SINGLE-USE ACCESSIBLE TOILET ROOMS, PROVIDE AND INSTALL MODEL No. E-BTCUST. SIGN SHALL SPECIFY STAFF OR STUDENT USE AS REQUIRED.


MANUFACTURER: "ALLSTATE SIGN AND PLAQUE", DEER PARK, NY OR APPROVED EQUAL. ALL SIGNAGE SHALL BE SUBMITTED TO ARCHITECT FOR REVIEW AND APPROVAL. COLOR AS SELECTED BY ARCHITECT

ALL REMOVABLE MULLIONS ARE TO BE KEYED ALIKE AND TO MATCH EXISTING BUILDING SYSTEM.


AUTOMATIC DOOR OPERATORS - THE ELECTRICAL CONTRACTOR SHALL PROVIDE A LINE VOLTAGE CIRCUIT TO THE AUTO OPERATOR. LOCATION SHALL BE COORDINATED WITH THE GENERAL CONTRACTOR. THE GENERAL CONTRACTOR IS RESPONSIBLE FOR ALL WIRING ASSOCIATED WITH AUTOMATIC DOOR OPERATORS, INCLUDING ELECTRONIC STRIKE, PUSH BUTTONS, TRANSFORMERS AND ANY OTHER DEVICES REQUIRED FOR A FULLY OPERATIONAL SYSTEM.


FIRE RATED GLAZING WITH SURFACE APPLIED FILMS WILL NOT BE CONSIDERED EQUIVALENT WHERE LAMINATED FILM IS SPECIFIED.

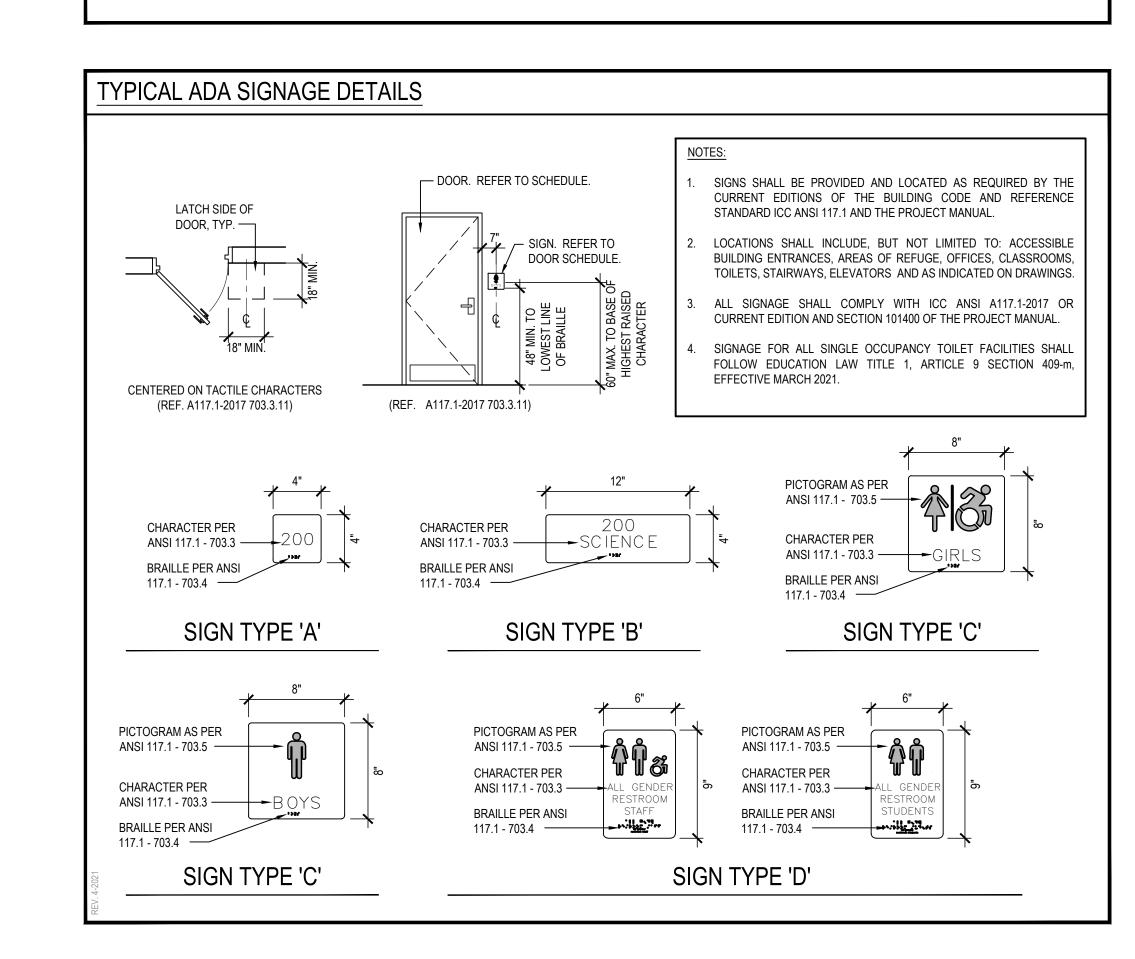


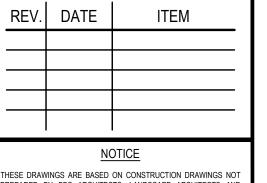


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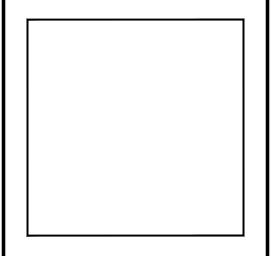
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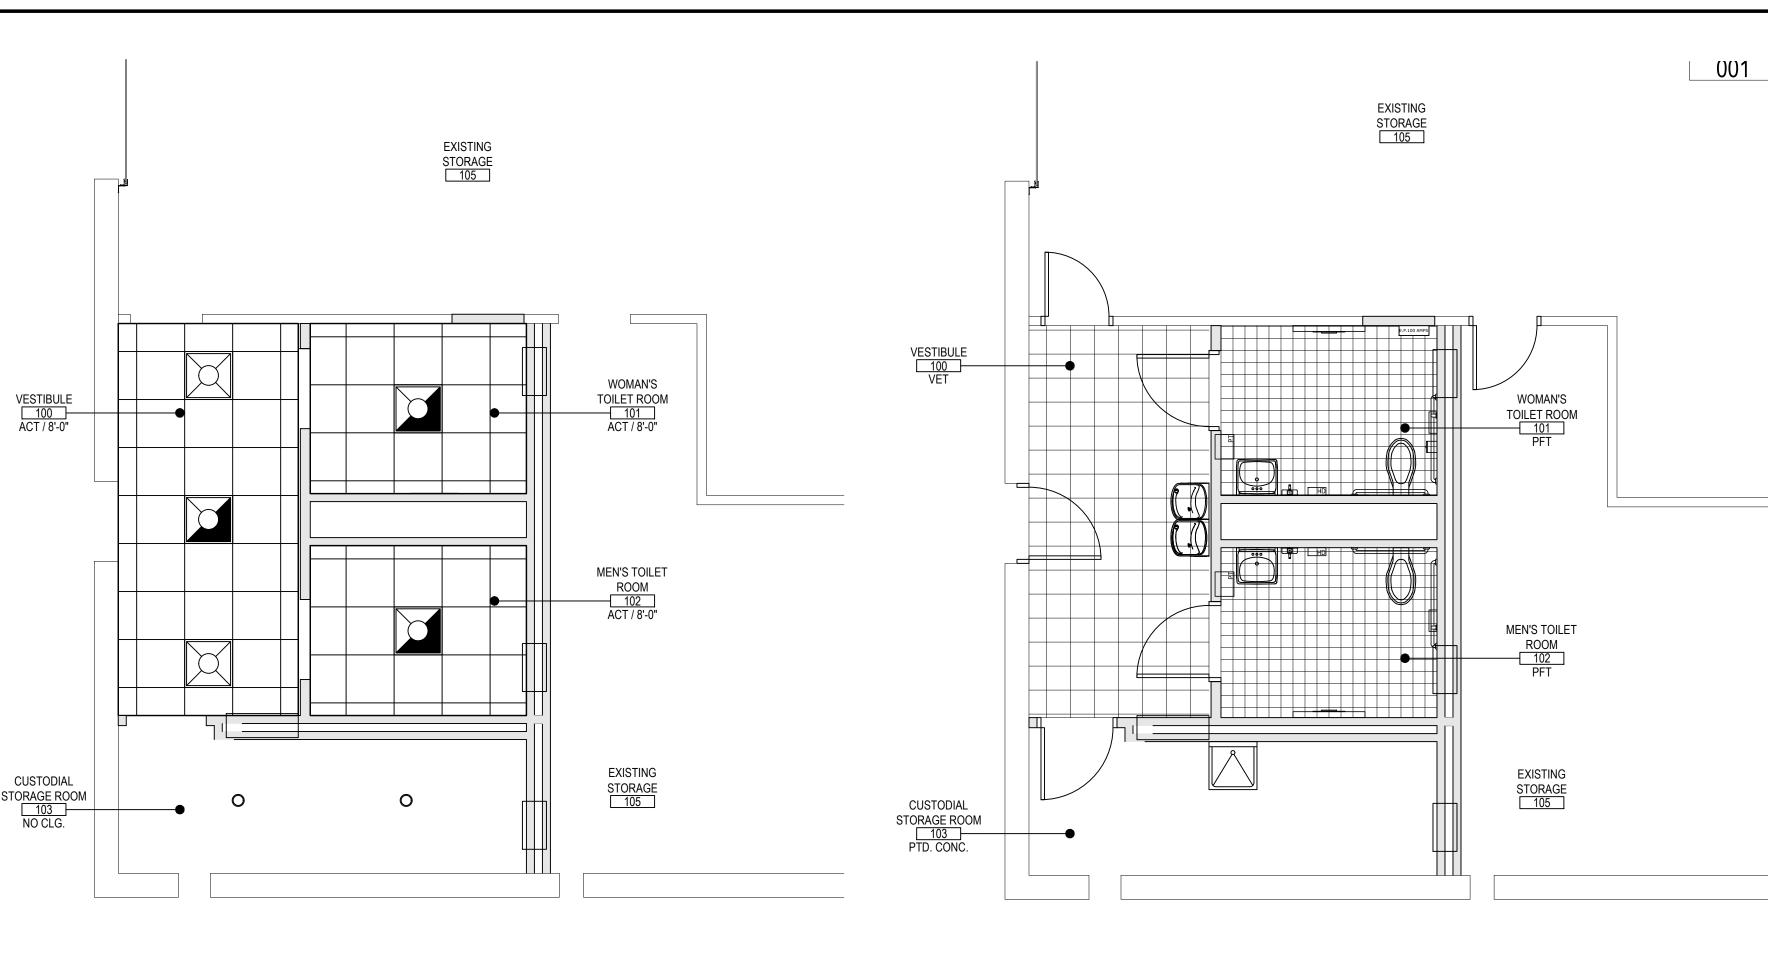
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SED No.	66-01-02-06-1-008-014
DISTRICT	BEDFORD CENTRAL SCHOOL DISTRICT
PROJECT	PHASE 2 - BOND IMPROVEMENTS
DWG TITLE	DOOR SCHEDULE and DETAILS

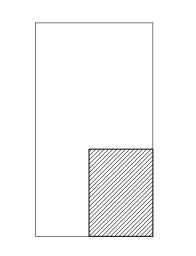
SCALE: AS NOTED APRIL 2024 BID PICK-UP: FEBRUARY 24, 2025 FILE No: 23-131C

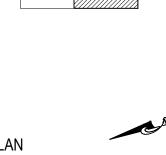A8.01

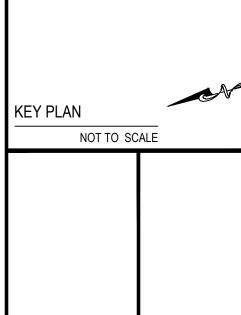

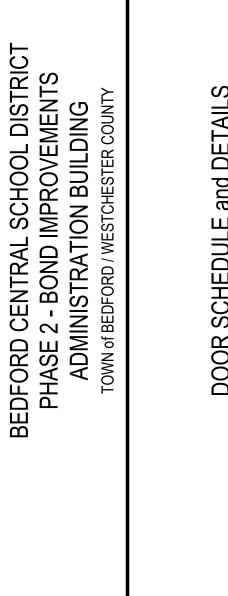BASEMENT FINISHED FLOOR PLAN

SCALE: 1/4" = 1'-0"

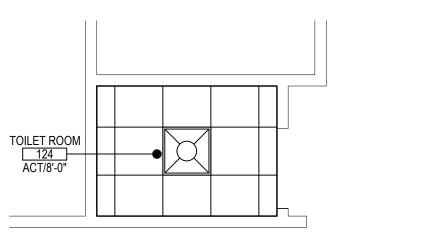


FIRST FLOOR REFLECTED CEILING PLAN

BASEMENT REFLECTED CEILING PLAN

SCALE: 1/4" = 1'-0"

SCALE: 1/4" = 1'-0"

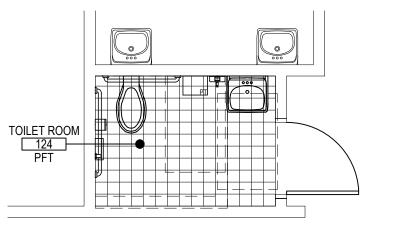

FIRST FLOOR FINISHED FLOOR PLAN

SCALE: 1/4" = 1'-0"

ABBREVIATIONS	
ACT	VET
CTILE	LVT LUXURY VINYL
PFT PORCELIAN FLOOR TILE	GYP
CMU	RUB
CTCB	RCB

.TERRAZZO / TERRAZZO BASE . VINYL COMPOSITION TILE

FINISH NOTES

ALL FINISHED TYPES (STYLE/COLOR/PATTERN) SHALL BE OFF THE STANDARD OF QUALITY INDICATED BY THE PROJECT MANUAL. FINAL STYLE / COLOR / PATTERN TO BE SELECTED BY ARCHITECT.

- 2. ALL INTERIOR AND EXTERIOR C.M.U. SURFACES SHALL BE PRIMED WITH SHERWIN WILLIAMS PRO INDUSTRIAL HEAVY DUTY BLOCK FILLER B 42 SERIES PRIOR TO FINISH PAINT APPLICATION.
- . ALL NEW BRICK WALLS ARE TO REMAIN NATURAL, CLEANED AND SEALED, IN ACCORDANCE WITH MANUFACTURER'S SPECIFICATIONS.
- CONTRACTOR SHALL PREP, PRIME AND PAINT ALL SHEET METAL PIPE ENCLOSURES (INSTALLED BY M.C.) COLOR AS SELECTED BY ARCHITECT.
- BEFORE PAINTING, CONCRETE SURFACES MUST CURE 30 DAYS, BLOCK AND PLASTER SURFACES MUST CURE FOR 30 DAYS
- 6. REFER TO REFLECTED CEILING PLANS AND FINISH FLOOR PLANS FOR ADDITIONAL INFORMATION.
- ALL INTERIOR FINISHES IN CORRIDOR SHALL BE 'CLASS A' RATED.
- 8. PATCH, REPAIR AND FINISH CEILING, WALLS, AND FLOOR AT POINTS OF DEMOLITION TO MATCH EXISTING. EXISTING FINISHES TO REMAIN.
- SHOULD ANY FINISH MATERIALS BE DISCONTINUED BY MANUFACTURER, THE CONTRACTOR MUST REPLACE WITH CLOSEST MATCH AT NO ADDITIONAL COST, AND SUBMIT TO ARCHI FOR APPROVAL PRIOR TO INSTALLATION.
- 0. AT ROOMS HAVING EXISTING FLOOR TILE TO BE REMOVED AND / OR ABATED, CONTRACTOR SHALL PROVIDE AND INSTALL FLOOR PATCH (PLANI/PATCH PLUS) BY 'MAPEI' OR ARCHI APPROVED EQUAL OVER ENTIRE EXISTING SUBSTRATE AND / OR CONCRETE SLAB TO PROVIDE A FLOOR SURFACE IN ACCORDANCE WITH MANUFACTURER'S SPECIFICATIONS AN SPECIFIED FOR INSTALLATION OF FINISH FLOORING AS SPECIFIED ON FINISH SCHEDULE.
- 1. HOLLOW METAL DOOR FRAMES, SIDE LIGHTS AND WINDOW FRAMES SHALL BE PREPPED AND PAINTED AS PER PAINTING SPECIFICATION 099000. (ALL COLORS AS SELECTED BY ARCHIT
- 12. CONTRACTOR SHALL PREP, PRIME AND PAINT SHEETROCK CEILINGS UNLESS OTHERWISE NOTED. 3. REFER TO FINISH FLOOR PLANS FOR TILE PATTERNS - THE TILE PATTERNS MAY NOT REPRESENT THE FINAL PATTERNS TO BE DESIGNED, INSTALLED AND TURNED OVER TO OWNER.
- BID SHALL BE BASED ON THE TILE MIX AND PERCENTAGES AS INDICATED IN THE PROJECT MANUAL. 4. ALL FINISHES SHALL BE PROVIDED AND INSTALLED BY GENERAL CONTRACTOR UNLESS OTHERWISE NOTED.
- 15. REFER TO REFLECTED CEILING PLANS, TOILET ROOM TILE PLANS AND FINISHED FLOOR PLANS FOR ADDITIONAL FINISH INFORMATION.
- 6. NEW TOILET AND URINAL PARTITIONS SHALL BE 1" THICK HDPE AS MANUFACTURED BY SCRANTON, ASI GLOBAL PARTITIONS, OR APPROVED EQUAL. (COLOR AND FINISH TO BE SELEI BY ARCHITECT).

GENERAL	CONTRACTO	R SHALL	PROVIDE	TERMINATION	STRIPS,	RUBBER	REDUCERS,	EDGE	GUARDS,	ADAPTERS	AND	TRANSITIONS	BETWEEN	DISSIMILAR MA	ATERIALS /	AND HEIGHT
DIFFEREN	ITIALS BOTH TO	O PROTE	CT THE FIN	IISH EDGE OR T	O PROVI	DE AN AD	A ACCESSIBL	E TRAN	ISITION.							

SYMBOLS LEGEND										
SYMBOL	DESCRIPTION									
ROOM NAME XXX CLG. HEIGHT / TYPE	ROOM TAG, CEILING TILE TYPE AND FINISH CEILING ELEVATION (A.F.F.)									
NO CLG.	OPEN TO STRUCTURE AND DECK ABOVE (PAINT)									
	SUSPENDED ACOUSTICAL CEILING TILE AND GRID									
	VINYL ENHANCED TILE									
	PORCELAIN FLOOR TILE									
D D D	PAINTED CONCRETE									
	2x2' RECESSED LED LIGHT FIXTURE MODEL NO. CRUZE ST '22CZ2-LD5-24-UNV-L835-CD1-U'									
	1' X 4' SURFACE MOUNT LIGHTING FIXTURE									

TYPICAL REFLECTED CEILING PLAN NOTES

- CEILING GRID SHALL BE ARRANGED TO BE SPACED EQUALLY IN EACH DIRECTION WITH NO TILE LESS THAN 6" UNLESS OTHERWISE REQUIRED.
- WHERE INDICATED ON PLANS.
- UNLESS OTHERWISE NOTED, ALL SOFFITS AND WINDOW POCKETS SHALL BE 5/8" TYPE 'X' GYP. BOARD OVER 18 GA. COLD FORMED FRAMING AT 16" O.C.
- ALL AREAS NOTED AS 'OPEN' AND / OR 'NO CEILING (CLG.) SHALL BE PAINTED -INCLUDING BUT NOT LIMITED TO DECK, STRUCTURE, DUCTWORK, ETC.)
- ACOUSTICAL CEILINGS SHALL HAVE A FLAME SPREAD OF 25 OR LESS COMPLYING WITH
- ACOUSTICAL CEILINGS SHALL HAVE A MINIMUM NOISE REDUCTION COEFFICIENT (NRC)

NSITION.									
SYMBOLS LEGEND									
SYMBOL	DESCRIPTION								
ROOM NAME XXX CLG. HEIGHT / TYPE	ROOM TAG, CEILING TILE TYPE AND FINISH CEILING ELEVATION (A.F.F.)								
NO CLG.	OPEN TO STRUCTURE AND DECK ABOVE (PAINT)								
	SUSPENDED ACOUSTICAL CEILING TILE AND GRID								
	VINYL ENHANCED TILE								
	PORCELAIN FLOOR TILE								
D D	PAINTED CONCRETE								
	2x2' RECESSED LED LIGHT FIXTURE MODEL NO. CRUZE ST '22CZ2-LD5-24-UNV-L835-CD1-U'								
	·								

CEILING PLANS MAY NOT INDICATE ALL MECHANICAL AND / OR ELECTRICAL CEILING MOUNTED ITEMS. REFER TO M - SERIES AND E - SERIES DRAWINGS FOR ADDITIONAL

- PROVIDE CEILING EXPANSION JOINT AT ALL NEW TO EXISTING INTERSECTIONS AND

- 'ASTM E-84'; SMOKE DEVELOPED RATING OF 50 OR LESS COMPLYING WITH PERFORMANCE REQUIREMENTS AND PHYSICAL CHARACTERISTICS OF THE SPECIFIED CEILINGS AS INDICATED IN THE REFLECTED CEILING PLAN. (ASTM E-1264)
- RATING OF 0.65.

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HEIGHT				

REV. DATE

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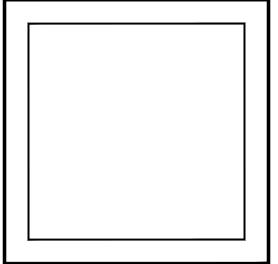
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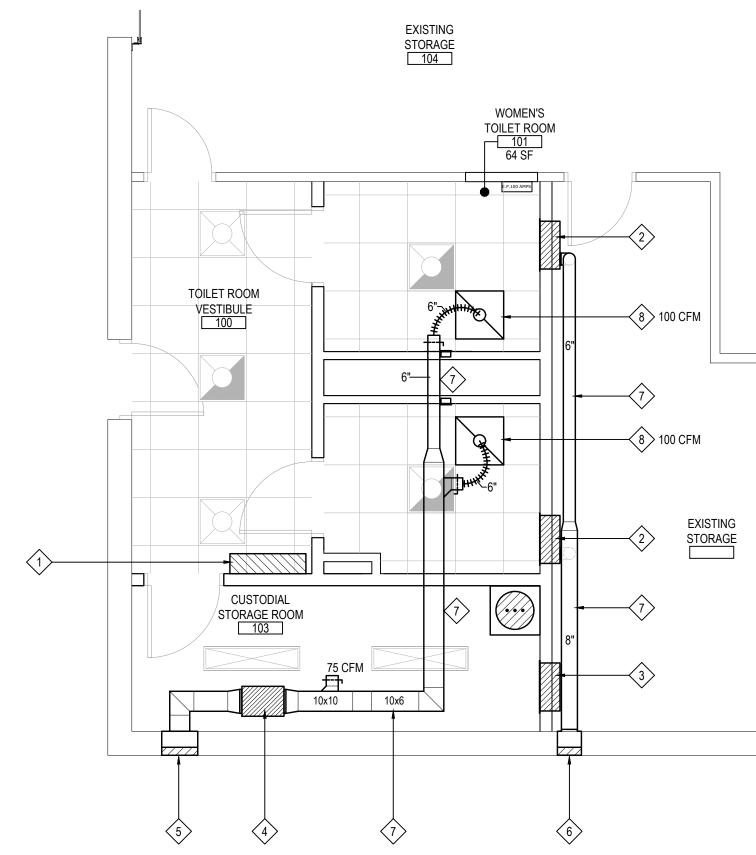


66-01-02-06-1-008-014 DISTRICT BEDFORD CENTRAL SCHOOL DISTRICT PROJECT PHASE 2 -BOND IMPROVEMENTS DWG TITLE REFLECTED CEILING PLAN and

SCALE: AS NOTED BID PICK-UP: FEBRUARY 24, 2025 FILE No: 23-131C

FINISH FLOOR PLAN

A9.01





PROPOSED TOILET ROOM PLAN - LOWER LEVEL MECHANICAL LAYOUT

SCALE: 1/4" = 1'-0"

NEW MECHANICAL CONSTRUCTION NOTES

- MC to provide & install a new electric cabinet unit heater in the vestibule at the location shown. New cabinet unit heater shall be a "Stelpro" #ACBH0381CTW, 3kW, 208v / 1 ph., fully exposed cabinet, arrangement "TF", 300 cfm. New unit to be wired by the EC. Unit shall come with a unit mounted built-in thermostat, on-off switch, unit sub base, & built in disconnect switch. Unit shall have a fully finished cabinet on all sides & back.
- MC to provide & install a new electric cabinet unit heater at the location shown. New cabinet unit heater shall be a "Stelpro" #ACBH0281CTW, 2kW, 208v / 1 ph., fully recessed cabinet, arrangement "TF", 300 cfm. New unit to be wired by the EC. Unit shall come with a unit mounted built-in thermostat, on-off switch, full recess trim ring & built in disconnect switch. Unit shall have a fully finished cabinet on the front only.
- MC to provide & install a new electric cabinet unit heater in the Storage / Custodial Room at the location shown. New cabinet unit heater shall be a "Stelpro" #ACBH0281CTW, 2kW, 208v / 1 ph., fully recessed cabinet, arrangement "TF", 300 cfm. New unit to be wired by the EC. Unit shall come with a unit mounted built-in thermostat, on-off switch, recess trim ring, & built in disconnect switch. Unit shall have a fully finished cabinet on the front only.
- MC shall provide & install a new in-line exhaust fan, mtd. +/- 7'-0" a.f.f. at the location shown. New fan shall be a "Penn Barry" #SX085S, $\frac{1}{6}$ hp, 120v, 435 cfm @ $\frac{1}{4}$ " s.p., 5.5 sones. Provide speed control for fan, mtd. in Custodial / Storage room. Provide backdraft damper. Provide a 7 day programmable timeclock to provide day / night operation of fan, mtd. in Custodial / Sto. room. Provide all supports for fan, tied into structure above. Provide kindorf or other steel rail systems as required to provide support for the fan. Use rubber in shear vibration isolators on hangers & flexible duct connections at inlet & outlet of fan.
- MC shall provide & install a new 18x12 louver & duct box through the wall where shown. Backing galvanized sheet metal box shall be 18x12 & shall extend completely through the wall. Provide bird screen for louver. Louver to be .081 t. extruded aluminum blades / jambs. Provide louver in color as selected by architect.
- MC shall provide & install a new 12x12 louver & duct box through the wall where shown. Backing galvanized sheet metal box shall be 12x12 & shall extend completely through the wall. Provide bird screen for louver. Louver to be .081 t. extruded aluminum blades / jambs. Provide louver in color as selected by architect.
- MC shall provide new ductwork as shown. New galvanized sheet steel ductwork shall be constructed per SMACNA standards. Provide all supports, duct seal, fittings, etc. as required. New ductwork for outdoor air applications must be insulated per the latest edition of the NYS Energy Conservation Code. New exhaust ductwork is not required to be insulated. Provide volume dampers for each diffuser / each point of connection to cabinet unit heaters.
- MC shall provide a new "Nailor" #4260 egg crate exhaust grille w/ 6" dia. round collar at the locations shown. Provide support for grilles from the structure above (not the ceiling grid). Balance each grille to the value(s) shown on the plan.

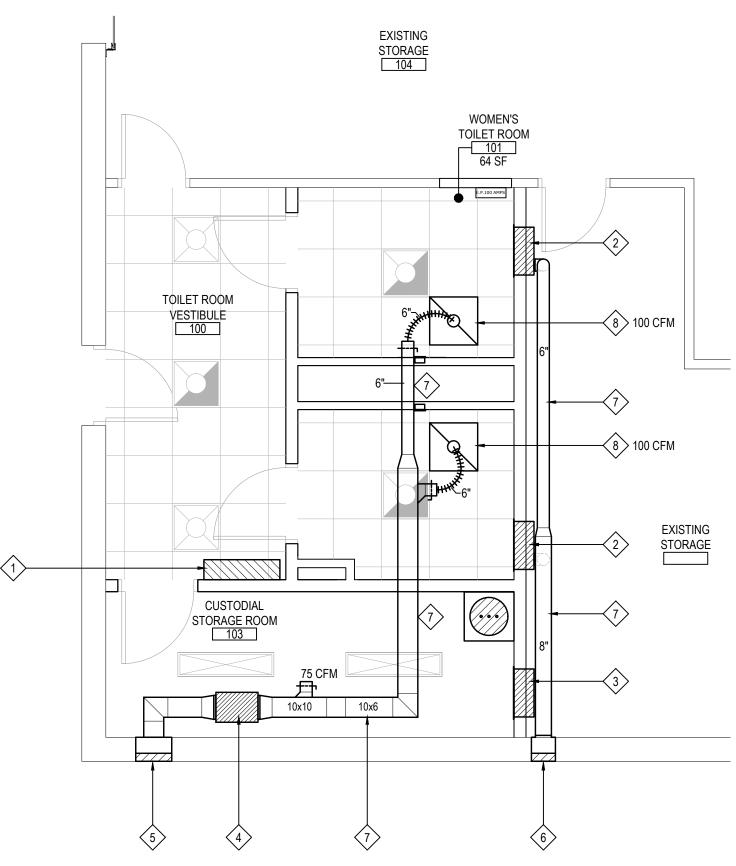

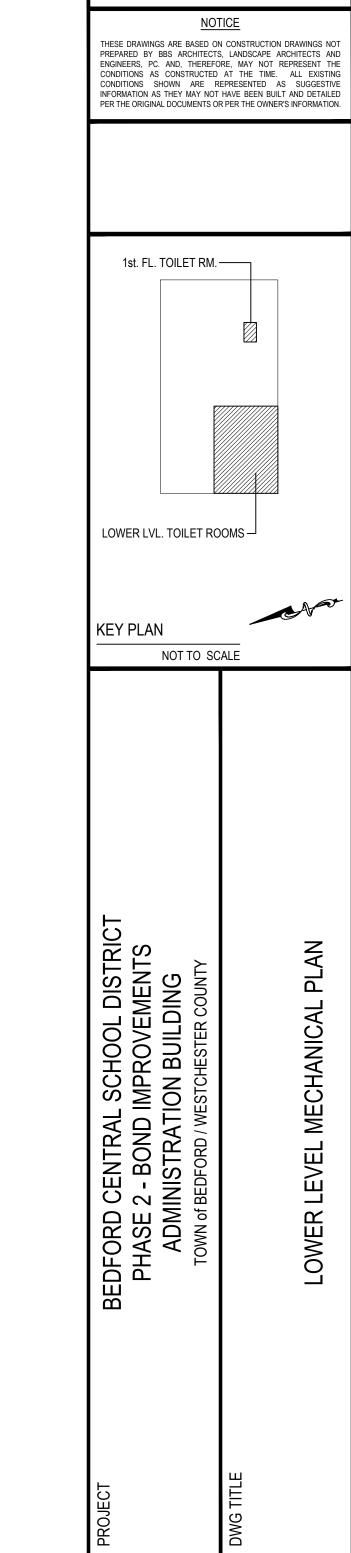


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ENGINEERS

NEW YORK 11772



LANDSCAPE ARCHITECTS

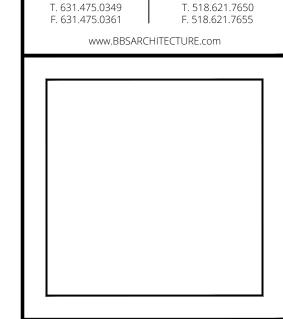
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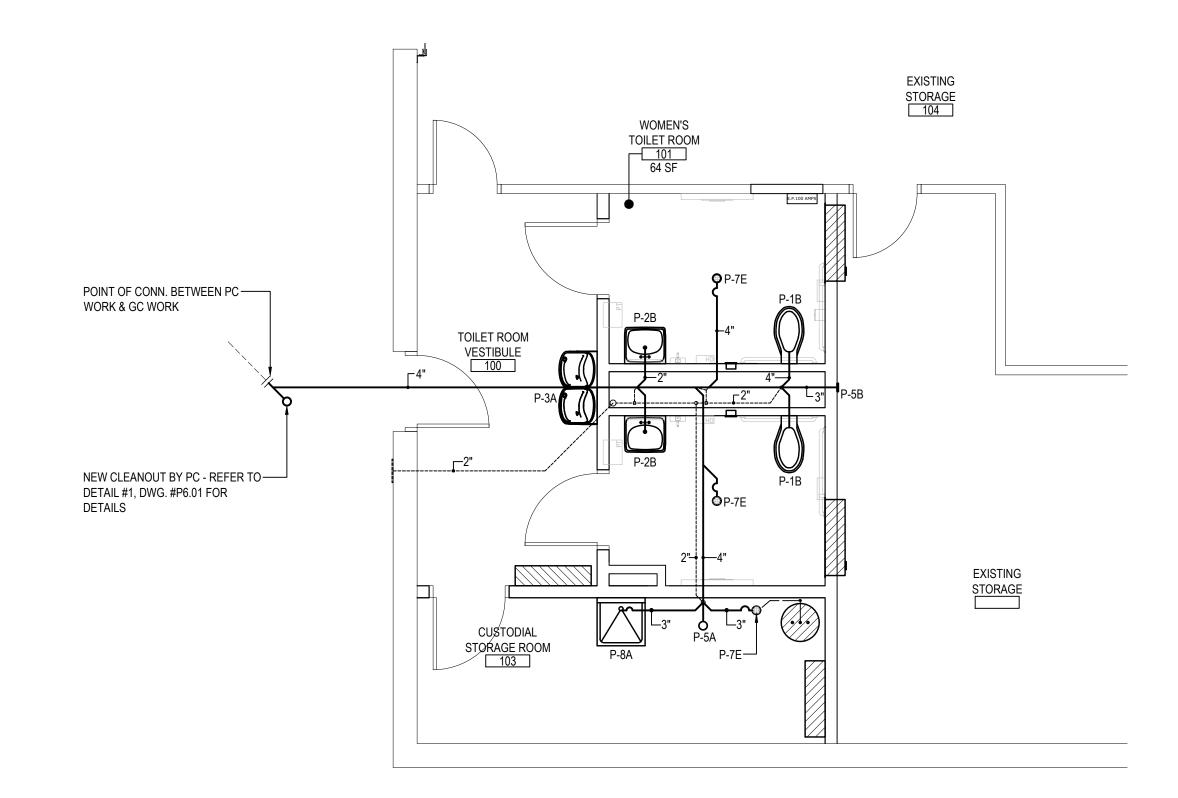
NEW YORK 12205

	SED No.	66-01-02-06-1-008-014					
	DISTRICT	BEDFORD CENTRAL SCHOOL DISTRICT					
	PROJECT	PHASE 2 - BOND IMPROVEMENTS					
	DWG TITLE	LOWER LEVEL MECHANICAL PLAN					
	SCALE:	AS NOTED					

BID PICK-UP: FEBRUARY 24, 2025

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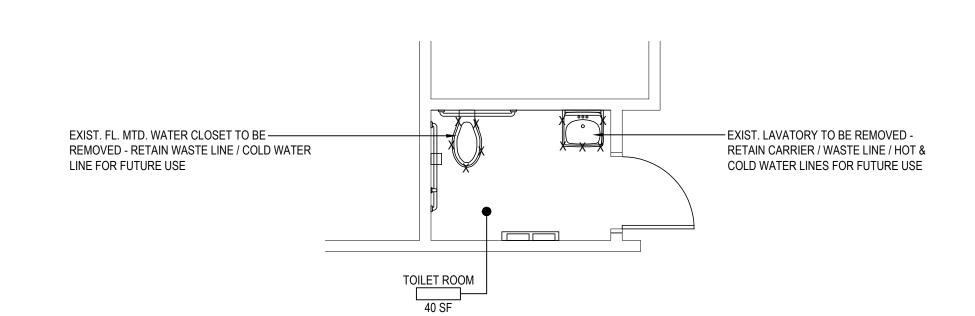


PROPOSED TOILET ROOM PLAN - LOWER LEVEL WATER PIPING LAYOUT

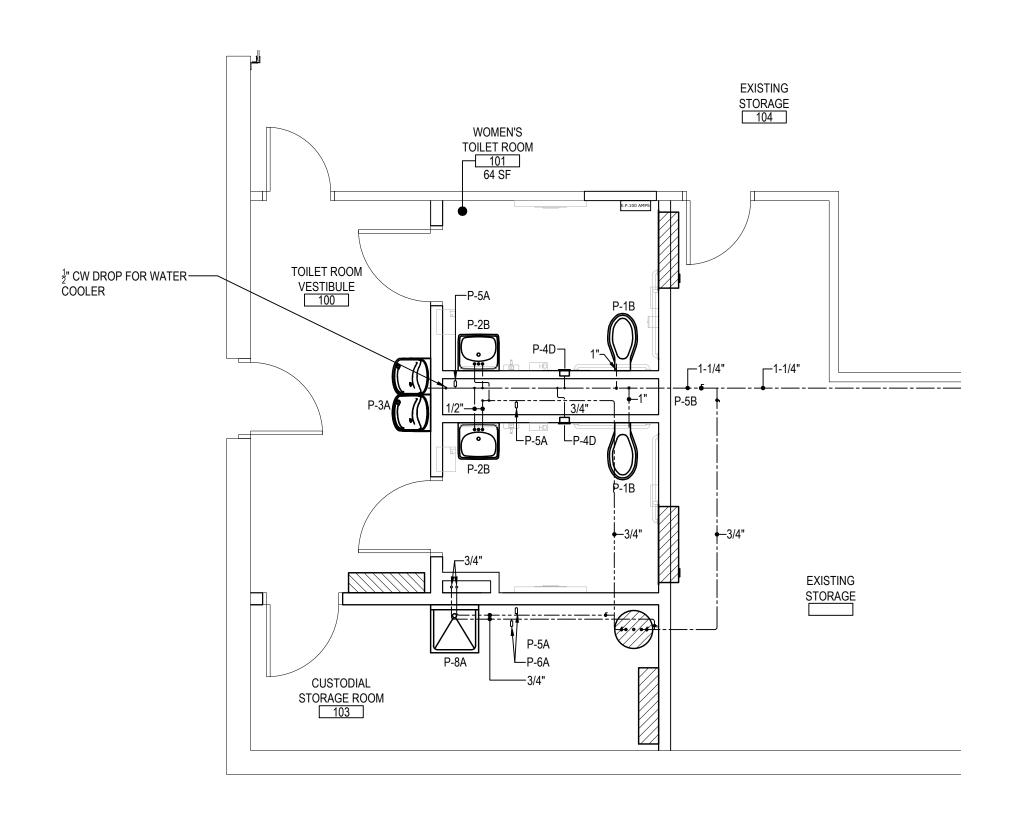SCALE: 1/4" = 1'-0"

PROPOSED TOILET ROOM PLAN - LOWER LEVEL SANITARY PIPING LAYOUT

SCALE: 1/4" = 1'-0"



NEW WATER CLOSET, INSTALLED ON EXIST. WASTE LINE
- MODIFY EXIST. PIPING AS REQ'D. TO PIPE WC / CONN.
NEW FLUSH VLV.

NEW LAV, INSTALLED ON EXIST CARRIER - PROVIDE NEW FIXTURE STOPS, SUPPLIES, P-TRAP & TAILPIECE - MODIFY EXIST. PIPING AS REQ'D. TO PIPE SINK & HAVE ALL PIPING FIT WITHIN LAV SHIELD

TOILET ROOM
40 SF

DEMOLITION PLAN (1st. FLOOR TOILET ROOM)

SCALE: 1/4" = 1'-0"

PROPOSED TOILET ROOM PLAN (1st. FLOOR TOILET ROOM)

SCALE: 1/4" = 1'-0"

NOTE: USE ADULT HEIGHT FIXTURES.

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SED No.

66-01-02-06-1-008-014

DISTRICT
BEDFORD CENTRAL
SCHOOL DISTRICT

PROJECT
PHASE 2 BOND IMPROVEMENTS

DWG TITLE
TOILET ROOM
PLANS and DETAILS

SCALE: AS NOTED


DATE: APRIL 2024

BID PICK-UP: FEBRUARY 24, 2025

FILE No: 23-131C

P2.01

FIXTURE TYPE	TAG NO.	FIXTURE	TRAP SIZE	VENT SIZE	COLD WATER	HOT WATER	TEMPERED WATER	DESCRIPTION
WATER CLOSET	P-1B	ADA ACCESSIBLE WALL MOUNTED WATER CLOSET	4"	2"	1-1⁄4"			ZURN MODEL# <u>Z5615-BWL-AM</u> , ECOVANTAGE HIGH-EFFICIENCY TOILET SYSTEM VITREOUS CHINA, 1.1 GPF OR GREATER HIGH-EFFICIENCY WALL HUNG TOILET WITH SIPHON JET FLUSHING ACTION, ZURN SHIELD CERAMIC GLAZE AND ELONGATED FRONT RIM WITH 1-1/2" TOP SPUD. ZURN MODEL# <u>ZTR6200-ONE-LL</u> , EXPOSED, QUIET PISTON-TYPE, CHROME-PLATED FLUSHOMETER VALVE WITH A POLISHED EXTERIOR. COMPLETE WITH CHLORAMINE-RESISTANT, FILTERED PISTON KIT. THE VALVE INCORPORATES A BATTERY-POWERED SOLENOID ACTUATOR, AN AUTOMATIC SENSOR WITH A MANUAL OVERRIDE PUSH BUTTON, AND A ROBUST VANDAL-RESISTANT METAL COVER. ZURN MODEL# <u>Z5956SS-EL-AM</u> , 1" HIGH, IS AN ELONGATED, EXTRA HEAVY DUTY, PREMIUM WHITE, OPEN FRONT TOILET SEAT WITH LESS COVER AND STAINLESS STEEL CHECK HINGE. PROVIDE A WALL CARRIER FOR TOILET SYSTEM. REFER TO ARCHITECTURAL DRAWINGS FOR MOUNTING HEIGHT.
VATER CLOSET	P-1D	ADA ACCESSIBLE FLOOR MOUNTED WATER CLOSET	4"	2"	1-1/4"			ZURN MODEL# <u>Z5665-BWL1-AM</u> , ECOVANTAGE HIGH-EFFICIENCY TOILET SYSTEM VITREOUS CHINA, 1.1 GPF OR GREATER, 16-3/4" HIGH WITH 1" HIGH TOILET SEAT, FLOOR MOUNTED, BOTTOM OUTLET TOILET WITH SIPHON JET FLUSHING ACTION AND ELONGATED FRONT RIM WITH 1-1/2" SPUD. ZURN MODEL# <u>ZTR6200-ONE-LL</u> EXPOSED, QUIET PISTON-TYPE, CHROME-PLATED FLUSHOMETER VALVE WITH A POLISHED EXTERIOR. COMPLETE WITH CHLORAMINE-RESISTANT, FILTERED PISTON KIT. THE VALVE INCORPORATES A BATTERY-POWERED SOLENOID ACTUATOR, AN AUTOMATIC SENSOR WITH A MANUAL OVERRIDE PUSH BUTTON, AND A ROBUST VANDAL-RESISTANT METAL COVER. BATTERY POWERED SOLENOID ACTUATOR, AUTOMATIC SENSOR WITH MANUAL OVERRIDE PUSH BUTTON, AND ROBUST VANDAL RESISTANT METAL COVER. BATTERY POWERED SOLENOID WHITE, OPEN FRONT TOILET SEAT, LESS COVER, WITH STAINLESS STEEL CHECK HINGE.
LAVATORY	P-2B	ADA ACCESSIBLE TOILET ROOM LAVATORY	1-½"	1-½"	½ "	1/2"		ZURN MODEL# <u>Z5341</u> WALL-MOUNTED CONCEALED CARRIER ARM LAVATORY – SINGLE HOLE 20" X 18" VITREOUS CHINA WALL-MOUNTED LAVATORY WITH SINGLE FAUCET HOLE. PROVIDED WITH HANGER PLATE AND HOLES FOR CONCEALED ARM CARRIER SYSTEMS, FRONT OVERFLOW. ZURN MODEL# <u>Z6950-XL-S-F</u> ZURN HYDRO-X POWER SENSOR FAUCETS. CHROME-PLATED CAST BRASS SENSOR FAUCET WITH INFRARED PROXIMITY SENSOR. A STANDARD 0.5 GPM FLOW CONTROL AND MOUNTING HARDWARE. ZURN MODEL# <u>P6900-TMV-1-XL</u> THERMOSTATIC LEAD FREE VALVE MEETS ASSE 1070. ZURN MODEL# <u>Z8746-PC</u> , CHROME PLATED CAST BRASS OPEN GRID DRAIN STRAINER, AND CHROME PLATED CAST BRASS ELBOW. FURNISHED WITH 1-1/4 17 GAUGE CHROME PLATED TUBULAR BRASS OFFSET TAILPIECE FOI SINK DEPTH TO 2-1/2. ZURN MODEL# <u>Z8700-PC TO Z8708-PC</u> . CHROME-PLATED CAST BRASS (COPPER ALLOY) BODY P-TRAP WITH CLEANOUT, TUBULAR BRASS WALL BEND AS SPECIFIED, DIE-CAST NUTS, AND SHALLOW ESCUTCHEON WITH COMPRESSION INLET. ZURN MODEL# <u>Z8800-XL-LR-PC TO Z8809-XL-LR-PC TO Z8</u>
VATER COOLER	P-3A	BI-LEVEL WATER COOLER WITH BOTTLE FILL STATION	2"	1-½"	1/2"			FURNISH AND INSTALL ELKAY MODEL# <u>LZSTL8WSLP</u> FILTERED BI-LEVEL SELF-CONTAINED WALL HUNG ELECTRIC REFRIGERATED WATER COOLER AT 8-GPH CHILLING CAPACITY AT 50 DEG. F WATER, LIGHT GRAY GRANITE FINISH, LEAD FREE, RATED 370-WATTS, 115-VOLTS, SINGLE PHASE, WITH EASY TOUCH FRONT AND SIDE PUSHBAR CONTROLS, FLEXI-GUARD SAFETY BUBBLER AND MODEL EZH2O BOTTLE FILLER STATION LOCATED ON THE LEFT SIDE (LOW-HI) ADA COOLER. WEIGHT 98-LBS. INSTALL ADA COOLER PER GUIDELINES 32" FROM FLOOR TO ORIFICE HEIGHT. FURNISH WITH MODEL# MLP200 BI-LEVEL IN WALL CARRIER.
WALL HYDRANT	P-4D	WALL HYDRANT (INTERIOR)			3/4"			ZURN MODEL# <u>Z1335CI-CL-34FS</u> ENCASED, ECOLOTROLTM, LEAD-FREE, ANTI-SIPHON, MODERATE CLIMATE / INTERIOR WALL HYDRANT FOR FLUSH INSTALLATION. HYDRANT FEATURES ALL-BRONZE INTERIOR COMPONENTS WITH 1/2 TURN LONG-LIFE CERAMIC DISC CARTRIDGE, 3/4" FEMALE SOLDER INLET CONNECTION, AND 3/4" MALE HOSE CONNECTION. HYDRANT FURNISHED WITH TYPE 304 STAINLESS STEEL FLANGED HOUSING WITH LOCKING HINGED COVER STAMPED "WATER" AND INCLUDES OPERATING KEY.
CLEANOUT	P-5A	FLOOR CLEAN-OUT						ZURN MODEL# ZN1400-BZ1-VP CLEAN-OUT, DURA-COATED CAST IRON BODY WITH BOTTOM OUTLET, WITH GAS AND WATER TIGHT THREADED ABS TAPERED PLUG, POLISHED NICKEL BRONZE TOP AND VANDAL-PROOF SCREWS. (CLEANOUT SIZE TO MATCH PIPE SIZE)
CLEANOUT	P-5B	WALL CLEAN-OUT						ZURN MODEL# <u>Z1468-VP</u> WALL CLEAN-OUT, ROUND STAINLESS STEEL WALL ACCESS COVER COMPLETE WITH SECURING SCREW AND BRONZE RAISED HEX HEAD PLUG. (CLEANOUT SIZE TO MATCH PIPE SIZE)
ARRESTOR	P-6A	WATER HAMMER ARRESTOR			3/4"			OATEY QUIET PIPES HAMMER ARRESTORS SIZE A-F. ARRESTOR CHAMBERS SHAL BE SPECIFICALLY SIZED TO ACCOMMODATE AND DISSIPATE ENERGY GENERATED BY SUCH VALVES AND FAUCETS. ARRESTORS SHALL BE EFFECTIVE WHEN INSTALLED ANY ANGLE. ARRESTOR SHALL BE LEAD-FREE, MADE OF COPPER AND INCLUDE POLYPROPYLENE PISTON WITH TWO NBR O-RINGS. ARRESTORS SHALL BE ANSI/ASSE1010-200 CERTIFIED AND APPROVED FOR INSTALLATION WITH NO ACCESS PANEL REQUIRED. ARRESTOR BODY:COPPER(TYPE K). PISTION:POLYPROPYLENE WITH TWO NBR O-RINGS.PISTON LUBRICATION: DOW CORNING MOLYKOTE 111. FITTINGS AVAILABLE: MALES SWEAT/PRESS,FEMALE CPVC.MIP,F1807 PEX & F1960 PEX(NO LEAD BRASS C46400). TEMPERATURE RANGE:33°F-180°F.MAX WORKING PRESSURE: 0-400 PSI. ANSI/ASSE1010-2004CUPC.PDI WH-201-2017.
FLOOR DRAIN	P-7E	LOW PROFILE ADJUSTABLE FLOOR DRAIN	4"	2"				ZURN MODEL# <u>FD-2322-ST</u> LOW PROFILE ADJUSTABLE FLOOR DRAIN, RECOMMENDED FOR FINISHED FLOOR AREAS WHERE IS NOT REQUIRED. THE DRAIN IS DESIGNED FOR FOOT TRAFFIC AND LIGHT CART APPLICATIONS. COMPLETE WITH CAST IRON BODY AND ADJUSTABLE NICKEL BRONZE STRAINER ASSEMBLY. 1/2" P-TRAP PRIMER CONNECTION WITH PLUG. OPTIONS CHROME PLATED, POLISHED BRASS, 6" DIAMETER NICKEL HEAD ASSY, VANDAL PROOF. FURNISH AND INSTALL WITH J R. SMITH MODEL# <u>2692-04</u> QUAD CLOSE TRAP SEAL.
SERVICE SINK	P-8A	FLOOR MOUNTED SERVICE SINK	3"	2"	1/2"	1/2"		ZURN MODEL# Z1996-36 MOP SERVICE BASIN 24"X36"X10", MOLDED HIGH DENSITY COMPOSITE BASIN WITH AN INTERGRALLY MOLDED, SELF-DRAINING MOP SHELF, PVC DRAIN BODY, STAINLESS STEEL STRAINER & 3" GASKETED OUTLET CONNECTION. CERTIFICATIONS: MEETS ANSI Z124, CSA LISTED, AND IAPMO LIST UNDER FILE#3561. ZURN MODEL# Z843M6-XL POLISHED CHROME-PLATED CAST BRASS 8" SINK FAUCET, LEAD FREE W/ QUARTER TURN CERAMIC DISC CARTRIDGES, 3/8" SHORT SWIVEL INLETS PROVIDING ADJUSTABLE CENTERS FROM 7-1/4" TO 8-3/4", INTEGRAL SERVICE STOPS & A 6" CENTERLINE CAST BRASS SPOUT W/ CHEMICAL RESISTANT VACUUM BREAKER, 3/4" HOSE THREADED OUTLET, PAIL HOOK AND ADJUSTABLE WALL BRACE. UNIT IS FURNISHED W/ 6" VANDAL-RESISTANT COLOR-CODED METAL WRIST BLADE HANDLES.

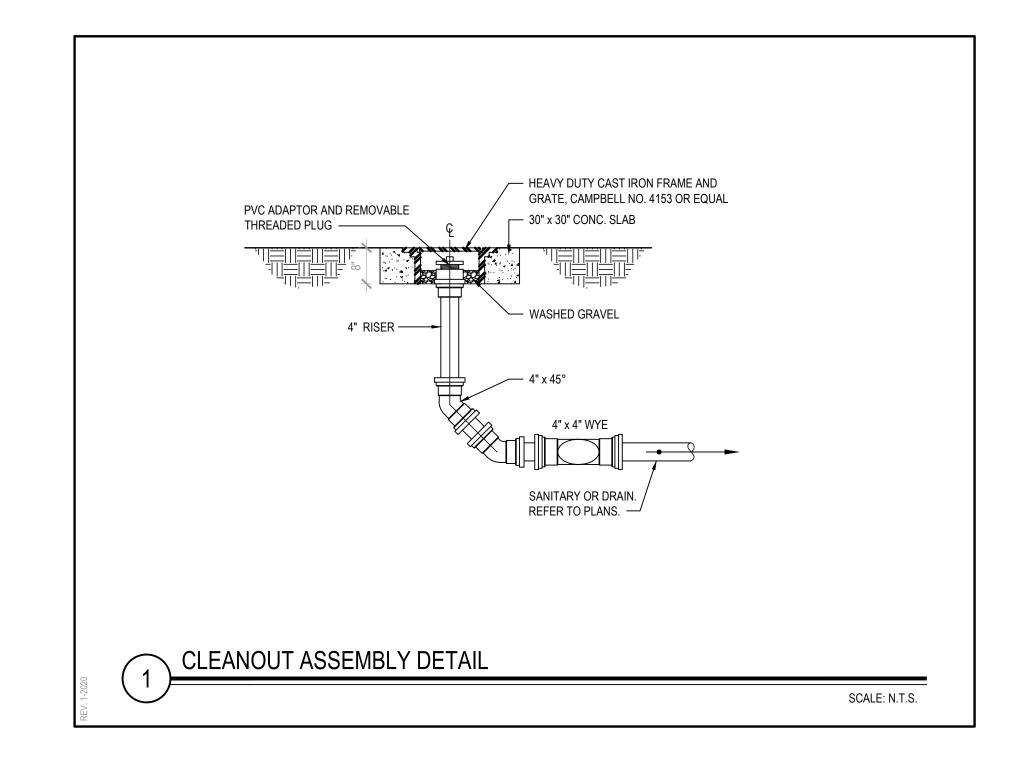

THESE DRAWINGS ARE BASED ON PREPARED BY BBS ARCHITECTS ENGINEERS, PC. AND, THEREFO CONDITIONS AS CONSTRUCTED CONDITIONS SHOWN ARE RI INFORMATION AS THEY MAY NOT PER THE ORIGINAL DOCUMENTS OF	I CONSTRUCTION DRAWINGS NO: I, LANDSCAPE ARCHITECTS AND IE, MAY NOT REPRESENT THE AT THE TIME. ALL EXISTING EPRESENTED AS SUGGESTIVE HAVE BEEN BUILT AND DETAILED
KEY PLAN NOT TO SC	ALE
BEDFORD CENTRAL SCHOOL DISTRICT PHASE 2 - BOND IMPROVEMENTS ADMINISTRATION BUILDING TOWN of BEDFORD / WESTCHESTER COUNTY	PLUMBING DEMOLITION / NEW PLUMBING WORK
	MWG TITLE
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ARCHITECTS LANDSCAPE ENGINEERS 244 EAST MAIN STREET PATCHOGUE NEW YORK 11772 T. 631.475.0349 F. 631.475.0361 www.bbsarch	100 GREAT OAKS BLVD. SUITE 115, ALBANY NEW YORK 12203 T. 518.621.7650 F. 518.621.7655
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DISTRICT BEDFORD CENTRAL SCHOOL DISTRICT

PROJECT PHASE 2 - BOND IMPROVEMENTS

DWG TITLE PLUMBING DEMOLITION & NEW WORK

P6.01

SCALE: AS NOTED

DATE: APRIL 2024

BID PICK-UP: FEBRUARY 24, 2025

FILE No: 23-131C

REV. DATE

ELECTRICAL CONSTRUCTION NOTES:

- ALL WORK SHALL BE DONE IN ACCORDANCE WITH THE LATEST EDITIONS OF THE NEC. APPLICABLE LOCAL CODES. STATE CODES. SCHOOL WORKING RULES AND SCHEDULE DIRECTIVES, AND THE ENGINEER'S SPECIFICATIONS.
- THE VOLTAGE CHARACTERISTIC OF EXISTING BUILDING IS 208Y/120V, 3-PASE, 4-WIRE. THE VOLTAGE CHARACTERISTIC OF THE PROPOSED ADDITION SHALL BE 480/277V, 3-PHASE 4-WIRE WITH 208/120V DERIVED FROM STEP DOWN TRANSFORMERS. , ALL
- EQUIPMENT SHALL BE COMPATIBLE WITH THESE CHARACTERISTICS. THE DRAWINGS SHOW SCHEMATICALLY, THE APPROXIMATE LOCATION OF ALL EQUIPMENT, CONDUITS, DEVICES, ETC. THE EXACT LOCATION OF WHICH SHALL BE SUBJECT TO APPROVAL BY THE ARCHITECT/OWNER WHO RESERVES THE RIGHT TO MAKE PRIOR TO INSTALLATION, ANY REASONABLE CHANGES IN LOCATION INDICATED WITHOUT EXTRA COST TO THE OWNER. CONTRACTOR SHALL VERIFY ALL INDICATED OR APPROXIMATED DIMENSIONS DRAWN OR DENOTED.
- ELECTRICAL CONTRACTOR SHALL EXAMINE THE SITE TO VERIFY WORK TO BE PERFORMED AS SHOWN ON DRAWINGS AND SPECIFICATIONS BEFORE SUBMITTING HIS BID. ANY DISCREPANCY BETWEEN DRAWINGS/SPECIFICATIONS AND ACTUAL FIELD CONDITIONS SHALL BE BROUGHT TO ARCHITECT/ENGINEERS ATTENTION BEFORE BID SUBMITTAL.
- ELECTRICAL CONTRACTOR SHALL PROVIDE ALL LABOR SERVICE MATERIALS. EQUIPMENT, AND RELATED ITEMS TO COMPLETE THE WORK OF THIS DIVISION, AS REQUIRED BY THE NATIONAL ELECTRIC CODE, AND ALL STATE AND LOCAL AUTHORITIES HAVING
- ELECTRICAL CONTRACTOR SHALL PROVIDE ALL ELECTRICAL HARDWARE SHOWN ON THESE DRAWINGS AND RELATED DETAIL MATERIALS NOT SPECIFICALLY SHOWN OR SPECIFIED.
- ELECTRICAL CONTRACTOR SHALL PAY ANY FEES APPLICABLE TO ELECTRICAL WORK, SUCH AS, BUT NOT LIMITED TO, THE POWER COMPANY, TELEPHONE COMPANY, CATV, CERTIFIED ELECTRICAL INSPECTORS, ALARM AND FIRE PROTECTION COMPANIES. THE ELECTRICAL CONTRACTOR SHALL REFER TO ALL OTHER DRAWINGS IN BID PACKAGE AND PERFORM THE WORK (INCLUDE IN HIS
- BID) INDICATED AS ELECTRICAL CONTRACTOR (E.C.) WORK. ALL WORK SHALL BE IN ACCORDANCE WITH MANUFACTURER'S RECOMMENDATIONS AND DIRECTIVES OF THE SCHOOL DISTRICT
- BUILDINGS AND GROUNDS DEPARTMENT ALL WORK SHALL BE PERFORMED BY A LICENSED ELECTRICAL CONTRACTOR WHO SHALL OBTAIN AN INSPECTION CERTIFICATE AND
- PAY ASSOCIATED FEE. SUBMIT A PHOTOCOPY OF THIS CERTIFICATE TO THE ENGINEER WITH FINAL PAYMENT APPLICATION. ELECTRICAL CONTRACTOR SHALL GUARANTEE ALL MATERIALS AND THEIR INSTALLATION TO BE FREE OF DEFECTS FOR A PERIOD AS DEFINED IN SECTION 1700 OF THE PROJECT MANUAL.
- A COMPLETE SYSTEM OF WIRING, WITH ALL FEEDERS, MAINS, AND BRANCHES AS SHOWN ON THE DRAWINGS, SHALL BE FURNISHED AND INSTALLED FROM THE MAIN DISTRIBUTION BOARD TO THE PANELS OUTLETS, MOTORS, AND APPURTENANCES. PROVIDE IDENTIFICATION FOR ALL PANEL AND MOTOR FEEDER CABLES IN PULL BOXES AND AT TERMINATIONS. ANY CONDUCTOR VOLTAGES HIGHER THAN 240 VOLTS SHALL BE MARKED ON DEVICES AND JUNCTION BOXES.
- FURNISH AND INSTALL ALL WIRING OF ANY VOLTAGE OR PURPOSE AS SHOWN ON THE DRAWINGS. 15. ALL BRANCH CIRCUITS SHALL HAVE INDIVIDUAL NEUTRALS. SHARING COMMON NEUTRALS AMONG BUNDLED CIRCUITS IS
- SPECIFICALLY DISALLOWED UNLESS OTHERWISE NOTED. 16. PULL/JUNCTION BOXES SHALL BE PROVIDED WHERE INDICATED OR AS OTHERWISE REQUIRED TO FACILITATE THE PROPER
- INSTALLATION OF WIRES AND CABLES. CONDUITS MAY BE INCREASED IN SIZE FOR CONSTRUCTION CONVENIENCE. FURNISH AND INSTALL ALL DISCONNECT DEVICES AND SAFETY SWITCHES AS SHOWN ON THE DRAWINGS AND/OR AS REQUIRED TO
- CONFORM WITH REQUIREMENTS 18. FURNISH AND INSTALL ALL INDICATED LIGHTING FIXTURES AND MOUNTING HARDWARE AS REQUIRED FOR A COMPLETE INSTALLATION.
- 19. ELECTRICAL CONTRACTOR SHALL PROVIDE TO SCHOOL 5 PERCENT SPARE LAMPS (MINIMUM QUANTITY 1) OF EACH TYPE SPECIFIED PROVIDE ALL WIRING, PANEL BOARDS, SWITCHES, FUSES, EQUIPMENT, AND ALL INCIDENTAL MATERIALS REQUIRED TO SUPPLY
- TEMPORARY AND PERMANENT ELECTRICAL NEEDS FOR THE WORK INVOLVED, ALL IN ACCORDANCE WITH OSHA, LOCAL, STATE AND UNDERWRITERS REQUIREMENTS ALL WIRING TO BE 1#12+1#12(N)+1#12(G)-3/4"C., OR STEEL JACKETED MC CABLE (WHERE CODE PERMITTED), UNLESS OTHERWISE SPECIFIED ON DRAWINGS. RUN BRANCH CIRCUITS IN DROPPED CEILINGS, VOIDS, & CHASES. CONDUITS MAY BE SURFACE MOUNTED IN MECHANICAL SPACES UNLESS OTHERWISE NOTED. CONDUITS IN PUBLIC AREAS SHALL BE CONCEALED IN HUNG CEILINGS,
- EMBEDDED IN SLAB OR MASONRY WALLS, EXCEPT WHERE SURFACE MOUNTED RACEWAY IS SPECIFIED. ALUMINUM JACKETED MC CABLE IS NOT ACCEPTABLE. ALL CONNECTIONS AND/OR SPLICES SHALL BE MADE ONLY IN ACCESSIBLE JUNCTION BOXES.
- ALL COUPLINGS AND CONNECTORS FOR USE WITH EMT SHALL BE COMPRESSION TYPE. SET SCREW TYPE OR INDENT TYPE FITTINGS WILL NOT BE ACCEPTED. ALL CONNECTIONS TO CONDUIT RUN UNDERGROUND SHALL BE MADE WATERTIGHT. ALL METALLIC CONDUIT INSTALLED IN EARTH
- FILL, AS WELL AS UNDERGROUND, SHALL BE PAINTED WITH (2) COATS OF ASPHALTUM PAINT OR EQUAL. WIRING INSTALLED IN CEILINGS SHALL BE HUNG INDEPENDENT OF CEILING SYSTEM AND SECURELY TIED TO BUILDING STEEL. ALL LOW VOLTAGE (FIRE ALARM, PA INTERCOM, PHONE, DATA, ETC.) WIRING INSTALLED IN OPEN AREAS SHALL BE IN METALLIC RACEWAY IN MECHANICAL AREAS, GYMNASIUMS, ART ROOMS, STOREROOMS, ETC., AND IN SURFACE MOUNTED RACEWAY IN PUBLIC AREAS. LOW VOLTAGE WIRE INSTALLED IN DROPPED CEILINGS SHALL BE BUNDLED TOGETHER AND SUPPORTED BY BUILDING STEEL. LOW VOLTAGE WIRE SHALL NOT BE SUPPORTED WITH BRANCH CIRCUITS OR FEEDER CIRCUITS AND SHALL NOT BE SUPPORTED BY
- CONDUIT, PIPES, ETC., LOW VOLTAGE WIRING NOT INSTALLED IN CONDUITS, SHALL BE PLENUM RATED. CONDUITS SHALL BE SECURED IN PLACE AND PROTECTED WHERE NECESSARY TO PREVENT DAMAGE DURING CONSTRUCTION.
- FURNISH AND INSTALL ALL HARDWARE TO PROPERLY SUPPORT ALL CONDUITS NOT INSTALLED IN CONCRETE SLABS OR UNDERGROUND. ALL CONDUITS OR MC CABLE SHALL BE EQUIPPED WITH AN INSULATING/CHAFE GUARD GROMMET AT WIRE EXIT/ENTRANCE. MC
- CABLE SHALL USE MC STYLE BUSHINGS. BX OR OTHER BUSHINGS ARE SPECIFICALLY DISALLOWED. WHERE AN EXISTING CONDUIT OR CABLE IS REQUIRED TO BE REMOVED BUT SERVES AND EXISTING PIECE OF EQUIPMENT WHICH IS
- TO REMAIN OPERABLE, THE ELECTRICAL CONTRACTOR SHALL REROUTE SAID CONDUIT OR CABLE OR PROVIDE A NEW SOURCE OF POWER (APPROVED BY ENGINEERING) TO THIS EQUIPMENT AS A PART OF THIS CONTRACT. ALL PANELS, SWITCHES, DISCONNECT STARTERS, OR OTHER ELECTRIC SYSTEM CONTROLS SHALL BE STENCILED WITH THEIR
- APPROPRIATE DESIGNATION/FUNCTION. ALL CIRCUIT BREAKERS SHALL BE IDENTIFIED BY A PANEL SCHEDULE OR STENCIL ADJACENT ALL CIRCUIT BREAKERS POSITIONS IN ALL PANELS ARE SHOWN FOR ESTIMATE PURPOSES ONLY. EC IS RESPONSIBLE FOR LOAD
- ALL DEVICES SHALL BE FASTENED IN PLACE SECURELY. GRID MOUNTING LIGHTING FIXTURES SHALL BE SECURED TO GRID WITH
- CLIPS LISTED FOR THE PURPOSE OR SUSPENDED FROM STRUCTURE PER NEC.
- WORK WHICH MUST BE DONE IN OCCUPIED AREAS SHALL BE DONE AT SUCH TIMES AS INDICATED IN THE PHASING OF CONSTRUCTION AND AS APPROVED BY THE SCHOOL.
- WHERE THE ELECTRICAL CONTRACTOR IS INSTRUCTED TO PROVIDE, INSTALL AND WIRE CIRCUIT BREAKER(S) TO AN EXISTING PANEL AND THAT PANEL DOES NOT HAVE THE ROOM TO INSTALL REQUIRED CIRCUIT BREAKERS, THE ELECTRICAL CONTRACTOR SHALL REMOVE (3) ADJACENT 1P CIRCUIT BREAKERS AND PROVIDE A 3P, 60A BREAKER IN THEIR PLACE FOR SUB FEED TO A SURFACE MOUNTED 100A,3~,4W,24 POLE SUB PANEL AND ESTABLISH OVERFLOW CIRCUITS IN NEW SUB PANEL, EACH WITH REQUIRED CIRCUIT BREAKERS. PROVIDE (3) 1P, AMPERAGE AS BEFORE CIRCUIT BREAKERS FOR DISCONNECTED CIRCUITS IN MAIN PANEL AND
- RECONNECT THEM IN SUB PANEL. SUB PANEL FEED TO BE 3#6+1#6(N)+1#10(G)-1"C. SELECTED RECEPTACLES AS SHOWN ON DRAWINGS MAY BE GFI PROTECTED BY CONNECTING TO GFCI RECEPTACLE FIRST IN CIRCUIT. ALL RECEPTACLES THAT ARE PROTECTED FROM AN UPSTREAM GFCI UNIT SHALL BE VISABLY LABELED AS SUCH. GFCI RECEPTACLE SHALL BE SPEC GRADE AND RATED 20A, WITH OPERATING NOTIFICATION INDICATING LIGHT.
- ALL DEVICES ADDRESSED BY ADA REGULATIONS SHALL BE INSTALLED AT ADA COMPLIANT HEIGHT AND LOCATIONS. ALL NEW LIGHTING OR EXISTING LIGHTING HAVING SWITCHING REARRANGEMENT SHALL BE EQUIPPED WITH CODE COMPLIANT ENERGY CONSERVATION CONTROLS. SUCH CONTROL SHALL BE SUBMITTED TO THE ENGINEER FOR APPROVAL PRIOR TO
- REMOVAL OF ELECTRICAL ITEMS INCLUDES THEIR DISPOSAL. THE EXCEPTION WILL BE TO TURN OVER TO THE OWNER ITEMS, IF ANY, THEY SPECIFY TO BE RETAINED IN THEIR INVENTORY. PCB OR ASBESTOS BEARING MATERIAL SHALL BE DISPOSED OF IN ACCORDANCE WITH LAWS AND REGULATIONS.
- 40. EC SHALL PROVIDE & WIRE WEATHERPROOF GFCI RECEPTACLES ON ALL APPLICABLE ROOFTOP UNITS AS PART OF HIS BID. SEE MECHANICAL EQUIPMENT SCHEDULES FOR UNITS WITH SERVICE RECEPTACLES FACTORY INSTALLED.
- UNLESS OTHERWISE NOTED, STARTERS AND DISCONNECTS FOR MECHANICAL EQUIPMENT SHALL BE FURNISHED BY THE MECHANICAL CONTRACTOR.. COORDINATE WITH THE MECHANICAL CONTRACTOR FOR ALL POWERED MECHANICAL EQUIPMENT. THE ELECTRICAL CONTRACTOR IS RESPONSIBLE TO INSTALL ALL MOTOR STARTERS AND ASSOCIATED POWER WIRING FROM SOURCE TO UNIT VIA STARTERS AND DISCONNECTS. THE LOCATIONS OF MOTOR STARTERS SHALL BE DETERMINED BY THE MECHANICAL CONTRACTOR IN THE FIELD AND SUBMITTED TO THE ENGINEER FOR APPROVAL UNLESS IT IS SPECIFIED ON THE DRAWINGS. THE ELECTRICAL CONTRACTOR SHALL REFER TO THE MECHANICAL DRAWINGS, EQUIPMENT SCHEDULES & NOTES AND INCLUDE IN HIS BID PRICE ALL ELECTRICAL WORK ASSOCIATED WITH THEIR INSTALLATION, .AND THE REMOVAL OF ANY STARTERS/DISCONNECTS NO

DEMOLITION NOTES:

- 1. THE ITEMS SPECIFICALLY SHOWN ON DEMOLITION DRAWING/S ARE TO BE ADDRESSED BY THE ELECTRICAL CONTRACTOR. THE ITEMS ARE TO BE TREATED AS NOTED AND RANGE FROM DIRECT REMOVAL AND DISPOSAL, OR REMOVAL, STORAGE, AND REINSTALLATION/RELOCATION, OR TEMPORARY REMOVE/STORAGE, AND REINSTALLATION IN SAME LOCATION. MANY OTHER ELECTRIC ITEMS EXIST THAT ARE NOT SHOWN INCLUDE, BUT ARE NOT LIMITED TO, SWITCHES, RECEPTACLE, FLOOR
- OUTLETS, LOW VOLTAGE JACKS, LOW VOLTAGE DEVICES AND WIRING, TELEPHONE PUNCH DOWN BLOCKS, AND OUT OF SERVICE ITEMS. ALL SUCH ITEMS SHALL BE PERMANENTLY DE-ENERGIZED, DISCONNECTED, AND OTHERWISE MADE SAFE FOR DEMOLITION BY NON-ELECTRIC DEMOLITION WORKERS. THE ELECTRICAL CONTRACTOR IS RESPONSIBLE FOR ASSURING THAT ALL ELECTRIC DEVICES, OF ANY VOLTAGE OR FUNCTION, THAT ARE TO BE DEMOLISHED ARE SAFE AND ADVISE THE DEMOLITION CONTRACTOR WHEN THIS IS SO. AFTER THE ELECTRICAL CONTRACTOR HAS DISCONNECTED ELECTRIC SUPPLIES TO ITEMS TO BE DEMOLISHED, HE SHALL ADVISE
- THE GENERAL CONTRACTOR OF ANY ELECTRIC ITEMS TO BE RETAINED FOR FUTURE USE AND THEREFOR NOT TO BE DEMOLISHED. THE GENERAL CONTRACTOR SHALL THEN PERFORM ALL WORK ZONE DEMOLITION. THIS MATTER APPLIES TO ALL ELECTRIC ITEMS. OF ANY VOLTAGE OR PURPOSE. THE SPECIAL/SPECIFIC ITEMS SHOWN ON THE DRAWING FOR ELECTRICAL CONTRACTOR TO ACT ON WERE FOUND BY SURVEY. NUMEROUS LOCATIONS WERE BLOCKED BY FURNITURE, ETC. AND ADDITIONAL EQUAL TYPE ITEMS MAY BE PRESENT. THE
- REMOVAL ITEMS THAT ARE LISTED AS TO BE TURNED OVER TO OWNER'S INVENTORY SHALL BE DISCUSSED WITH THE DISTRICT BUILDINGS AND GROUNDS MANAGER. THOSE ITEMS THAT THE OWNER DECLINES SHALL THEN BE DISPOSED OF BY THE CONTRACTOR IN THE MANOR OF OTHER PERMANENT REMOVALS. ANY PCB BEARING FLUORESCENT FIXTURES SHALL BE

ELECTRICAL CONTRACTOR SHALL ALLOW FOR THIS IN HIS BID PRICE AND ATTEND TO THOSE EQUAL OR SIMILAR DEVICES AS MAY

- DISPOSED OF PER REGULATIONS. RETAIN EXISTING RECEPTACLES IN WALLS THAT WILL NOT BE IN CONFLICT WITH NEW CONSTRUCTION. RETAIN LIGHT SWITCH LOCATIONS THAT WILL NOT BE IN CONFLICT WITH NEW CONSTRUCTION. INSTALL BLANKING PLATE COVERS OVER THE UNUSED
- PORTION OF GANG BOXES HAVING MORE GANG POSITIONS THAN NEEDED FOR NEW SWITCHES. LIGHT FIXTURES ARE TO BE REMOVED AS GENERAL. NON ELECTRIC. CONTRACTOR DEMOLITION. ELECTRICAL CONTRACTOR RESPONSIBLE TO SAFE OFF LIGHTUING CIRCUITS FOR REMOVAL BY OTHERS. NO SPECIFIC QUANTITIES OR LOCATIONS ARE SHOWN. RETURN WHATEVER QUANTITY, IF ANY, OF THESE TO OWNER'S INVENTORY IF HE SO SPECIFIES OR THEY ARE OTHERWISE TO BE DISPOSED OF. ELECTRICAL CONTRACTOR SHALL EXAMINE FIXTURES FOR PRESENCE OF PCB'S AND SPECIAL
- THE ELECTRICAL CONTRACTOR SHALL COVER ALL BACK BOXES IN THE WALL THAT BECOME EXPOSED DUE TO DEVICE REMOVALS. THIS INSTRUCTION ALSO APPLIES TO EXPOSED ELECTRICAL BACK BOXES AS MAY EXIST AT THE SITE PRIOR TO THIS PROJECT. THE COVER SHALL BE BRUSHED ALUMINUM WITH CHAMFERED EDGES AND COVER THE HOLE COMPLETELY WITH AT LEAST 3/4" EXTRA MARGIN ON ALL SIDES. MOUNT THE COVER WITH SCREWS TO MATCH THE ORIGINAL PATTERN.
- IT IS EXPECTED THAT STRUCTURAL DEMOLITION BY THE GENERAL CONTRACTOR WILL CAUSE VARIOUS ELECTRIC SUPPLIES, OF VARIOUS VOLTAGES AND PURPOSES, TO BE CUT AND RENDER SOME DEVICES TEMPORARILY INACTIVE. IT IS THE ELECTRICAL CONTRACTOR'S RESPONSIBILITY TO RECONSTRUCT AND RECONNECT SUCH ELECTRIC SOURCES WHEN THE NEW STRUCTURE IS BUILT. NOTE THAT MOST REINSTALLED ITEMS WILL BE IN DIFFERENT LOCATIONS FROM THE REMOVAL LOCATION. THE ELECTRICAL CONTRACTOR SHALL MAKE ALL REQUIRED CIRCUIT EXTENSIONS OR MODIFICATIONS TO PROVIDE SERVICE TO A REINSTALLED ITEM AS RELOCATED. PROVIDE ALL REQUIRED CIRCUIT EXTENSIONS AS REQUIRED TO RESTORE SERVICE TO DEVICES. NOTE THAT THIS REQUIREMENT ALSO APPLIES TO THE ROOMS AND ELECTRICAL ITEMS WITHIN THAT ARE NOMINALLY NOT IN CONTRACT. SUCH RESTORATION OF SERVICE, IF NEEDED, IS SPECIFICALLY IN THE ELECTRICAL CONTRACTOR'S
- 10. IT SHALL BE THE ELECTRICAL CONTRACTOR'S RESPONSIBILITY TO PROTECT ALL ELECTRICAL DEVICES, FROM DAMAGES DURING CONSTRUCTION, WHICH ARE EITHER INDICATED TO REMAIN, AND/OR TO BE REMOVED AND REINSTALLED THROUGHOUT ALL CONSTRUCTION AREAS. DEVICES SHALL INCLUDE BUT WILL NOT BE LIMITED TO: SMOKE DETECTORS, EMERGENCY LIGHTS, EXIT SIGNS, OCCUPANCY SENSORS, SPEAKERS, LIGHT FIXTURES, SWITCHES, RECEPTACLE, ETC. IN THE EVENT OF DAMAGES INCURRED DUE TO CONSTRUCTION ACTIVITIES, THE ELECTRICAL CONTRACTOR SHALL BE RESPONSIBLE TO REPLACE ANY DAMAGED DEVICES AT NO ADDITIONAL COST TO OWNER.
- 11. ALL SYSTEM ASSOCIATED WITH THE DEVICES SCHEDULED TO BE REMOVED. STORED AND PROTECTED SHALL BE TESTED BY THE MANUFACTURER'S CERTIFIED TESTING VENDOR PRIOR TO ANY DEMOLITION ACTIVITY. ANY DEVICE WHICH FAILS THE TEST SHALL BE REPLACED WITH A FORM, FIT AND FUNCTION COMPONENT PER UNIT PRICES, AND SUCH DEVICES ARE NOT INCLUDED IN THIS RESPONSIBILITY STATEMENT, BUT ALSO SUCH INSTALLATION SHALL BE IN THE ELECTRICAL CONTRACTOR'S BASE BID. THE ELECTRICAL CONTRACTOR SHALL RE-TEST ALL SUCH SYSTEM COMPONENTS BY A MANUFACTURER CERTIFIED TESTING VENDOR OF SUCH SYSTEM OF ALL PREVIOUSLY TESTED SYSTEM COMPONENTS AFTER ALL WORK BY ALL TRADES HAS BEEN COMPLETED, AND ALL SYSTEM COMPONENTS HAVE BEEN INSTALLED. ANY COMPONENT WHICH FAILS SHALL BE REPLACED, AND PROGRAMMED IF NECESSARY BY THE ELECTRICAL CONTRACTOR. ALL SUCH REPLACEMENT AND PROGRAMMING COSTS SHALI BE ELECTRICAL CONTRACTOR'S RESPONSIBILITY. ALL COSTS ASSOCIATED WITH THE TESTING OF AFFECTED SYSTEM SUCH AS BUT NOT LIMITED TO FIRE ALARM, PUBLIC ADDRESS, INTERCOM, TELEPHONE, AND SECURITY SYSTEMS SHALL BE THE RESPONSIBILITY OF THE ELECTRICAL CONTRACTOR. ALL EQUIPMENT, DEVICES, WIRING AND THEIR ASSOCIATED MATERIAL SPECIFIED TO REMAIN, WHICH IS NOT STORED AND PROTECTED, SHALL BE PROTECTED DURING THE DEMOLITION ACTIVITIES, AND ALL TRADES SHALL BE INFORMED OF SUCH COMPONENTS. ANY OF SUCH COMPONENTS WHICH BECOME DAMAGED DURING DEMOLITION SHALL BE REPLACED FORM, FIT AND FUNCTION BY THE ELECTRICAL CONTRACTOR AT HIS EXPENSE.

ABBREVIATIONS

EXISTING TO REMAIN PSE&G LONG ISLAND (UTILITY CO.) SURFACE MOUNTED UNLESS OTHERWISE NOTED

ELECTRICAL CONTRACTOR GENERAL CONTRACTOR MECHANICAL CONTRACTOR

PLUMBING CONTRACTOR

ON CENTER AWAY FROM FLOOR CIRCUIT BREAKER

RECEPTACLE

ABOVE COUNTERTOP

LINE DESIGNATIONS

DEVICES TO BE REMOVED. PULL BACK ALL ASSOCIATED CONDUIT AND WIRING AND REMOVE UNLESS OTHERWISE NOTED ON THE

EXISTING TO REMAIN DEVICES

NEW DEVICES

TEMPORARY POWER CONSTRUCTION NOTES:

1. THE ELECTRICAL CONTRACTOR SHALL PROVIDE TEMPORARY POWER AND LIGHT IN THE NEW AREAS 'D'. AND 'E' AND THE RECONSTRUCTED AREAS OF THE EXISTING BUILDING. ALL TEMPORARY POWER PANELS AND FUSED SWITCHES OUTSIDE SHALL BE NEMA 3R CONSTRUCTION AND LOCKABLE. ALL OUTSIDE RECEPTACLES SHALL BE WATERPROOF AND HAVE A COVER THAT ENCLOSES THE PLUGGED IN CORDS WHILE IN

SERVICE AS INTERMATIC WP120C. NON-WATERPROOF GEAR IN A HOUSING IS NOT ACCEPTABLE.

- ALL RECEPTACLES SHALL BE GFCI PROTECTED AND MOUNTED 3'-0" ABOVE FINISHED FLOOR. PROVIDE WORK BLOCKING AS REQUIRED. ALL RECEPTACLES OUTLETS SHALL BE 2 GANG DOUBLE DUPLEX. TEMPORARY LIGHTING SHALL BE CONSTRUCTED OF SINGLE AND DOUBLE 100 WATT CLEAR INCANDESCENT LAMPS, OR EQUIVALENT, AND WATERPROOF RUBBER SOCKETS, SPLICED WITH WATERPROOF CONNECTORS ON FESTOONED ROMEX-TYPE WIRE. ADEQUACY OF ALL TEMPORARY LIGHTING CONFIGURATIONS SHALL BE AS DETERMINED BY THE CONSTRUCTION MANAGER. PRE ASSEMBLED TEMPORARY LIGHTING IS DISALLOWED. TAPS AND SPLICES SHALL BE MADE WITH SCOTCH LOCK CONNECTORS, RUBBER TAPE, AND THEM PVC COATED. THE CONNECTORS SHALL BE FILLED WITH PENETROX. A PLASTIC SHAPE ON CAGE/GUARD SHALL PROTECT EACH SOCKET AND LAMP. NOMINAL SPACING BETWEEN LAMP CLUSTER IS 16 FEET. MOUNT LIGHTS EIGHT FEET ABOVE FINISHED FLOOR IN TYPICAL LOCATIONS AND 10 FEET ABOVE FINISHED FLOOR IN CORRIDOR. PROVIDE NIGHT LIGHTING CIRCUIT, WHICH SHALL OPERATE CONTINUOUSLY. ALL LAMPS SHALL BE 130 VOLT, ROUGH SERVICE
- RATED. TEMPORARY LIGHTS SHALL BE TO OSHA STANDARDS. ALTERNATE FIXTURES SHALL BE 400W CONSTRUCTION SITE STYLE PROVIDE HOOK UPS TO JOB TRAILER FOR ALL TRADES. USE SITE POWER AS SOURCE. OWNER PAYS FOR POWER CONSUMPTION. WIRING SHALL BE 1#12+1#12(N)+1#12(G) ROMEX STYLE. CIRCUITS SHALL BE OPERATED A MAXIMUM OF 15 AMPS OR 1800 WATTS
- (18 100 WATT LAMPS), SWITCHING SHALL BE DONE VIA THE SWITCH RATED 20A, 10 CIRCUIT BREAKERS. SEGREGATE THE NIGHT LIGHTS AND RECEPTACLES IN THE LOWER PART OF THE POWER PANELS AND LABEL THESE "DO NOT TURN OFF". CIRCUIT HOME RUNS CONDUCTORS SHALL INCREASE ONE WIRE SIZE EVERY 100 FEET I.E. #10 CONDUCTORS. VIRING WITHIN THE ROOM AREA SHALL BE MADE WITH #12 CONDUCTORS.
- THE ELECTRICAL CONTRACTOR SHALL PREPARE EACH PANEL SCHEDULE A LENGTH OF GREENFIELD FLEX CONDUIT AT PINCH POINTS SHALL PROTECT ALL WIRE, SUCH AS WHERE WIRING PASSED IHROUGH A DOORWAY. WIRING SHALL BE SUPPORTED FROM ANCHORS INSTALLED BY THE ELECTRICAL CONTRACTOR FOR THE PURPOSE OF ATTACHMENT TO PROJECT, ALL ELECTRICAL HARDWARE SHALL BE NEW FOR THIS PROJECT.
- 10. ALL WIRING SHALL BE INSTALLED SO AS NOT TO CAUSE TRIPPING HAZARD OR SIMILAR OBSTRUCTION. 11. POWER PANELS SHALL BE EQUIPPED WITH 42 1P. 20A CIRCUIT BREAKERS AND ALL CIRCUIT BREAKERS NOT IN SERVICE SHALL BE LABELED SPARE. AT THE OWNERS OPTION PANEL AND CIRCUIT BREAKERS SHALL BE TURNED OVER TO OWNERS INVENTORY AT CONCLUSION OF THE PROJECT. ALL ELECTRICAL HARDWARE SHALL BE NEW FOR THIS PROJECT. THE ELECTRICAL CONTRACTOR SHALL BE RESPONSIBLE FOR ALL MAINTENANCE OF TEMPORARY LIGHTING AND POWER SYSTEMS DURING, AND AFTER INSTALLATION, UP TO THE TIME OF BENEFICIAL OCCUPANCY, AND TIME OF REMOVAL. REPAIRS
- IMMEDIATE DISPOSAL REMOVAL OF THE TEMPORARY POWER AND LIGHTING SHALL BE THE RESPONSIBILITY OF THE ELECTRICAL CONTRACTOR WHEN THE PROJECT IS COMPLETE. ALL EQUIPMENT. WIRING SUPPORTS. CONNECTORS. ETC. SHALL BE REMOVED FROM OWNER'S PROPERTY AFTER PROJECT IS COMPLETE. INCLUDE STATEMENT OF REMOVAL WITHIN CLOSE OUT DOCUMENTS, REQUIRED FOR
- OF THE TRADES, TEMPORARY SERVICES ARE REQUIRED PER SPECIAL CONDITIONS OF THE PROJECT. 15. ALL TEMPORARY POWER WORK SHALL BE COORDINATED WITH THE CONSTRUCTION MANAGER SPECIAL EMPHASIS SHALL BE

FIRE STOP NOTES:

1. ALL CONDUIT AND CABLE PENETRATIONS THROUGH FIRE RATED WALLS, FLOORS OR OTHER STRUCTURES SHALL BE FIRE STOPPED. 2. THE FIRE STOP MATERIALS SHALL BE HILTI TYPE FS-657 FIRE BLOCK, FS-ONE SEALANT, CP-672 JOINT SPRAY, CP-601S ELASTOMERIC SEALANT, 6P-606 FLEXIBLE SEALANT, CP-643 OR CP-642 COLLAR, CP-618 PUTTY STICK, OR FS-635 TROWEL ABLE COMPOUND, AS

3. CONTRACTOR SHALL SUBMIT SHOP DRAWINGS OF PRODUCTS SPECIFIED OR EQUAL.

DEVICE DECODIDATION

4. FIRE STOP MATERIALS OTHER THAN HILTI SHALL INCLUDE FULL TECHNICAL DATA WITH SHOP DRAWINGS TO DEMONSTRATE EQUALITY WITH THE SPECIFIED FIRE STOPS AND STATEMENT FROM MANUFACTURER THAT THEY MEET OR EXCEED THE PRODUCTS SPECIFIED

5. ALL SYSTEMS SHALL HAVE THEIR OWN SLEEVE THROUGH FIRE RATED WALLS. IE FIRE ALARM, PUBLIC ADDRESS, TELEPHONE, DATA, POWER AND LIGHTING.

FIRE ALARM SYSTEM LEGEND

AOR-MCP AREA OF RESCUE MAIN CONTROL PANE BASE BID IS GAMEWELL FCI-E3 SYSTEM WITH VOICE EVACUATION. REFER TO SPECIFICATIONS AND TO NOTES ON DWG. E5.01 FOR PART NUMBERS AND ADDITIONAL INFORMATION

AOR-PS AREA OF RESCUE POWER SUPPLY

MISCELLANEOUS SYMBOL DESCRIPTION CEILING MOUNTED PUBLIC ADDRESS SPEAKER. WALL MOUNTED PUBLIC ADDRESS SPEAKER HORN LOUDSPEAKER SUBSCRIPT 'WP' INDICATES OUTDOOR WEATHERPROOF HORN SPEAKER WALL MOUNTED VOLUME CONTROL FOR LOCAL PUBLIC ADDRESS SPEAKER WIRELESS CLOCK

ITEMS IN ABOVE LEGENDS MARKED WITH SUBSCRIPTS ON THE PLANS ARE DENOTED AS FOLLOWS: (E) - EXISTING ITEM TO REMAIN

(RL) - EXISTING ITEM TO BE RE-INSTALLED AND RELOCATED (RR) - REMOVE AND RE-INSTALL TO ACCOMMODATE NEW CONSTRUCTION NO SUBSCRIPT - NEW ITEM TO BE FURNISHED AND INSTALLED

SINGLE POLE CIRCUIT 2-#12, #12G, ["C UNLESS OTHERWISE NOTED

ELECTRICAL SYMBOL LEGEND

	TWO POLE CIRCUIT 3-#12, #12G, ["C UNLESS OTHERWISE NOTED
•	THREE POLE CIRCUIT 4-#12, #12G, ["C UNLESS OTHERWISE NOTED
φ	SINGLE RECEPTACLE, NEMA 5-20R W/ STAINLESS STEEL FACEPLATE
Ф	GROUND FAULT CIRCUIT INTERRUPTER 20A, 125V SINGLE RECEPTACLE, WITH STAINLESS STEEL FACEPLATE FOR KITCHEN EQUIPMENT.
φ ^M	DUPLEX RECEPTACLE, 125V, 20A W/ STAINLESS STEEL FACEPLATE. M DESIGNATES TEACHING MONITOR RECEPTACLE. COORDINATE EXACT MOUNTING HEIGHT WITH ARCHITECTURAL PLANS
#	QUADRUPLEX RECEPTACLE - (2)-GANG DUPLEX RECEPTACLES PER ABOVE W/ STAINLESS STEEL FACEPLATE
₽ _{W.P.}	GROUND FAULT CIRCUIT INTERRUPTER 20A, 125V DUPLEX RECEPTACLE, WITH STAINLESS STEEL 302/304 FACEPLATE FOR MECHANICAL SPACES, BOILER ROOM, CORRIDORS, OUTDOORS, ETC. 'W.P.' ANNOTATION - IN RAINPROOF & IN-USE COVER
#	GROUND FAULT CIRCUIT INTERRUPTER 20A, 125V QUADRUPLEX RECEPTACLE, 2 GANG WITH STAINLESS STEEL 302/304 FACEPLATE OR EQUAL
© _{277 1~}	30A-TWISTLOCK RECEPTACLE, SPECIAL VOLTAGE & PHASE PER LABEL

POWER ONLY DUPLEX FLOOR BOX CAST IRON WHEN INSTALLED IN CONC. SLAB. COVER COLOR AND TYPE AS APPROVED BY

POWER ONLY DUPLEX FLOOR BOX CAST IRON WHEN INSTALLED IN CONC. SLAB. COVER COLOR AND TYPE AS APPROVED BY

CEILING MOUNTED OCCUPANCY (OS)/VACANCY(VS) SENSOR, LOW VOLTAGE, DUAL TECHNOLOGY, COMPLETE W/ POWER

FOR LIGHTING FIXTURES - INDICATES PANELBOARD 'LPA'. POLE POSITION '1'. FIXTURE TYPE 'G' CONTROLLED BY SWITCH 'a'

'EX' CIRCUIT DESIGNATION INDICATES CONNECTION TO EXISTING ROOM LIGHTING CIRCUIT -INCLUDES ANY NECESSARY WIRING EXTENSIONS. 'NL' NIGHT LIGHT DESIGNATION INDICATED FIXTURES TO BE UNSWITCHED AND CIRCUITED AHEAD OF ALL

DATA & POWER SURFACE RACEWAY DROP - NUMBER OF TRIANGLES INDICATES NUMBER OF DATA DROPS - PROVIDE (2) DUPLEX

FIRE/SMOKE DAMPER - FURNISHED AND INSTALLED BY MC. EC TO WIRE. SEE MECH DRAWINGS FOR EXACT LOCATIONS

DATA & POWER RECESSED WALL BOX - NUMBER OF TRIANGLES INDICATES NUMBER OF DATA DROPS. SEE ALSO TECH. PLANS.

POWER ONLY DUPLEX RECEPTACLE MOUNTED ABOVE CEILING LOCATION FOR LIGHTING CONTROLLER

LOWER CASE ALPHA SUPERSCRIPT - CONTROLS CORRESPONDINGLY LABELLED FIXTURES IN ROOM

ROOM CONTROLLER, EATON SERIES OR EQUAL, MOUNT ABOVE CLG UNLESS OTHERWISE NOTED.

WIRELESS RELAY SWITCHPACK, MOUNT ABOVE CEILING. 0-10V DIMMING, 20A LOAD, 120/277V

'G'-GAS SHUTOFF. PC TO FURNISH EC TO WIRE, REFER TO PLUMBING DRAWINGS

'W'- WATER SHUTOFF. PC TO FURNISH EC TO WIRE, REFER TO PLUMBING DRAWINGS

RETRACTABLE INDUSTRIAL CORD REEL, 20A, 125V, 25' CORD LENGTH, DOUBLE GFI RECEPTACLE END.

EXISTING PROJECTOR TO BE REMOVED AND RE-INSTALLED UPON CONSTRUCTION COMPLETION

DATA & POWER FLOOR MOUNTED POKE THROUGH. SEE TECH PLANS FOR ADDITIONAL INFO

PC TO FURNISH, EC TO WIRE AND INSTALL - REFER TO PLUMBING DRAWINGS FOR

SINGLE, DUPLEX, QUADRUPLEX RECEPTACLE MOUNTED IN SERVICE PEDESTAL BOX, HUBBEL #SA6685 OR SA6687, SS13 OR SS23 BLANK PLATE IN REAR AND PLATE DUPLEX RECEPTACLE WITH USB PORTS, 125V, 20A WITH STAINLESS S STUB-UP CONDUIT FROM THE FLOOR MOTOR, NO. INDICATES HORSEPOWER UNFUSED DISCONNECT SWITCH, SIZE PER PLAN

POWER/DATA COMBO BOX. REFER TO TECHNOLOGY DRAWINGS

(NONE) = SINGLE POLE 20A, HEAVY DUTY SPEC GRADE SWITCH,

DIG# = DIGITAL SWITCH, # - INDICATES NUMBER OF BUTTONS

MCS= MASTER CONTROL SWITCH, ASCO 216B89, BY PLUMBING CONTRACTOR

D = WALLBOX SLIDE DIMMER COMPATIBLE W/ FIXTURE DIMMING BALLAST

VS/OS = DUAL TECH WALL SWITCH VACANCY OR OCCUPANCY SENSOR

PACK(S) AS REQUIRED. EATON GREENGATE OAC-DT-2000-R OR EQUAL

DAYLIGHT SENSOR PHOTOCELL - COMPATIBLE W/ ROOM CONTROLS

SWITCHPACK MOUNT ABOVE CLG UNLESS OTHERWISE NOTED

POWERPACK MOUNT ABOVE CLG UNLESS OTHERWISE NOTED

WIRELESS WAVELINX CONTROLLER OR APPROVED EQUAL.

EMERGENCY SHUT-OFF MUSHROOM TYPE PUSH BUTTON

'E'-ELECTRICAL SHUTOFF

H'- MOTORIZED HOIST SHUTOFF

SUBSCRIPT 'R'- INCLUDES KEY RESET

EMERGENCY POWER OFF BUTTON

SEE ALSO MOUNTING DETAIL ON DWG. E0.02

(2) DUPLEX RECEPTACLES PER DATA JACK ()

LOCATIONS AND ADDITIONAL INFORMATION

SEE E9.XX, E10.XX FOR DETAILS

RECEPTACLES PER DATA DROP. SEE ALSO TECH. PLANS.

GAS SYSTEM TEACHER EMERGENCY SHUT AND KEY RESET

ELECTRONIC SMARTBOARD - REFER TO TECH. DRAWINGS FOR DETAILS

NEW POWER & DATA FLOOR BOX, CAST IRON WHEN INSTALLED IN CONC. SLAB

M= MOMENTARY CONTACT SWITCH - MODEL # GMDS-W OR EQUAL

WALL SWITCH W/ STAINLESS STEEL FACEPLATE FACEPLATE

JUNCTION BOX CLG MOUNT, WALL MOUNT

PANEL 'RPC1' - POLE POSITION '1'

CONTACTOR 'SC211' - CONTACT '1'

K = KEY SWITCH

3 = 20A THREE WAY SWITCH

4 = 20A FOUR WAY SWITCH

WS = PRESET WALLSTATION

VS - PROGRAM FOR MANUAL ON MODE

U - ULTRASONIC TECHNOLOGY ONLY

OS - PROGRAM FOR AUTOMATIC ON MODE

SHALL BE MADE WITHIN 24 HOURS OF THE REPORTED OUTAGE. OR AS DIRECTED BY THE CONSTRUCTION MANAGER. ELECTRICAL CONTRACTOR SHALL COMMENCE WORK ON THIS PROJECT WITH A GROSS OF SPARE CONSTRUCTION BULBS AT HIS F FUSED DISCONNECT SWITCH, SIZE AND FUSE PER PLAN TRANSFORMER, VOLTAGE, PHASE, KVA PER PLAN PANEL BOARD, MOUNTING PER SCHEDULE

RPC1-1

SC211-1

WB

SP

PW

WAC

14. PROVIDE THE TEMPORARY ELECTRICAL SERVICE TO THE CONSTRUCTION TRAILERS SHALL BE AS PER USERS REQUIREMENTS

EXERCISED FOR TERRAZZO MACHINES AND ITS ELECTRICAL REQUIREMENT.

YMBOL	DEVICE DESCRIPTION
FACP	NEW INTELLIGENT ADDRESSABLE FIRE ALARM CONTROL PANEL W/ VOICE EVACUATION AND AUDIBLE NOTIFICATION. PROVIDE FRAMED BLDG GRAPHIC MAP WITHIN SIGHT OF PANEL
RAP	NEW REMOTE ANNUNCIATOR PANEL OR EQUAL. E.C. TO PROVIDE FRAMED BLDG GRAPHIC MAP WITHIN SIGHT
FSD	FIRE ALARM SHUT DOWN
$\langle S \rangle$	NEW SMOKE DETECTOR W/ BASE
© OR @	NEW CARBON MONOXIDE DETECTOR WITH SOUNDER BASE. CONNECT TO ASSOCIATED UNIT WITH SOUNDER BASE FOR SIMULTANEOUS LOCAL ALARM.
Ь¢	NEW CARBON MONOXIDE SYSTEM AMBER COLOR VISUAL NOTIFICATION DEVICE.
P	NEW MANUAL PULL STATION. PROVIDE WITH NON-ALARMED STI STOPPER II LIFT COVER (OR SIMILAR)
\$\bar{\bar{\bar{\bar{\bar{\bar{\bar{\bar	NEW DUCT TYPE SMOKE DETECTOR W/ HOUSING AND REMOTE LED INDICATOR
\vdash	NEW SPEAKER NOTIFICATION DEVICE - WALL MOUNT.
$\vdash \bigcirc$	NEW SPEAKER/STROBE NOTIFICATION DEVICE - WALL MOUNT.
∇	NEW SPEAKER NOTIFICATION DEVICE - CEILING MOUNT.
\bigcirc	NEW SPEAKER/STROBE NOTIFICATION DEVICE - CEILING MOUNT.
ÞΦ	NEW STROBE NOTIFICATION DEVICE. WALL MOUNTED.
\Diamond	NEW STROBE NOTIFICATION DEVICE. CEILING MOUNTED.
	NEW HORNSTROBE NOTIFICATION DEVICE
$(\widehat{\mathbf{M}})$	NEW 24V ELECTROMAGNETIC DOOR HOLDER - GC FURNISH & MOUNT. EC TO WIRE. REFER TO FIRE ALARM DEVICE NOTES ON E5.01 FOR ADDITIONAL INFORMATION
\circ	EXISTING FIRE ALARM BELL TO BE REMOVED. INSTALL BLANK COVER PLATE.
	NEW FIRE ALARM RELAY
\odot	EXISTING BATTERY OPERATED CO DETECTOR TO REMAIN UNLESS OTHERWISE NOTED
R	NEW AIR HANDLING UNIT. REFER TO MECHANICAL DWG. FOR ADDITIONAL INFORMATION ANNOTATION 'R' - UNIT TO HAVE RELAY SHUTDOWN. REQUIRED ON ALL FANS OVER 1000 CFM
eW)	WATERFLOW SWITCH FOR NEW SPRINKLER SYSTEM (BY FIRE SPRINKLER CONTRACTOR)
TS	TAMPER SWITCH FOR NEW SPRINKLER SYSTEM (BY FIRE SPRINKLER CONTRACTOR)
ANSUL	EXISTING ANSUL SYSTEM TO REMAIN.
RC →	FIRE ALARM - BEAM DETECTOR RECEIVER
⟨SP⟩ ►	FIRE ALARM - BEAM DETECTOR TRANSMITTER
S.W.G.	STEEL WIRE GUARD.
W.P.	WEATHER PROOF.
W.M.	WALL MOUNT.
E, EX	EXISTING TO REMAIN
AOR	AREA OF RESCUE
AOD DC	ADEA OF DESCRIF DOMED SLIDDLY

SIMILAR SYMBOLS USED ON DEMO PLANS. ALL ITEMS SHOWN ON DEMO PLAN TO BE REMOVED ENTIRELY UNLESS OTHERWISE NOTED.

SOUND SYTEM DESCRIPTION

SYMBOL	DESCRIPTION
ER	FLOOR/WALL RACK
S#)	SPEAKERS
S	MONITOR SPEAKER OUTPUT JACK PLATE
ANT	ANTENNA
A	AUDIO INPUT JACK PLATE
(AV)	HDBASET TRANSMITTER JACK PLATE - HOUSE CENTER STAGE APRON 2 GANG BOX
M	MICROPHONE INPUT JACK PLATE
X	DIGITAL MIXER JACK PLATE F.O.H. MIX BOOTH
VC	REMOTE CONTROL JACK PLATE
SW	SUBWOOFERS
FB	FOLDBACK (STAGE MONITOR) LOUDSPEAKERS
P	12K LASER PROJECTOR
LA	COLUMN/LINE ARRAY LOUDSPEAKERS
CF	CENTER FILL LOUDSPEAKER
(CS)	CEILING SPEAKERS

REV. DATE

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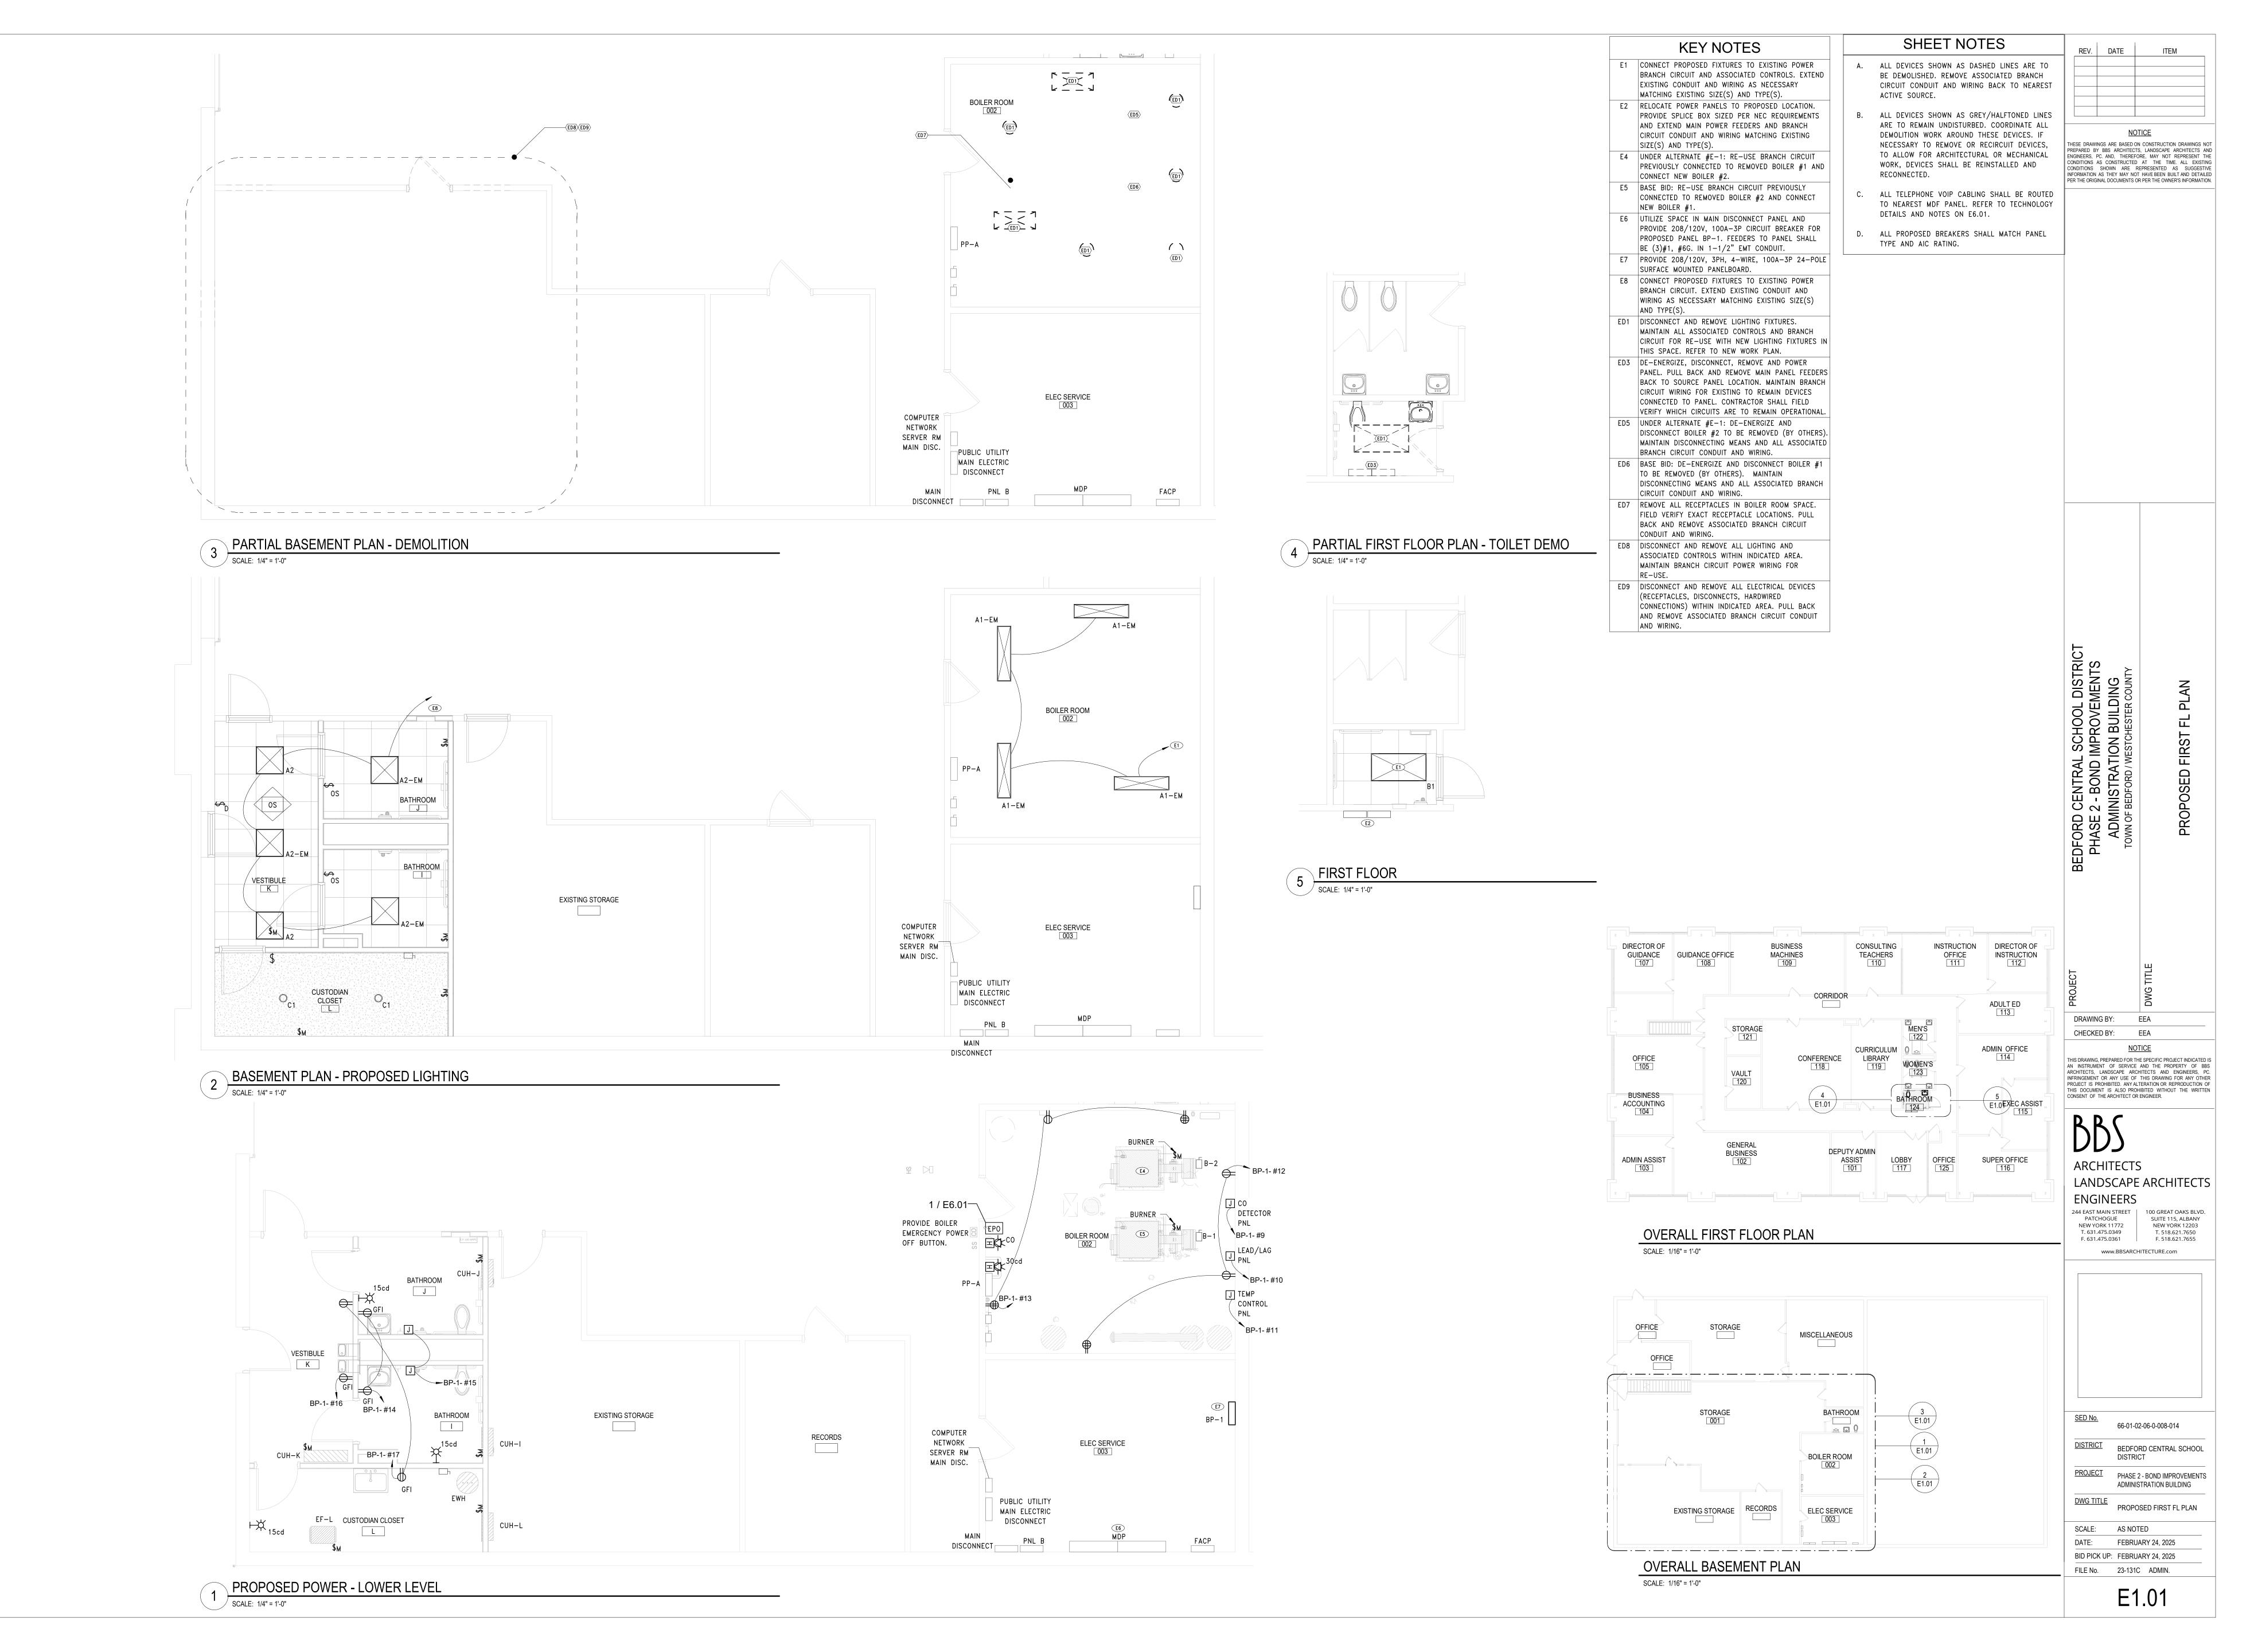
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66-01-02-06-0-008-014 DISTRICT BEDFORD CENTRAL SCHOOL PROJECT PHASE 2 - BOND IMPROVEMENTS ADMINISTRATION BUILDING


<u>DWG TITLE</u> GENERAL NOTES, SYMBOLS AND ABBREVIATIONS SCALE: AS NOTED DATE: FEBRUARY 24, 2025 BID PICK UP: FEBRUARY 24, 2025

FILE No. 23-131C ADMIN.




LIGHTING FIXTURE SCHEDULE											
TAG	DESCRIPTION	MANUFACTURER	CATALOG NUMBER	WATTAGE / CCT / LAMP / CRI	VOLTAGE	REMARKS					
A1-EM	LED LINEAR BAY LIGHTING FIXTURE WITH EM BATTERY PACK, 14,000 LUMENS PACKAGE, DLC LISTING AND FROSTED ACRYLIC LENS	COOPER METALUX	4ILED-LD5-14-W-FL-UNV-L835-EL14W	98W/3500/LED/85+	UNV						
A2	2'X2' LED TROFFER WITH DLC LISTING AND 4300 LUMENS PACKAGE	COOPER METALUX	22EN-LD2-43-UNV-L835-CD1-U	38W/3500/LED/85+	UNV						
A2-EM	SAME AS A2 WITH EMERGENCY OPTION	COOPER METALUX	22EN-LD2-43-UNV-EL7W-L835-CD1-U	38W/3500/LED/85+	UNV						
B1	2'X4' LED TROFFER WITH EM BATTERY PACK, DLC LISTING AND 5400 LUMENS PACKAGE	COOPER METALUX	24EN-LD2-54-UNV-EL7W-L835-CD1-U	43W/3500/LED/85+	UNV						
C1	6" DOWNLIGHT	COOPER HALO	PR6-FS24-D010	39W/3500/LED/85+	UNV						

	Electrical Equipment Schedule													
TAG	DESCRIPTION	VOLTAGE	PHAS E	AMPS - (FLA/MCA)	POWER PANEL	CIRCUIT NUMBER	BREAKER RATING	WIRE	PROVIDE DISCONNECT	DISCONNECT	Notes			
B-1	BOILER	208 V	3	7.8 FLA	BP-1	3,5,7	20A-3P	(3)#12, #12G. IN 3/4" C.	Yes	30A NEMA 1				
B-1 BURNER	BURNER	120 V	1	10 FLA	BP-1	1	20A-1P	(2)#12, #12G. IN 3/4" C.	Yes	MOTOR RATED TOGGLE SWITCH				
B-2 (ADD ALTERNATE)	BOILER	208 V	3	7.8 FLA	BP-1	4,6,8	20A-3P	(3)#12, #12G. IN 3/4" C.	Yes	30A NEMA 1				
B-2 BURNER (ADD ALTERNATE)	BURNER	120 V	1	10 FLA	BP-1	2	20A-1P	(2)#12, #12G. IN 3/4" C.	Yes	MOTOR RATED TOGGLE SWITCH				
CUH-I	CABINET UNIT HEATER	208 V	1	9.6 FLA	BP-1	19,21	20A-2P	(2)#12, #12G. IN 3/4" C.	Yes	MOTOR RATED TOGGLE SWITCH				
CUH-J	CABINET UNIT HEATER	208 V	1	9.6 FLA	BP-1	18,20	20A-2P	(2)#12, #12G. IN 3/4" C.	Yes	MOTOR RATED TOGGLE SWITCH				
CUH-K	CABINET UNIT HEATER	208 V	1	14.4 FLA	BP-1	26,28	25A-2P	(2)#10, #10G. IN 3/4" C.	Yes	MOTOR RATED TOGGLE SWITCH				
CUH-L	CABINET UNIT HEATER	208 V	1	9.6 FLA	BP-1	22,24	20A-2P	(2)#12, #12G. IN 3/4" C.	Yes	MOTOR RATED TOGGLE SWITCH				
EF-L	EXHAUST FAN	120 V	1	1 FLA	BP-1	29	15A-1P	(2)#12, #12G. IN 3/4" C.	Yes	MOTOR RATED TOGGLE SWITCH				
EWH	ELECTRIC WATER HEATER	208 V	3	16.7 FLA	BP-1	23,25,27	25A-3P	(3)#10, #10G. IN 3/4" C.	Yes	30A NEMA 1				

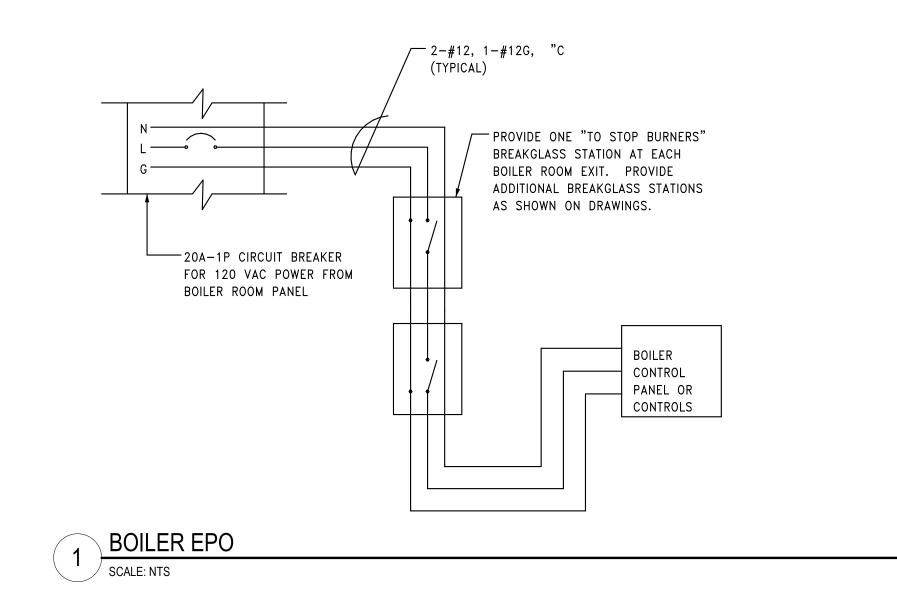

	Location: ELE Supply From: Mounting: SUF	€ 003	Volts: 120/208 Wye Phases: 3 Wires: 4							A.I.C. Rating: Mains Type: MCB Mains Rating: 100 A				
СКТ	Circuit Description	Trip	Poles		A	ı	В		С	Poles	Trip	Circui	t Description	CK
1	B-1 BURNER (SHUNT TRIP CB)	20 A	1	1200 VA	1200 VA					1	1 20 A	B-2 BURNER (SH	<u> </u>	2
3	B-1	20 A	3			941.9 VA	941.9 VA			3	20 A	B-2		4
5								941.9 VA	941.9 VA					6
7				941.9 VA	941.9 VA									8
9	CO DETECTOR PNL	20 A	1			900 VA	900 VA			1	20 A	LEAD/LAG PNL		10
11	TEMP CONTROL	20 A	1					900 VA	720 VA	1	20 A	CONVINIENCE R	ECEPT	12
13	CONVINIENCE RECEPT	20 A	1	900 VA	360 VA					1	20 A	RECEPT - TOILE	T RM BASEMENT	14
15	HAND DRYERS	20 A	1			1800 VA	180 VA			1	20 A	WATER COOLER	2	16
17	GEN RECEPT	20 A	1					360 VA	1000 VA	2	20 A	CUH-J		18
19	CUH-I	20 A	2	1000 VA	1000 VA							 		20
21						1000 VA	1000 VA			2	20 A	CUH-L		22
23	EWH	25 A	3					2000 VA	1000 VA					24
25				2000 VA	1500 VA					2	25 A	CUH-K		26
27						2000 VA	1500 VA							28
29	EF-L	15 A	1					1200 VA						30
31														32
33														34
35														36
37														38
39														40
41														42
Total L						11164 VA		9064 VA						
		Tota	I Amps:	95	5 A	96	6 A	76	6 A					
Load Classification				Connected Load		Demand Factor		Estimated Demand		Panel Totals			Totals	
Equipment				4500 VA		100.00%		4500 VA						
Motor				12600 VA		100.00%		12600 VA		Total Conn. Load:		otal Conn. Load:	31271 VA	
Receptacle				2520 VA		100.00%		2520 VA		Total Est. Demand:				
Power				11651 VA		100.00%	,)	11651	VA		Tota	al Conn. Current:	87 A	
								Tota	al Est. I	Demand Current:	87 A			
Notes:														

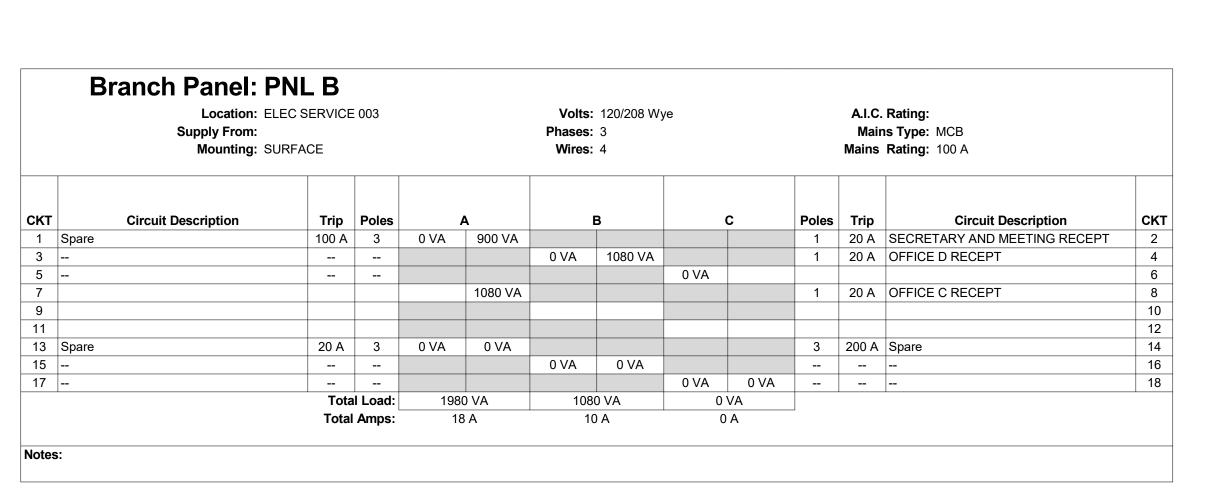

REV. DATE ITEM

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BEDFORD CENTRAL SCHOOL DISTRIL

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BEDFORD CENTRAL SCHOOL DISTRIL

BEDFORD IMPROVEMENTS

ADMINISTRALION BUILDING

TOWN OF BEDFORD / WESTCHESTER COUNTY

TOWN OF BEDFORD / WESTCHESTER SPC.

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SED No. 66-01-02-06-0-008-014

DISTRICT PEDEORD CENTRAL SC

DISTRICT
BEDFORD CENTRAL SCHOOL
DISTRICT

PROJECT
PHASE 2 - BOND IMPROVEMENTS
ADMINISTRATION BUILDING

DWG TITLE
SCHEDULES

SCALE: AS NOTED

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