

## **NEW YORK CITY DEPARTMENT OF ENVIRONMENTAL PROTECTION BUREAU OF WATER SUPPLY DIVISION OF INFRASTRUCTURE DESIGN & CONSTRUCTION**

## **CONTRACT NO. CRO-624G** TOWN OF MOUNT PLEASANT, NY



**KEY PLAN** 



Todd A. West. P.E., Director

TODD WEST, P. E. **DIRECTOR - PLANNING BUREAU OF WATER SUPPLY** 

Digitally signed by Todd A. West, P.E., Director Date: 2023.05.04 11:45:47 -04'00'

## **REPURPOSING OF THE KENSICO LABORATORY AS THE KENSICO** REGIONAL **HEADQUARTERS**

## **MAY 2023**

# **APPROVED FOR THE CITY OF NEW YORK**

Paul V Rush Digitally signed by Paul V Rush Date: 2023.05.10 13:54:37

PAUL V. RUSH, P.E. **DEPUTY COMMISSIONER BUREAU OF WATER SUPPLY** 



LOCATION PLAN



Rohit T. Aggarwala

Digitally signed by Rohit T. Aggarwala Date: 2023.05.11 10:06:08 -04'00

**ROHIT T. AGGARWALA** COMMISSIONER NYC DEPARTMENT OF ENVIRONMENTAL PROTECTION

## REPURPOSING OF THE KENSICO LABORATORY AS THE KENSICO REGIONAL HEADQUARTERS MOUNT PLEASANT, NY

<u>HEET</u> <u>NO.</u>	DRAWING NO.	TITLE	<u>SHEET</u> <u>NO.</u>	DRAWING NO.	TITLE
<u>110.</u>	<u>GENERAL</u>		<u></u>	DEMOLITION	
1	G-000	COVER SHEET	26	DG-100	CELLAR PH
2	G-001	SHEET INDEX	27	DG-101	FIRST FLOO
3	G-002	SHEET INDEX	28	DG-102	SECOND FI
			29	DG-103	ATTIC PHO
			30	DG-104	CELLAR PH
			31	DG-105	FIRST FLO
	<u>CIVIL</u>		32	DG-106	SECOND F
			33	DG-107	ATTIC AND
4	GC-100	GENERAL NOTES, LEGEND, AND ABBREVIATIONS	34	DG-108	DEMOLITIC
			35	DG-109	EXISTING F
5	C-100	LOCATION PLAN	36	DG-110	EXISTING F
6	C-101	EXISTING CONDITIONS PLAN	37	DG-111	EXISTING F
7	DC-100	DEMOLITION PLAN	38	DG-112	EXISTING F
8	C-102	SOIL EROSION AND SEDIMENT CONTROL PLAN	39	DG-113	EXISTING F
9	C-102	SITE PLAN	40	DG-114	EXISTING F
10	C-104	GRADING AND DRAINAGE PLAN	41	DG-115	EXISTING F
11	C-104 C-105	DETAILS - 1	42	DG-116	EXISTING F
12	C-105 C-106	DETAILS - 2	43	DG-117	EXISTING E
13	C-100 C-107	DETAILS - 3	44	DG-118	EXISTING E
4	C-107 C-108	DETAILS - 4	45	DG-119	EXISTING E
5	C-109	DETAILS - 5			
	LANDSCAPING			<u>STRUCTURAL</u>	
16	GL-100	LANDSCAPE PLAN	46	GS-001	GENERAL
17	LS1-300	DETAILS	47	DS-100	FIRST FLOO
			48	DS-101	SECOND FL
	<u>HAZMAT</u>		49	DS-300	DEMOLITIO
			40 50	S-100	FOUNDATIO
18	HZ-100	EXISTING CELLAR - DEMOLOTION PLAN	50	S-101	FIRST FLO
19	HZ-100	EXISTING CELLAR - DEMOLOTION PLAN	52	S-102	SECOND FI
20	HZ-102	EXISTING FIRST FLOOR - DEMOLITION PLAN	53	S-300	SECTIONS
21	HZ-102	EXISTING FIRST FLOOR - DEMOLITION PLAN	54	S-301	SECTIONS
22	HZ-103	EXISTING FIRST FLOOR - DEMOLITION PLAN	55	S-400	ENLARGED
23	HZ-104	EXISTING FIRST FLOOR - DEMOLITION FLAN	56	S-500	REPAIR SC
24	HZ-106	EXISTING SECOND FLOOR - DEMOLITION PLAN	57	S-501	DETAILS
25	HZ-100	EXISTING ATTIC - DEMOLITION PLAN	58	S-502	DETAILS
20	112-107		59	S-503	DETAILS
	DESIGNE M. LOPEZ	M. LOPEZ	"WARNING-IT IS A VIOLATION, OF THE NEW YORK STATE EDUCATION LAW, SECTION, 7209.2, FOR ANY PERSON,	NEW Y	ORK CITY
	CHECKEI		UNLESS (S)HE IS ACTING UNDER THE DIRECTION OF A LICENSED PROFESSIONAL ENGINEER, TO ALTE		

utodesk Docs://90290-03A\_CAT-423 WO-03A Recon of Kensico Lab/90290-03A\_G\_KLB.I

NO. DATE

All inquiries regarding this drawing(s) or project should be made to NYC Environmental Protection, Bureau of Water Supply.

APPR'D

**REVISIONS/DESCRIPTION** 

Hazen

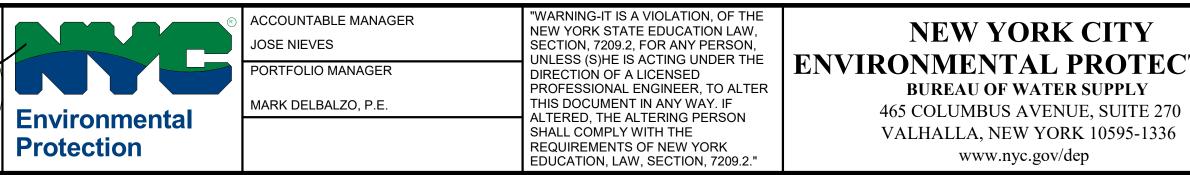


PHOTO KEY PLAN OOR PHOTO KEY PLAN FLOOR PHOTO KEY PLAN IOTO KEY PLAN PHOTOS OOR PHOTOS FLOOR PHOTOS ID ROOF PHOTOS ION PLAN - EXTERIOR PHOTOS **B PLUMBING PLAN - CELLAR** PLUMBING PLAN - FIRST FLOOR PLUMBING PLAN - SECOND FLOOR PLUMBING PLAN - ATTIC HVAC PLAN - CELLAR HVAC PLAN - FIRST FLOOR HVAC PLAN - SECOND FLOOR HVAC PLAN - ATTIC ELECTRICAL PLAN - CELLAR ELECTRICAL PLAN - FIRST FLOOR ELECTRICAL PLAN - SECOND FLOOR AND ATTIC

L NOTES, ABBREVIATIONS AND SYMBOLS OOR DEMOLITION PLAN FLOOR DEMOLITION PLAN TON SECTIONS TION PLAN OOR OVERALL PLAN FLOOR OVERALL PLAN IS IS

SCHEDULE AND DETAILS


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CTION	THE KENSICO REGIONAL HE MOUNT PLEASANT, NE	REPURPOSING OF THE KENSICO LABORATORY AS THE KENSICO REGIONAL HEADQUARTERS MOUNT PLEASANT, NEW YORK CONTRACT CRO-624		
	GENERAL SHEET INDEX		drawing no. G-001	

## REPURPOSING OF THE KENSICO LABORATORY AS THE KENSICO REGIONAL HEADQUARTERS MOUNT PLEASANT, NY
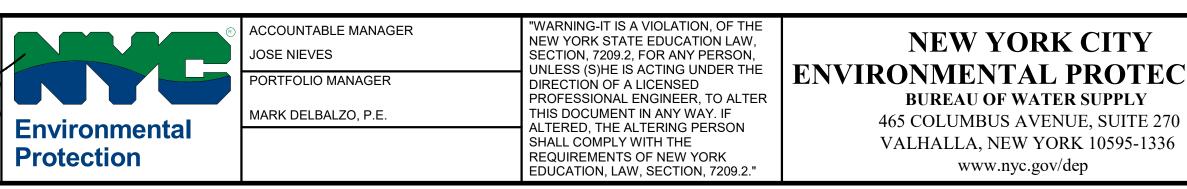
<u>SHEET</u> <u>NO.</u>	<u>DRAWING NO.</u>	TITLE	<u>SHEET</u> <u>NO.</u>	DRAWING NO.	<u>TITLE</u>
	ARCHITECTURAL			<u>ARCHITECTURAL</u>	
60	GA-001	GENERAL NOTES & SYMBOLS	99	A-551	CANOPY DE
61	GA-002	ACCESSIBILITY DETAILS	100	A-552	CANOPY DE
62	GA-003	CODE ANALYSIS	101	A-561	ROOFING D
63	DA-100	DEMOLITION PLAN - BASEMENT	102	A-601	PARTITION
64	DA-101	DEMOLITION PLAN - FIRST FLOOR	103	A-611	DOOR SCH
65	DA-102	DEMOLITION PLAN - SECOND FLOOR	104	A-612	OVERHEAD
66	DA-103	DEMOLITION PLAN - ATTIC	105	A-621	WINDOW SC
67	DA-201	DEMOLITION ELEVATIONS	106	A-622	WINDOW DE
68	DA-202	DEMOLITION ELEVATIONS	107	A-631	STOREFRO
69	A-100	CONSTRUCTION PLAN - CELLAR	108	A-632	STOREFRO
70	A-101	CONSTRUCTION PLAN - FIRST FLOOR	109	A-633	STOREFRO
71	A-102	CONSTRUCTION PLAN - SECOND FLOOR			
72	A-103	CONSTRUCTION PLAN - ATTIC		<b>MECHANICAL</b>	
73	A-104	CONSTRUCTION PLAN - ROOF			
74	A-110	REFLECTED CEILING PLAN - CELLAR	110	M-001	FOUNDATIC
75	A-111	REFLECTED CEILING PLAN - FIRST FLOOR	111	M-002	PLAN AND S
76	A-112	REFLECTED CEILING PLAN - SECOND FLOOR		101-002	
77	A-113	REFLECTED CEILING PLAN - ATTIC			
78	A-120	FINISH PLAN - FIRST FLOOR			
79	A-121	FINISH PLAN - SECOND FLOOR		SECURITY	
80	A-201	EXTERIOR ELEVATIONS			
81	A-202	EXTERIOR ELEVATIONS	112	SC-100	TEMPORAR
82	A-301	BUILDING SECTIONS	113	SC-101	BASEMENT
83	A-302	BUILDING SECTIONS	114	SC-102	FIRST FLOC
84	A-303	BUILDING SECTIONS	115	SC-103	SECOND FL
85	A-304	BUILDING SECTIONS	116	SC-104	RISER DIAG
86	A-311	WALL SECTIONS	117	SC-105	RISER DIAG
87	A-401	ENLARGED KITCHEN PLANS, ELEVATIONS, AND DETAILS	118	SC-106	OUTDOOR
88	A-402	ENLARGED FIRST FLOOR TOILET ROOMS PLAN AND ELEVATIONS	119	SC-107	PANEL LAY
89	A-403	ENLARGED FIRST FLOOR TOILET ROOMS PLAN AND ELEVATIONS	120	SC-300	MOUNTING
90	A-404	ENLARGED SECOND FLOOR TOILET ROOMS PLAN AND ELEVATIONS	121	SC-301	MOUNTING
91	A-411	STAIR PLANS AND SECTIONS			
92	A-412	STAIR DETAILS			
93	A-501	PLAN DETAILS			
94	A-511	SIGNAGE DETAILS			
95	A-521	INTERIOR DETAILS			
96	A-522	FIRESTOPPING DETAILS			
97	A-531	CEILING DETAILS			
98	A-541	MASONRY RESTORATION DETAILS			
	-				

CHECKED BY: DESIGN LEAD:	DATE	REVISIONS/DESCRIPTION	APPR'D		lazen	100 0.08 7035 R0FESSION
				M. LOPEZ CHECKED BY: E. BARBOE, P.E.	M. LOPEZ DESIGN LEAD: E. BARBOE, P.E.	SIAN S. B.

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TION	REPURPOSING OF THE KENSICO THE KENSICO REGIONAL HE MOUNT PLEASANT, NE CONTRACT CRO-	DATE: MAY 2023 SCALE: SHEET NO: <b>3</b> OF No. <b>121</b>			
	GENERAL SHEET INDEX		drawing no. <b>G-002</b>		

EXISTING	
XX	CHAINLINK FENCE
-000000	STOCKADE FENCE
00	SPLIT RAIL FENCE
	BOTTOM OF CURB LINE
	TAX LOT LINE
~	OVERHEAD UTILITY LINES
S	SEWER LINE (OF RECORD)
— SD —— SD —— SD ——	STORM DRAIN LINE
W	WATER LINE (OF RECORD)
W	WATER LINE (TONE OUT)
—— GAS——— GAS———	GAS LINE (TONE OUT)
	BUILDING
	SAW CUT LINE

LIMIT OF WORK ELEVATION

365.2	TOP OF CURB ELEVATION
365.0	BOTTOM OF CURB ELEVATION

\* SEE INDIVIDUAL SHEETS FOR PROPOSED LEGEND ITEMS.

365.2

					DESIGNED BY:	DRAWN BY:		OF NEW
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					ENGINEERS + 1	GRC CONSULTING	T	Terrorita and a second and a se
Ν	NO.	DATE	REVISIONS/DESCRIPTION	APPR'D	6901 31	ERICHO TURNPIKE, SUITE 216 SYOSSET, N.Y. 11791	V	VIESSION VIENN

All inquiries regarding this drawing(s) or project should be made to NYC Environmental Protection, Bureau of Engineering Design and Construction.

ABBREVIATIONS	
ABANDONED AHEAD	ABDN. AH
AHEAD AMERICAN SOCIETY FOR TESTING AND MATERIALS	AH ASTM
AS ORDER BY THE ENGINEER	AOBE
ASPHALT	ASPH.
BACK	ВК
BASE LINE	B.L.
BITUMINOUS BUILDING	BIT.
BLOCK	BLDG. BLK.
BOTTOM OF CURB	BC
BOTTOM OF WALL	BW
BOTTOM OF SIDEWALK ELEVATION	BS
BRICK	BRK.
	CB.
CENTER LINE CENTER TO CENTER	C.L. C-C
CHAIN LINK FENCE	C.L.F.
CLEARANCE	CL.
CONCRETE	CONC.
CONCRETE SIDEWALK	C.SW.
	C.C.
DIAMETER DRAWING	DIA. DWG
DROP CURB	D.C.
DRYWELL	D.0. DW.
EAST	E
EDGE OF PAVEMENT	E.O.P.
	ELEV
ELECTRIC PULL BOX EXISTING	EPB EXIST.
FEET	FT
FIELD INLET	FI.
FRAME	FR.
GAS VALVE	GV
GROUND ELEVATION	GRD
HANDICAP HIGH-DENSITY POLYETHYLENE	H.C. HDPE
HORIZONTAL	HORZ
INCH	IN
INVERT ELEVATION	INV.
LINEAR FEET	LF
LINEAR	LIN
LONG MANHOLE	LG MH
MANHOLE	MAX.
MINIMUM	MIN.
NEW YORK CITY DEPARTMENT OF ENVIRONMENTAL PROTECTION	NYCDEP
NORTH	N
NOT TO SCALE	N.T.S. O.C.
ON CENTER OCCUPATIONAL SAFETY AND HEALTH ADMINISTRATION	O.C. OSHA
PAVEMENT	PAVT.
POUNDS	LB
POUNDS PER SQUARE INCH	PSI
RADIUS	R
	RCA RCP
REINFORCED CONCRETE PIPE RIM ELEVATION	RIM.
ROADWAY	RDWY.
STONE UNDERDRAIN	S
SANITARY	SAN
SEWER	SWR.
SPECIFICATIONS	SPECS. SQ
SQUARE STANDARD	SQ STD.
STANDARD STORM WATER	ST.W.
TOP OF CURB	ТС
TOP OF WALL	TW
TYPICAL	TYP.
UNKNOWN PULL BOXES	UPB
	VAC. VAR
VARIES VERIFY IN FIELD	VIF
VERIEVIN FIELD	VERT
WATER VALVE	WV
	14/14/17
WELDED WIRE FABRIC WELDED WIRE MESH	WWF WWM

## **GENERAL NOTES**

- CONSTRUCT THE PROJECT AND/OR AS SHOWN IN THE PLANS.
- EXPLOSIVES SHALL NOT BE ALLOWED FOR ROCK EXCAVATION. SEE SPECIFICATIONS.
- STARTING CONSTRUCTION.

- IMMEDIATELY, AT NO ADDITIONAL COST TO NYCDEP.
- UNDERGROUND DRAINAGE.
- PRIOR TO REMOVAL.
- THE SUPERVISION OF A NEW YORK STATE LICENSED LAND SURVEYOR.

- 16. CONTRACTOR SHALL GRADE ALL AREAS ON THE SITE TO MAINTAIN POSITIVE DRAINAGE.

- SAFETY FENCE.

INSTRUCTIONS:

- CONTRACTOR AND NOT THE ENGINEER/DESIGNER.



ACCOUNTABLE MANAGER JOSE NIEVES PROJECT MANAGER MARK DELBALZO, P.E.

"WARNING-IT IS A VIOLATION, OF THE NEW YORK STATE EDUCATION LAW, SECTION, 7209.2, FOR ANY PERSON, UNLESS (S)HE IS ACTING UNDER THE DIRECTION OF A LICENSED PROFESSIONAL ENGINEER, TO ALTER THIS DOCUMENT IN ANY WAY. IF ALTERED, THE ALTERING PERSON SHALL COMPLY WITH THE REQUIREMENTS OF NEW YORK EDUCATION, LAW, SECTION, 7209.2."

**NEW YORK CITY ENVIRONMENTAL PROTEC BUREAU OF WATER SUPPLY** 465 COLUMBUS AVENUE, SUITE 270 VALHALLA, NEW YORK 10595-1336 www.nyc.gov/dep

1. SELECT DEMOLITION AND SITE CLEARING INCLUDES BUT IS NOT LIMITED TO THE REMOVAL OF SIDEWALK, CURB, PAVEMENT, DRIVEWAYS, PIPE, MANHOLES, AND OTHER SUBSURFACE STRUCTURES, TREES, BRUSH, ROOTS, DEBRIS, VEGETATION, POLES AND ALL OTHER ITEMS REQUIRED TO

2. UNCLASSIFIED EXCAVATION INCLUDES BUT IS NOT LIMITED TO EXCAVATION REQUIRED FOR SOIL RESTORATIONS, NEW MANHOLES, INLETS, OR DRAINAGE PIPES. ALL VOIDS CREATED BY THE REMOVAL OF EXISTING STORM DRAINS AND SUBSURFACE STRUCTURES SHALL BE BACKFILLED WITH SUITABLE UNCLASSIFIED EXCAVATION MATERIAL AS DIRECTED BY THE CLIENT. ALL EXCAVATION SHALL COMPLY WITH OSHA REQUIREMENTS.

3. LOCATIONS OF EXISTING UTILITIES AND SEWERS SHOWN ON THE PLANS WERE DETERMINED BY STANDARD SURVEYING METHODS, AVAILABLE RECORDS AND THROUGH SOLICITATION OF THE RESPECTIVE UTILITY OWNERS. THE INFORMATION FOR THE EXACT LOCATION OF THESE UTILITIES IS NOT GUARANTEED TO BE COMPLETE OR CORRECT. THE CONTRACTOR SHALL VERIFY THE EXACT LOCATION OF ALL UTILITIES IN THE FIELD PRIOR TO

4. THE CONTRACTOR IS RESPONSIBLE FOR PROVIDING ALL FIELD LAYOUT AND VERIFYING ALL EXISTING CONDITIONS IN THE FIELD.

5. EXISTING DIMENSIONS, OFFSETS, INVERTS, RADII, ETC. SHALL BE VERIFIED IN THE FIELD PRIOR TO ANY CONSTRUCTION ACTIVITY. ANY DISCREPANCY SHALL BE IMMEDIATELY BROUGHT TO THE ATTENTION OF THE CLIENT FOR RESOLUTION. ALL NOTIFICATIONS SHALL BE IN WRITING.

6. ALL GRADING SHALL BE AS SHOWN ON THE PLANS. THE CONTRACTOR SHALL CAREFULLY DETERMINE ACTUAL GRADING LIMITS BEFORE BEGINNING DEMOLITION AND SITE CLEARING OPERATIONS. CARE SHALL BE TAKEN TO RETAIN EXISTING NATURAL GROWTH AND PREVENT DAMAGE TO TREES OUTSIDE THE PROJECT LIMITS. ANY DAMAGE CAUSED TO THIS NATURAL GROWTH SHALL BE RESTORED AT THE CONTRACTOR'S EXPENSE. ALL AREAS DISTURBED BY THE CONTRACTOR WITHOUT AUTHORIZATION BY THE CLIENT SHALL BE RESTORED BY THE CONTRACTOR AT HIS EXPENSE.

7. WHERE CONSTRUCTION CROSSES OR IS ADJACENT TO AN EXISTING ELECTRIC, GAS, COMMUNICATIONS, OR OTHER UTILITY LINE, THE CONTRACTOR SHALL CAREFULLY HAND EXCAVATE TO LOCATE, MARK AND PROTECT THE UTILITY LINE AGAINST DISTURBANCE OR DAMAGE BY PROVIDING ADEQUATE SUPPORT AND PROTECTION AS APPROVED BY THE CLIENT. THE CONTRACTOR SHALL REPAIR ANY ELECTRIC POWER INTERRUPTION

8. THE CONTRACTOR SHALL COORDINATE THE LOCATIONS OF TREES AND OTHER PLANTINGS AS TO NOT CONFLICT WITH DRAINAGE, INCLUDING

9. THE CONTRACTOR SHALL RESTORE ALL PUBLIC OR PRIVATE PROPERTY DAMAGED OR REMOVED TO AT LEAST AS GOOD A CONDITION AS BEFORE BEING DISTURBED, AS DETERMINED BY THE CLIENT. ANY DAMAGED TREES, SHRUBS, AND/OR HEDGES SHALL BE REPLACED AT THE CONTRACTOR'S EXPENSE. NO WORK SHALL BE PERFORMED ON OTHER PROPERTIES AND BUILDINGS WITHOUT THE PROPER AUTHORIZATION.

10. CONTRACTOR SHALL EXERCISE CARE TO MINIMIZE CLEARING. SPECIFIC TREES AND ITEMS TO BE CLEARED MUST BE APPROVED BY THE CLIENT

11. THE CONTRACTOR SHALL COMPLY WITH ALL REQUIRED PERMITS FROM LOCAL. STATE AND FEDERAL AGENCIES, AS REQUIRED, THE CONTRACTOR SHALL BE RESPONSIBLE FOR OBTAINING AND INCURRING THE COST OF ALL REQUIRED PERMITS, INSPECTIONS, CERTIFICATES, ETC,

12. THE CONTRACTOR SHALL PROTECT EXISTING SURVEYING AND PROPERTY LINE MONUMENTATION. ANY EXISTING SURVEYING AND PROPERTY LINE MONUMENTATION THAT IS DISTURBED OR DESTROYED, AS JUDGED BY THE NYCDEP, SHALL BE REPLACED AT THE CONTRACTOR'S EXPENSE UNDER

13. BEFORE PLANNING OR PROCEEDING WITH ANY EXCAVATION WORK, THE CONTRACTOR SHALL NOTIFY THE "CALL BEFORE YOU DIG" NUMBER AT 1-800-962-7962 A MINIMUM OF FIVE WORKING DAYS PRIOR TO ANY EXCAVATION OPERATIONS.

14. ALL TRENCH EXCAVATION AND ANY REQUIRED SHEETING AND SHORING SHALL BE DONE IN ACCORDANCE WITH THE LATEST REVISIONS OF NEW YORK STATE INDUSTRIAL CODE RULE 23 AND OSHA REGULATIONS FOR CONSTRUCTION AND IN ACCORDANCE WITH THE SPECIFICATIONS.

15. CONTRACTOR IS RESPONSIBLE FOR DEWATERING AND THE MAINTENANCE OF SURFACE DRAINAGE DURING THE COURSE OF WORK, IF REQUIRED, IN ACCORDANCE WITH THE SOIL EROSION AND SEDIMENTATION CONTROL PLANS AND DETAILS.

17. ALL CONFINED SPACE ENTRIES SHALL BE MADE IN STRICT ACCORDANCE WITH OSHA REGULATIONS REGARDING CONFINED SPACE ENTRY.

18. ALL WORK SHALL BE DONE IN STRICT COMPLIANCE WITH ALL APPLICABLE NYSDOT AND NYCDOT SPECIFICATIONS, AS THEY MAY APPLY.

19. CONTRACTOR SHALL MAINTAIN PEDESTRIAN AND VEHICLE ACCESS TO THE SITE AT ALL TIMES IN A MANNER ACCEPTABLE TO THE CLIENT

20. CONTRACTOR SHALL TAKE GREAT CARE TO MAINTAIN A SAFE AND SECURE WORK AREA AT ALL TIMES THROUGH THE USE OF BARRICADES AND

21. THE CONTRACTOR SHALL COMPLY WITH THE CONDITIONS AS SET FORTH IN THE PERMITS ISSUED BY THE REGULATORY AGENCIES, IF ANY. 22. PROVIDE SPECIAL INSPECTIONS AS FOLLOWS AS PER TOWN OF MOUNT PLEASANT BUILDING DEPARTMENT REQUIREMENTS, SPECIFICATIONS AND

23. IT IS THE CONTRACTOR'S RESPONSIBILITY TO SUBMIT AND OBTAIN THE NECESSARY PERMITS FROM ALL APPLICABLE AGENCIES, EXCEPT FOR NYSDEC, SITE PLAN, & SPECIAL USE PERMIT. ALL COMMENTS RESULTING FROM A REVIEW BY SAID AGENCIES SHALL BE ADDRESSED BY THE

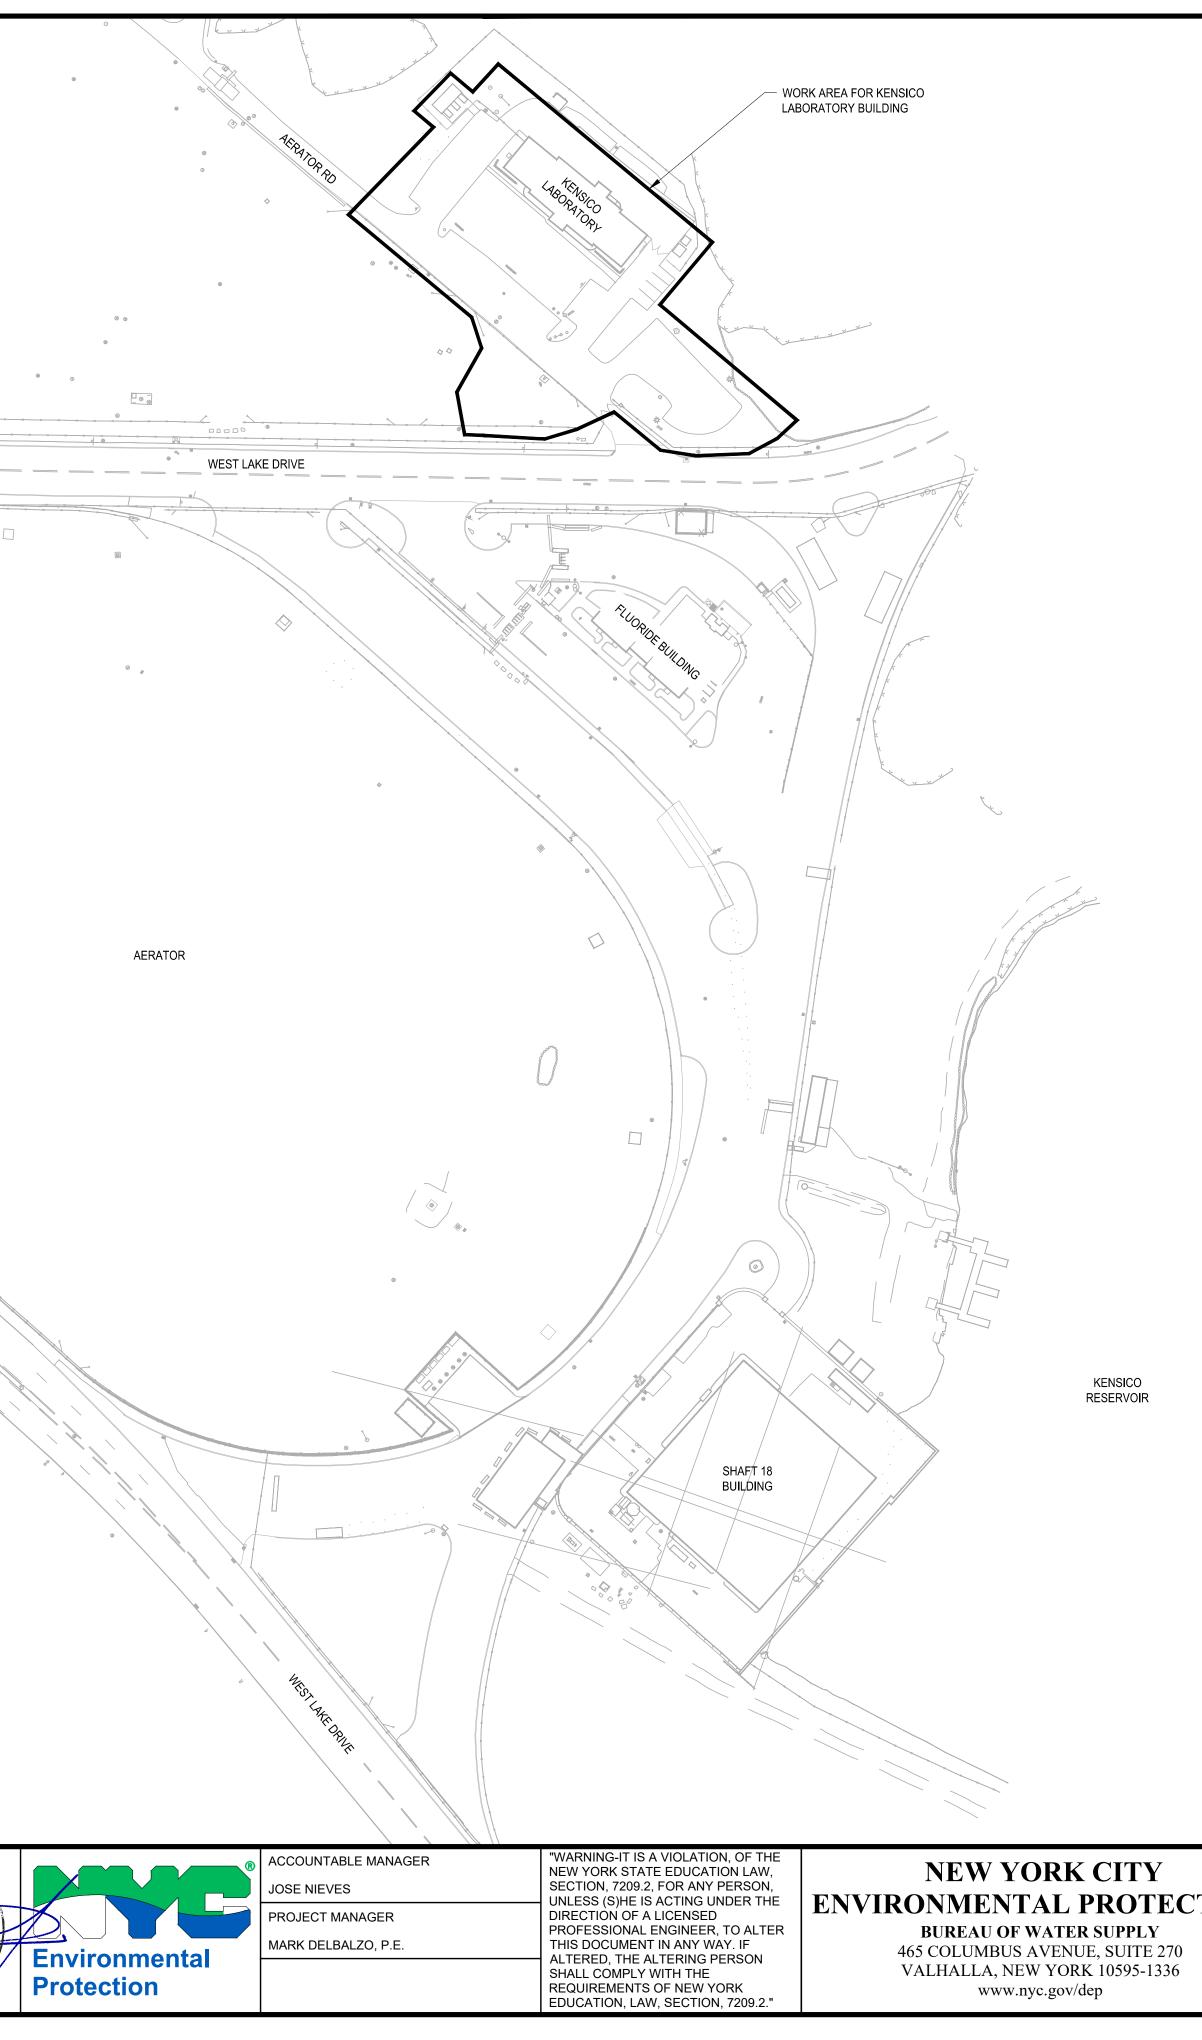
24. HORIZONTAL DATUM IS NAD-83 NEW YORK EAST ZONE 3101. VERTICAL DATUM IS NAVD 88, EXPRESSED IN US FEET.

25. THE CONTRACTOR SHALL DO TEST PIT FOR UTILITY CONFLICTS PRIOR TO CONSTRICTION ACTIVITIES.


26. IF CONTRACTOR IDENTIFIES A BLACK TAR-LIKE MATERIAL NEAR THE EXISTING BUILDING DURING EXCAVATION IT SHALL BE CONSIDERED PRESUMED ASBESTOS-CONTAINING. REFER TO SPECIFICATIONS 01355 AND 13281 FOR TESTING AND DISPOSAL REQUIREMENTS.


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TION	REPURPOSING OF KENSICO LA THE KENSICO REGIONAL HEA MOUNT PLEASANT, NEW CONTRACT CRO-62	DQUARTERS V YORK	DATE: MAY 2023 SCALE: NA SHEET NO: 4 OF No.121
	CIVIL GENERAL NOTES, LEGEND, AND ABBREVIATIONS		drawing no.


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		COLUMBUS AVENUE	



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	BID SET IF SHEET IS LESS THAN 22" X 34 IT IS A REDUCED PRINT. SCALE ACCORDINGLY				
	REPURPOSING OF KENSICO LA	BORATORY AS	DATE: MAY 2023		
	THE KENSICO REGIONAL HEA	SCALE: 1" = 80'			
TION	MOUNT PLEASANT, NEV	SHEET NO:			
	CONTRACT CRO-62	5 OF No.121			
	CIVIL		DRAWING NO.		
	LOCATION PLAN		C-100		

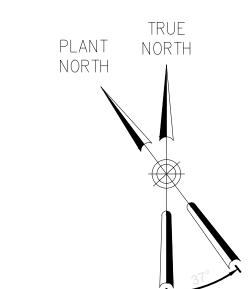

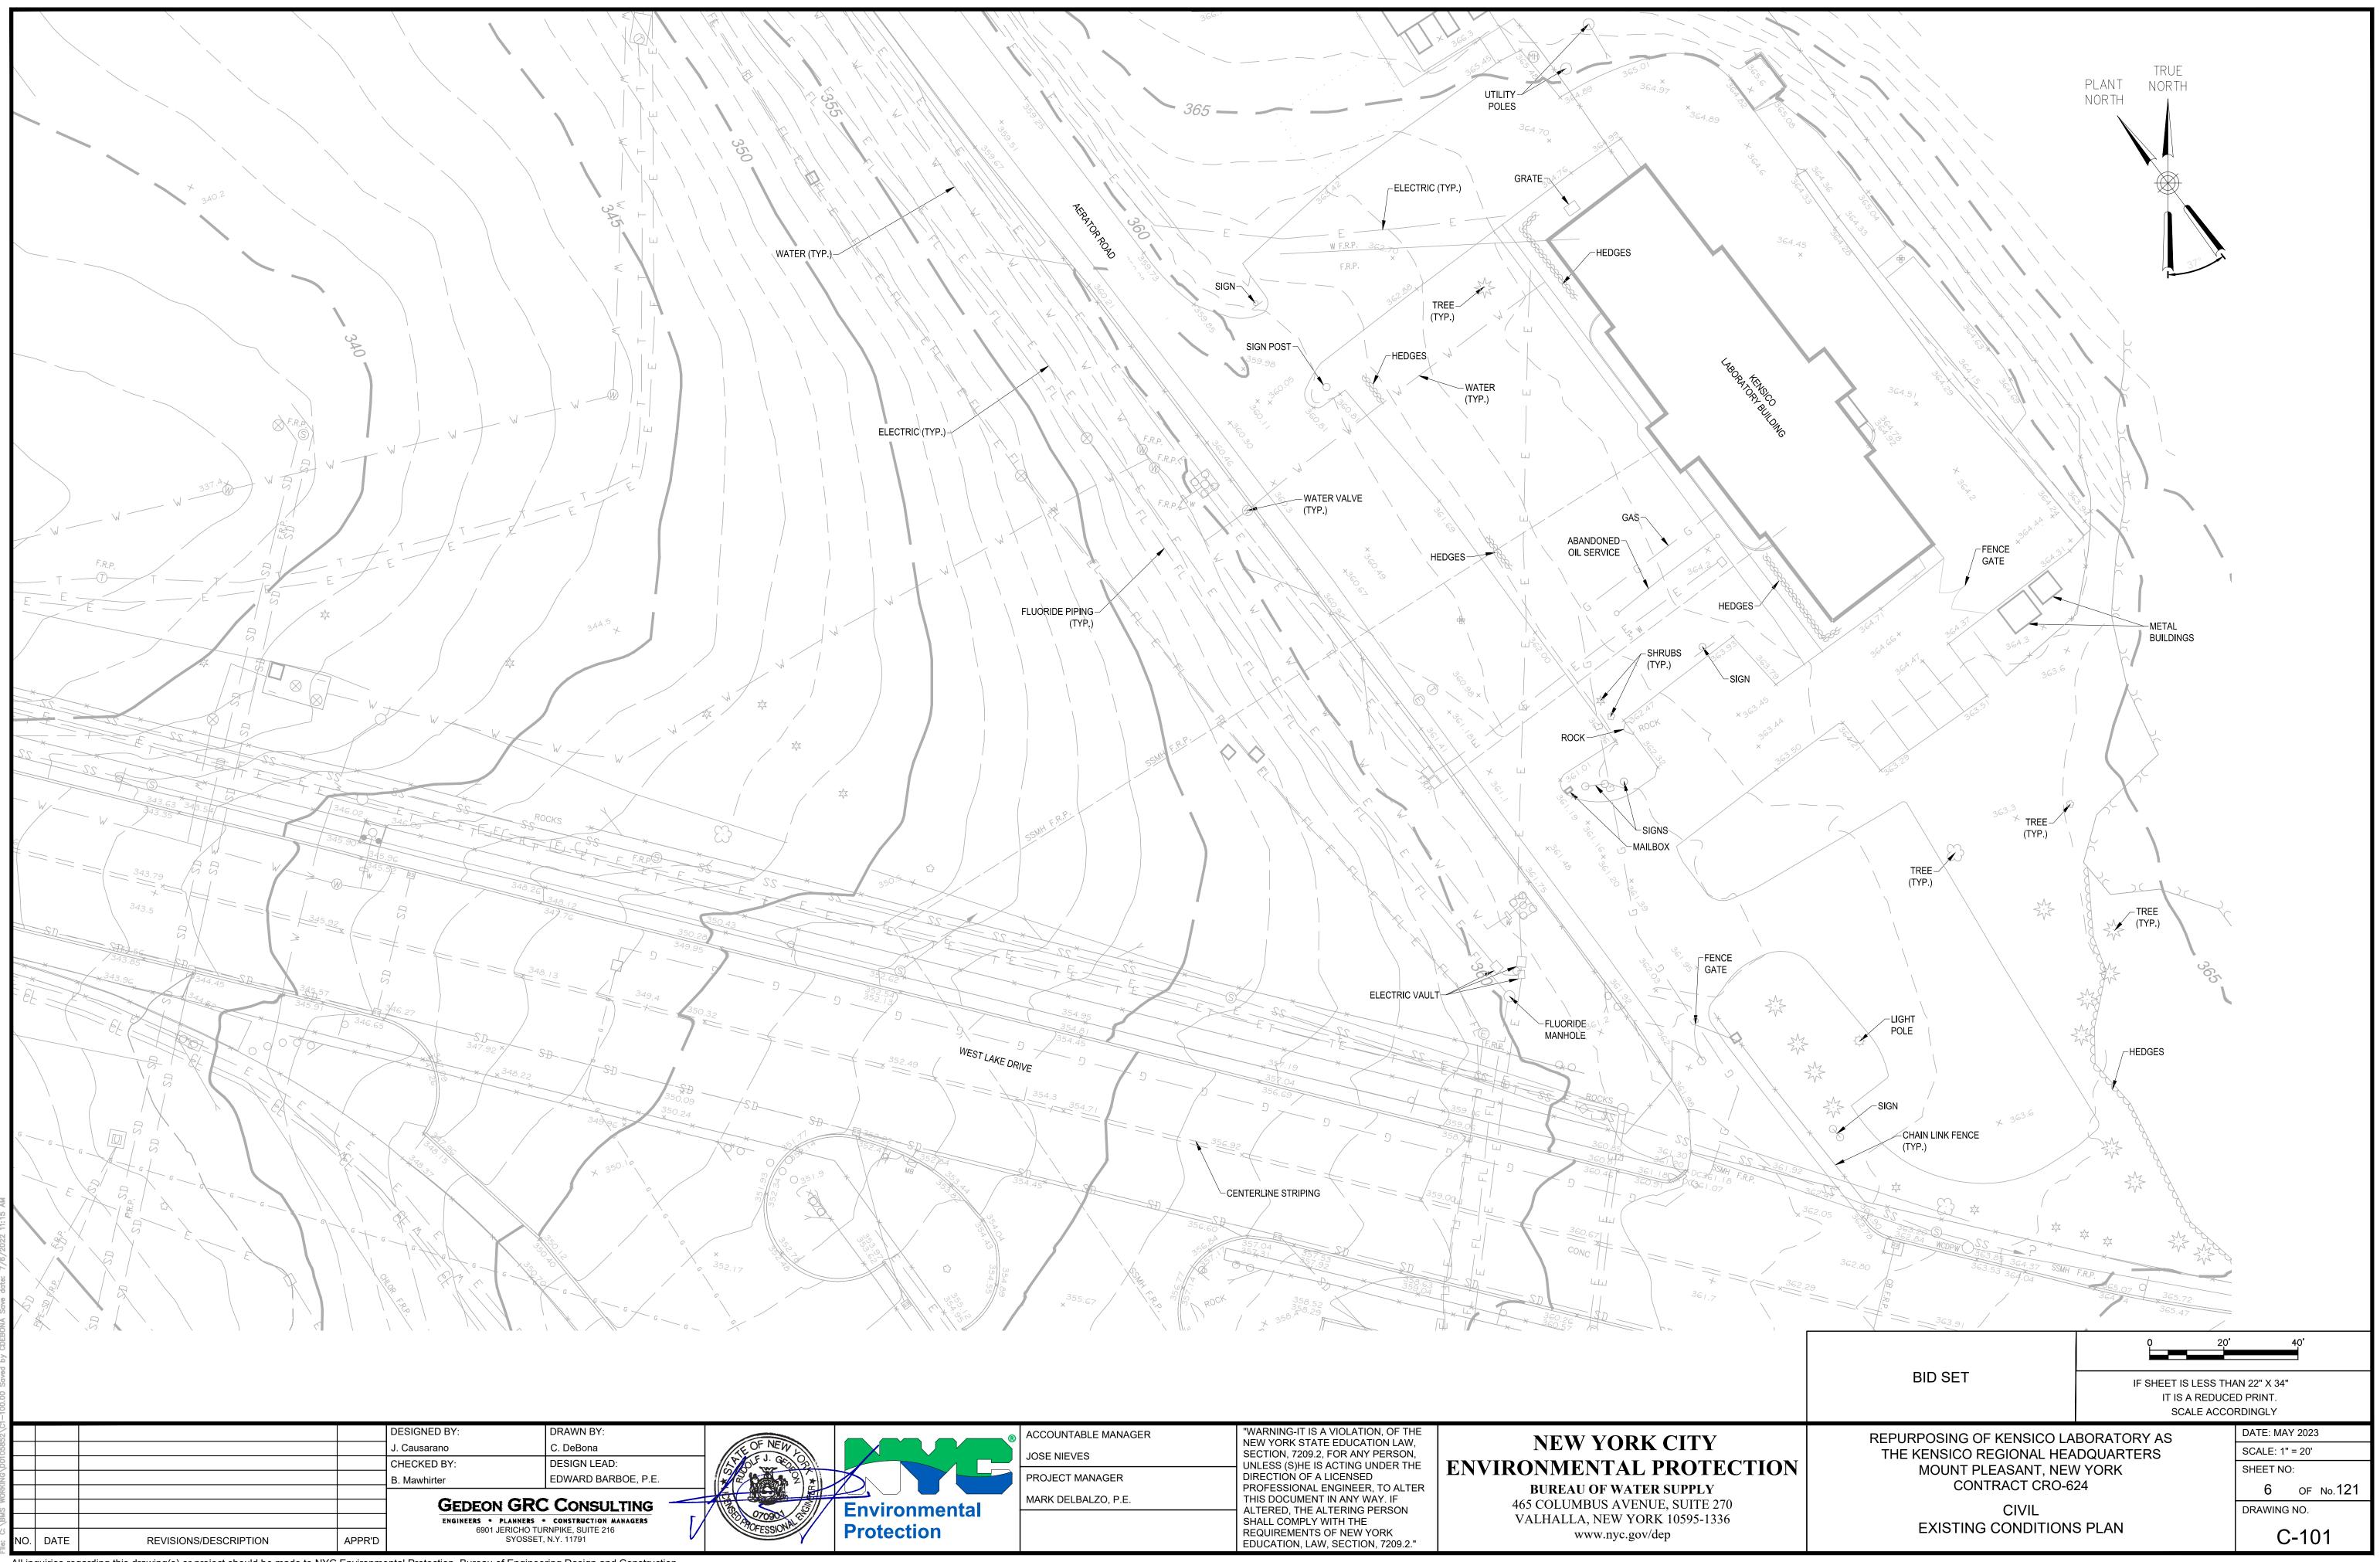

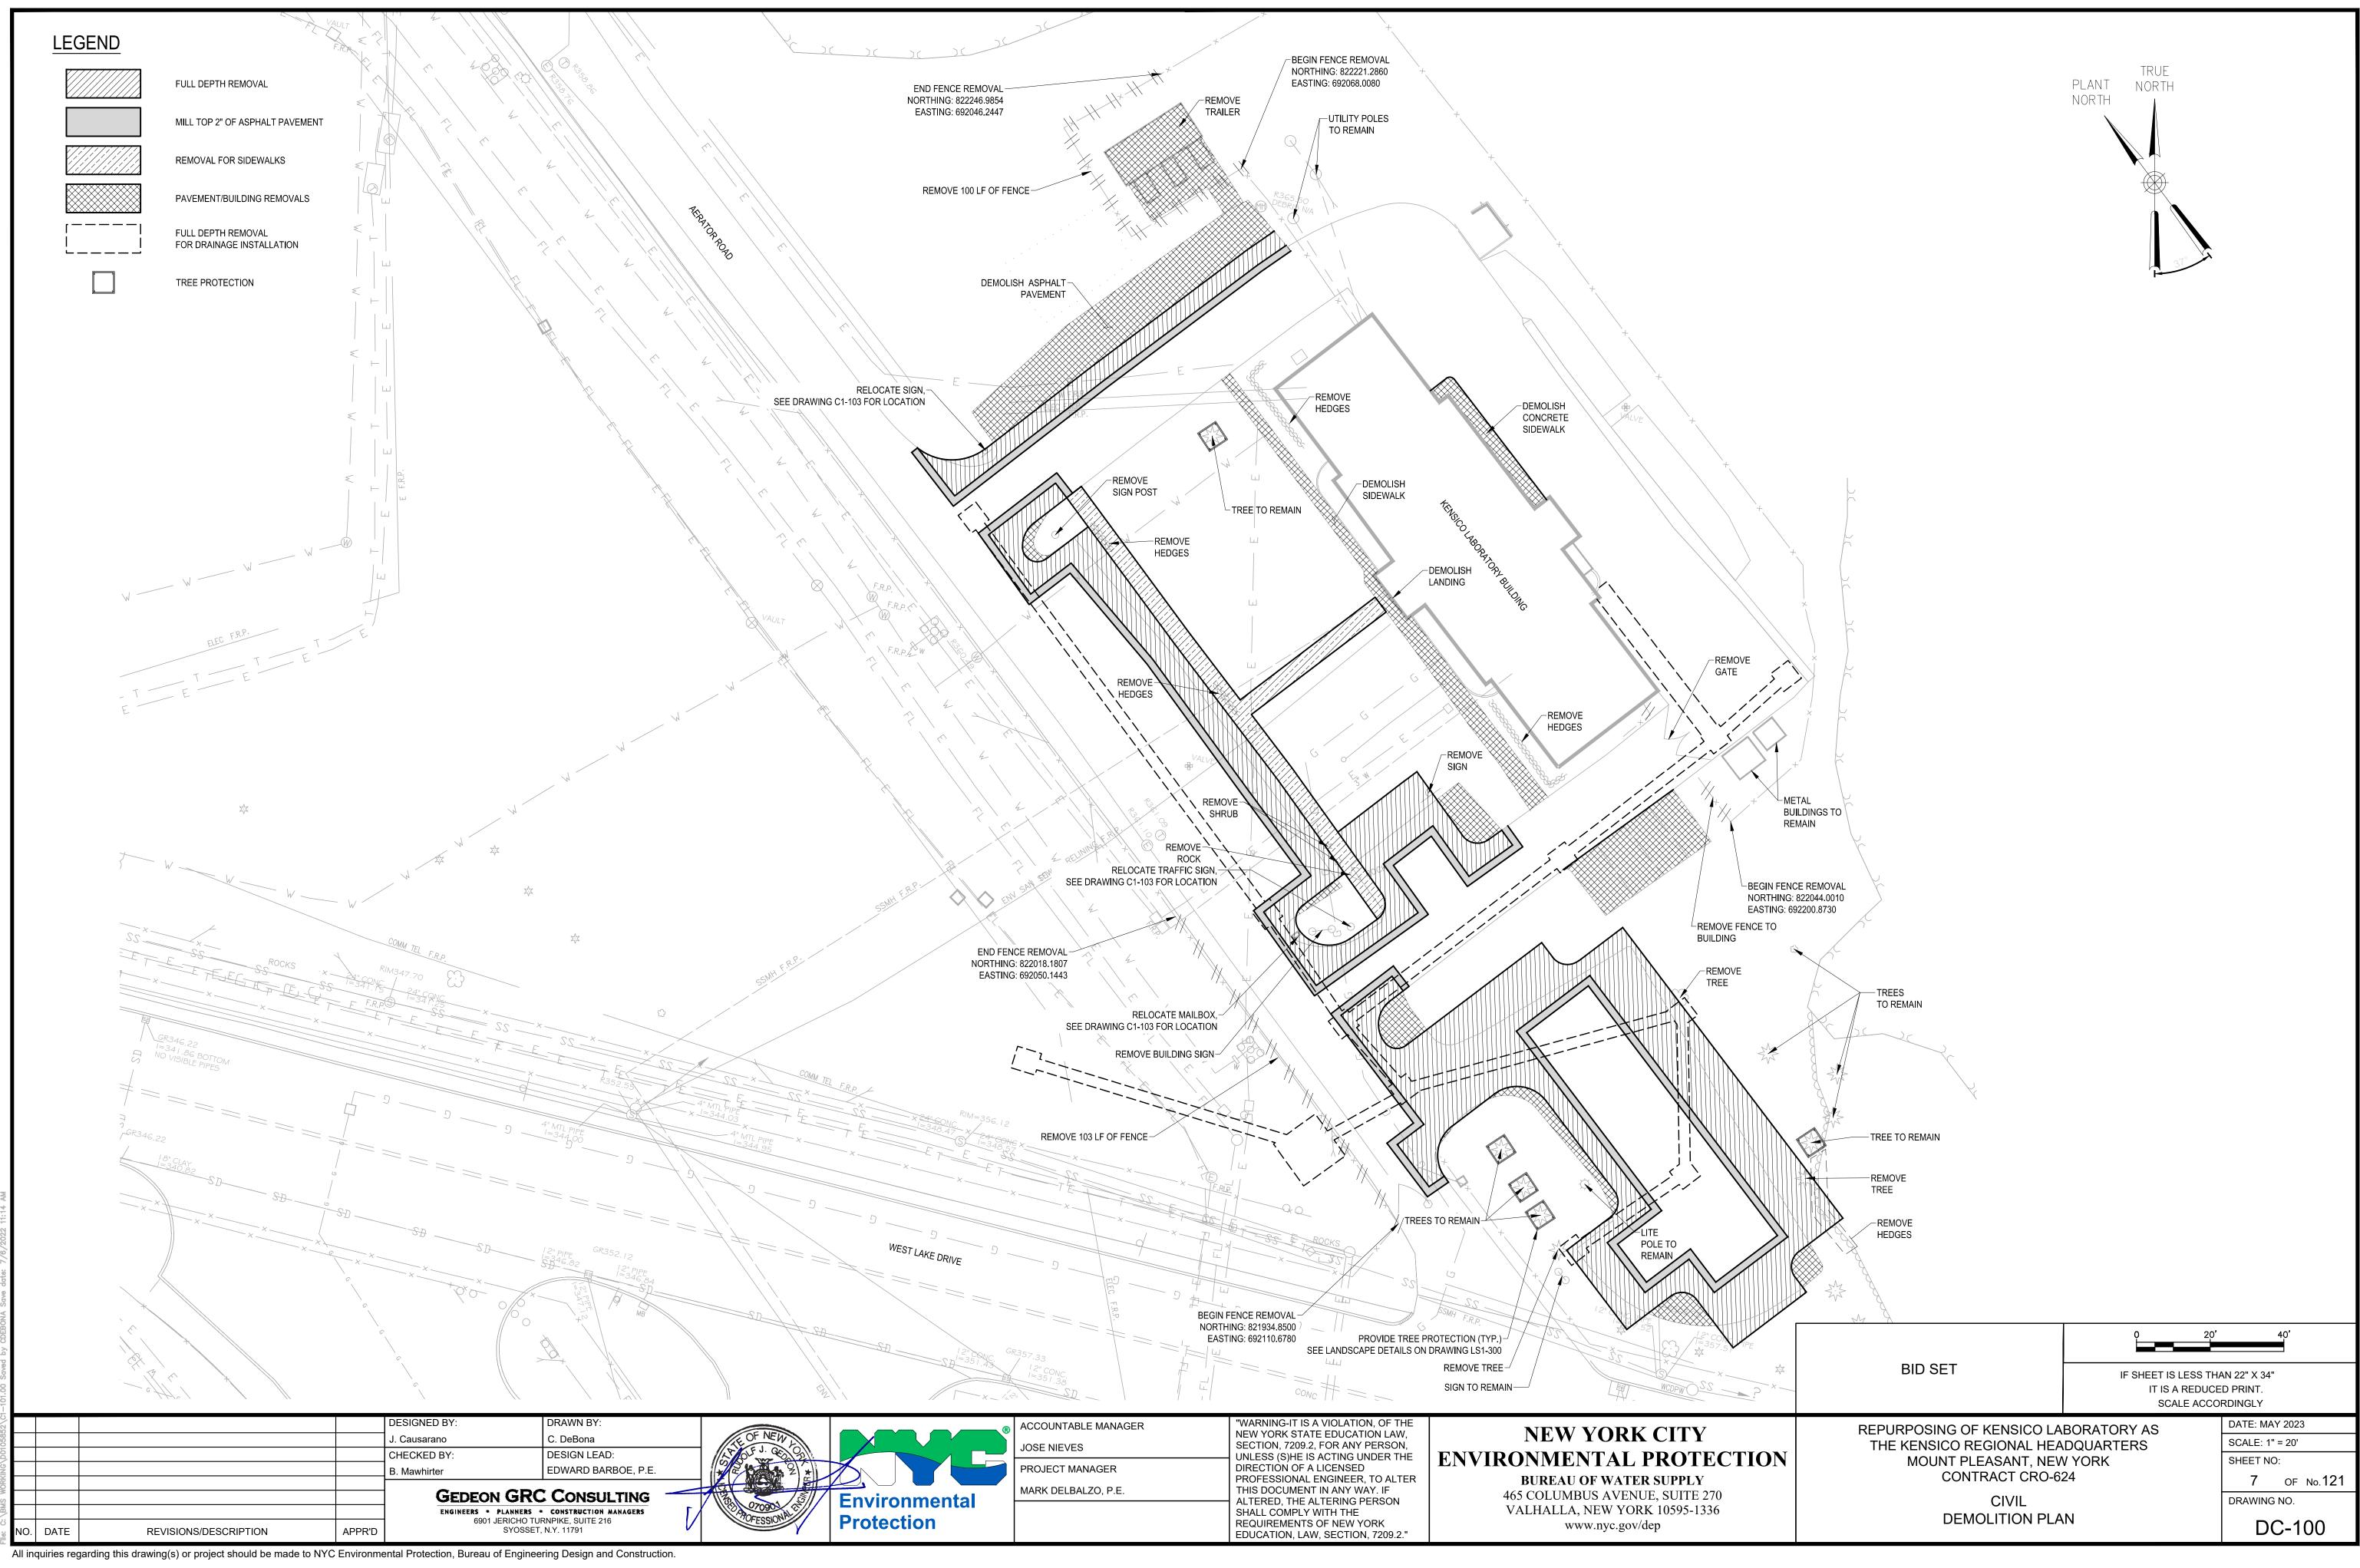

		ISTRUCTION AND DEMOLITION PHASES REQUIRED BY THIS CONTRACT, IT IS ANTICIPATED THAT THE LOCATION AND NATURE OF
	CONSTRUC REQUIRED F REVISED AT	ID SEDIMENT CONTROL MEASURES WILL BE ADJUSTED AS REQUIRED TO REFLECT THE CURRENT PHASE OF WORK. THE FION SCHEDULE ADOPTED BY THE CONTRACTOR WILL IMPACT ON THE PLACEMENT AND NEED FOR SPECIFIC DEVICES FOR THE CONTROL OF EROSION. THE LOCATION AND EXTENT OF EROSION AND SEDIMENT CONTROL MEASURES SHALL BE EACH PHASE OF CONSTRUCTION THAT RESULTS IN A CHANGE OF EITHER THE QUANTITY OR DIRECTION OF THE SURFACE OM THE CONSTRUCTION AREAS.
	INSTALLED A SILT FENCIN A PARTICUL	UCTION OR LAND DISTURBANCE ACTIVITY MAY BEGIN UNTIL ALL PERIMETER EROSION CONTROL MEASURES HAVE BEEN AS SHOWN ON THE CONTRACT DRAWINGS. MEASURES SHALL INCLUDE BUT NOT LIMITED TO TEMPORARY DIVERSION SWALES, IG, CATCH BASIN PROTECTION AND STABILIZED CONSTRUCTION ENTRANCE. IF CLEARING IS REQUIRED FOR INSTALLATION OF AR MEASURE, ALL MEASURES NOT REQUIRING CLEARING SHALL BE INSTALLED FIRST. CLEARING OF THE NECESSARY LAND LATION OF THE PARTICULAR MEASURE MAY THEN PROCEED.
		N CONTROL MEASURES SHALL BE IN PLACE BEFORE OR AS SOON AS PRACTICABLE AFTER ANY LAND CLEARING OR FION ACTIVITY.
		ND PAVEMENT DEMOLITION SHALL BE LIMITED AS MUCH AS POSSIBLE TO AREAS REQUIRED FOR CURRENT CONSTRUCTION MASS CLEARING, GRADING AND PAVEMENT DEMOLITION SHALL BE AVOIDED.
	TRAVERSED VEHICLES V IMMEDIATEL	OF CONSTRUCTION INGRESS AND EGRESS SHALL BE PROTECTED TO PREVENT THE DEPOSITION OF MATERIALS ONTO PUBLIC THOROUGHFARE(S) BY INSTALLING AND MAINTAINING A STABILIZED CONSTRUCTION ENTRANCE AND BY WASHING ALL /HEELS IN A SAFE DISPOSAL AREA. ALL MATERIALS DEPOSITED ONTO PUBLIC THOROUGHFARE(S) SHALL BE REMOVED Y. PROPER PRECAUTIONS SHALL BE TAKEN TO ENSURE THAT MATERIALS DEPOSITED ONTO PUBLIC THOROUGHFARE(S) ARE O THAT THEY DO NOT ENTER CATCH BASINS, STORM SEWERS, COMBINED SEWERS OR ROADSIDE SWALES.
	ALL EROSIC	N CONTROL MEASURES SHALL BE INSPECTED FOLLOWING EVERY RAINFALL, BUT IN NO CASE LESS THAN ONCE EVERY WEEK.
		EASURES SHALL BE REPAIRED OR REPLACED IMMEDIATELY AS REQUIRED_TO MAINTAIN PERFORMANCE OF MEASURE. EDIMENTS SHALL BE DISPOSED OF IN SUCH A MANNER AS TO ENSURE FURTHER SEDIMENT TRANSPORT DOES NOT OCCUR.
	CONSTRUC	ACTOR SHALL INITIATE STABILIZATION MEASURES AS SOON AS PRACTICABLE IN PORTIONS OF THE SITE WHERE FION ACTIVITIES HAVE TEMPORARILY OR PERMANENTLY CEASED, BUT IN NO CASE MORE THAN 7 DAYS AFTER THE FION ACTIVITY IN THAT PORTION OF THE SITE HAS TEMPORARILY OR PERMANENTLY CEASED. THIS REQUIREMENT DOES NOT IE FOLLOWING INSTANCES:
	A.	THE INITIATION OF STABILIZATION MEASURES BY THE 7TH DAY AFTER CONSTRUCTION ACTIVITY TEMPORARILY OR PERMANENTLY CEASED IS PRECLUDED BY SNOW COVER OR FROZEN GROUND CONDITIONS, STABILIZATION MEASURES SHALL BE INITIATED AS SOON AS PRACTICABLE.
	В.	WHERE CONSTRUCTION ACTIVITY ON A PORTION OF THE SITE IS TEMPORARILY CEASED, AND EARTH-DISTURBING ACTIVITIES WILL BE RESUMED WITHIN FOURTEEN (14) DAYS, TEMPORARY STABILIZATION MEASURES NEED NOT BE INITIATED ON THAT PORTION OF THE SITE.
		SHALL BE FERTILIZED, SEEDED AND MULCHED IN ACCORDANCE WITH THE SPECIFICATIONS, AND RE-SEEDED AS NECESSARY TO AND MAINTAIN A VIGOROUS DENSE VEGETATIVE COVER.
ı.		PERFORMED SHALL BE IN ACCORDANCE WITH THE "NEW YORK STANDARDS AND SPECIFICATIONS FOR EROSION AND SEDIMENT 1016, OR LATEST EDITION AND IN ACCORDANCE WITH THE CONTRACT DOCUMENTS.
-	THE CONTR	ACTOR SHALL TEMPORARILY REMOVE AND REPLACE REQUIRED SECTION OF FENCE DURING PROXIMITY EXCAVATION.
•	THE CONTR	ACTOR SHALL PROVIDE EROSION CONTROL PROTECTION AGAINST SILT ACCUMULATION ON EXISTING DRAINAGE.
-		ACTOR SHALL PROVIDE ADJUSTABLE CATCH BASIN DRAIN INSERTS ON THE AFFECTED CATCH BASIN SHOWN ON THE DRAWING ECTED BY THE ENGINEER.
•		O OR DISTURBED AREAS INCLUDING SLOPES SHALL BE PROTECTED DURING CLEARING AND CONSTRUCTION IN ACCORDANCE PPROVED EROSION AND SEDIMENT CONTROL PLAN UNTIL THEY ARE PERMANENTLY STABILIZED.
•		NT CONTROL PRACTICES AND MEASURES SHALL BE CONSTRUCTED, APPLIED AND MAINTAINED IN ACCORDANCE WITH THE EROSION AND SEDIMENT CONTROL PLAN.
•		QUIRED FOR THE ESTABLISHMENT OF VEGETATION SHALL BE STOCKPILED IN AMOUNT NECESSARY TO COMPLETE FINISHED
•		E FILLED SHALL BE CLEARED, GRUBBED, AND STRIPPED OF TOPSOIL TO REMOVE TREES, VEGETATION, ROOTS OR OTHER ABLE MATERIAL.
-	AREAS WHI	CH ARE TO BE TOPSOILED SHALL BE SCARIFIED TO A MINIMUM DEPTH OF FOUR INCHES PRIOR TO PLACEMENT OF TOPSOIL.
	PROBLEMS.	HALL BE COMPACTED AS REQUIRED TO REDUCE EROSION, SLIPPAGE, SETTLEMENT, SUBSIDENCE OR OTHER RELATED FILL INTENDED TO SUPPORT BUILDINGS, STRUCTURES AND CONDUITS, ETC. SHALL BE COMPACTED IN ACCORDANCE WITH IONS, LOCAL REQUIREMENTS OR CODES.
).		ALL BE PLACED AND COMPACTED IN LAYERS NOT TO EXCEED 9 INCHES IN THICKNESS.
•		AL SHALL BE FREE OF FROZEN PARTICLES, BRUSH, ROOTS, SOD, OR OTHER FOREIGN OR OTHER OBJECTIONABLE MATERIALS D INTERFERE WITH OR PREVENT CONSTRUCTION OF SATISFACTORY FILLS.
	FROZEN MA	TERIALS OR SOFT, MUCKY OR HIGHLY COMPRESSIBLE MATERIALS SHALL NOT BE INCORPORATED IN FILLS.
•	FILL SHALL	NOT BE PLACED ON SATURATED OR FROZEN SURFACES.
	ALL GRADE	BENCHES SHALL BE KEPT FREE OF SEDIMENT DURING ALL PHASES OF DEVELOPMENT.
•		PRINGS ENCOUNTERED DURING CONSTRUCTION SHALL BE HANDLED IN ACCORDANCE WITH THE STANDARD AND ION FOR SUBSURFACE DRAIN OR OTHER APPROVED METHOD.
j.	ALL GRADE	O AREAS SHALL BE PERMANENTLY STABILIZED IMMEDIATELY FOLLOWING FINISHED GRADING.
<b>'</b> .		S, BORROW AREAS AND SPOIL AREAS SHALL BE SHOWN ON THE PLANS AND SHALL BE SUBJECT TO THE PROVISIONS OF ANDARDS AND SPECIFICATIONS.

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DRKING/DOTOFARS/C1-102 00 Saved h
WORKING/ DOTOFASS/ C1-102 00 Saved h
WORKING/ DOTOFASS/ C1-102 00 Saved h
WORKING/ DOTOFASS/ C1-102 00 Saved h
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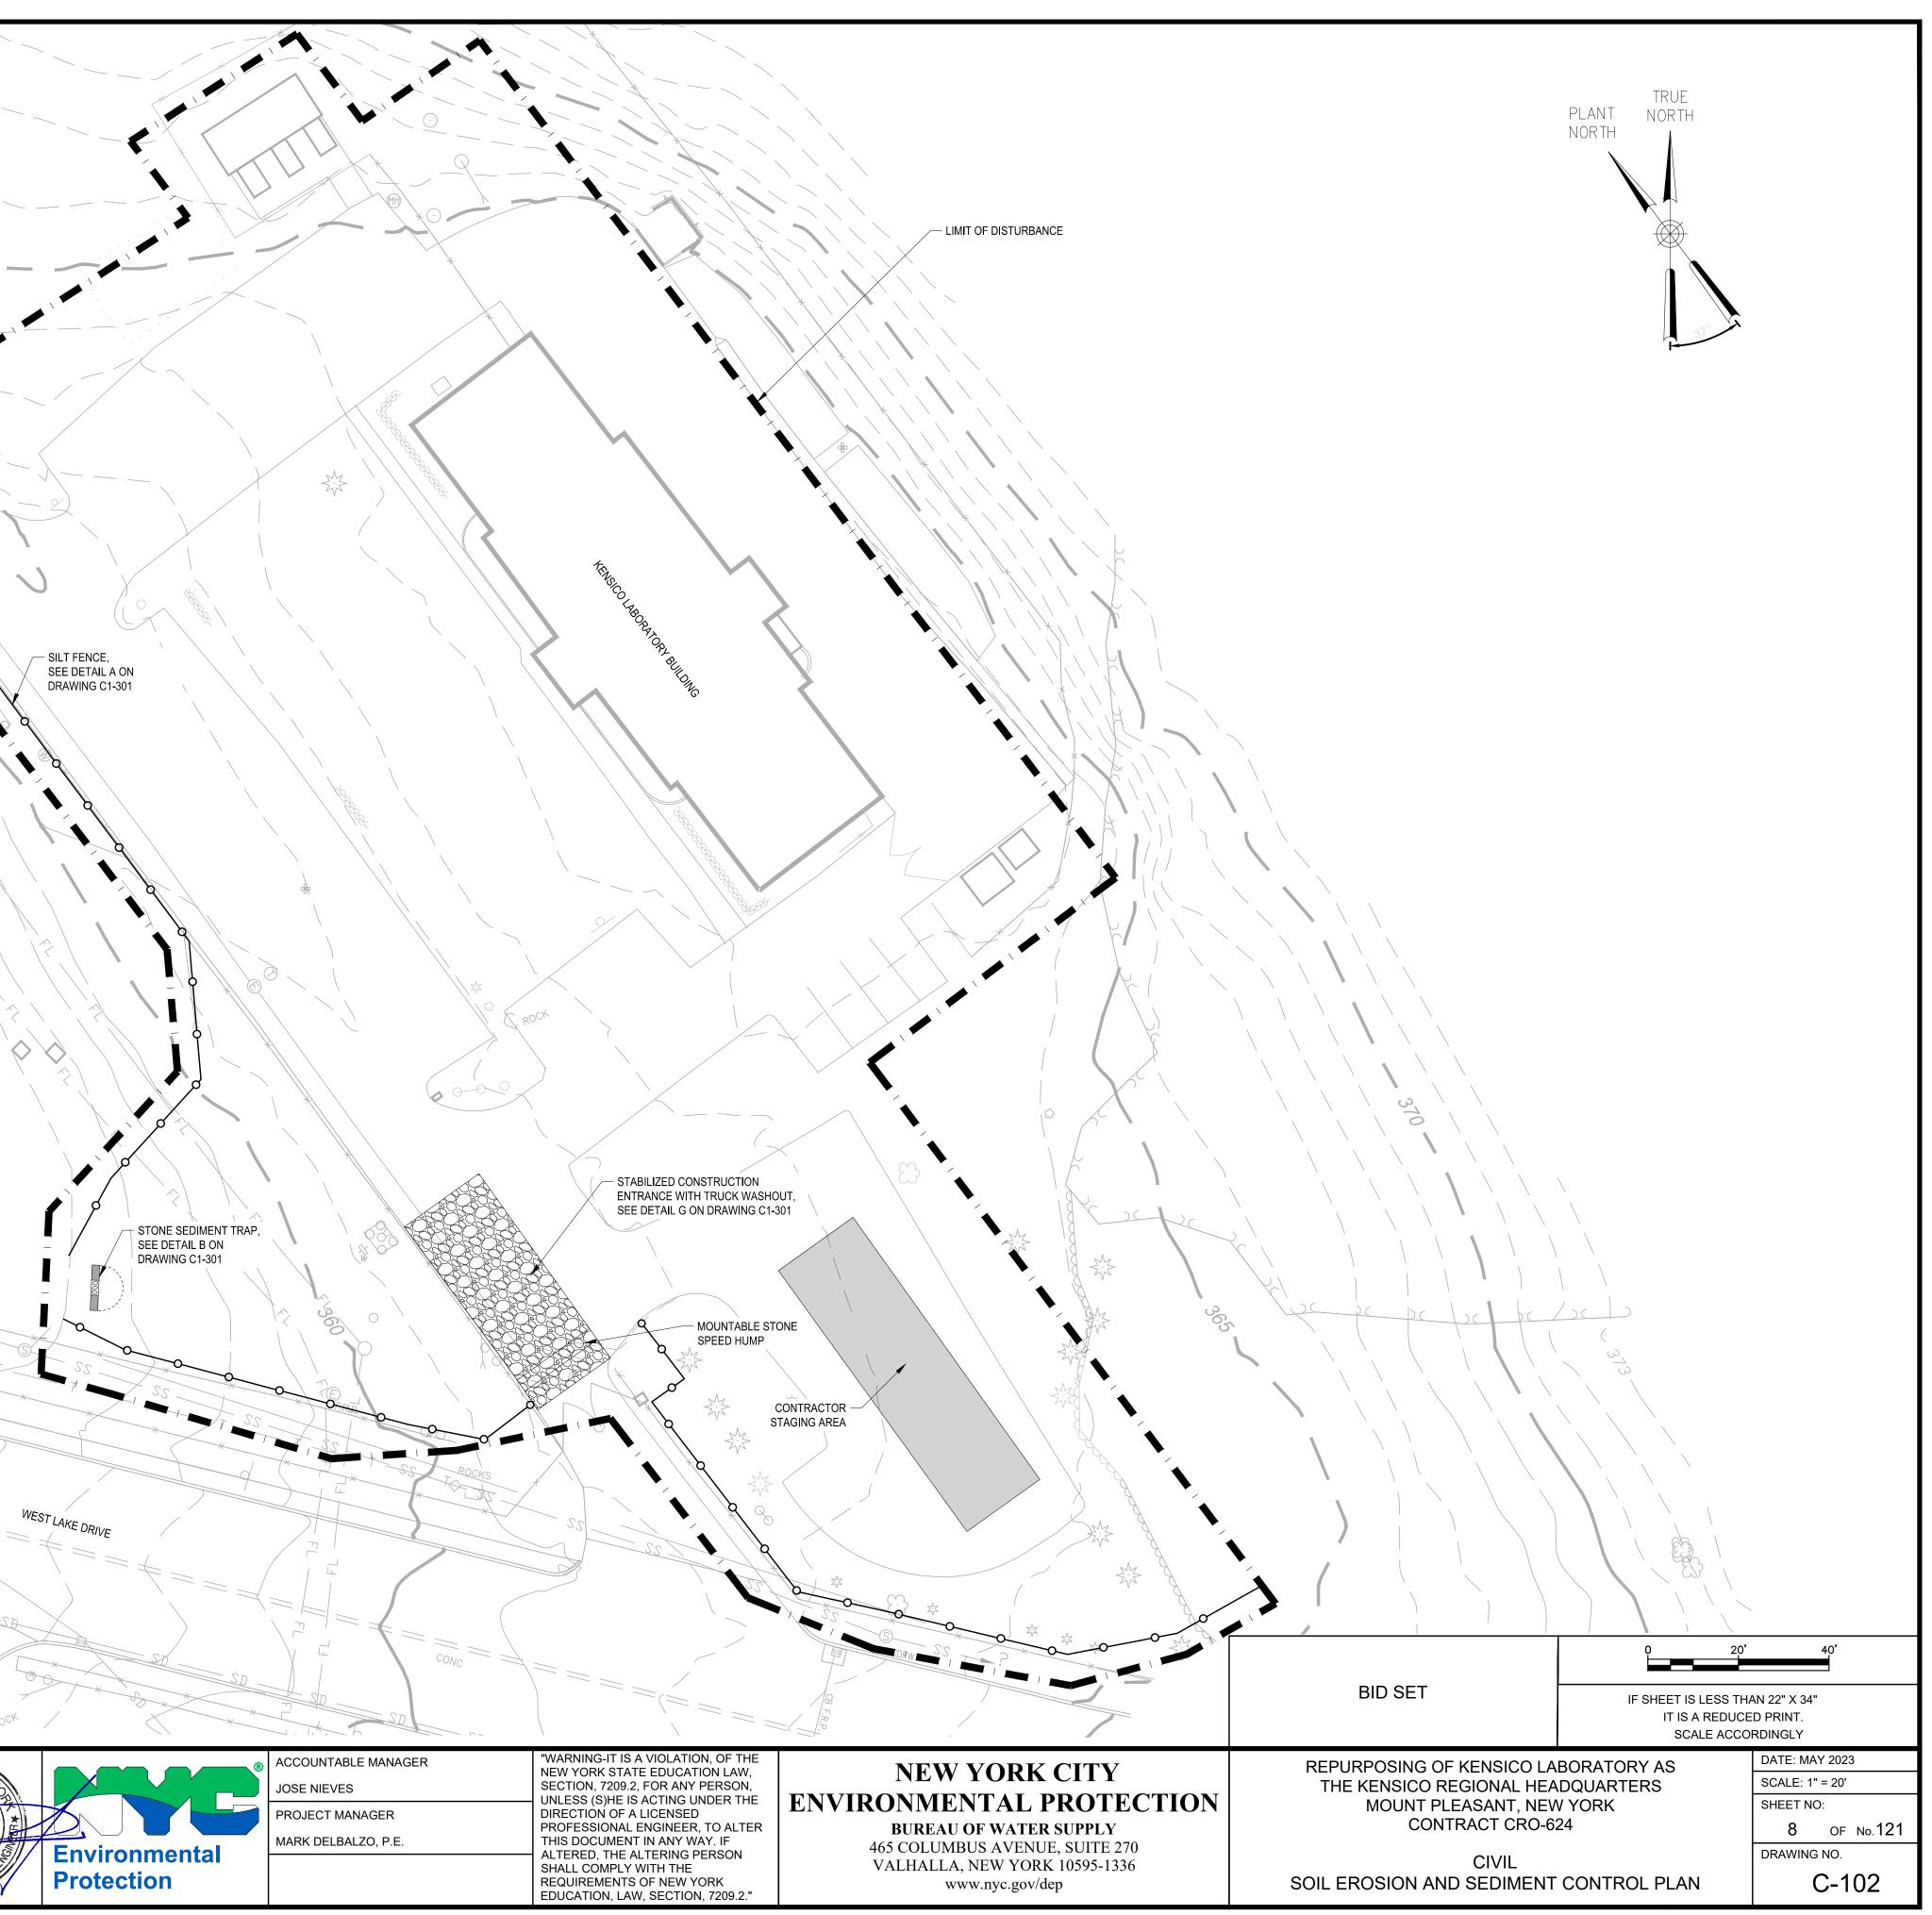
LIMIT OF DISTURBANCE

SEDIMENT TRAP


STABILIZED CONSTRUCTION ENTRANCE WITH TRUCK WASHOUT 


CONTRACTOR STAGING AREA

L								
					DESIGNED BY:	DRAWN BY:		
I					J. Causarano	C. DeBona		LE OF NEW
					CHECKED BY:	DESIGN LEAD:		LT OF J. CE OF
					B. Mawhirter	EDWARD BARBOE, P.E.		* 2 2 *
					<b>6</b>			
					GEDEO	N GRC CONSULTING		30 07000
						PLANNERS • CONSTRUCTION MANAGERS JERICHO TURNPIKE, SUITE 216	- F/	POFFEELINA
	NO.	DATE	REVISIONS/DESCRIPTION	APPR'D	0901	SYOSSET, N.Y. 11791	V	123310



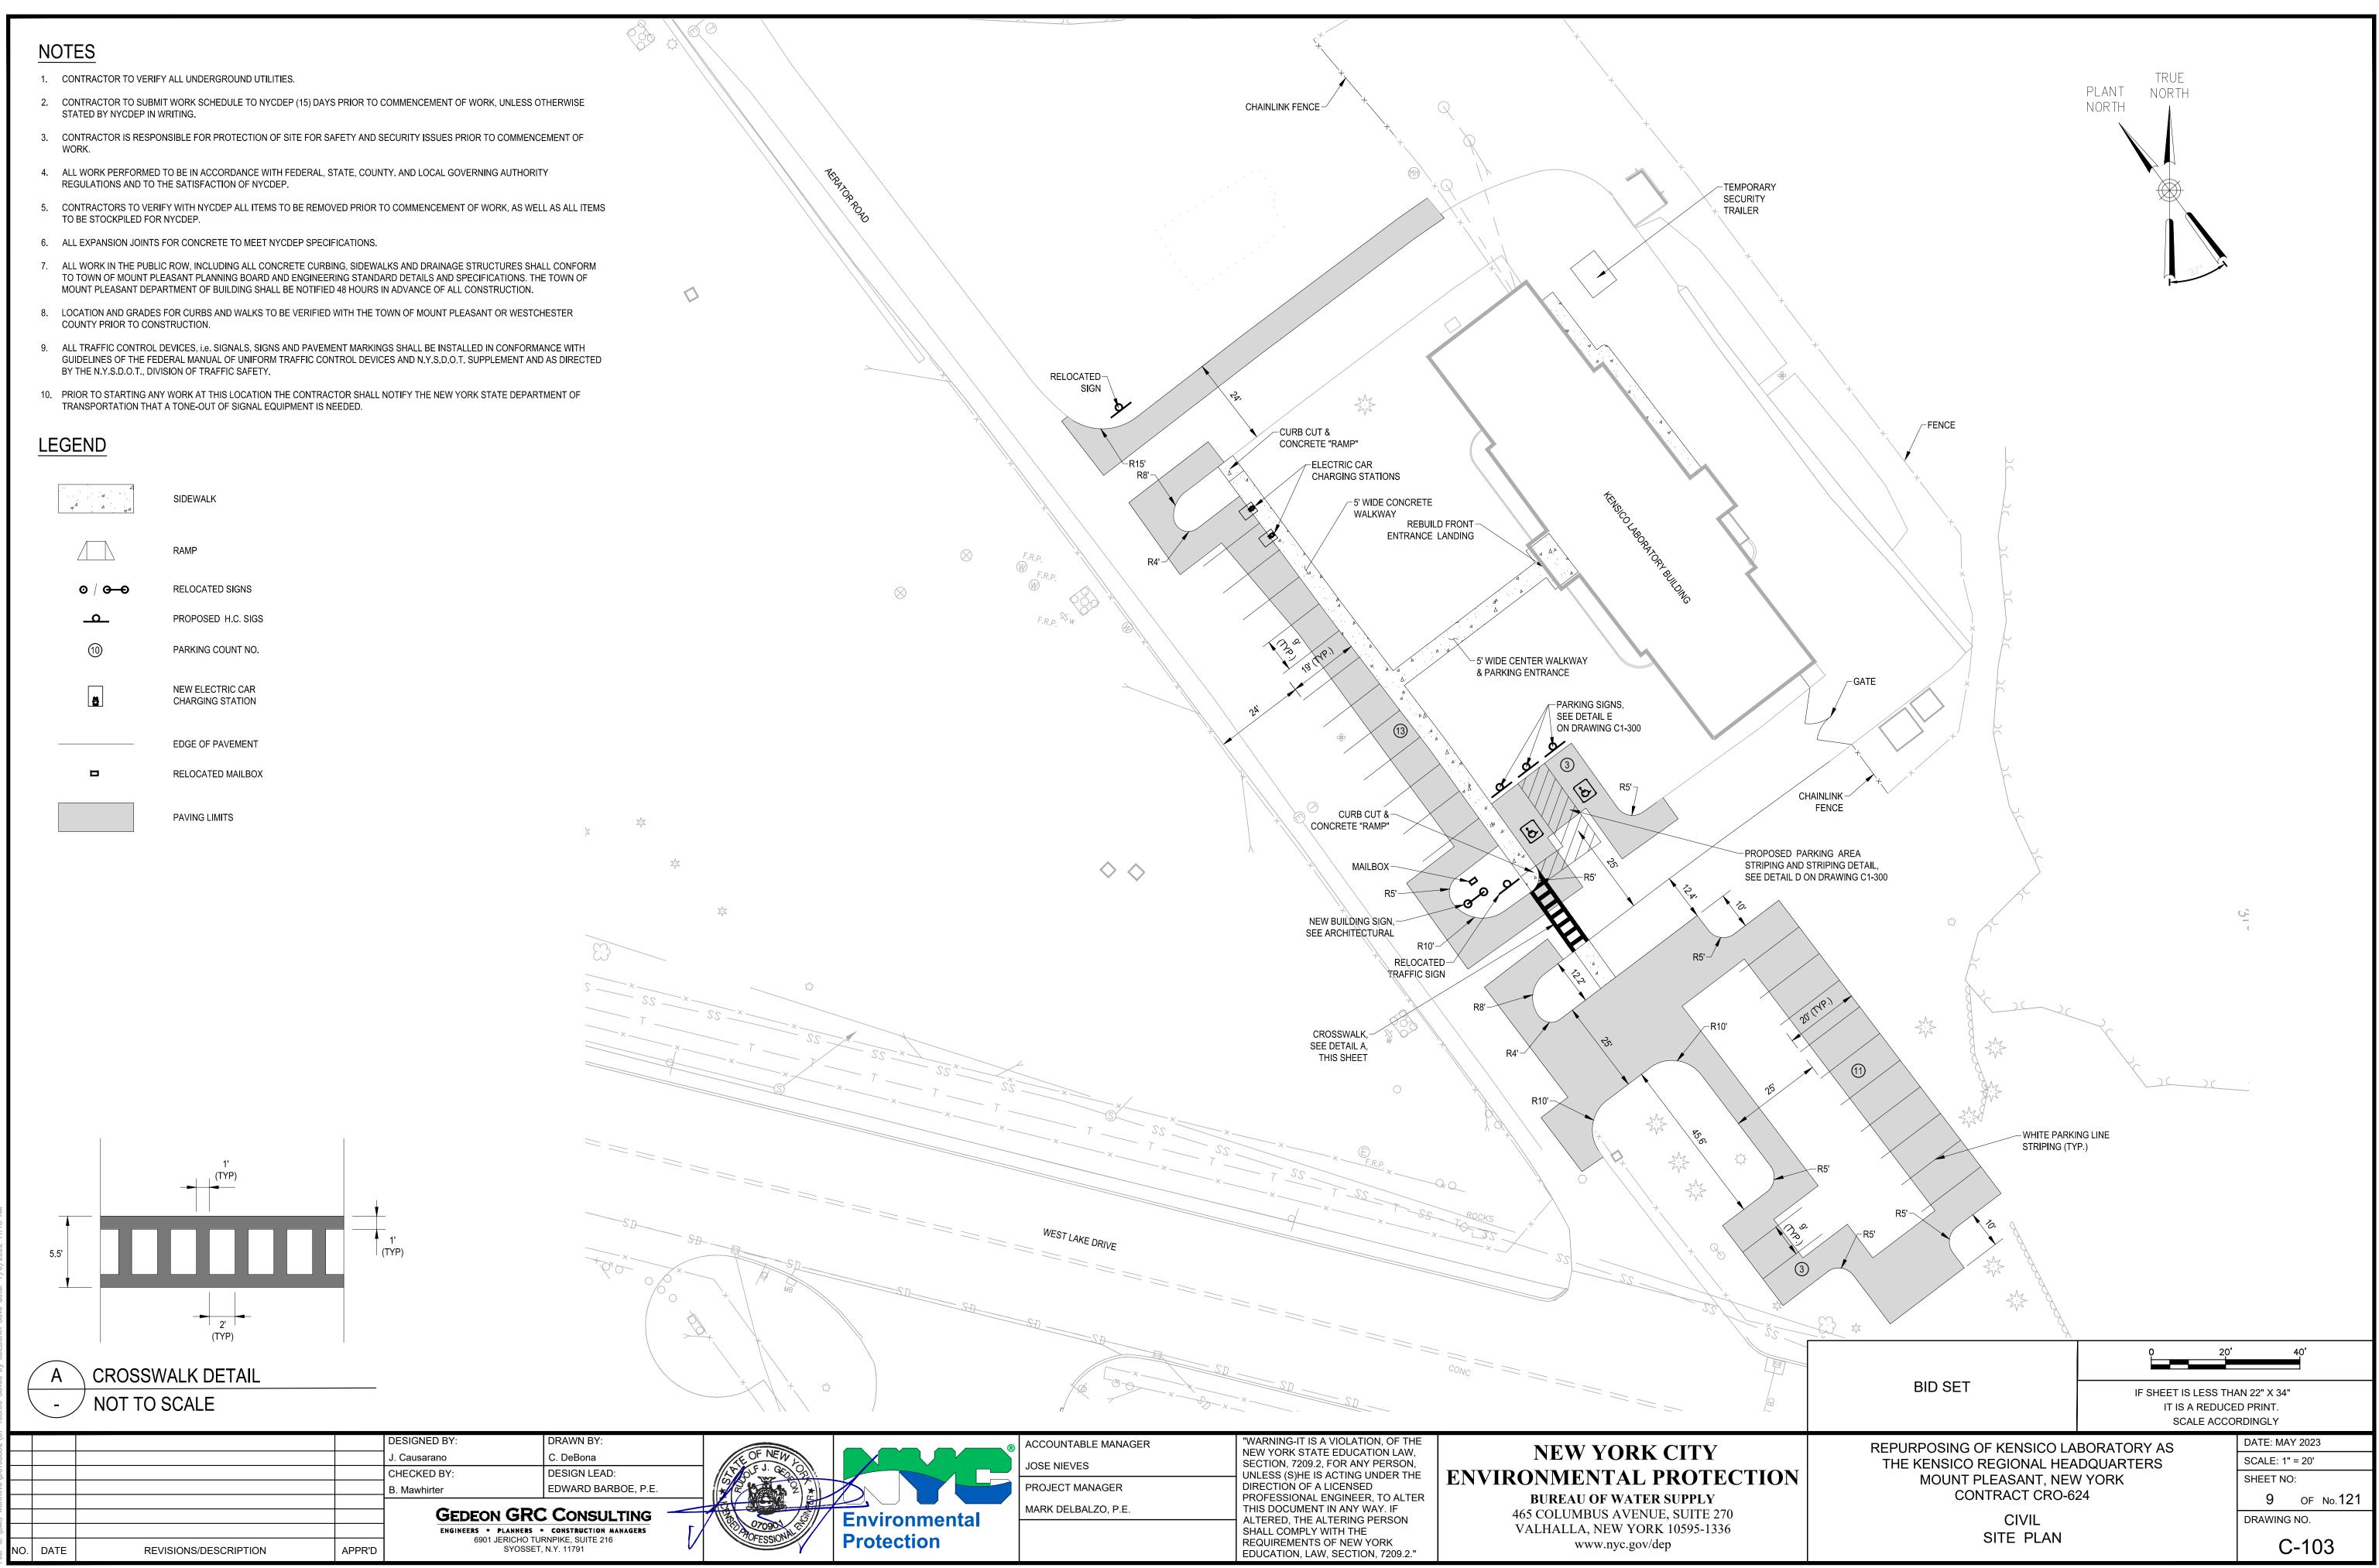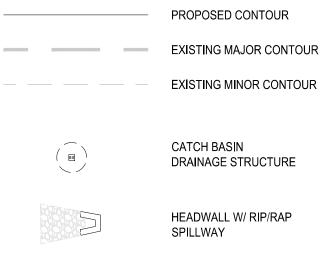- STATED BY NYCDEP IN WRITING.
- WORK.
- REGULATIONS AND TO THE SATISFACTION OF NYCDEP.
- TO BE STOCKPILED FOR NYCDEP.
- TO TOWN OF MOUNT PLEASANT PLANNING BOARD AND ENGINEERING STANDARD DETAILS AND SPECIFICATIONS. THE TOWN OF MOUNT PLEASANT DEPARTMENT OF BUILDING SHALL BE NOTIFIED 48 HOURS IN ADVANCE OF ALL CONSTRUCTION.
- COUNTY PRIOR TO CONSTRUCTION.
- BY THE N.Y.S.D.O.T., DIVISION OF TRAFFIC SAFETY.
- TRANSPORTATION THAT A TONE-OUT OF SIGNAL EQUIPMENT IS NEEDED.





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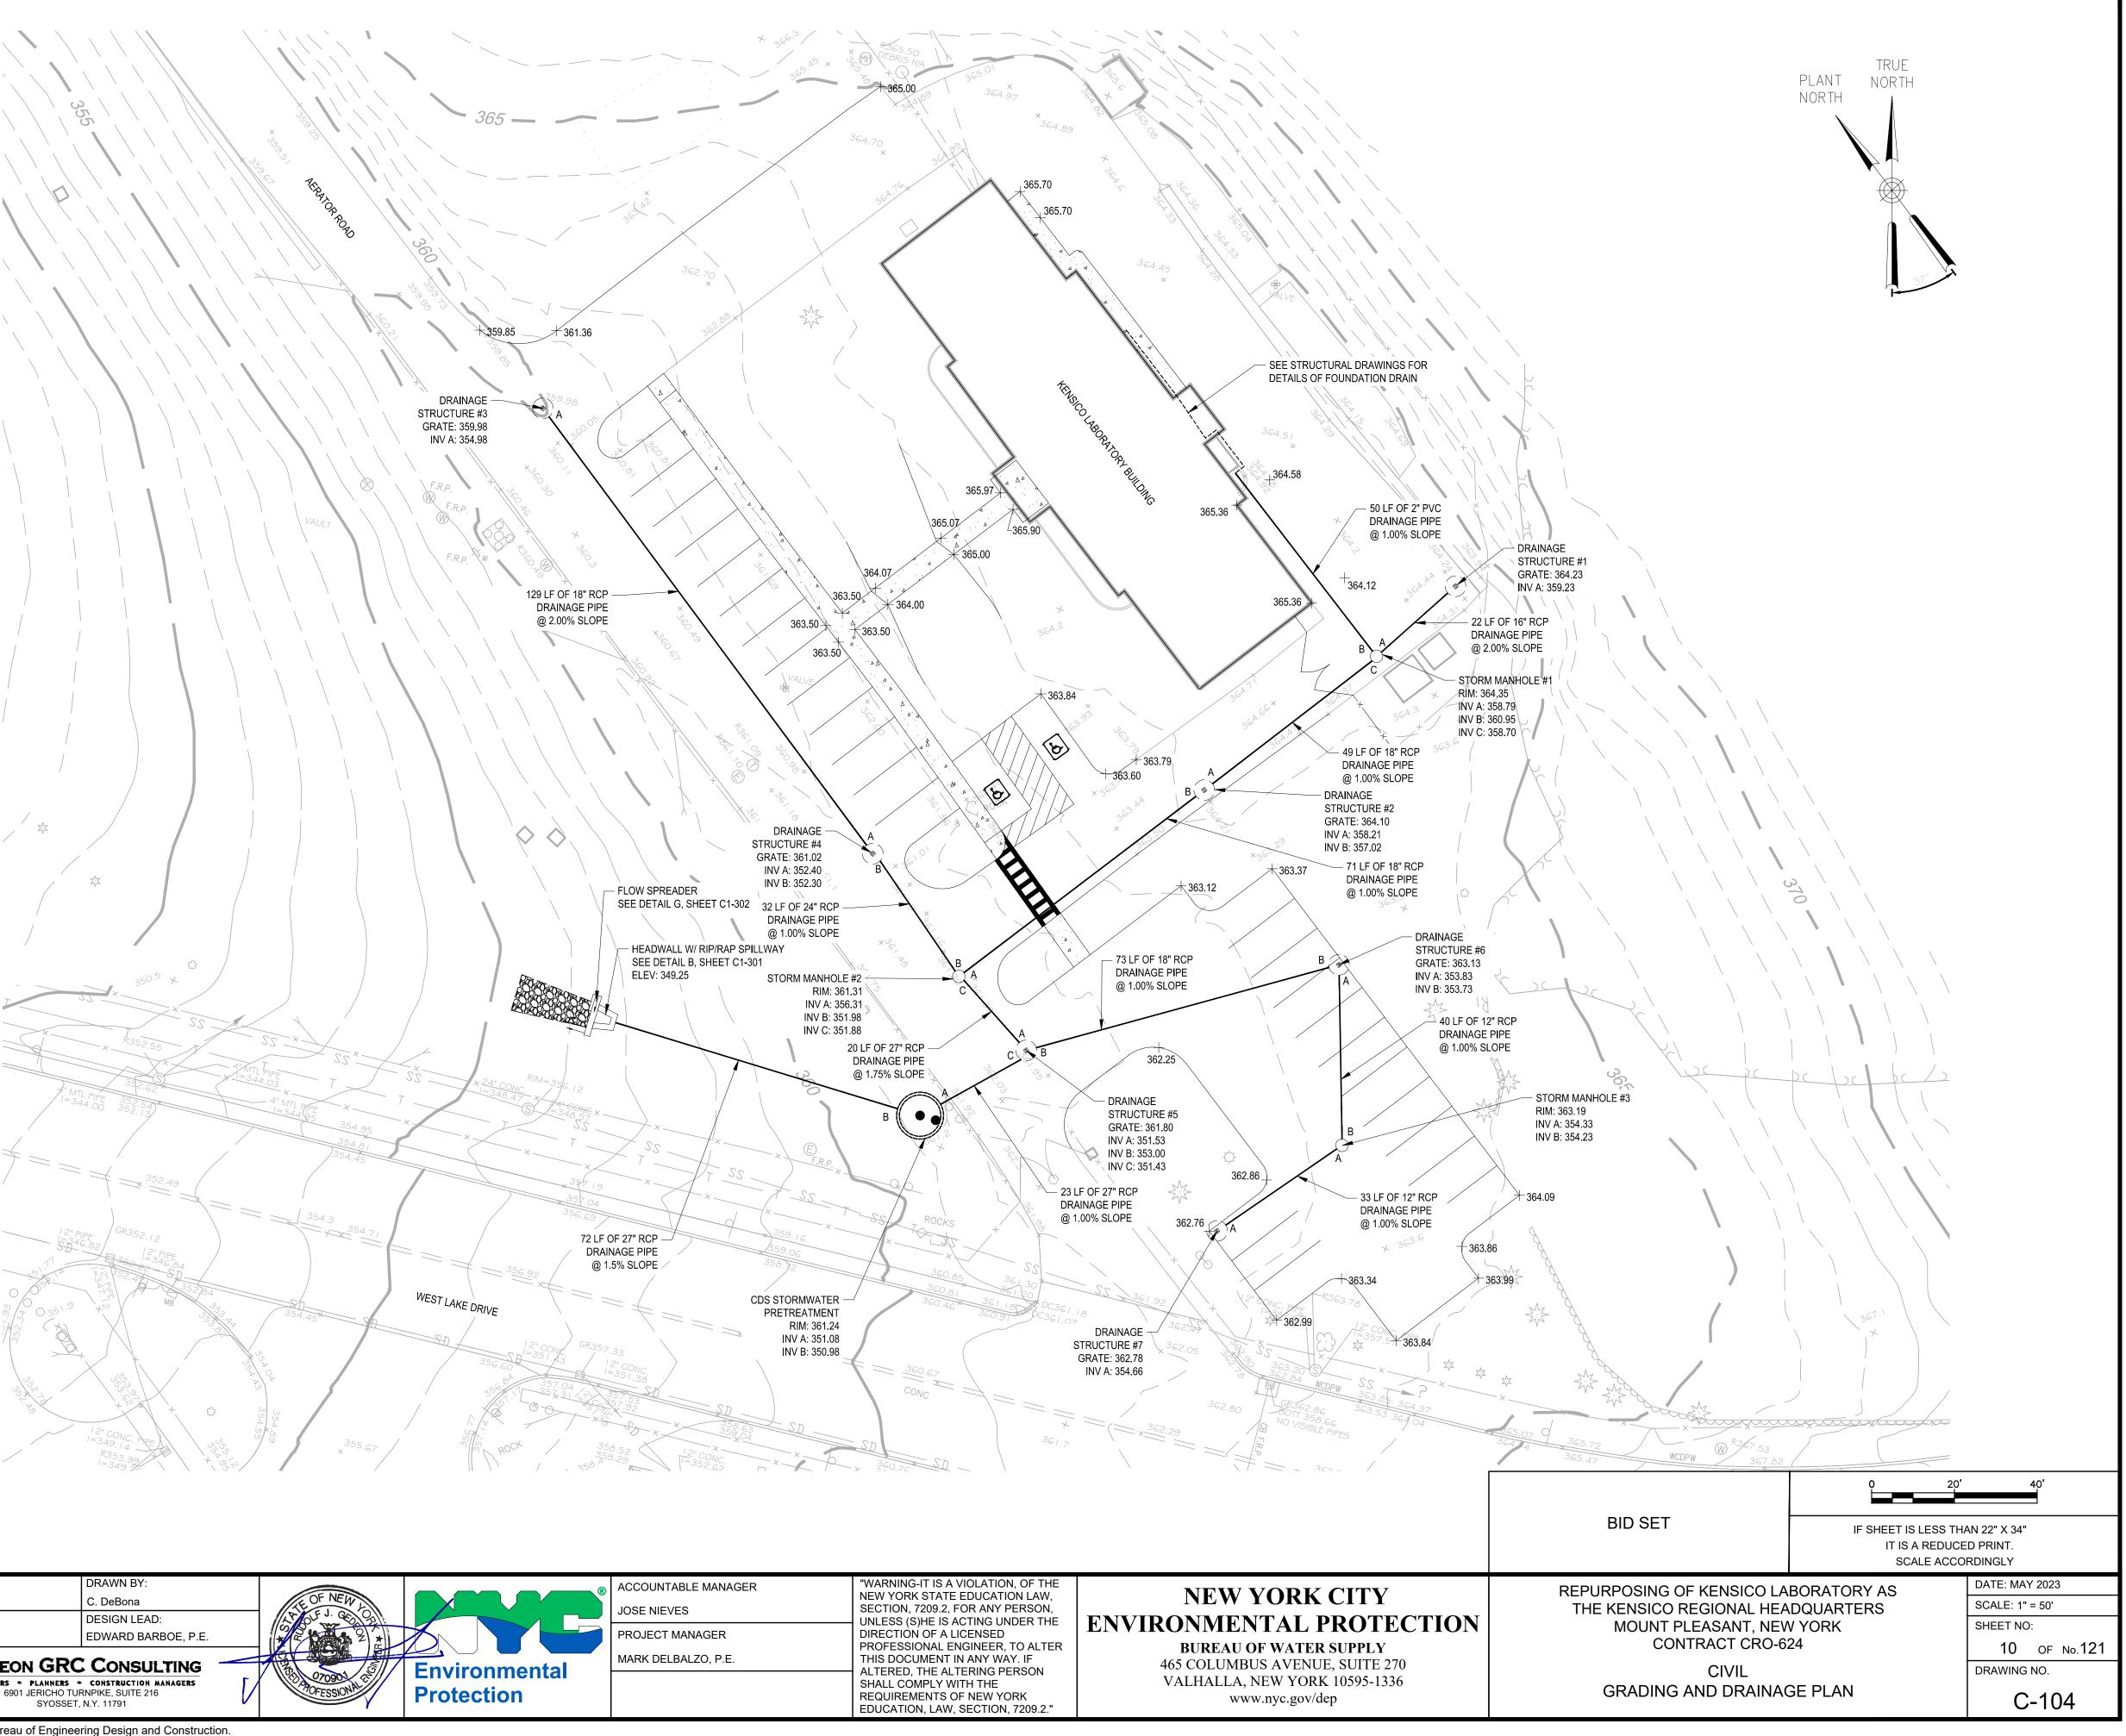
CATCH BASIN DRAINAGE STRUCTURE

EXISTING MINOR CONTOUR

PROPOSED CONTOUR

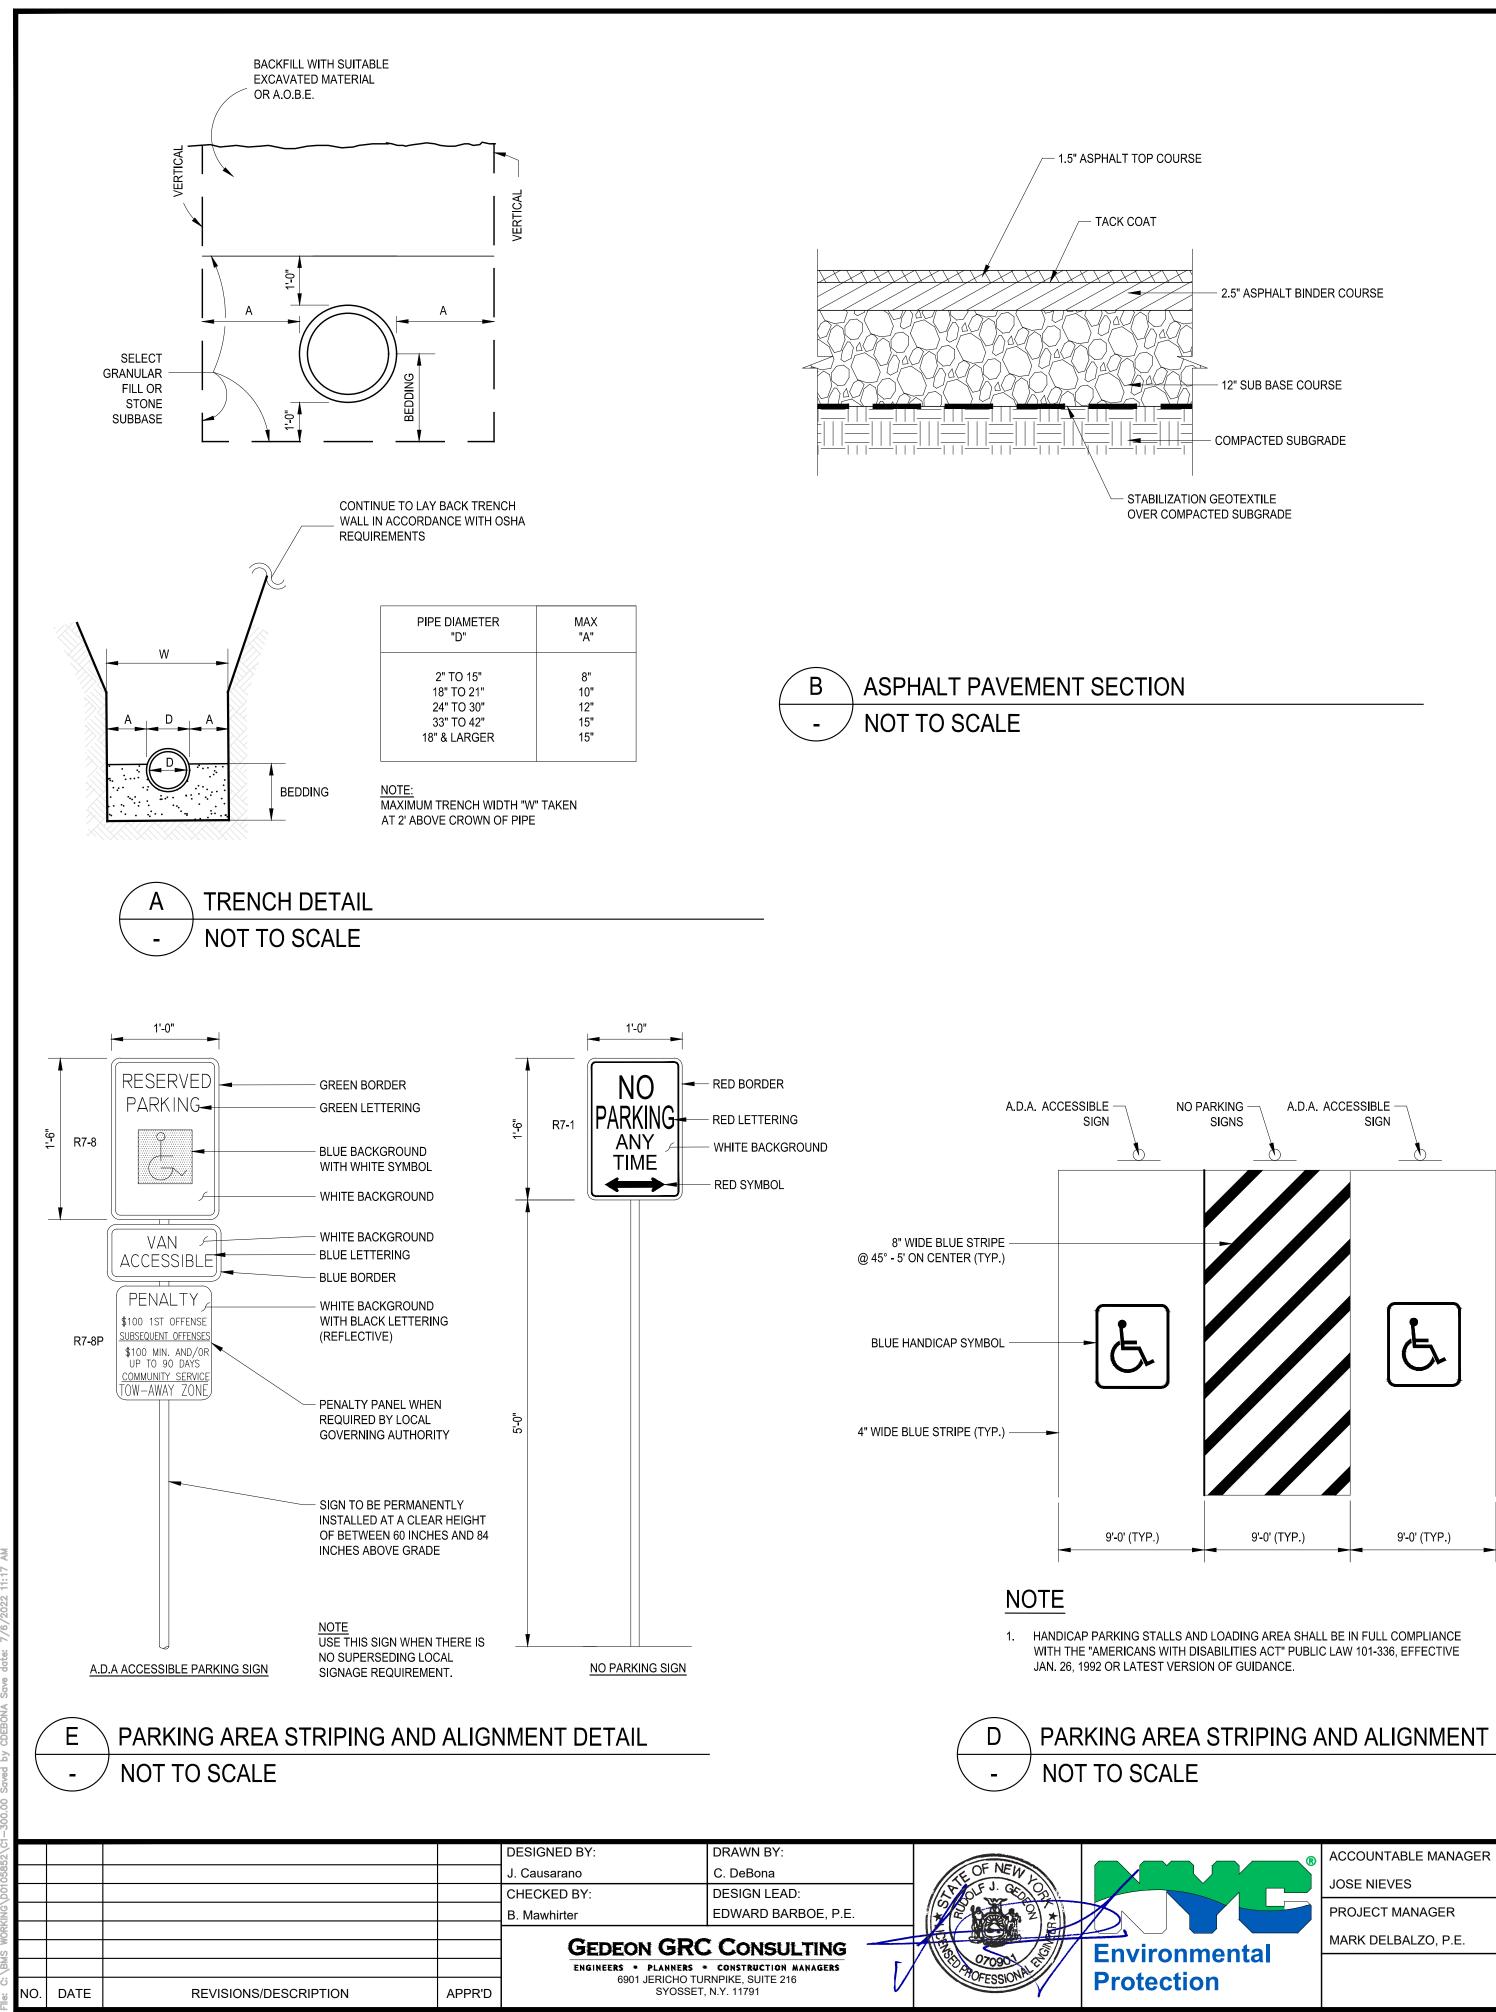
HEADWALL W/ RIP/RAP SPILLWAY

STORM MANHOLE



1-104							
52 \C					DESIGNED BY:	DRAWN BY:	
0585					J. Causarano	C. DeBona	LE OF NEW
rody					CHECKED BY:	DESIGN LEAD:	LT OF J. GE OF
KING					B. Mawhirter	EDWARD BARBOE, P.E.	* 2 2 *
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<u> </u>						PLANNERS • CONSTRUCTION MANAGERS ERICHO TURNPIKE, SUITE 216	POFFSSIONA
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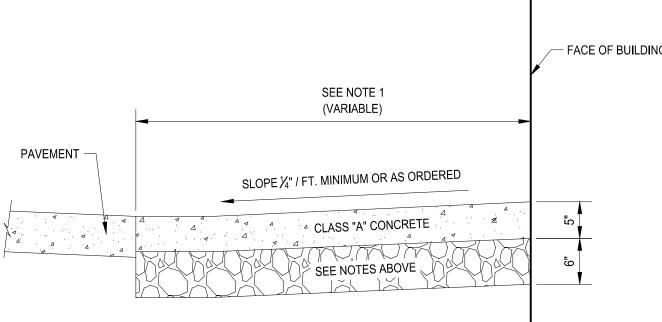




All inquiries regarding this drawing(s) or project should be made to NYC Environmental Protection, Bureau of Engineering Design and Construction.

## NOTES

- 1. SIDEWALKS WIDER THAN 4'-0" OR AS DIRECTED SHALL BE REINFORCED WITH EPOXY COATED WELDED WIRE FABRIC 10 GA. 6" x 6" W1.4.
- 2. ALL CONCRETE SIDEWALKS SHALL HAVE A BROOM FINISH WITH SCORES AT 5'-0".
- IMMEDIATELY AFTER FINISHING THE CONCRETE, THE CONTRACTOR SHALL APPLY AN APPROVED CURING 3 MATERIAL. THE CONTRACTOR SHALL SPRAY TWO (2) COATS AT COMBINED COVERAGE OF 250 SQUARE FEET PER GALLON, OR ROLL ONE (1) COAST AT THE RATE 250 SQUARE FEET PER GALLON AND IN A MANNER ACCORDANCE WITH THE MANUFACTURER'S RECOMMENDATIONS.
- 4. THE BASE COURSE SHALL CONSIST OF COMPACTED <sup>3</sup>/<sub>4</sub>" CRUSHED STONE.



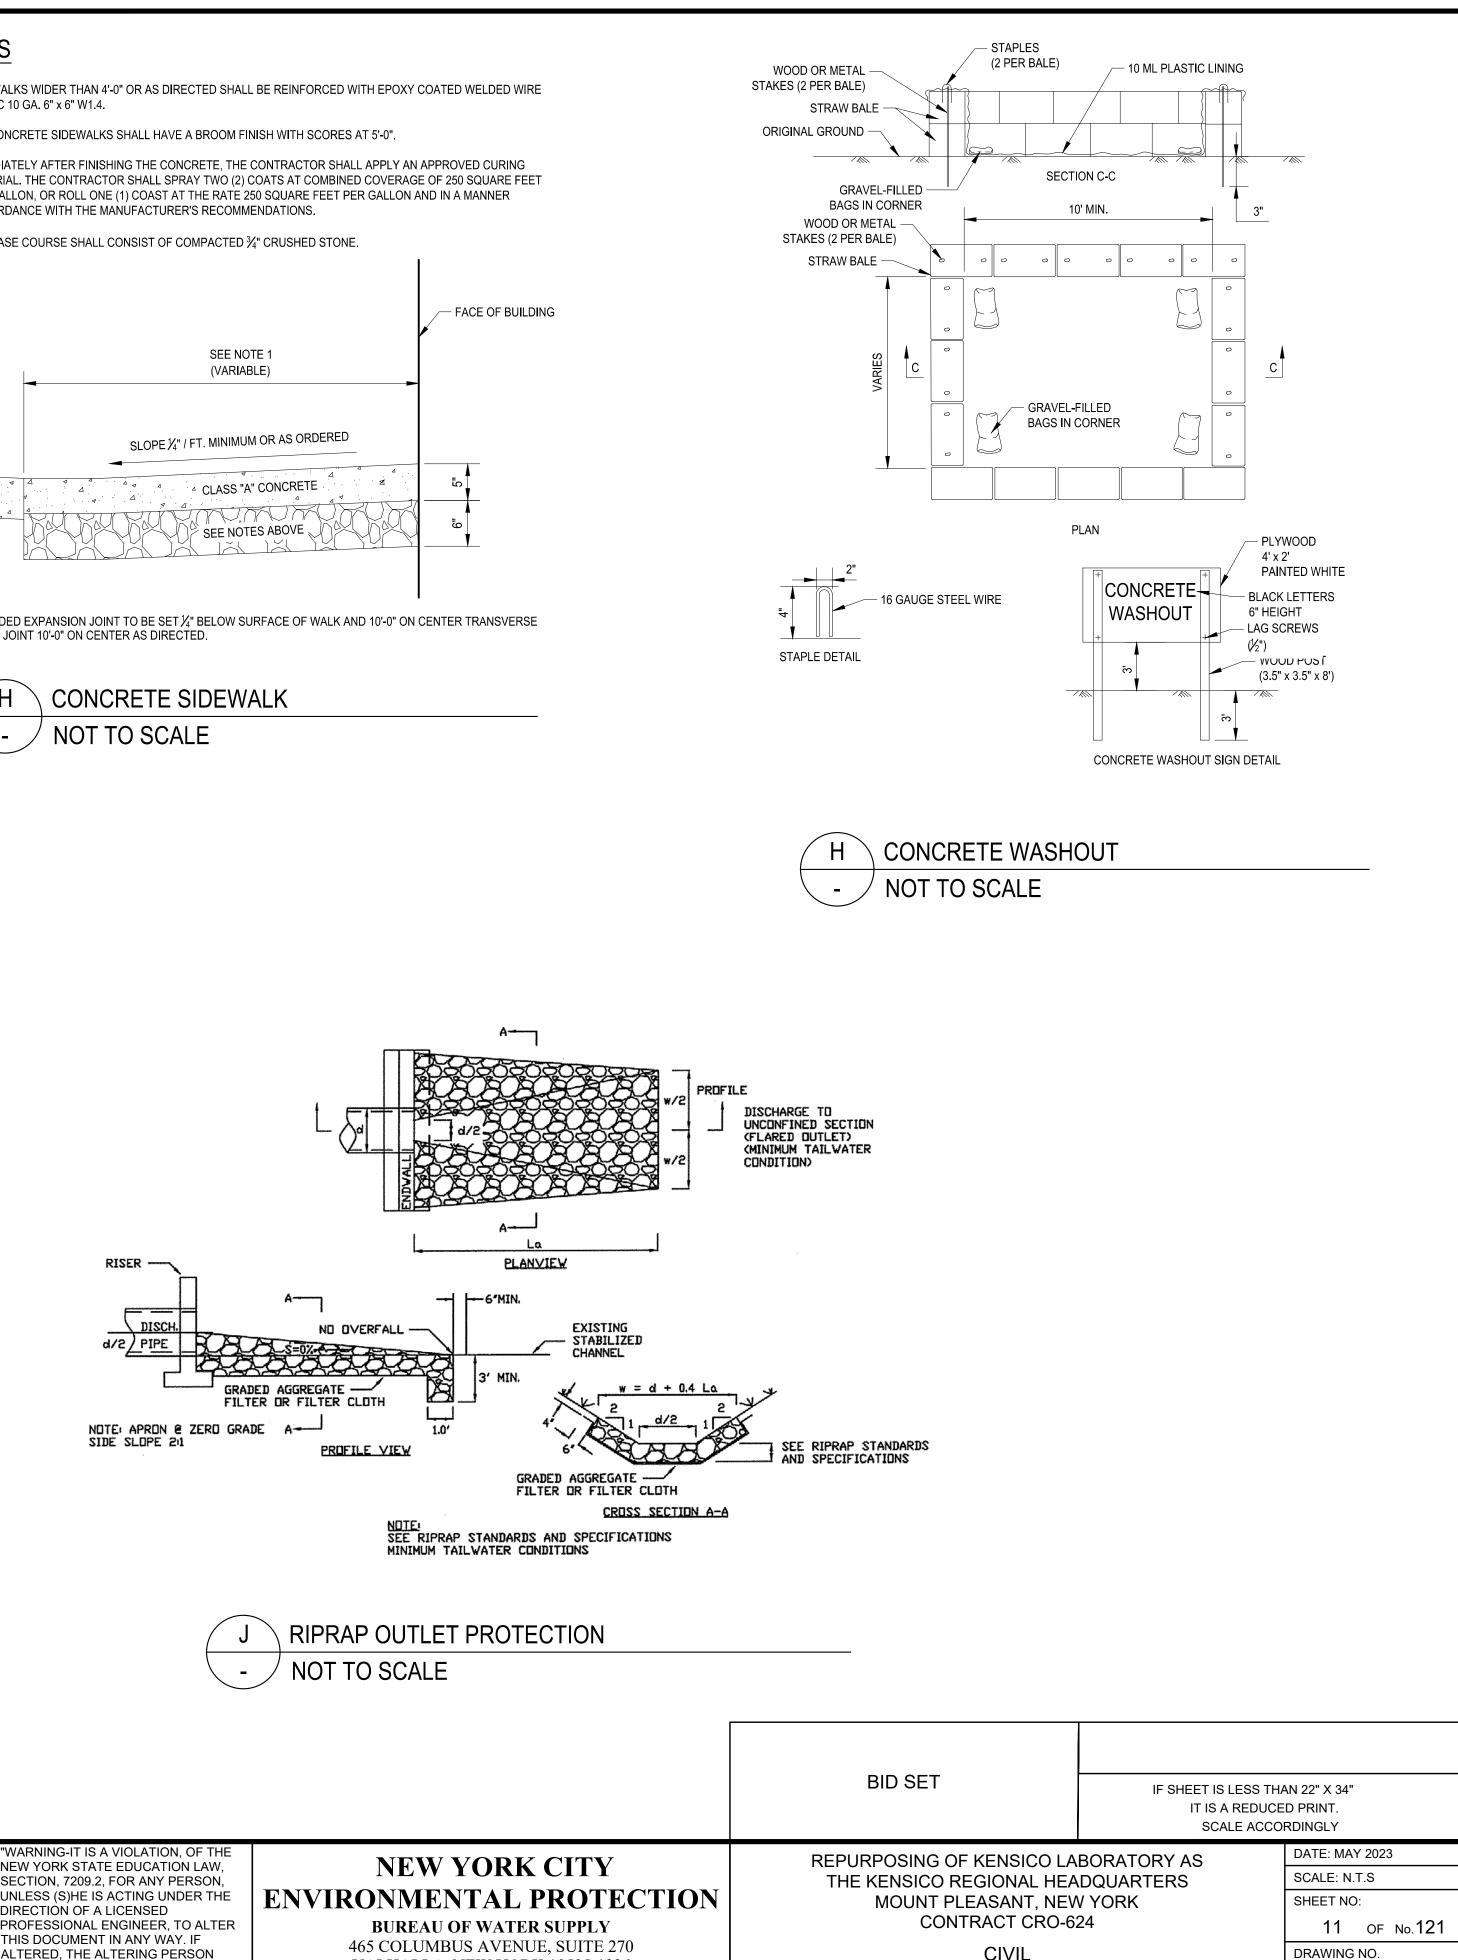
 $\gamma_2$ " PREMOLDED EXPANSION JOINT TO BE SET  $\gamma_4$ " BELOW SURFACE OF WALK AND 10'-0" ON CENTER TRANSVERSE EXPANSION JOINT 10'-0" ON CENTER AS DIRECTED.

Н NOT TO SCALE

## PARKING AREA STRIPING AND ALIGNMENT DETAIL


NEW YORK STATE EDUCATION LAW, SECTION, 7209.2, FOR ANY PERSON, UNLESS (S)HE IS ACTING UNDER THE DIRECTION OF A LICENSED PROFESSIONAL ENGINEER, TO ALTER THIS DOCUMENT IN ANY WAY. IF ALTERED, THE ALTERING PERSON SHALL COMPLY WITH THE REQUIREMENTS OF NEW YORK EDUCATION, LAW, SECTION, 7209.2."

**NEW YORK CITY BUREAU OF WATER SUPPLY** 465 COLUMBUS AVENUE, SUITE 270 VALHALLA, NEW YORK 10595-1336 www.nyc.gov/dep



CONTRACT CRO-624
CIVIL DETAILS - 1

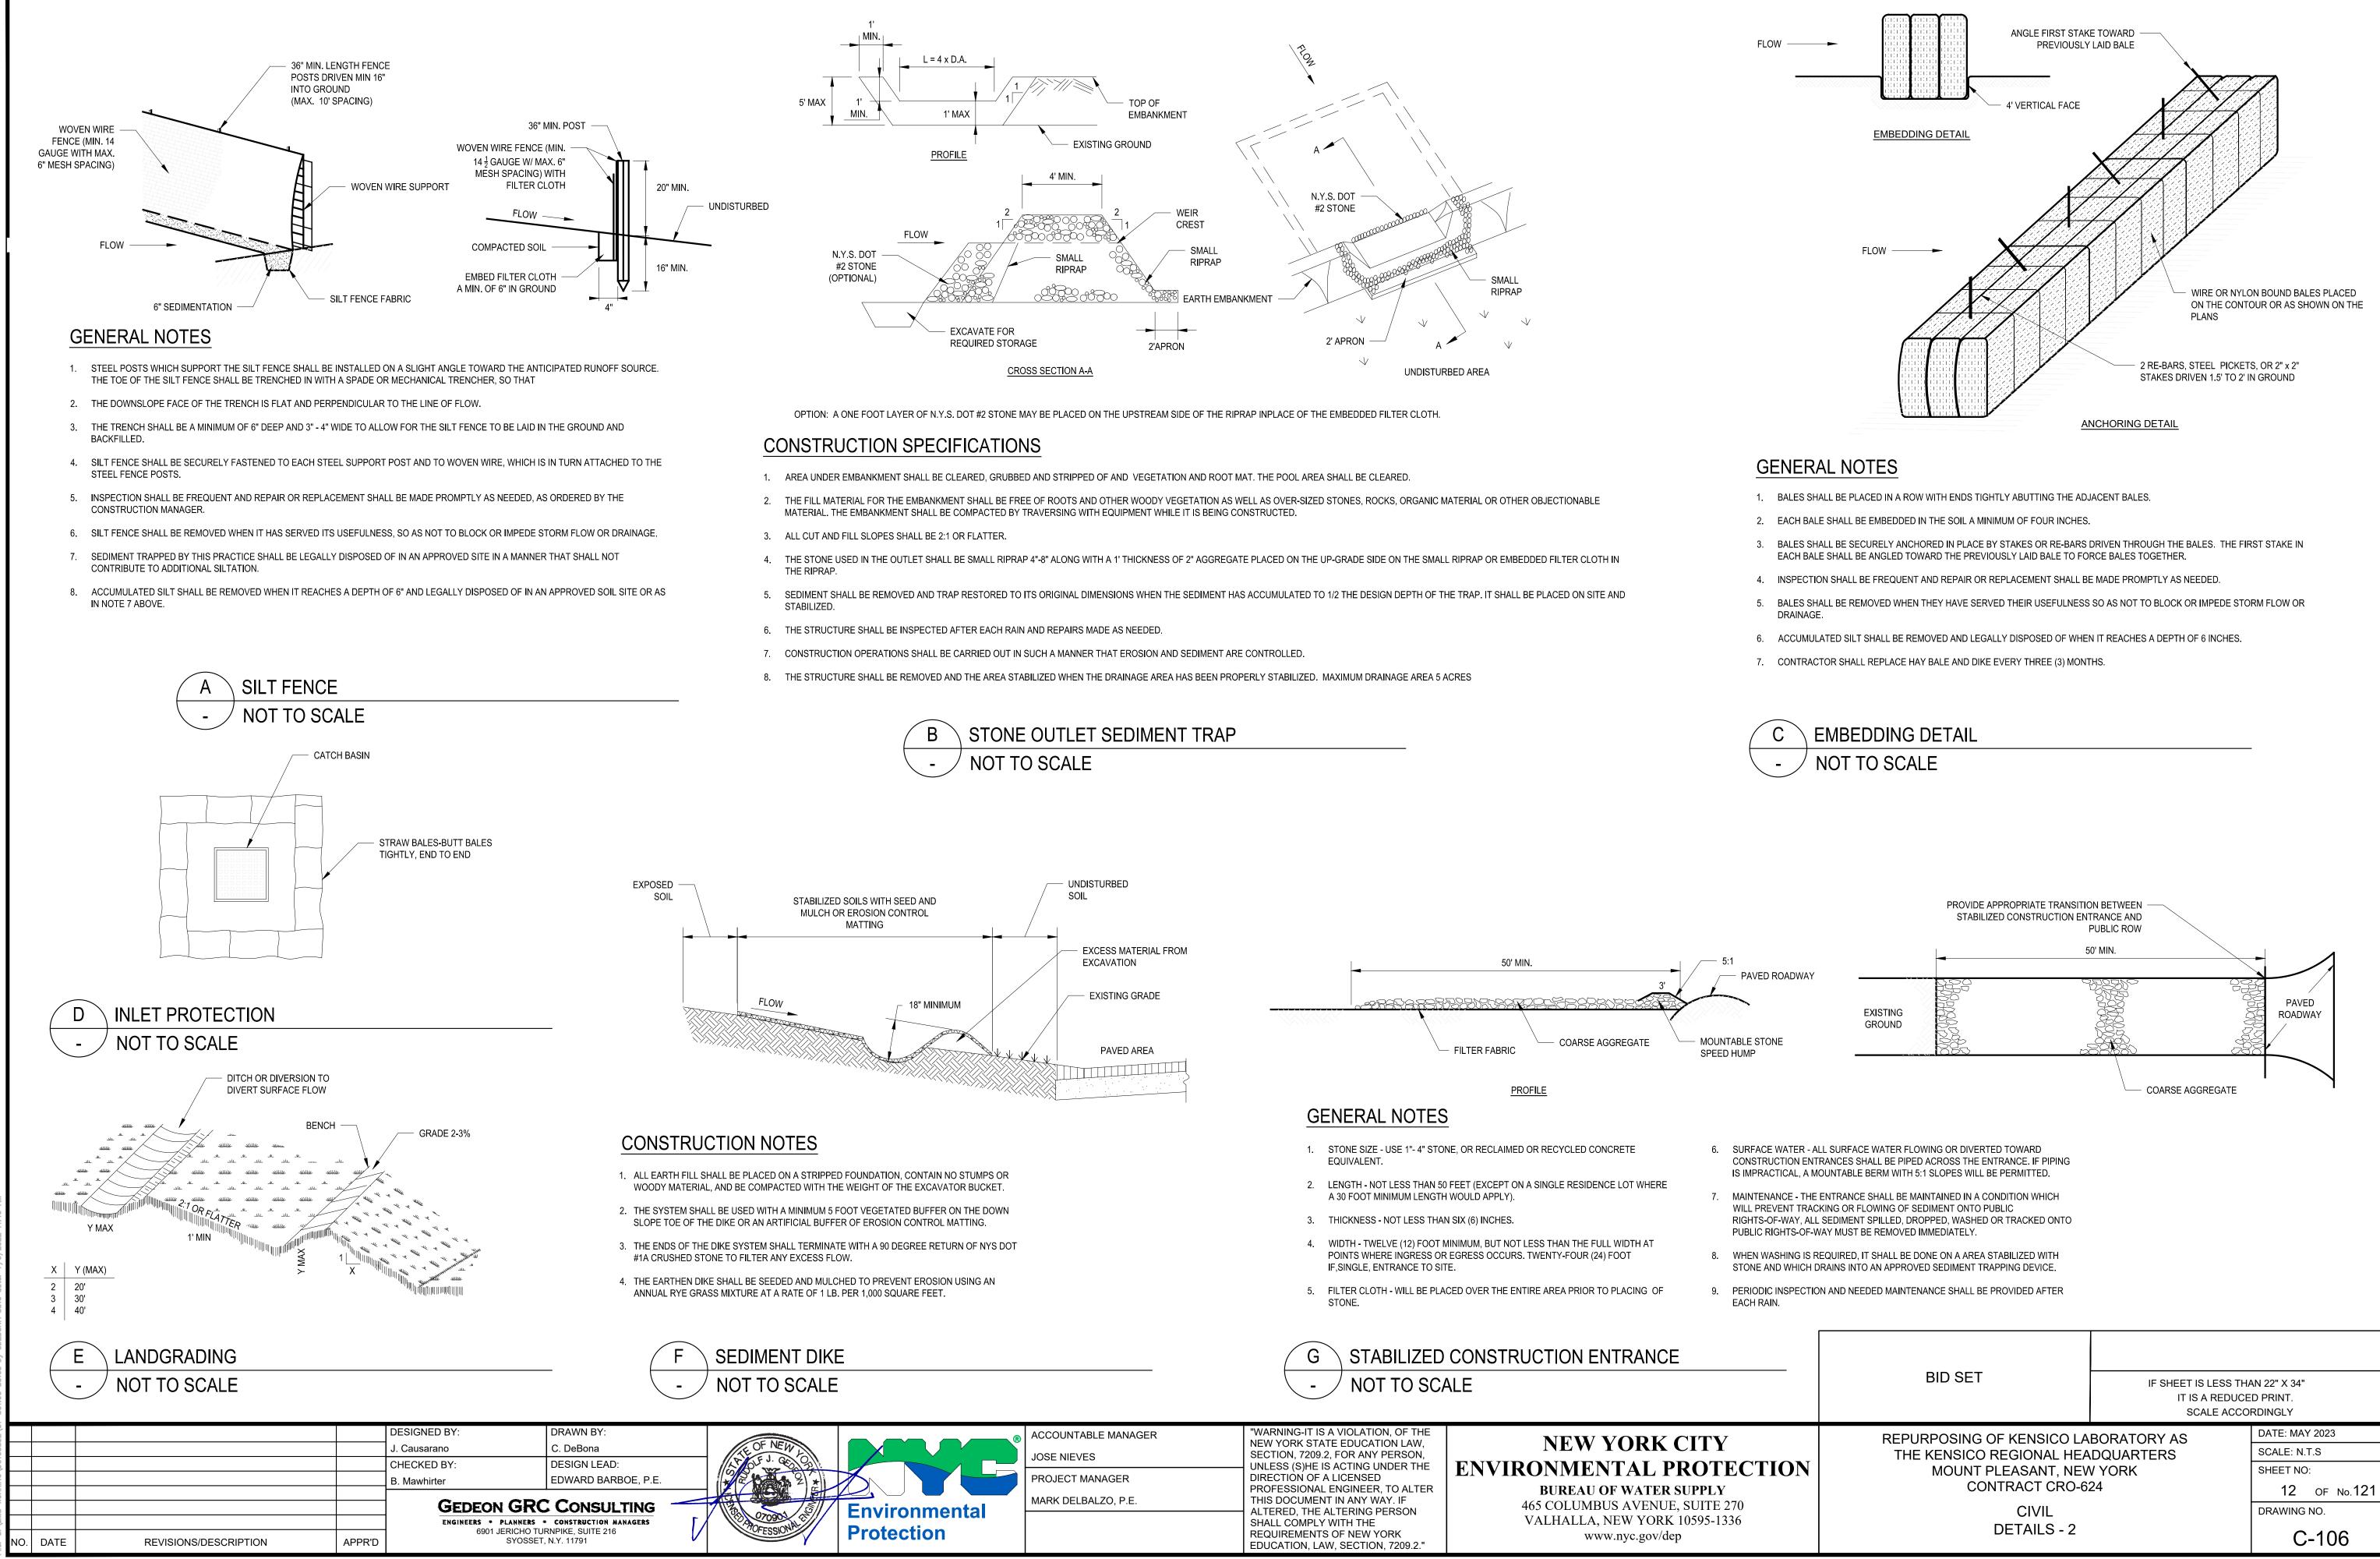
C-105




	ACCOUNTABLE MANAGER JOSE NIEVES	"WARNING-IT IS A VIOLATION, OF THE NEW YORK STATE EDUCATION LAW, SECTION, 7209.2, FOR ANY PERSON,	NEW YORK CITY	
		PROJECT MANAGER MARK DELBALZO, P.E.	<ul> <li>UNLESS (S)HE IS ACTING UNDER THE DIRECTION OF A LICENSED</li> <li>PROFESSIONAL ENGINEER, TO ALTER THIS DOCUMENT IN ANY WAY. IF</li> </ul>	<b>ENVIRONMENTAL PROTECT</b> BUREAU OF WATER SUPPLY 465 COLUMBUS AVENUE, SUITE 270
	Environmental Protection		ALTERED, THE ALTERING PERSON SHALL COMPLY WITH THE REQUIREMENTS OF NEW YORK EDUCATION, LAW, SECTION, 7209.2."	VALHALLA, NEW YORK 10595-1336 www.nyc.gov/dep

			ROPRIATE TRANSITION BETWEE CONSTRUCTION ENTRANCE ANI PUBLIC ROV	D	
		-	50' MIN.		
VED ROADWAY	EXISTING GROUND				PAVED ROADWAY
STONE			68883	- COARSE AGGREGATE	

BID SET IF SHEET IS LESS THAN 22" X 34 IT IS A REDUCED PRINT. SCALE ACCORDINGLY				
	REPURPOSING OF KENSICO LABORATORY AS		DATE: MAY 2023	
	THE KENSICO REGIONAL HEA	SCALE: N.T.S		
TION	MOUNT PLEASANT, NEV	SHEET NO:		
	CONTRACT CRO-62	12 OF No.121		
	CIVIL DETAILS - 2		DRAWING NO.	
			C-106	

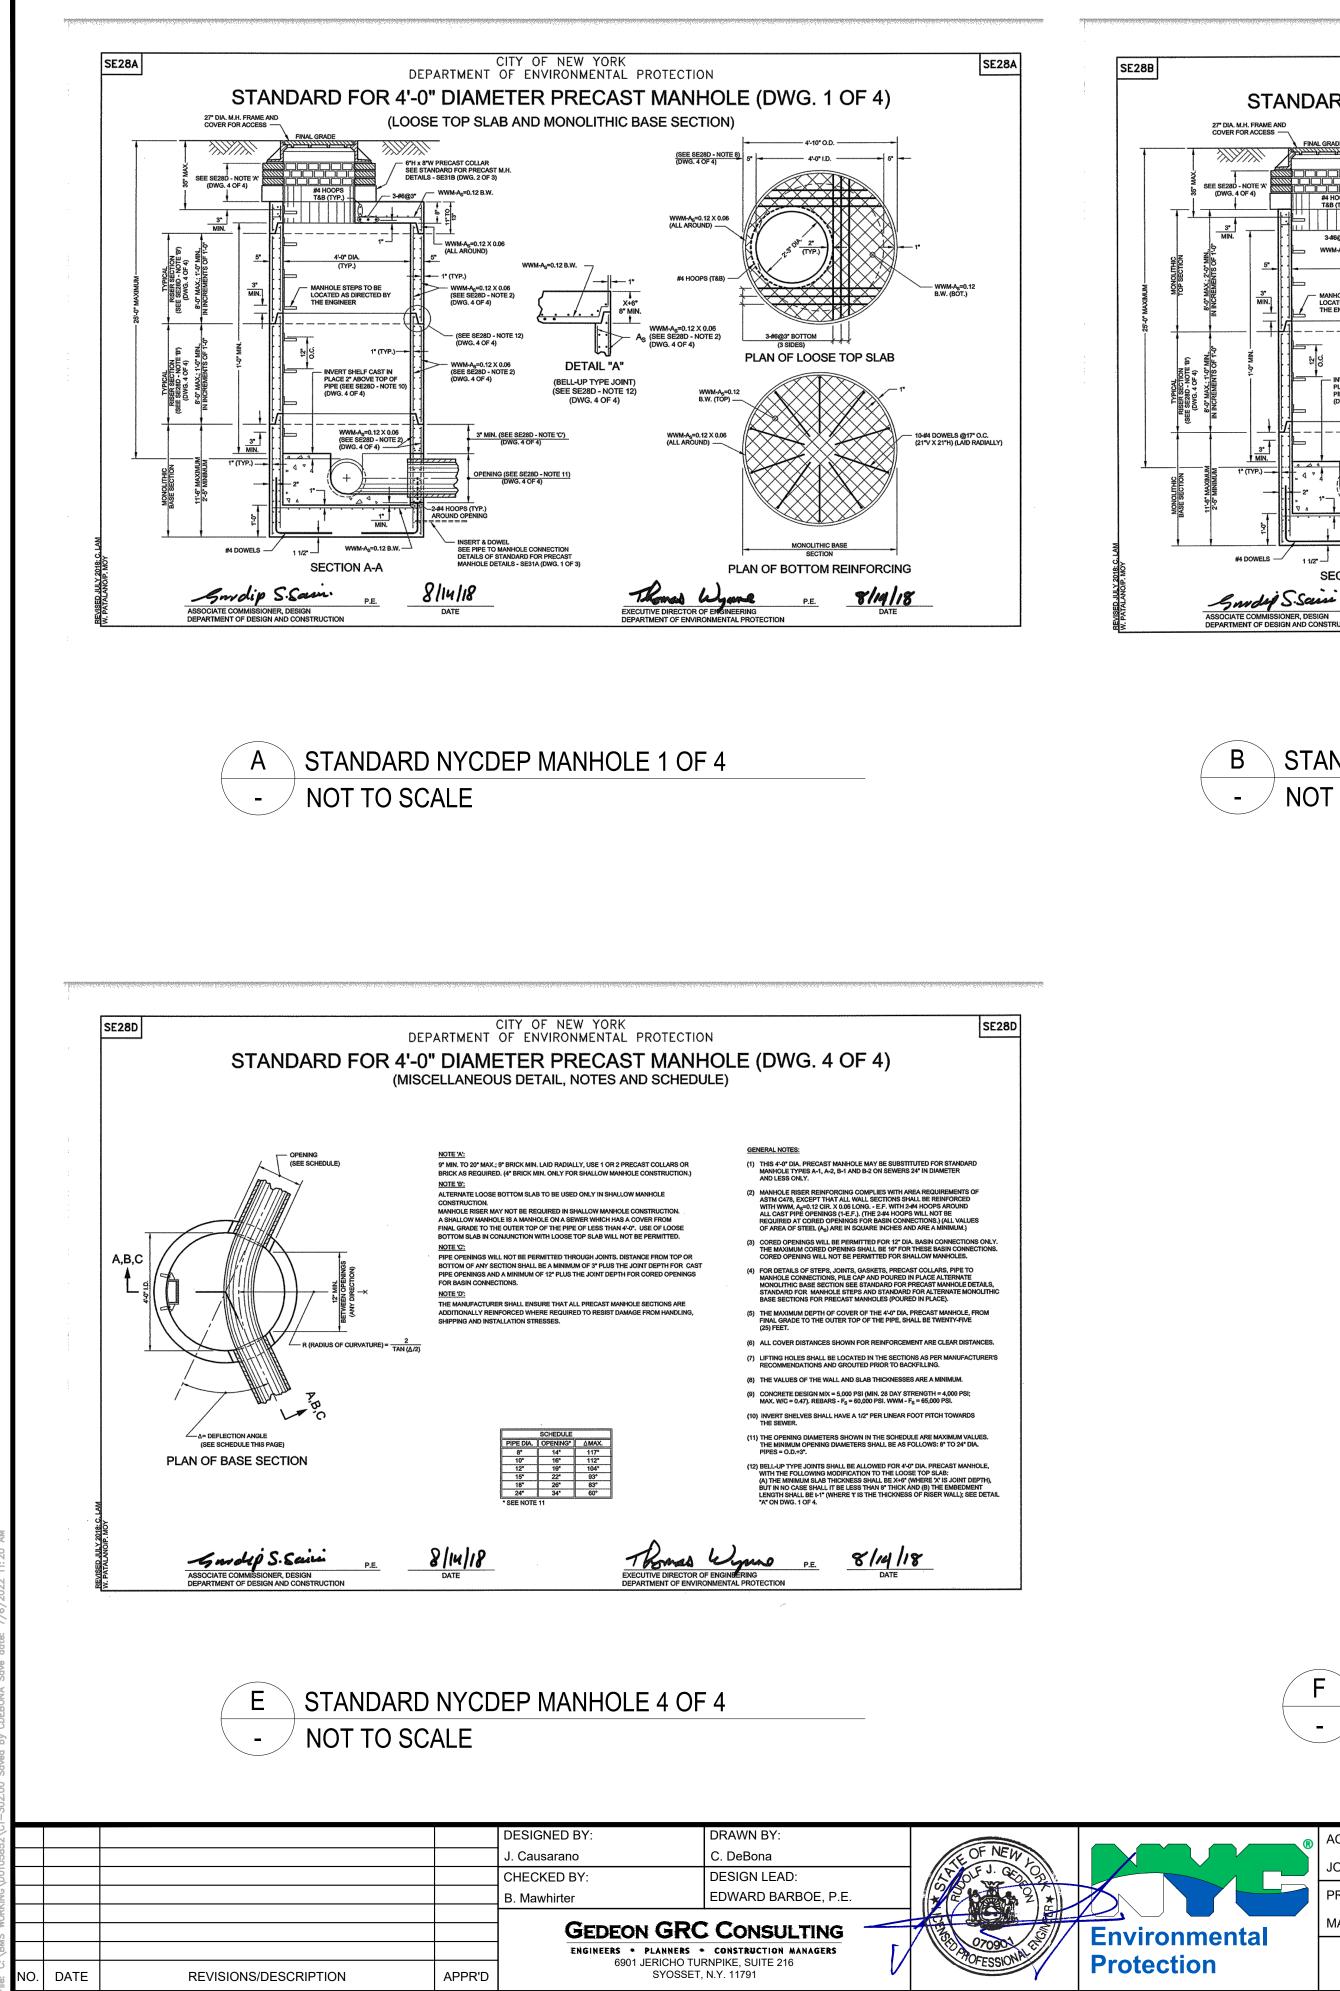

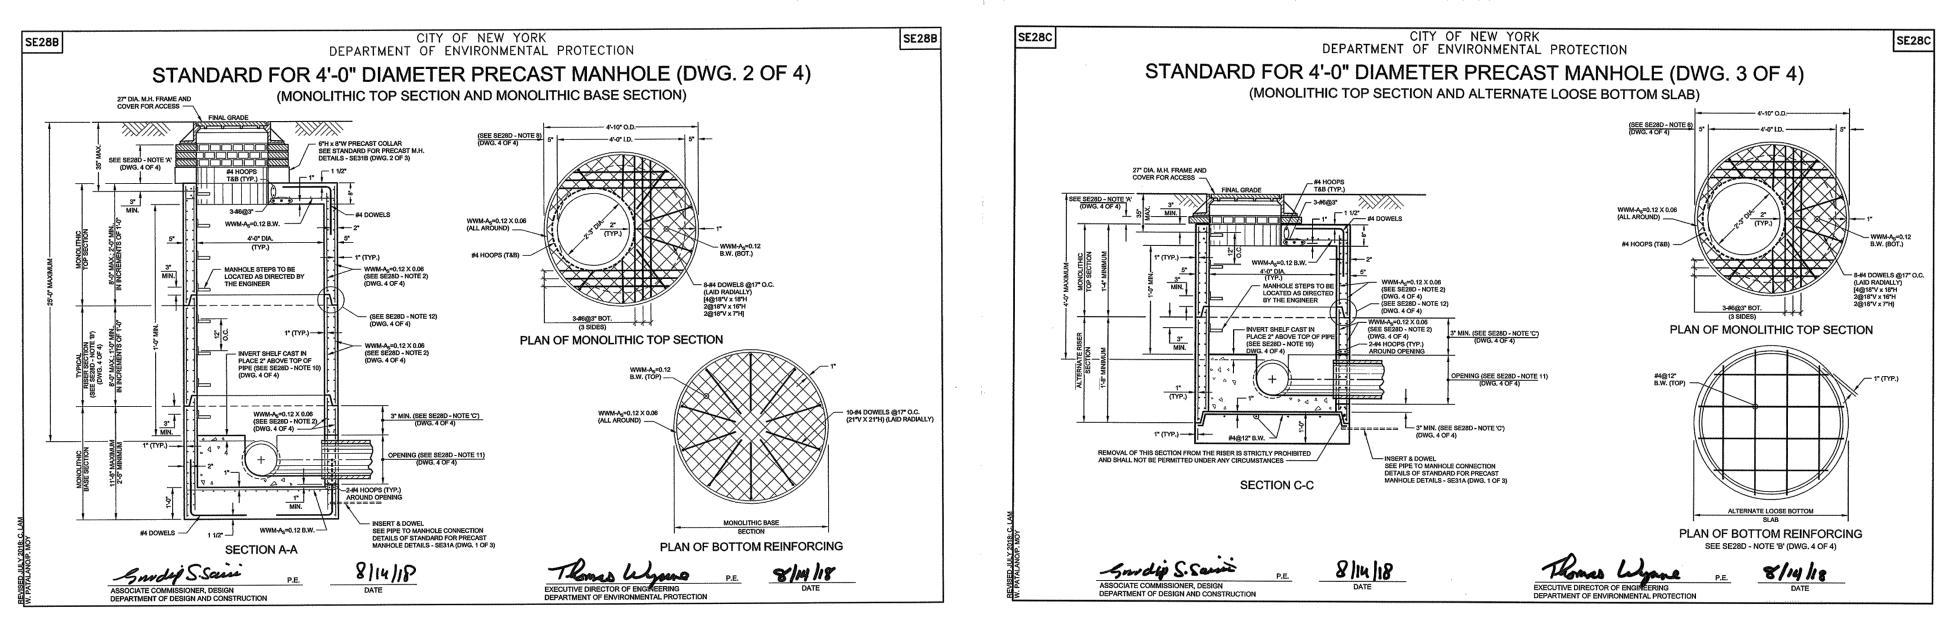All inquiries regarding this drawing(s) or project should be made to NYC Environmental Protection, Bureau of Engineering Design and Construction.

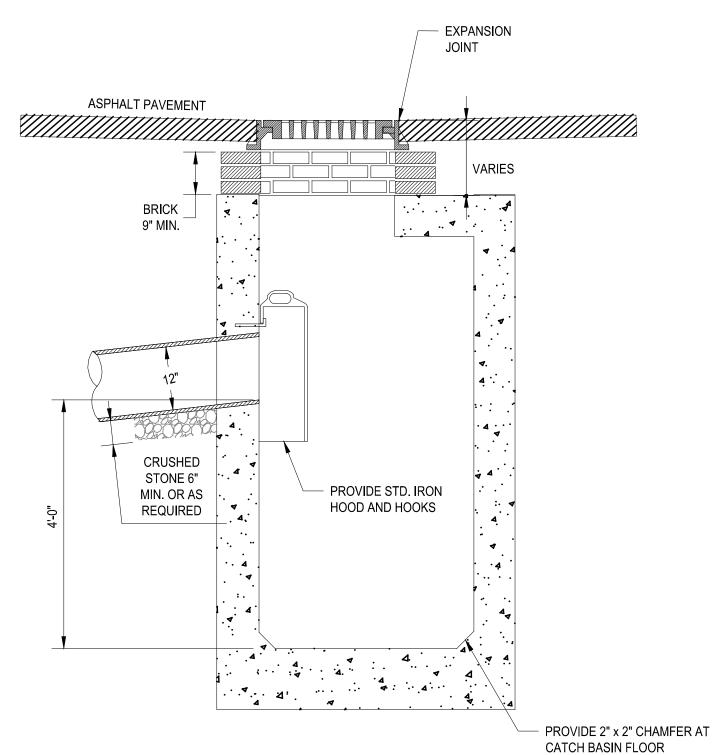


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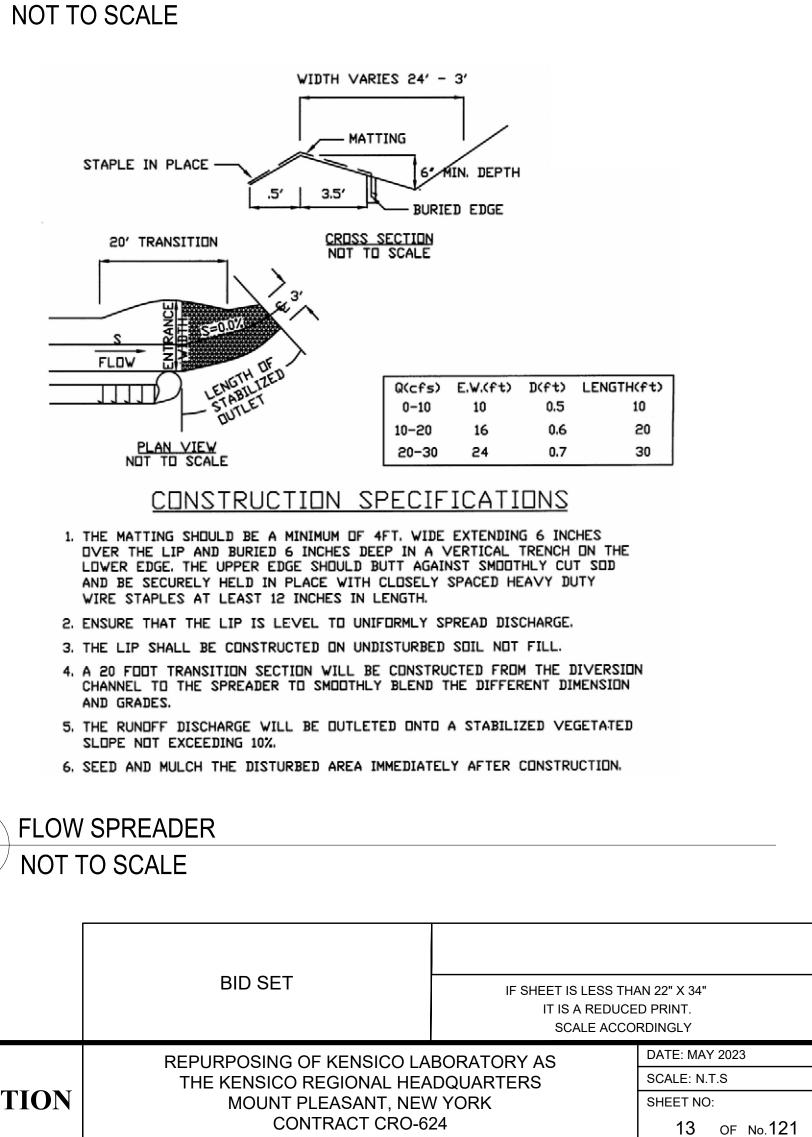
MODIFIED NYCDEP TYPE 2 CATCH BASIN WITHOUT CURB PIECE NOT TO SCALE

ACCOUNTABLE MANAGER	
JOSE NIEVES	
PROJECT MANAGER	
MARK DELBALZO, P.E.	

"WARNING-IT IS A VIOLATION, OF THE NEW YORK STATE EDUCATION LAW, SECTION, 7209.2, FOR ANY PERSON, UNLESS (S)HE IS ACTING UNDER THE DIRECTION OF A LICENSED PROFESSIONAL ENGINEER, TO ALTER THIS DOCUMENT IN ANY WAY. IF ALTERED, THE ALTERING PERSON SHALL COMPLY WITH THE REQUIREMENTS OF NEW YORK EDUCATION, LAW, SECTION, 7209.2."

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## STANDARD NYCDEP MANHOLE 3 OF 4

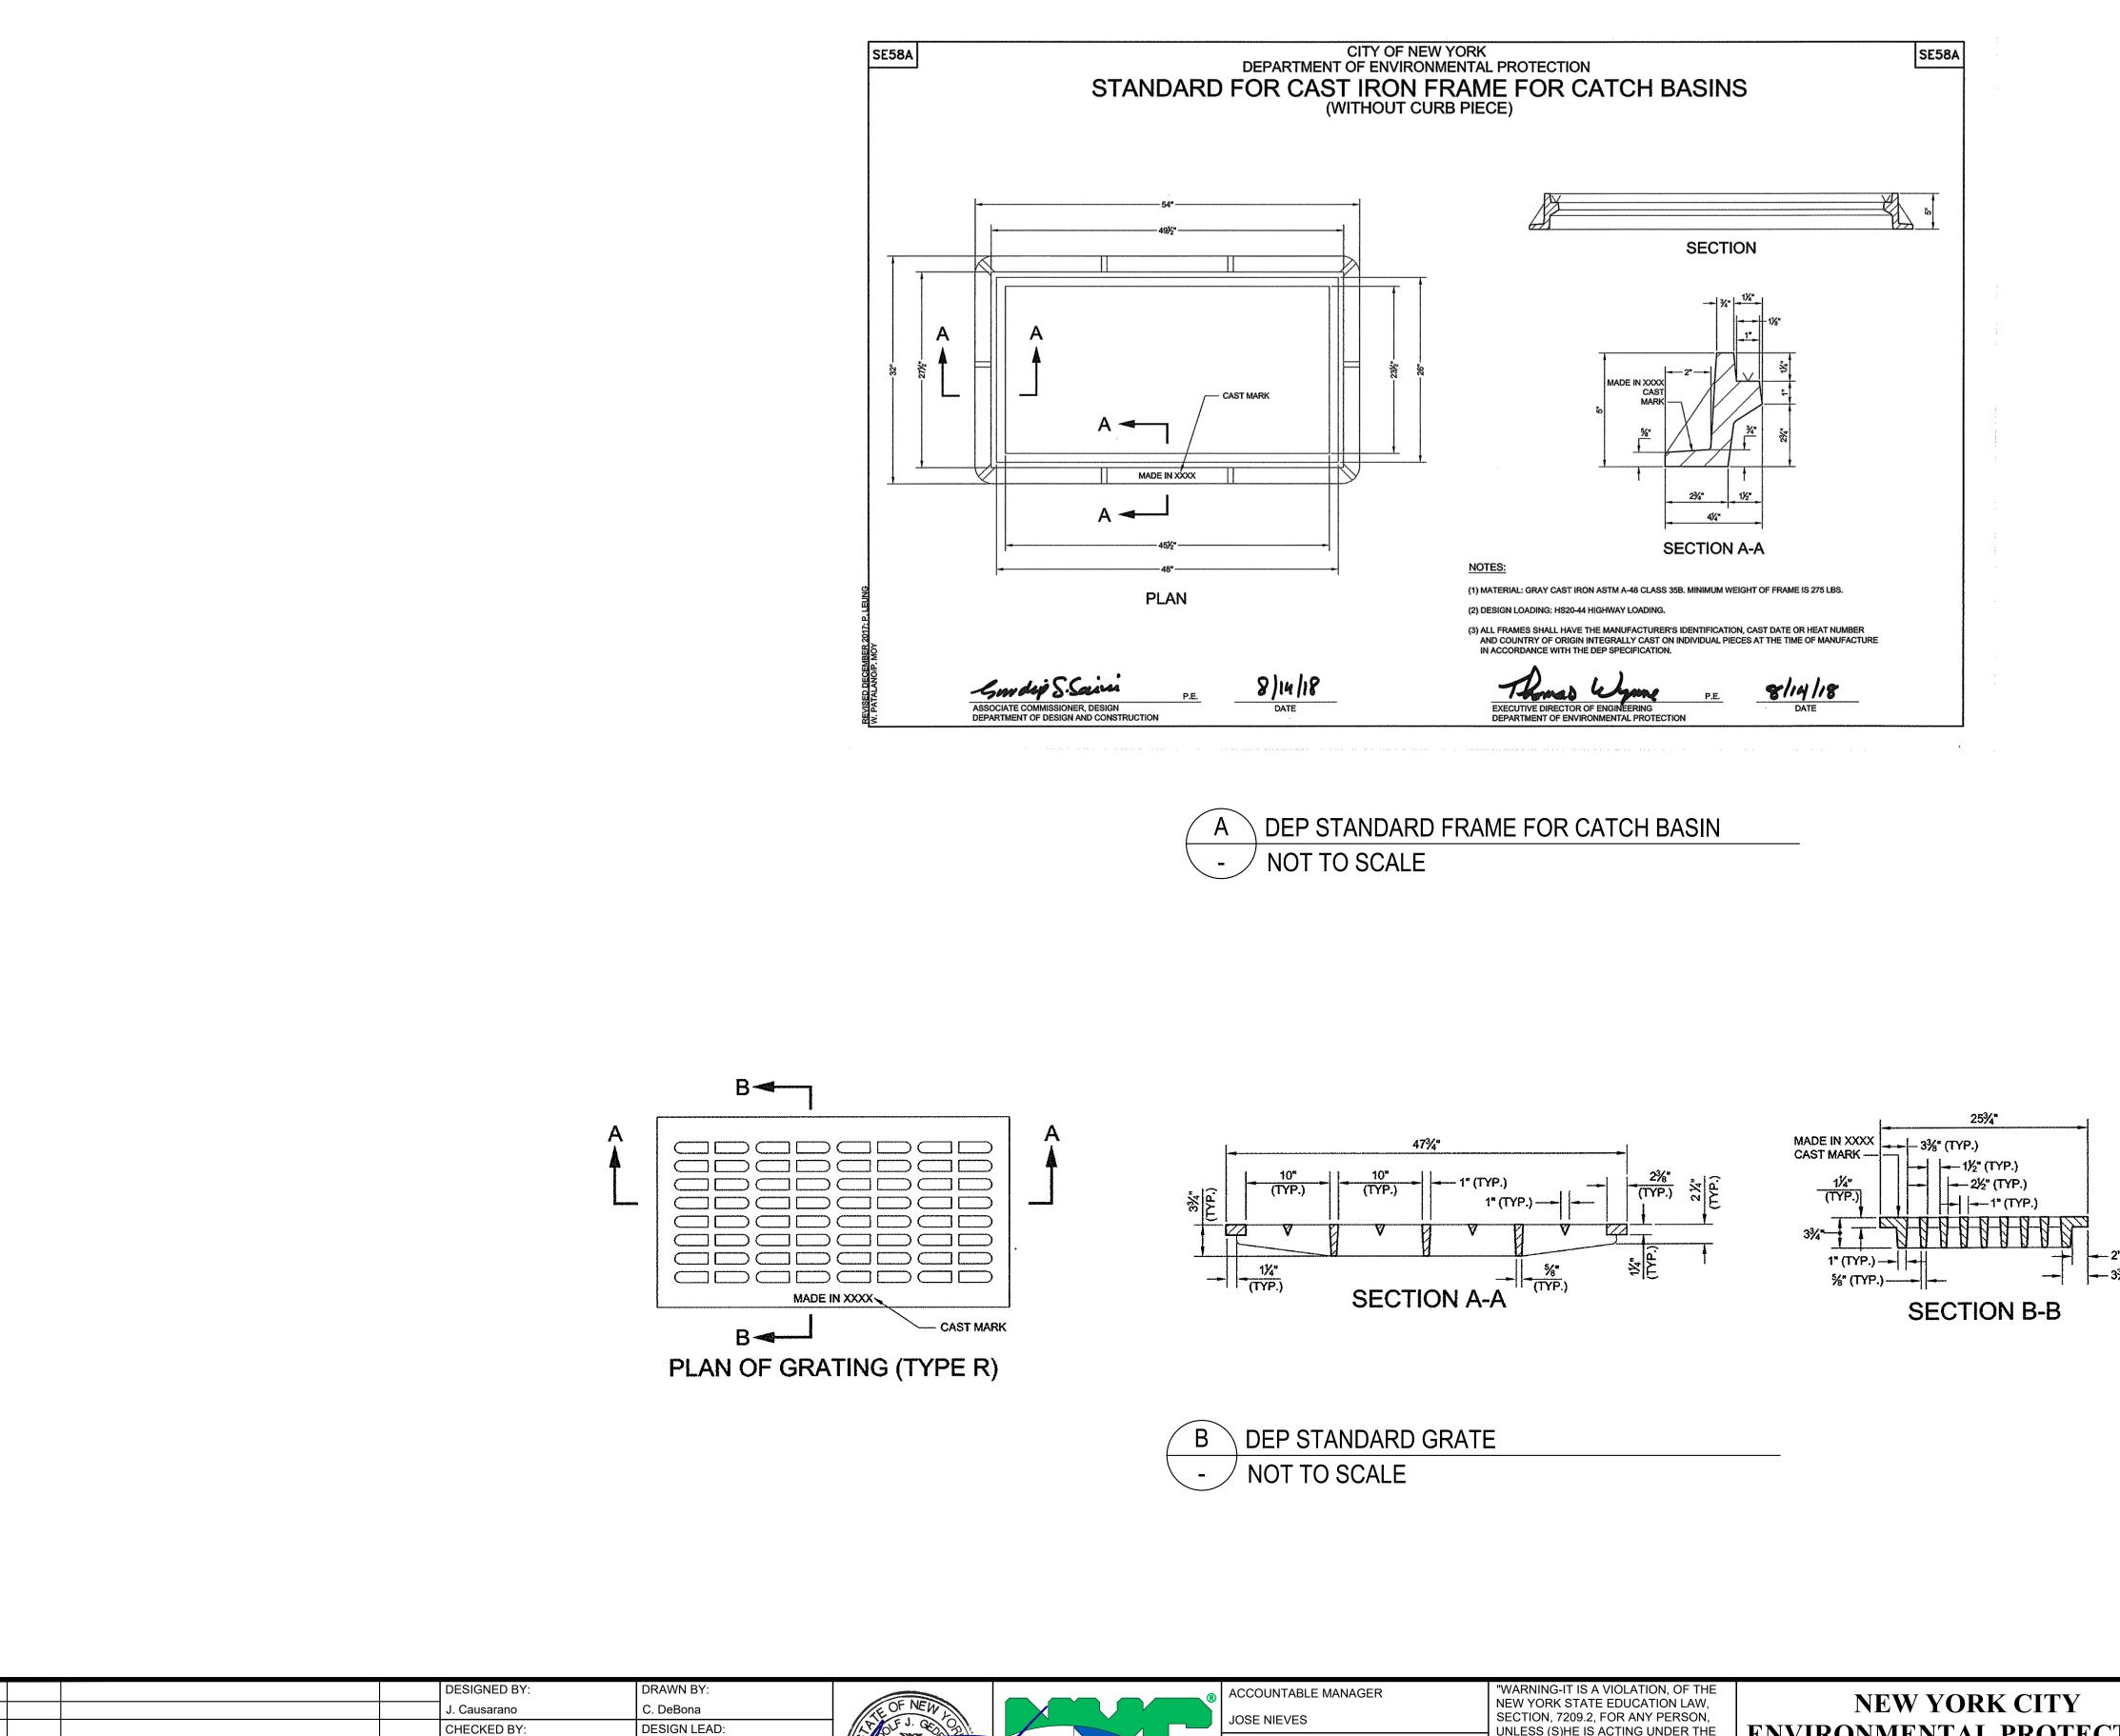


CIVIL

DETAILS - 3

DRAWING NO.

C-107



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NO. DATE

All inquiries regarding this drawing(s) or project should be made to NYC Environmental Protection, Bureau of Engineering Design and Construction.

APPR'D

**REVISIONS/DESCRIPTION** 

B. Mawhirter

EDWARD BARBOE, P.E.

GEDEON GRC CONSULTING

ENGINEERS • PLANNERS • CONSTRUCTION MANAGERS 6901 JERICHO TURNPIKE, SUITE 216

SYOSSET, N.Y. 11791

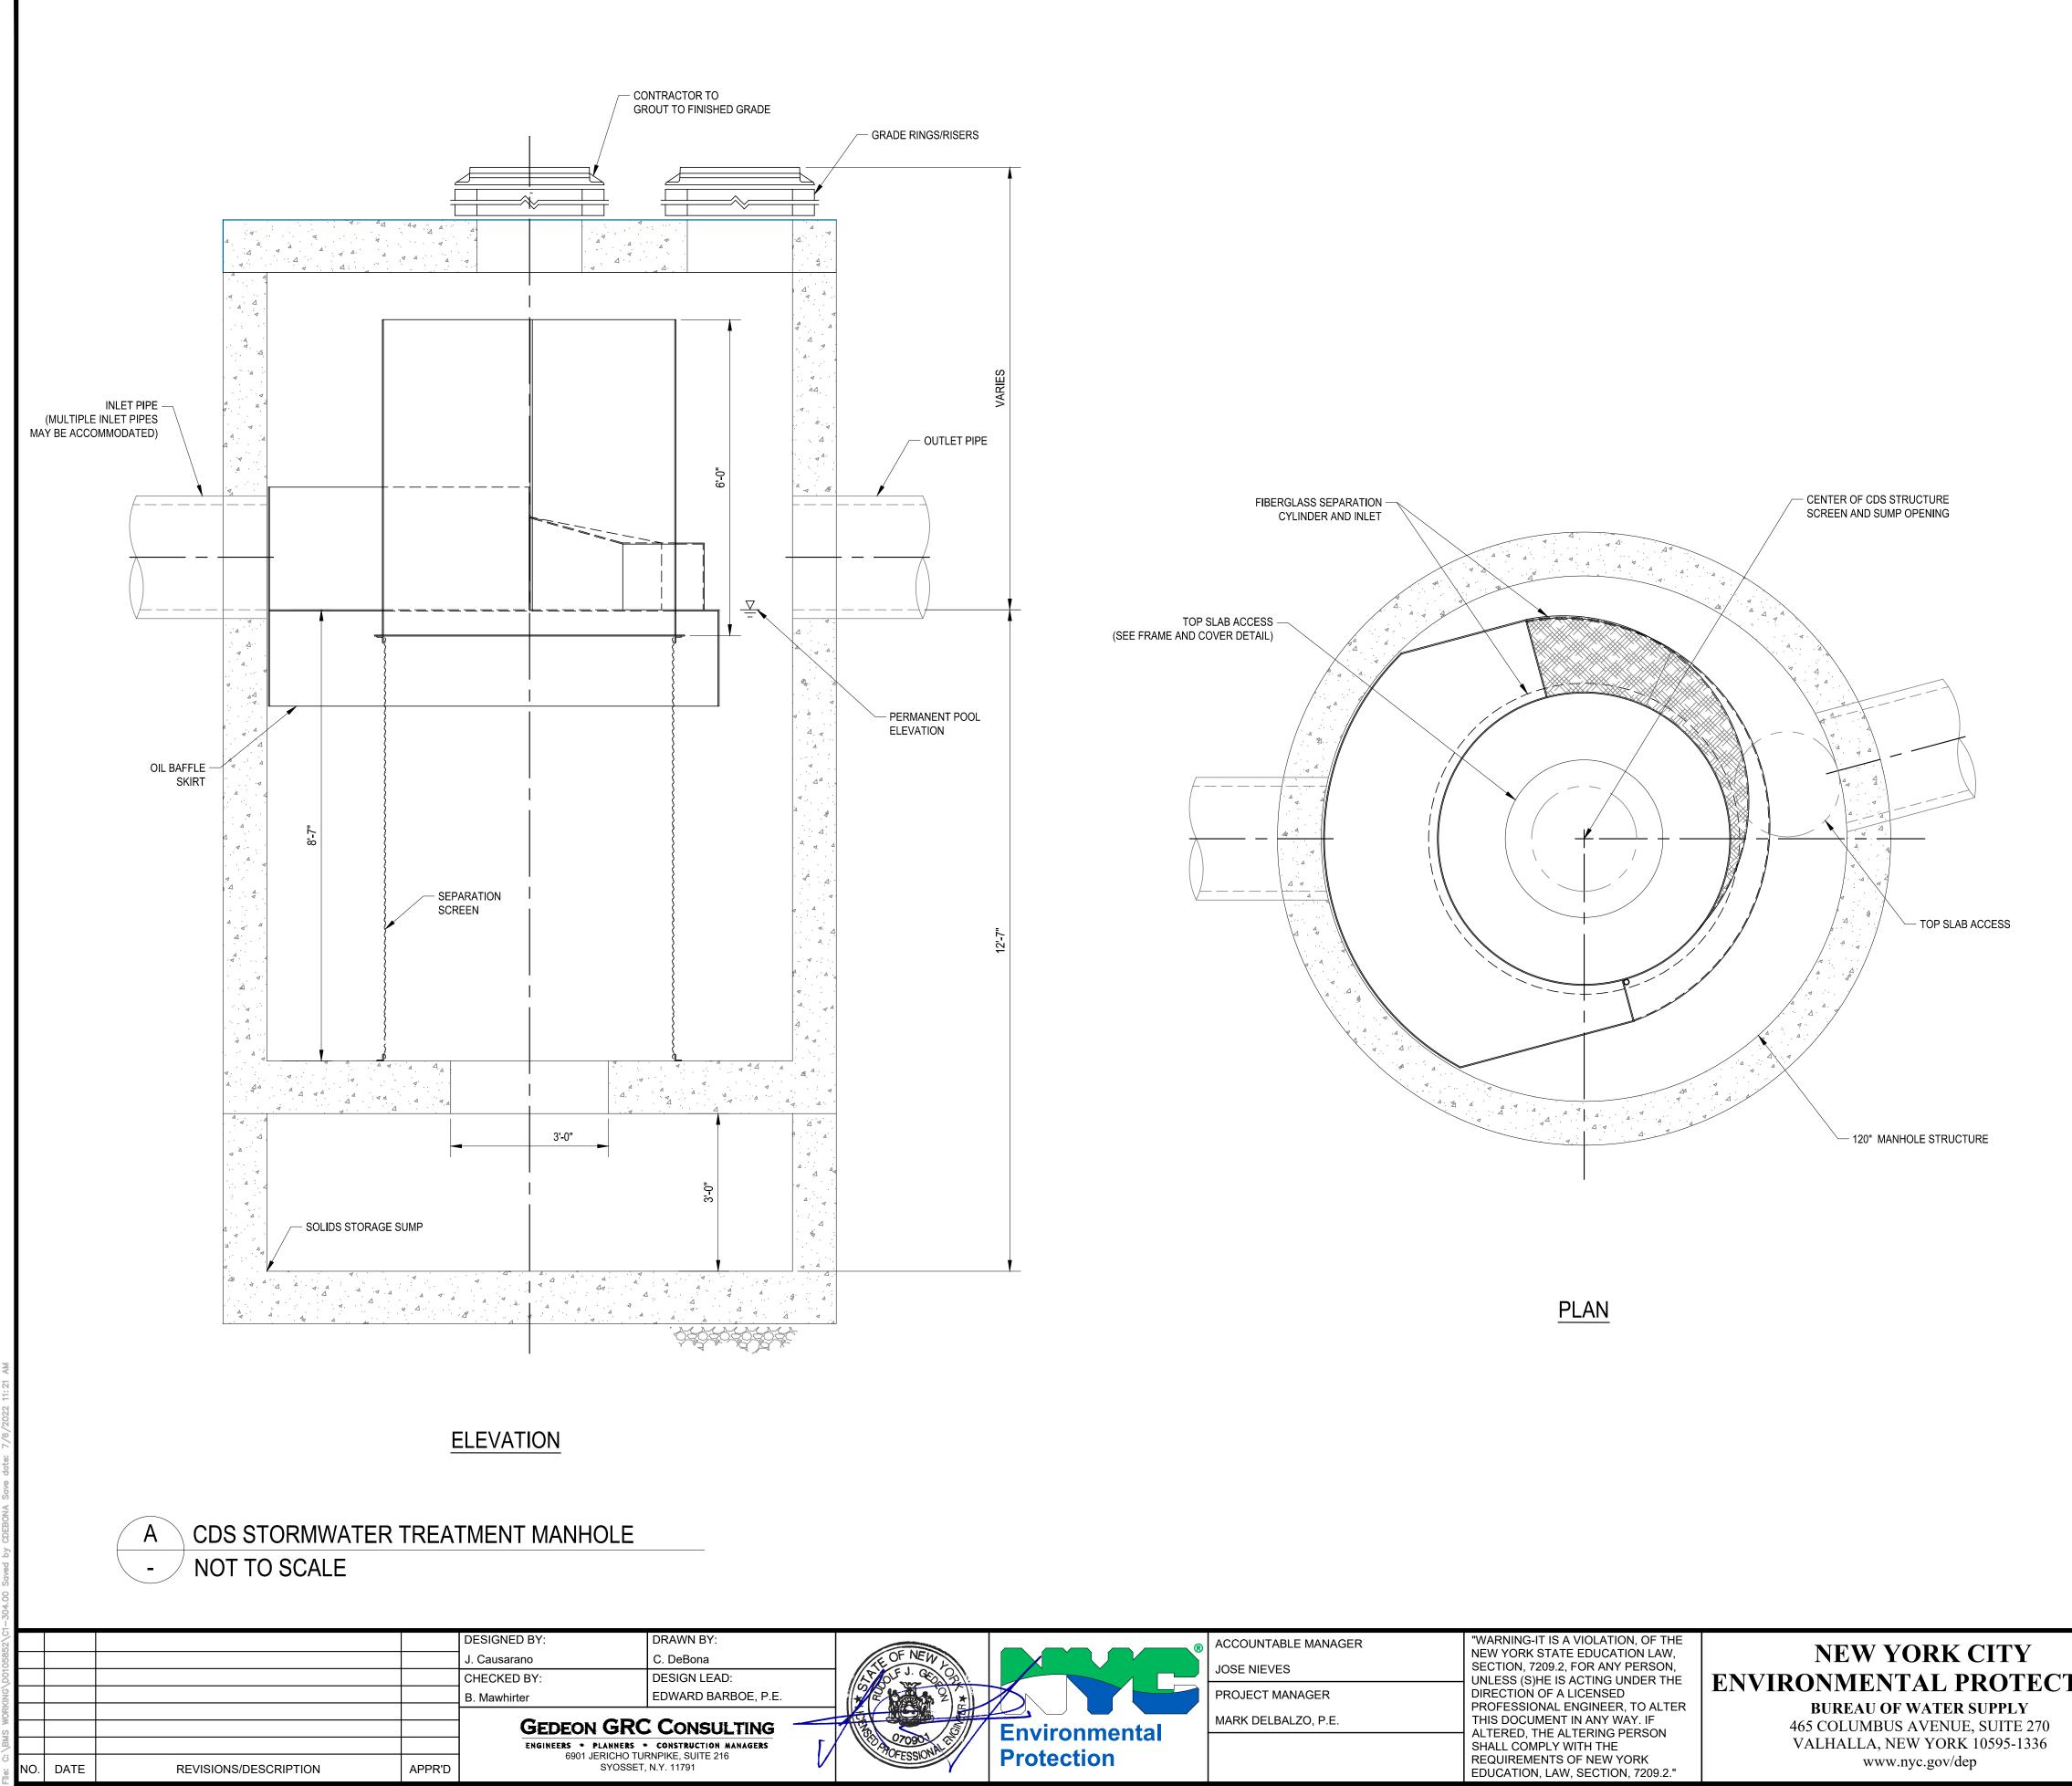


CCOUNTABLE MANAGER	
DSE NIEVES	
ROJECT MANAGER	
ARK DELBALZO, P.E.	


"WARNING-IT IS A VIOLATION, OF THE NEW YORK STATE EDUCATION LAW, SECTION, 7209.2, FOR ANY PERSON, UNLESS (S)HE IS ACTING UNDER THE DIRECTION OF A LICENSED PROFESSIONAL ENGINEER, TO ALTER THIS DOCUMENT IN ANY WAY. IF ALTERED, THE ALTERING PERSON SHALL COMPLY WITH THE REQUIREMENTS OF NEW YORK EDUCATION, LAW, SECTION, 7209.2."

NEW YORK CITY ENVIRONMENTAL PROTEC' BUREAU OF WATER SUPPLY 465 COLUMBUS AVENUE, SUITE 270 VALHALLA, NEW YORK 10595-1336 www.nyc.gov/dep

	BID SET	IF SHEET IS LESS TH/ IT IS A REDUCE SCALE ACCO	D PRINT.
	REPURPOSING OF KENSICO LA	BORATORY AS	DATE: MAY 2023
TION	THE KENSICO REGIONAL HEA	DQUARTERS	SCALE: N.T.S
TION	MOUNT PLEASANT, NEV		SHEET NO:
	CONTRACT CRO-62	24	14 OF No.121
	CIVIL		DRAWING NO.
	DETAILS - 4		C-108




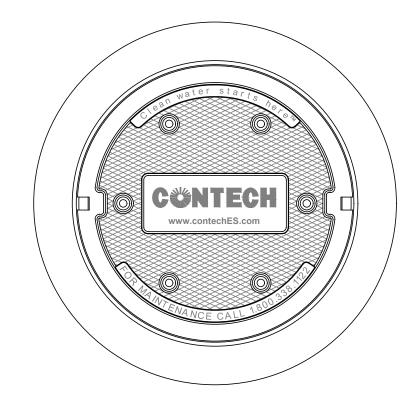All inquiries regarding this drawing(s) or project should be made to NYC Environmental Protection, Bureau of Engineering Design and Construction.



## FRAME AND COVER

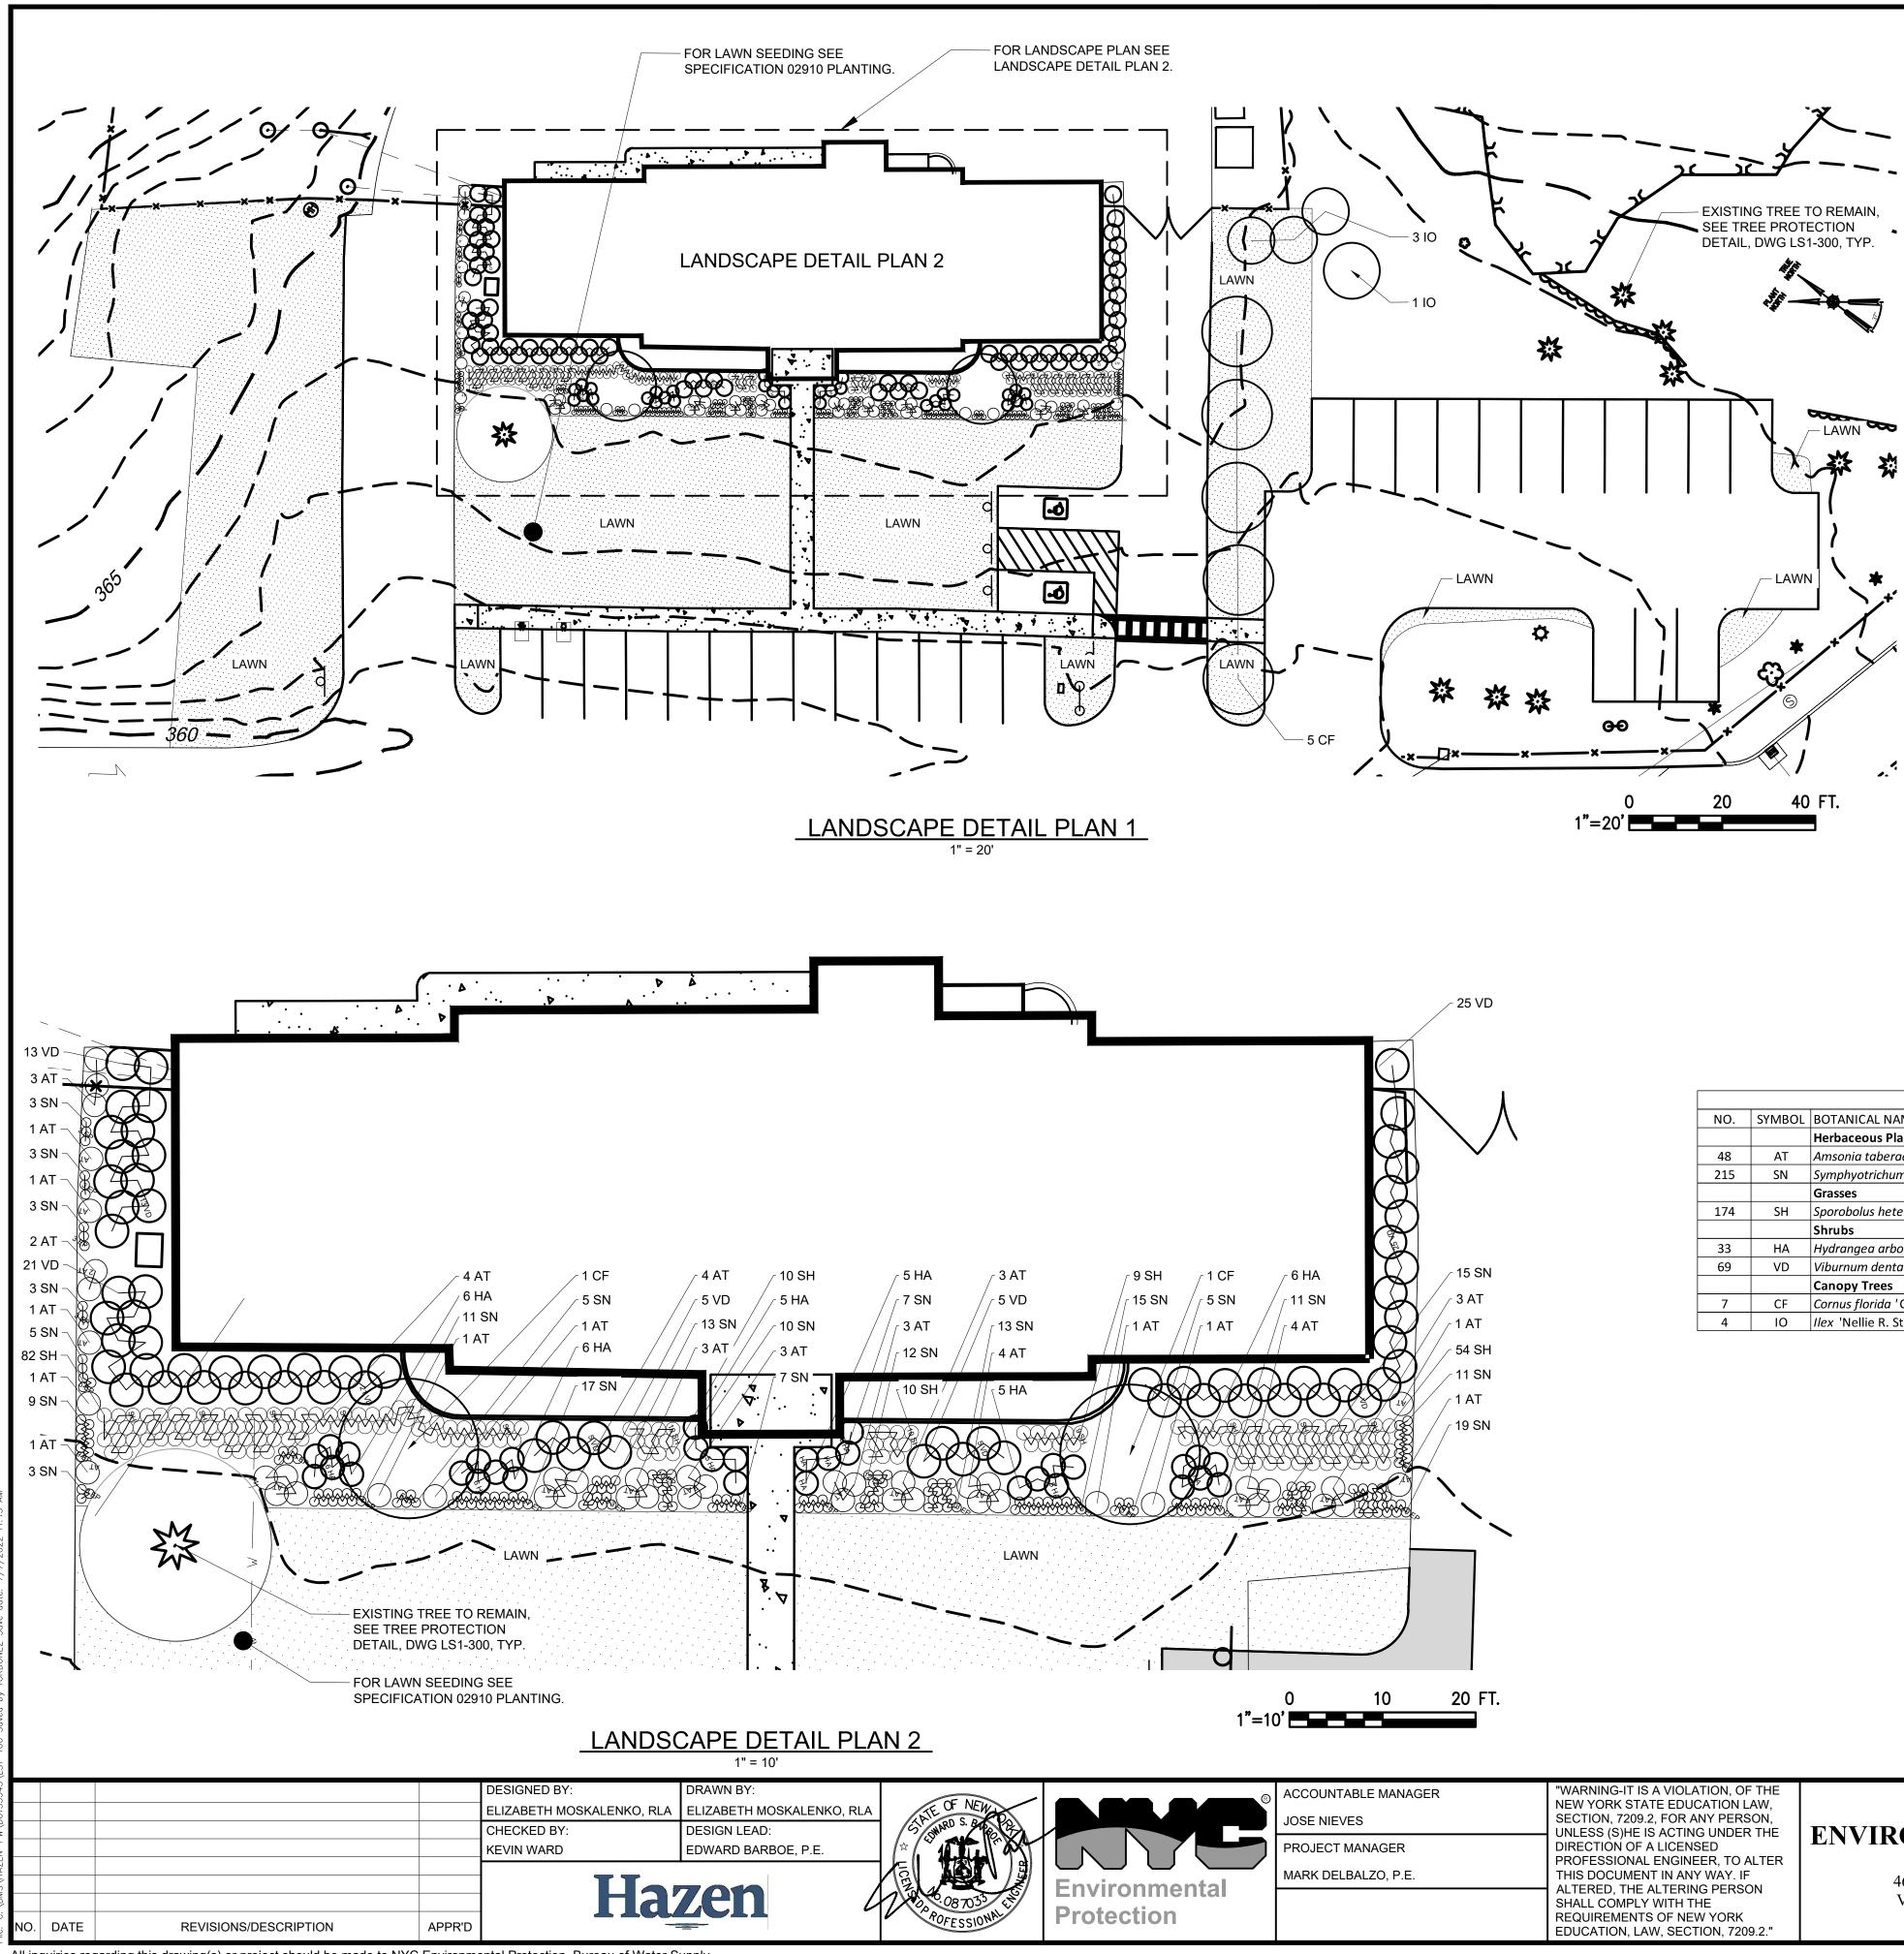	BID SET	IF SHEET IS LESS THAN IT IS A REDUCED SCALE ACCORE	
	REPURPOSING OF KENSICO LA	DATE: MAY 2023	
	THE KENSICO REGIONAL HEA	SCALE: N.T.S	
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	CONTRACT CRO-62	24	15 OF No.121
	CIVIL		DRAWING NO.
	DETAILS - 5		C-109



All inquiries regarding this drawing(s) or project should be made to NYC Environmental Protection, Bureau of Water Supply.

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		F
	Environmental Protection	

## NOTES:

- 4. REFER TO DWG LS1-300 FOR LANDSCAPE DETAILS. AS INDICATED IN SPECIFICATION 02910 PLANTING.

#### SEEDING:

- PLANTING AND SEED SCHEDULE ON DRAWINGS.

#### PLANTING:

- PER THE SPECIFICATION.
- REOUIREMENTS.

- SEEDED AREAS. AT CONTRACTOR'S EXPENSE.

PLANTING SCHEDULE							
NO.	SYMBOL	BOTANICAL NAME	COMMON NAME	SIZE	FORM	SPACING	REMARKS
		Herbaceous Plants					
48	AT	Amsonia taberaemontana	blue star	#1	cont	1.5' O.C.	
215	SN	Symphyotrichum novi-belgii 'Raydon's Favorite'	Raydon's Favorite New York aster	#1	cont	1.5' O.C.	
		Grasses					
174	SH	Sporobolus heterolepsis 'Tara'	Tara prairie dropseed	#1	cont	1.5' O.C.	
		Shrubs					
33	HA	Hydrangea arborescens 'Invincibelle Limetta'	Invincibelle Limetta hydrangea	#5	cont	2.5' O.C.	
69	VD	Viburnum dentatum 'Little Joe'	Little Joe arrowwood	#5	cont	3.5' O.C.	
		Canopy Trees					
7	CF	Cornus florida ' Cherokee Brave'	Cherokee brave dogwood	8-10'	B&B	As shown	limb up to 6'
4	10	<i>llex</i> 'Nellie R. Stevens'	Nellie R. Stevens' holly	8-10'	B&B	As shown	

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1. THE CONTRACTOR SHALL TAKE CARE TO AVOID DAMAGE TO EXISTING PAVEMENT, TREES, VEGETATION, STRUCTURES, AND UTILITIES THAT ARE NOT INDICATED TO BE DEMOLISHED OR REMOVED. ANY DAMAGE TO EXISTING PAVEMENT, TREES, VEGETATION, STRUCTURES, AND UTILITIES NOT INDICATED TO BE DEMOLISHED OR REMOVED SHALL BE REPAIRED AT THE CONTRACTOR'S EXPENSE.

2. ANY AREA OUTSIDE THE LIMITS OF DISTURBANCE IS NOT TO BE AFFECTED BY THE CONTRACT WITHOUT PRE-APPROVAL FROM THE ENGINEER. ANY AREA AFFECTED BY THE CONTRACTOR SHALL BE RESTORED AS PER THE DIRECTION OF THE ENGINEER AT THE CONTRACTOR'S EXPENSE. 3. THE CONTRACTOR SHALL NOT DRIVE ANY VEHICLE OR STORE ANY MATERIALS WITHIN THE DRIPLINE OF ANY EXISTING TREE OR SHRUB TO BE RETAINED. FURTHERMORE, ALL SOFTSCAPE AREAS WITHIN THE WORK LIMITS SHALL BE PROTECTED FROM COMPACTION. CORRECTIVE DECOMPACTION MEASURES SHALL BE TAKEN IN THE CASE OF ANY COMPACTION AT THE DIRECTION OF THE ENGINEER AND AT THE CONTRACTOR'S EXPENSE. ANY DAMAGE TO EXISTING TREES OR VEGETATION SHALL BE REPLACED AT THE CONTRACTOR'S EXPENSE. TREE PROTECTION SHALL BE IN ACCORDANCE WITH SPECIFICATION 02230 - SITE CLEARING AND TREE PROTECTION DETAIL ON DWG LS1-300.

5. UNLESS INDICATED ELSEWHERE, ALL AREAS DISTURBED BY CONSTRUCTION ACTIVITIES SHALL BE SEEDED WITH GRASS SEED FOR LAWN AREAS

1. ALL SCHEDULE, SUBMITTALS, PRODUCTS AND METHODS FOR SEEDING OPERATIONS SHALL BE IN ACCORDANCE WITH SPECIFICATION 02910

2. ALL SEED SHALL BE INTERAGENCY CERTIFIED UNDER THE AUSPICES OF A STATE SEED IMPROVEMENT COOPERATIVE AND SHALL BEAR THEIR SEALS OF CERTIFICATION ON EACH BAG. PERMANENT SEED SHALL BE 75% PURE LIVE SEED MINIMUM.

3. SEED BROUGHT TO THE PROJECT SITE SHALL BE IN UNOPENED BAGS SHOWING THE NET WEIGHT, COMPOSITION OF MIX, SUPPLIERS NAME AND GUARANTEE OF ANALYSIS. SEED SHALL BE STORED IN ORIGINAL UNOPENED PACKAGES, KEPT DRY, AND NOT OPENED UNTIL NEEDED FOR USE. DAMAGED OR FAULTY PACKAGES SHALL NOT BE USED AND WILL BE REJECTED. SEED SHALL BE FRESH, RECLEANED SEED OF THE LATEST CROP AND BE IN CONFORMANCE WITH THE PLANTING SPECIFICATION. ALL SEED MATERIALS SHALL BE PROTECTED FROM DRYING OUT AND FROM WIND DAMAGE DURING DELIVERY. GRASS SEED FOR LAWN AREAS SHALL BE MIX AND RATE AS INDICATED IN SPECIFICATION 02910 PLANTING. 5. SEED MIXTURE SHALL BE INSPECTED BY THE ENGINEER UPON ARRIVAL AT THE JOB SITE AND PRIOR TO INSTALLATION. ANY MATERIALS NOT IN COMPLIANCE WITH THE PLANTING SPECIFICATION WILL NOT BE ACCEPTED AND SHALL BE REMOVED FROM THE JOB SITE IMMEDIATELY. 6. SEEDBED PREPARATIONS AND SEEDING SHALL BE AS STATED IN THE SPECIFICATION 02910 PLANTING.

7. DO NOT BROADCAST SEED BY MECHANICAL APPLICATION WHEN THE WIND VELOCITY IS SUCH TO PREVENT UNIFORM SEED DISTRIBUTION. 8. ALL SEEDED AREAS SHALL BE COVERED WITH ECS-1B SINGLE NET STRAW BIODEGRADABLE ROLLED EROSION CONTROL PRODUCT AS PER PLANTING SPECIFICATION AND EROSION CONTROL MATTING DETAIL, DWG LS1-300.

9. SEEDED AREAS SHALL BE WATERED AT A MINIMUM OF ONCE PER WEEK UNTIL SEED HAS GERMINATED AND BECOME ESTABLISHED. 10. ACCEPTABLE SEEDING ESTABLISHMENT WILL BE 85% COVERAGE OF THE OPEN AREA WITH THE SEEDED SPECIES. ANY AREA NOT MEETING THIS REOUIREMENT SHALL BE RESEEDED WITH THE ORIGINAL SEED MIX.

1. ALL PLANTINGS SHALL BE IN ACCORDANCE WITH THE PLANS AND SPECIFICATIONS. IN THE EVENT THE ACTUAL LIMITS OF SITE CLEARING AND STAGING AREAS DIFFER FROM THOSE SHOWN IN THE PLANS, THE CONTRACTOR SHALL SUBMIT SHOP DRAWINGS FOR PLANTINGS IN CONFORMANCE WITH THE SPECIFICATIONS, SHOP DRAWINGS FOR REVISED PLANTINGS SHALL BE SUBMITTED A MINIMUM OF 90 DAYS IN ADVANCE OF THE PLANTING SEASON WHEN PLANTING IS SCHEDULED TO OCCUR.

2. ALL PLANT MATERIAL TO BE VIGOROUS, FREE OF INJURY OR DEFECTS. ALL PLANT MATERIAL SHALL BE STOCK FROM AN APPROVED NURSERY AS

3. ALL SEED MIXES AND PLANT SOURCES SHALL BE SUBMITTED IN ADVANCE FOR REVIEW AS NOTED IN SPECIFICATION 02910 PLANTING. 4. THE ENGINEER MAY REJECT ANY MATERIAL NOT IN CONFORMANCE WITH THE PLANTING SCHEDULES AND THE PLANTING SPECIFICATION

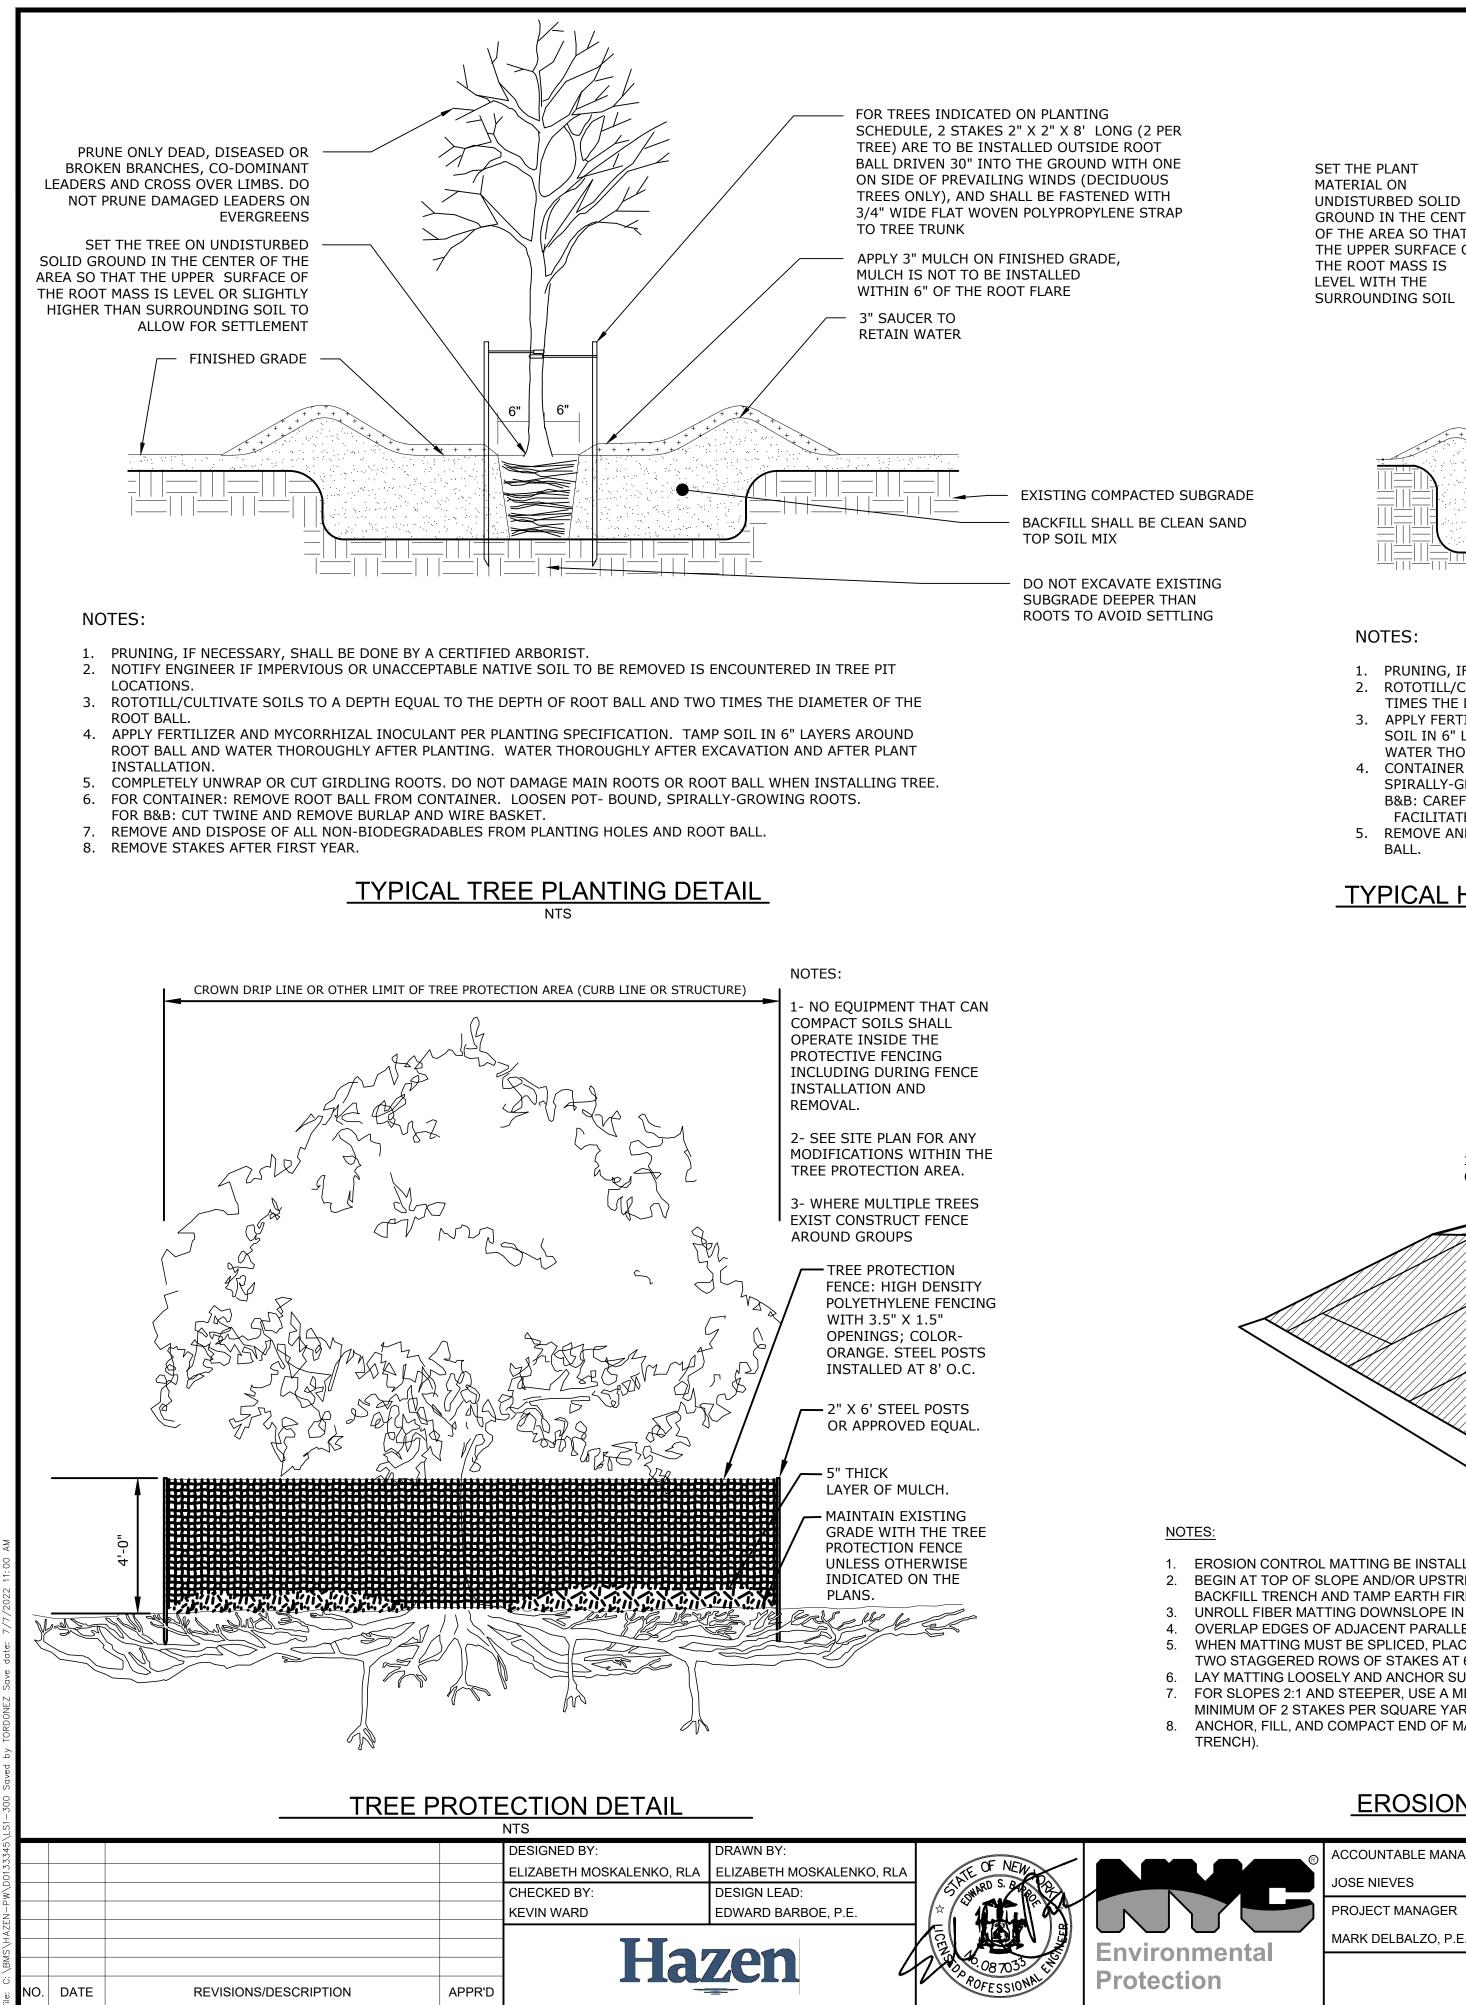
5. THE CONTRACTOR SHALL EXCAVATE AS NEEDED AND PROVIDE TOPSOIL TO ACHIEVE FINISHED GRADES IN ALL AREAS TO BE SEEDED OR OTHERWISE PLANTED. TOPSOIL SHALL BE 6" MINIMUM IN SEEDED AREAS. 6. FERTILIZER SHALL BE APPLIED IN ACCORDANCE WITH SPECIFICATION 02910 PLANTING. FERTILIZER DELIVERED TO THE SITE SHALL BE IN

ORIGINAL, UNOPENED CONTAINERS BEARING THE MANUFACTURER'S CHEMICAL ANALYSIS AND ESSENTIAL INFORMATION. FERTILIZER CONTAINERS SHALL BE PROTECTED FROM EXPOSURE TO PRECIPITATION AND DIRECT SUNLIGHT.

7. PLANTS SHALL BE INSTALLED IN "DRY" CONDITIONS AND NOT WHEN PLANTING LOCATIONS ARE WET OR FROZEN. PRIOR TO INSTALLATION, CONTRACTOR SHALL STAKE OUT AND RECEIVE APPROVAL FROM ENGINEER FOR LOCATIONS OF PLANTINGS. 8. INSTALL MULCH ACROSS ENTIRE PLANTING BEDS INCLUDING ALL AREAS OF TREE, SHRUB, ORNAMENTAL GRASS AND HERBACEOUS PLUG

PLANTING AS PER PLANTING SPECIFICATION AND EACH ASSOCIATED PLANTING DETAIL ON DWG LS1-300. NO MULCH SHALL BE APPLIED TO 9. ANY TREES DAMAGED BY THE CONTRACTOR NOT SCHEDULED TO BE REMOVED SHALL BE REPLACE IN KIND AT THE DIRECTION OF THE ENGINEER

	BID SET		
		IF SHEET IS LESS THA IT IS A REDUCE SCALE ACCO	D PRINT.
	REPURPOSING OF THE KENSICC	) LABORATORY AS	DATE: MAY 2023
	THE KENSICO REGIONAL HE	ADQUARTERS	SCALE:
TION	MOUNT PLEASANT, NE	W YORK	SHEET NO:
	CONTRACT CRO-	624	16 OF No.121
	LANDSCAPE		DRAWING NO.
	PLAN		GL-100



All inquiries regarding this drawing(s) or project should be made to NYC Environmental Protection, Bureau of Water Supply.

CLEAN PRUNE ONLY DAMAGED, GROUND IN THE CENTER DISEASED AND DEAD BRANCHES OF THE AREA SO THAT THE UPPER SURFACE OF APPLY 3" MULCH ON FINISHED GRADE, THE ROOT MASS IS LEVEL WITH THE SURROUNDING SOIL **3" SAUCER TO** RETAIN WATER + + + TOPSOIL MIX <u>- | | | - - - - | | | - - - - | | |</u>-

MULCH IS NOT TO BE INSTALLED WITHIN 6" OF THE STEM(S)

FINISHED GRADE AROUND PLANT TO BE THE SAME AS ORIGINAL GRADE OF PLANT IN POT

> EXISTING COMPACTED SUBGRADE BACKFILL SHALL BE CLEAN SAND

DO NOT EXCAVATE EXISTING SUBGRADE DEEPER THAN ROOTS

TO AVOID SETTLING

TIMES THE DIAMETER OF THE ROOT BALL.


1. PRUNING, IF NECESSARY, SHALL BE DONE BY A CERTIFIED ARBORIST.

APPLY FERTILIZER AND MYCORRHIZAL INOCULANT PER PLANTING SPECIFICATION. TAMP 3.

2. ROTOTILL/CULTIVATE SOILS TO A DEPTH EQUAL TO THE DEPTH OF ROOT BALL AND TWO

- SOIL IN 6" LAYERS AROUND ROOT BALL AND WATER THOROUGHLY AFTER PLANTING. WATER THOROUGHLY AFTER EXCAVATION AND AFTER PLANT INSTALLATION.
- 4. CONTAINER: REMOVE ROOT BALL FROM CONTAINER. LOOSEN POT- BOUND, SPIRALLY-GROWING AND GIRDLING ROOTS.
- B&B: CAREFULLY REMOVE TOP 1/3 OF BURLAP. CUT SEVERAL SLITS IN BURLAP TO FACILITATE ROOT PENETRATION
- REMOVE AND DISPOSE OF ALL NON-BIODEGRADABLES FROM PLANTING HOLES AND ROOT
- BALL.

## **TYPICAL HERBACEOUS/GRASS/SHRUB PLANTING DETAIL**

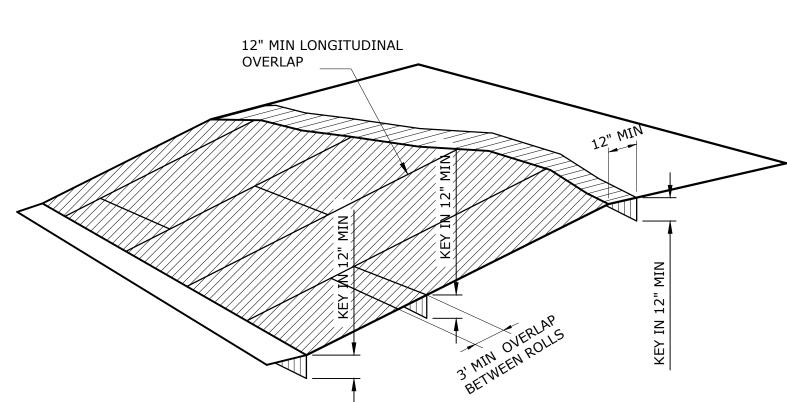


EROSION CONTROL MATTING BE INSTALLED FOR ALL SEEDED AREAS.

NOTES:

- 2. BEGIN AT TOP OF SLOPE AND/OR UPSTREAM AND ANCHOR FIBER MATTING IN A 12 INCH DEEP INITIAL ANCHOR TRENCH.
- BACKFILL TRENCH AND TAMP EARTH FIRMLY. 3. UNROLL FIBER MATTING DOWNSLOPE IN THE DIRECTION OF WATER FLOW.
- 4. OVERLAP EDGES OF ADJACENT PARALLEL ROLLS A MINIMUM 12 INCHES AND ANCHOR AT 12 INCHES O.C.
- WHEN MATTING MUST BE SPLICED, PLACE END OVER END (SHINGLE STYLE) WITH 12 INCH OVERLAP AND ANCHOR USING
- TWO STAGGERED ROWS OF STAKES AT 6 INCHES O.C. LAY MATTING LOOSELY AND ANCHOR SUFFICIENTLY TO MAINTAIN DIRECT CONTACT WITH THE SOIL. DO NOT STRETCH.
- 7. FOR SLOPES 2:1 AND STEEPER, USE A MINIMUM 3 STAKES PER SQUARE YARD AND FOR SLOPES FLATTER THAN 2:1, USE A
- MINIMUM OF 2 STAKES PER SQUARE YARD. 8. ANCHOR, FILL, AND COMPACT END OF MATTING IN A 12X6 INCH TERMINAL ANCHOR TRENCH (MIRROR IMAGE OF EXISTING

#### **EROSION CONTROL MATTING DETAIL** NTS

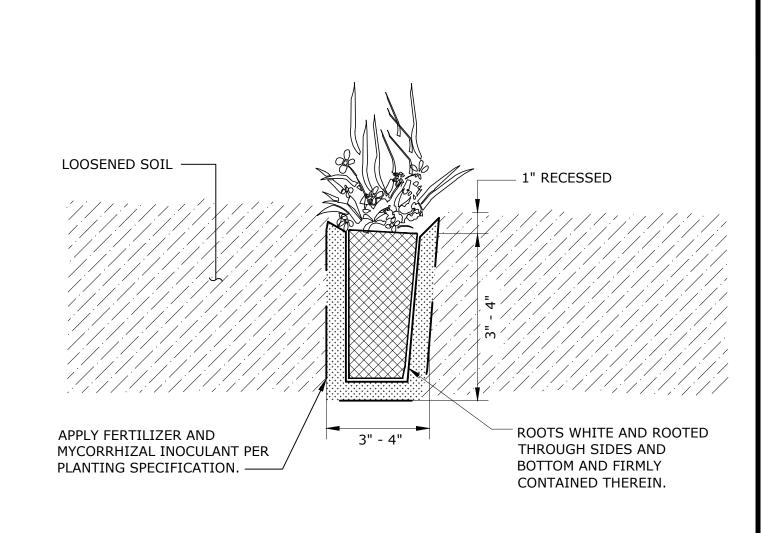	110		
®	ACCOUNTABLE MANAGER	"WARNING-IT IS A VIOLATION, OF THE NEW YORK STATE EDUCATION LAW,	NEW YORK CITY
	JOSE NIEVES	SECTION, 7209.2, FOR ANY PERSON, UNLESS (S)HE IS ACTING UNDER THE	ENVIRONMENTAL PROTECT
	PROJECT MANAGER	DIRECTION OF A LICENSED	
	MARK DELBALZO, P.E.	PROFESSIONAL ENGINEER, TO ALTER THIS DOCUMENT IN ANY WAY. IF	BUREAU OF WATER SUPPLY 465 COLUMBUS AVENUE, SUITE 270
		ALTERED, THE ALTERING PERSON SHALL COMPLY WITH THE	VALHALLA, NEW YORK 10595-1336
		REQUIREMENTS OF NEW YORK EDUCATION, LAW, SECTION, 7209.2."	www.nyc.gov/dep



#### NOTES:

- ALL PLASTIC WRAP SHALL BE REMOVED PRIOR TO PLANTING. CAREFULLY FIRM PLUG INTO PLACE AFTER PLANTING BY LIGHTLY 2. TAMPING.
- 3. IF NOT PLANTED IMMEDIATELY AFTER DELIVERED TO JOB SITE, THE PLANTS SHALL BE STORED OUT OF DIRECT SUNLIGHT AND WIND WITH THEIR POTS AND ASSOCIATED ROOT MASSES MAINTAINED MOIST THROUGH PERIODIC WATERING UNTIL THE TIME OF PLANTING.

#### **TYPICAL PLUG PLANTING DETAIL** NTS

	BID SET		
		IF SHEET IS LESS TH/ IT IS A REDUCE SCALE ACCO	D PRINT.
	REPURPOSING OF THE KENSICO	D LABORATORY AS	DATE: MAY 2023
	THE KENSICO REGIONAL HE	SCALE:	
ΓΙΟΝ	MOUNT PLEASANT, NE	SHEET NO:	
	CONTRACT CRO-	624	17 OF No.121
	LANDSCAPE		DRAWING NO.
	DETAILS		LS1-300

### Summary of Confirmed Hazardous Materials for the Basement, Crawlspace

#### Lead and PCBs

Material Description	Location	Hazard	Quantity	Sample ID
Black paint*	Drain pipe	Lead-based, TSCA-regulated PCBs	28 linear ft	CAT423-BASE-PC-18
Brown paint*	Drain pipe	Lead-based, TSCA-regulated PCBs	286 linear ft	CAT423-BASE-PC-19
Green paint*	Pipe	Lead-based, TSCA-regulated PCBs	110 linear ft	CAT423-BASE-PC-21
Yellow paint*	Pipe	Lead-based, TSCA-regulated PCBs	88 linear ft (2 pipes)	CAT423-BASE-PC-22
Blue paint*	Pipe	Lead-based, PCB-containing		CAT423-BASE-PC-20
Lead packing	Drain pipes	Lead joints	143 locations	

#### Asbestos

Material Description Locat	tion Sample II	D Quant	tity Co	ondition F	riability
Brown 4" gasket Pipe	CAT423-B/	ASE-ASB-94,95 3.5 ft <sup>2</sup>	<sup>2</sup> (7 locations) Da	amaged N	lon-friable

## Universal and other Miscellaneous Wastes

Material Description	Location	Quantity	Waste Classification
Chemical waste tank (concrete)	Crawlspace	1 (approx. 200 gal)	Mercury and corrosive hazardous waste**

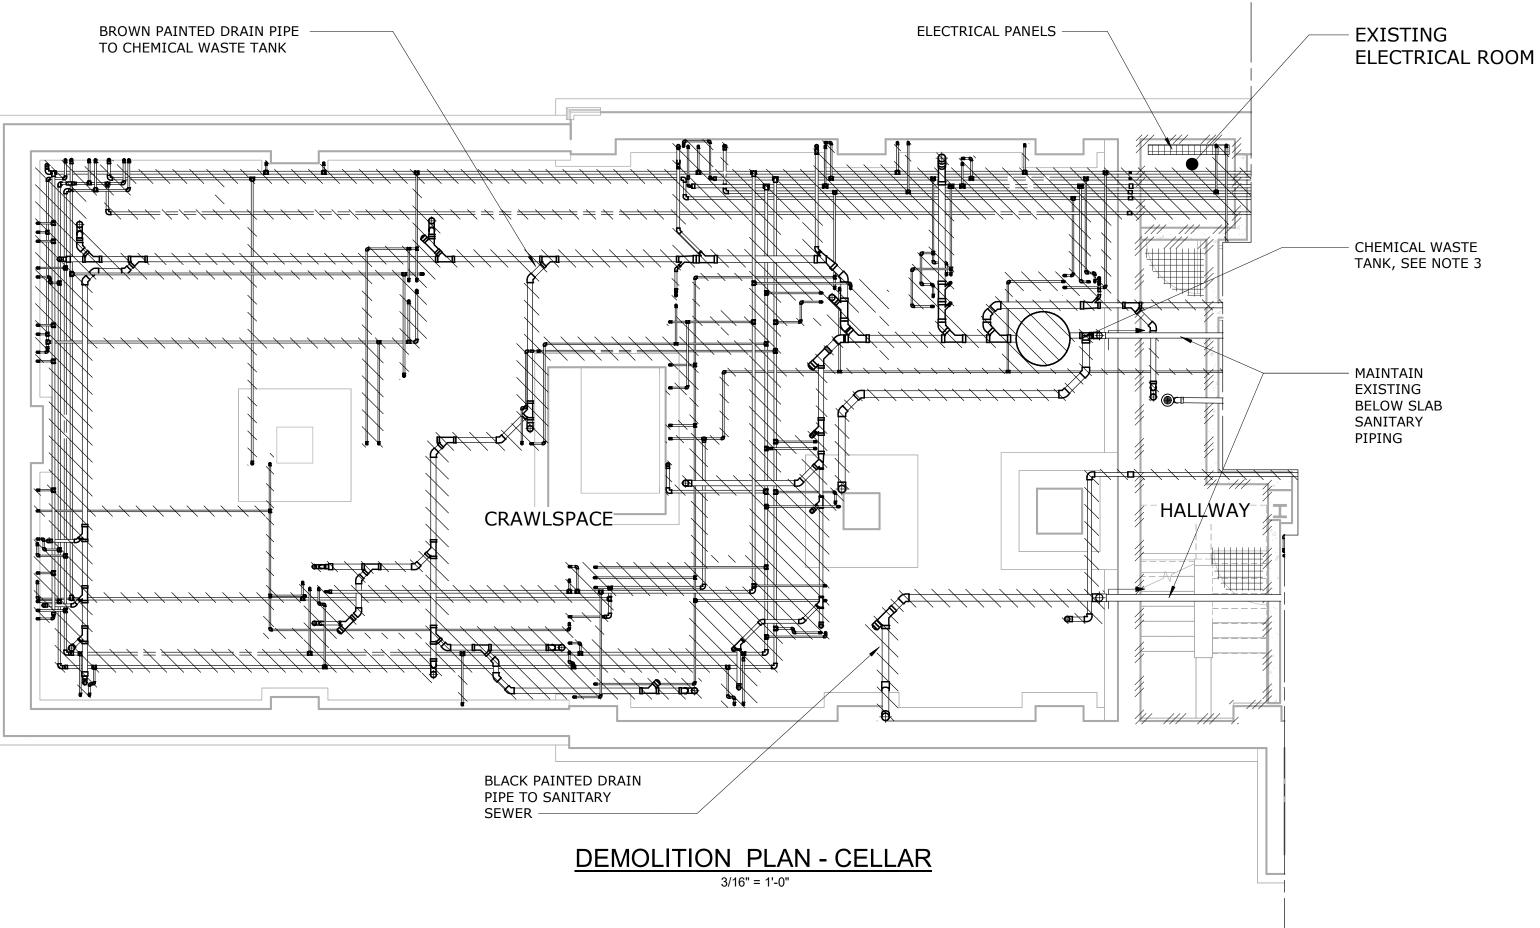
#### Notes:

\* - Paints are in poor condition.

\*\* - Contents of chemical waste tank were not investigated during survey.



ASBESTOS-CONTAINING BROWN 4" GASKET IN THE BASEMENT, CRAWLSPACE (CAT423-BASE-ASB-94,95).



#### <u>LEGEND</u>

PIPING / DUCT / PAINT TO BE REMOVED CONTAINS LEAD. SEE TABLES FOR PAINTS CONTAINING PCBS

REMOVE EXISTING FINISHES. WALL PAINT CONTAINS LEAD. SEE TABLES FOR PAINTS CONTAINING PCBS

CONTAINS ASBESTOS AND TO BE REMOVED. SEE TABLES FOR CONDITION AND FRIABILITY

				DESIGNED BY: R. NEUMANN, P.E.	DRAWN BY: M. LOPEZ	STE OF NEW
				CHECKED BY:	DESIGN LEAD:	STANARD S. 64
				E. BARBOE, P.E.	E. BARBOE, P.E.	
				H	azen	0.08 TO 33
NO.	DATE	<b>REVISIONS/DESCRIPTION</b>	APPR'D			I OFESSION

### Summary of Confirmed Hazardous Materials for the Basement, Hallway

## Summary of Confirmed Hazardous Materials for the Basement, Electrical Room

### Lead and PCBs

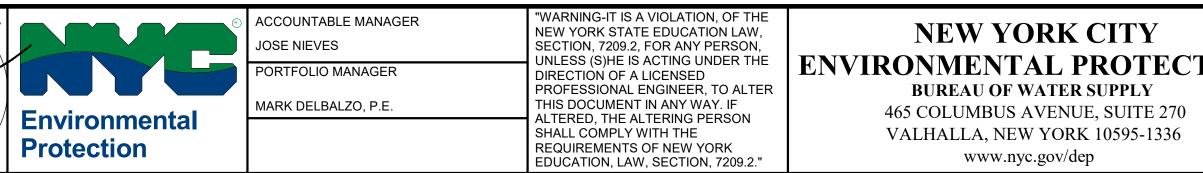
Material Description	Location	Hazard	Quantity	Sample ID
Brown paint	Drain pipe (4")	Lead-based, TSCA-regulated PCBs	15 linear ft	CAT423-BASE-PC-19
Blue paint	Pipe	Lead-based, PCB-containing		CAT423-BASE-PC-20
White paint	Walls	Lead-based, PCB-containing		CAT423-1ST-PC-13
Grey/blue paint	Floor	Lead-containing		CAT423-1ST-PC-09
Lead packing	Drain pipes	Lead joints	7 locations	

#### Asbestos

Material Description	Location	Sample ID	Quantity	Condition	Friability
Black tar	Floor	2E	2 ft <sup>2</sup>	Damaged	Non-friable

#### Universal and other Miscellaneous Wastes

Material Description	Location	Quantity	Waste Classification
Exit/Emergency light	Wall	2 bulbs	Universal waste
		1 circuit board	Electronic waste
		1 lead battery	Universal waste
Fire extinguisher	Wall	1	Regulated waste



Location	Hazard	Sample ID
Wall/ceiling	Lead-based, PCB-containing	CAT423-BASE-PC-14
Floor	Lead-containing	CAT423-1ST-PC-09
Electrical panels	Lead-containing, PCB-containing	CAT423-BASE-PC-15
Door	PCB-containing	CAT423-1ST-PCB-11

Location	Sample ID	Quantity	Condition	Friability
Electrical panels		20 ft <sup>2</sup> (2 locations)	Unknown	Unknown
Door	191-06-01	20 linear ft	Good	Non-friable

\* - Item is presumed to be present and asbestos containing.

Lead and PCBs

Beige paint

Grey/blue paint Grey/silver paint

Door closer oil

Asbestos

Grey caulk\*\*

Notes:

Material Description

Material Description

Transite arc panels\*

\*\* - Caulk is presumed to be present under the entire steel frame (approx. 8" wide).



LEAD-BASED AND TSCA-REGULATED PCB BLUE PIPE PAINT IN THE BASEMENT, CRAWLSPACE (CAT423-BASE-PC-20)

- 1. ALL REMOVAL AND ABATEMENT WORK SHALL BE DOWN TO THE BARE SUBSTRATE AND COMPLETED IN ACCORDANCE WITH DETAILED SPECIFICATIONS 01355 - HAZARDOUS MATERIALS CONTROL, AND SPECIFICATIONS 13281- ASBESTOS MANAGEMENT, 13282 - MERCURY MANAGEMENT, 13283 - LEAD MANAGEMENT, AND 13284 - PCB MANAGEMENT, AS WELL AS FEDERAL, STATE, AND LOCAL REGULATIONS AS APPLICABLE.
- 2. REFER TO THE HAZARDOUS MATERIAL SURVEY REPORT FOR THE KENSICO LABORTORY, REV. 1, MAY 2018, PREPARED BY BIDWELL ENVIRONMENTAL, LLC FOR SUMMARY OF SAMPLING LOCATIONS OF SUSPECT HAZARDOUS MATERIALS.
- 3. REMOVAL AND DISPOSAL OF CHEMICAL WASTE TANK AND ASSOCIATED PIPING SHALL BE IN ACCORDANCE WITH DETAILED SPECIFICATION 02116 - ABOVE GROUND STORAGE TANK REMOVAL AND DISPOSAL.
- 4. DUE TO THE UNKNOWN SOURCE OF THE ASBESTOS-CONTAINING BLACK TAR, THE CONTRACTOR SHALL SURVEY THE BASEMENT TO CONFIRM LOCATIONS AND QUANTITIES PRIOR TO REMOVAL.
- 5. CRAWLSPACE IS CONSIDERED A NON-PERMIT REQUIRED CONFINED SPACE.
- 6. MATERIALS CONTAINING < 5,000 MG/KG OR ≥ 5,000 MG/KG LEAD ARE CONSIDERED LEAD-CONTAINING OR LEAD-BASED, RESPECTIVELY.
- 7. MATERIALS CONTAINING < 50 MG/KG OR ≥50 MG/KG PCBS ARE CONSIDERED PCB-CONTAINING OR TSCA-REGULATED, RESPECTIVELY.
- 8. MATERIALS CONTAINING MORE THAN 1% ASBESTOS ARE CONSIDERED ASBESTOS-CONTAINING MATERIALS.
- 9. QUANTITIES AND LOCATIONS ARE APPROXIMATE FOR ASBESTOS-CONTAINING MATERIALS, TSCA-REGULATED PCBS AND UNIVERSAL OTHER REGULATED MATERIALS AND SHOULD BE FIELD VERIFIED BY THE CONTRACTOR.
- 10. EXISTING SANITARY PIPES AND FLOOR DRAINS THAT ARE AT OR BELOW SLAB ELEVATION TO BE MAINTAINED. ALL OTHER PIPES BELOW THE CONCRETE SLAB SHALL BE ABANDONED AND CAPPED.
- 11. ALL HOLES CREATED BY REMOVED PIPES TO BE FILLED. REFER TO S-501 FOR REPAIR DETAIL.

	BID SET	GRAPHIC SCALES CHECK BEFORE USE		
		IF SHEET IS LESS IT IS A REDUCI SCALE ACCO	ED PRINT.	
	REPURPOSING OF THE KENSICC	DATE: MAY 2023		
ΓΙΟΝ	THE KENSICO REGIONAL HE MOUNT PLEASANT, NE	SCALE: SHEET NO:		
	CONTRACT CRO-624		18 OF No. 121	
	HAZMAT	DRAWING NO.		
	EXISTING CELLAR - DEMOL	HZ-100		

### Summary of Confirmed Hazardous Materials for the Basement, Storage Room

#### Lead and PCBs

Material Description	Location	Hazard	Quantity	Sample ID
Black paint*	Drain pipe (4")	Lead-based, TSCA-regulated PCBs	38 linear ft	CAT423-BASE-PC-18
Brown paint*	Drain pipe (4")	Lead-based, TSCA-regulated PCBs	13 linear ft	CAT423-BASE-PC-19
Green paint*	Pipe (2")	Lead-based, TSCA-regulated PCBs	20 linear ft	CAT423-BASE-PC-21
Yellow paint*	Pipe (2")	Lead-based, TSCA-regulated PCBs	38 linear ft	CAT423-BASE-PC-22
White paint	Ceiling	Lead-based, PCB-containing		CAT423-BASE-PC-13
Blue paint*	Pipe	Lead-based, PCB-containing		CAT423-BASE-PC-20
Beige paint	Walls	Lead-based, PCB-containing		CAT423-BASE-PC-14
Green paint	Floor	Lead-containing, PCB-containing		CAT423-BASE-PC-12
Lead packing	Drain pipes	Lead joints	23 locations	
Door closer oil	Door	PCB-containing		CAT423-1ST-PCB-11

#### Asbestos

Material Description	Location	Sample ID	Quantity	Condition	Friability
Black tar coating	Floor	2E	4 ft <sup>2</sup>	Damaged	Non-friable
Grey caulk**	Interior door	191-06-01	16 linear ft	Good	Non-friable
Grey caulk**	Exterior door	1, 2, 3	20 linear ft	Good	Non-friable

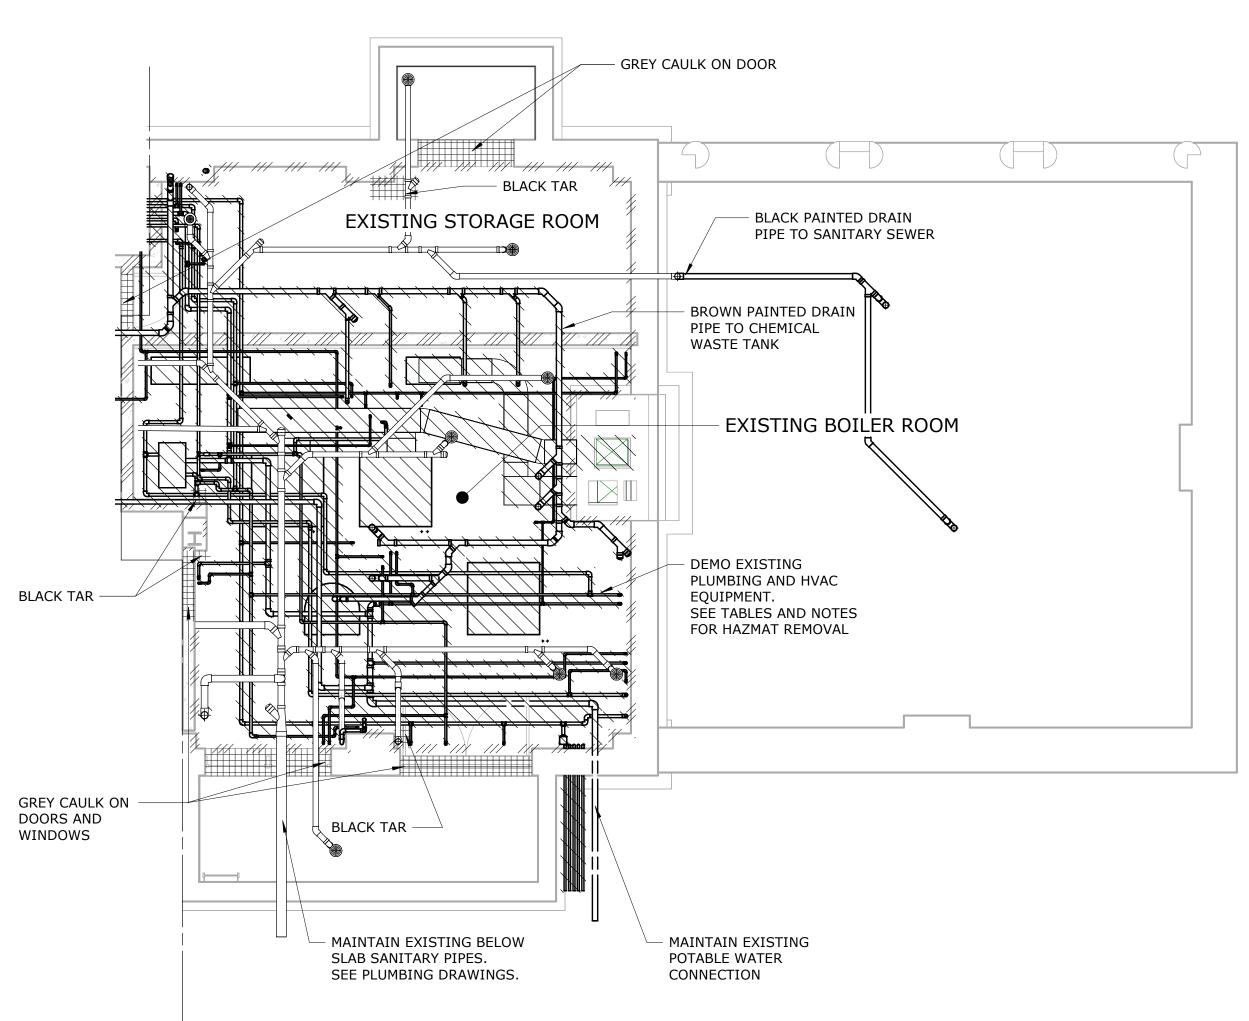
Notes:

\* - Paints are in poor condition.

\*\* - Caulk is presumed to be present under the entire steel frame (approx. 8" wide).



LEAD-CONTAINING, PCB-CONTAINING FLOOR PAINT IN BASEMENT, STORAGE ROOM (CAT423-BASE-PC-12).



#### LEGEND

PIPING / DUCT / PAINT TO BE REMOVED CONTAINS LEAD. SEE TABLES FOR PAINTS CONTAINING PCBS

REMOVE EXISTING FINISHES. WALL PAINT CONTAINS LEAD. SEE TABLES FOR PAINTS CONTAINING PCBS

CONTAINS ASBESTOS AND TO BE REMOVED. SEE TABLES FOR CONDITION AND FRIABILITY

3 9:16:03 AM				E. BARBOE, P.E.	E. BARBOE, P.E.	
NO.	DATE	REVISIONS/DESCRIPTION	APPR'D			ROFESSIONAL

All inquiries regarding this drawing(s) or project should be made to NYC Environmental Protection, Bureau of Water Supply.

## Summary of Confirmed Hazardous Materials for the Basement, Boiler Room

#### Lead and PCBs

Material Description	Location	Hazard	Quantity	Sample ID
Black paint	Duct work	Lead-containing		191-01-LCP-01
Silver paint	Boiler	Lead-containing		191-01-LCP-02
White paint	Walls	Lead-based, PCB-containing		264428.08
Green paint	Floor	Lead-containing, PCB-containing		CAT423-BASE-PC-12
Green paint*	Pipes (2")	Lead-based, TSCA-regulated PCBs	60 linear ft	CAT423-BASE-PC-21
Yellow paint*	Pipes (2")	Lead-based, TSCA-regulated PCBs	60 linear ft	CAT423-BASE-PC-22
Grey/silver paint	Electrical panel	Lead-containing, PCB-containing		CAT423-BASE-PC-15
Black paint	Drain pipe	Lead-containing, PCB-containing		CAT423-BASE-PC-11
Grey caulk	Interior door	PCB-containing		CAT423-BASE-PCB-02
Lead packing	Drain pipes	Lead joints	36 locations	
Door closer oil	Door	PCB-containing		CAT423-1ST-PCB-11



Material Description	Location	Sample ID	Quantity	Condition	Friability
Grey caulk**	Interior door	191-06-01	20 linear ft	Good	Non-Friable
Grey caulk**	Exterior door	1, 2, 3	26 linear ft	Good	Non-Friable
Grey caulk	Window	1, 2, 3	22 linear ft	Good	Non-Friable
Transite arc panels***	Electrical panel		33 ft <sup>2</sup> (3 locations)	Good	Non-Friable
Black tar	Floor	2E	4 ft <sup>2</sup> (3 locations)	Damaged	Non-Friable
White insulation****	Pipe		11 linear ft (5 locations)	Damaged	Friable

### Universal and other Miscellaneous Wastes

Material Description	Location	Quantity	Waste Classification
Exit/Emergency light	Wall	2 bulbs	Universal waste
		1 circuit board	Electronic waste
		1 lead battery	Universal waste
Fire extinguisher	Wall	1	Regulated waste
			-

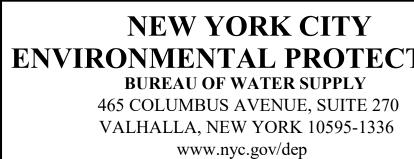
#### Notes:

\* - Paint is in poor condition. \*\*\* - Item is presumed to be present and asbestos containing.





"WARNING-IT IS A VIOLATION, OF THE NEW YORK STATE EDUCATION LAW, SECTION, 7209.2, FOR ANY PERSON, UNLESS (S)HE IS ACTING UNDER THE DIRECTION OF A LICENSED PROFESSIONAL ENGINEER, TO ALTER THIS DOCUMENT IN ANY WAY. IF ALTERED, THE ALTERING PERSON SHALL COMPLY WITH THE REQUIREMENTS OF NEW YORK EDUCATION, LAW, SECTION, 7209.2."




\*\* - Caulk is presumed to be present under the entire steel frame (approx. 8" wide).

\*\*\*\* - Insulation extends through the wall into the Basement, Storage Room and is presumed asbestos containing.

- 1. ALL REMOVAL AND ABATEMENT WORK SHALL BE DOWN TO THE BARE SUBSTRATE AND COMPLETED IN ACCORDANCE WITH DETAILED SPECIFICATIONS 01355 - HAZARDOUS MATERIALS CONTROL, AND SPECIFICATIONS 13281- ASBESTOS MANAGEMENT, 13282 - MERCURY MANAGEMENT, 13283 - LEAD MANAGEMENT, AND 13284 - PCB MANAGEMENT, AS WELL AS FEDERAL, STATE, AND LOCAL REGULATIONS AS APPLICABLE.
- 2. REFER TO THE HAZARDOUS MATERIAL SURVEY REPORT FOR THE KENSICO LABORTORY, REV. 1, MAY 2018, PREPARED BY BIDWELL ENVIRONMENTAL, LLC FOR SUMMARY OF SAMPLING LOCATIONS OF SUSPECT HAZARDOUS MATERIALS.
- 3. REMOVAL AND DISPOSAL OF CHEMICAL WASTE TANK AND ASSOCIATED PIPING SHALL BE IN ACCORDANCE WITH DETAILED SPECIFICATION 02116 - ABOVE GROUND STORAGE TANK REMOVAL AND DISPOSAL.
- 4. DUE TO THE UNKNOWN SOURCE OF THE ASBESTOS-CONTAINING BLACK TAR, THE CONTRACTOR SHALL SURVEY THE BASEMENT TO CONFIRM LOCATIONS AND QUANTITIES PRIOR TO REMOVAL.
- 5. CRAWLSPACE IS CONSIDERED A NON-PERMIT REQUIRED CONFINED SPACE.
- 6. MATERIALS CONTAINING < 5,000 MG/KG OR ≥ 5,000 MG/KG LEAD ARE CONSIDERED LEAD-CONTAINING OR LEAD-BASED, RESPECTIVELY.
- 7. MATERIALS CONTAINING < 50 MG/KG OR ≥50 MG/KG PCBS ARE CONSIDERED PCB-CONTAINING OR TSCA-REGULATED, RESPECTIVELY.
- 8. MATERIALS CONTAINING MORE THAN 1% ASBESTOS ARE CONSIDERED ASBESTOS-CONTAINING MATERIALS.
- 9. QUANTITIES AND LOCATIONS ARE APPROXIMATE FOR ASBESTOS-CONTAINING MATERIALS, TSCA-REGULATED PCBS AND UNIVERSAL OTHER REGULATED MATERIALS AND SHOULD BE FIELD VERIFIED BY THE CONTRACTOR.
- 10. EXISTING SANITARY PIPES AND FLOOR DRAINS THAT ARE AT OR BELOW SLAB ELEVATION TO BE MAINTAINED. ALL OTHER PIPES BELOW THE CONCRETE SLAB SHALL BE ABANDONED AND CAPPED.
- 11. ALL HOLES CREATED BY REMOVED PIPES TO BE FILLED. REFER TO S-501 FOR REPAIR DETAIL.

	BID SET	GRAPHIC S CHECK BEFC	
		IF SHEET IS LESS IT IS A REDUCI SCALE ACCO	ED PRINT.
	REPURPOSING OF THE KENSICO	DATE: MAY 2023	
TION	THE KENSICO REGIONAL HE MOUNT PLEASANT, NE CONTRACT CRO-	SCALE: SHEET NO: 19 OF No. 121	
	HAZMAT EXISTING CELLAR - DEMOL	DRAWING NO. HZ-101	

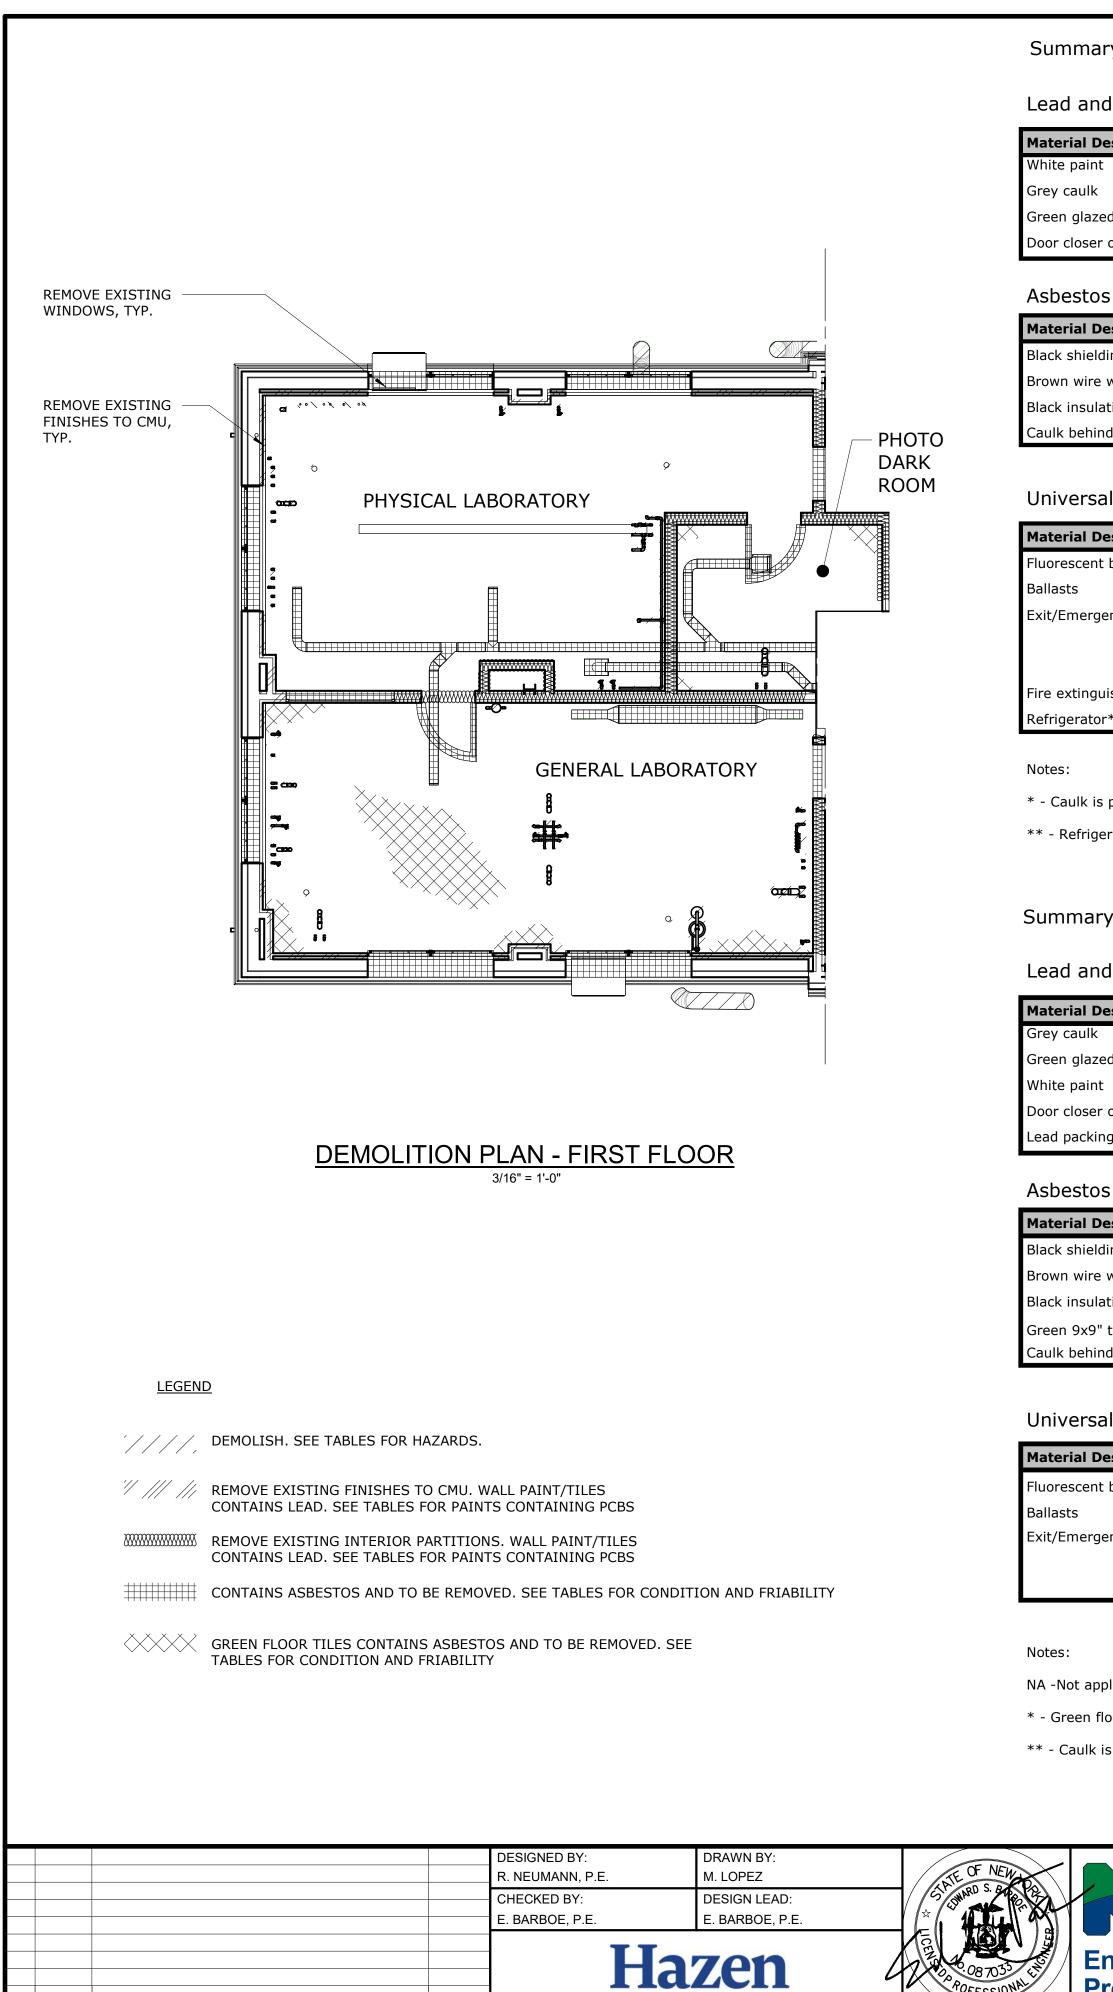

NO. DATE

<sup>5</sup> All inquiries regarding this drawing(s) or project should be made to NYC Environmental Protection, Bureau of Water Supply.

APPR'D

**REVISIONS/DESCRIPTION** 

Summary of Confirmed Hazardous Materials for the First Floor, Physical Laboratory (Microbiology Lab)

#### Lead and PCBs

terial Description	Location	Hazard	Sample ID
ite paint	Ceiling	Lead-containing, PCB-containing	264428.07
ey caulk	Windows	PCB-containing	CAT423-1ST-PCB-01
een glazed tile	Walls	Lead-containing	CAT423-1ST-PB-03
or closer oil	Door	PCB-containing	CAT423-1ST-PCB-11

Destos						
aterial Description	Location	Sample ID	Quantity	Condition	Friability	
ack shielding	Radiators	CAT423-2ND-ASB-28,29	70 ft <sup>2</sup> (3 locations)	Good	Non-friable	
own wire wrap	Radiators	CAT423-1ST-ASB-38,39	15 linear ft (3 locations)	Good	Non-friable	
ack insulation spot coating	Duct work	30A, 31A , 44A	420 ft <sup>2</sup>	Unknown	Unknown	
ulk behind door frame*	Door		20 linear ft	Unknown	Unknown	

#### Universal and other Miscellaneous Wastes

terial Description	Location	Quantity	Waste Classification
prescent bulbs	Ceiling	14, 8 ft bulbs	Universal waste
asts	Ceiling	7	Non-hazardous regulated waste (no PCBs)
/Emergency light	Wall	2 bulbs	Universal waste
		1 circuit board	Electronic waste
		1 lead battery	Universal waste
extinguisher	Wall	1	Regulated waste
rigerator**	Wall	1	Regulated waste

\* - Caulk is presumed to be present and asbestos containing. Caulk is presumed to be present under the entire steel frame (approx. 8" wide).

\*\* - Refrigerator uses Freon 134a (1,1,1,2-Tetrafluoroethane) as a refrigerant.

#### Summary of Confirmed Hazardous Materials for the First Floor, General Laboratory (Instrumentation)

#### Lead and PCBs

terial Description	Location	Hazard	Sample ID
ey caulk	Windows	PCB-containing	CAT423-1ST-PCB-01
en glazed tile	Walls	Lead-containing	CAT423-1ST-PB-03
ite paint	Ceiling	Lead-containing, PCB-containing	264428.07
or closer oil	Door	PCB-containing	CAT423-1ST-PCB-11
d packing	Drain piping	Lead joints (7 locations)	

Asbestos

terial Description	Location	Sample ID	Quantity	Condition	Friability
ack shielding	Radiators	CAT423-2ND-ASB-28,29	70 ft2 (3 locations)	Good	Non-friable
own wire wrap	Radiators	CAT423-1ST-ASB-38,39	15 linear ft (3 locations)	Good	Non-friable
ack insulation spot coating	Duct work	30A, 31A , 44A	540 ft <sup>2</sup>	Unknown	Unknown
een 9x9" tile	Floor	NA*	465 ft <sup>2</sup>	Good	Non-friable
ulk behind door frame**	Door		20 linear ft	Unknown	Unknown

#### Universal and other Miscellaneous Wastes

terial Description	Location	Quantity	Waste Classification
orescent bulbs	Ceiling	12, 8 ft bulbs	Universal waste
llasts	Ceiling	6	Non-hazardous regulated waste (no PCBs)
it/Emergency light	ency light Wall 2 bulbs Universal waste		Universal waste
		1 circuit board	Electronic waste
		1 lead battery	Universal waste

NA -Not applicable

\* - Green floor tile confirmed ACM by NYCDEP Legacy Database.

\*\* - Caulk is presumed to be present and asbestos containing. Caulk is presumed to be present under the entire steel frame (approx. 8" wide).

_				
/		ACCOUNTABLE MANAGER	"WARNING-IT IS A VIOLATION, OF THE NEW YORK STATE EDUCATION LAW,	NEW YORK CITY
$\setminus$		JOSE NIEVES	SECTION, 7209.2, FOR ANY PERSON,	
Y		PORTFOLIO MANAGER	UNLESS (S)HE IS ACTING UNDER THE DIRECTION OF A LICENSED	ENVIRONMENTAL PROTECT
			PROFESSIONAL ENGINEER, TO ALTER	BUREAU OF WATER SUPPLY
7	Environmental	MARK DELBALZO, P.E.	THIS DOCUMENT IN ANY WAY. IF ALTERED, THE ALTERING PERSON	465 COLUMBUS AVENUE, SUITE 270
/			SHALL COMPLY WITH THE	VALHALLA, NEW YORK 10595-1336
/	Protection		REQUIREMENTS OF NEW YORK EDUCATION, LAW, SECTION, 7209.2."	www.nyc.gov/dep

### Summary of Confirmed Hazardous Materials for the First Floor, Dark Room (Storage)

#### Lead and PCBs

Material Description	Location	Hazard	Sample ID
White paint	Ceiling	Lead-containing, PCB-containing	264428.07
Green glazed tile	Wall	Lead-containing	CAT423-1ST-PB-03
Asbestos			

## Material Description Black insulation spot coati Green 9x9" tile

#### Universal and other Miscellaneous Wastes

Material Description	Location	Quantity	Waste Classification
Fluorescent lights	Ceiling	2, 4 ft bulbs	Universal waste
Ballasts	Ceiling	1	Non-hazardous regulated waste (no PCBs)

Notes:

NA - Not applicable

Material Description	Location	Sample ID	Quantity	Condition	Friability
Black insulation spot coating	Duct work	30A, 31A , 44A	300 ft <sup>2</sup>	Unknown	Unknown
Green 9x9" tile	Floor	NA*	86 ft <sup>2</sup>	Good	Non-friable
Caulk behind door frame**	Door		20 linear ft	Unknown	Unknown

\* - Green floor tile confirmed to be ACM by NYCDEP Legacy Database.

\*\* - Caulk is presumed to be present and asbestos containing. Caulk is presumed to be present under the entire steel frame (approx. 8" wide).

- 1. ALL REMOVAL AND ABATEMENT WORK SHALL BEDOWN TO THE BARE SUBSTRATE AND COMPLETED IN ACCORDANCE WITH DETAILED SPECIFICATIONS 01355 - HAZARDOUS MATERIALS CONTROL, AND SPECIFICATIONS 13281- ASBESTOS MANAGEMENT, 13282 - MERCURY MANAGEMENT, 13283 - LEAD MANAGEMENT, AND 13284 - PCB MANAGEMENT, AS WELL AS FEDERAL, STATE, AND LOCAL REGULATIONS AS APPLICABLE.
- 2. REFER TO THE HAZARDOUS MATERIAL SURVEY REPORT FOR THE KENSICO LABORTORY, REV. 1, MAY 2018, PREPARED BY BIDWELL ENVIRONMENTAL, LLC FOR SUMMARY OF SAMPLING LOCATIONS OF SUSPECT HAZARDOUS MATERIALS.
- 3. MATERIALS CONTAINING < 5,000 MG/KG OR ≥ 5,000 MG/KG LEAD ARE CONSIDERED LEAD-CONTAINING OR LEAD-BASED, RESPECTIVELY.
- 4. MATERIALS CONTAINING < 50 MG/KG OR ≥50 MG/KG PCBS ARE CONSIDERED PCB-CONTAINING OR TSCA-REGULATED, RESPECTIVELY.
- 5. MATERIALS CONTAINING MORE THAN 1% ASBESTOS ARE CONSIDERED ASBESTOS-CONTAINING MATERIALS.
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- 7. ALL HOLES CREATED BY REMOVED PIPES TO BE FILLED. REFER TO S-501 FOR REPAIR DETAIL.

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TION	MOUNT PLEASANT, NE	SHEET NO:	
	CONTRACT CRO-	20 OF No. 121	
	HAZMAT		DRAWING NO.
	EXISTING FIRST FLOOR - DEN	HZ-102	

## Summary of Confirmed Hazardous Materials for the First Floor, Water and Sewage Laboratory (Wet Chemistry Lab)

#### Lead and PCBs

Material Description	Location	Hazard	Sample ID
White paint	Ceiling	Lead-containing, PCB-containing	264428.07
Grey caulk	Windows	PCB-containing	CAT423-1ST-PCB-01
Green glazed tile	Wall	Lead-containing	CAT423-1ST-PB-03
Door closer oil	Door	PCB-containing	CAT423-1ST-PCB-11
Black paint	Duct work	Lead-containing, PCB-containing	264428.02

#### Asbestos

Material Description	Location	Sample ID	Quantity	Condition	Friability
Black shielding	Radiators	CAT423-2ND-ASB-28,29	70 ft <sup>2</sup> (3 locations)	Good	Non-friable
Brown wire wrap	Radiators	CAT423-1ST-ASB-38,39	12 linear ft (3 locations)	Good	Non-friable
Grey caulk	Windows	1, 2, 3	82 linear ft (3 locations)	Good	Non-friable
Black insulation spot coating	Duct work	30A, 31A , 44A	660 ft <sup>2</sup>	Unknown	Unknown
Green 9x9" tile	Floor	NA*	800 ft <sup>2</sup>	Good	Non-friable
Caulk behind door frame**	Door		40 linear ft (2 locations)	Unknown	Unknown
White insulation	Piping	0913040201E, 2E, 3E	100 linear ft	Good	Non-friable
White insulation	Piping	0913040201E, 2E, 3E	20 elbows	Good	Non-friable

#### Universal and other Miscellaneous Wastes

Material Description	Location	Quantity	Waste Classification	
Fluorescent bulbs	Ceiling	12, 8 ft bulbs	Universal waste	
		4, 4 ft bulbs	Universal waste	
Ballasts	Ceiling	8	Non-hazardous regulated waste (no PCBs)	
Exit/Emergency light	Wall	2 bulbs	Universal waste	
		1 circuit board	Electronic waste	
		1 lead battery	Universal waste	
Fire extinguishers	Wall	2	Regulated waste	
Refrigerator***	Wall	1	Regulated waste	

Notes:

\* - Green floor tile confirmed ACM by NYCDEP Legacy Database.

\*\* - Caulk is presumed to be present and asbestos containing. Caulk is presumed to be present under the entire steel frame (approx. 8" wide).

\*\*\* - Refrigerator uses Freon 134a (1,1,1,2-Tetrafluoroethane) as a refrigerant.

NA - Not applicable

#### Summary of Confirmed Hazardous Materials for the First Floor, Entrance

#### Lead and PCBs

Material Description	Location	Hazard	Sample ID
Black paint	Hand rail	Lead-based	CAT423-2ND-PC-06
White paint	Ceiling	Lead-containing, PCB-containing	264428.07
Green glazed tile	Wall	Lead-containing	CAT423-1ST-PB-03

Asbestos

Material Description	Location	Sample ID	Quantity	Condition	Friability
Grey caulk	Window	1, 2, 3	28 linear ft	Good	Non-friable
Black shielding	Radiator	CAT423-2ND-ASB-28,29	25 ft <sup>2</sup>	Good	Non-friable
Brown wire wrap (presumed present)	Radiator	CAT423-1ST-ASB-38,39	5 linear ft	Good	Non-friable

#### Universal and other Miscellaneous Wastes

Material Description	Location	Quantity	Waste Classification
Exit sign/Emergency light	Wall	2 bulbs	Universal waste
		1 circuit board	Electronic waste
		1 lead battery	Universal waste
Fire extinguisher	Wall	1	Regulated waste

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Ι					CHECKED BY: E. BARBOE, P.E.	DESIGN LEAD: E. BARBOE, P.E.	
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## Summary of Confirmed Hazardous Materials for First Floor, Offices

#### Lead and PCBs

Material Description	Location	Hazard	Sample ID
White paint	Ceiling	Lead-containing, PCB-containing	264428.07
Beige over green paint	Dividing wall	Lead-containing, PCB-containing	CAT423-1ST-PC-10
Green glazed tile	Wall	Lead-containing	CAT423-1ST-PB-03
Door closer oil	Door	PCB-containing	CAT423-1ST-PCB-11
Grey caulk	Windows	PCB-containing	CAT423-1ST-PCB-01

#### Asbestos

Material Description	Location	Sample ID	Quantity	Condition	Friability
Material Description	Location	Sample ID	Quantity	Condition	Filability
Black shielding	Radiators	CAT423-2ND-ASB-28,29	46 ft <sup>2</sup> (2 locations)	Good	Non-friable
Brown wire wrap	Radiators	CAT423-1ST-ASB-38,39	9 linear ft (2 locations)	Good	Non-friable
Grey caulk	Windows	1, 2, 3	55 linear ft (2 locations)	Good	Non-friable
Black insulation spot coating	Duct	30A, 31A , 44A	120 ft <sup>2</sup>	Unknown	Unknown
Green 9x9" tile	Floor	NA*	300 ft <sup>2</sup>	Good	Non-friable
Caulk behind door frame**	Door		40 linear ft (2 locations)	Unknown	Unknown
White insulation	Piping	0913040201E, 2E, 3E	48 linear ft	Good	Non-friable
White insulation	Piping	0913040201E, 2E, 3E	12 elbows	Good	Non-friable

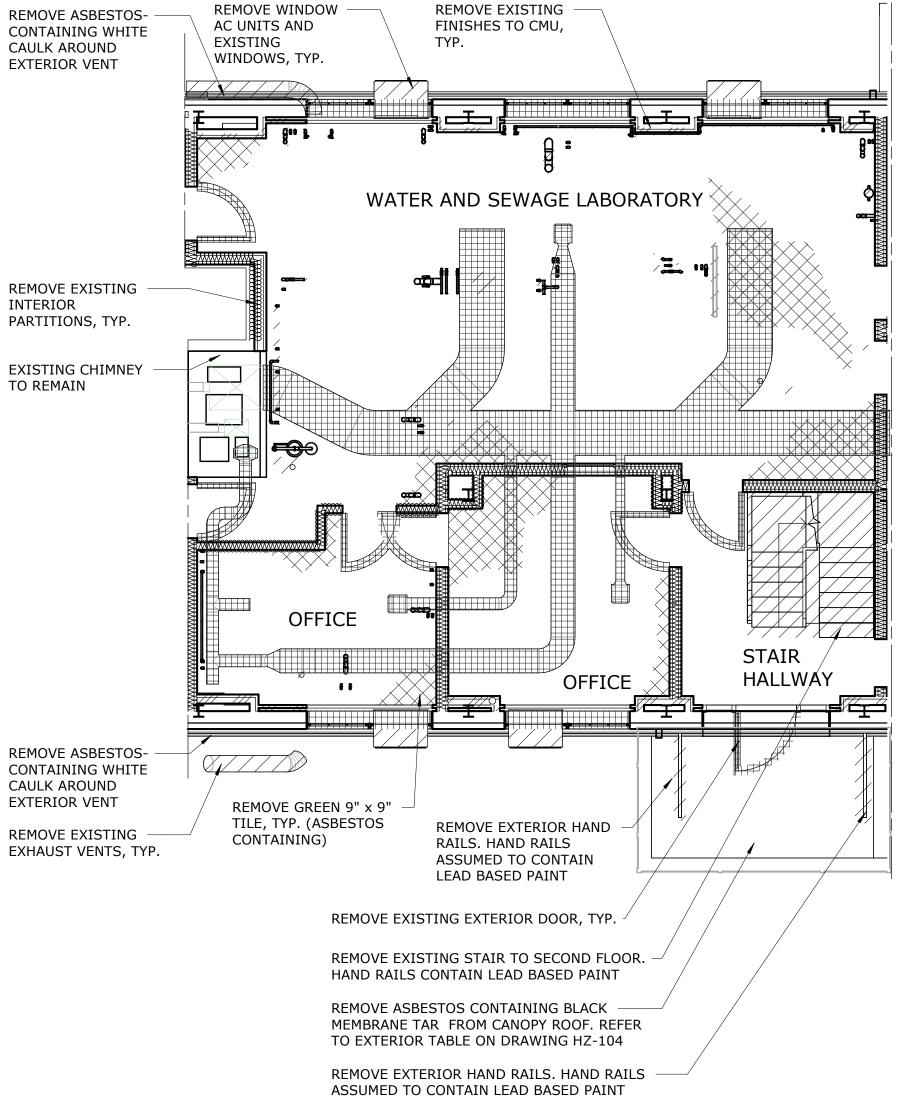
#### Universal and other Miscellaneous Wastes

Material Description	Location	Quantity	Waste Classification
	Ceiling	6, 8 ft bulbs	Universal waste
		2, 4 ft bulbs	Universal waste
Ballasts	Ceiling	4	Non-hazardous regulated waste (no PCBs)
Emergency light	Wall	2 bulbs	Universal waste
		1 circuit board	Electronic waste
		1 lead battery	Universal waste
Notes:			
* - Green tile confirmed AC	M by NYCDEP Leg	acy Database.	

NA - Not Applicable

### **LEGEND**

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<i>"        </i>	REMOVE EXISTING FINISH CONTAINS LEAD. SEE TABL
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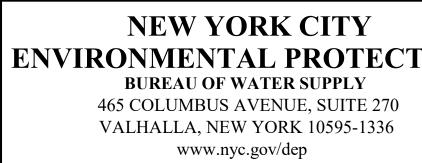


**DEMOLITION PLAN - FIRST FLOOR** 3/16" = 1'-0"



ACCOUNTABLE MANAGER
JOSE NIEVES
PORTFOLIO MANAGER
MARK DELBALZO, P.E.

"WARNING-IT IS A VIOLATION, OF THE NEW YORK STATE EDUCATION LAW, SECTION, 7209.2, FOR ANY PERSON, UNLESS (S)HE IS ACTING UNDER THE DIRECTION OF A LICENSED PROFESSIONAL ENGINEER, TO ALTER THIS DOCUMENT IN ANY WAY. IF ALTERED, THE ALTERING PERSON SHALL COMPLY WITH THE REQUIREMENTS OF NEW YORK EDUCATION, LAW, SECTION, 7209.2."



\*\* - Caulk is presumed to be present and asbestos containing. Caulk is presumed to be present under the entire steel frame (approx. 8" wide).

OR HAZARDS.

HES TO CMU. WALL PAINT/TILES LES FOR PAINTS CONTAINING PCBS

RIOR PARTITIONS. WALL PAINT/TILES BLES FOR PAINTS CONTAINING PCBS

TO BE REMOVED. SEE TABLES FOR CONDITION AND FRIABILITY

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AND FRIABILITY

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	HAZMAT EXISTING FIRST FLOOR - DEMOLITION PLAN		DRAWING NO.
			HZ-103

#### Summary of Confirmed Hazardous Materials for the First Floor, Reagent and Media Prep Room (Autoclave and Bottle Washing)

#### Lead and PCBs

Material Description	Location	Hazard	Sample ID
White paint	Ceiling	Lead-containing, PCB-containing	264428.07
Green glazed tile	Wall	Lead-containing	CAT423-1ST-PB-03
Grey caulk	Windows	PCB-containing	CAT423-1ST-PCB-01
Lead packing	Drain pipes	Lead joints (4 locations)	

Asbestos					
Material Description	Location	Sample ID	Quantity	Condition	Friability
Black shielding	Radiators	CAT423-2ND-ASB-28,29	46 ft2 (2 locations)	Good	Non-friable
Brown wire wrap (presumed present)	Radiators	CAT423-1ST-ASB-38,39	9 linear ft (2 locations)	Good	Non-friable
Grey caulk	Windows	1, 2, 3	55 linear ft (2 locations)	Good	Non-friable
Black insulation spot coating	Duct work	30A, 31A, 44A	720 ft2	Unknown	Unknown
Green 9x9" tile	Floor	NA*	500 ft2	Good	Non-friable
Caulk behind door frame**	Door		20 linear ft	Unknown	Unknown
White insulation	Piping	0913040201E, 2E, 3E	28 linear ft	Good	Non-friable
White insulation	Piping	0913040201E, 2E, 3E	2 elbows	Good	Non-friable

#### Universal and other Miscellaneous Wastes

Material Description	Location	Quantity	Waste Classification
Fluorescent bulbs	Ceiling	4, 4 ft bulbs	Universal waste
		8, 8 ft bulbs	Universal waste
Ballasts	Ceiling	6	Non-hazardous regulated waste (no PCBs)
Fire extinguisher	Wall	1	Regulated waste
Exit/Emergency light	Wall	2 bulbs	Universal waste
		1 circuit board	Electronic waste
		1 lead battery	Universal waste

#### Notes:

\* - Green floor tile confirmed ACM by NYCDEP Legacy Database.

\*\* - Caulk is presumed to be present and asbestos containing. Caulk is presumed to be present under the entire steel frame (approx. 8"wide).

NA - Not applicable

#### Summary of Confirmed Hazardous Materials for the Laboratory Exterior

#### Asbestos

Material Description	Location	Sample ID	Quantity	Condition	Friability
Black membrane tar	Canopy over north wall entranceway	0821060213E	132 ft <sup>2</sup>	Damaged	Non-friable
Black membrane tar	Canopy over south wall entranceway	0821060213E	132 ft <sup>2</sup>	Damaged	Non-friable
White caulk	Vents	CAT423-EXT-ASB-84,85	18 linear ft (3 locations)	Significantly damaged	Non-friable



ASBESTOS CONTAINING WHITE CAULK AROUND EXTERIOR VENT, TYP. (CAT423-EXT-ASB-84, 85)

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<sup>4</sup> <sup>16</sup> All inquiries regarding this drawing(s) or project should be made to NYC Environmental Protection, Bureau of Water Supply.

### Summary of Confirmed Hazardous Materials for the First Floor, Garage

Quantity

12, 8 ft bulbs

Lead and PCBs

Material Description

-luorescent bulbs

Refrigerators\*

Fire extinguishers

Ballasts

Universal and other Miscellaneous Wastes

Location

Ceiling

Ceiling

Wall

Wall

Material Description	Location	Hazard	Sample ID
Green concrete	Floor	Lead-containing	CAT423-1ST-PC-16
Grey over red paint	Support beam	Lead-based	CAT423-1ST-PC-17

#### Grey caulk Green 9x9" tile Notes: Black insulation spot coating \* - Refrigerators uses Freon 134a (1,1,1,2-Tetrafluoroethane) as a refrigerant. Caulk behind door frame\*\* White insulation White insulation **Material Description** Fluorescent bulbs Ballasts REMOVE EXTERIOR HAND RAILS. HAND RAILS ASSUMED TO CONTAIN LEAD BASED PAINT Exit/Emergency Light REMOVE ASBESTOS CONTAINING BLACK MEMBRANE TAR FROM CANOPY ROOF. Notes: REMOVE EXISTING EXTERIOR DOOR, TYP. \* - Green floor tile confirmed ACM by NYCDEP Legacy Database. - REMOVE EXTERIOR HAND RAILS. HAND RAILS ASSUMED TO CONTAIN LEAD BASED PAINT REMOVE WINDOW AC UNITS AND EXISTING WINDOWS, TYP. NA - Not Applicable REMOVE ASBESTOS-CONTAINING WHITE CAULK AROUND EXTERIOR VENT þ SAMPLE RECEPTION ROOM REMOVE EXISTING DEMO CMU TO PROVIDE NEW OPENING TO GARAGE GARAGE DOORS, TYP. ₽.... $\times$ REMOVE EXISTING INTERIOR PARTITIONS, TYP. EXISTING CHIMNEY TO REMAIN I DEMO DUCTWORK, ÓCIRÓ TYP. GARAGE REMOVE EXISTING REAGENT AND MEDIA FINISHES TO CMU, TYP. PREPARATION ROOM REMOVE EXISTING REMOVE EXISTING EXHAUST VENTS, TYP. WINDOWS, TYP. REMOVE GREEN 9" x9" FLOOR TILE, TYP. (ASBESTOS CONTAINING) **DEMOLITION PLAN - FIRST FLOOR**

## **Environmental** Protection

R	ACCOUNTABLE MANAGER JOSE NIEVES	"WARNING-IT IS A VIOLATION, OF THE NEW YORK STATE EDUCATION LAW, SECTION, 7209.2, FOR ANY PERSON, UNLESS (S)HE IS ACTING UNDER THE	T
	PORTFOLIO MANAGER	DIRECTION OF A LICENSED	ľ
	MARK DELBALZO, P.E.	PROFESSIONAL ENGINEER, TO ALTER THIS DOCUMENT IN ANY WAY. IF ALTERED, THE ALTERING PERSON	
		SHALL COMPLY WITH THE	
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3/16" = 1'-0"

**NEW YORK CITY ENVIRONMENTAL PROTEC BUREAU OF WATER SUPPLY** 465 COLUMBUS AVENUE, SUITE 270 VALHALLA, NEW YORK 10595-1336 www.nyc.gov/dep

#### Summary of Confirmed Hazardous Materials for the First Floor, Sample Reception Room (Sample Log-in and Bottle Storage)

#### Lead and PCBs

Asbestos

Material Description	Location	Hazard	Sample ID
Grey/blue paint	Floor	Lead-containing	CAT423-1ST-PC-09
White paint	Ceiling	Lead-containing, PCB-containing	264428.07
Green glazed tile	Walls	Lead-containing	CAT423-1ST-PB-03
Grey caulk	Windows	PCB-containing	CAT423-1ST-PCB-01
Door closer oil	Door	PCB-containing	CAT423-1ST-PCB-11

## Regulated waste Regulated waste

Non-hazardous regulated waste (no PCBs)

Waste Classification

Universal waste

Material Description	Location	Sample ID	Quantity	Condition	Friability
Black shielding	Radiators	CAT423-2ND-ASB-28,29	46 ft <sup>2</sup> (2 locations)	Good	Non-friable
Brown wire wrap (presumed present)	Radiators	CAT423-1ST-ASB-38,39	9 linear ft (2 locations)	Good	Non-friable
Grey caulk	Windows	1, 2, 3	28 linear ft (1 location)	Good	Non-friable
Green 9x9" tile	Floor	NA*	235 ft <sup>2</sup>	Good	Non-friable
Black insulation spot coating	Duct work	30A, 31A , 44A	180 ft <sup>2</sup>	Unknown	Unknown
Caulk behind door frame**	Door		20 linear ft	Unknown	Unknown
White insulation	Piping	0913040201E, 2E,3E	45 linear ft	Good	Non-friable
White insulation	Piping	0913040201E, 2E,3E	12 elbows	Good	Non-friable

#### Universal and other Miscellaneous Wastes

Location	Quantity	Waste Classification
Ceiling	6 bulbs	Universal waste
Ceiling	3	Non-hazardous regulated waste (no PCBs)
Wall	2 bulbs	Universal waste
	1 circuit board	Electronic waste
	1 lead battery	Universal waste

\*\* - Caulk is presumed to be present and asbestos containing. Caulk is presumed to be present under the entire steel frame (approx. 8" wide).

#### <u>LEGEND</u>

'////.	DEMOLISH. SEE TABLES FOR HAZARDS.
''/ /// ///	REMOVE EXISTING FINISHES TO CMU. WALL PAINT/TILES CONTAINS LEAD. SEE TABLES FOR PAINTS CONTAINING PCBS
	REMOVE EXISTING INTERIOR PARTITIONS. WALL PAINT/TILES CONTAINS LEAD. SEE TABLES FOR PAINTS CONTAINING PCBS
	CONTAINS ASBESTOS AND TO BE REMOVED. SEE TABLES FOR CONDITION AND FRIABILITY
${\longleftrightarrow}{\bullet}{\longleftrightarrow}{\longleftrightarrow}{\longleftrightarrow}{\bullet}{\longleftrightarrow}{\longleftrightarrow}{\bullet}{\longleftrightarrow}{\bullet}{\longleftrightarrow}{\bullet}{\longleftrightarrow}{\bullet}{\bullet}{\longleftrightarrow}{\bullet}{$	GREEN FLOOR TILES CONTAINS ASBESTOS AND TO BE REMOVED. SEE TABLES FOR CONDITION AND FRIABILITY

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	CONTRACT CRO-	22 OF No. 121			
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	EXISTING FIRST FLOOR - DEMOLITION PLAN				

## Summary of Confirmed Hazardous Materials for the Second Floor, Men's Restroom

Lead and PCBs

Material Description	Location	Hazard	Sample ID	
White paint	Sink drain pipe	Lead-containing, PCB-containing		CAT423-2ND-PC-03
White paint	Ceiling	Lead-containing, PCB-containing		264428.03
Green glazed tile	Wall	Lead-containing		CAT423-1ST-PB-03
Door closer oil	Door	PCB-containing	CAT423-1ST-PCB-11	

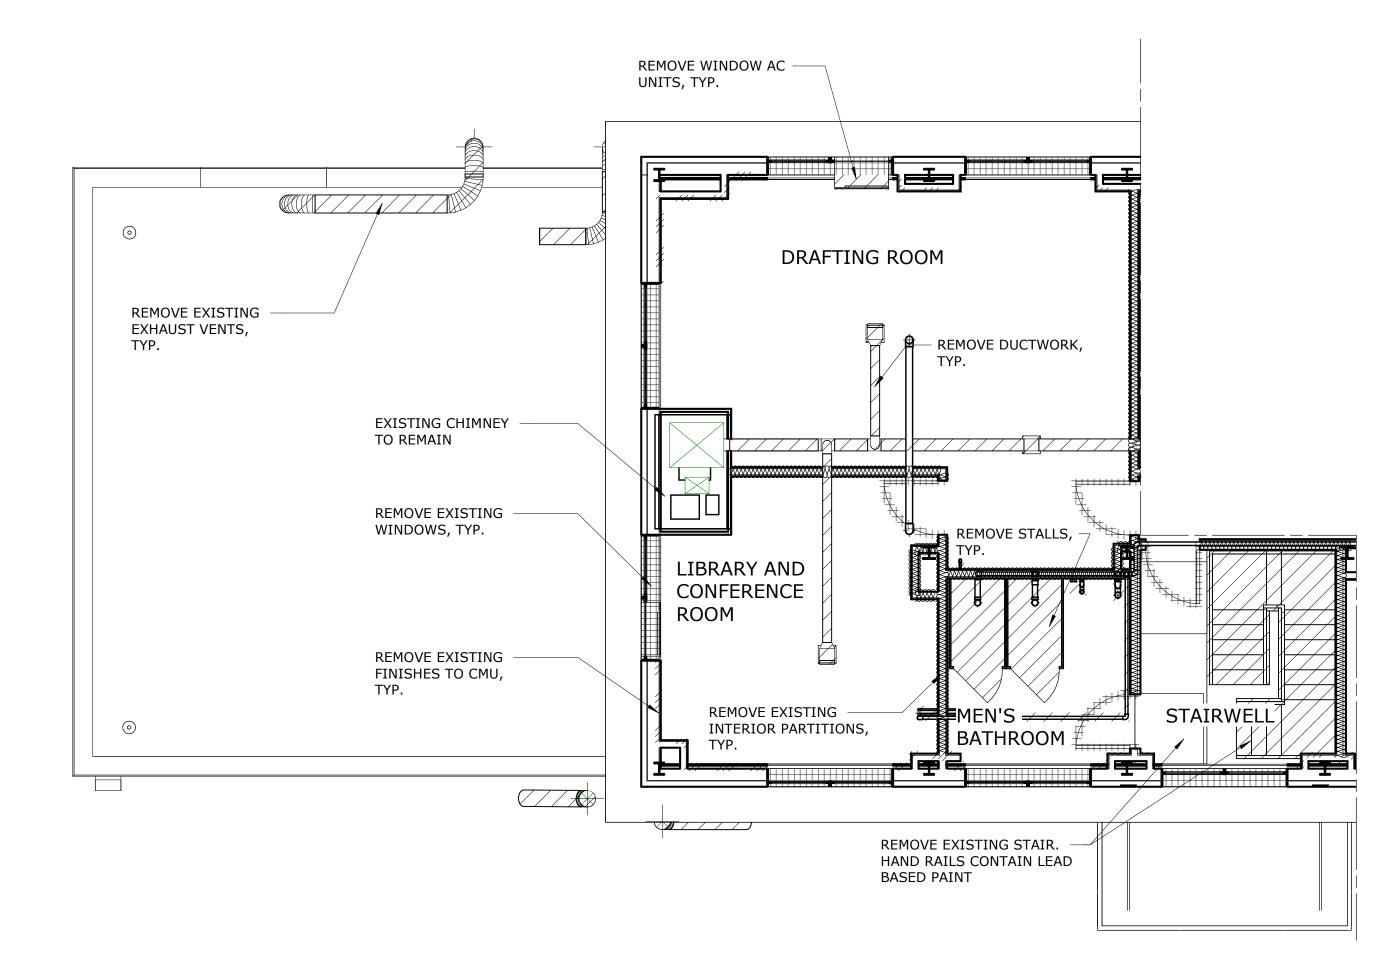
Material Description	Location	Sample ID	Quantity	Condition	Friability
Black shielding	Radiator	CAT423-2ND-ASB-28,29	23 ft <sup>2</sup> (1 location)	Good	Non-friable
Black caulk	Radiator	CAT423-2ND-ASB-26,27	3.5 linear ft (1 location)	Good	Non-friable
Grey caulk	Windows	1, 2, 3	28 linear ft (1 location)	Good	Non-friable
Caulk behind door frame*	Door		20 linear ft	Unknown	Unknown

#### Universal and other Miscellaneous Wastes

Material Description	Location	Quantity	Waste Classification
Fluorescent bulbs	Ceiling	2, 4 ft bulbs	Universal waste
Ballast	Ceiling	1	Non-hazardous regulated waste (no PCBs)

Notes:

\* - Caulk is presumed to be present and asbestos containing. Caulk is presumed to be present under the entire steel frame (approx. 8" wide).



#### <u>LEGEND</u>

DEMOLISH. SEE TABLES FOR HAZARDS.

REMOVE EXISTING FINISHES TO CMU. WALL PAINT/TILES CONTAINS LEAD. SEE TABLES FOR PAINTS CONTAINING PCBS

CONTAINS LEAD. SEE TABLES FOR PAINTS CONTAINING PCBS

CONTAINS ASBESTOS AND TO BE REMOVED. SEE TABLES FOR CONDITION AND FRIABILITY

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#### Summary of Confirmed Hazardous Materials for the Second Floor, Stairwell

#### Lead and PCBs

Material Description	Location	Hazard	Sample ID
Black paint	Hand rail	Lead-based	CAT423-2ND-PC-06
White paint	Ceiling	Lead-containing, PCB-containing	264428.03
Green glazed tile	Wall	Lead-containing	CAT423-1ST-PB-03

Material Description	Location	Sample ID	Quantity	Condition	Friability
Black shielding	Radiator	CAT423-2ND-ASB-28,29	23 ft <sup>2</sup> (1 location)	Good	Non-friable
Grey caulk	Window	1, 2, 3	28 linear ft (1 location)	Good	Non-friable

#### Universal and other Miscellaneous Wastes

Material Description	Location	Quantity	Waste Classification
Emergency light	Wall	2 bulbs	Universal waste
		1 circuit board	Electronic waste
		1 lead battery	Universal waste

#### **DEMOLITION PLAN - SECOND FLOOR** 3/16" = 1'-0"

ACCOUNTABLE MANAGER JOSE NIEVES PORTFOLIO MANAGER MARK DELBALZO, P.E.

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**NEW YORK CITY ENVIRONMENTAL PROTEC BUREAU OF WATER SUPPLY** 465 COLUMBUS AVENUE, SUITE 270 VALHALLA, NEW YORK 10595-1336 www.nyc.gov/dep

#### Summary of Confirmed Hazardous Materials for the Second Floor, Library and Conference Room (Microbiology Office)

#### Lead and PCBs

Material Description
Blue over beige paint
Grey vinyl covebase
Beige paint
Beige paint
Door closer oil

#### Asbestos

Material Description	Location	Sample ID	Quantity	Condition	Friability
Black shielding	Radiators	CAT423-2ND-ASB-28,29	46 ft <sup>2</sup> (2 radiators)	Good	Non-friable
Grey caulk around frame	Windows	1, 2, 3	55 linear ft (2 windows)	Good	Non-friable
Caulk behind door frame*	Door		20 linear ft	Unknown	Unknown

Material Description	Location	Quantity	Waste Classification
Fluorescent buibs	Celling	o, 4 it buibs	Universal waste
Ballasts	Ceiling	4 ballasts	Non-hazardous regulated waste (no PCBs)
Notes.			

(approx. 8" wide).

## (Administration Office)

#### Lead and PCBs

Material Description
White paint
Blue over beige paint
Door closer oil

#### Asbestos

Material Description	Location	Sample ID	Quantity	Condition	Friability
Black shielding	Radiators	CAT423-2ND-ASB-28,29	70 ft <sup>2</sup> (3 radiators)	Good	Non-friable
Grey caulk around frame	Windows	1, 2, 3	82 linear ft (3 windows)	Good	Non-friable
Caulk behind door frame*	Door		20 linear ft	Unknown	Unknown

Material Description	Location	Quantity	Waste Classification
Fluorescent bulbs	Ceiling	14, 8 ft bulbs	Universal waste
Ballasts	Ceiling	7 ballasts	Non-hazardous regulated waste (no PCBs)
Notes:			

frame (approx. 8" wide).

Location	Hazard	Sample ID
Walls	Lead-based, PCB-containing	CAT423-2ND-PC-01
Walls	Lead-containing	CAT423-2ND-PB-01
Walls	Lead-containing	264428.04
Ceiling	Lead-containing, PCB-containing	191-19-LCP-01
Door	PCB-containing	CAT423-1ST-PCB-11

#### Universal and other Miscellaneous Wastes

\* - Caulk is presumed to be present and asbestos containing. Caulk is presumed to be present under the entire steel frame

## Summary of Confirmed Hazardous Materials for the Second Floor, Drafting Room

Location	Hazard	Sample ID
Ceiling	Lead-containing, PCB-containing	264428.05
Walls	Lead-based, PCB-containing	CAT423-2ND-PC-01
Door	PCB-containing	CAT423-1ST-PCB-11

#### Universal and other Miscellaneous Wastes

\* - Caulk is presumed to be present and asbestos containing. Caulk is presumed to be present under the entire steel

#### NOTES:

- 1. ALL REMOVAL AND ABATEMENT WORK SHALL BE DOWN TO THE BARE SUBSTRATE AND COMPLETED IN ACCORDANCE WITH DETAILED SPECIFICATIONS 01355 - HAZARDOUS MATERIALS CONTROL, AND SPECIFICATIONS 13281- ASBESTOS MANAGEMENT, 13282 - MERCURY MANAGEMENT, 13283 - LEAD MANAGEMENT, AND 13284 - PCB MANAGEMENT, AS WELL AS FEDERAL, STATE, AND LOCAL REGULATIONS AS APPLICABLE.
- 2. REFER TO THE HAZARDOUS MATERIAL SURVEY REPORT FOR THE KENSICO LABORTORY, REV. 1, MAY 2018, PREPARED BY BIDWELL ENVIRONMENTAL, LLC FOR SUMMARY OF SAMPLING LOCATIONS OF SUSPECT HAZARDOUS MATERIALS.
- 3. MATERIALS CONTAINING < 5,000 MG/KG OR ≥ 5,000 MG/KG LEAD ARE CONSIDERED LEAD-CONTAINING OR LEAD-BASED, RESPECTIVELY.
- 4. MATERIALS CONTAINING < 50 MG/KG OR ≥50 MG/KG PCBS ARE CONSIDERED PCB-CONTAINING OR TSCA-REGULATED, RESPECTIVELY.
- 5. MATERIALS CONTAINING MORE THAN 1% ASBESTOS ARE CONSIDERED ASBESTOS-CONTAINING MATERIALS.
- 6. QUANTITIES AND LOCATIONS ARE APPROXIMATE FOR ASBESTOS-CONTAINING MATERIALS, TSCA-REGULATED PCBS AND UNIVERSAL OTHER REGULATED MATERIALS AND SHOULD BE FIELD VERIFIED BY THE CONTRACTOR.

7. ALL HOLES CREATED BY REMOVED PIPES TO BE FILLED. REFER TO S-501 FOR REPAIR DETAIL.

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	REPURPOSING OF THE KENSICC	LABORATORY AS	DATE: MAY 2023
	THE KENSICO REGIONAL HE	ADQUARTERS	SCALE:
ΓΙΟΝ		MOUNT PLEASANT, NEW YORK SHEET NO	
	CONTRACT CRO-	624	23 OF No. 121
	HAZMAT		DRAWING NO.
	EXISTING SECOND FLOOR - DE	EMOLITION PLAN	HZ-105

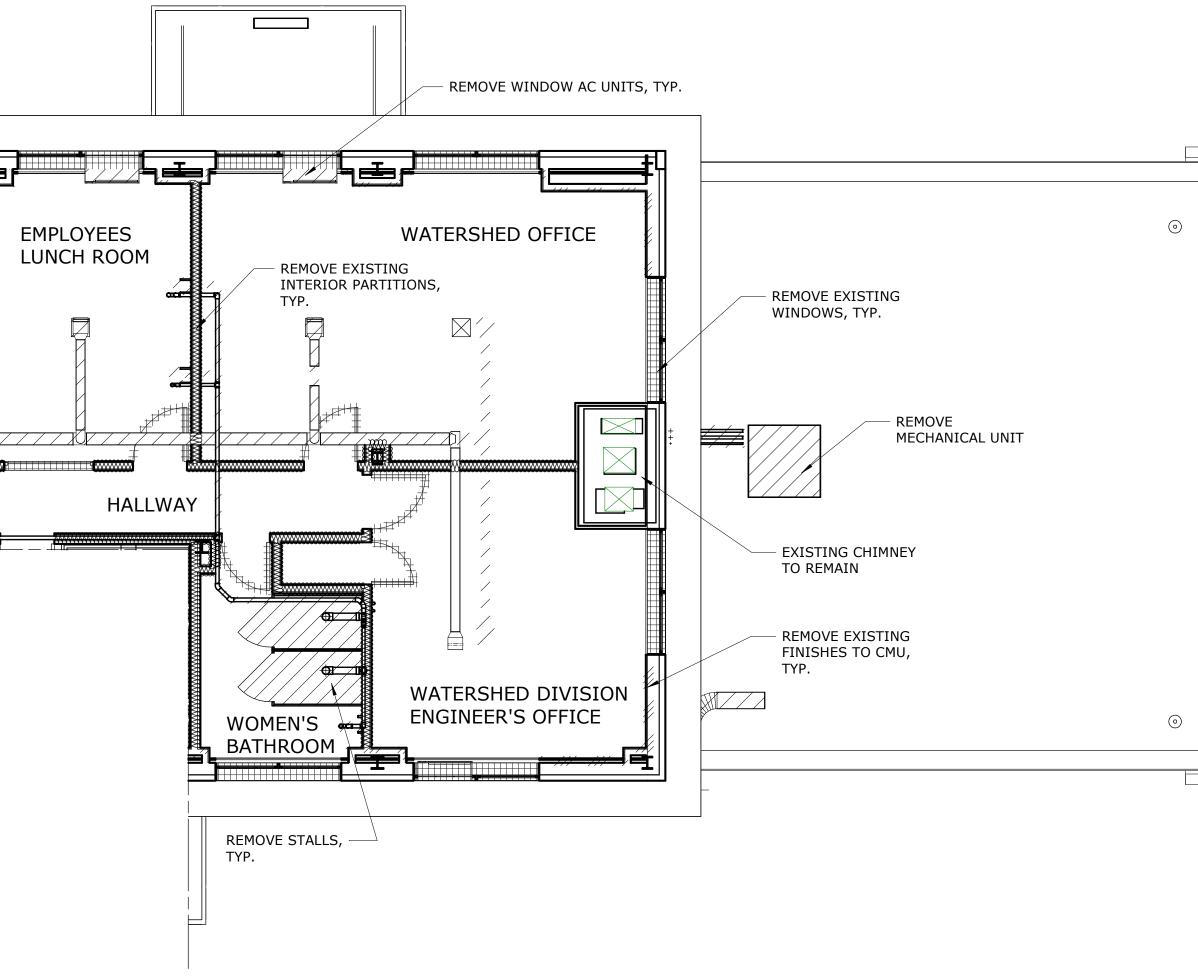
Summary of Con	nfirmed Hazard	ous Materials for the	Second Floor, Hallway		Summary of Cont	irmed Hazaı	rdous Materials for the Se	cond Floor, Women's	s Restroom		Summary of Conf (Directors Office)	rmed Hazard	lous Materials for the Secor	nd Floor, Watershed Division	Engineer's Office
Lead and PCBs					Lead and PCBs										
Material Description	Location	Hazard		Sample ID	Material Description	Location	Hazard		Sample ID	1	Lead and PCBs				
Green paint Beige paint	Walls Ceiling	Lead-containing, PCB-co Lead-containing, PCB-co	-	CAT423-2ND-PC-02 191-19-LCP-01	Green glazed tile	Wall	Lead-containing		CAT423-1ST-PB-03	1	Material Description	Location	Hazard		Sample ID
Door closer oil	Door	PCB-containing		CAT423-1ST-PCB-11	White paint	Ceiling	Lead-containing, PCB-containir	ıg	264428.03		Beige over blue paint	Walls	Lead-containing, I	PCB-containing	CAT423-2ND-PC-04
•					Door closer oil	Door	PCB-containing		CAT423-1ST-PCB-11	J	Yellow paint	Closet walls	Lead-containing, I	-	CAT423-2ND-PC-05
Asbestos					Asbestos						Blue paint Door closer oil	Walls above su Door	uspended ceiling Lead-containing, l PCB-containing	PCB-containing	CAT423-2ND-PC-01 CAT423-1ST-PCB-11
Material Description	Location	Sample ID Quar	ntity Condition	Friability	Material Description	Location	Sample ID	Quantity	Condition	Friability	Grey vinyl covebase	Walls	Lead-containing		CAT423-2ND-PB-01
Caulk behind door fram	ne* Door	20 lir	near ft Unknown	Unknown	Black shielding	Radiator	CAT423-2ND-ASB-28,29	23 ft <sup>2</sup> (1 location)	Good	Non-friable					
Universal and ot	her Miscellane	ous Wastes			Black caulk	Radiator	CAT423-2ND-ASB-26,27	3.5 linear ft (1 location)	) Good	Non-friable	Asbestos				
Material Description	Location	Quantity	Waste Classificati	on	Grey caulk	Window	1, 2, 3	28 linear ft (1 location)		Non-friable	Material Description	Location	Sample ID	Quantity Conditio	n Friability
Exit/Emergency light	Above door	2 bulbs	Universal waste		Caulk behind door frame	e* Door		20 linear ft	Unknown	Unknown	Black shielding	Radiators	CAT423-2ND-ASB-28,29	46 ft <sup>2</sup> (2 locations) Good	Non-friable
		1 circuit board	Electronic waste								Grey caulk	Windows	1, 2, 3	55 linear ft (2 locations) Good	Non-friable
		1 lead battery	Universal waste		Universal and oth	ier Miscellan	eous Wastes				Caulk behind door frame	* Door		40 linear ft (2 locations) Unknown	Unknown
Notes:					Material Description	Location	Quantity	Waste Classification							
* - Caulk is presumed to be	e present and asbestos c	ontaining. Caulk is presumed to be	present under the entire steel frame	(approx. 8" wide).	Fluorescent bulbs	Ceiling	2, 4ft bulbs	Universal waste	ad wasta (na DCRa)		Universal and oth	er Miscellane	ous Wastes		
	<b>C 1 1 1</b>				Ballast	Ceiling	1	Non-hazardous regulate	ed waste (no PCBS)		Material Description	Location	Quantity	Waste Classification	
	firmed Hazardo	ous Materials for the S	Second Floor, Watersh	ed Office (Conference R	Room) Notes:						Fluorescent bulbs	Ceiling	8, 4 ft bulbs	Universal waste	
Lead and PCBs					* - Caulk is presumed to be	present and asbesto	s containing. Caulk is presumed to be pres	ent under the entire steel frame (	(approx. 8" wide).		Ballast	Ceiling	4	Non-hazardous regula	ieu waste (no PCBS)
Material Description		lazard		Sample ID							Notes:				
Beige paint	_	ead-containing, PCB-containin	-	191-19-LCP-01							* - Caulk is presumed to	be present and as	sbestos containing. Caulk is presumed	to be present under the entire steel fra	me (approx. 8" wide).
Blue over beige paint Grey vinyl covebase		.ead-based, PCB-containing .ead-containing		CAT423-2ND-PC-01 CAT423-2ND-PB-01											
Door closer oil		PCB-containing		CAT423-1ST-PCB-11											
Asbestos								VE WINDOW AC UNITS, TYP.							
Material Description		Sample ID		Condition Friability	y										
Black shielding		CAT423-2ND-ASB-28,29		Good Non-friat											
Grey caulk Caulk behind door frame		., 2, 3	83 linear ft (3 locations) 20 linear ft	Good Non-friat Unknown Unknown		╕═┻═╒									
													LEGEND		
	N4:				EMPLOYEES		WATERSH								
Universal and oth					LUNCH ROO	M	REMOVE EXISTING						DEMOLISH. SEE TABLES	FOR HAZARDS.	
Material Description		Quantity	Waste Classification				INTERIOR PARTITIONS, TYP.		REMOVE EX				/// // REMOVE EXISTING FINIS	HES TO CMU. WALL PAINT/TILES	
Fluorescent bulbs Ballast	Ceiling 1 Ceiling 8	16, 4 ft bulbs	Universal waste Non-hazardous regulated v	waste (no PCBs)					WINDOWS,	TYP.			CONTAINS LEAD. SEE TA	BLES FOR PAINTS CONTAINING PCBS	
				()										RIOR PARTITIONS. WALL PAINT/TILES BLES FOR PAINTS CONTAINING PCBS	
Notes:							Ŕ							D TO BE REMOVED. SEE TABLES FOR C	
* - Caulk is presumed to	o be present and asl	pestos containing. Caulk is pre	esumed to be present under the	entire steel frame (approx. 8" w	· · · · · · · · · · · · · · · · · · ·					REMOVE				D TO DE REMOVED. SEE TADEES FOR C	
Summary of Conf	firmed Hazardo	ous Materials for the S	Second Floor, Lunch Ro	oom						MECHANI	CAL UNIT				
,															
Lead and PCBs					HAI	_LWAY									
Material Description		lazard		Sample ID					EXISTING	CHIMNEY		<u>N</u>	OTES:		
White paint Beige paint	5	ead-containing, PCB-containin ead-containing	5	264428.03 264428.04					TO REMAI	N				RK SHALL BE DOWN TO THE BARE SUB	
Green paint		ead-containing, PCB-containin		CAT423-2ND-PC-02									IN ACCORDANCE WITH DETAILED S	PECIFICATIONS 01355 - HAZARDOUS N	1ATERIALS CONTROL, AND
Door closer oil	Door F	PCB-containing	(	CAT423-1ST-PCB-11					REMOVE E FINISHES				MANAGEMENT, AND 13284 - PCB M	S MANAGEMENT, 13282 - MERCURY MAI ANAGEMENT, AS WELL AS FEDERAL, ST	
									TYP.				REGULATIONS AS APPLICABLE.		
Asbestos					_			HED DIVISION					2018, PREPARED BY BIDWELL ENVI	IAL SURVEY REPORT FOR THE KENSICO RONMENTAL, LLC FOR SUMMARY OF SA	
Material Description		Sample ID		Condition Friability		K.	DMEN'S ENGINEE					•	SUSPECT HAZARDOUS MATERIALS.		
Black shielding		CAT423-2ND-ASB-28,29		Good Non-friabl								3.	. MATERIALS CONTAINING < 5,000 M CONTAINING OR LEAD-BASED, RES	IG/KG OR ≥ 5,000 MG/KG LEAD ARE C PECTIVELY.	ONSIDERED LEAD-
Grey caulk around frame Caulk behind door frame		., 2, 3	28 linear ft (1 window) ( 20 linear ft	Good Non-friabl Jnknown Unknown				¥				<u> </u>	. MATERIALS CONTAINING < 50 MG/	KG OR ≥50 MG/KG PCBS ARE CONSID	RED PCB-CONTAINING OR
				UIKIUWI		DEM			]				TSCA-REGULATED, RESPECTIVELY.		
	oor M:											5.	. MATERIALS CONTAINING MORE TH/ MATERIALS.	AN 1% ASBESTOS ARE CONSIDERED AS	BESTOS-CONTAINING
Universal and oth												F		APPROXIMATE FOR ASBESTOS-CONTAI	ING MATERIALS TSCA-
Material Description Fluorescent lights		Quantity 4, 4ft bulbs	Waste Classification Universal waste									0.		OTHER REGULATED MATERIALS AND SI	,
Ballasts	Ceiling 2	<u>)</u>	Non-hazardous regulated v	waste (no PCBs)								-		PIPES TO BE FILLED. REFER TO S-501 F	
Fire extinguisher	Wall 1	L	Regulated waste	. ,		I						7.			
Notes:													BID SET		C SCALES EFORE USE
	o be present and as	pestos containing. Caulk is pre	esumed to be present under the	entire steel frame			DEMOLITIO	<u>N PLAN - SECO</u>	ND FLOOR						ESS THAN 22"x34"
(approx. 8" wide).	present and asl	course containing: Caurk is pre						3/16" = 1'-0"						IT IS A RED	DUCED PRINT. CORDINGLY
		DFS	SIGNED BY: DRA'	WN BY:			ACCOUNTABLE MANAGER	"WARNING-IT IS A VIOLA	TION, OF THE			_		KENSICO LABORATORY AS	DATE: MAY 2023
		R. N	NEUMANN, P.E. M. LO	DPEZ	TE OF NEW PR	R	JOSE NIEVES	NEW YORK STATE EDUC SECTION, 7209.2, FOR A	CATION LAW, NY PERSON,		W YORK CITY		THE KENSICO REG	ONAL HEADQUARTERS	SCALE:
				IGN LEAD: ARBOE, P.E.			PORTFOLIO MANAGER	UNLESS (S)HE IS ACTING DIRECTION OF A LICENS	G UNDER THE ENV		ENTAL PROT		MOUNT PLEA	SANT, NEW YORK	SHEET NO:
							MARK DELBALZO, P.E.	PROFESSIONAL ENGINE THIS DOCUMENT IN ANY	EER, TO ALTER Y WAY. IF		AU OF WATER SUPPLY JMBUS AVENUE, SUITE			ACT CRO-624	24 OF No. 121
			Haze	en ax	0870357 8 / EIVIOIIII			ALTERED, THE ALTERIN SHALL COMPLY WITH TH	HE		LA, NEW YORK 10595-1			AZMAT LOOR - DEMOLITION PLAN	DRAWING NO. HZ-106
NO. DATE	REVISIONS/DESCRIPT	ION APPR'D			Pofessional	I.		REQUIREMENTS OF NEW EDUCATION, LAW, SECT			www.nyc.gov/dep				

All inquiries regarding this drawing(s) or project should be made to NYC Environmental Protection, Bureau of Water Supply.

Material Description	Location	Hazard	Sample ID
Beige over blue paint	Walls	Lead-containing, PCB-containing	CAT423-2ND-PC-04
Yellow paint	Closet walls	Lead-containing, PCB-containing	CAT423-2ND-PC-05
Blue paint	Walls above suspended ceiling	Lead-containing, PCB-containing	CAT423-2ND-PC-01
Door closer oil	Door	PCB-containing	CAT423-1ST-PCB-11
Grey vinyl covebase	Walls	Lead-containing	CAT423-2ND-PB-01


Material Description	Location	Sample ID	Quantity	Condition	Friability
Black shielding	Radiators	CAT423-2ND-ASB-28,29	46 ft <sup>2</sup> (2 locations)	Good	Non-friable
Grey caulk	Windows	1, 2, 3	55 linear ft (2 locations)	Good	Non-friable
Caulk behind door frame*	Door		40 linear ft (2 locations)	Unknown	Unknown

Material Description	Location	Quantity	Waste Classification
Fluorescent bulbs	Ceiling	8, 4 ft bulbs	Universal waste
Ballast	Ceiling	4	Non-hazardous regulated waste (no PCBs)





	<u>LEGENI</u>	<u>D</u>		
, ,	////.	DEMOLISH. SEE TABLES FOR HAZARD	DS.	
/		REMOVE EXISTING FINISHES TO CMU CONTAINS LEAD. SEE TABLES FOR PA	J. WALL PAINT/TILES AINTS CONTAINING PCBS	
δ		REMOVE EXISTING INTERIOR PARTIT CONTAINS LEAD. SEE TABLES FOR PA		
		CONTAINS ASBESTOS AND TO BE REP	MOVED. SEE TABLES FOR CON	DITION AND FRIABILITY
<u>N</u> (	OTES:			
1.	IN ACCOR SPECIFIC MANAGEM	OVAL AND ABATEMENT WORK SHALL BE DANCE WITH DETAILED SPECIFICATIONS 13281- ASBESTOS MANAGEME 1ENT, AND 13284 - PCB MANAGEMENT, 1ONS AS APPLICABLE.	DNS 01355 - HAZARDOUS MAT ENT, 13282 - MERCURY MANAG	ERIALS CONTROL, AND EMENT, 13283 - LEAD
2.	2018, PRE	THE HAZARDOUS MATERIAL SURVEY EPARED BY BIDWELL ENVIRONMENTAL HAZARDOUS MATERIALS.		
3.		S CONTAINING < 5,000 MG/KG OR ≥ ING OR LEAD-BASED, RESPECTIVELY.	5,000 MG/KG LEAD ARE CONS	SIDERED LEAD-
4.		LS CONTAINING < 50 MG/KG OR ≥50 GULATED, RESPECTIVELY.	MG/KG PCBS ARE CONSIDERE	D PCB-CONTAINING OR
5.	MATERIAL MATERIAL	S CONTAINING MORE THAN 1% ASBE	STOS ARE CONSIDERED ASBES	STOS-CONTAINING
6.	REGULATI	ES AND LOCATIONS ARE APPROXIMAT ED PCBS AND UNIVERSAL OTHER REGU ONTRACTOR.		
7.	ALL HOLE	S CREATED BY REMOVED PIPES TO BE	FILLED. REFER TO S-501 FOR	REPAIR DETAIL.
		BID SET	GRAPHIC S CHECK BEFC	
			IF SHEET IS LESS IT IS A REDUCI SCALE ACCO	ED PRINT.
	REF	URPOSING OF THE KENSICC	) LABORATORY AS	DATE: MAY 2023
		THE KENSICO REGIONAL HE	ADQUARTERS	SCALE:
ION		MOUNT PLEASANT, NE		SHEET NO:
		CONTRACT CRO-	624	24 OF No. 121
		HAZMAT		DRAWING NO.
	E	KISTING SECOND FLOOR - DE	EMOLITION PLAN	HZ-106
	-			

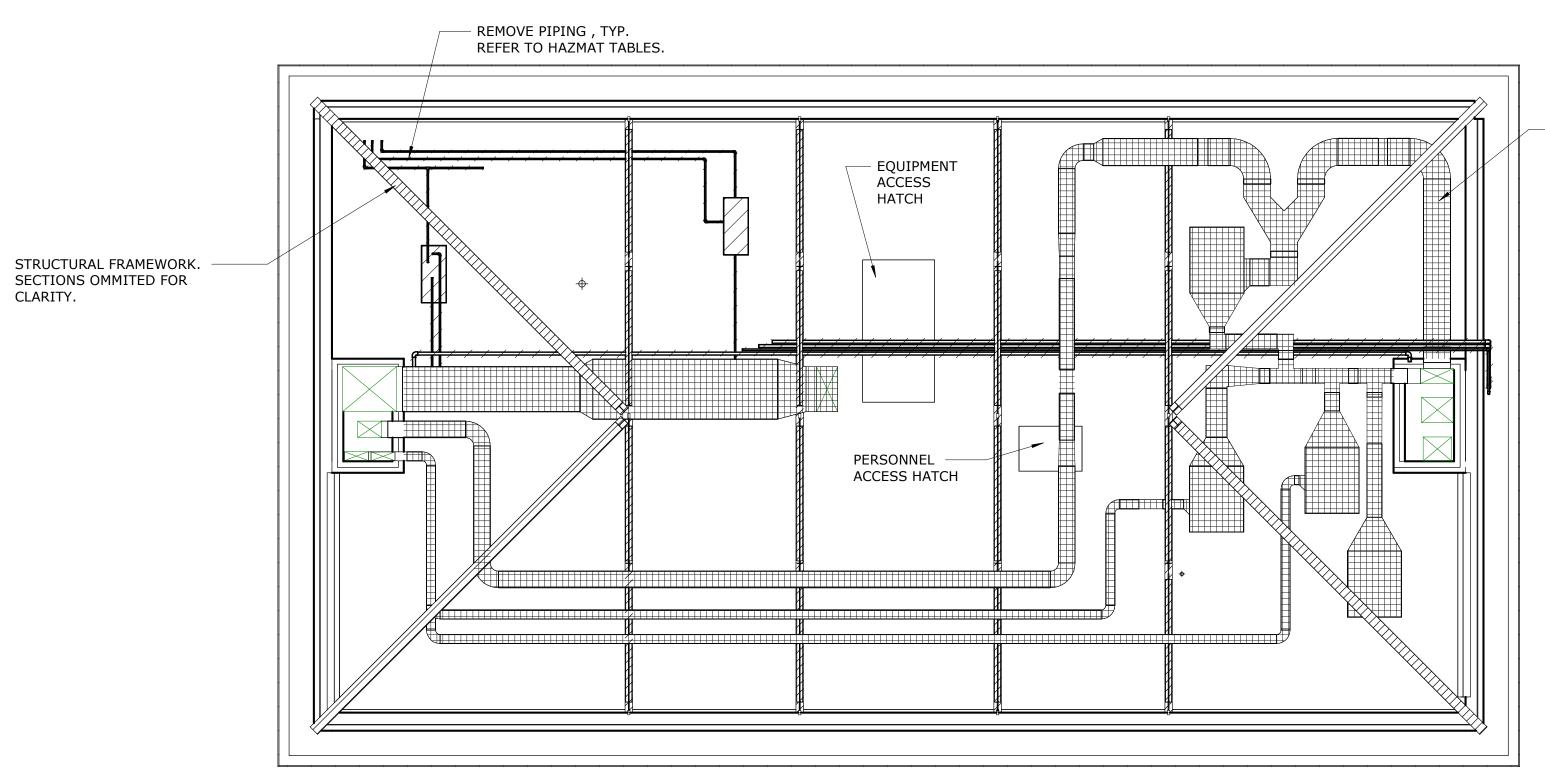

DEMOLITION PLAN - ATTIC 3/16" = 1'-0"



todesk Docs://90290-03A\_CAT-423 WO-03A Recon of Kensico Lab/90290-03A\_G\_K

All inquiries regarding this drawing(s) or project should be made to NYC Environmental Protection, Bureau of Water Supply.

## Summary of Confirmed Hazardous Materials for the Attic

### Lead and PCBs

Material Description	Location	Hazard	Sample ID
Silver paint	Frame work	Lead-based, PCB-containing	CAT423-ATT-PC-07
Yellow over silver paint	Framework	Lead-containing	CAT423-ATT-PC-08
Black paint	Duct work	Lead containing, PCB-containing	264428.02
Lead packing	Drain piping	Lead joints (23 locations)	

### Asbestos

Material Description	Location	Sample ID	Quantity	Condition	Friability
Black gasket	Inside HVAC unit	02130802-07E	88 linear ft	Damaged	Non-friable
Black residual mastic	HVAC duct	02130802-10E,11E,12E	Approx. 275 spots (2x2 in) on 750 ft <sup>2</sup> of duct work	Damaged	Non-friable

REMOVE DUCTWORK AND MECHANICAL UNITS, TYP.
 REFER TO HAZMAT TABLES.

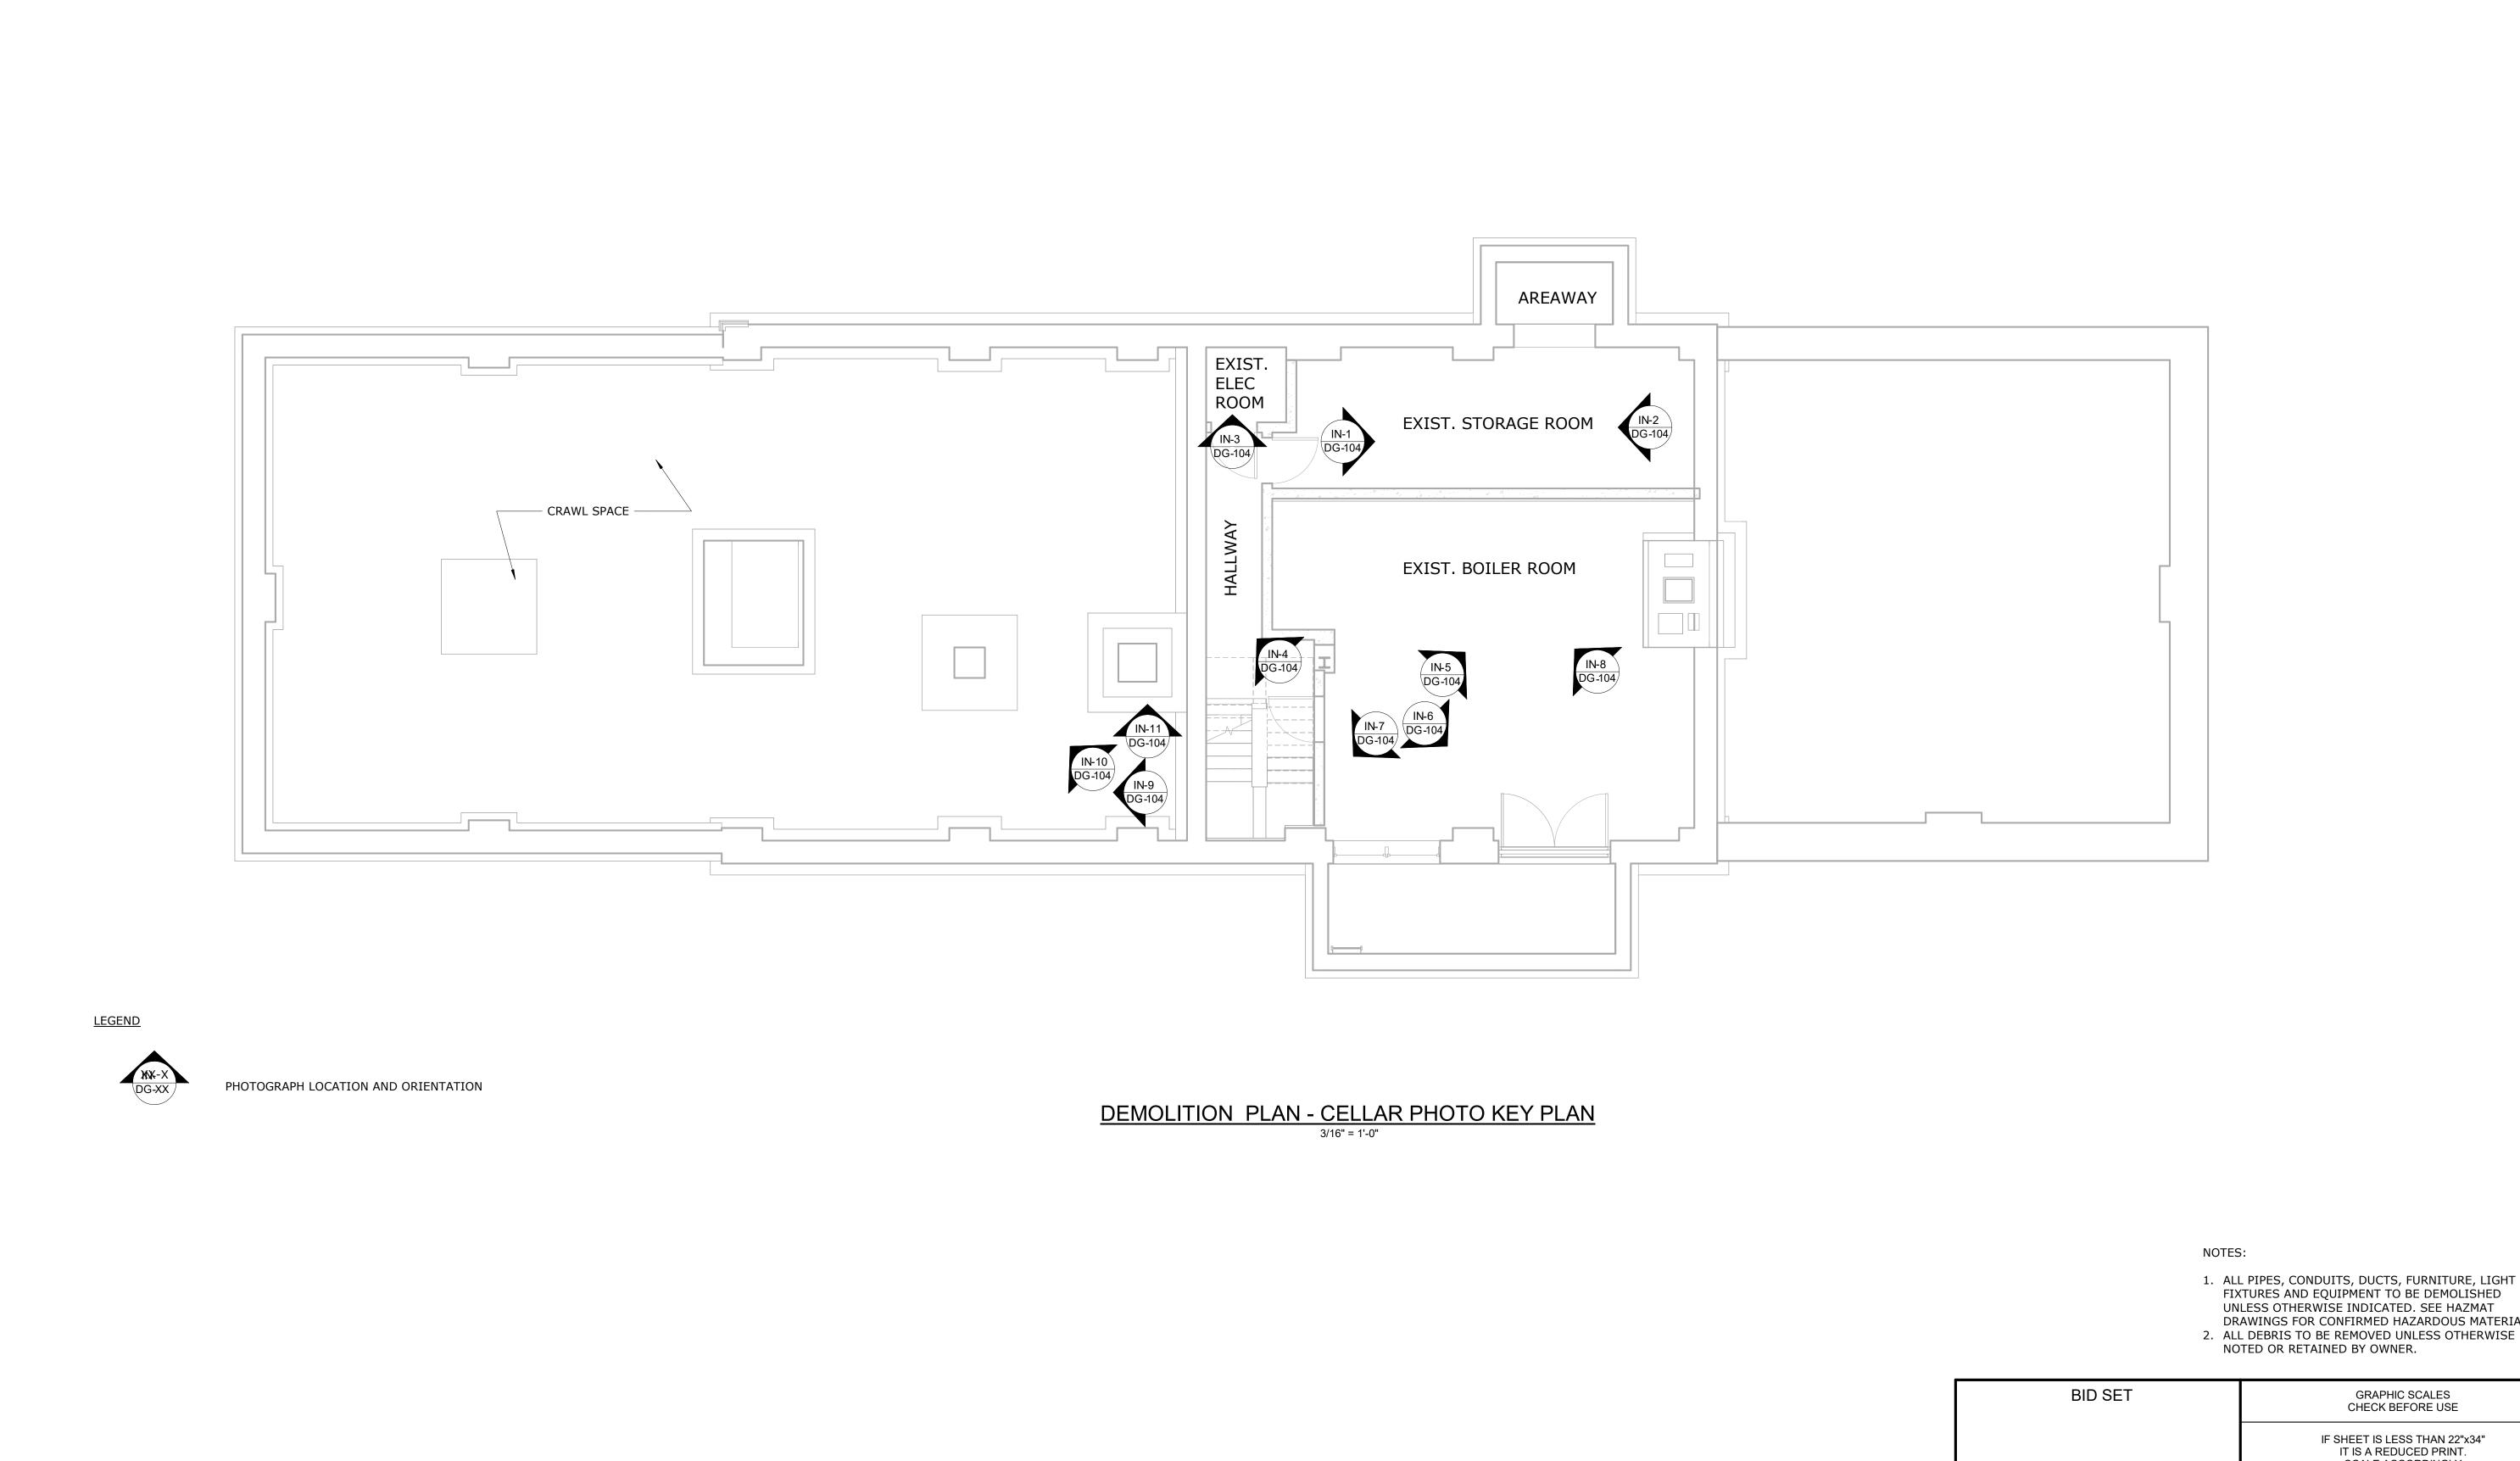
#### <u>LEGEND</u>

	DEMOLISH. SEE TABLES FOR HAZARDS.
////////	REMOVE LEAD-CONTAINING PAINT ON STRUCTURAL FRAMEWORK. SEE TABLES FOR PAINTS CONTAINING PCBS.
+++++++++++++++++++++++++++++++++++++++	CONTAINS ASPECTOS AND LEAD CONTAINING DED CONTAINING

CONTAINS ASBESTOS AND LEAD-CONTAINING, PCB-CONTAINING PAINT. TO BE REMOVED. SEE TABLES FOR ASBESTOS CONDITION AND FRIABILITY.

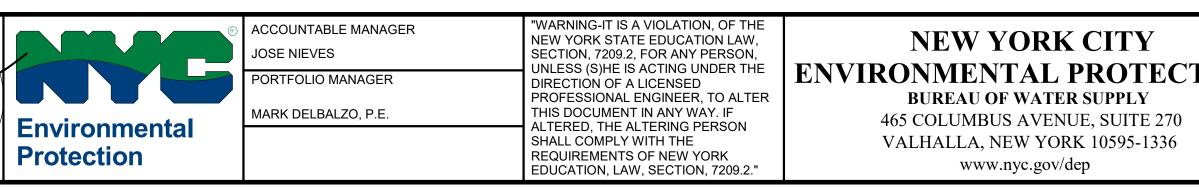
- ALL REMOVAL AND ABATEMENT WORK SHALL BE DOWN TO THE BARE SUBSTRATE AND COMPLETED IN ACCORDANCE WITH DETAILED SPECIFICATIONS 01355 - HAZARDOUS MATERIALS CONTROL, AND SPECIFICATIONS 13281- ASBESTOS MANAGEMENT, 13282 - MERCURY MANAGEMENT, 13283 - LEAD MANAGEMENT, AND 13284 - PCB MANAGEMENT, AS WELL AS FEDERAL, STATE, AND LOCAL REGULATIONS AS APPLICABLE.
- 2. REFER TO THE HAZARDOUS MATERIAL SURVEY REPORT FOR THE KENSICO LABORTORY, REV. 1, MAY 2018, PREPARED BY BIDWELL ENVIRONMENTAL, LLC FOR SUMMARY OF SAMPLING LOCATIONS OF SUSPECT HAZARDOUS MATERIALS.
- MATERIALS CONTAINING < 5,000 MG/KG OR ≥ 5,000 MG/KG LEAD ARE CONSIDERED LEAD-CONTAINING OR LEAD-BASED, RESPECTIVELY.
- MATERIALS CONTAINING < 50 MG/KG OR ≥50 MG/KG PCBS ARE CONSIDERED PCB-CONTAINING OR TSCA-REGULATED, RESPECTIVELY.
- 5. MATERIALS CONTAINING MORE THAN 1% ASBESTOS ARE CONSIDERED ASBESTOS-CONTAINING MATERIALS.
- 6. QUANTITIES AND LOCATIONS ARE APPROXIMATE FOR ASBESTOS-CONTAINING MATERIALS, TSCA-REGULATED PCBS AND UNIVERSAL OTHER REGULATED MATERIALS AND SHOULD BE FIELD VERIFIED BY THE CONTRACTOR.
- 7. ALL HOLES CREATED BY REMOVED PIPES TO BE FILLED. REFER TO S-501 FOR REPAIR DETAIL.

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	HAZMAT	DRAWING NO.		
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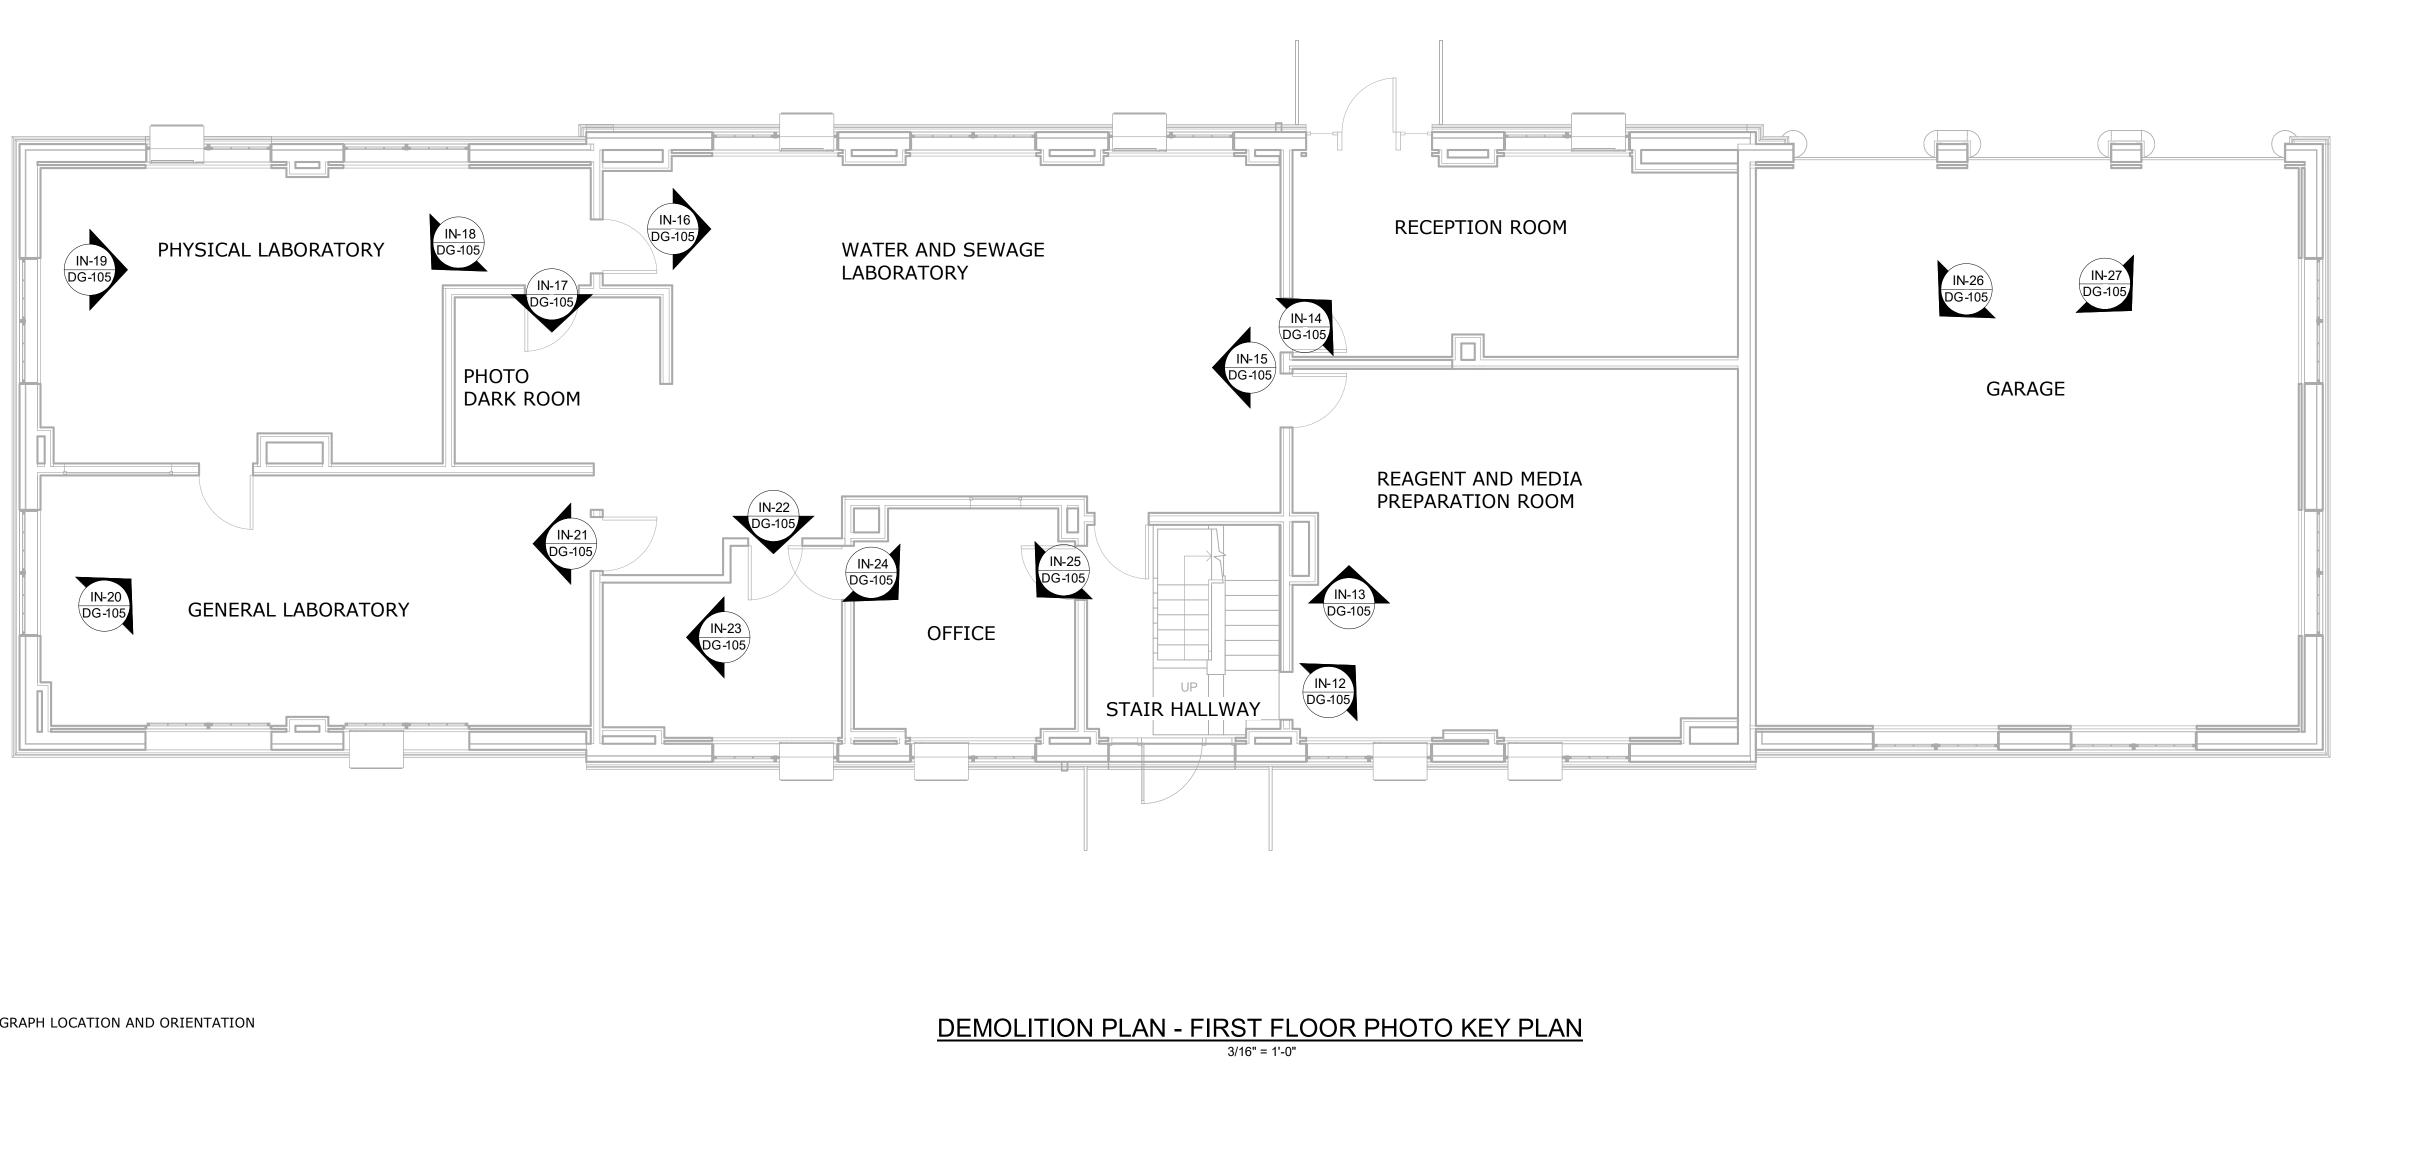
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						R. NEUMANN, P.E. CHECKED BY: E. BARBOE, P.E.	T. ORDONEZ DESIGN LEAD: E. BARBOE, P.E.	STATE S. B. P. P. S.

All inquiries regarding this drawing(s) or project should be made to NYC Environmental Protection, Bureau of Water Supply.



	FIXTURES AND EQUIPMENT TO BE DEMOLISHED UNLESS OTHERWISE INDICATED. SEE HAZMAT DRAWINGS FOR CONFIRMED HAZARDOUS MATERIALS. 2. ALL DEBRIS TO BE REMOVED UNLESS OTHERWISE NOTED OR RETAINED BY OWNER.				
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TION	CONTRACT CRO-		26 OF No. 121		
	DEMOLITION	DRAWING NO.			
	CELLAR PHOTO KEY	DG-100			





LEGEND



PHOTOGRAPH LOCATION AND ORIENTATION

90-03A_CAT-42					DESIGNED BY: R. NEUMANN, P.E. CHECKED BY: E. BARBOE, P.E.	DRAWN BY: T. ORDONEZ DESIGN LEAD: E. BARBOE, P.E.	/	STATE OF NEW PRO
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All inquiries regarding this drawing(s) or project should be made to NYC Environmental Protection, Bureau of Water Supply.



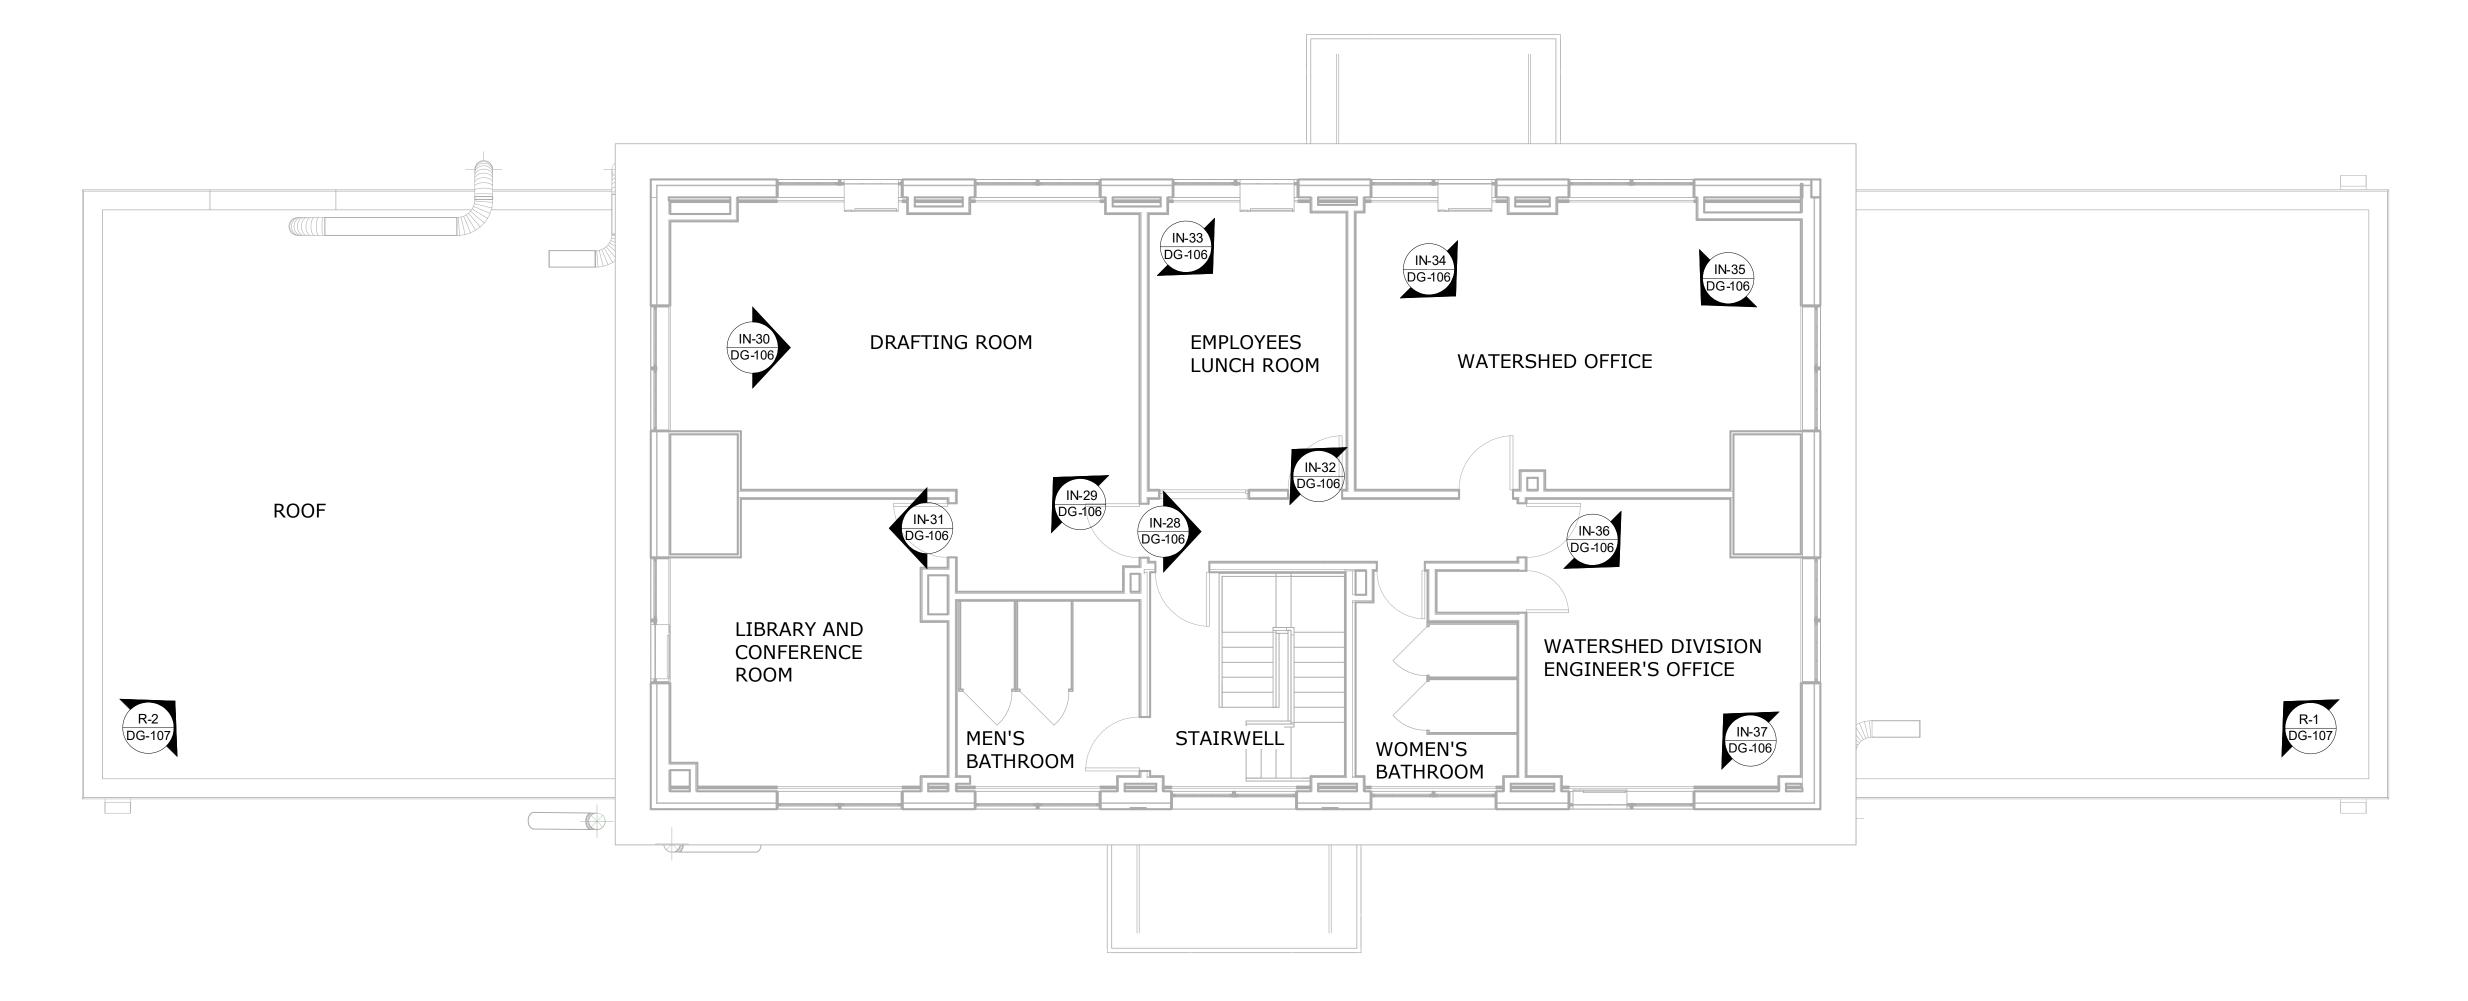
"WARNING-IT IS A VIOLATION, OF THE NEW YORK STATE EDUCATION, OF THE NEW YORK STATE EDUCATION LAW, SECTION, 7209.2, FOR ANY PERSON, UNLESS (S)HE IS ACTING UNDER THE DIRECTION OF A LICENSED PROFESSIONAL ENGINEER, TO ALTER THIS DOCUMENT IN ANY WAY. IF ALTERED, THE ALTERING PERSON SHALL COMPLY WITH THE REQUIREMENTS OF NEW YORK EDUCATION, LAW, SECTION, 7209.2."





NOTES:

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	DEMOLITION		DRAWING NO.
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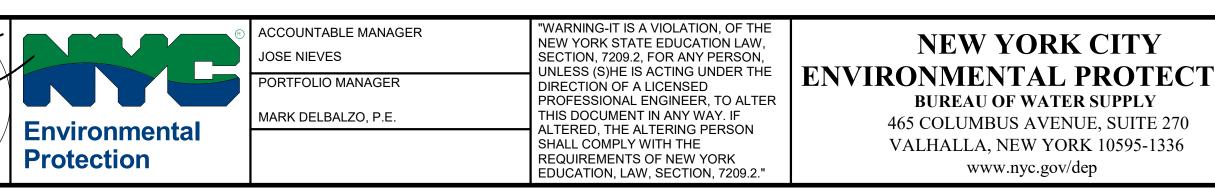


PHOTOGRAPH LOCATION AND ORIENTATION

CAT-423 WC					DESIGNED BY: R. NEUMANN, P.E.	DRAWN BY: T. ORDONEZ	STE OF NEW
-03A_					CHECKED BY: E. BARBOE, P.E.	DESIGN LEAD: E. BARBOE, P.E.	
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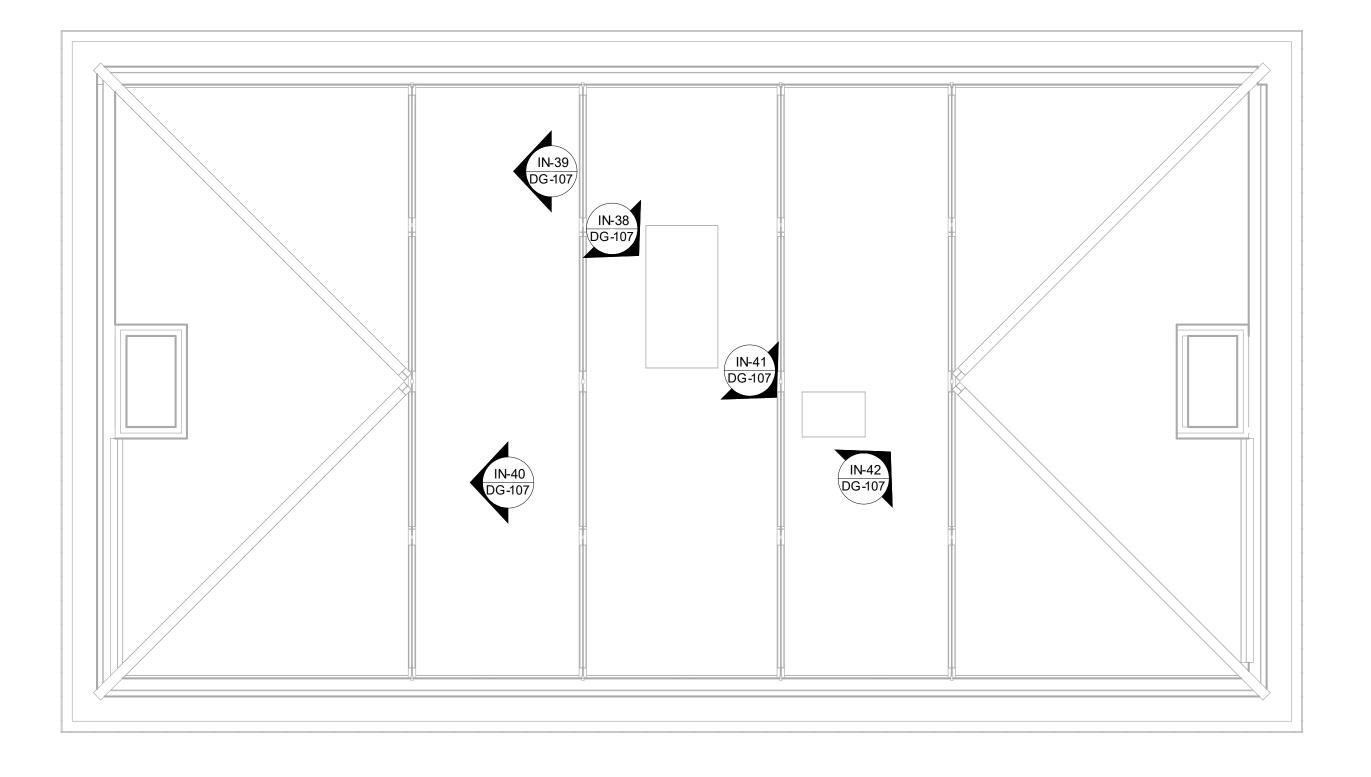
All inquiries regarding this drawing(s) or project should be made to NYC Environmental Protection, Bureau of Water Supply.

#### **DEMOLITION PLAN - SECOND FLOOR PHOTO KEY PLAN** 3/16" = 1'-0"



- 1. ALL PIPES, CONDUITS, DUCTS, FURNITURE, LIGHT ALL PIPES, CONDUITS, DUCTS, FORNITORE, LIGHT FIXTURES AND EQUIPMENT TO BE DEMOLISHED UNLESS OTHERWISE INDICATED. SEE HAZMAT DRAWINGS FOR KNOWN HAZARDOUS MATERIALS.
   ALL DEBRIS TO BE REMOVED UNLESS OTHERWISE NOTED OR RETAINED BY OWNER.

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	THE KENSICO REGIONAL HE	SCALE: AS NOTED	
ION	MOUNT PLEASANT, NE	SHEET NO:	
	CONTRACT CRO-	624	28 OF No. 121
	DEMOLITION		DRAWING NO.
	SECOND FLOOR PHOTO	KEY PLAN	DG-102







PHOTOGRAPH LOCATION AND ORIENTATION

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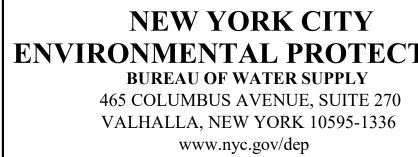
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#### DEMOLITION PLAN - ATTIC PHOTO KEY PLAN 3/16" = 1'-0"



ACCOUNTABLE MANAGER
JOSE NIEVES
PORTFOLIO MANAGER
MARK DELBALZO, P.E.

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TION	CONTRACT CRO-	29 OF No. 121		
	DEMOLITION	DRAWING NO.		
	ATTIC PHOTO KEY PLAN		DG-103	

NOTES:



EXISTING STORAGE ROOM (IN-2)

DG-100

CARFULLY MOVE
 EXISTING UPS TO
 TEMPORARY TRAILER.
 SEE SECURITY
 DRAWINGS.











EXISTING BOILER ROOM

<u>И</u> (IN-7 DG-100)

EXISTING BOILER ROOM

todesk Docs://90290-03A\_CAT-423 WO-03A Recon of Kensico Lab/90290-03A\_G\_KI

					R. NEUMANN, P.E. CHECKED BY: E. BARBOE, P.E.	T. ORDONEZ DESIGN LEAD: E. BARBOE, P.E.	STATE OF NEW
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All inquiries regarding this drawing(s) or project should be made to NYC Environmental Protection, Bureau of Water Supply.



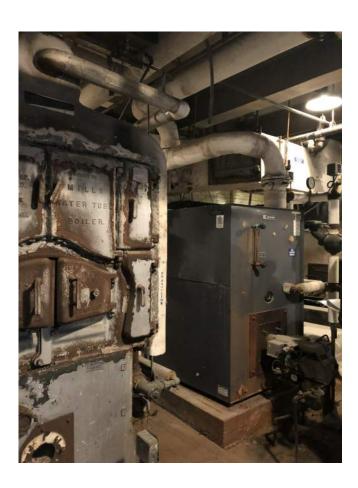
EXISTING ELECTRICAL





BASEMENT HALLWAY

IN-10 DG-100



EXISTING BOILER ROOM



CRAWL SPACE

IN-9 DG-100



CRAWL SPACE

CRAWL SPACE



)	ACCOUNTABLE MANAGER	"WAF NEW
	JOSE NIEVES	SEC
	PORTFOLIO MANAGER	UNLE
	MARK DELBALZO, P.E.	PRO THIS
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(IN-5 DG-100





NOTES:

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	CONTRACT CRO-	30 OF No. 121	
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REAGENT AND MEDIA PREPARATION ROOM

IN-12 DG-101

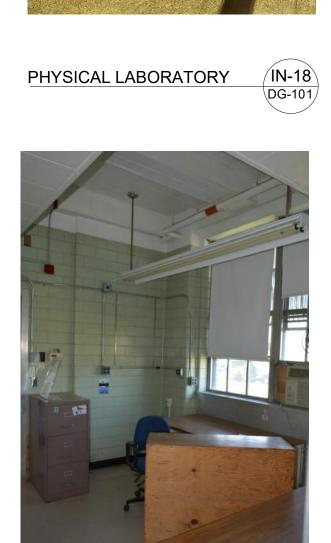


PHYSICAL LABORATORY

(IN-19) \DG-101/



OFFICE



OFFICE



DRAWN BY: DESIGNED BY: R. NEUMANN, P.E. T. ORDONEZ CHECKED BY: DESIGN LEAD: 極 E. BARBOE, P.E. E. BARBOE, P.E. Hazen

NO. DATE

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**REVISIONS/DESCRIPTION** 

(IN-24 DG-101)

APPR'D



WATER AND SEWAGE LABORATORY



OFFICE



WATER AND SEWAGE LABORATORY (IN-15 DG-101)



SAMPLE RECEPTION ROOM (IN-14 DG-101)



GENERAL LABORATORY

(IN-21)

DG-101/



IN-26 DG-101

ACCOUNTABLE MANAGER

PORTFOLIO MANAGER

MARK DELBALZO, P.E.

JOSE NIEVES

GENERAL LABORATORY










GARAGE

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GARAGE

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IN-16 DG-101



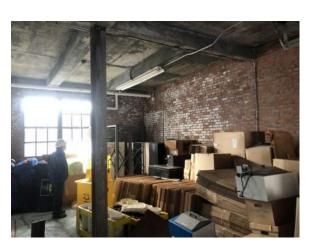

(IN-17 DG-101) PHOTO DARK ROOM



OFFICE

IN-23 DG-101

NOTES:

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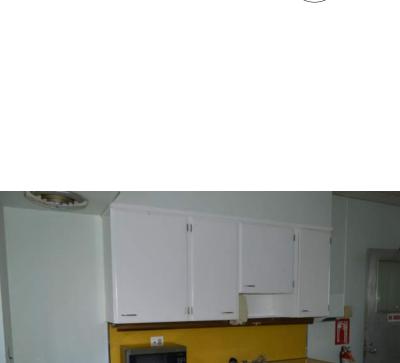












HALLWAY

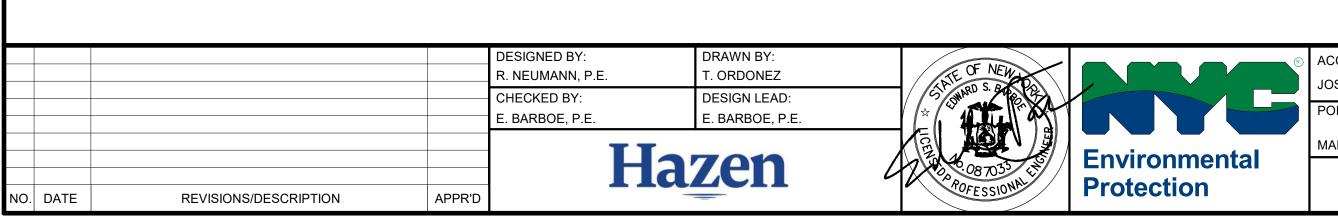
IN-28 DG-102







EMPLOYEES LUNCH ROOM (IN-33) DG-102



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CAREFULLY MOVE EXISTING SERVER TO TEMPORARY TRAILER. SEE SECURITY DRAWINGS.



DRAFTING ROOM







 $\frown$ 

(IN-34 DG-102





WATERSHED DIVISION ENGINEERS OFFICE



 $\frown$ (IN-35 DG-102  $\smallsetminus$   $\checkmark$ 

IN-30 DG-102




CCOUNTABLE MANAGER
OSE NIEVES
ORTFOLIO MANAGER
IARK DELBALZO, P.E.

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EMPLOYEES LUNCH ROOM IN-32 DG-102



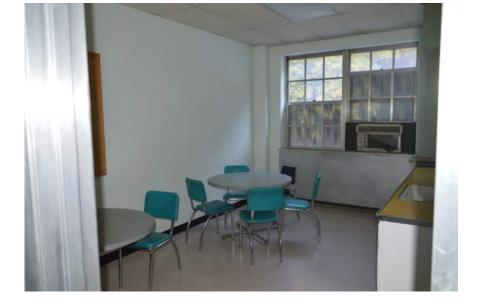WATERSHED DIVISION ENGINEERS OFFICE


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	DEMOLITION		DRAWING NO.	
	SECOND FLOOR PH	OTOS	DG-106	







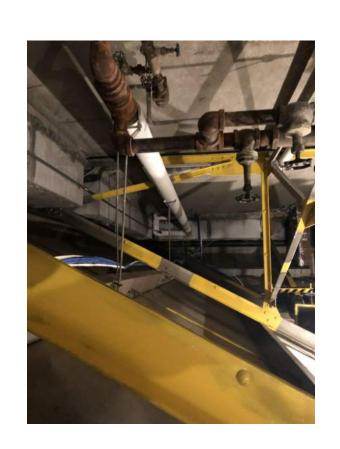ATTIC





SOUTH ROOF

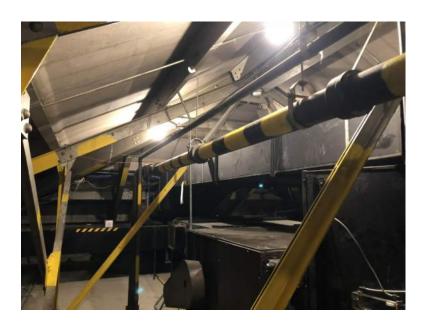
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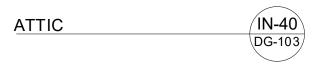
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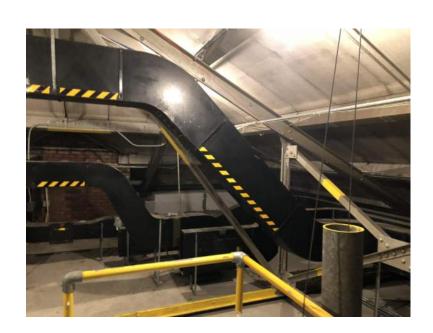
IN-42 DG-103 ATTIC

DESIGNED BY: DRAWN BY: R. NEUMANN, P.E. T. ORDONEZ CHECKED BY: DESIGN LEAD: E. BARBOE, P.E. E. BARBOE, P.E. Hazen NO. DATE **REVISIONS/DESCRIPTION** APPR'D All inquiries regarding this drawing(s) or project should be made to NYC Environmental Protection, Bureau of Water Supply.

IN-39 DG-103  $\searrow$ 

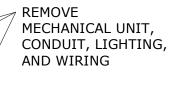






AT





DEMOLISH EXISTING WINDOWS, (TYP)

REMOVE MATS,
 PLYWOOD, AND
 CINDER BLOCKS



 REMOVE MECHANICAL UNITS, CONDUIT, AND WIRING

R-1 DG-102

NORTH ROOF

R-2 DG-102



ACCOUNTABLE MANAGER JOSE NIEVES PORTFOLIO MANAGER MARK DELBALZO, P.E.

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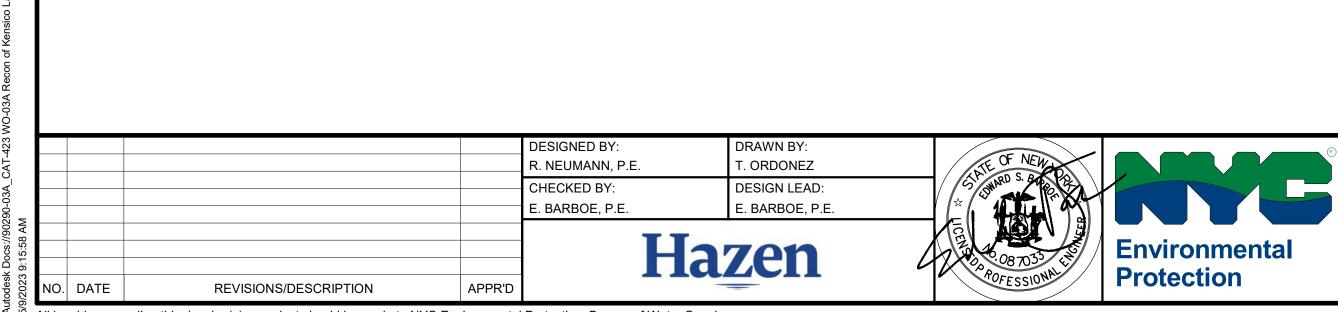
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NOTES:

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	CONTRACT CRO-	33 OF No. 121	
	DEMOLITION ATTIC AND ROOF PHOTOS		DRAWING NO.
			DG-107







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SOUTH AND WEST FACADES


ACCOUNTABLE MANAGER
JOSE NIEVES
PORTFOLIO MANAGER
MARK DELBALZO, P.E.

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EX-2 DG-101

NOTES: SEE HAZMAT DRAWINGS FOR CONFIRMED HAZARDOUS MATERIALS,
 DEMOLISH ALL EXISISTING DOORS, GARAGE DOORS, AND WINDOWS. REMOVE AND DISPOSE OF ALL AIR CONDITIONER UNITS, VENTALATION EXHAUST DUCTS, MECHANICAL UNITS, CONDUIT, WIRING, LIGHTING FIXTURES, LIGHTNING PROTECTION, ANTENNAS, AND PIPING. BID SET GRAPHIC SCALES CHECK BEFORE USE IF SHEET IS LESS THAN 22"x34" IT IS A REDUCED PRINT. SCALE ACCORDINGLY REPURPOSING OF THE KENSICO LABORATORY AS DATE: MAY 2023 THE KENSICO REGIONAL HEADQUARTERS SCALE: AS NOTED MOUNT PLEASANT, NEW YORK SHEET NO: CONTRACT CRO-624 34 OF No. 121 DRAWING NO. **DEMOLITION PLAN - EXTERIOR PHOTOS** DG-108




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ACCOUNTABLE MANAGER
JOSE NIEVES
PORTFOLIO MANAGER
MARK DELBALZO, P.E.

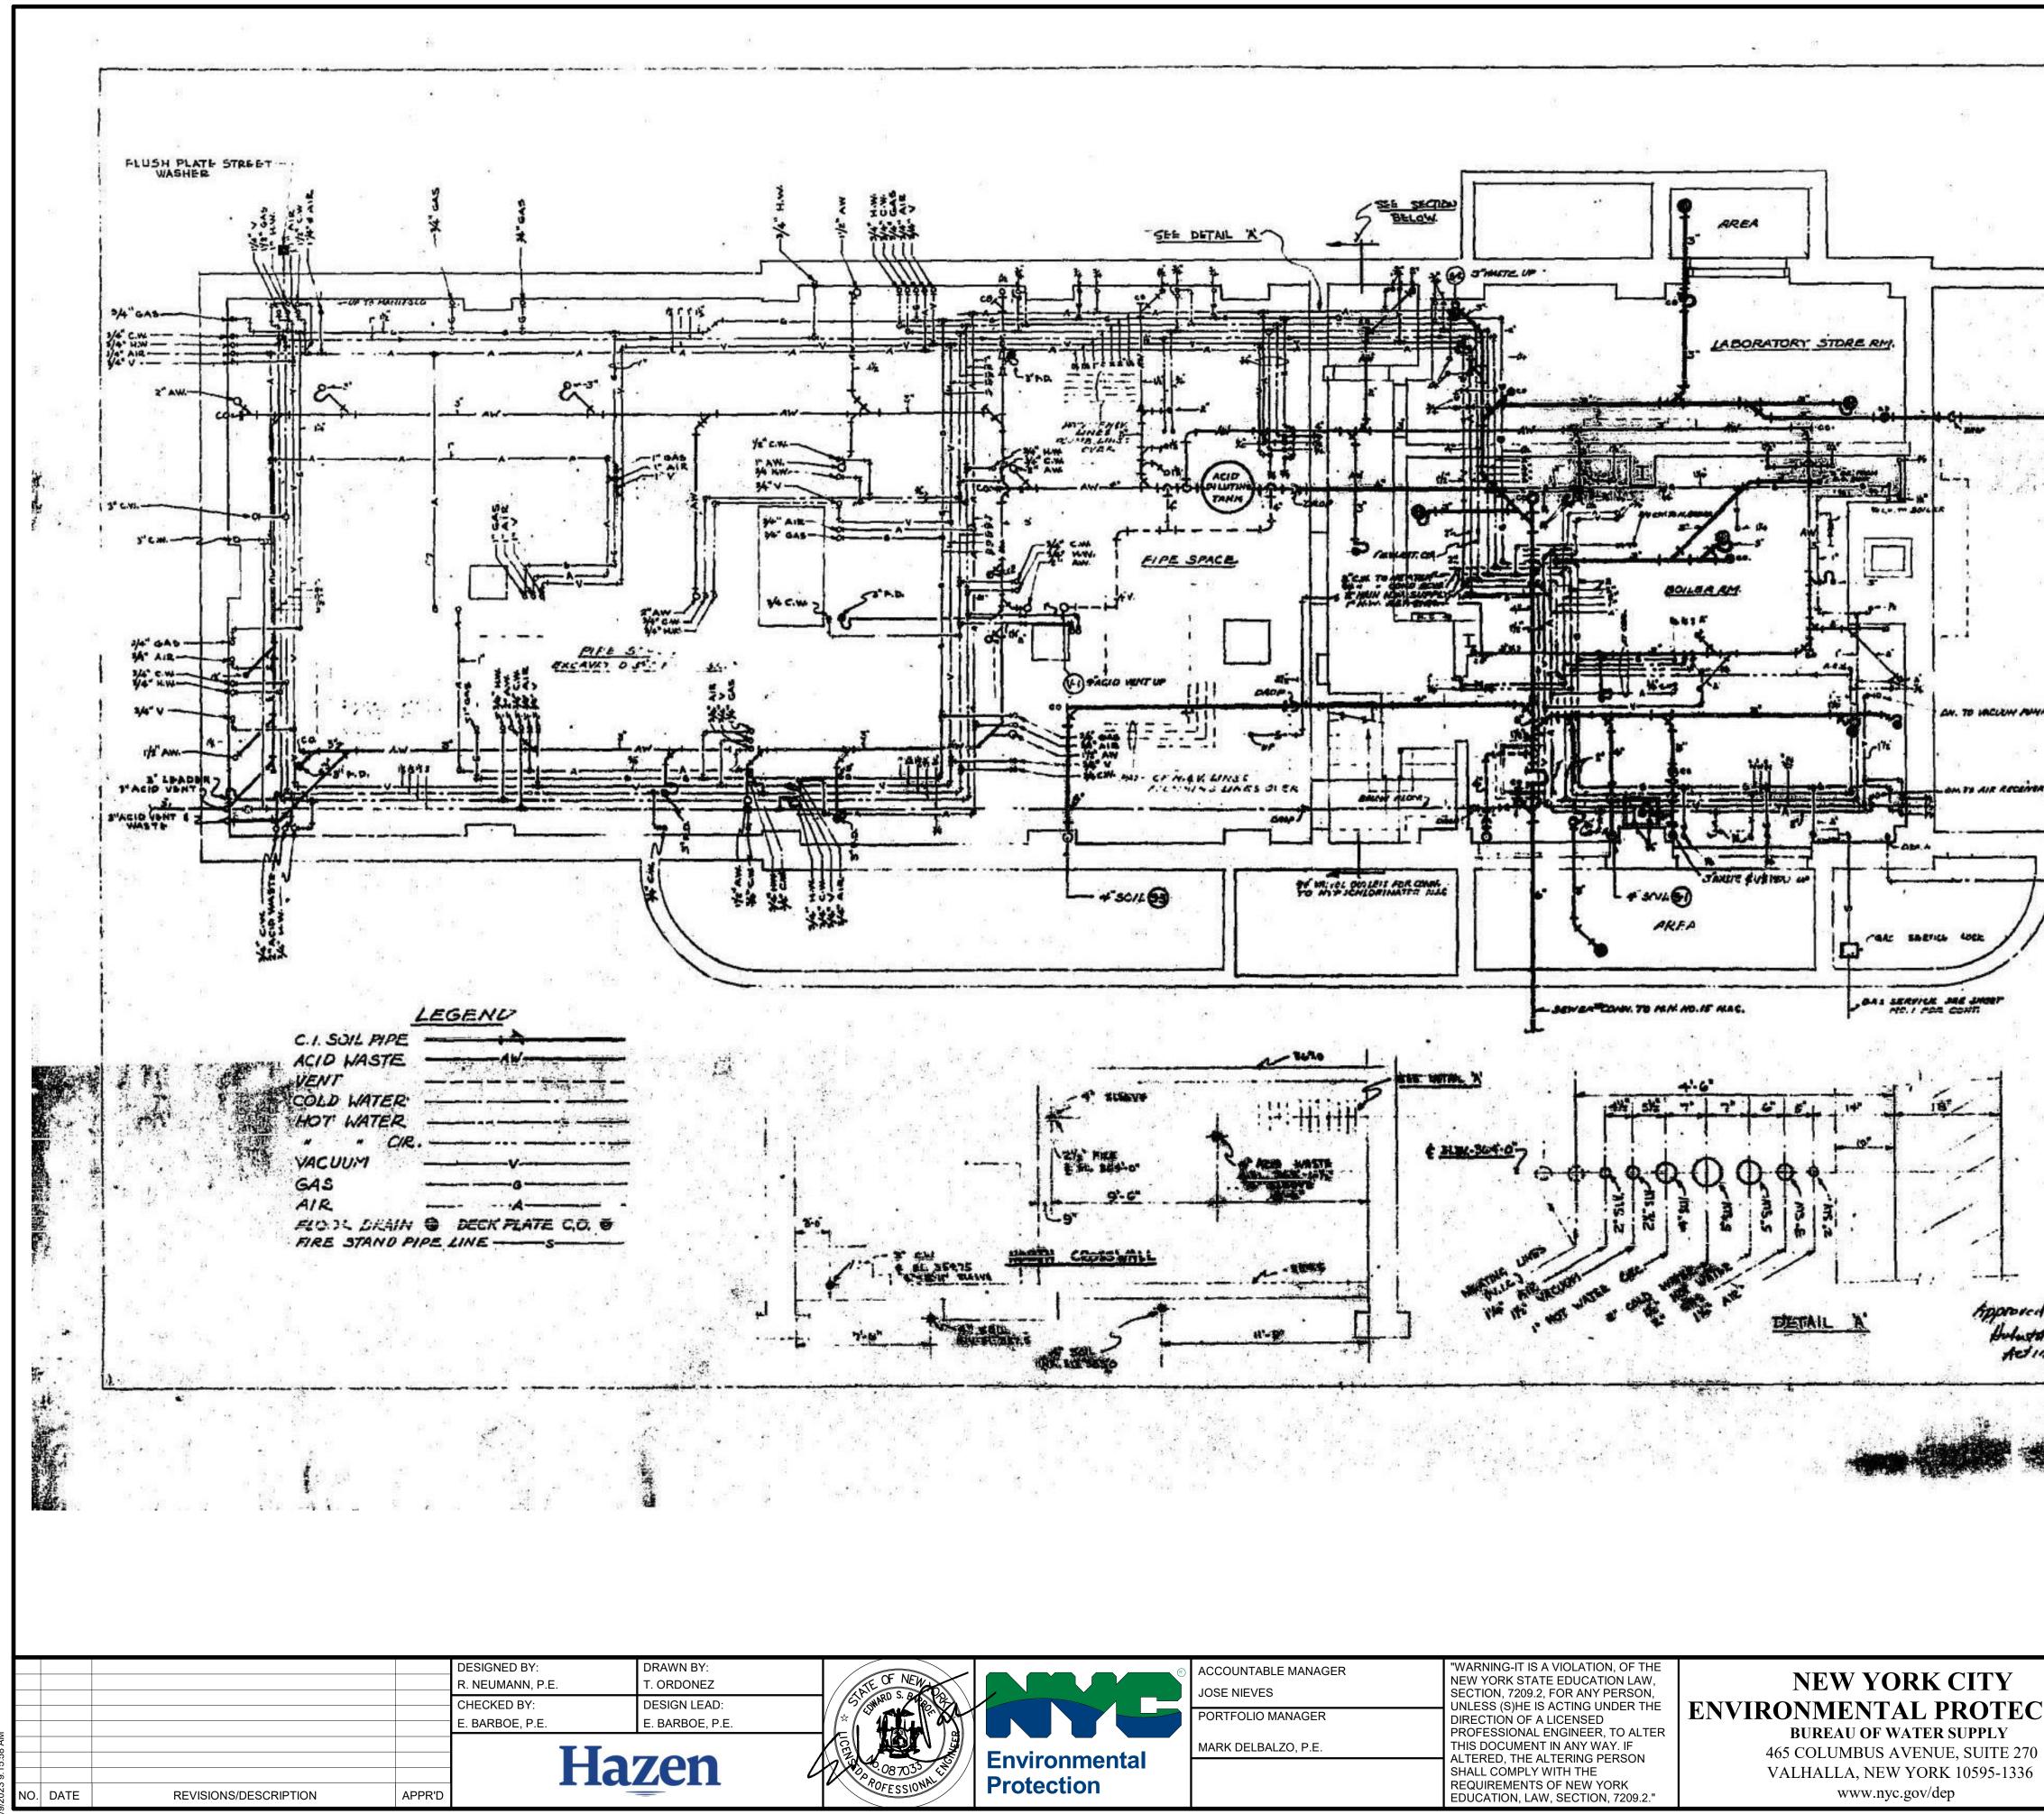
465 COLUMBUS AVENUE, SUITE 270
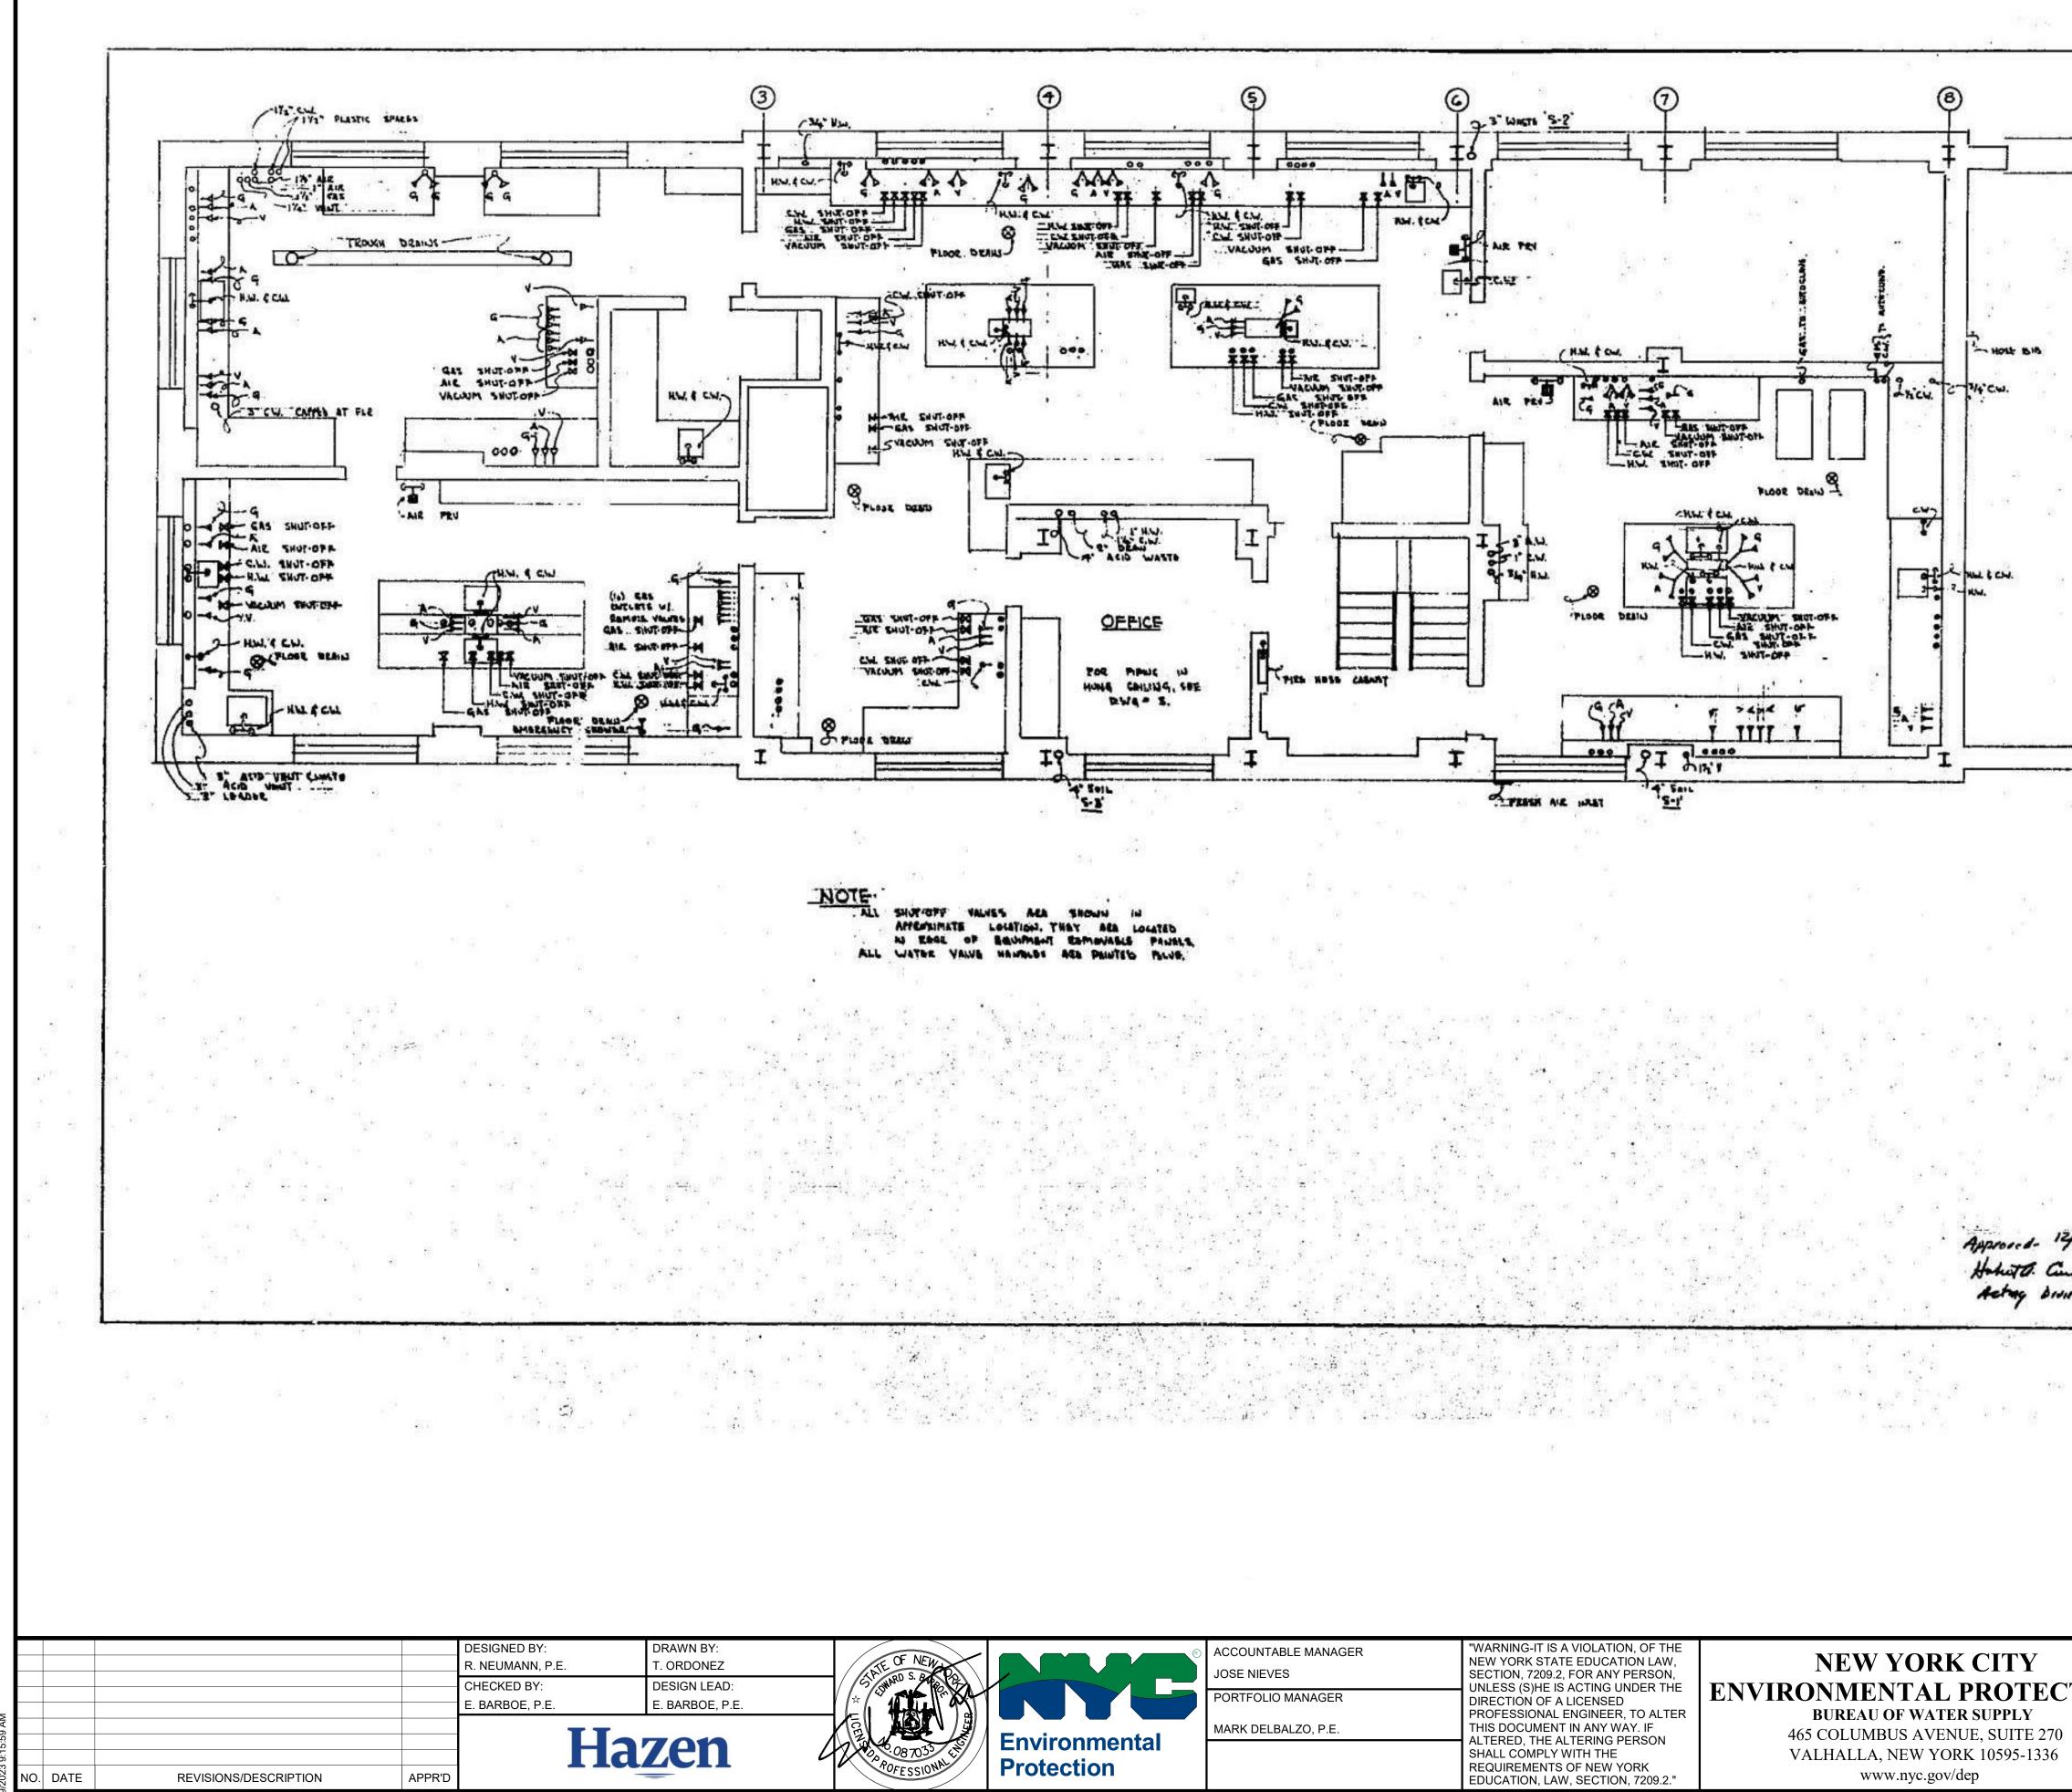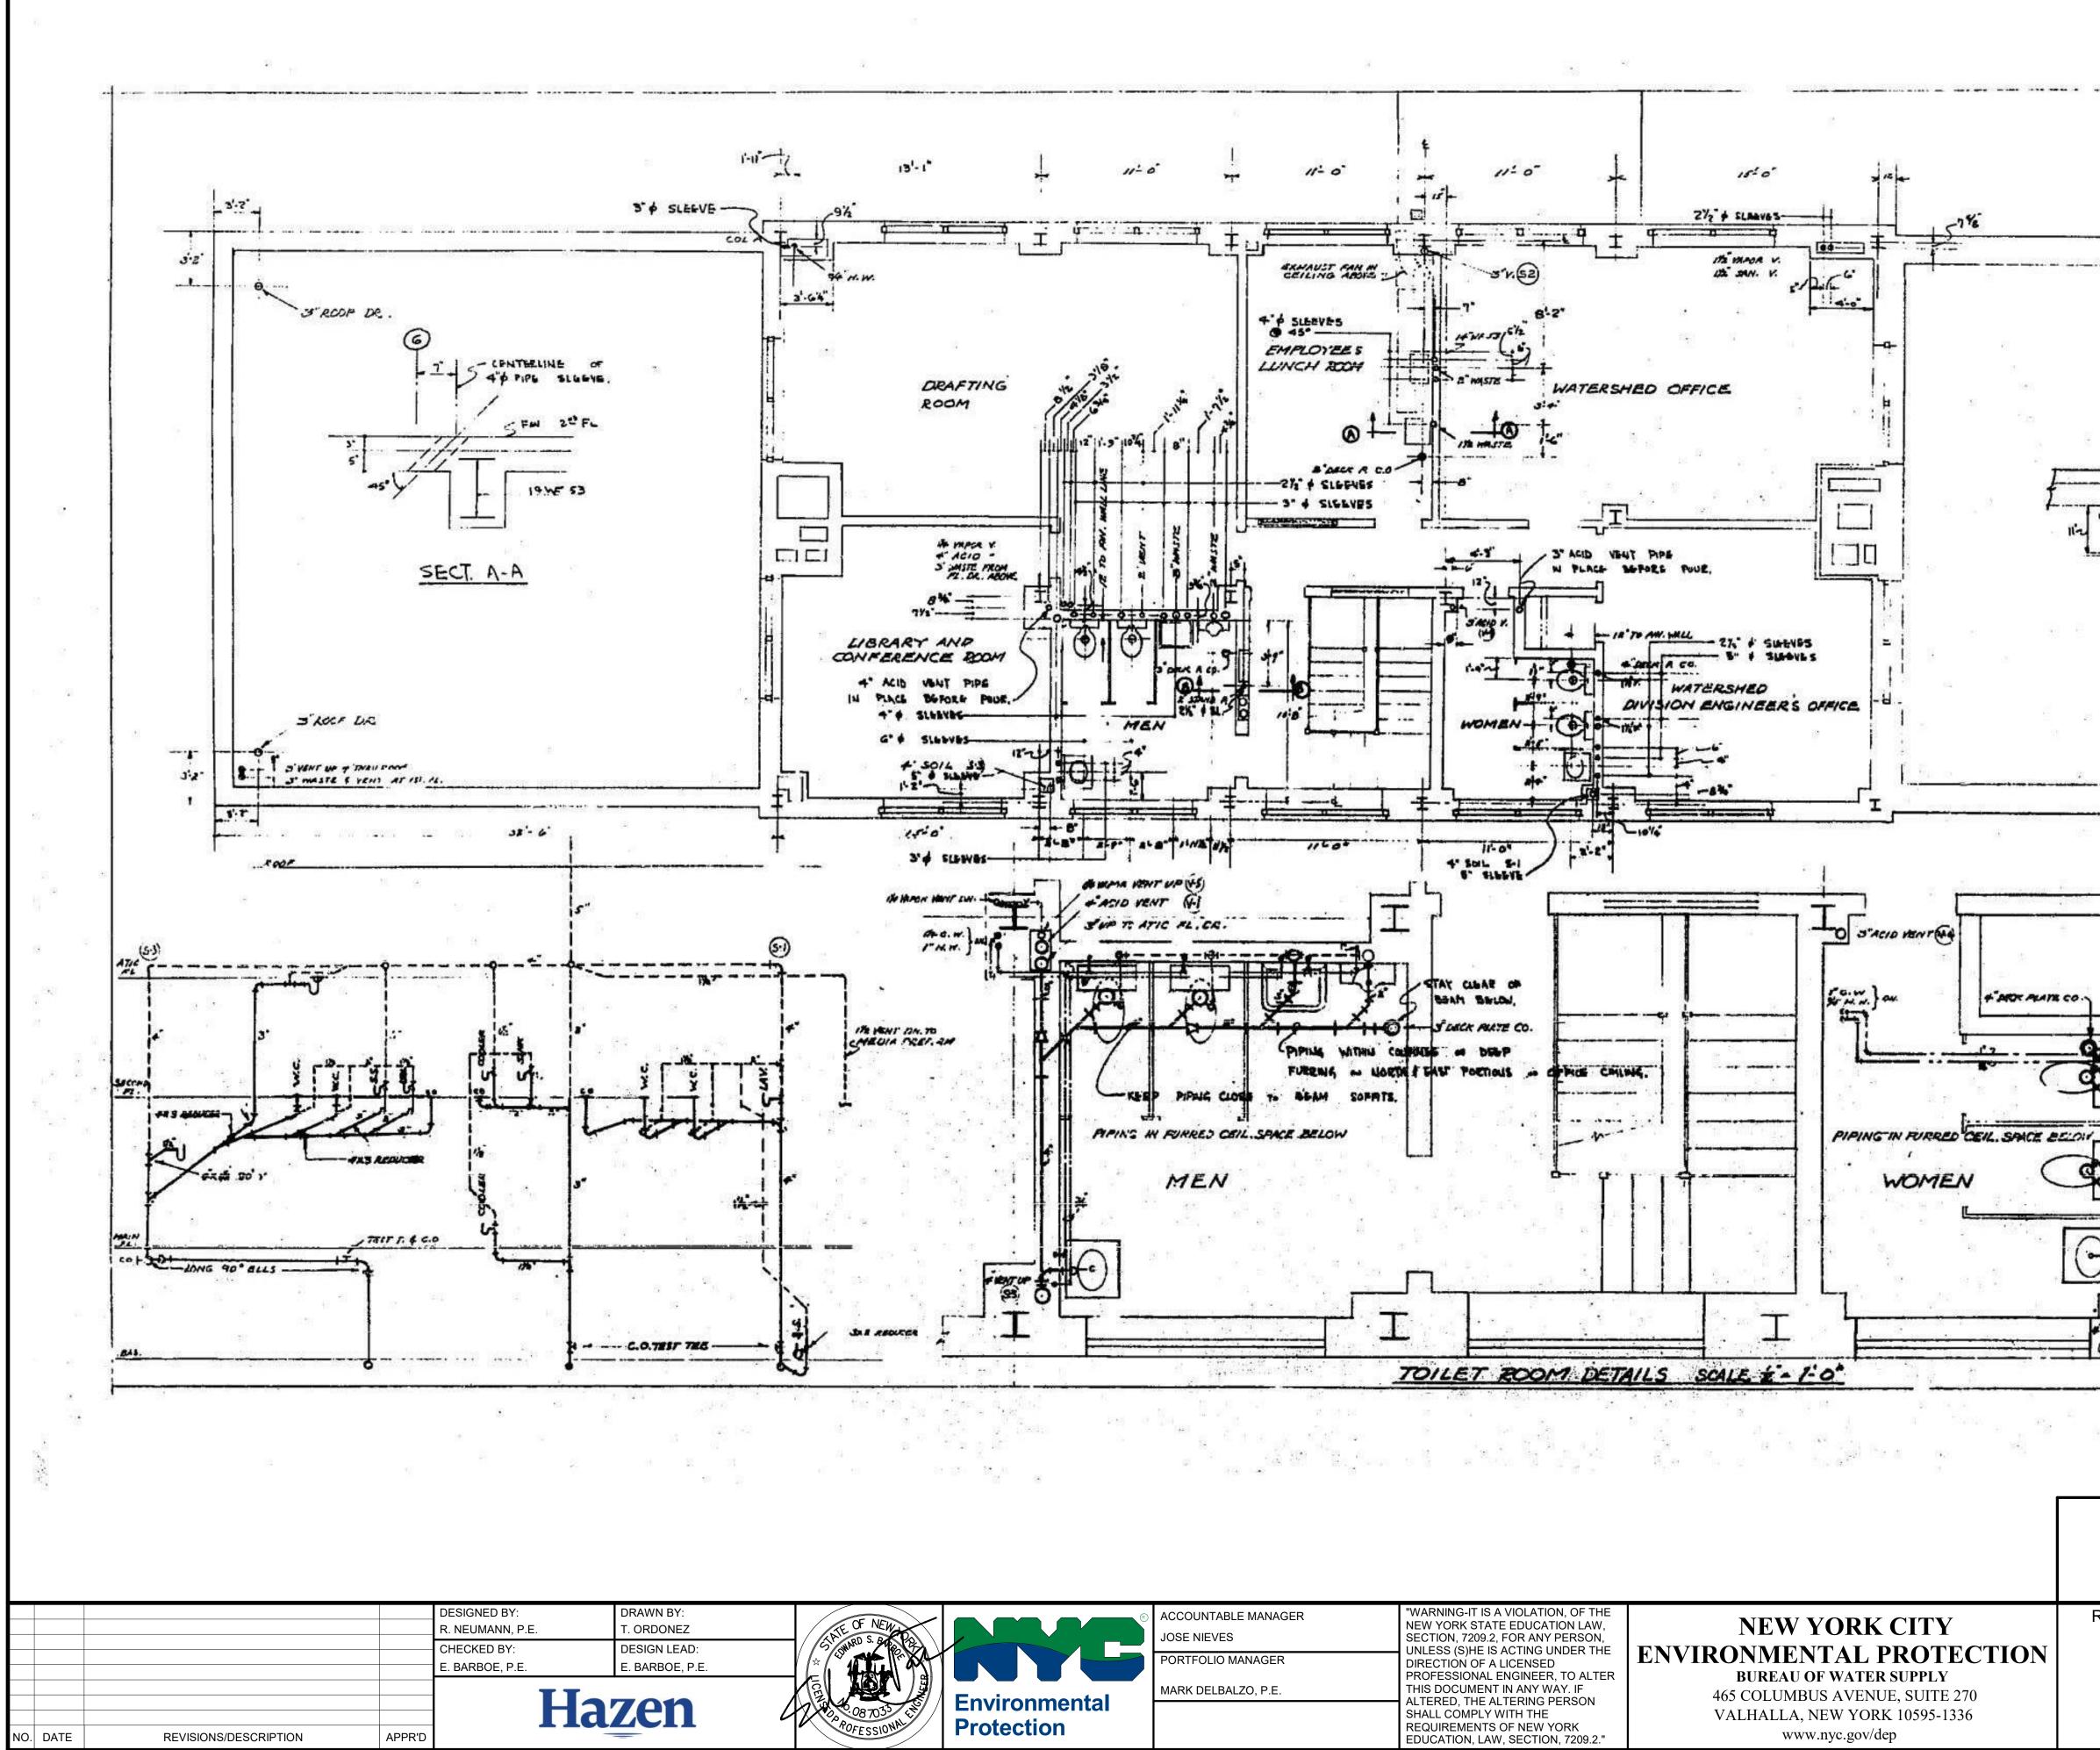
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<del>J.</del>	PLUSH FLATE STREET WASHER	
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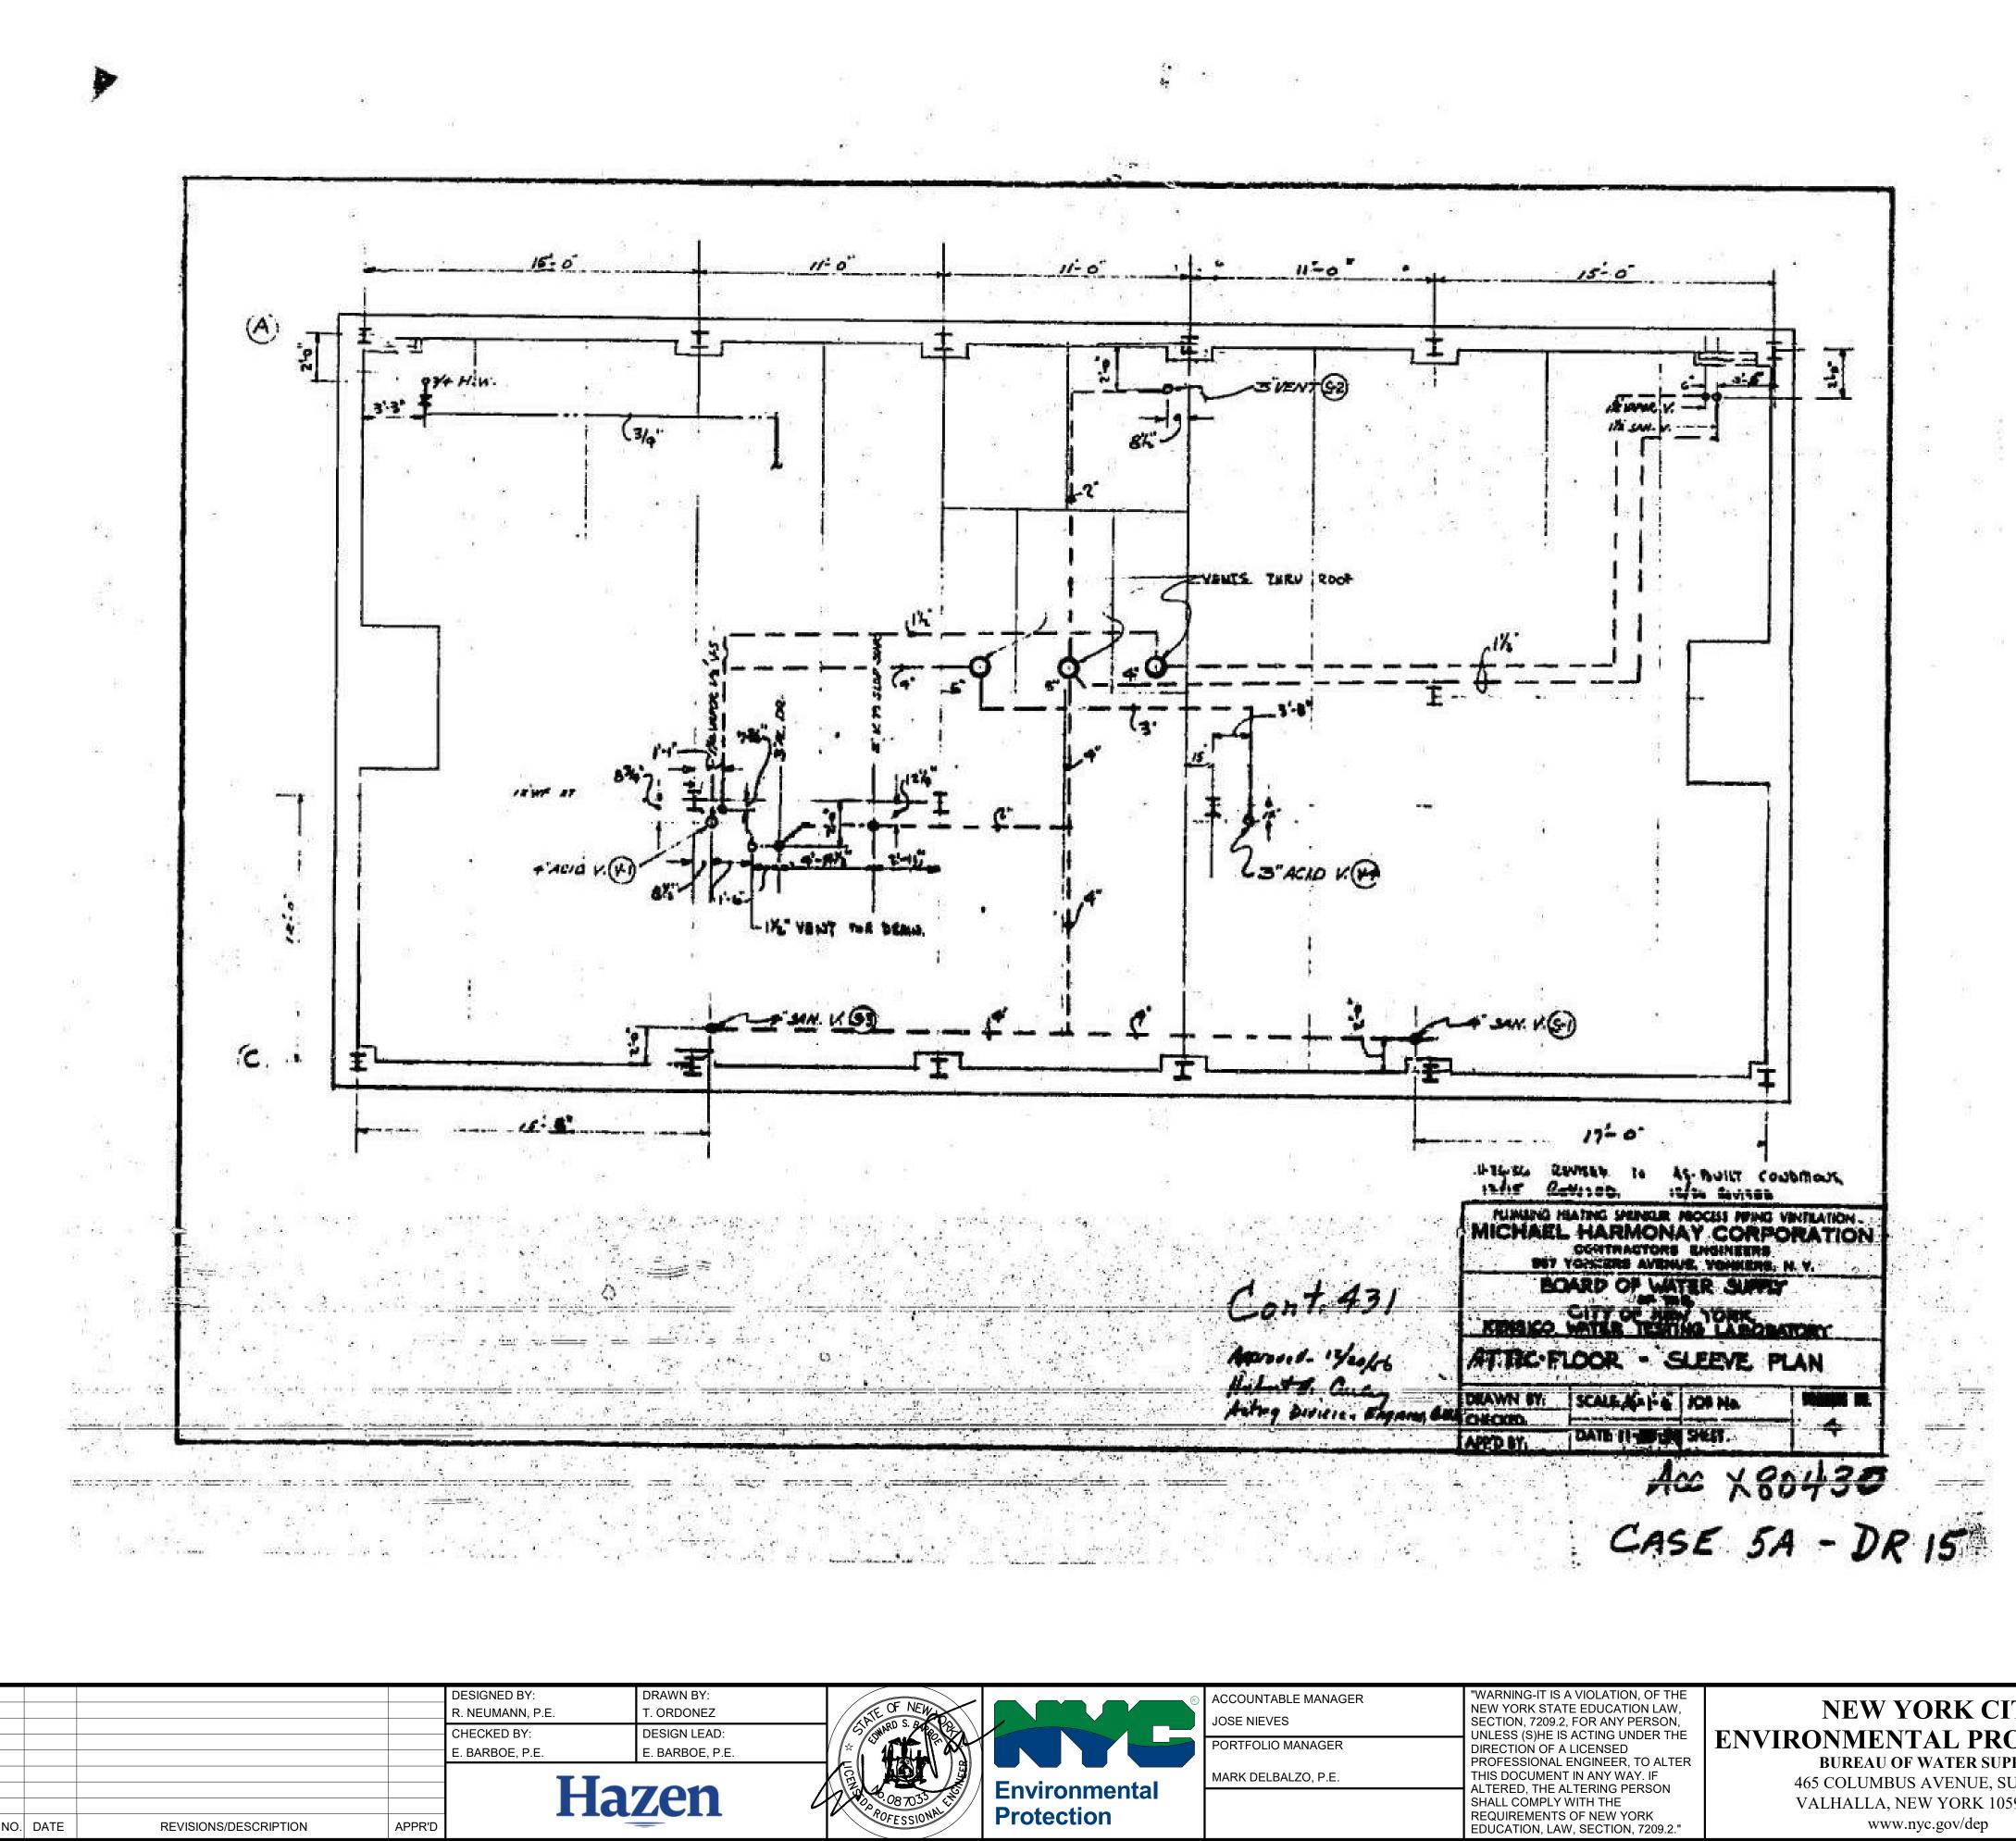


<sup>10</sup> All inquiries regarding this drawing(s) or project should be made to NYC Environmental Protection, Bureau of Water Supply.

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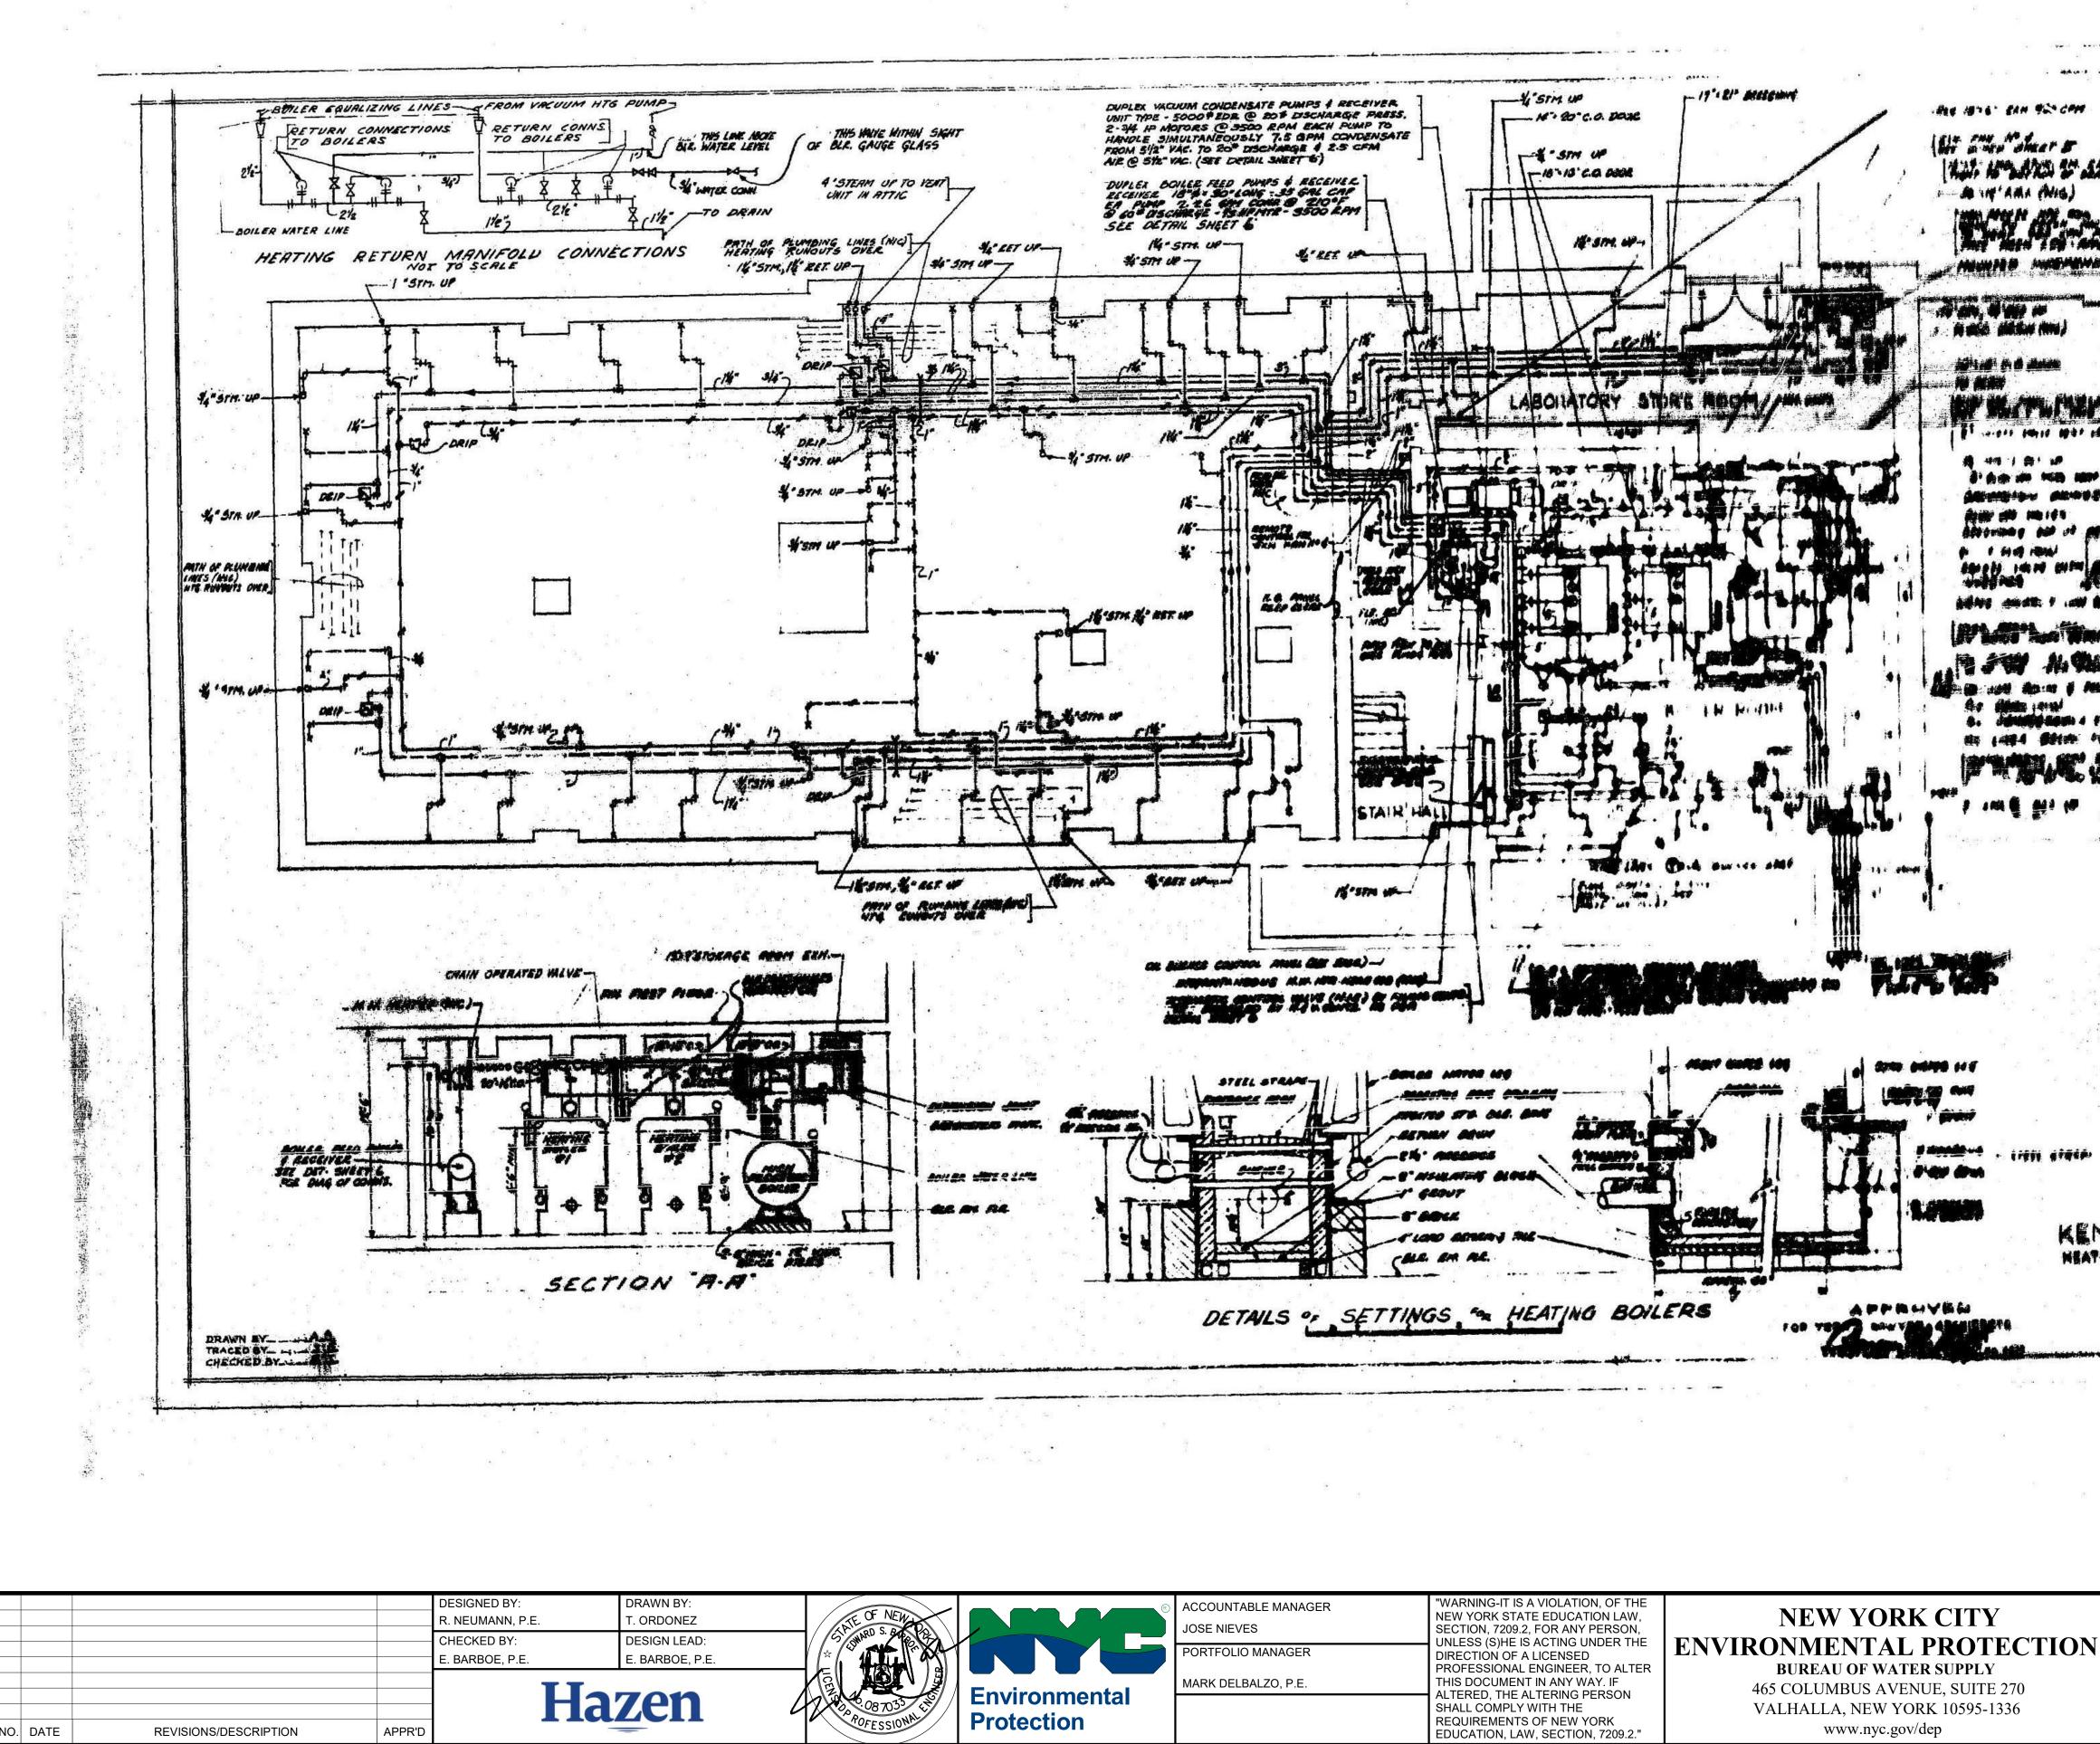
-----3.2 B ROOF OR FM. 240 P MAN. - \$13.0 12 - 23 254 - Zh e SLEAVE SECT. B.B. 3 ROOF DR dene. 4" THERAS - SE VENT FIG. SGS J.E. SMILLE DETAIL OF H.C. ROUSHING FOR W. I. PIPE Approved- 12/29/18 Huturd. Contry Acting Prinsib, Engineer, B.W.S. ILEG. SC . LANSES TO AS BUILT CONDITIONS. 12.3.11 - LAN, 10 ALC. I SHAR. CORESCIPTION. MICHAEL HARMONAY CORPORATION CONTRACTORS ENGINEERS BOARD OF WATER SUPPLY 0+=+-SECONF FLOOR FLAN PLUMBING DETAILS DRAWN BY: SCALE CHECKED. DATE G . IS SHEET APP'D BY: Acc X 80429 CASE 5A DR 15 BID SET GRAPHIC SCALES CHECK BEFORE USE IF SHEET IS LESS THAN 22"x34" IT IS A REDUCED PRINT. SCALE ACCORDINGLY REPURPOSING OF THE KENSICO LABORATORY AS DATE: MAY 2023 THE KENSICO REGIONAL HEADQUARTERS SCALE: MOUNT PLEASANT, NEW YORK SHEET NO: CONTRACT CRO-624 37 OF No. 121 DRAWING NO. **EXISTING PLUMBING PLAN - SECOND FLOOR** DG-111






**NEW YORK CITY ENVIRONMENTAL PROTEC BUREAU OF WATER SUPPLY** 465 COLUMBUS AVENUE, SUITE 270 VALHALLA, NEW YORK 10595-1336

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TION	THE KENSICO REGIONAL HE MOUNT PLEASANT, NE	REPURPOSING OF THE KENSICO LABORATORY AS THE KENSICO REGIONAL HEADQUARTERS MOUNT PLEASANT, NEW YORK CONTRACT CRO-624		
	EXISTING PLUMBING PL/	AN - ATTIC	DRAWING NO. DG-112	




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CONTRACT 432 SHEET 2 SHEETS IN SET, 6 All How And In All ac " F WITH STM. AT 2" PRESS. 10-11 10 RUMBME ANI ON O' ALASSAN A STATE STATE FULL LANGTH ON ALL OF CONNS. TO no denic) SHEET & FOR LEGEND WING IPLAND OTTY & D. 3. As built City of New York BOARD OF WATER SUPPLY KENSICO WATER TESTING LABORATORY MEATING, VENTILATING & STEAM GENERATING EQUIPMENT 6 4 6 8 1 × 80422 FEBRUARY 15, 1954 ACC. THEIP THE CONT. - ... CASE 5A - DR 16 BID SET GRAPHIC SCALES CHECK BEFORE USE IF SHEET IS LESS THAN 22"x34" IT IS A REDUCED PRINT. SCALE ACCORDINGLY DATE: MAY 2023 REPURPOSING OF THE KENSICO LABORATORY AS THE KENSICO REGIONAL HEADQUARTERS SCALE: MOUNT PLEASANT, NEW YORK SHEET NO: CONTRACT CRO-624 39 OF No. 121 DRAWING NO. EXISTING HVAC PLAN - CELLAR DG-113

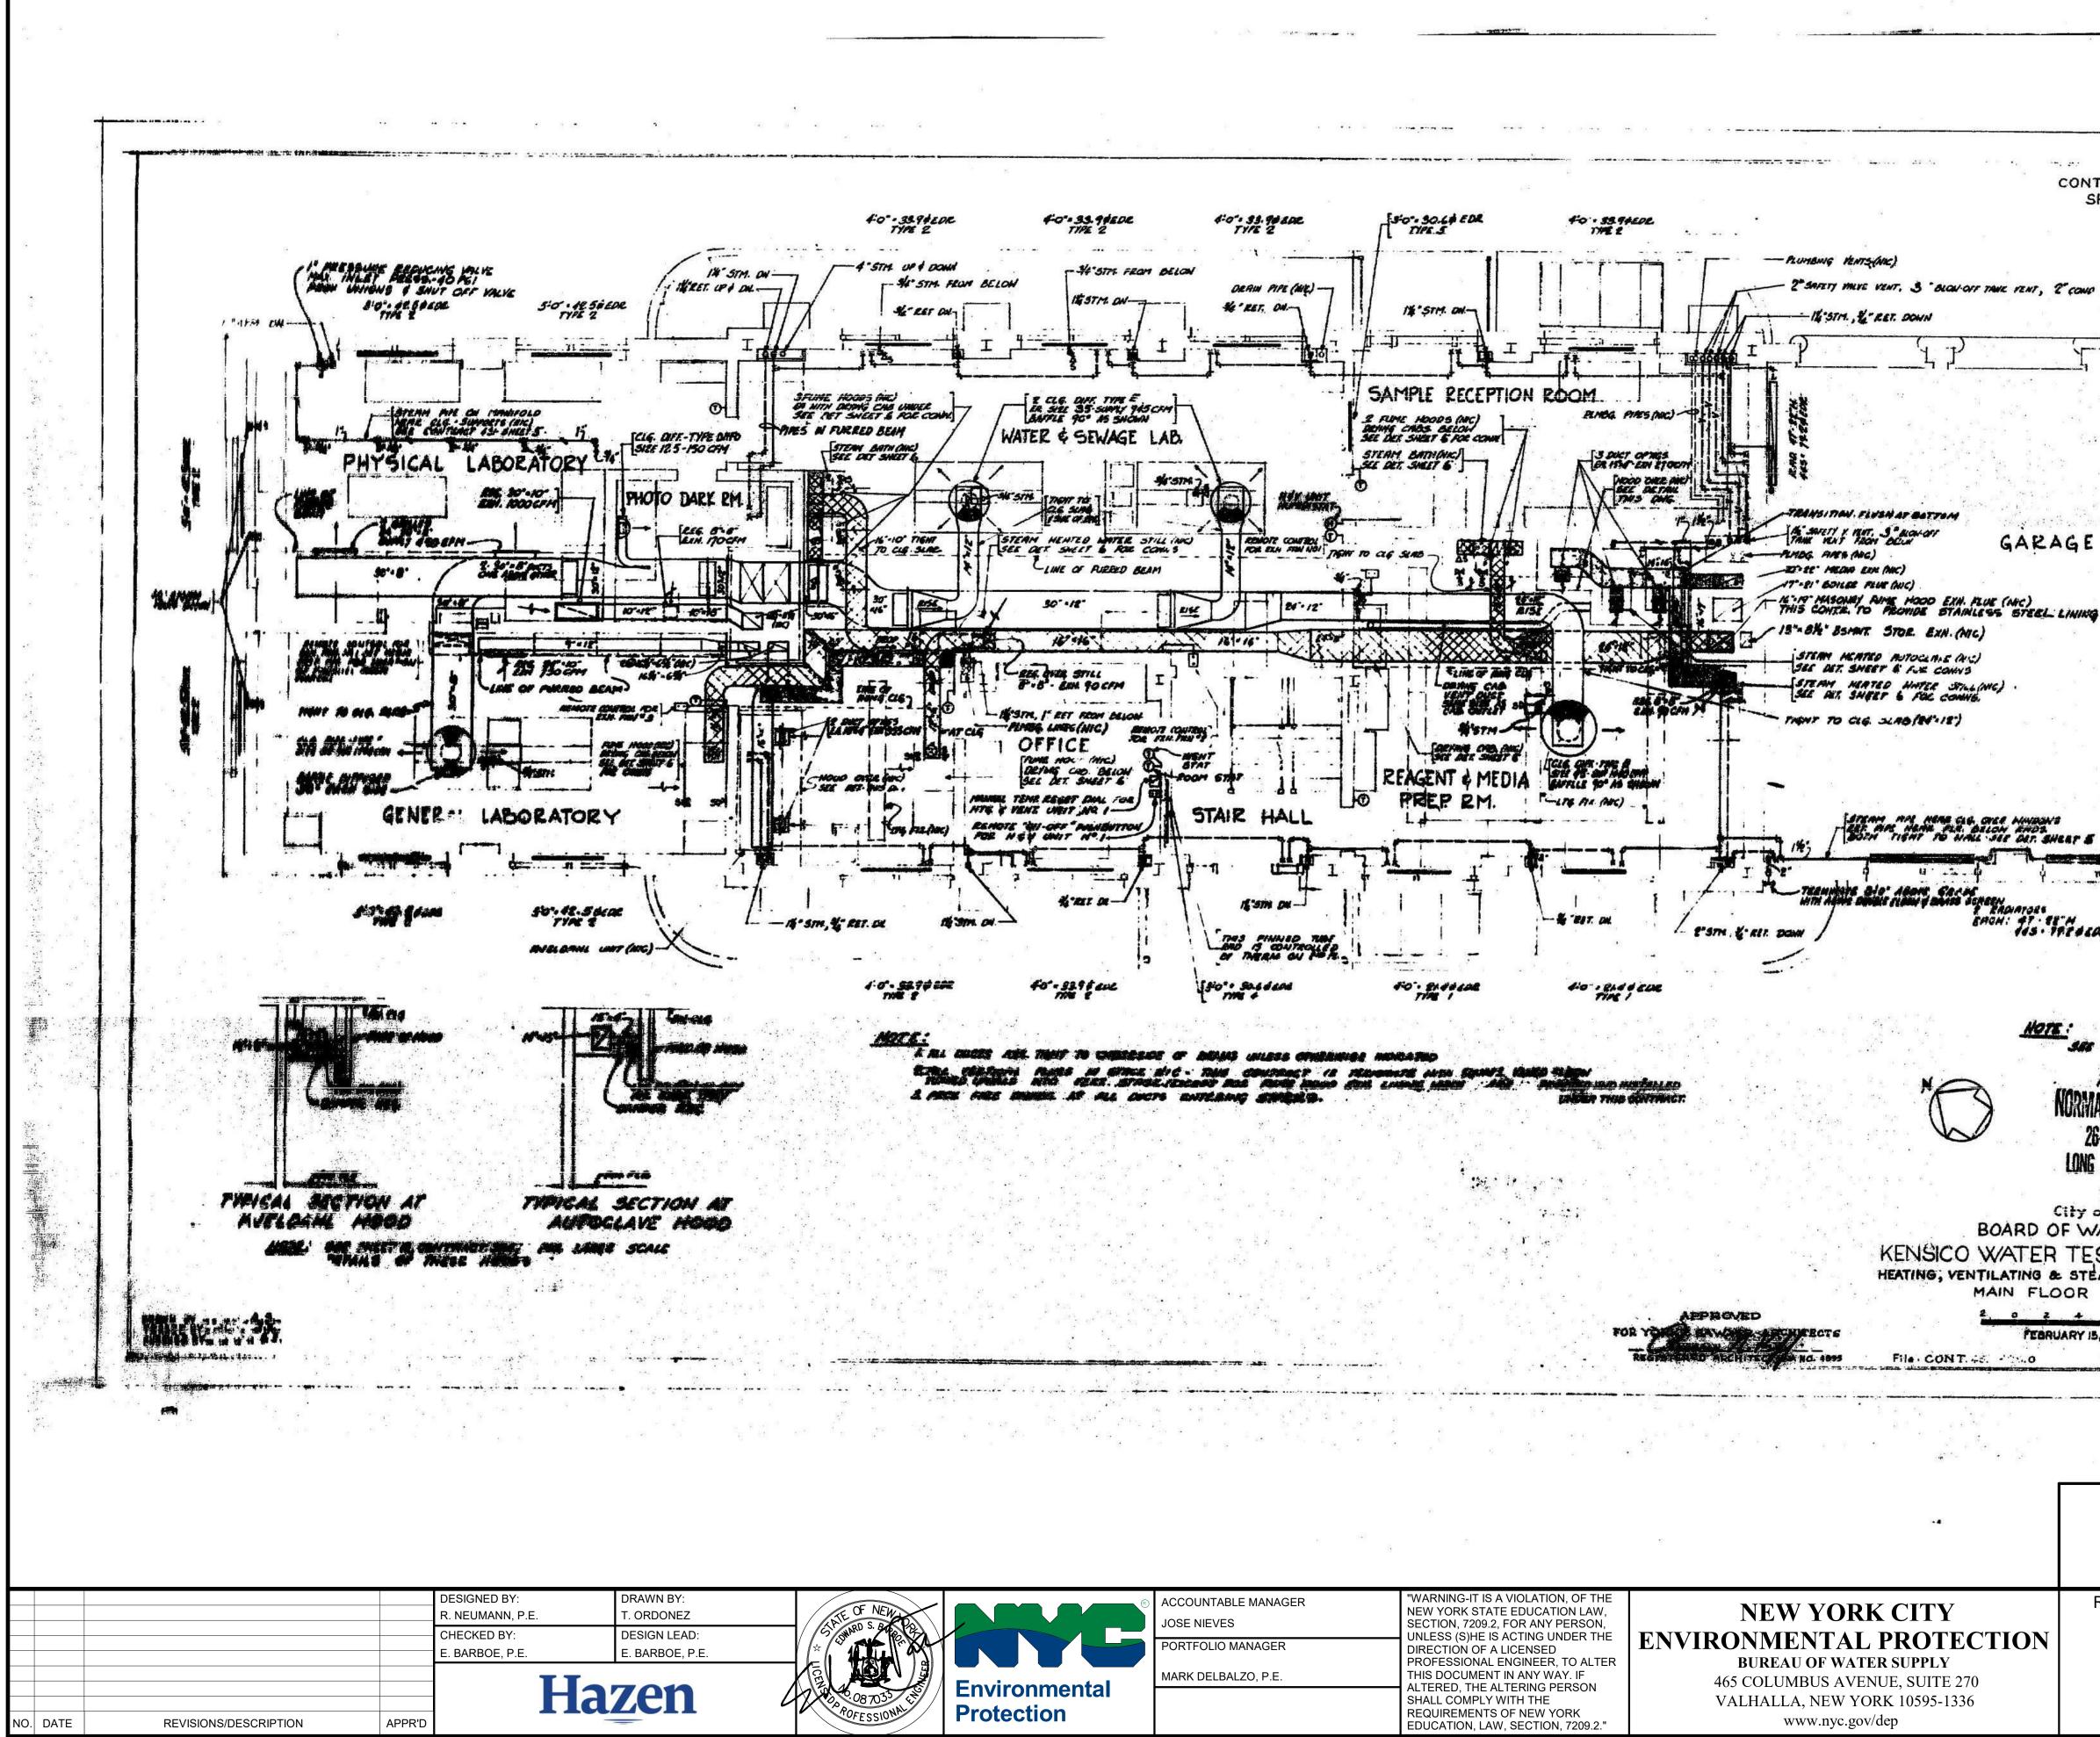

CONTRACT 432 SHEET 3 SHEETS IN SET, 6 MIVE VENT. 3 BLOW OFF THE VENT, 2" COND ROME KENT OP GARAGE MON: 17 . THE A COR SAC SHEET & FOR LEGENO As built NORMAN HEATING CO. INC. 26-16 SKILLMAN AVE. : 🐨 🗧 LONG ISLAND CITY 1, N.Y. City of New York BOARD OF WATER SUPPLY KENSICO WATER TESTING LABORATORY HEATING, VENTILATING & STEAM GENERATING EQUIPMENT 2 0 2 4 6 8 10 FEORUARY 15, 1854 CASE the way was ----BID SET GRAPHIC SCALES CHECK BEFORE USE IF SHEET IS LESS THAN 22"x34" IT IS A REDUCED PRINT. SCALE ACCORDINGLY DATE: MAY 2023 REPURPOSING OF THE KENSICO LABORATORY AS THE KENSICO REGIONAL HEADQUARTERS SCALE: MOUNT PLEASANT, NEW YORK SHEET NO: CONTRACT CRO-624 40 OF No. 121 DRAWING NO. EXISTING HVAC PLAN - FIRST FLOOR DG-114

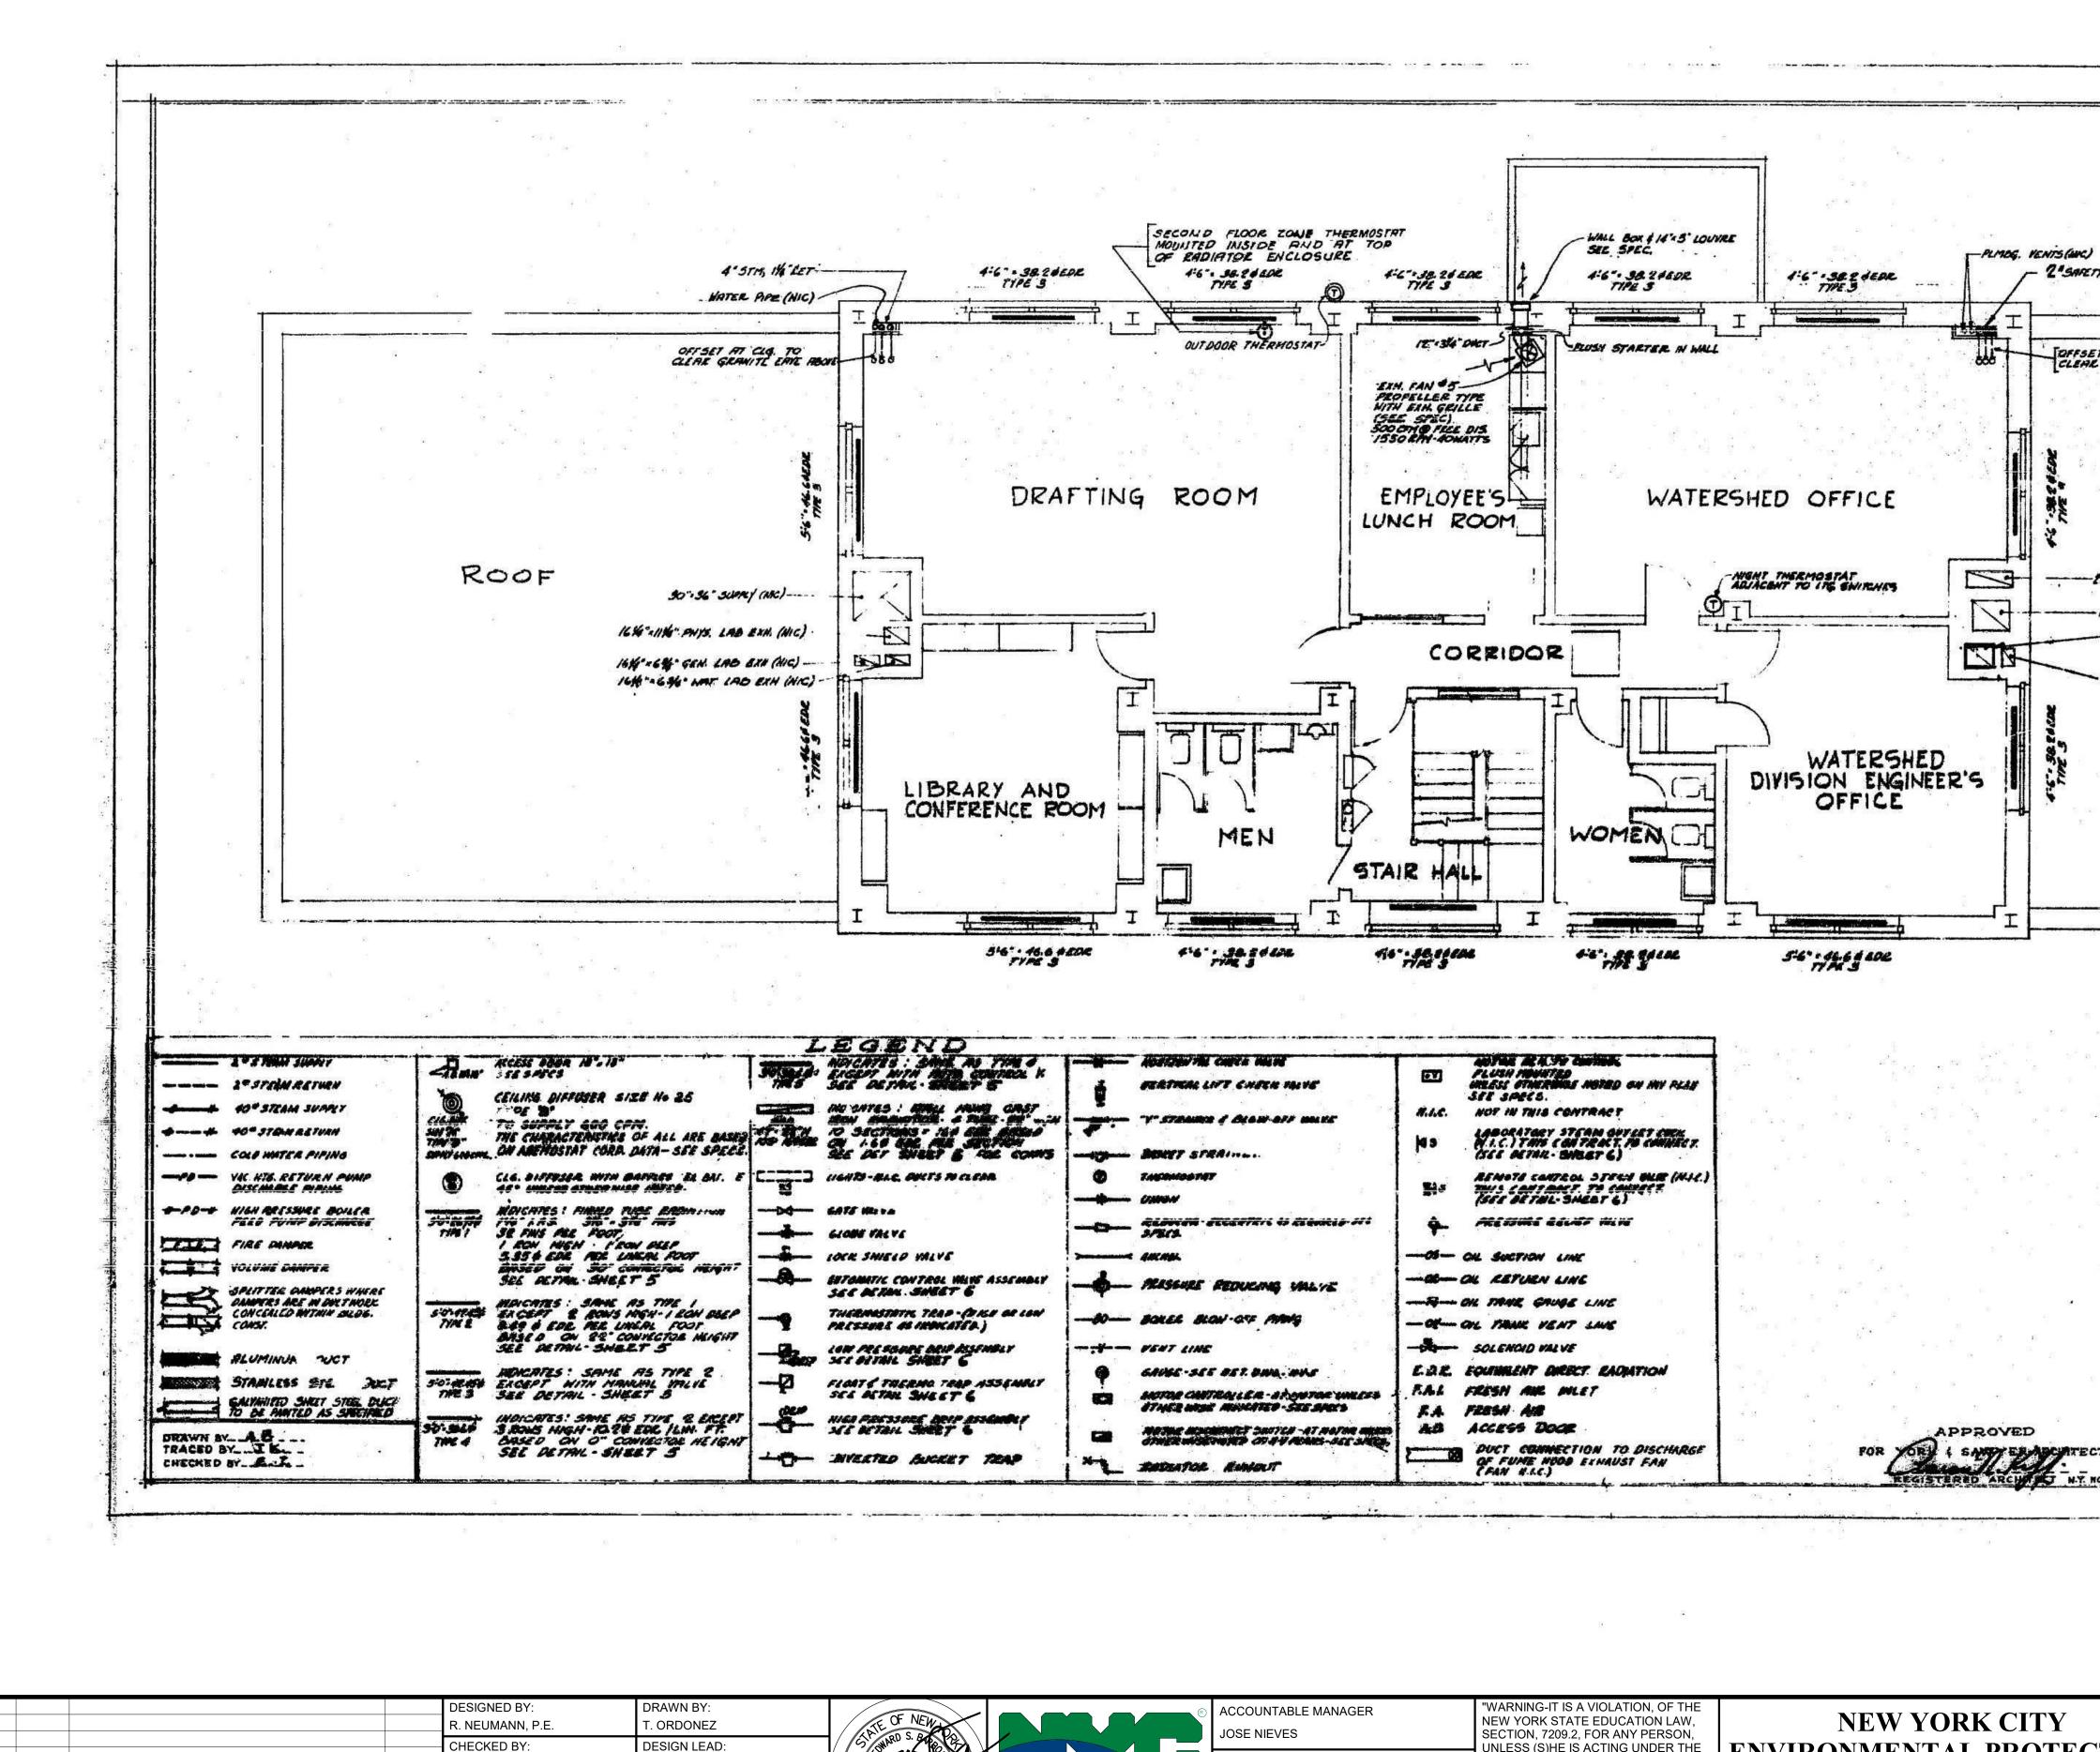

esk Docs://90290-03A\_CAT-423 WO-03A Recon of Kensico Lab/90290-03A\_G\_KLI

 Image: No. Date
 Revisions/description
 APPR'D
 DESIGNED BY: R. NEUMANN, P.E.
 DRAWN BY: T. ORDONEZ

 Image: Design Lead: R. Design Lead: E. BarBoe, P.E.
 Design Lead: E. BarBoe, P.E.
 Design Lead: E. BarBoe, P.E.


<sup>3</sup> All inquiries regarding this drawing(s) or project should be made to NYC Environmental Protection, Bureau of Water Supply.




ACCOUNTABLE MANAGER JOSE NIEVES PORTFOLIO MANAGER MARK DELBALZO, P.E. "WARNING-IT IS A VIOLATION, OF THE NEW YORK STATE EDUCATION LAW, SECTION, 7209.2, FOR ANY PERSON, UNLESS (S)HE IS ACTING UNDER THE DIRECTION OF A LICENSED PROFESSIONAL ENGINEER, TO ALTER THIS DOCUMENT IN ANY WAY. IF ALTERED, THE ALTERING PERSON SHALL COMPLY WITH THE REQUIREMENTS OF NEW YORK EDUCATION, LAW, SECTION, 7209.2."

NEW YORK CITY ENVIRONMENTAL PROTEC BUREAU OF WATER SUPPLY 465 COLUMBUS AVENUE, SUITE 270 VALHALLA, NEW YORK 10595-1336 www.nyc.gov/dep

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CONTRACT 432 SHEET 4 SHEETS IN SET, 6	
** · ·	
THEYE TENT, S" DLOWOFF TANK VENT, 2" COND REVE VENT	
GEANITE FRIE REONE	
** 10" MEDIA EXH (NIC) 1 + 21" DOILER FLUE (NIC) 9 ** 16" FUME HODO EXH. (NIC). THIS CONTRACT PROMORE STAINLESS STEEL LIMING 3* ABYE * LAB STORE RM. EXH. (NIC)	
	ē
	*3
NA As built	
PUKMAN HEATING CO. INC.	3
26-16 SKILLMAN AVE. Long Island City 1, N, Y,	
City of New Jork BOARD OF WATER SUPPLY	
HEATING, VENTILATING & STEAM GENERATING FOUIPMENT	
SECOND FLOOR PLAN	
5 FEBRUARY 15, 1984 X80422-	
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	NGLY TE: MAY 2023
THE KENSICO REGIONAL HEADQUARTERS	ALE: EET NO:
CONTRACT CRO-624	41 OF No. 121
EXISTING HVAC PLAN - SECOND ELOOR	awing no. DG-115
	JG-115

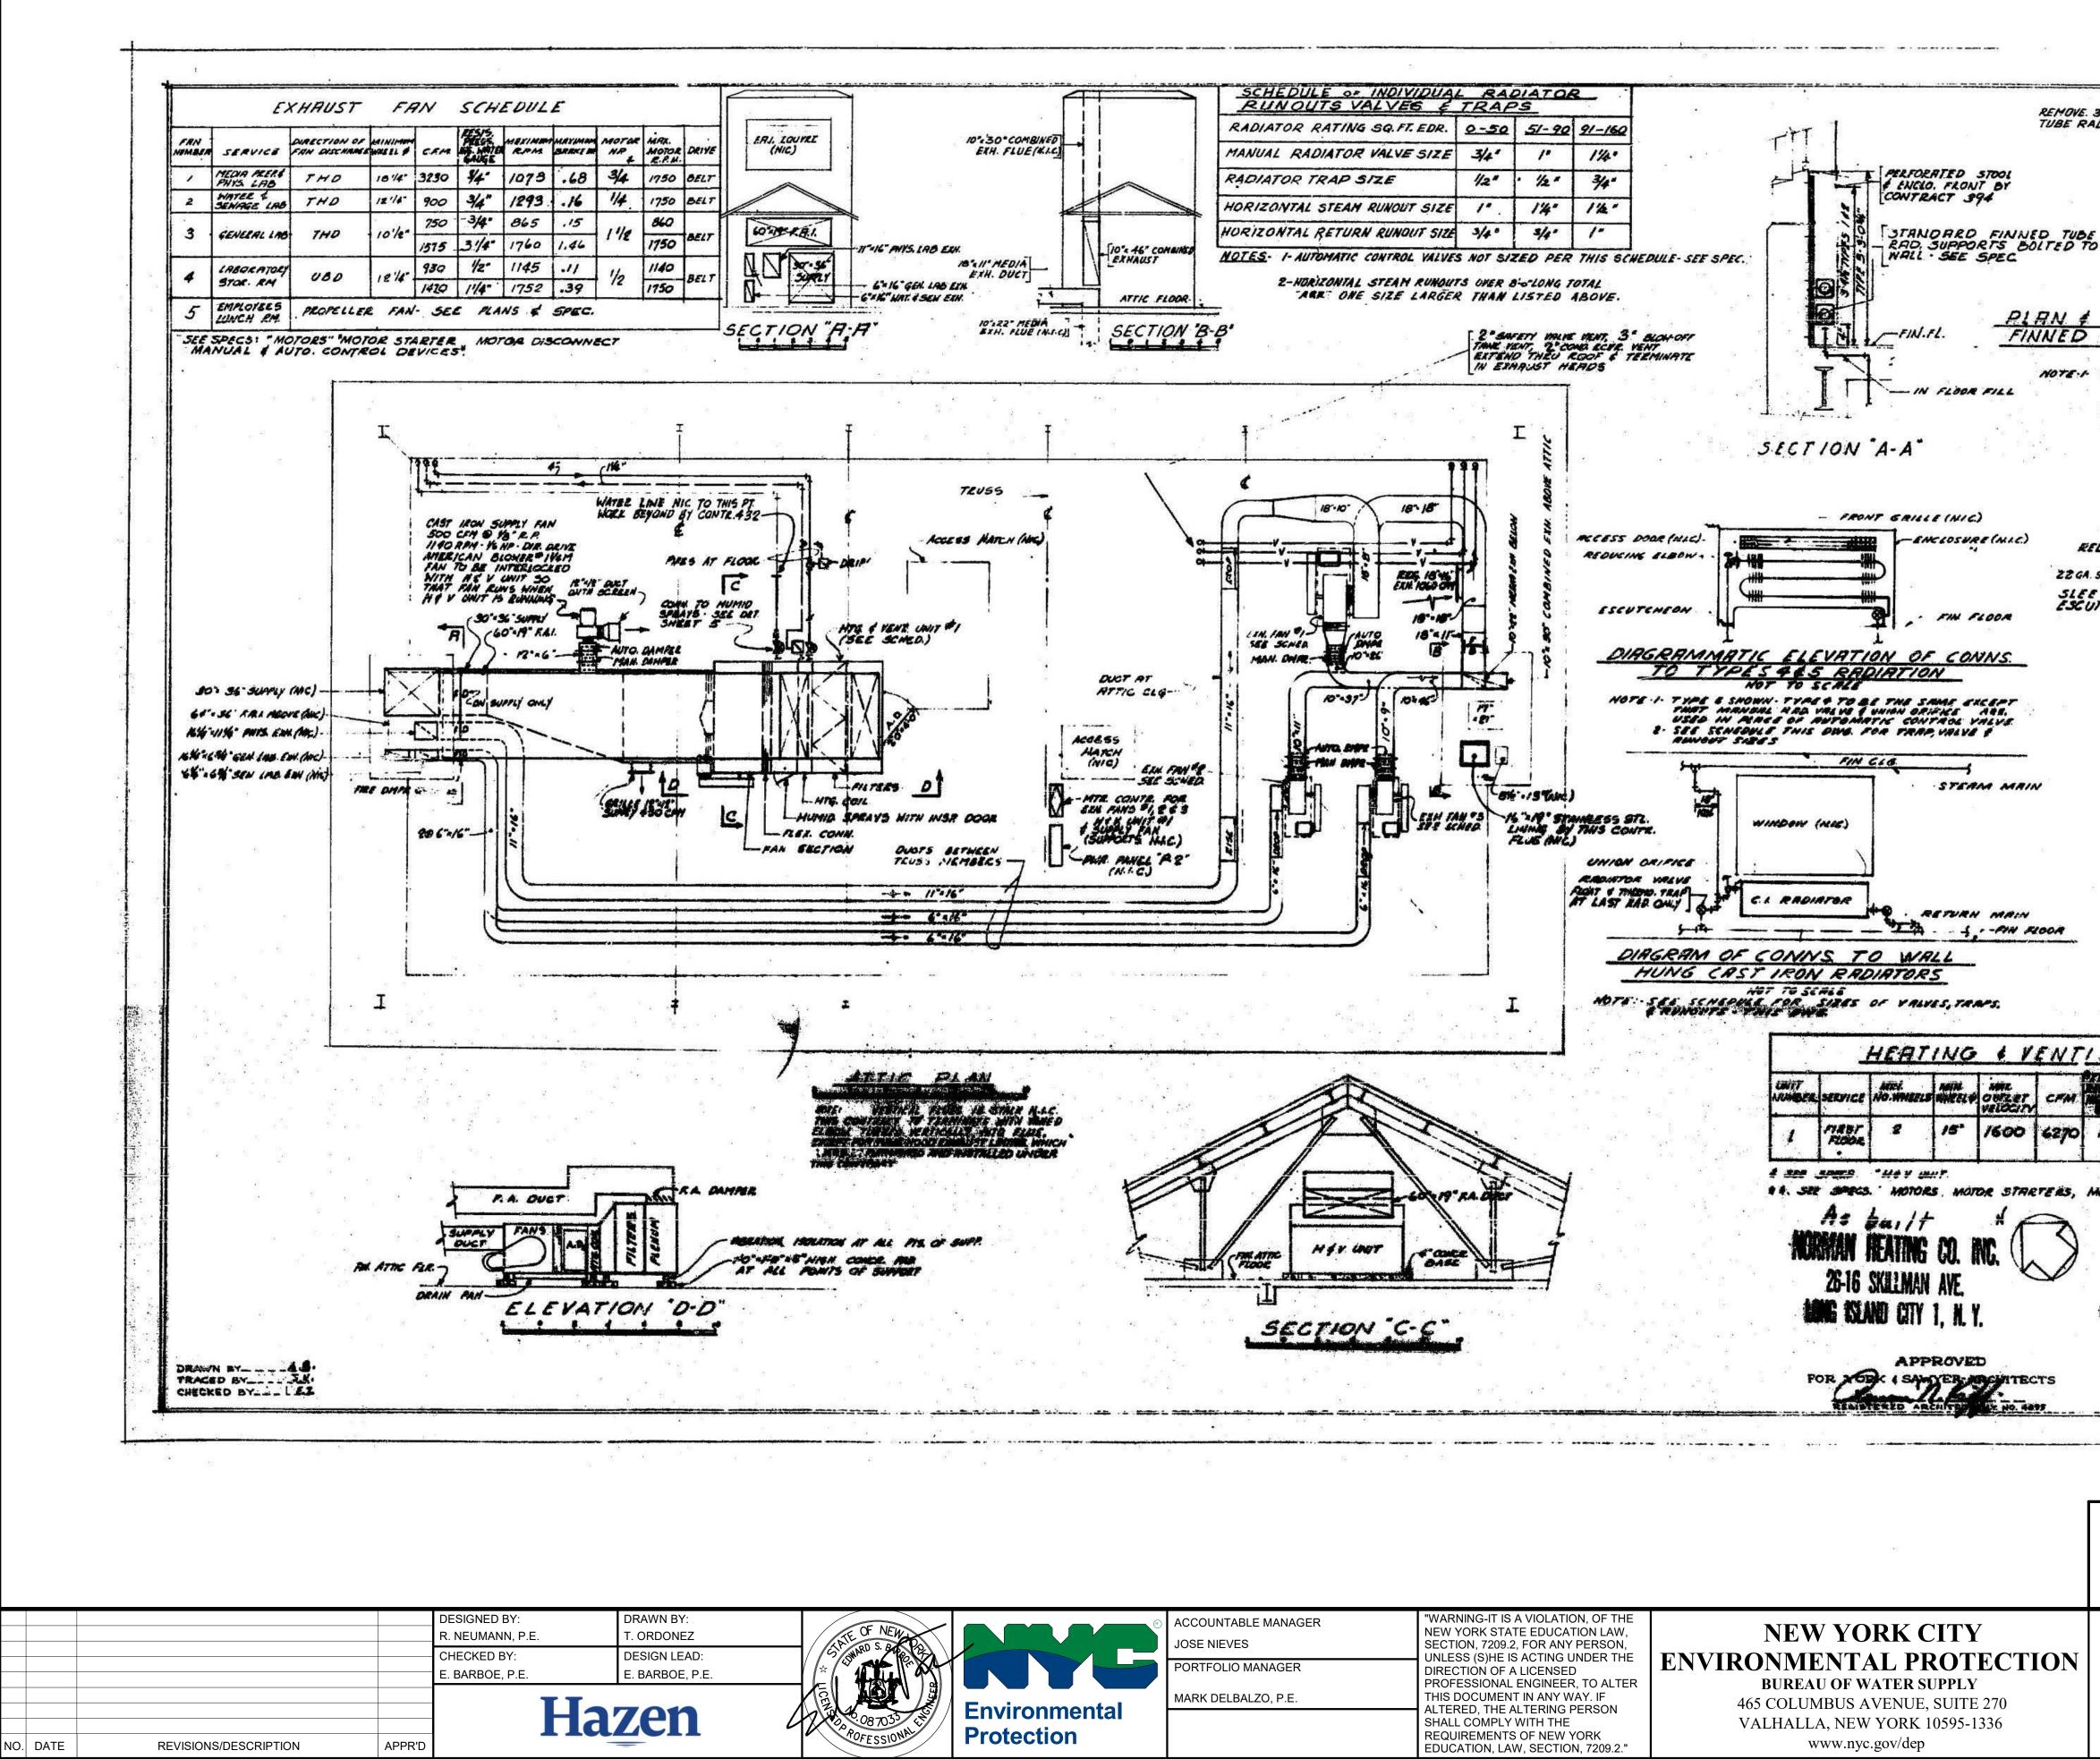

CONTRACT 432 SHEET 5 REMOVE. 3 FINS FROM FINNED TUBE RAD. & POINTS OF SUPPORT SHEETS IN SET,6 0 12 GA. SHEET METAL LINERA SEE ELEVATION - THIS DWG. A PLAN PLAN & SECTION SHOWING SUPPORTS FOR FINNED TUBE RAD. CONVECTORS TYPES I THRU 5 1 1 4 4 NOTE I TYPE 1,2,83 SNOWN - TYPES 645 TO BE THE SAME EXCEPT THAT ASBESTOS MILLBOARD 113 - OMITTED, ENCLOSURE WILL BE 3'-O" MARN WITH PERFORMTED FRONT IN LIEU OF STOOL(ALL MIC), & RUNOUTS SMILL BE DURECTEY FROM BELOW ACCESS TO RUTO. CONT. VALVE THRU NINGED STOOL N.I.C. JOP OF AUTO CONT VALVE 12 BELOW STOOL REDUCING ELDON-ENCLOSONE (NIS) ZZ GA. SHEET METAL BAFFLE--22 GA. SWEET METAL BAFFLE ESCUTCHEON --REDUCING ECOOM -... - RADIATOR TRAP ELEVATION SHOWING DIAGRAMMATIC CONNS. FOR TYPES I & SCALE REPROK ANTO NOTE I TYPE & SHOWN -CONNS. FOR TYPE I 'IS THE SAME BUT ONLY I NOW NIEN E-SEE SCHEDULE FOR TRAP & NOWOUT SIZES - THIS DWG. STOOL (NIC) RAD VALVE ENCLOSLIKE (NIC) -UNION ORIFICE -SIEEVE & ESCUTCHEON RAD. TRAP FIN. FL. ELEVATION SHOWING DIAGRAMMATIC CONNISCTIONS FOR TYPE 3 NOTE --- SEE SCHEDULE FOR TEAP & RUNOUT SIEES ME HEATING & VENTILATING UNIT SCHEDULE MAL. MAR MOTOR FILTERS HEATING COL HUMANTS NO CELLS (NON FREEZE) DRIVE SASAYS DELT 8-24-24" IL "TREE AREA TO 6270CAN HEAT 6290CAM AND 0-107 F 6270 1% 856 2.63 3 14. SET SPECS. MOTORS, MOTOR STRETERS, MOTOR DISCONNECT, MANUAL & AUTO. CONTROL DEVICES City of New York BOARD OF WATER SUPPLY KENSICO WATER TESTING LABORATORY HEATING, VENTILATING & STEAM GENERATING EQUIPMENT FEBRUARY 15, 1954 File: CONT. ---- 213 CASE 22-2 BID SET GRAPHIC SCALES CHECK BEFORE USE IF SHEET IS LESS THAN 22"x34" IT IS A REDUCED PRINT. SCALE ACCORDINGLY DATE: MAY 2023 REPURPOSING OF THE KENSICO LABORATORY AS THE KENSICO REGIONAL HEADQUARTERS SCALE: MOUNT PLEASANT, NEW YORK SHEET NO: CONTRACT CRO-624 42 OF No. 121 DRAWING NO. **EXISTING HVAC PLAN - ATTIC** DG-116

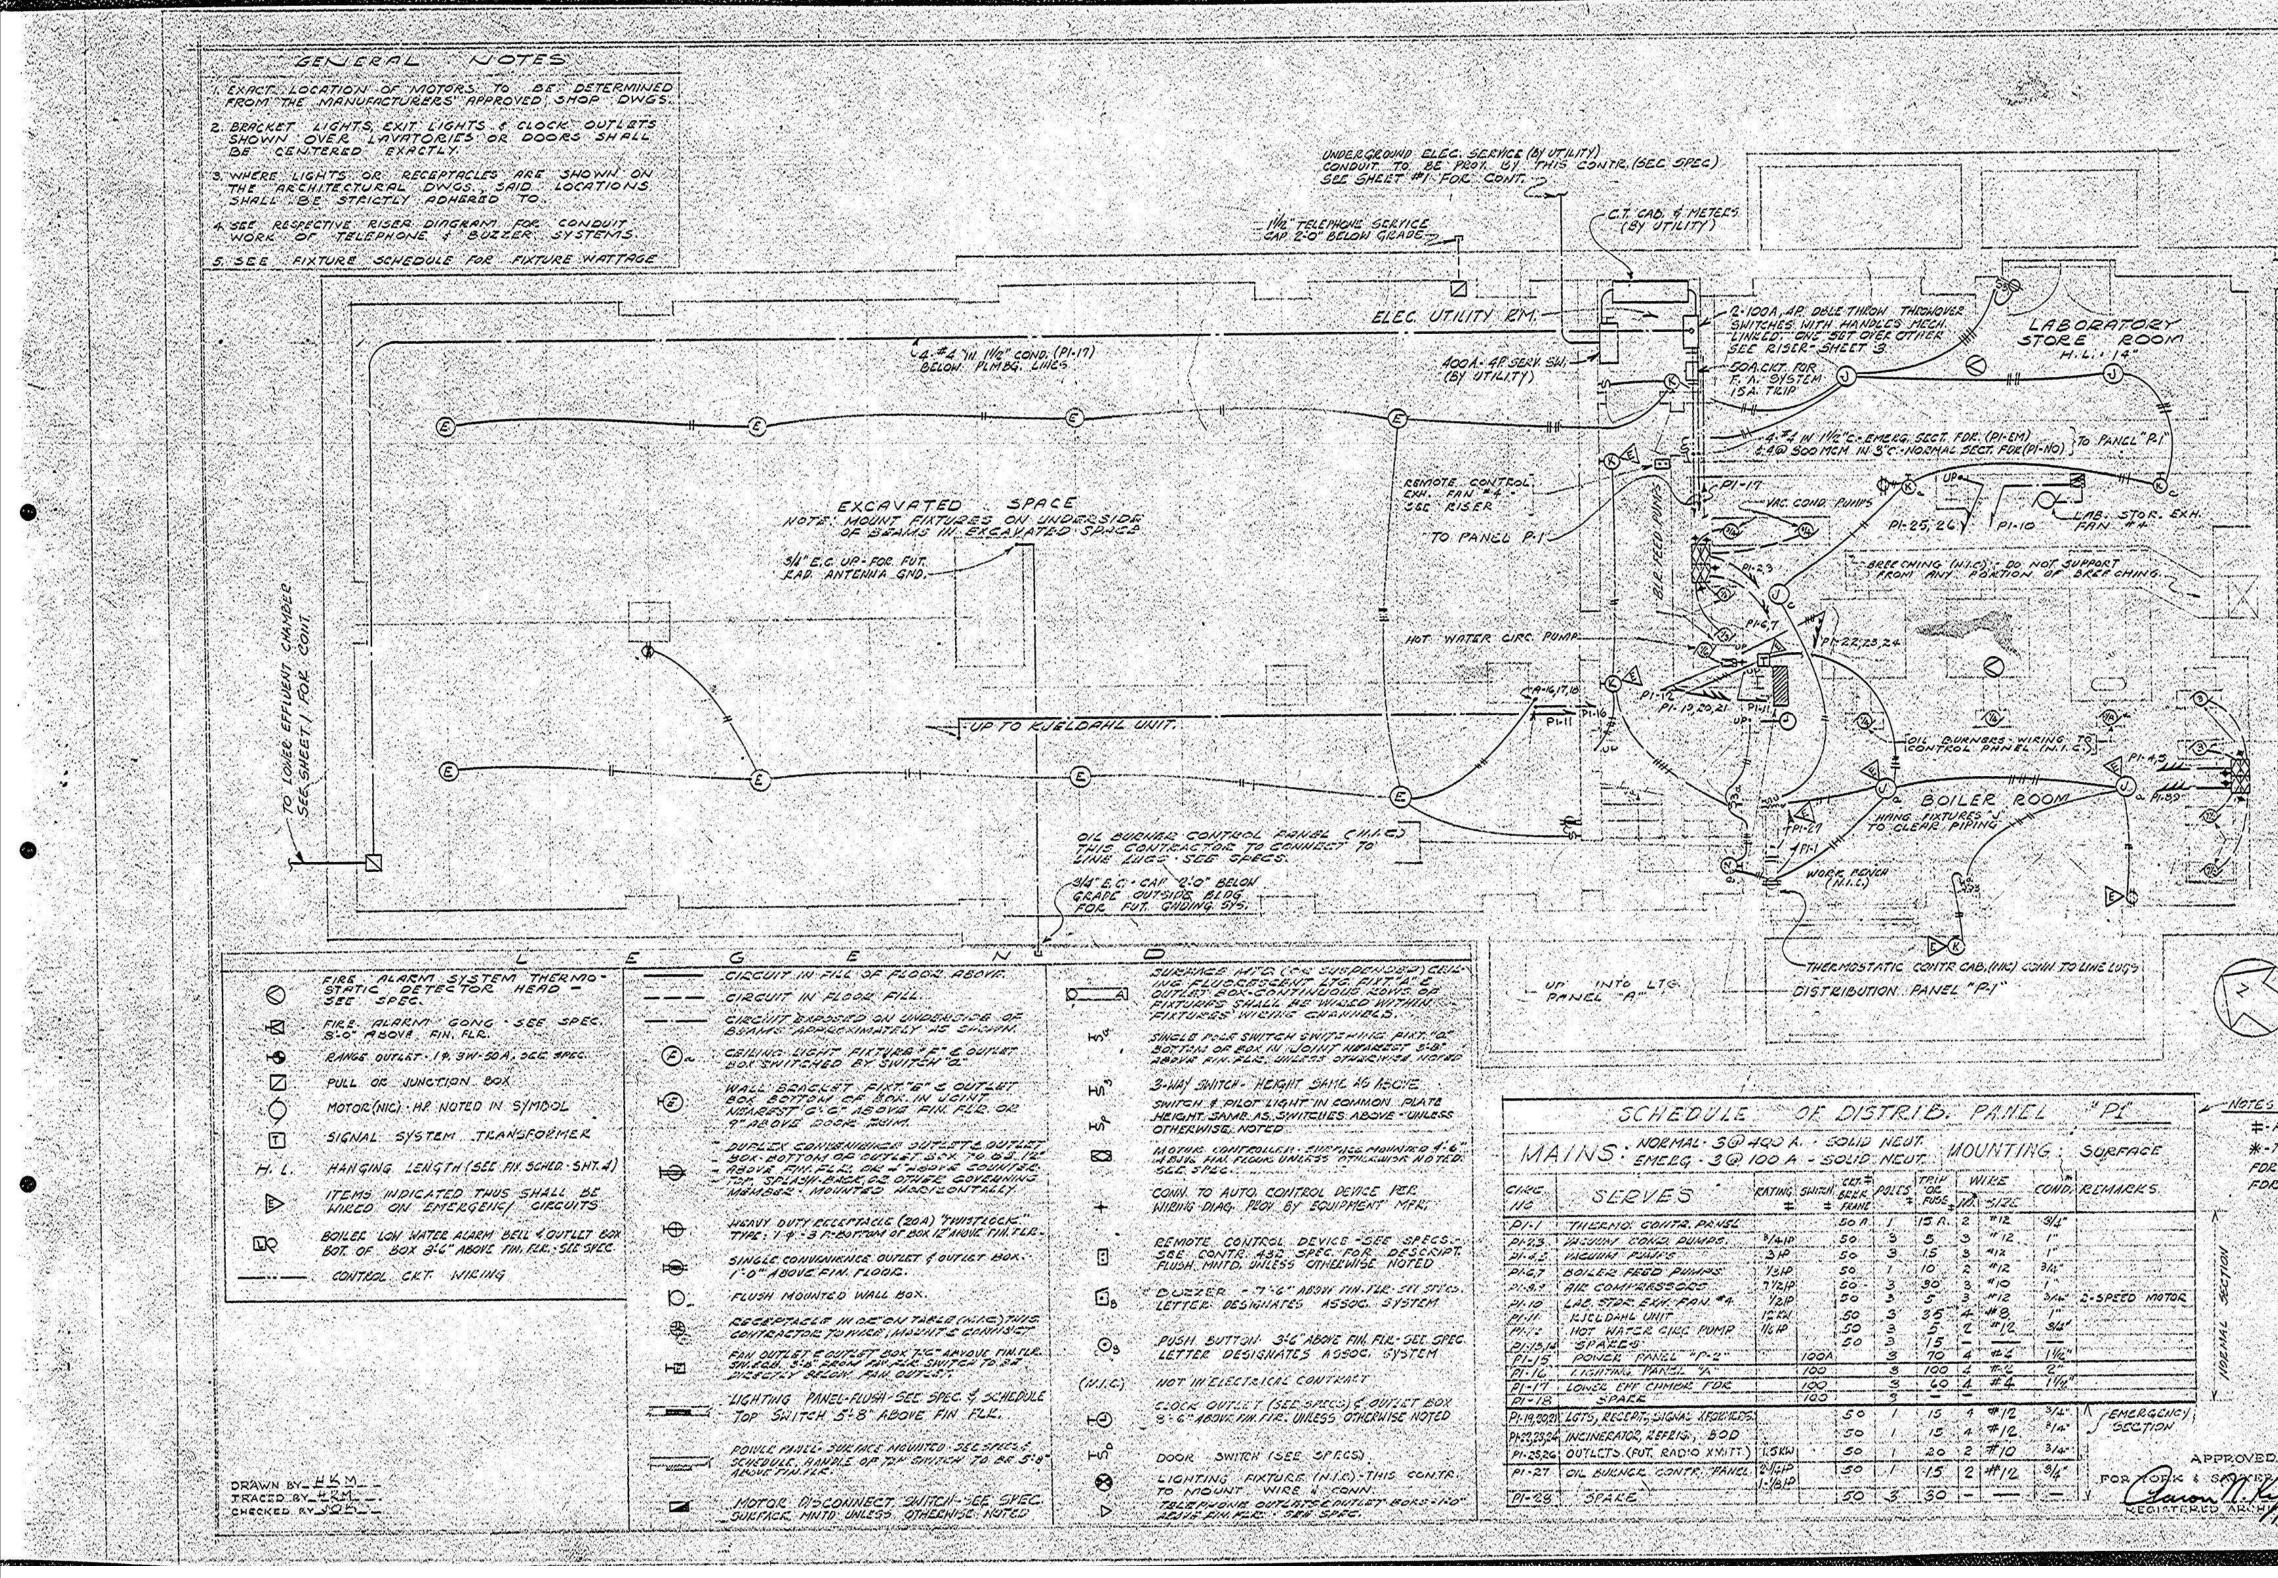



2023 9:16:01 AM	). DATE	REVISIONS/DESCRIPTION	APPR'D	Η	azen	FOR TO STATES
				CHECKED BY: E. BARBOE, P.E.	DESIGN LEAD: E. BARBOE, P.E.	
				DESIGNED BY: R. NEUMANN, P.E.	DRAWN BY: T. ORDONEZ	STE OF NEW




ACCOUNTABLE MANAGER
JOSE NIEVES
PORTFOLIO MANAGER
MARK DELBALZO, P.E.

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NEW YORK CITY ENVIRONMENTAL PROTECTION BUREAU OF WATER SUPPLY 465 COLUMBUS AVENUE, SUITE 270 VALHALLA, NEW YORK 10595-1336 www.nyc.gov/dep

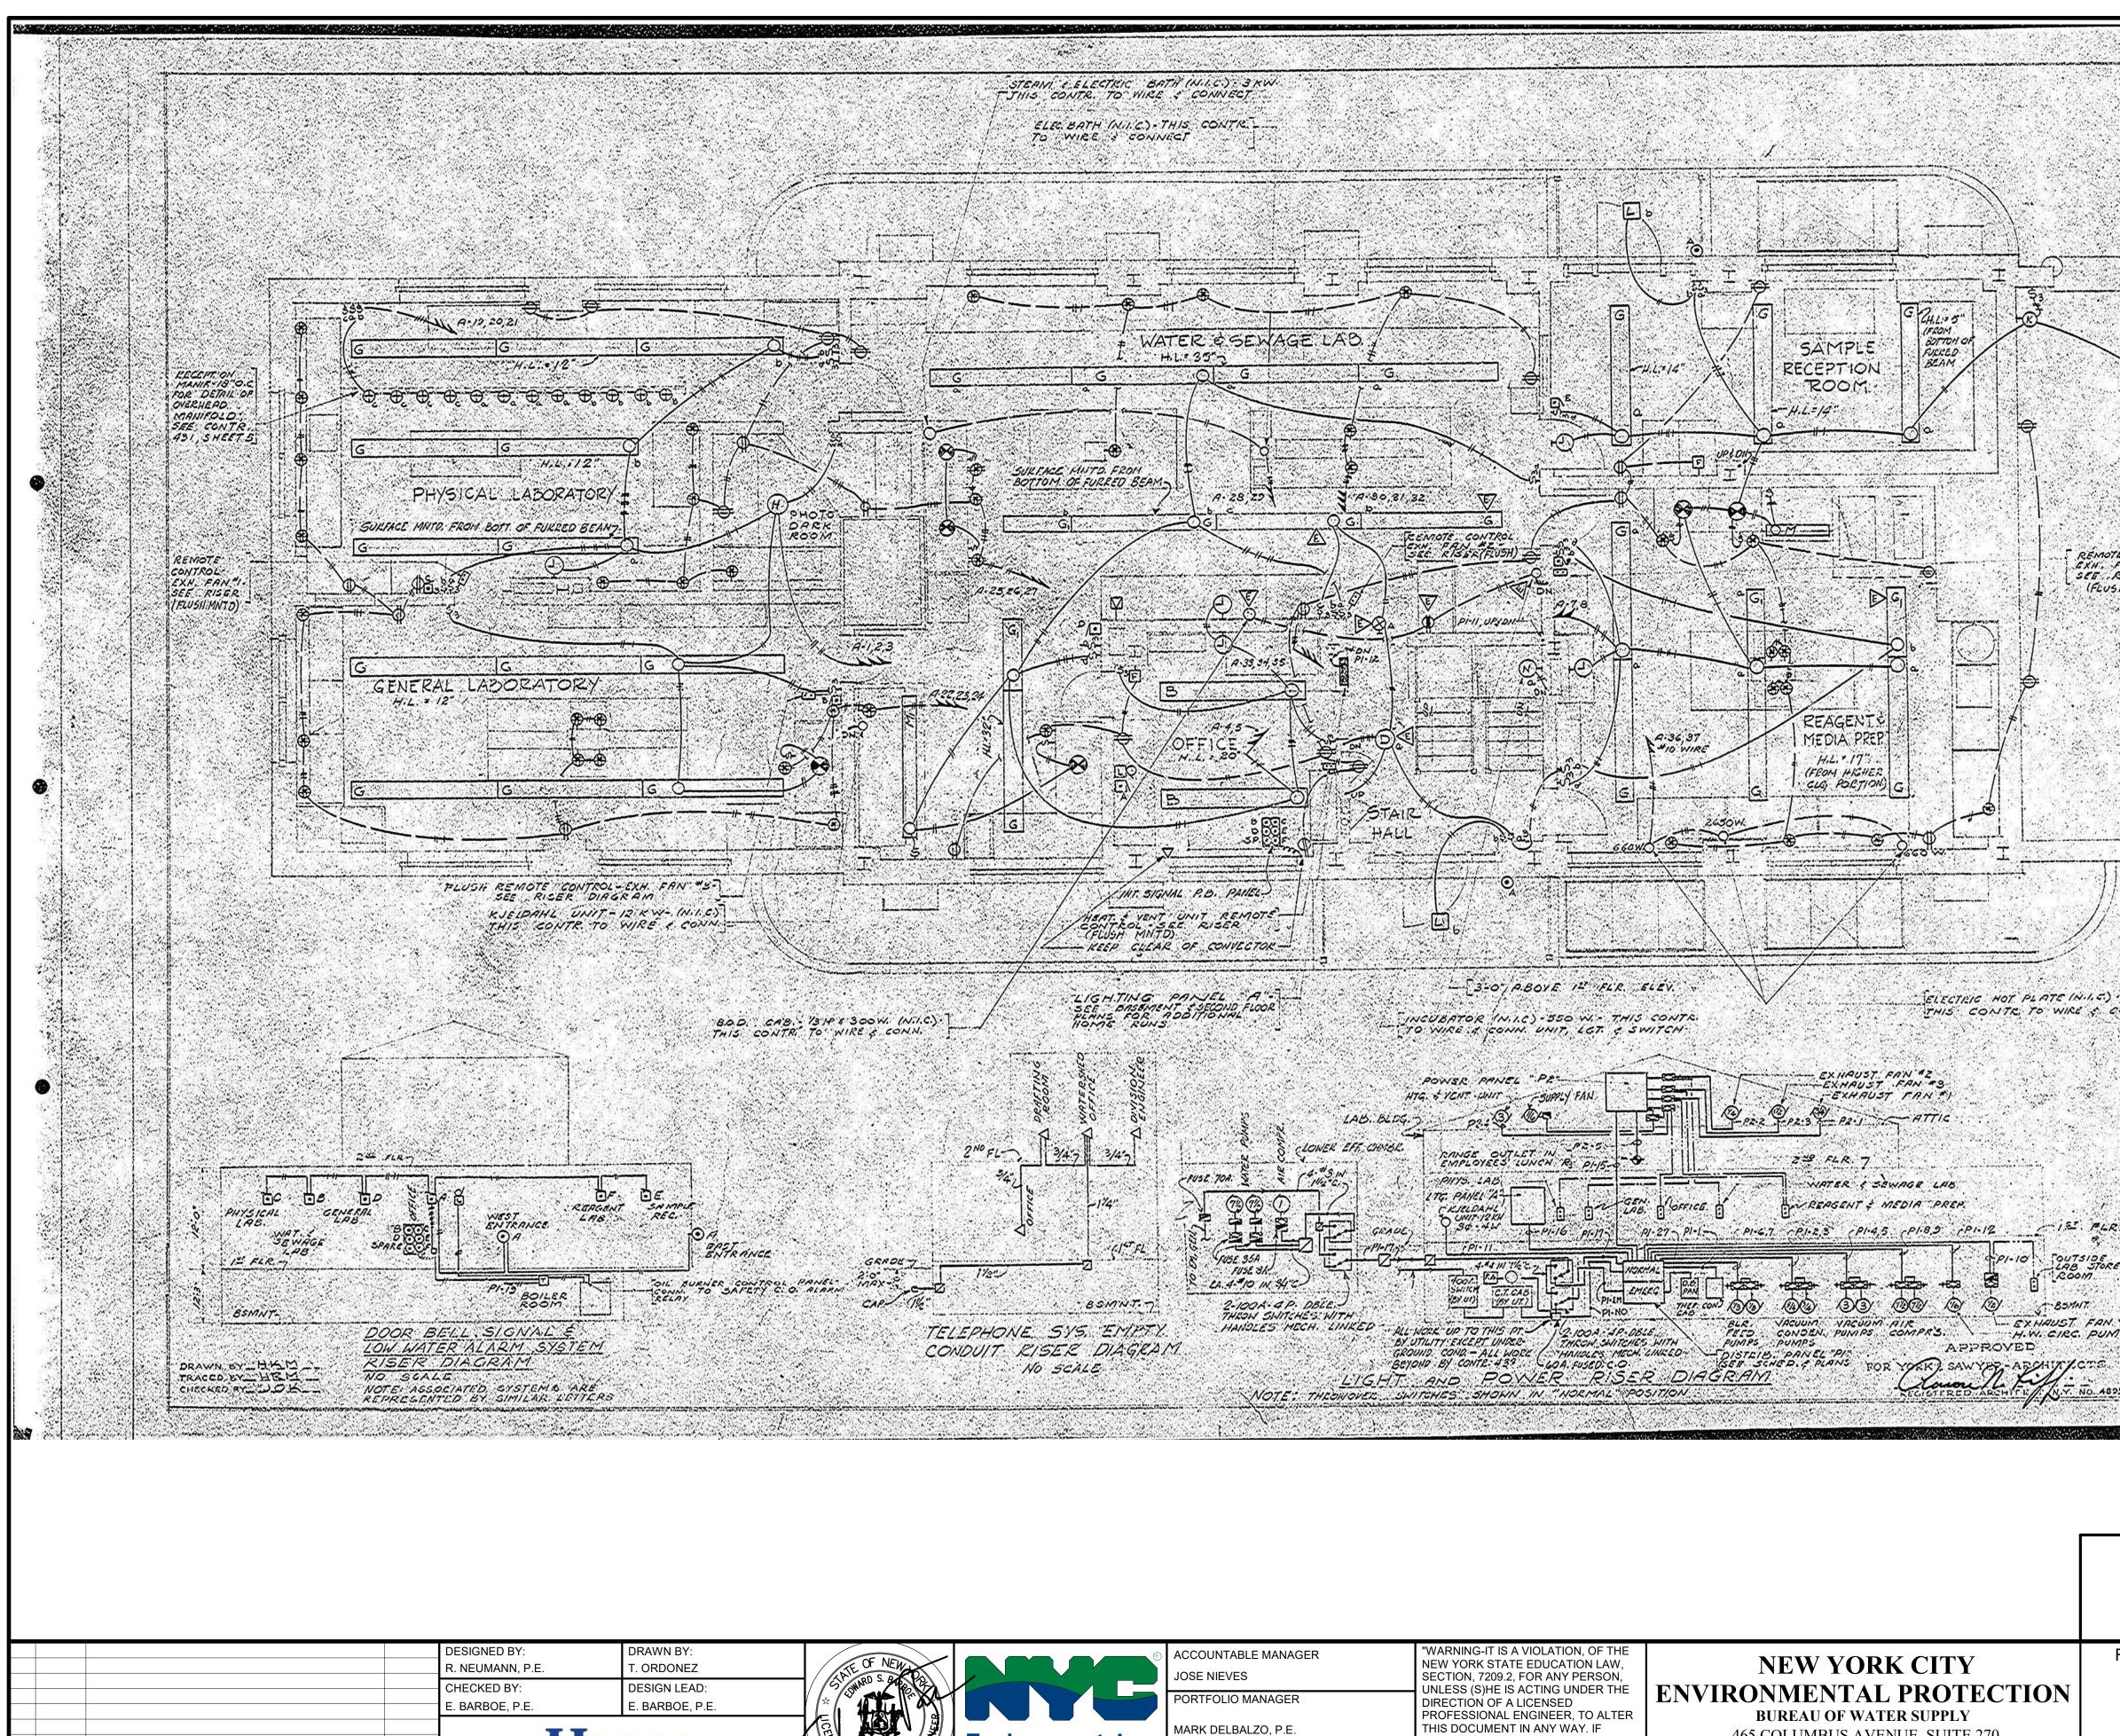CONTRACT 433 SHEET 2 SHEE TS IN SET . 4 1.182.44 Sec. 19 UN EXCAVATED -AIR COMPRESSOR NOTES FOR PANEL SCHEDULS +- FOR EACH CIRCUIT \*-TOTAL FOR ALL SKTS FDR. PI-NO : 4@ 300 MCM IN S"C. FOR PI-EM: 4- 4 4. IN 1/2" C. City of New York BOARD OF WATER SUPPLY KENSICO WATER TESTING LABORATORY ELECTRICAL EQUIPMENT AND APPURTENANCES. BASEMENT. FLOOR PLAN 0 2 4 0 NA FOR TOPK & SATURE ATTAINTECTS Acc: 71625 File, CONT. 435-28.0. BID SET GRAPHIC SCALES CHECK BEFORE USE IF SHEET IS LESS THAN 22"x34" IT IS A REDUCED PRINT. SCALE ACCORDINGLY REPURPOSING OF THE KENSICO LABORATORY AS DATE: MAY 2023 THE KENSICO REGIONAL HEADQUARTERS SCALE: MOUNT PLEASANT, NEW YORK SHEET NO: CONTRACT CRO-624 43 OF No. 121 DRAWING NO. EXISTING ELECTRICAL PLAN - CELLAR DG-117



NO. DATE

<sup>6</sup> All inquiries regarding this drawing(s) or project should be made to NYC Environmental Protection, Bureau of Water Supply.

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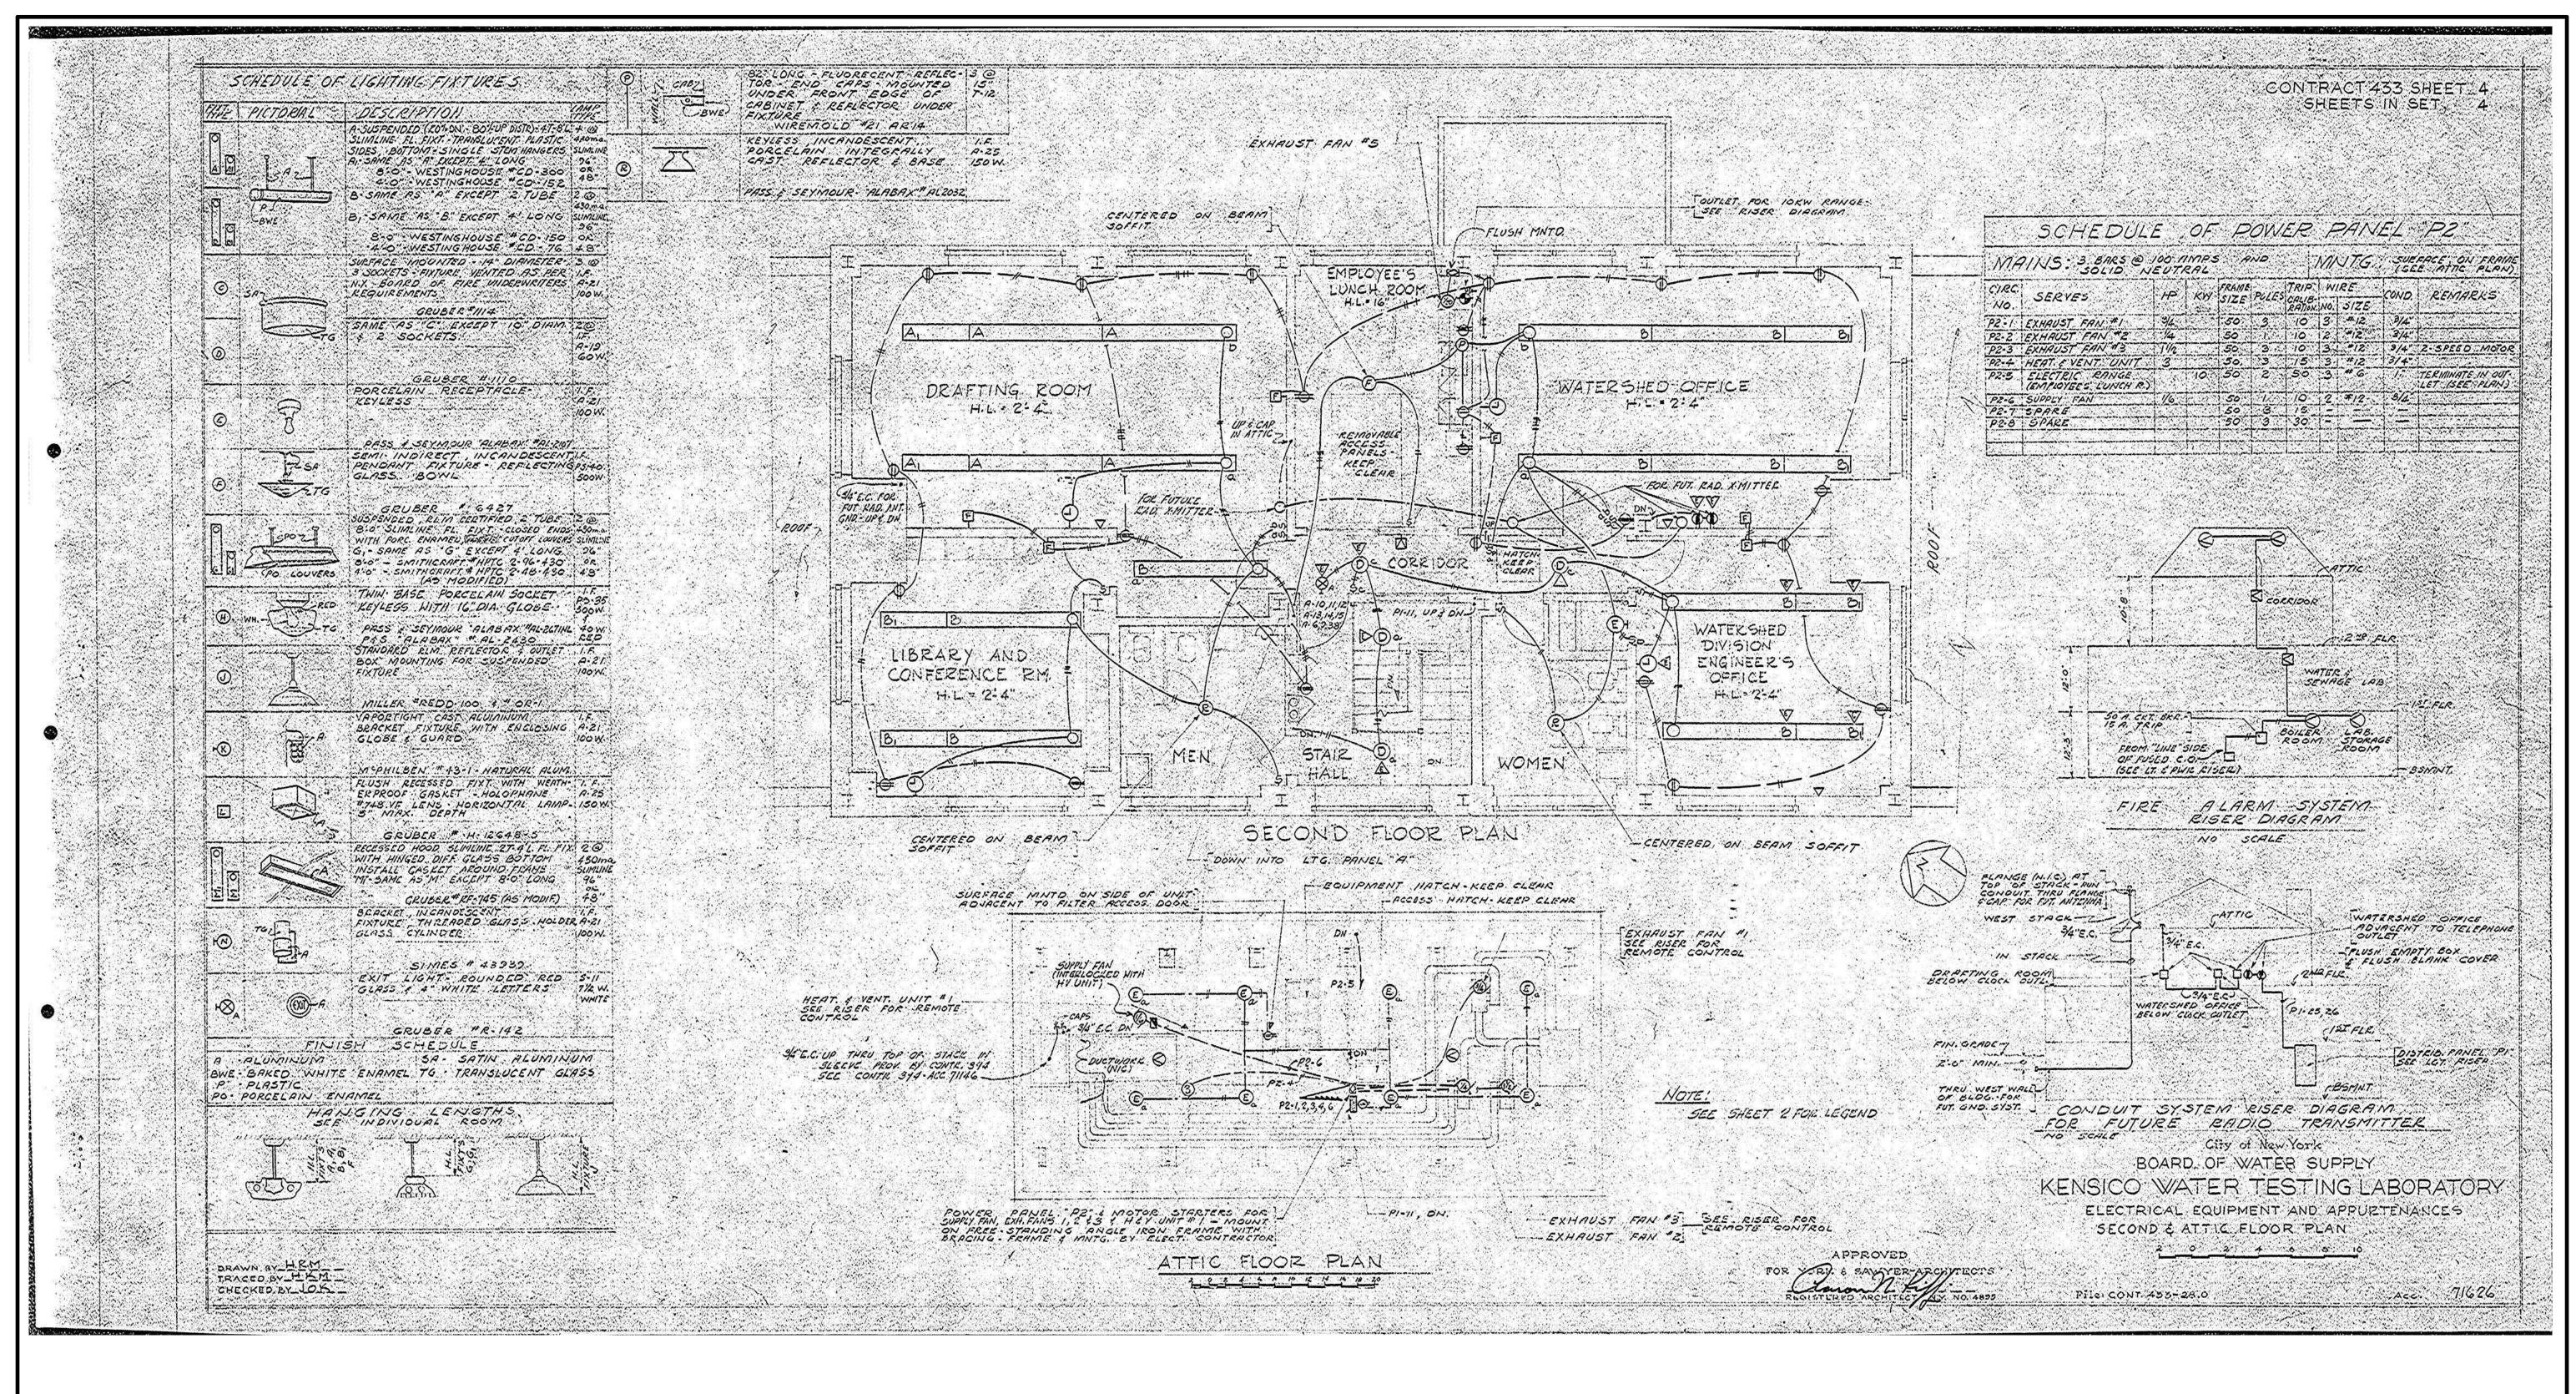


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CONTRACT 433 SHEET 3 SHEETS IN SET. 1. Comp GARAGE MOUNT LTG. FIXTURES ON UNDERSIDE OF BEAMS REMOTE CONTROL EXH. FAN \*1 SEE RISER Test (FLUSH MNTD) SCHEDULE OF LIGHTING PANELS PANEL MOUNTING NO. OF. CIRCUITS CKT. BKR. TRIP CALIBRE REMARKS A FLUSH 42 38 4. 19,20,21 25A 30A A FLUSH 42 38 4. 19,20,21 28,29,37 A ALL OTHER TRIP CALIBRATIONS SHALL BE IS ANIPERES I. CIRCUIT BREAKER FRAME SIZES SHALL BE 50 AMP. RATED. 2. PANEL SHALL HAVE 3 WIRE MAINS & SOLID NEUTRAL. ELECTRIC HOT PLATE (N.I.C.) THIS CONTR. TO WIRE & CONN. NOTE. SEE SHEET 12 FOR, LEGEND City of New York 1 BOARD OF WATER SUPPLY LAB STORE KENSICO WATER TESTING LABORATOR ELECTRICAL EQUIPMENT AND APPORTENANCES BOMNT. MAIN FLOOR PLAN EXHAUST FAN. "4. H.W. CIRC. PUMP Acc. 71621 File CONT. 433-28.0 N.Y. NO. 4895 BID SET GRAPHIC SCALES CHECK BEFORE USE IF SHEET IS LESS THAN 22"x34" IT IS A REDUCED PRINT. SCALE ACCORDINGLY DATE: MAY 2023 REPURPOSING OF THE KENSICO LABORATORY AS THE KENSICO REGIONAL HEADQUARTERS SCALE: MOUNT PLEASANT, NEW YORK SHEET NO: CONTRACT CRO-624 44 OF No. 121 DRAWING NO.



odesk Docs://90290-03A\_CAT-423 WO-03A Recon of Kensico Lab/90290-03A\_G\_KLB

2023 9:16:01 AN	D. DATE	REVISIONS/DESCRIPTION	APPR'D	H	lazen	POFESSIONAL
≥				E. BARBOE, P.E.	E. BARBOE, P.E.	
				CHECKED BY:	DESIGN LEAD:	ST SWARD S. G. P. S.
				DESIGNED BY: R. NEUMANN, P.E.	DRAWN BY: T. ORDONEZ	THE OF NEW

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	BID SET	GRAPHIC SCALES CHECK BEFORE USE		
		IF SHEET IS LESS IT IS A REDUC SCALE ACCO	ED PRINT.	
	REPURPOSING OF THE KENSICC	DATE: MAY 2023		
	THE KENSICO REGIONAL HE	SCALE:		
TION	MOUNT PLEASANT, NEW YORK CONTRACT CRO-624 EXISTING ELECTRICAL PLAN - SECOND FLOOR AND		SHEET NO:	
			45 OF No. 121	
			DRAWING NO.	
	ATTIC		DG-119	

-1	THESE NOTES ARE GENERAL AND SUPPLEME OR NOTED OTHERWISE IN THE CONTRACT DO		NOTES APPLY TO THE ENTIRE PROJE	CT UNLESS MODIFIED		
-2	STANDARD DETAILS SHALL BE USED WHEN R DRAWINGS.	EFERRED TO OR WHEN NO MORI	E RESTRICTIVE OR DIFFERENT DETAILS	S ARE SHOWN ON THE		
-3	DESIGN IS IN ACCORDANCE WITH AND CONST CODE ADOPTED BY THE STATE OF NEW YORK NOTES G-4 THROUGH G-7 WERE USED FOR D	VUNIFORM BUILDING CODE. THE	DESIGN LOADS AND OTHER DESIGN V	ALUES GIVEN IN		
-4	LIVE LOADS:					
	STRUCTURE	FIRST FLOOR	SECOND FLOOR	ROOF		
	ALL AREAS, EXCEPT AS NOTED BELOW	100 PSF	100 PSF	20 PSF		
	C12 MAINTENANCE AREA	200 PSF	N/A	N/A		
	TOS WORK AREA	300 PSF	N/A	N/A		
	ELECTRIC CLOSET	N/A	300 PSF	N/A		
	-ALL STAIRWAYS, LANDINGS AND PLATFORMS	ARE DESIGNED FOR A LIVE LOA	D = 100 PSF UNLESS NOTED OTHERWIS	SE.		
-5	SNOW LOAD: GROUND SNOW LOAD (Pg) = 30 PSF FLAT-ROOF SNOW LOAD (Pf) = 21 PSF SNOW EXPOSURE FACTOR (Ce) = 1.0 (EXPOS SNOW LOAD IMPORTANCE FACTOR (Is) = 1.0 ( THERMAL FACTOR (Ct) = 1.0					
-6	WIND DESIGN CRITERIA: ULTIMATE DESIGN WIND SPEED (Vult) = 115 MF RISK CATEGORY = II WIND EXPOSURE = C	ЭН				
7						
-7	SEISMIC LOAD: RISK CATEGORY = II					
	SEISMIC IMPORTANCE FACTOR (Ie) = 1.0 SITE CLASS = D MAPPED SPECTRAL RESPONSE ACCELERATIONS SPECTRAL RESPONSE ACCELERATIONS (SMS SPECTRAL RESPONSE COEFFICIENTS (SDS/SI SEISMIC DESIGN CATEGORY = B	s/SM1) = 0.457/0.147				
-8	ALL DIMENSIONS INDICATED FOR EXISTING STRUCTURES SHALL BE VERIFIED BY FIELD MEASUREMENT. ALL DIMENSIONS THAT ARE CONTROLLED BY OR RELATED TO EQUIPMENT SHALL BE VERIFIED BY THE CONTRACTOR WITH THE MANUFACTURER SHOP DRAWINGS PRIOR TO CONSTRUCTION.					
-9 -10						
	IF A CONFLICT IS FOUND BETWEEN DIFFERENT PORTIONS OF THE CONTRACT DOCUMENTS, THE CONTRACTOR SHALL NOTIFY THE ENGINEER IMMEDIATELY. CONTINUED CONSTRUCTION OF THE AREA IN CONFLICT SHALL BE AT THE CONTRACTOR'S OWN RISK UNTIL THE CONFLICT IS RESOLVED.					
-11	EQUIPMENT ANCHOR BOLT SIZES, TYPES, EM PATTERNS SHALL BE TEMPLATE TO ENSURE A		BE VERIFIED WITH THE MANUFACTUR	ER. ALL BOLT		
-12	STRUCTURAL DRAWINGS SHALL BE USED IN ( MANUFACTURER'S SHOP DRAWINGS.	COORDINATION WITH THE DRAWI	NGS OF ALL OTHER DISCIPLINES AND			
-13	STRUCTURES HAVE BEEN DESIGNED FOR OP STRUCTURES SHALL BE PROTECTED BY BRAC MAY OCCUR. OVERSTRESSING OF ANY STRU	CING AND TEMPORARY SUPPORT	S WHEREVER EXCESSIVE CONSTRUC			
-14	IF CONTRACTOR DESIRES TO TEMPORARILY F DURING CONSTRUCTION PROCESS, CONTRAC AVOIDING OVERSTRESSING AND DAMAGING F CALCULATIONS AND DRAWINGS VERIFYING P LOADS WILL NOT OVERSTRESS OR DAMAGE F SEALED BY A PROFESSIONAL ENGINEER CUR	CTOR IS EXCLUSIVELY RESPONSI EXISTING STRUCTURES AND UTIL ROPOSED CONSTRUCTION INCLU EXISTING STRUCTURES AND UTIL	BLE FOR MAINTAINING STRUCTURAL II ITIES. CONTRACTOR SHALL SUBMIT S JDING APPLICATION OF TEMPORARY C ITIES. DRAWINGS AND CALCULATIONS	NTEGRITY AND TRUCTURAL ONSTRUCTION		
-15	NO BACKFILL SHALL BE PLACED AGAINST ANY STRENGTH, OR WALLS HAVE BEEN PROPERLY UNLESS APPROVED BY THE ENGINEER. SUPP	Y BRACED, AND IN ANY CASE NO	SOONER THAN 28 DAYS AFTER THE F	PLACING OF CONCRETE		
101	NSTRUCTURAL COMPONENT AND	CHORAGE				
A-1	ALL ARCHITECTURAL, MECHANICAL, AND ELE CONTROLLING CONDITION OF OPERATIONAL SEISMIC FORCES SHALL ALSO BE AS PER AS POSITIVELY FASTENED WITHOUT CONSIDERA CONTINUOUS LOAD PATH OF SUFFICIENT STI SHALL BE PROVIDED. CONNECTIONS FOR BO BY THE CONTRACTOR'S ENGINEER CURRENT	FORCES OR SEISMIC FORCES IN CE 7. COMPONENT SEISMIC ATTA ATION OF FRICTIONAL RESISTANC RENGTH AND STIFFNESS BETWE DTH ORTHOGONAL DIRECTIONS (	ACCORDANCE WITH THE GOVERNING ACHMENTS SHALL BE BOLTED, WELDE CE PRODUCED BY THE EFFECTS OF GF EN THE COMPONENT AND THE SUPPO TRANSVERSE AND LONGITUDINAL) SH	BUILDING CODE. D, OR OTHERWISE &AVITY. A RTING STRUCTURE		
<b>\-</b> 2	COMPONENT REACTION FORCES AT THE POI WITH THE ENGINEER FOR CONFIRMATION SU			O COORDINATED		
<b>A-</b> 3	CONTRACTOR SHALL PROVIDE SPECIAL SEIS DEEMED NECESSARY BY SPECIFICATIONS. S	MIC CERTIFICATION (SSC) FROM	MANUFACTURER OF EQUIPMENT FOR			
XIS	STING INFORMATION					
-1	ALL EXISTING INFORMATION SHOWN ON THES FROM THE RECORD DRAWINGS TITLED CITY ( DATED FEBRUARY 1954 AND IS NOT GUARANT	OF NEW YORK, BOARD OF WATER	R SUPPLY KENSICO WATER TESTING LA			
-2	THE CONTRACTOR IS RESPONSIBLE FOR VER	IFYING ALL EXISTING INFORMATI	ON IN THE FIELD AS REQUIRED FOR DE	EMOLITION AND MODIFICATION		

			DESIGNED BY: S. MANZO	DRAWN BY: S. ROESER	ATTE OF NEW HOR
			CHECKED BY:	DESIGN LEAD:	
				E. BARBOE, P.E.	ES A STOTLA
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All inquiries	egarding this drawing(s) or project should be made to NYC	Environmental	Protection, Bureau of Wat	er Supply.	

inquines regarding this awing(s) of project оп, вс

CON	ICRETE (CAST-IN-PLACE)	STR	JCTUR
C-1	DESIGN OF CONCRETE ELEMENTS INCLUDING WALLS, FORMED SLABS, BEAMS, AND COLUMNS IS IN ACCORDANCE WITH ACI 318 (CODE REQUIREMENTS FOR STRUCTURAL CONCRETE).	M-1	DETAIL, F. BUILDING
C-2	FOR CONCRETE MIX DESIGN SEE SPECIFICATION SECTION 03300.	M-2	STEEL MA
-3	CONCRETE STRENGTH CLASSES (28-DAY COMPRESSIVE STRENGTH):		B. STRU C. PLATE
	A. CLASS 45 - USE FOR ALL CONCRETE UNLESS INDICATED OTHERWISE.		D. STRU
	B. CLASS B-32 - USE NYCDOT SPECIFICATION FOR SIDEWALKS, HEADERS AND CURB.		F. STRU G. RODS
	C. CLASS 25 - USE FOR LEAN CONCRETE.	M-3	PROVIDE
4	ALL BAR REINFORCING SHALL CONFORM TO ASTM A615, GRADE 60. WHERE REINFORCEMENT IS TO BE WELDED IN ACCORDANCE	M-4	STRUCTU
5	WITH AWS D1.4, ASTM A706 GRADE 60 SHALL BE USED. WELDED WIRE FABRIC SHALL CONFORM TO ASTM A185.		TABULAT
	CONCRETE COVER FOR REINFORCING (UNLESS NOTED OTHERWISE ON THE DRAWINGS):	M-5	DO NOT P
	A. CONCRETE DEPOSITED DIRECTLY AGAINST SOIL:       3"         B. CONCRETE EXPOSED TO WEATHER (#5 OR SMALLER):       1 1/2"         CONCRETE EXPOSED TO WEATHER (#6 OR LARGER):       2"	M-6	ALL STAIN FABRICAT
	C. SLABS: 1 1/2" AT SURFACES CONTACTING FLUID: 2"	M-7	ALUMINUI
	D. BEAMS AND COLUMNS (TO MAIN REINFORCEMENT):       2"         BEAMS AND COLUMNS (TO COLUMN TIES OR STIRRUPS):       1 1/2"	M-8	ALL BOLT
	E. WALLS 12" OR MORE:       2"         WALLS LESS THAN 12" (#5 OR SMALLER):       1 1/2"         WALLS LESS THAN 12" (#5 OR SMALLER):       1 1/2"	M-9	DETAIL, F
6	WALLS LESS THAN 12" (#6 OR LARGER):2"F. FOR SURFACES EXPOSED TO FLUID IN BEAMS, COLUMNS AND WALLS:ADD 1/2" TO ABOVE VALUES	M-10	ALUMINUI
	SPLICES SHALL BE CLASS "B" CONFORMING TO THE PROVISIONS OF ACI 318 UNLESS NOTED OTHERWISE. SPLICE LENGTH FOR TWO DIFFERENT SIZED BARS TO BE LAP SPLICED TOGETHER SHALL BE THE LENGTH OF THE LARGER BAR UNLESS NOTED	M-10 M-11	ALL GROO
	OTHERWISE.	M-12	FILLET WI
	CONSTRUCTION JOINTS SHALL BE LOCATED AS SHOWN ON THE DRAWINGS. CONSTRUCTION JOINTS NOT SHOWN SHALL BE SUBMITTED BY THE CONTRACTOR FOR THE APPROVAL OF THE ENGINEER PRIOR TO SUBMITTING REBAR SHOP DRAWINGS.		AND SHAL
	VERTICAL CONSTRUCTION JOINTS IN WALLS AND HORIZONTAL JOINTS IN SLABS SHALL BE PROVIDED AT A SPACING NOT GREATER THAN 45 FEET ON CENTER. FOR EXPOSED WALLS WITH FLUID OR EARTH ON THE OPPOSITE SIDE, THE SPACING	M-13	BOTTOM
	BETWEEN VERTICAL AND HORIZONTAL JOINTS SHALL BE A MAXIMUM OF 25 FEET. WHERE HORIZONTAL CONSTRUCTION JOINTS, LOCATED ABOVE THE FOUNDATION SLAB, EXTEND BEYOND WHERE NEEDED, THEY	M-14	WHENEVE THERE SH LOCATED
	SHALL BE TERMINATED AT A VERTICAL CONSTRUCTION JOINT APPROVED BY THE ENGINEER.	M-15	BOLTED
	ALL JOINTS WHICH ARE IN MEMBERS IN CONTACT WITH LIQUID OR BELOW GRADE SHALL HAVE A WATERSTOP. CONSTRUCTION JOINTS SHALL HAVE A 6" PVC RIBBED WATERSTOP. EXPANSION JOINTS SHALL HAVE A 9" PVC CENTER BULB RIBBED		(SPECIFIC
0	WATERSTOP. IN VERTICAL JOINTS, WATERSTOPS SHALL TERMINATE NO LESS THAN 18" ABOVE THE MAXIMUM WATER SURFACE OR 18" ABOVE GRADE, WHICHEVER IS HIGHER.	M-16	STRUCTU WELDING
1	ALL EXPOSED CORNERS SHALL HAVE A 3/4" CHAMFER OR A 1/2" RADIUS TOOLED CORNER.		
	EQUIPMENT SUPPORTS, ANCHORAGES, OPENINGS, RECESSES AND REVEALS NOT SHOWN ON THE STRUCTURAL DRAWINGS BUT REQUIRED BY OTHER CONTRACT DOCUMENTS, SHALL BE PROVIDED FOR PRIOR TO PLACING CONCRETE.	DEM	OLITIO
2	REINFORCING BARS AND ACCESSORIES SHALL NOT BE IN CONTACT WITH ANY METAL PIPE, PIPE FLANGE, METAL CONDUIT, OR OTHER METAL PARTS EMBEDDED IN CONCRETE. A MINIMUM CLEARANCE OF 2" SHALL BE PROVIDED.	D-1	FOR DEM
3	DOWELS, ANCHOR BOLTS, PIPES, WATERSTOPS AND OTHER EMBEDDED ITEMS SHALL BE HELD SECURELY IN POSITION WHILE	D-2	CONCRET SAWCUTT SHALL BE
4	CONCRETE IS BEING PLACED.		VIBRATO
5	CONDUITS AND OTHER SIMILAR ITEMS EMBEDDED IN OR PENETRATING THROUGH CONCRETE SHALL BE SPACED ON CENTER NOT LESS THAN 3 TIMES THEIR OUTSIDE DIMENSION, BUT NOT LESS THAN 2 1/2" CLEAR. WHEN SUCH ITEMS ARE EMBEDDED IN WALLS OR SLABS, THEY SHALL NOT OCCUPY MORE THAN 1/3 OF THE MEMBER THICKNESS.	D-3	UNLESS A BACK ANO BINDER. S
	AT ALL TYPICAL CURBS, EQUIPMENT PADS, AND PIPE SUPPORT PIERS, REINFORCING DOWELS SHOWN MAY BE REPLACED WITH MATCHING DOWELS SET IN EPOXY IN DRILLED HOLES AS SPECIFIED. DOWELS LOCATED CLOSER THAN 3" FROM ANY EDGE OF CONCRETE SHALL NOT BE REPLACED WITH DRILLED DOWELS.	D-4	EMBEDDE CONTRAC
6	DRILLED ADHESIVE DOWELS (WHERE DOWELS ARE SHOWN TO BE PLACED INTO HARDENED CONCRETE):	D-5	WHERE D
	A. THE HOLE DIAMETER SHALL BE NO LARGER THAN 1/8" GREATER THAN THE DIAMETER OF THE REINFORCING BAR AT THE DEFORMATIONS.		A. SAWC B. SCAR
	<ul> <li>B. THE DEPTH OF EMBEDMENT SHALL BE 12 BAR DIAMETERS, UNLESS NOTED OTHERWISE.</li> <li>C. ADJUST THE DOWEL LOCATIONS AS NEEDED TO AVOID DRILLING THROUGH ANY REINFORCING BARS. IF THE LOCATION</li> </ul>		LAITA C. RESU APPR
	NEEDS TO BE MODIFIED, CONTACT THE ENGINEER. CONTRACTOR SHALL USE NON-DESTRUCTIVE MEANS TO FIELD LOCATE REINFORCEMENT PRIOR TO DRILLING HOLES FOR DOWELS.		RECO
7	CLEAR DISTANCE FROM ANCHOR BOLTS TO ANY CONCRETE EDGE SHALL BE 4" MINIMUM UNLESS NOTED OTHERWISE.	D-6	PRIOR TO DESTRUC
8	CONCRETE COMPRESSIVE STRENGTH TESTS SHALL BE AVAILABLE ON THE JOB SITE FOR REVIEW BY THE ENGINEER.		REINFOR
۸ <b>с</b>	SONRY	D-7	CONCRET BY SIKA C
		D-8	DETAILED
1	MASONRY MORTAR SHALL BE ASTM C 270 TYPE "S" AND MASONRY GROUT SHALL CONFORM TO REQUIREMENTS OF ASTM C 476. CONCRETE MASONRY UNIT NET AREA COMPRESSIVE STRENGTH SHALL BE 1900 PSI WHEN TESTED IN ACCORDANCE WITH ASTM		THE OWN
2	C 140. COMPLETE TEST REPORTS SHALL BE SUBMITTED TO THE BUILDING INSPECTOR.		
3	MASONRY TRUSS TYPE REINFORCEMENT SHALL CONFORM TO ASTM A 951 AND REINFORCEMENT STEEL SHALL CONFORM TO REQUIREMENTS OF ASTM A 615 FOR GRADE 60 BILLET STEEL.		EGATED
4	MASONRY REINFORCEMENT BAR SPLICES SHALL BE CONTACT SPLICES. UNLESS NOTED OTHERWISE, LENGTH OF SPLICE FOR SINGLE BARS IN CENTER OF CELLS OF 8" OR LARGER CMU SHALL BE A MINIMUM OF 25 INCHES FOR #4 BARS AND 32 INCHES FOR #5 BARS. LENGTH OF SPLICE FOR OTHER CONDITIONS SHALL BE AS SHOWN ON THE DRAWINGS.	DSD-1	THE FOLL
-5	BOND BEAM REINFORCEMENT SHALL BE PROVIDED WITH STD 90° HOOKS AT ALL WALL INTERSECTIONS. WHERE BOND BEAM REINFORCEMENT IS INTERRUPTED BY OPENINGS REINFORCEMENT SHALL BE PROVIDED WITH STD 180° HOOKS AT ENDS. SEE ARCHITECTURAL DRAWINGS FOR DETAILS.		<ul><li>A. EXCA'</li><li>B. META</li><li>C. ACCE</li><li>D. HAND</li></ul>
6	DOWELS SHALL BE EITHER CAST INTO WALL OR INSTALLED WITH A DOWEL ADHESIVE SYSTEM. IF CAST, DOWELS SHALL BE		E. PIPE S F. EQUIF
	EMBEDDED IN STEM WALL OR FOUNDATION SLAB A MINIMUM 9" AND SHALL HAVE A STD 90° HOOK. IF INSTALLED WITH A DOWEL ADHESIVE SYSTEM DOWELS SHALL BE STRAIGHT BARS EMBEDDED A MINIMUM OF 10" INTO STEM WALL. DOWEL ADHESIVE SHALL BE QUALIFIED FOR USE UNDER SEISMIC LOADING IN BOTH CRACKED AND UNCRACKED CONDITIONS FOR ALL SEISMIC DESIGN CATEGORIES IN ACCORDANCE WITH THE SPECIFICATIONS. INSTALLATION OF ALL DOWELS SHALL BE PER MANUFACTURERS RECOMMENDATIONS. AS A MINIMUM THE FOLLOWING INSTALLATION REQUIREMENTS SHALL BE MET:	DSD-2	G. CHEC DRAWING IN THE ST

- A. HOLES SHOULD BE DRILLED WITH CARBIDE BIT UNLESS OTHERWISE RECOMMENDED BY THE MANUFACTURER. B. ALL HOLES SHALL BE CLEANED USING COMPRESSED AIR AND A PROPERLY SIZED NYLON OR WIRE BRUSH. C. ADHESIVE SHALL BE INJECTED USING A DISPENSER, STATIC MIXING NOZZLE AND A PISTON PLUG TO MINIMIZE THE
- FORMATION OF AIR POCKETS PROVIDED BY THE MANUFACTURER. IF DEPTH OF HOLE IS DEEPER THAN THE STATIC MIXING NOZZLE A PLASTIC EXTENSION TUBE SUPPLIED BY THE MANUFACTURER SHALL BE USED FOR PLACING ADHESIVE.



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**NEW YORK CITY ENVIRONMENTAL PROTEC BUREAU OF WATER SUPPLY** 465 COLUMBUS AVENUE, SUITE 270 VALHALLA, NEW YORK 10595-1336 www.nyc.gov/dep

## AL METALS

ABRICATE, AND ERECT STRUCTURAL STEEL IN ACCORDANCE WITH AISC SPECIFICATION FOR STRUCTURAL STEEL SS, ALLOWABLE STRESS DESIGN AND PLASTIC DESIGN, LATEST EDITION.

ATERIAL:

JCTURAL HSS: ASTM A500, GRADE C (46/50 KSI) OR A1085 (50 KSI) CTURAL PIPE: ASTM A53, GRADE B (35 KSI) ES, BARS AND ANGLES: ASTM A36 UNO (36 KSI) CTURAL W SHAPES: ASTM A992 (50 KSI) CTURAL S, M, C & MC SHAPES: ASTM A36 (36 KSI) JCTURAL HP ASTM A572 GRADE 50 (50 KSI) ASTM F1554 GRADE 36 (36 KSI)

MINIMUM 3/4" DIAMETER ASTM A325 HIGH STRENGTH BOLTS WITH SNUG TIGHTENED TYPE N CONNECTIONS FOR JRAL STEEL UNLESS NOTED OTHERWISE. HOLES FOR BOLTS SHALL BE STANDARD SIZE UNLESS NOTED OTHERWISE.

TYPICAL STEEL BEAM CONNECTIONS FOR A CAPACITY OF NOT LESS THAN THE TOTAL UNIFORM LOAD CAPACITY ED IN THE AISC TABLES FOR ALLOWABLE LOADS OF BEAMS UNLESS NOTED OTHERWISE.

PAINT STEEL SURFACES WHICH ARE TO BE WELDED OR ARE TO BE ENCASED IN CONCRETE.

NLESS STEEL FABRICATIONS EXPOSED TO UNDERWATER SERVICE SHALL BE TYPE 316. ALL OTHER STAINLESS STEEL TIONS SHALL BE TYPE 304 UNLESS NOTED OTHERWISE.

IM SHALL BE ALLOY 6061-T6 UNLESS NOTED OTHERWISE.

IS, ANCHOR BOLTS, AND CONCRETE ANCHORS CONNECTING ALUMINUM SHALL BE STAINLESS STEEL TYPE 316 FOR ATER APPLICATIONS AND TYPE 304 FOR ALL OTHER APPLICATIONS.

FABRICATE, AND ERECT ALUMINUM IN ACCORDANCE WITH THE LATEST EDITION OF THE ALUMINUM ASSOCIATION JM DESIGN MANUAL.

IM SHALL BE ISOLATED FROM CONTACT WITH CONCRETE AND DISSIMILAR METALS.

OVE AND BUTT WELDS SHALL BE FULL PENETRATION.

ELD SIZES SHALL NOT BE LESS THAN THE MINIMUM SIZE REQUIRED BY AISC CODE FOR PLATE SIZES TO BE CONNECTED ILL BE APPLIED TO THE ENTIRE JOINT CONTACT LENGTH, AND NOT LESS THAN 3/16".

SURFACES OF BASE PLATES SHALL BE GROUTED TO ENSURE FULL BEARING CONTACT WITH CONCRETE SLAB.

ER ONE MEMBER IS FASTENED TO ANOTHER WITH FASTENINGS (BOLTS, WELDS, ETC.) SET AT A UNIFORM SPACING, HALL BE A MINIMUM OF TWO FASTENINGS PER PIECE CONNECTED AND THE FIRST AND LAST FASTENINGS SHALL BE NOT TO EXCEED 0.25 OF FASTENER SPACING FROM EACH END.

CONNECTIONS FOR STRUCTURAL STEEL SHALL BE ASSEMBLED AND INSPECTED IN ACCORDANCE WITH RCSC CATIONS FOR STRUCTURAL JOINTS USING ASTM A325 OR ASTM A490 BOLTS).

JRAL WELDED JOINTS SHALL CONFORM TO THE PROVISIONS OF AWS D1.1, STRUCTURAL WELDING CODE BY AMERICAN SOCIETY. PROOF OF WELDER CERTIFICATION SHALL BE AVAILABLE AT THE JOB SITE DURING TIMES OF INSPECTION.

10LITION REQUIREMENTS, REFER TO SPECIFICATION 02222 - DEMOLITION AND REMOVAL.

TE DEMOLITION WITHIN STRUCTURES BEING MODIFIED SHALL BE SELECTIVE DEMOLITION BY CORE DRILLING OR TING AND CAREFUL REMOVAL OF CONCRETE SHOWN TO BE REMOVED. NO OVER CUTTING OF AREAS TO BE DEMOLISHED E PERMITTED. CONTRACTOR SHALL CORE DRILL CORNERS OF OPENING PRIOR TO SAWCUTTING. EXPLOSIVES AND RY HAMMERS SHALL NOT BE USED FOR DEMOLITION WORK.

ANCHORING DEVICES AND/OR REINFORCEMENT IS NOTED TO REMAIN FOLLOWING DEMOLITION, REMOVE AND/OR BURN CHORS AND REINFORCEMENT STEEL 1/2" MIN BELOW SURFACE AND VOIDS CREATED SHALL BE FILLED WITH EPOXY RESIN SUCH AS "SIKADUR 52" BY SIKA CORPORATION, "DURALCRETE LV" BY EUCLID CHEMICAL COMPANY, OR EQUAL.

ED CONDUIT ENCOUNTERED DURING DEMOLITION WORK LIMITS SHALL BE PERMANENTLY REROUTED AS NECESSARY. CTOR SHALL SUBMIT PROPOSED MEANS OF REROUTING ANY INTERFERING CONDUIT.

DRAWINGS INDICATE A CONCRETE EQUIPMENT PAD TO BE DEMOLISHED, THE FLOOR SLAB SURFACE SHALL BE REPAIRED AS ED BY ENGINEER. FOLLOWING SELECT DEMOLITION AND REMOVAL OF THE EQUIPMENT PAD REMOVAL THE REPAIR SHALL BE: CUT THE FLOOR AROUND THE EQUIPMENT PAD PERIMETER TO A DEPTH OF 1/4". RIFY AND REMOVE SLAB CONCRETE WITHIN THE PERIMETER TO A NOMINAL 1/4" DEPTH CLEAN AND REMOVE ALL CONCRETE NCE.

JRFACE THE AREA BY APPLYING A POLYMER MODIFIED OR SILICA FUME ENHANCED CEMENTITIOUS REPAIR MORTAR, OVED BY THE ENGINEER, FOLLOWING THE MANUFACTURER'S SURFACE PREPARATION AND APPLICATION OMMENDATIONS. LEVEL AND FINISH THE SURFACE TO MATCH THE FLOOR SLAB SURROUNDING AREA.

D DEMOLITION OF SMALL OPENINGS (LESS THAN 6 INCHES IN SIZE) FOR PENETRATIONS, ETC., CONTRACTOR SHALL USE NON-CTIVE MEANS TO FIELD LOCATE REINFORCEMENT. OPENINGS SHALL BE LOCATED TO AVOID CUTTING THROUGH EXISTING CEMENT, IF POSSIBLE. EXISTING REINFORCEMENT SHALL NOT BE CUT WITHOUT APPROVAL OF ENGINEER.

TE SURFACES LEFT EXPOSED FOLLOWING DEMOLITION SHALL BE SEALED WITH EPOXY RESIN COATING SUCH AS "SIKAGARD" CORPORATION, "DURACOTE 240" BY TAMMS INDUSTRIES, OR APPROVED EQUAL.

CONSTRUCTION AND DEMOLITION PLAN SHALL BE SUBMITTED TO THE ENGINEER AND APPROVED BY THE ENGINEER AND PRIOR TO BEGINNING CONSTRUCTION. ANY SHUTDOWNS SHALL BE SUBMITTED TO, COORDINATED WITH, AND APPROVED BY NER. ONCE APPROVED, CONTRACTOR SHALL PROVIDE A MINIMUM OF THREE (3) WEEKS NOTICE TO OWNER PRIOR TO WN.

## D STRUCTURAL DESIGN ITEMS

LOWING ITEMS SHALL BE SUBMITTED AS DELEGATED STRUCTURAL DESIGNS DURING CONSTRUCTION, IN ANCE WITH THE CONTRACT DRAWINGS AND SPECIFICATIONS

VATION SUPPORT SYSTEMS AL STAIRS AND PLATFORMS

ESS DOORS AND HATCHES

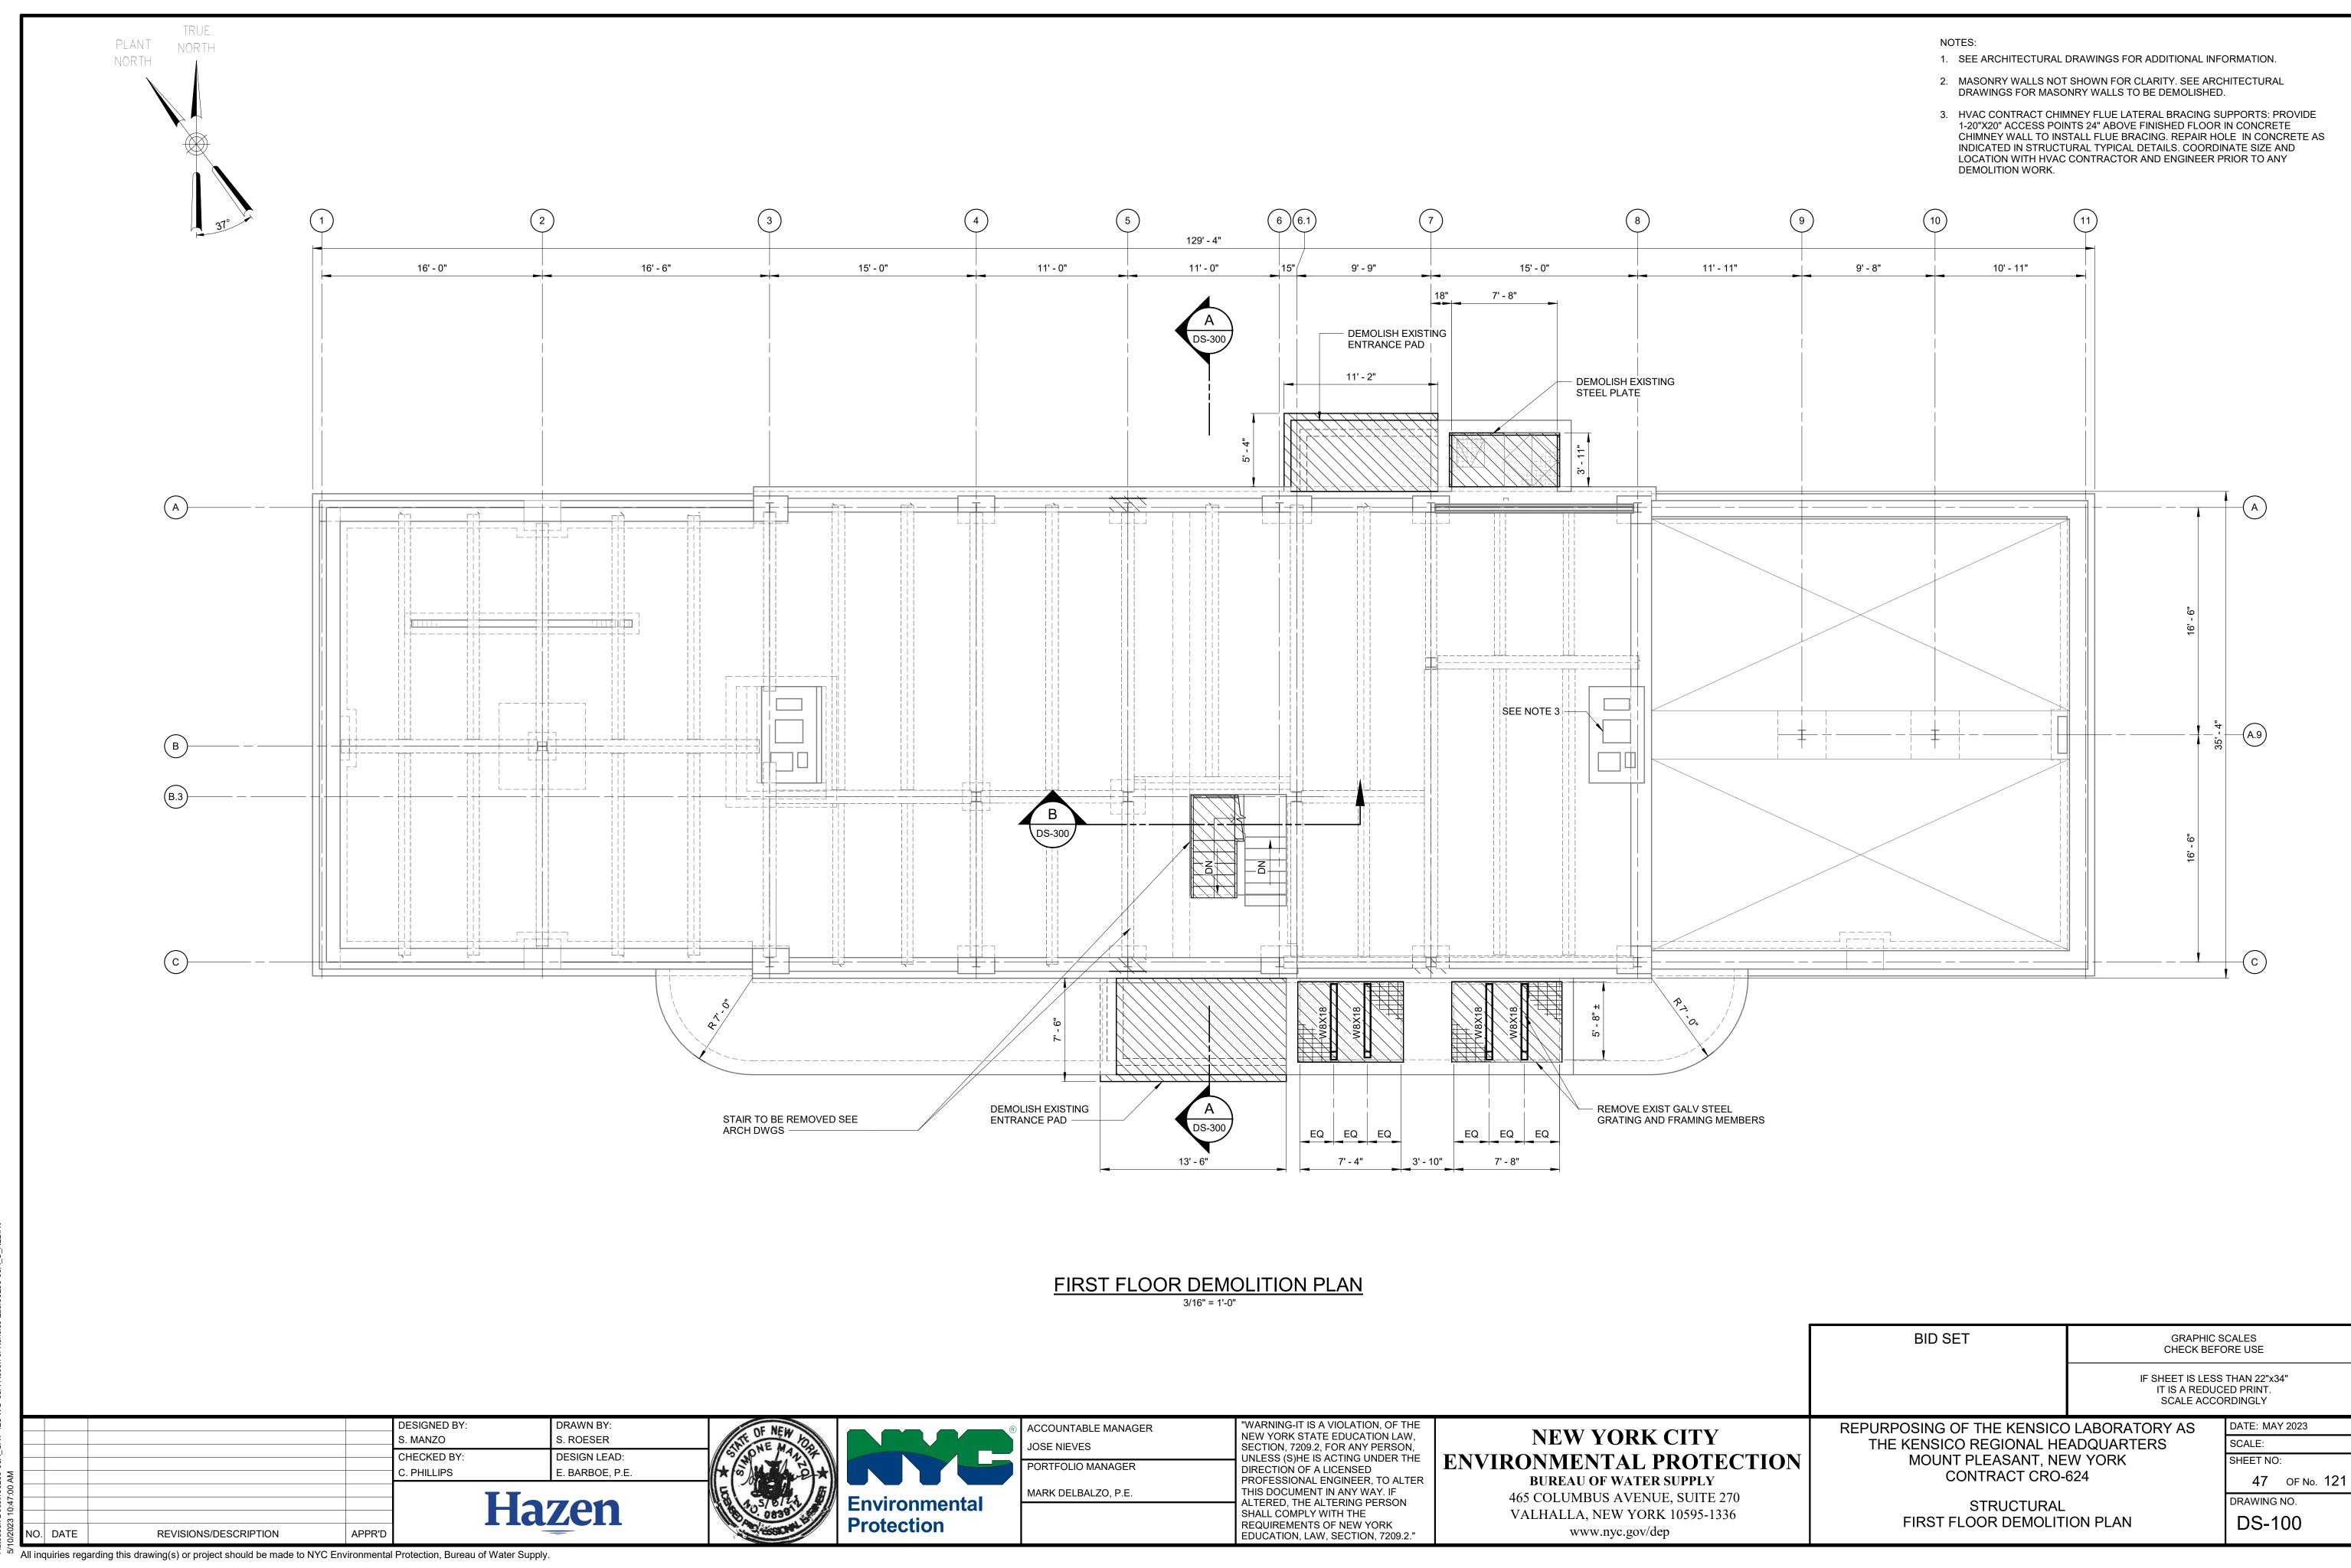
DRAILS SUPPORTS

PMENT ANCHORAGE


CKERED PLATE AND GRATING

GS AND CALCULATIONS FOR EACH ITEM SHALL BE SIGNED AND SEALED BY A PROFESSIONAL ENGINEER REGISTERED TATE OF NEW YORK


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TION	MOUNT PLEASANT, NE	SHEET NO:		
	CONTRACT CRO-	624	46 OF No. 121	
	STRUCTURAL	DRAWING NO.		
	GENERAL NOTES, ABBREVIATIO	GS-001		



/	ACCOUNTABLE MANAGER
.	JOSE NIEVES
F	PORTFOLIO MANAGER
r	MARK DELBALZO, P.E.

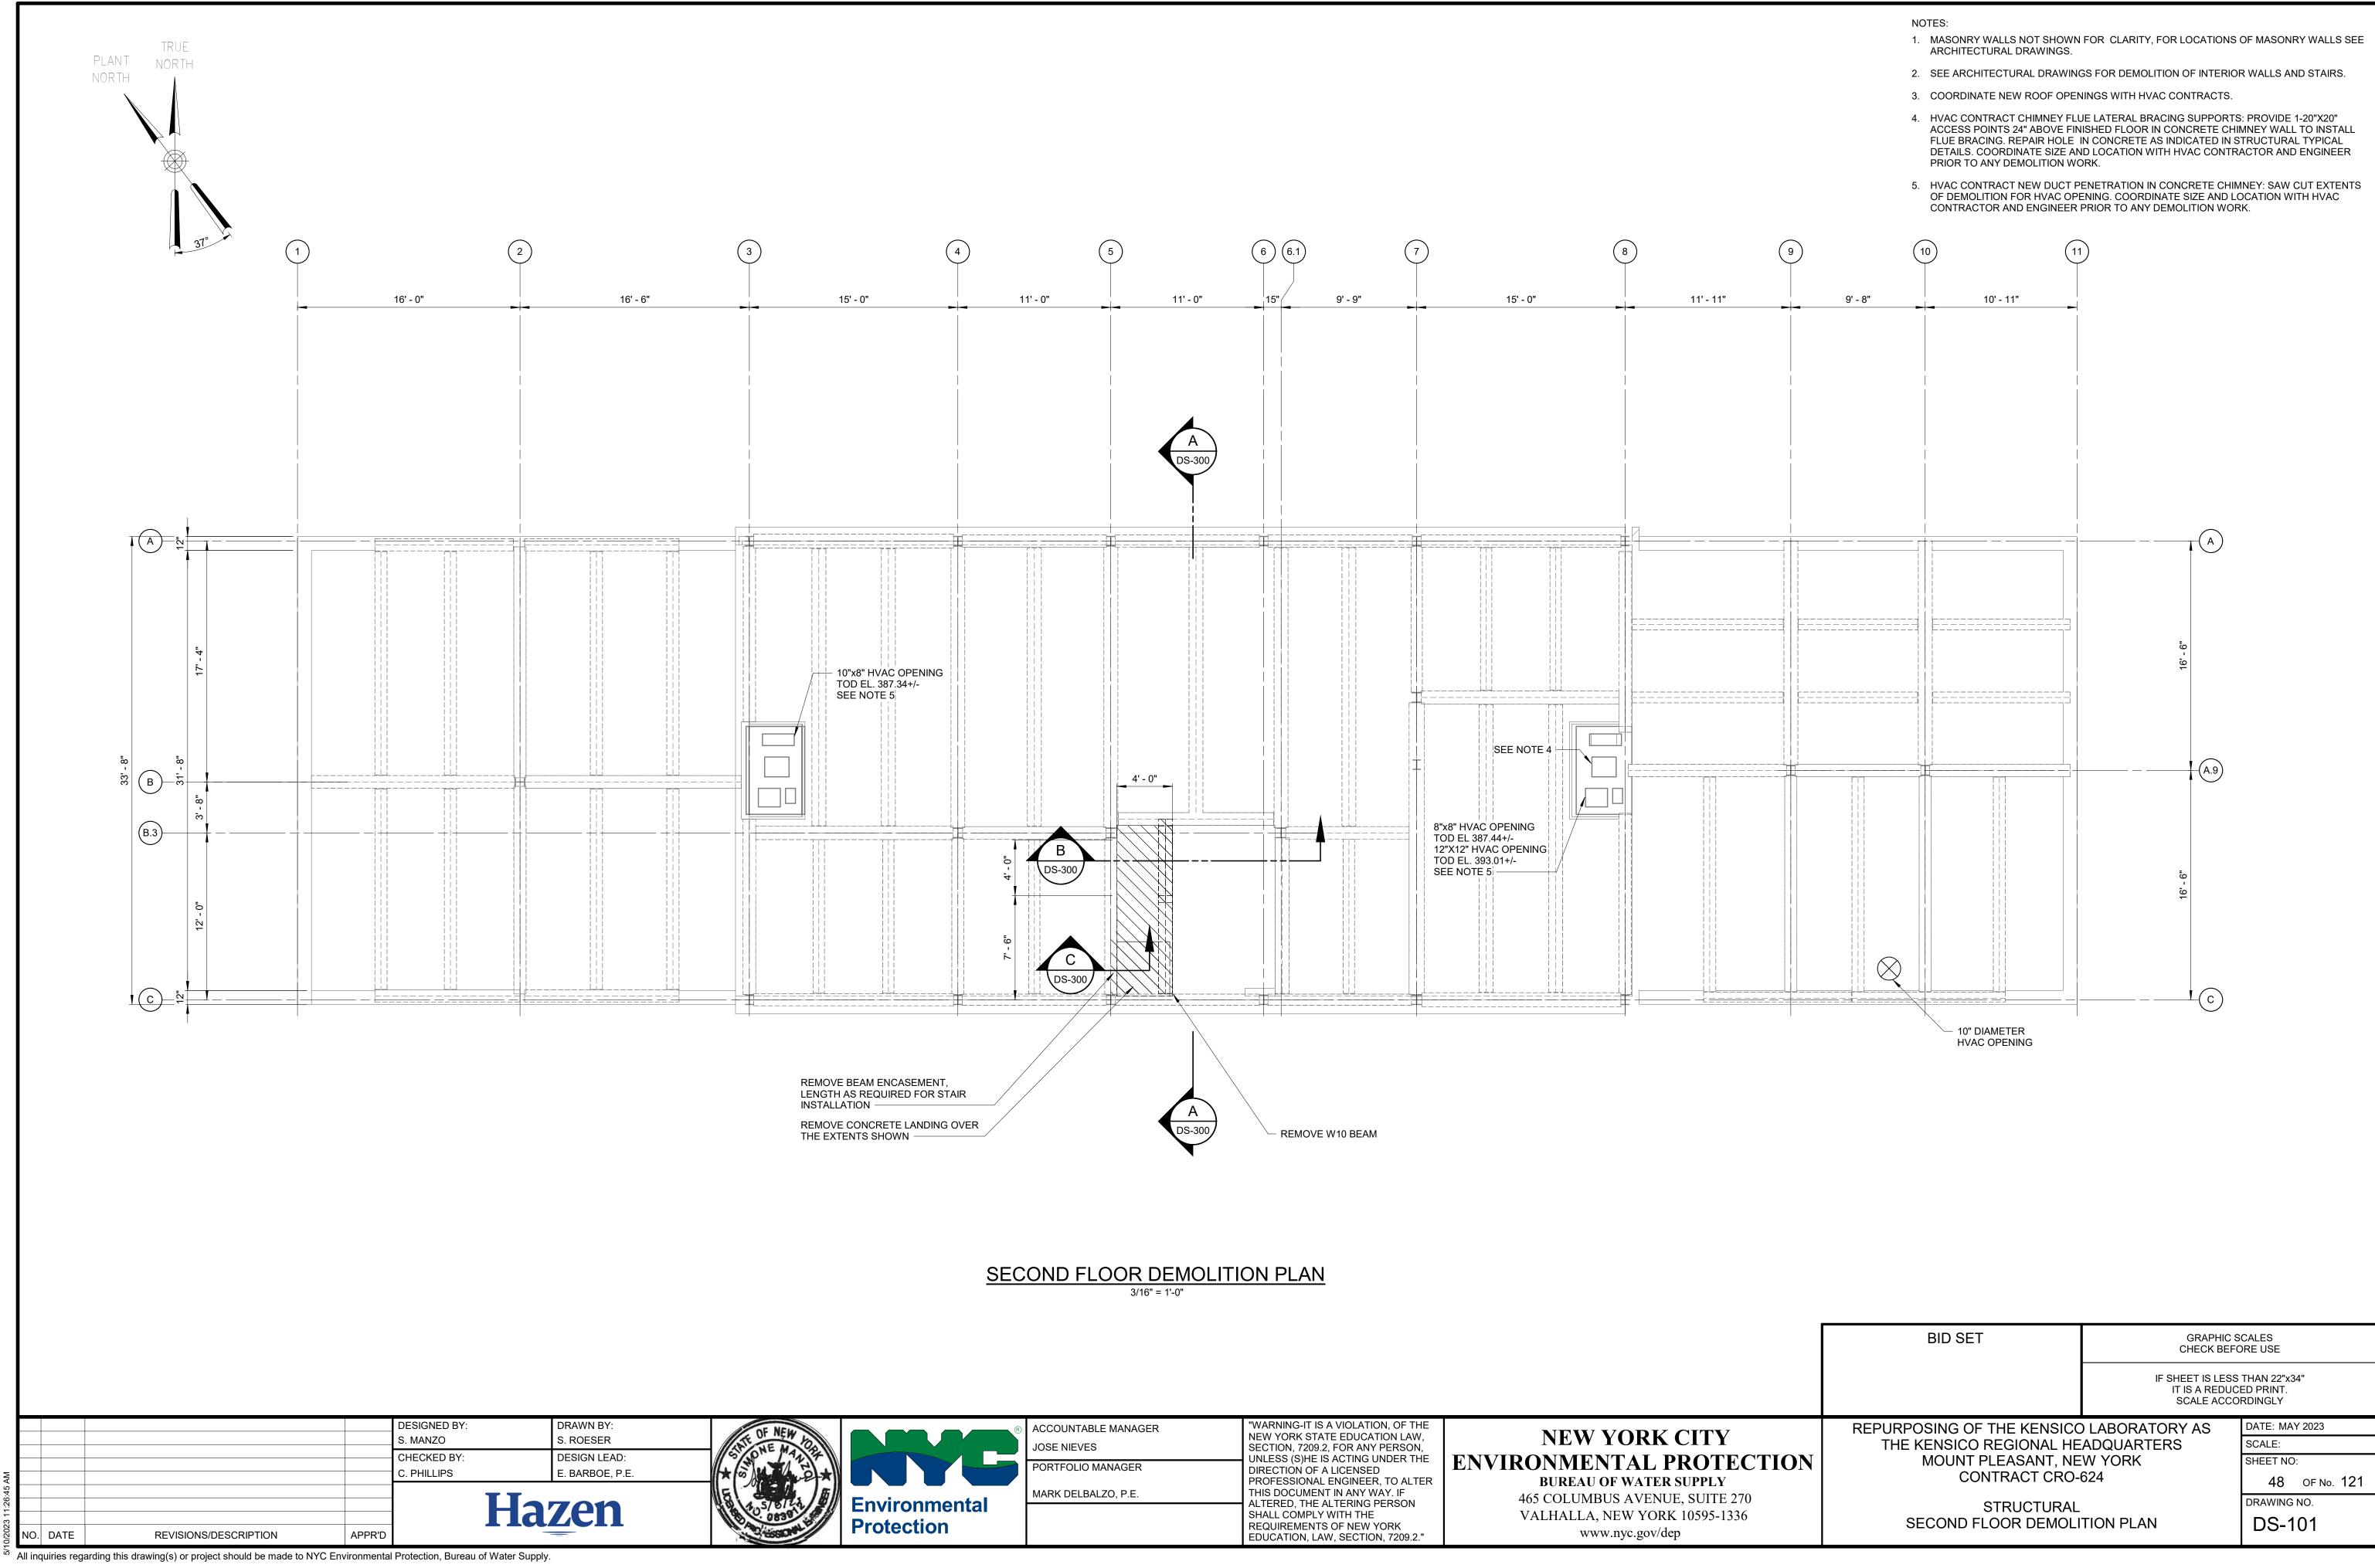

ACCOUNTABLE MANAGER	"WARNING-IT
JOSE NIEVES	NEW YORK S SECTION, 72 UNLESS (S)H
PORTFOLIO MANAGER	
MARK DELBALZO, P.E.	THIS DOCUM
	SHALL COMP REQUIREME

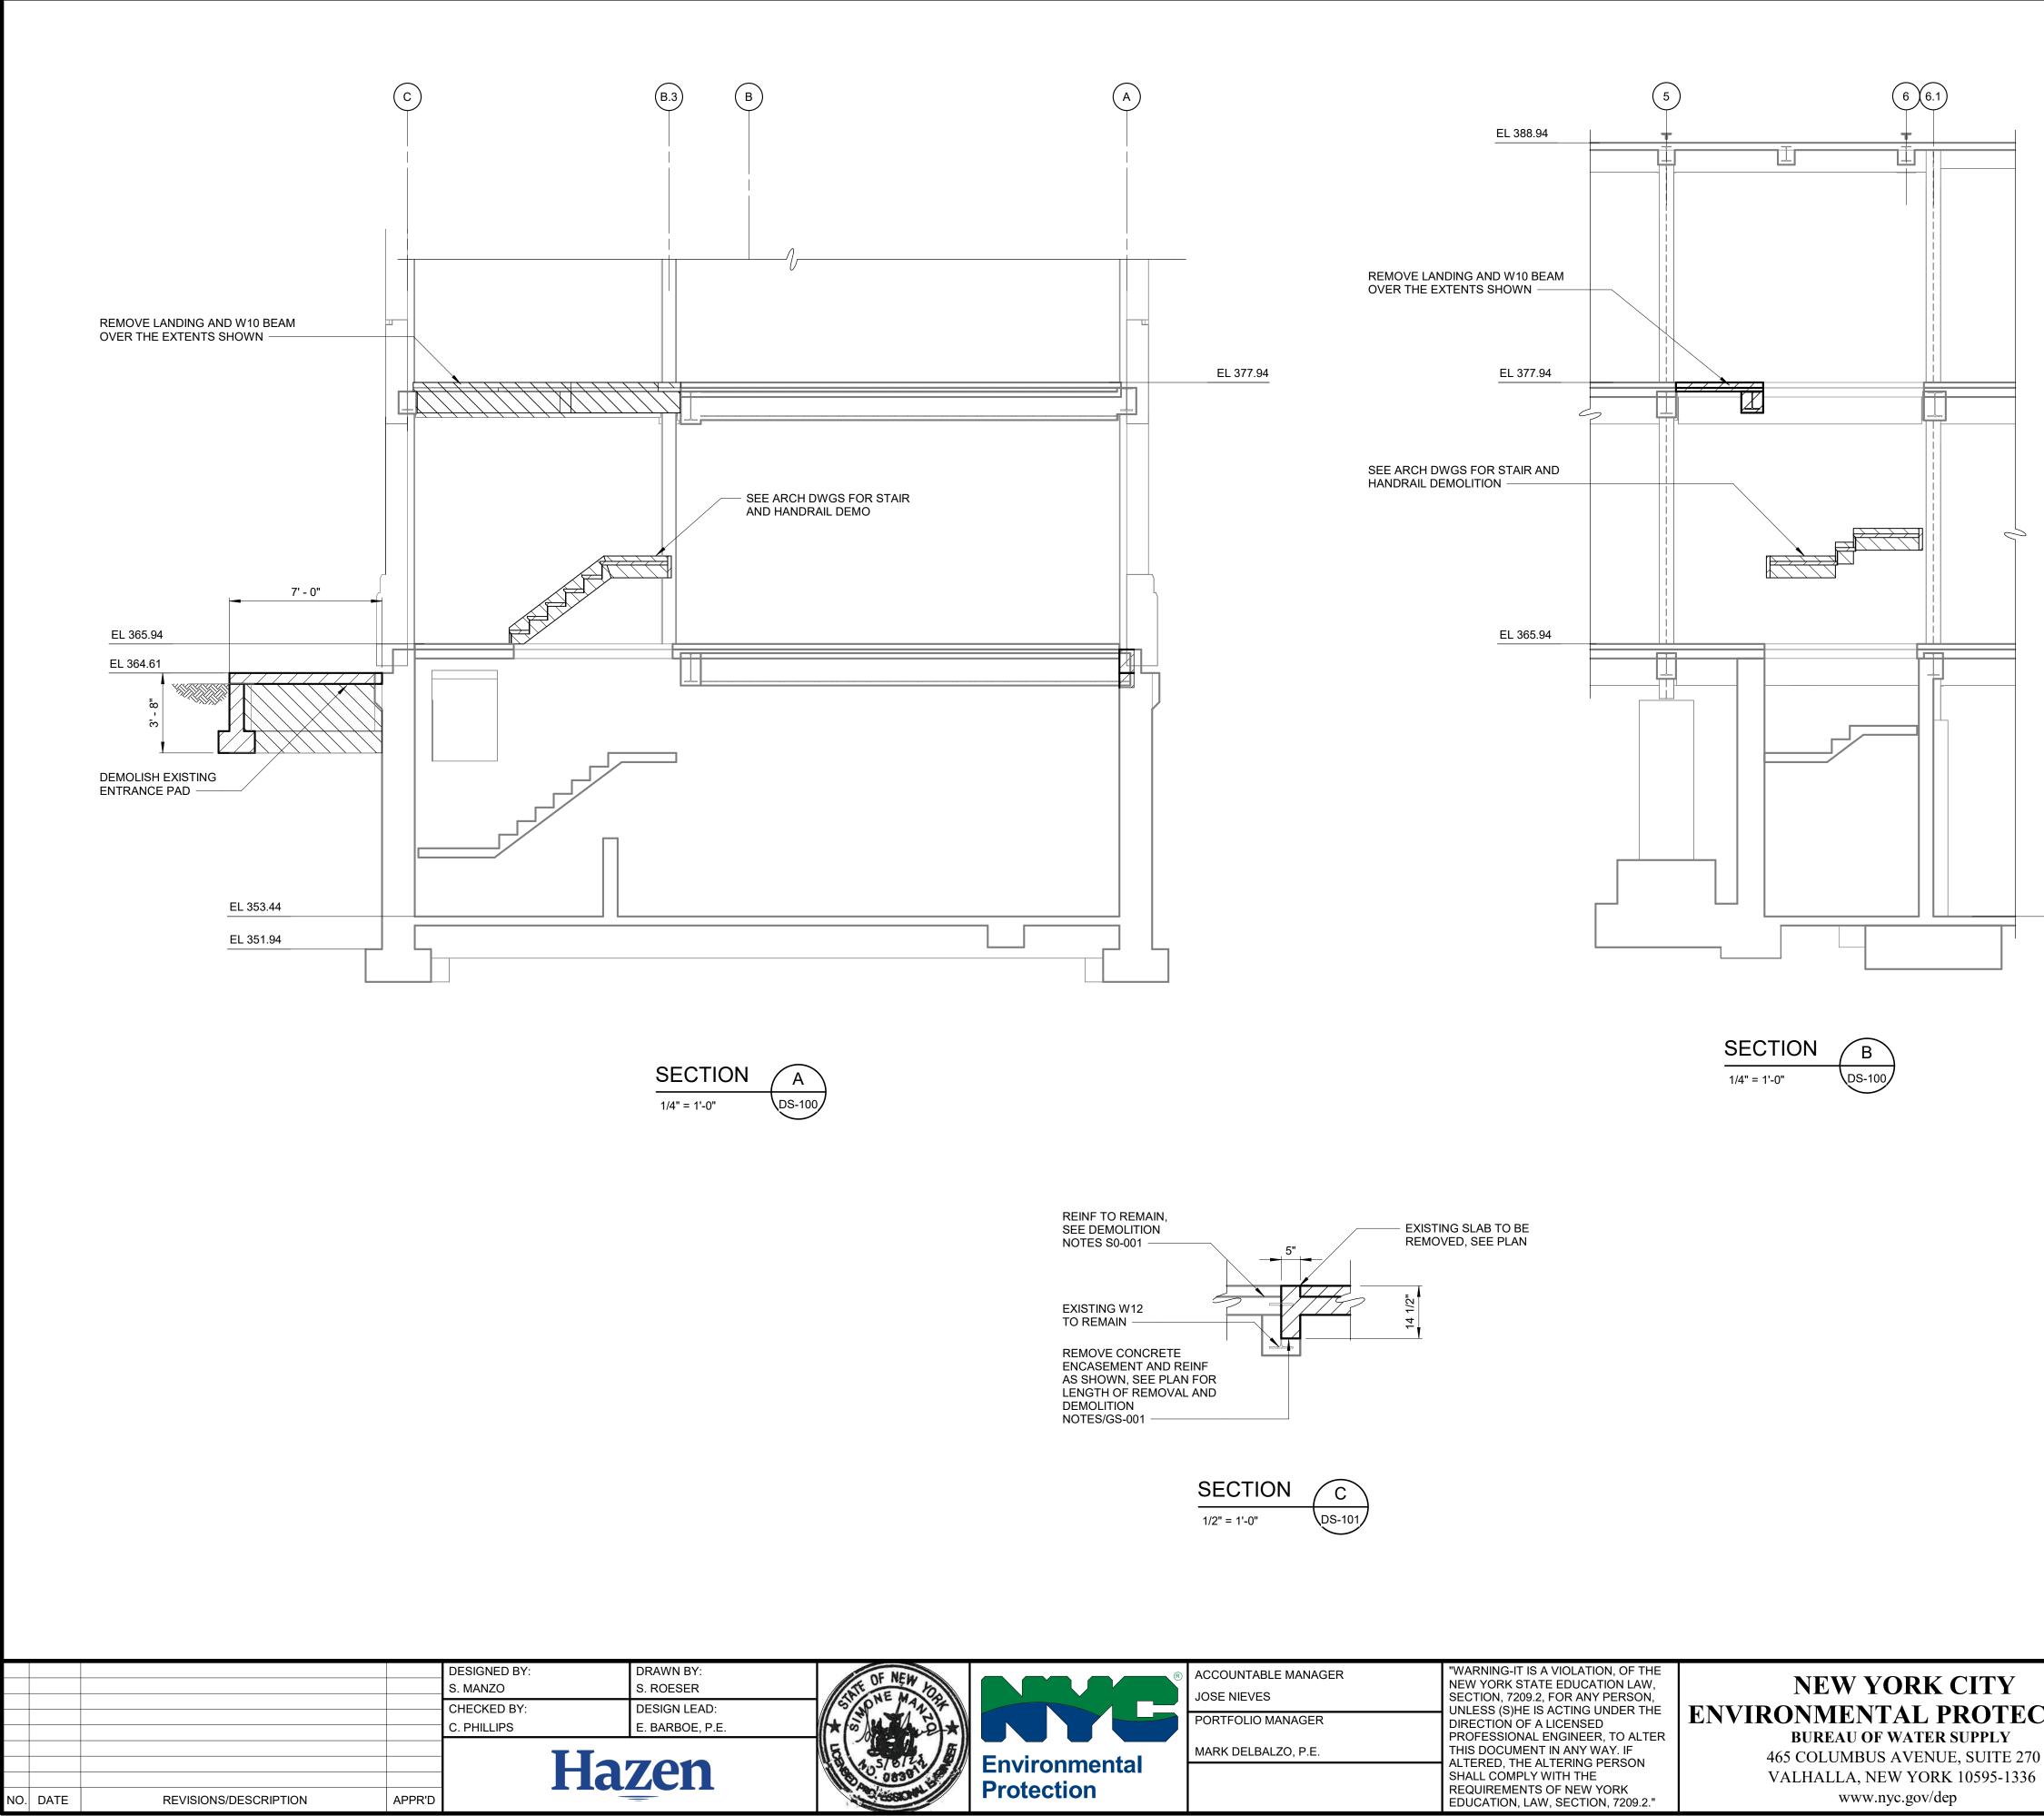


BLE MANAGER	"WARNING-IT IS A VIOLATION, OF THE
ES	NEW YORK STATE EDUCATION LAW, SECTION, 7209.2, FOR ANY PERSON, UNLESS (S)HE IS ACTING UNDER THE
MANAGER	DIRECTION OF A LICENSED
	PROFESSIONAL ENGINEER, TO ALTER THIS DOCUMENT IN ANY WAY, IF
BALZO, P.E.	ALTERED, THE ALTERING PERSON
	SHALL COMPLY WITH THE
	REQUIREMENTS OF NEW YORK


465 COLUMBUS AVENUE, SUITE 270 VALHALLA, NEW YORK 10595-1336

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	REPURPOSING OF THE KENSICO LABORATORY AS THE KENSICO REGIONAL HEADQUARTERS MOUNT PLEASANT, NEW YORK CONTRACT CRO-624		DATE: MAY 2023
			SCALE:
TION			SHEET NO:
			49 OF No. 121
	STRUCTURAL	DRAWING NO.	
	DEMOLITION SECTIONS		DS-300

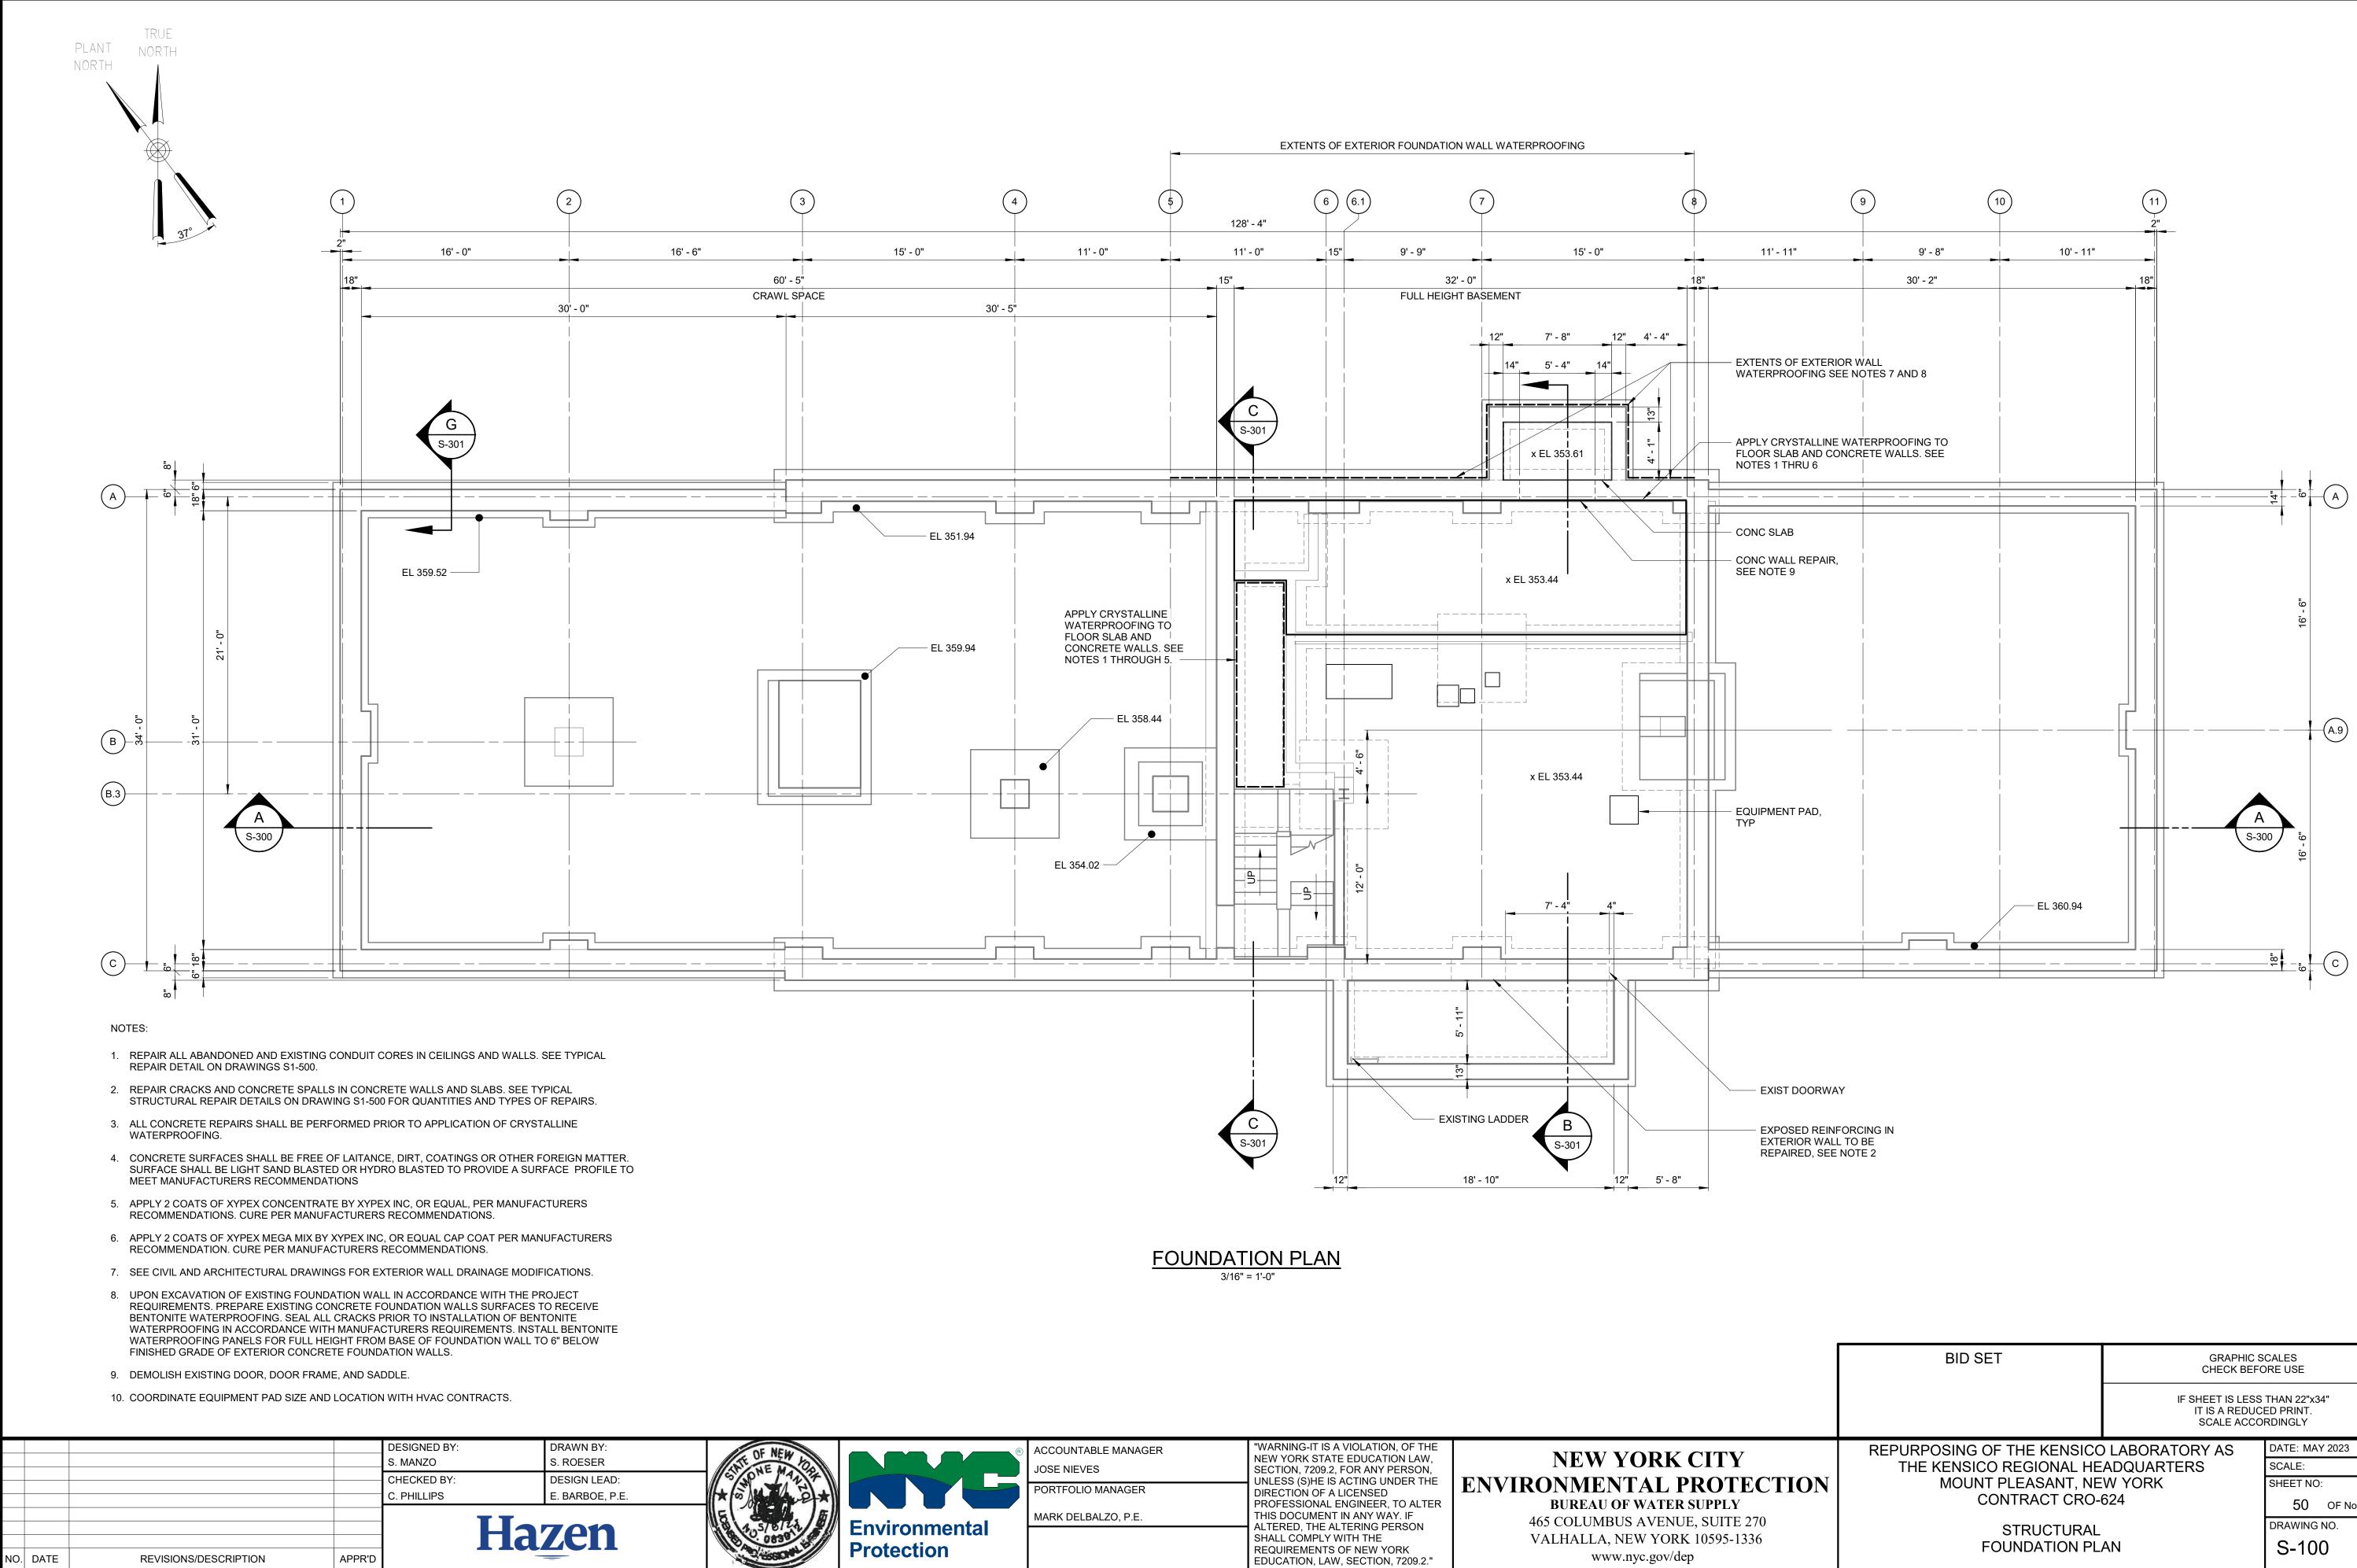EL 353.44



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TION	THE KENSICO REGIONAL HEADQUARTERS MOUNT PLEASANT, NEW YORK CONTRACT CRO-624		DATE: MAY 2023 SCALE: SHEET NO: <b>50</b> OF No. <b>121</b> DRAWING NO.	
	FOUNDATION PLAN		S-100	

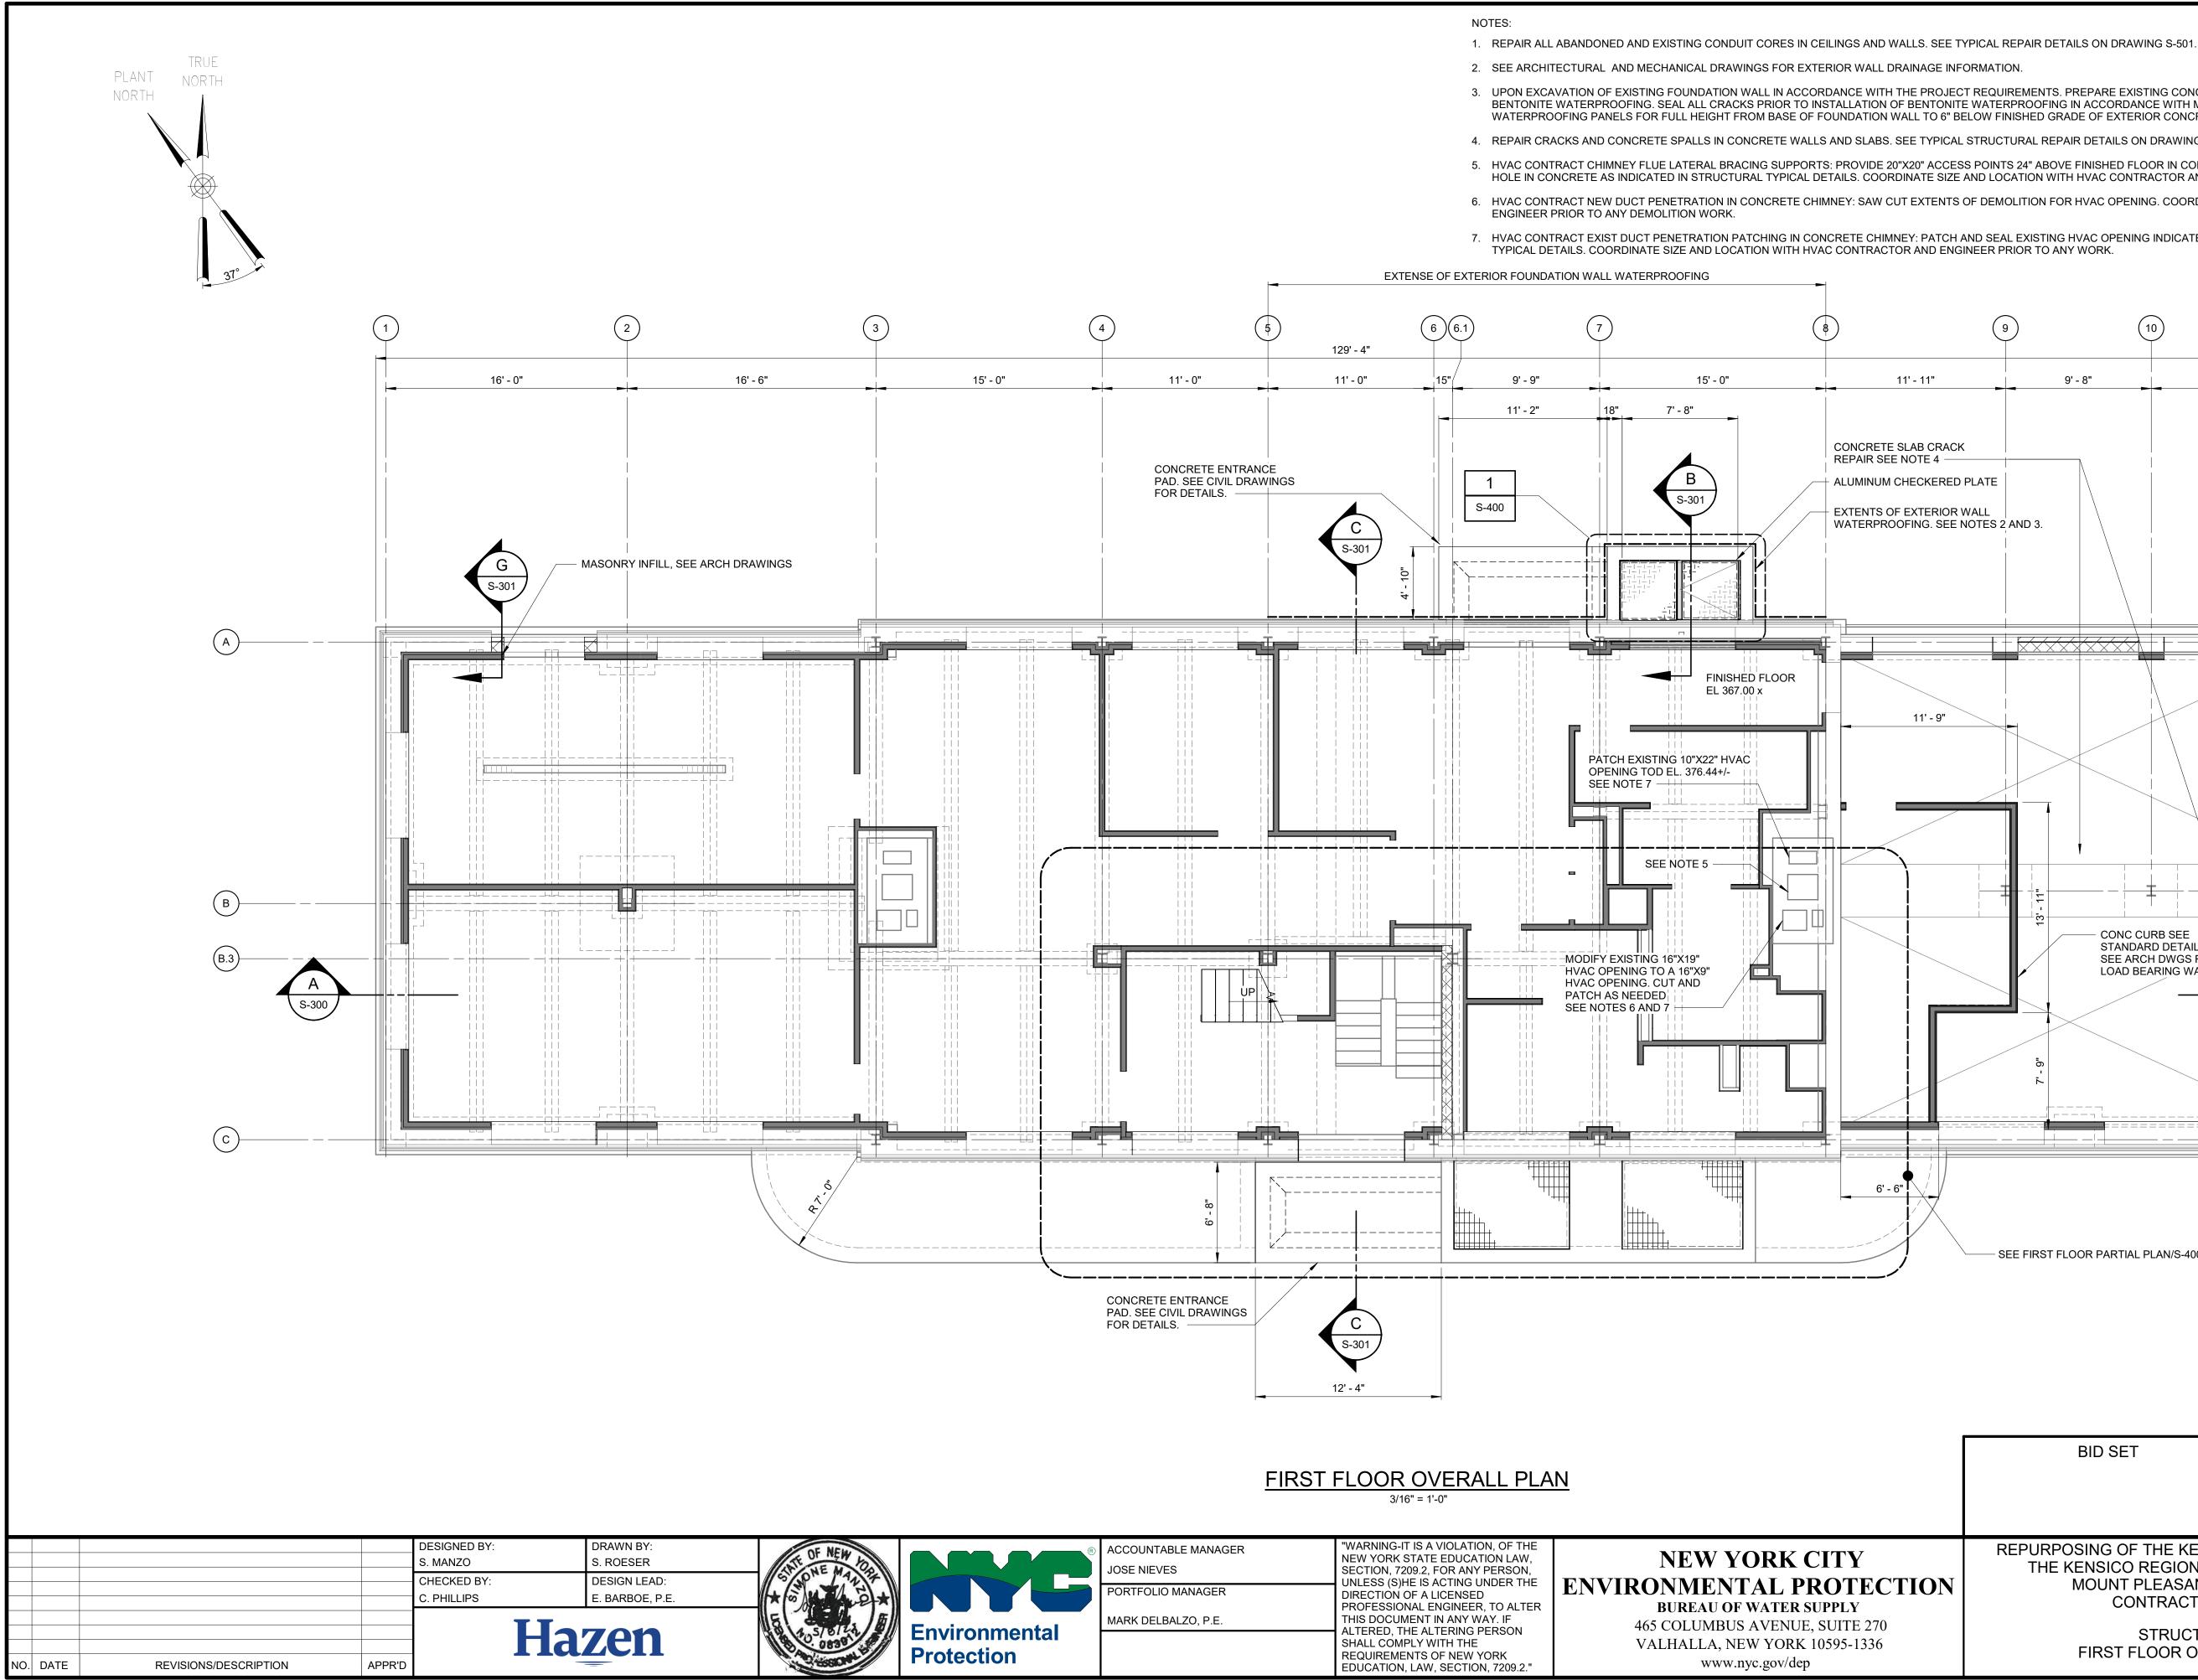



- 2. SEE ARCHITECTURAL AND MECHANICAL DRAWINGS FOR EXTERIOR WALL DRAINAGE INFORMATION.

- 6. HVAC CONTRACT NEW DUCT PENETRATION IN CONCRETE CHIMNEY: SAW CUT EXTENTS OF DEMOLITION FOR HVAC OPENING. COORDINATE SIZE AND LOCATION WITH HVAC CONTRACTOR AND

- TYPICAL DETAILS. COORDINATE SIZE AND LOCATION WITH HVAC CONTRACTOR AND ENGINEER PRIOR TO ANY WORK.



R	ACCOUNTABLE MANAGER
	JOSE NIEVES
	PORTFOLIO MANAGER
	MARK DELBALZO, P.E.

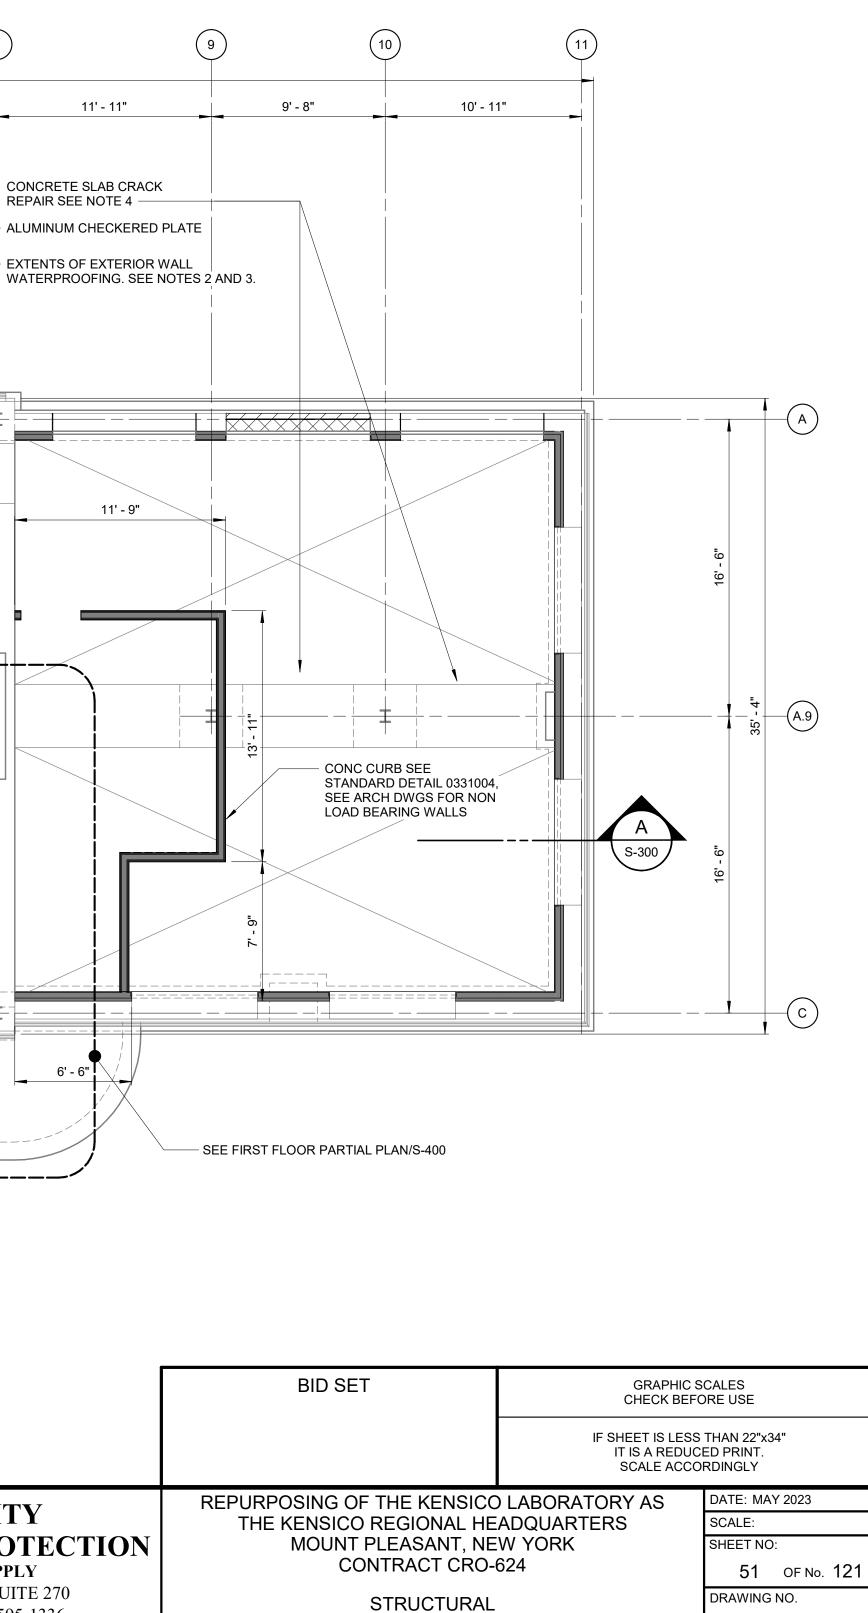
**NEW YORK CITY ENVIRONMENTAL PROTECTION** 465 COLUMBUS AVENUE, SUITE 270 VALHALLA, NEW YORK 10595-1336

3. UPON EXCAVATION OF EXISTING FOUNDATION WALL IN ACCORDANCE WITH THE PROJECT REQUIREMENTS. PREPARE EXISTING CONCRETE FOUNDATION WALLS SURFACES TO RECEIVE BENTONITE WATERPROOFING. SEAL ALL CRACKS PRIOR TO INSTALLATION OF BENTONITE WATERPROOFING IN ACCORDANCE WITH MANUFACTURERS REQUIREMENTS . INSTALL BENTONITE WATERPROOFING PANELS FOR FULL HEIGHT FROM BASE OF FOUNDATION WALL TO 6" BELOW FINISHED GRADE OF EXTERIOR CONCRETE FOUNDATION WALLS.

4. REPAIR CRACKS AND CONCRETE SPALLS IN CONCRETE WALLS AND SLABS. SEE TYPICAL STRUCTURAL REPAIR DETAILS ON DRAWING S1-500 FOR QUANTITIES AND TYPES OF REPAIRS.


5. HVAC CONTRACT CHIMNEY FLUE LATERAL BRACING SUPPORTS: PROVIDE 20"X20" ACCESS POINTS 24" ABOVE FINISHED FLOOR IN CONCRETE CHIMNEY WALL TO INSTALL FLUE BRACING. REPAIR HOLE IN CONCRETE AS INDICATED IN STRUCTURAL TYPICAL DETAILS. COORDINATE SIZE AND LOCATION WITH HVAC CONTRACTOR AND ENGINEER PRIOR TO ANY DEMOLITION WORK.

7. HVAC CONTRACT EXIST DUCT PENETRATION PATCHING IN CONCRETE CHIMNEY: PATCH AND SEAL EXISTING HVAC OPENING INDICATED. REPAIR HOLE IN CONCRETE AS INDICATED IN STRUCTURAL




FIRST FLOOR OVERALL PLAN

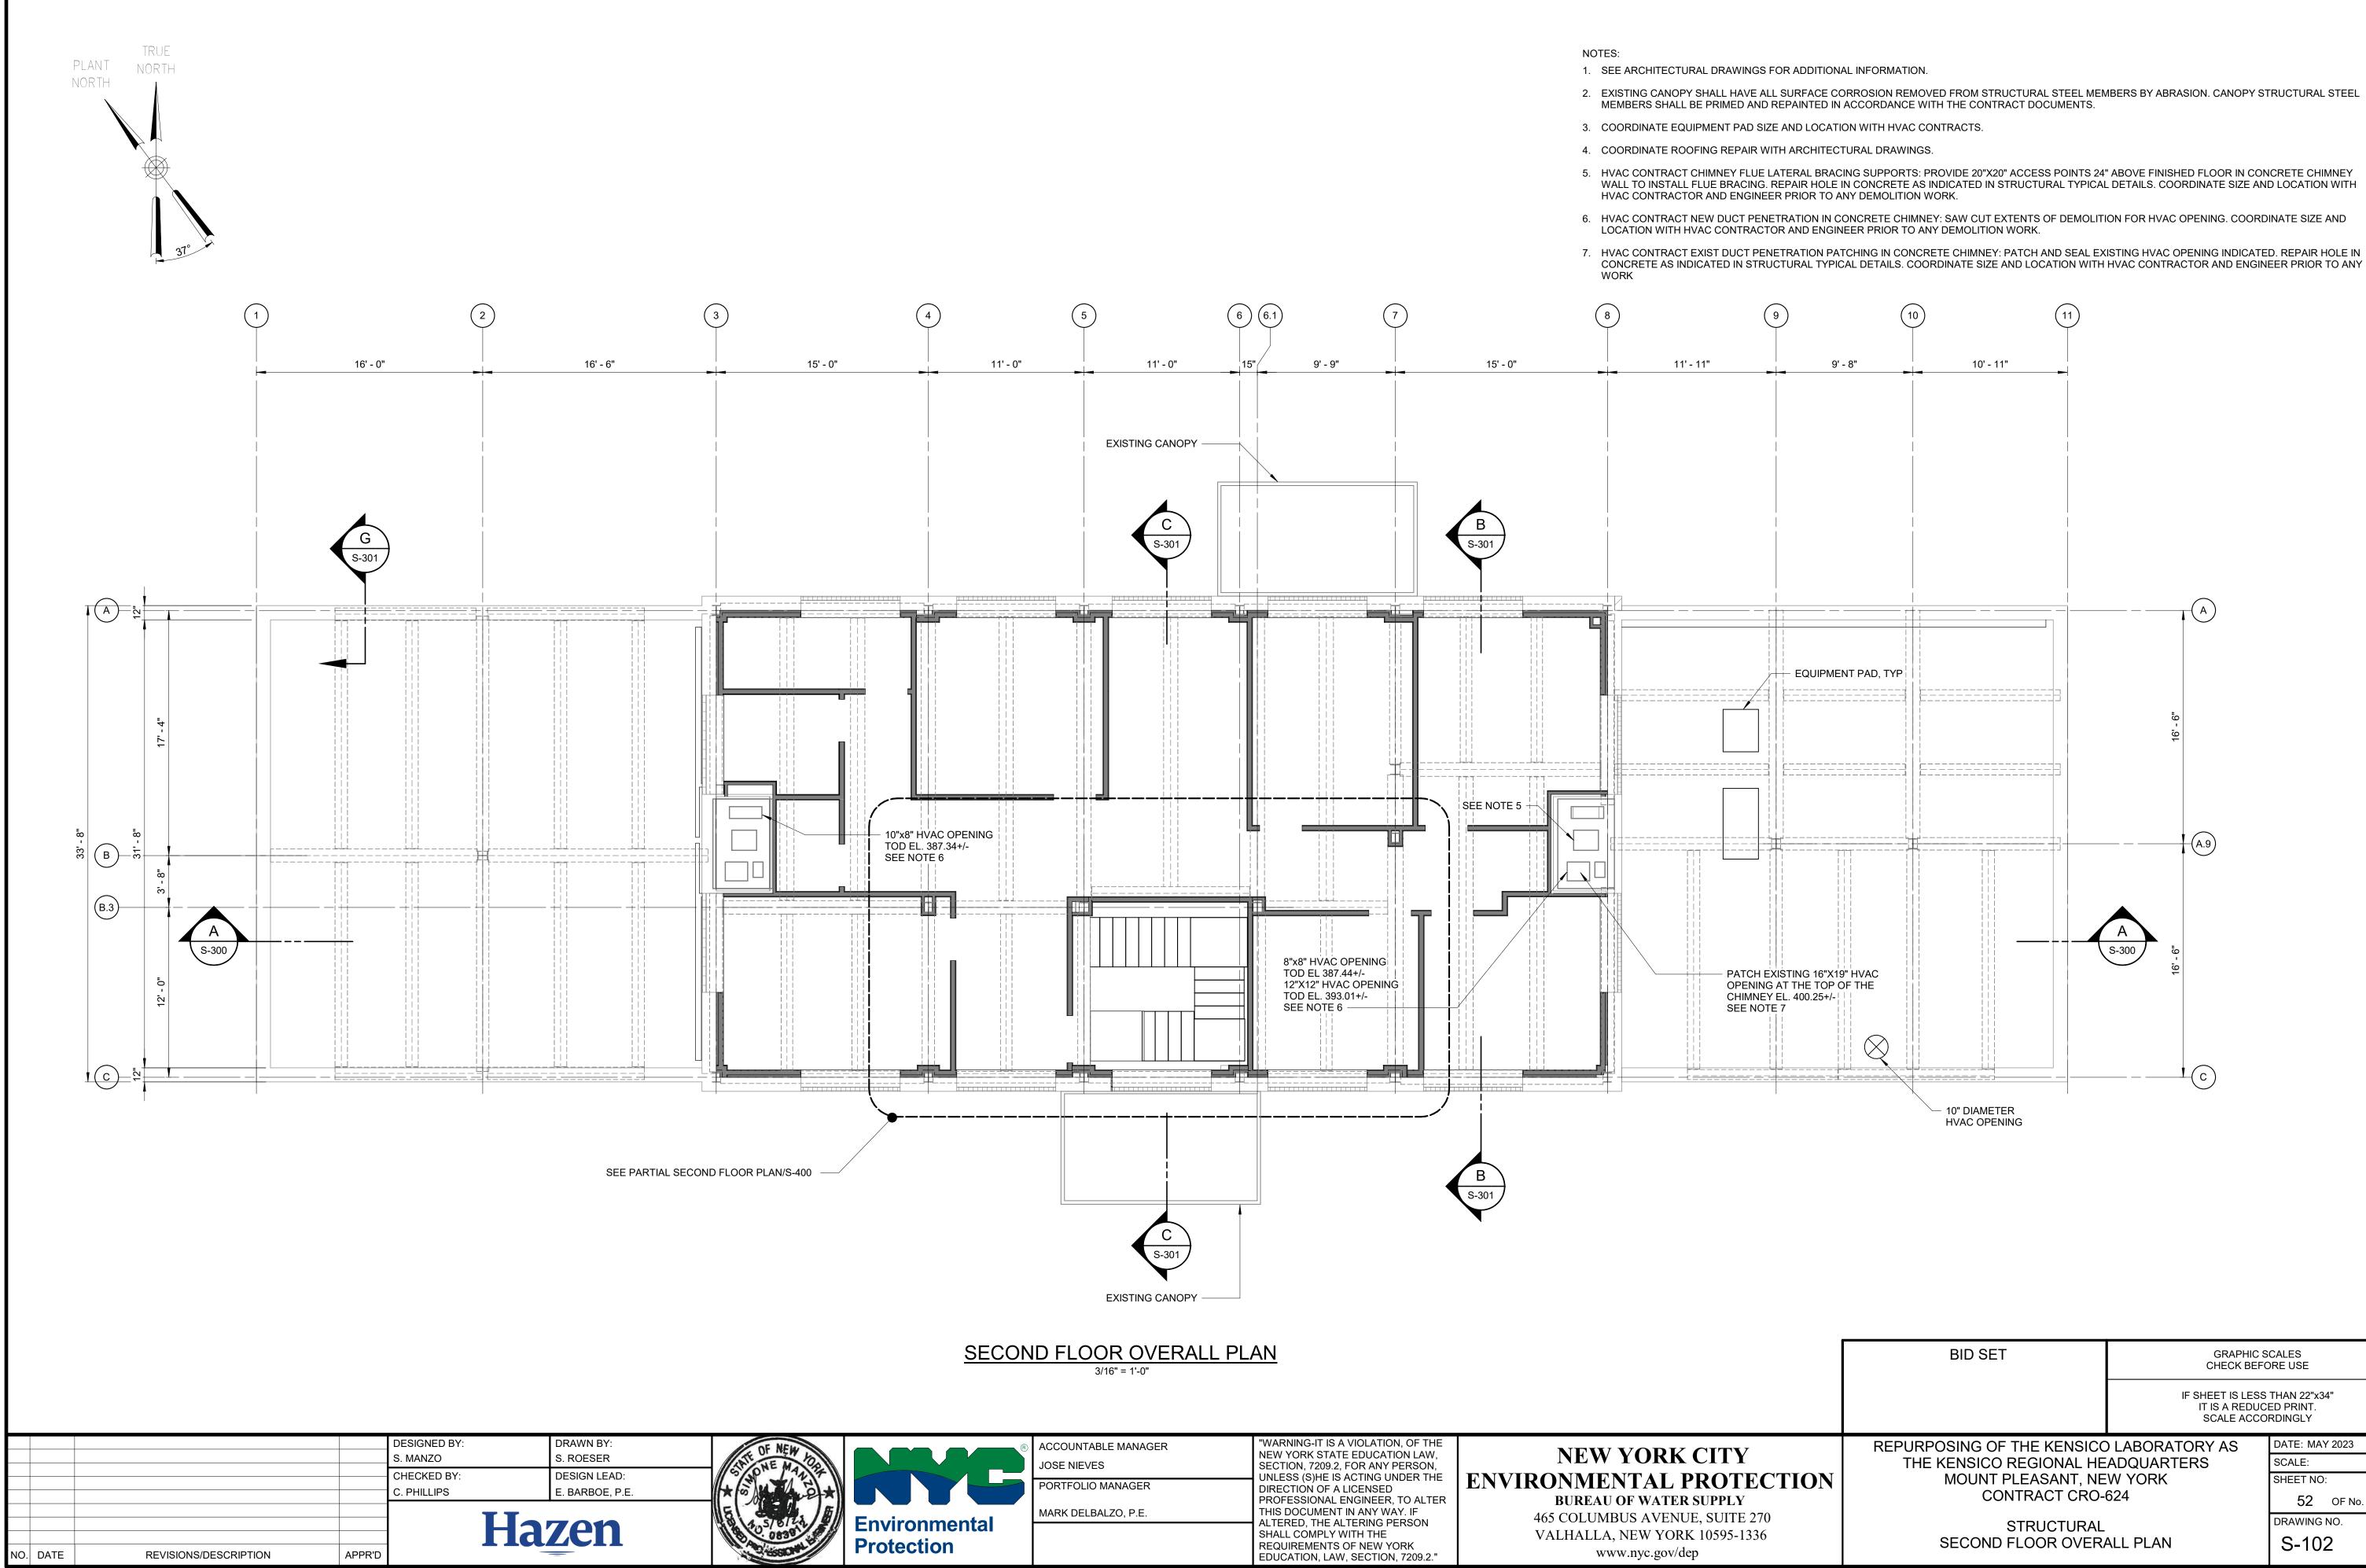
S-101




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TION	MOUNT PLEASANT, NE CONTRACT CRO-	SHEET NO: 52 OF №. 121		
	STRUCTURAL SECOND FLOOR OVERALL PLAN		drawing no. S-102	

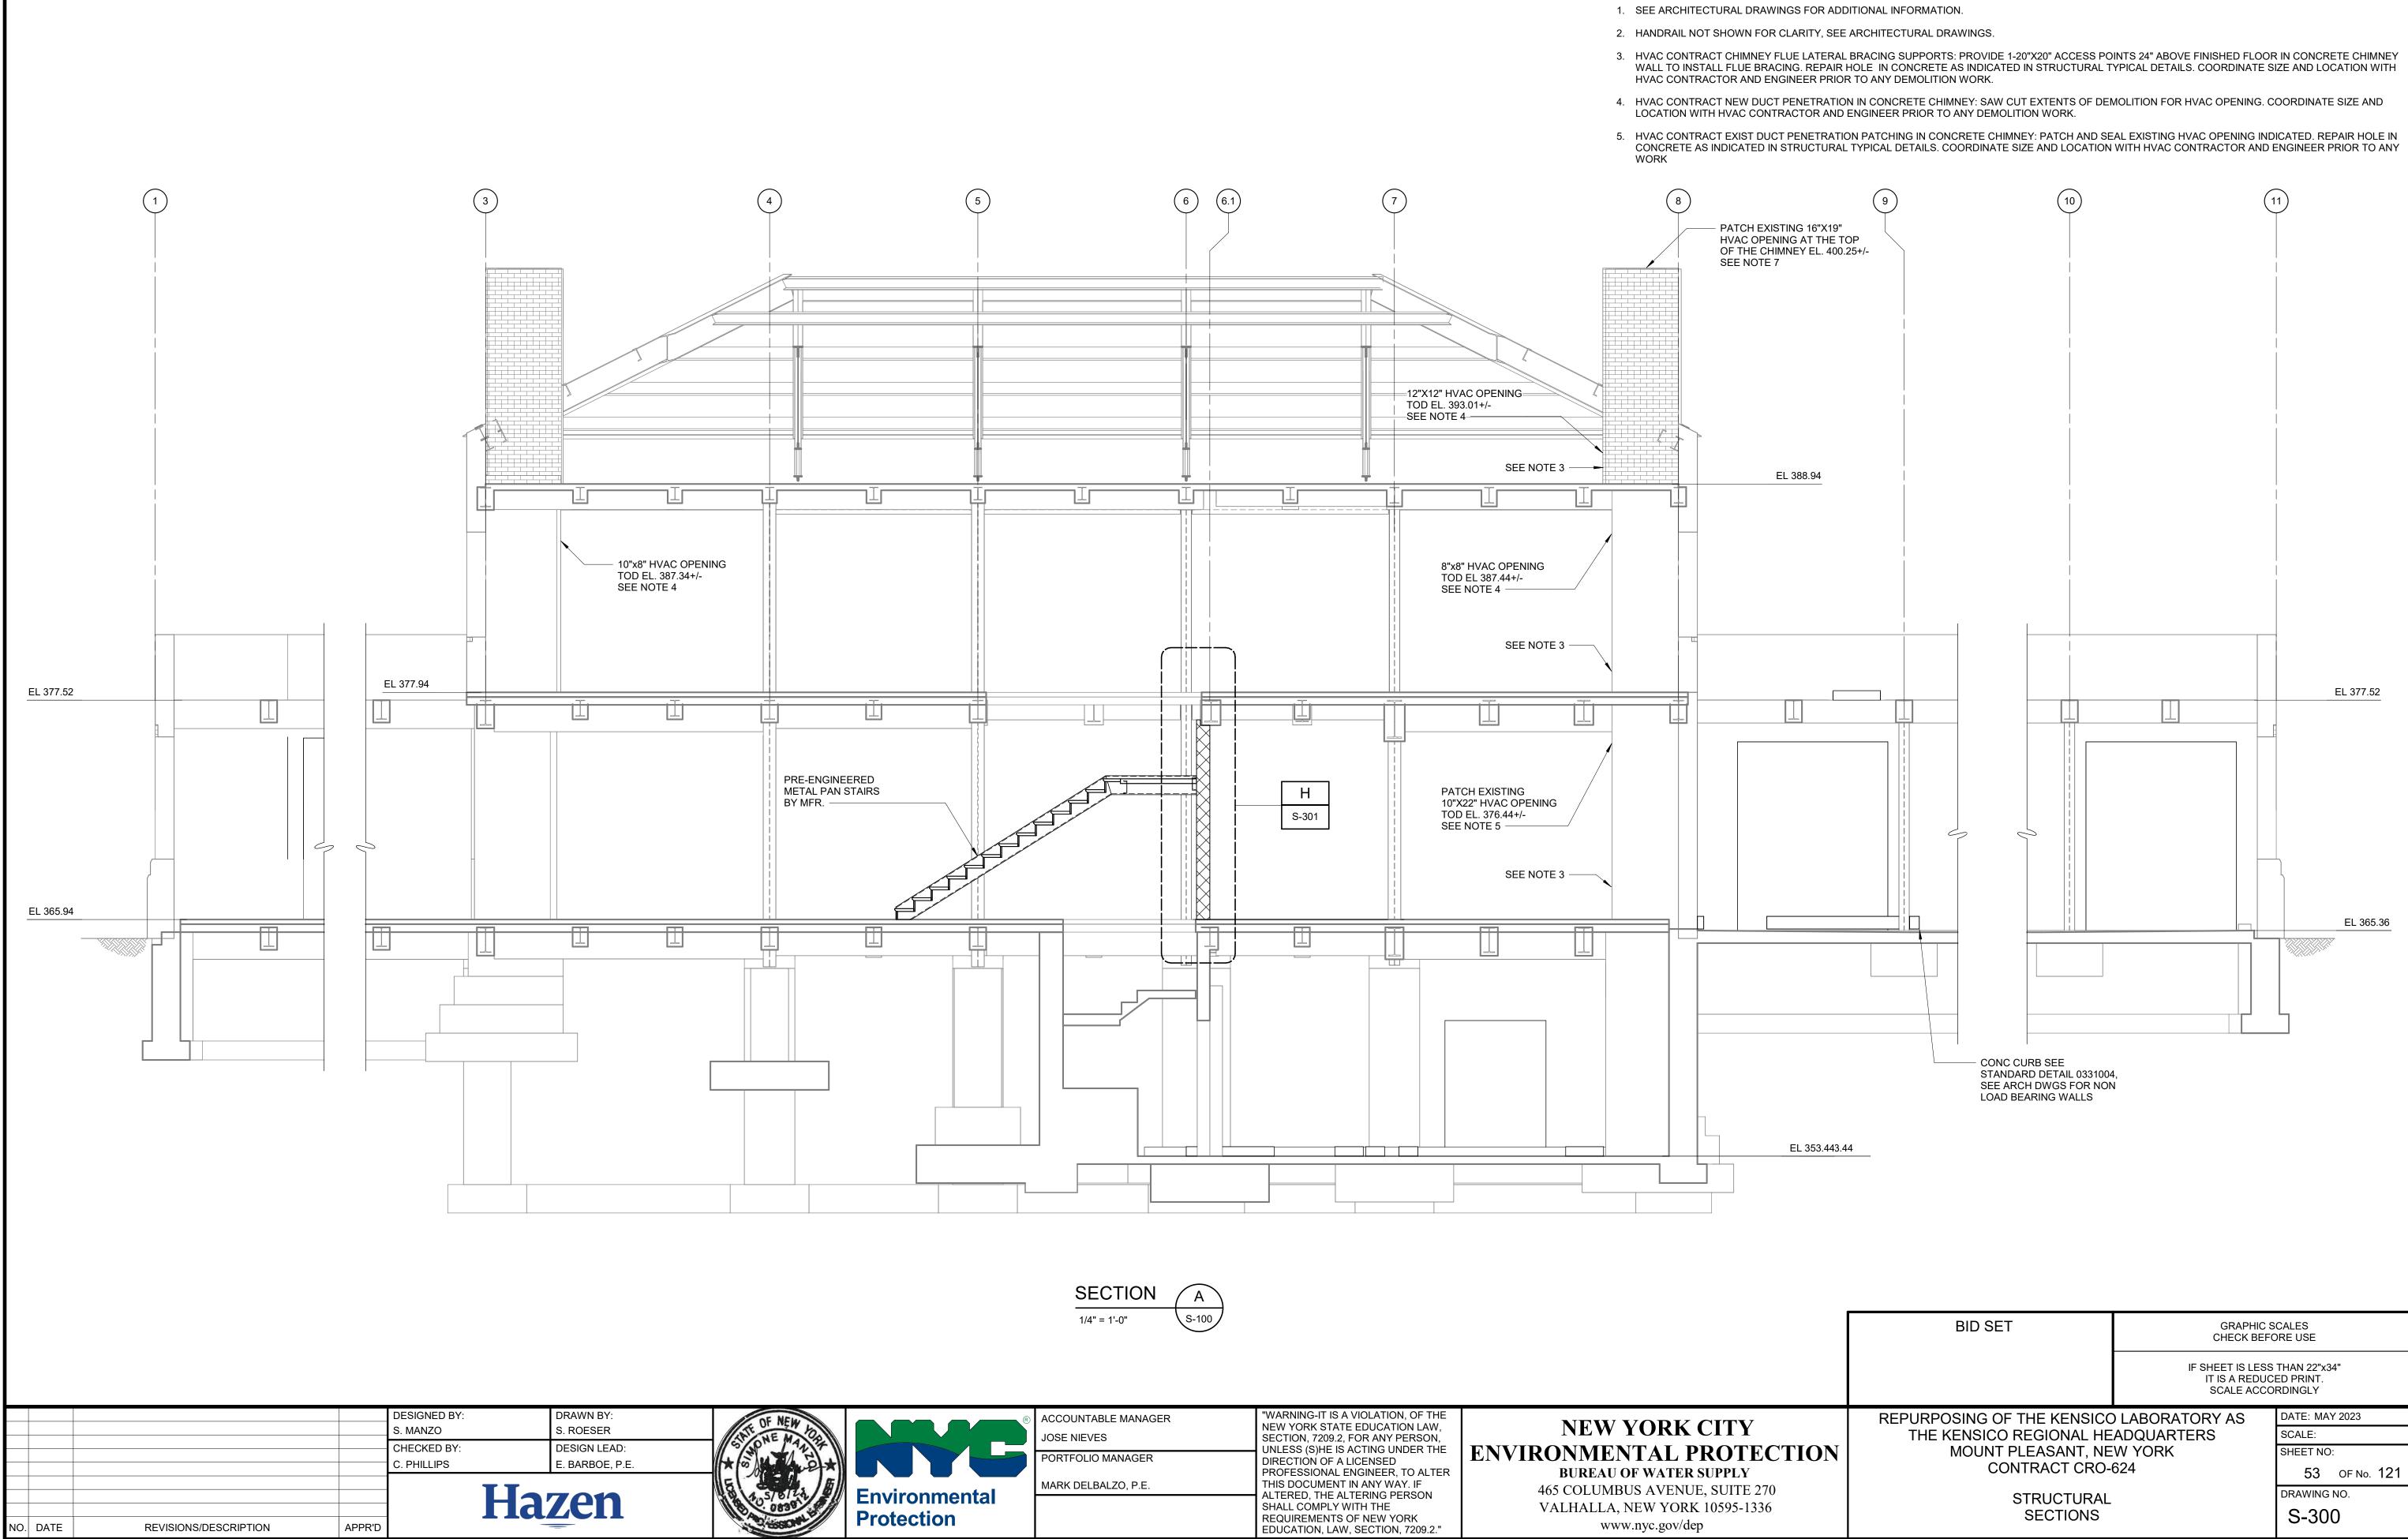

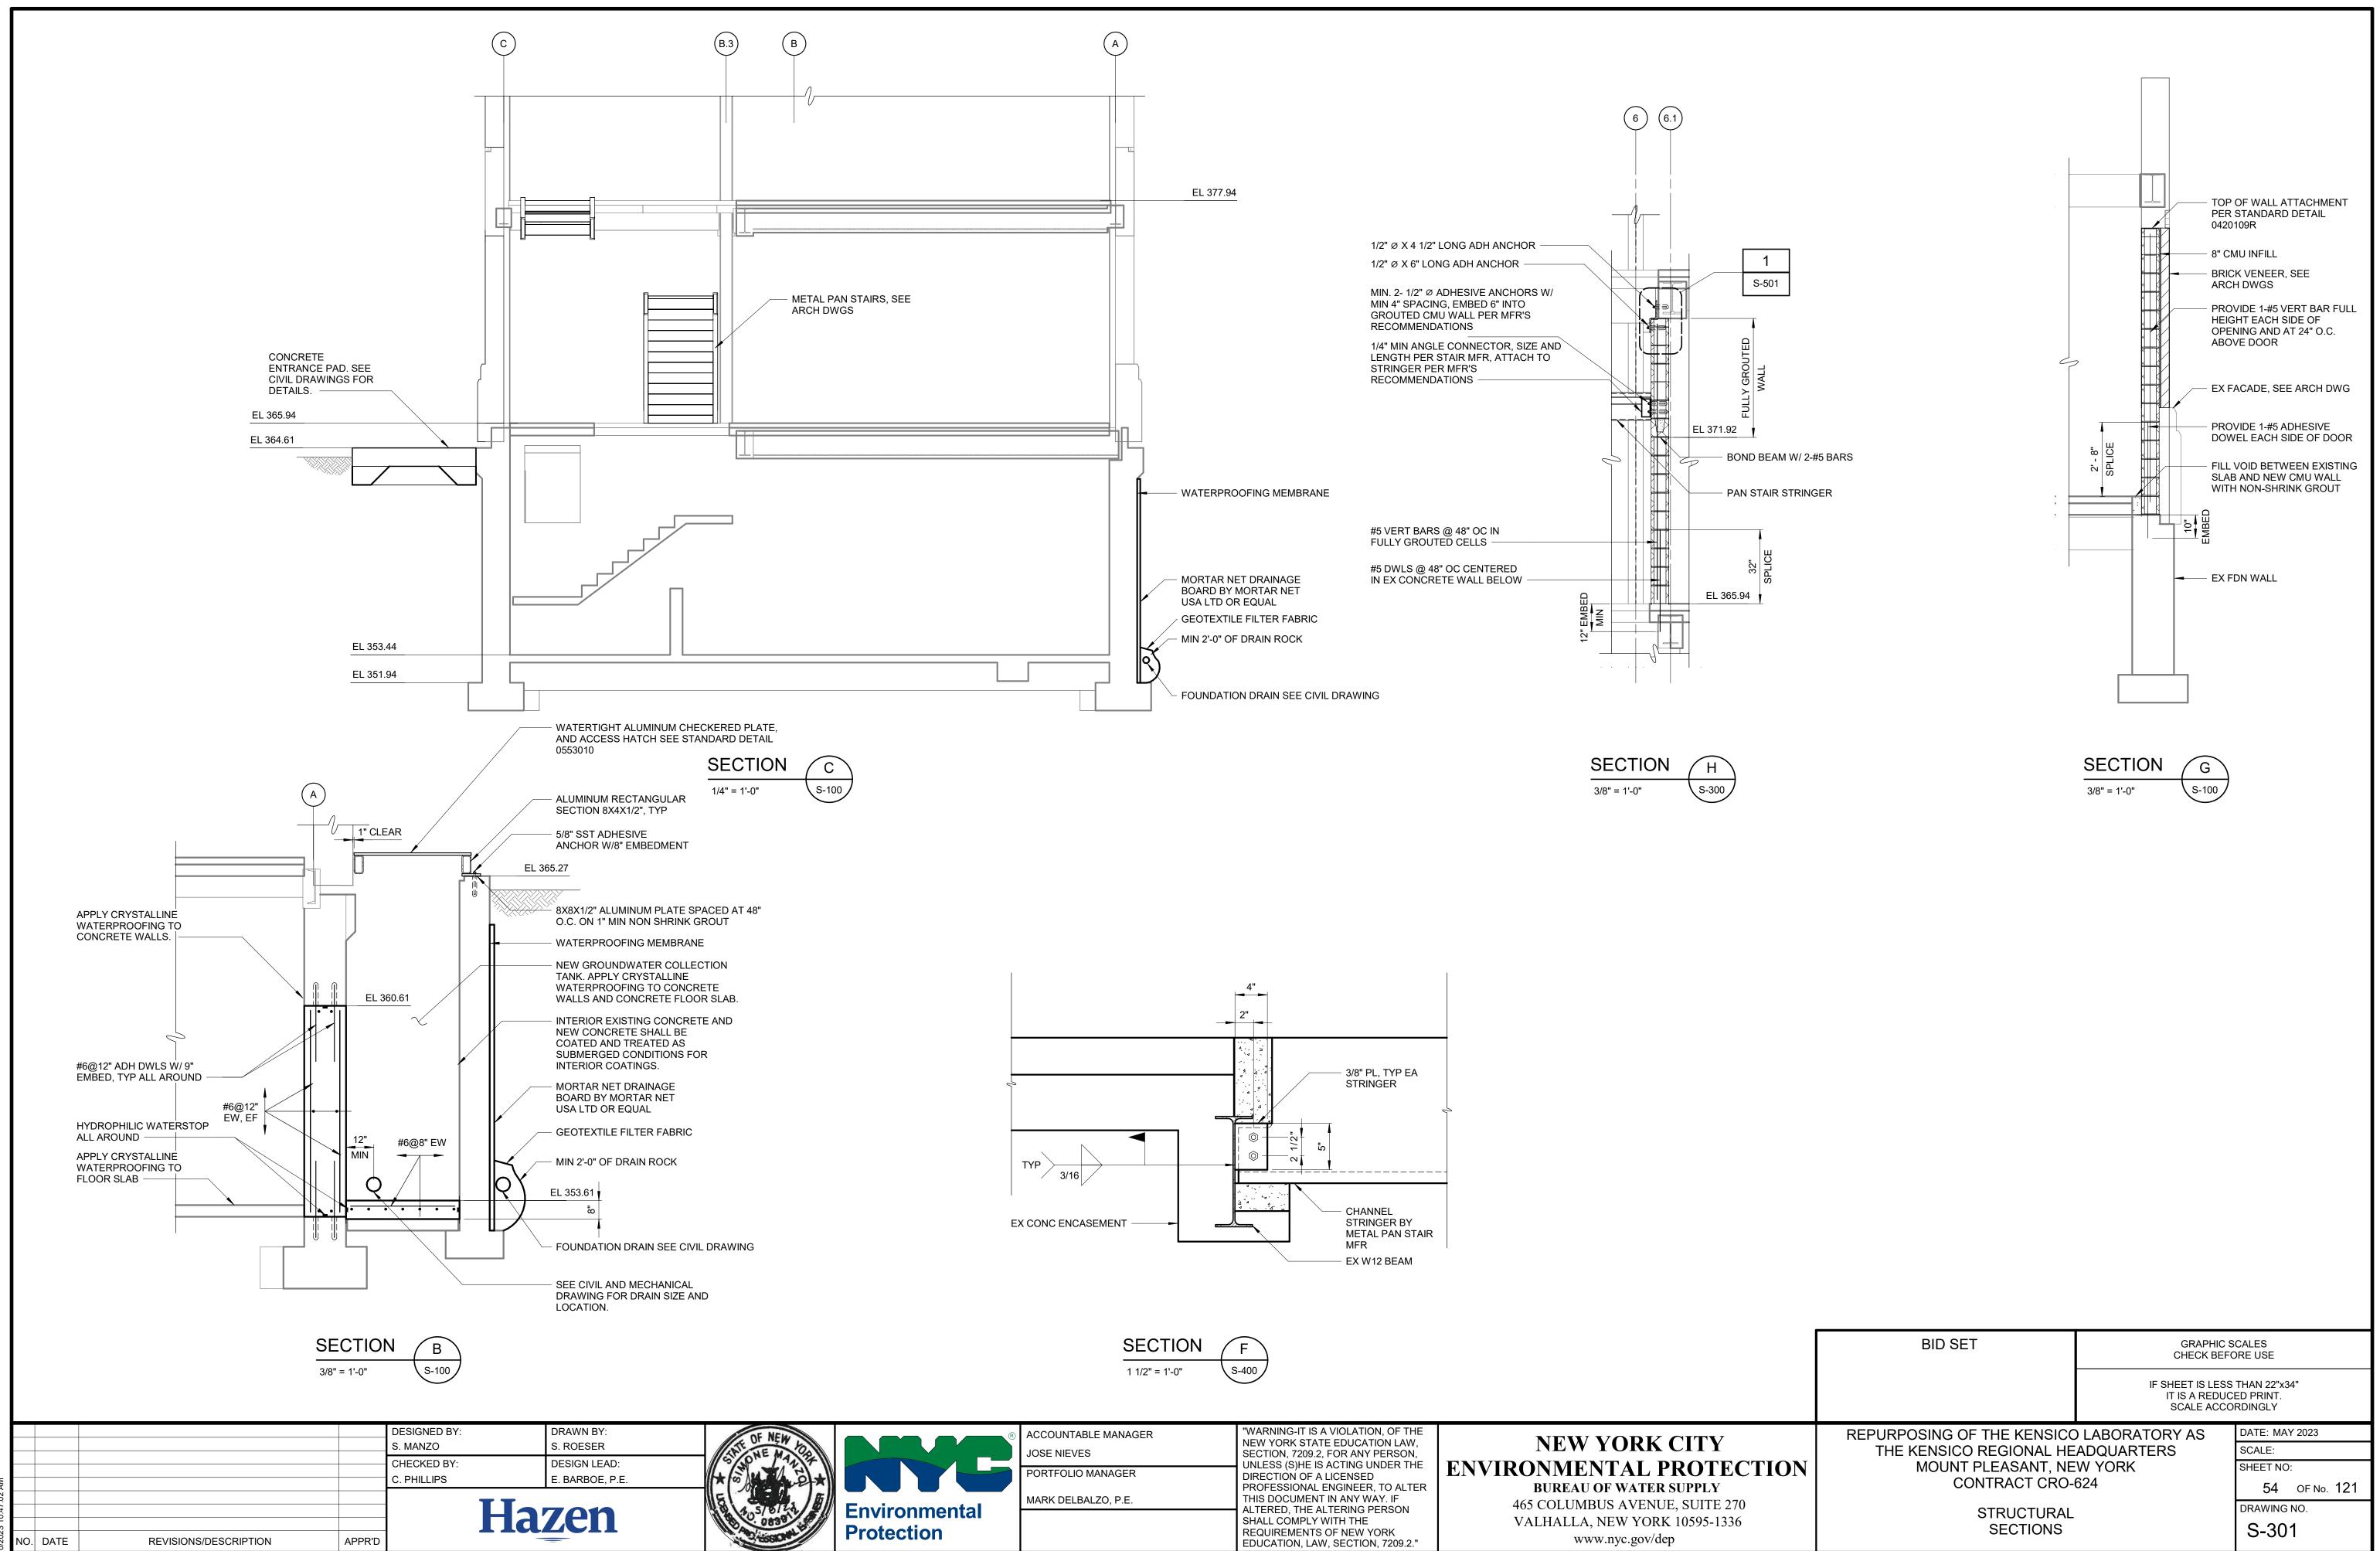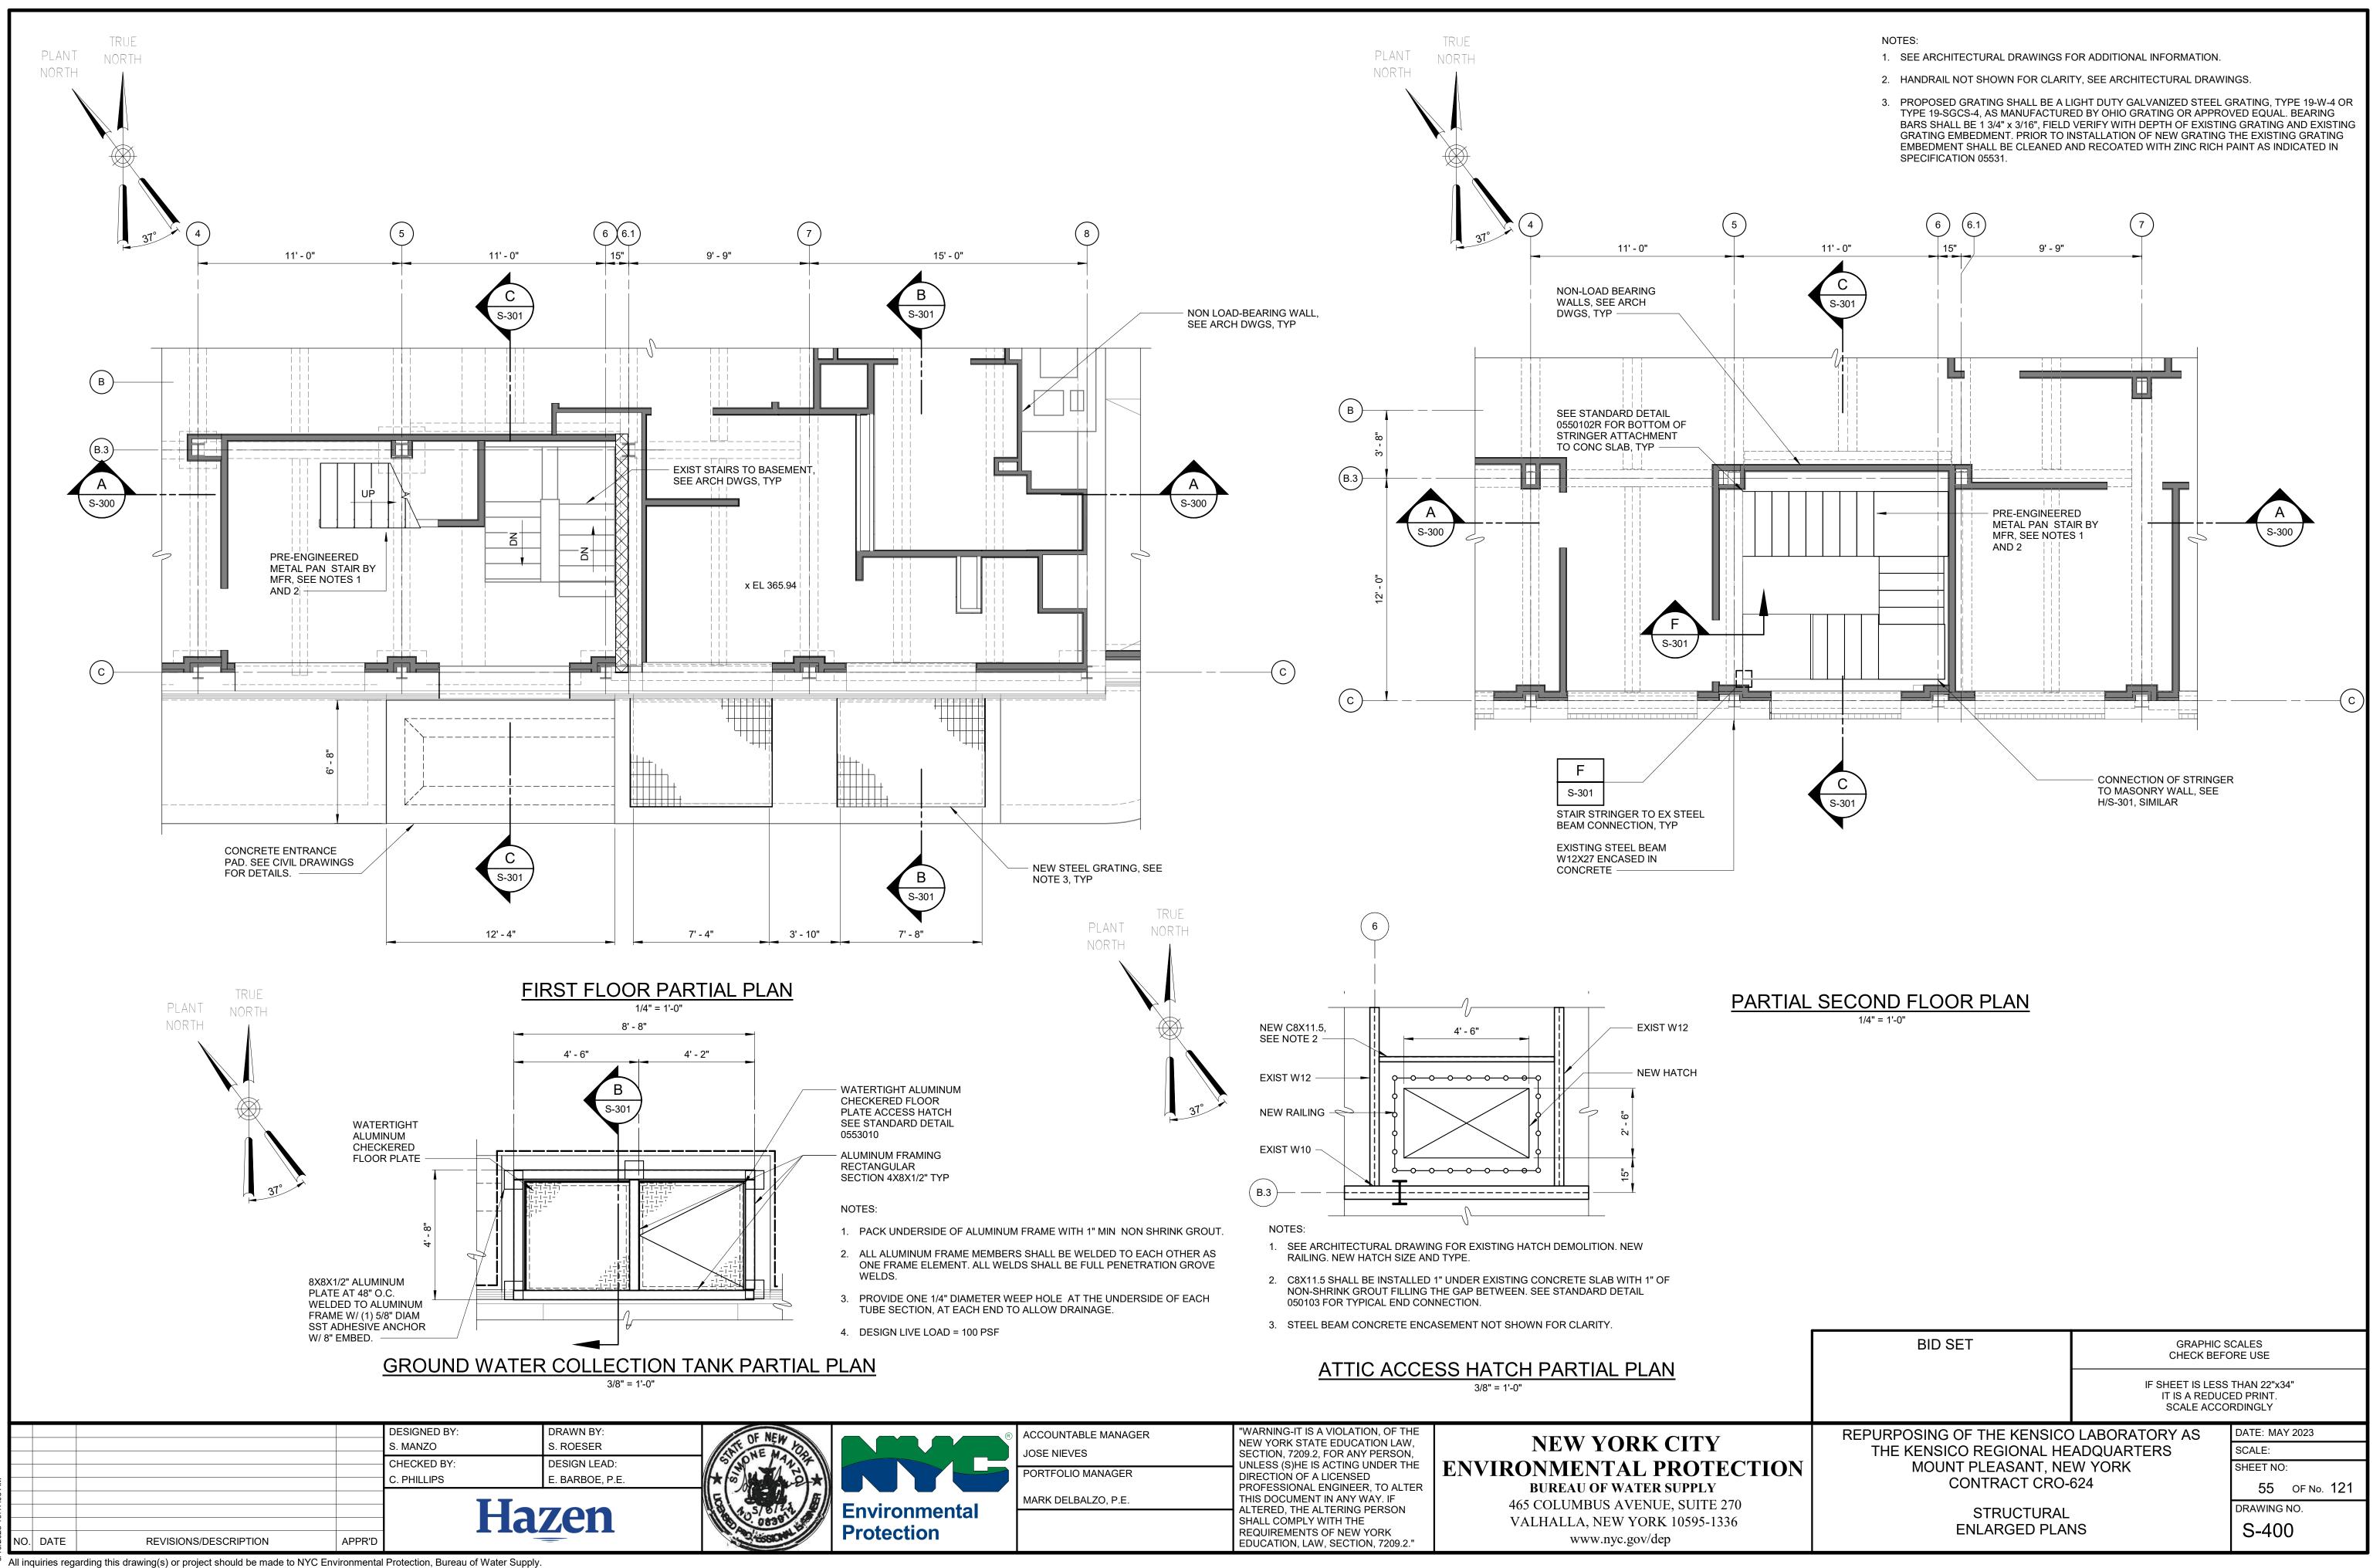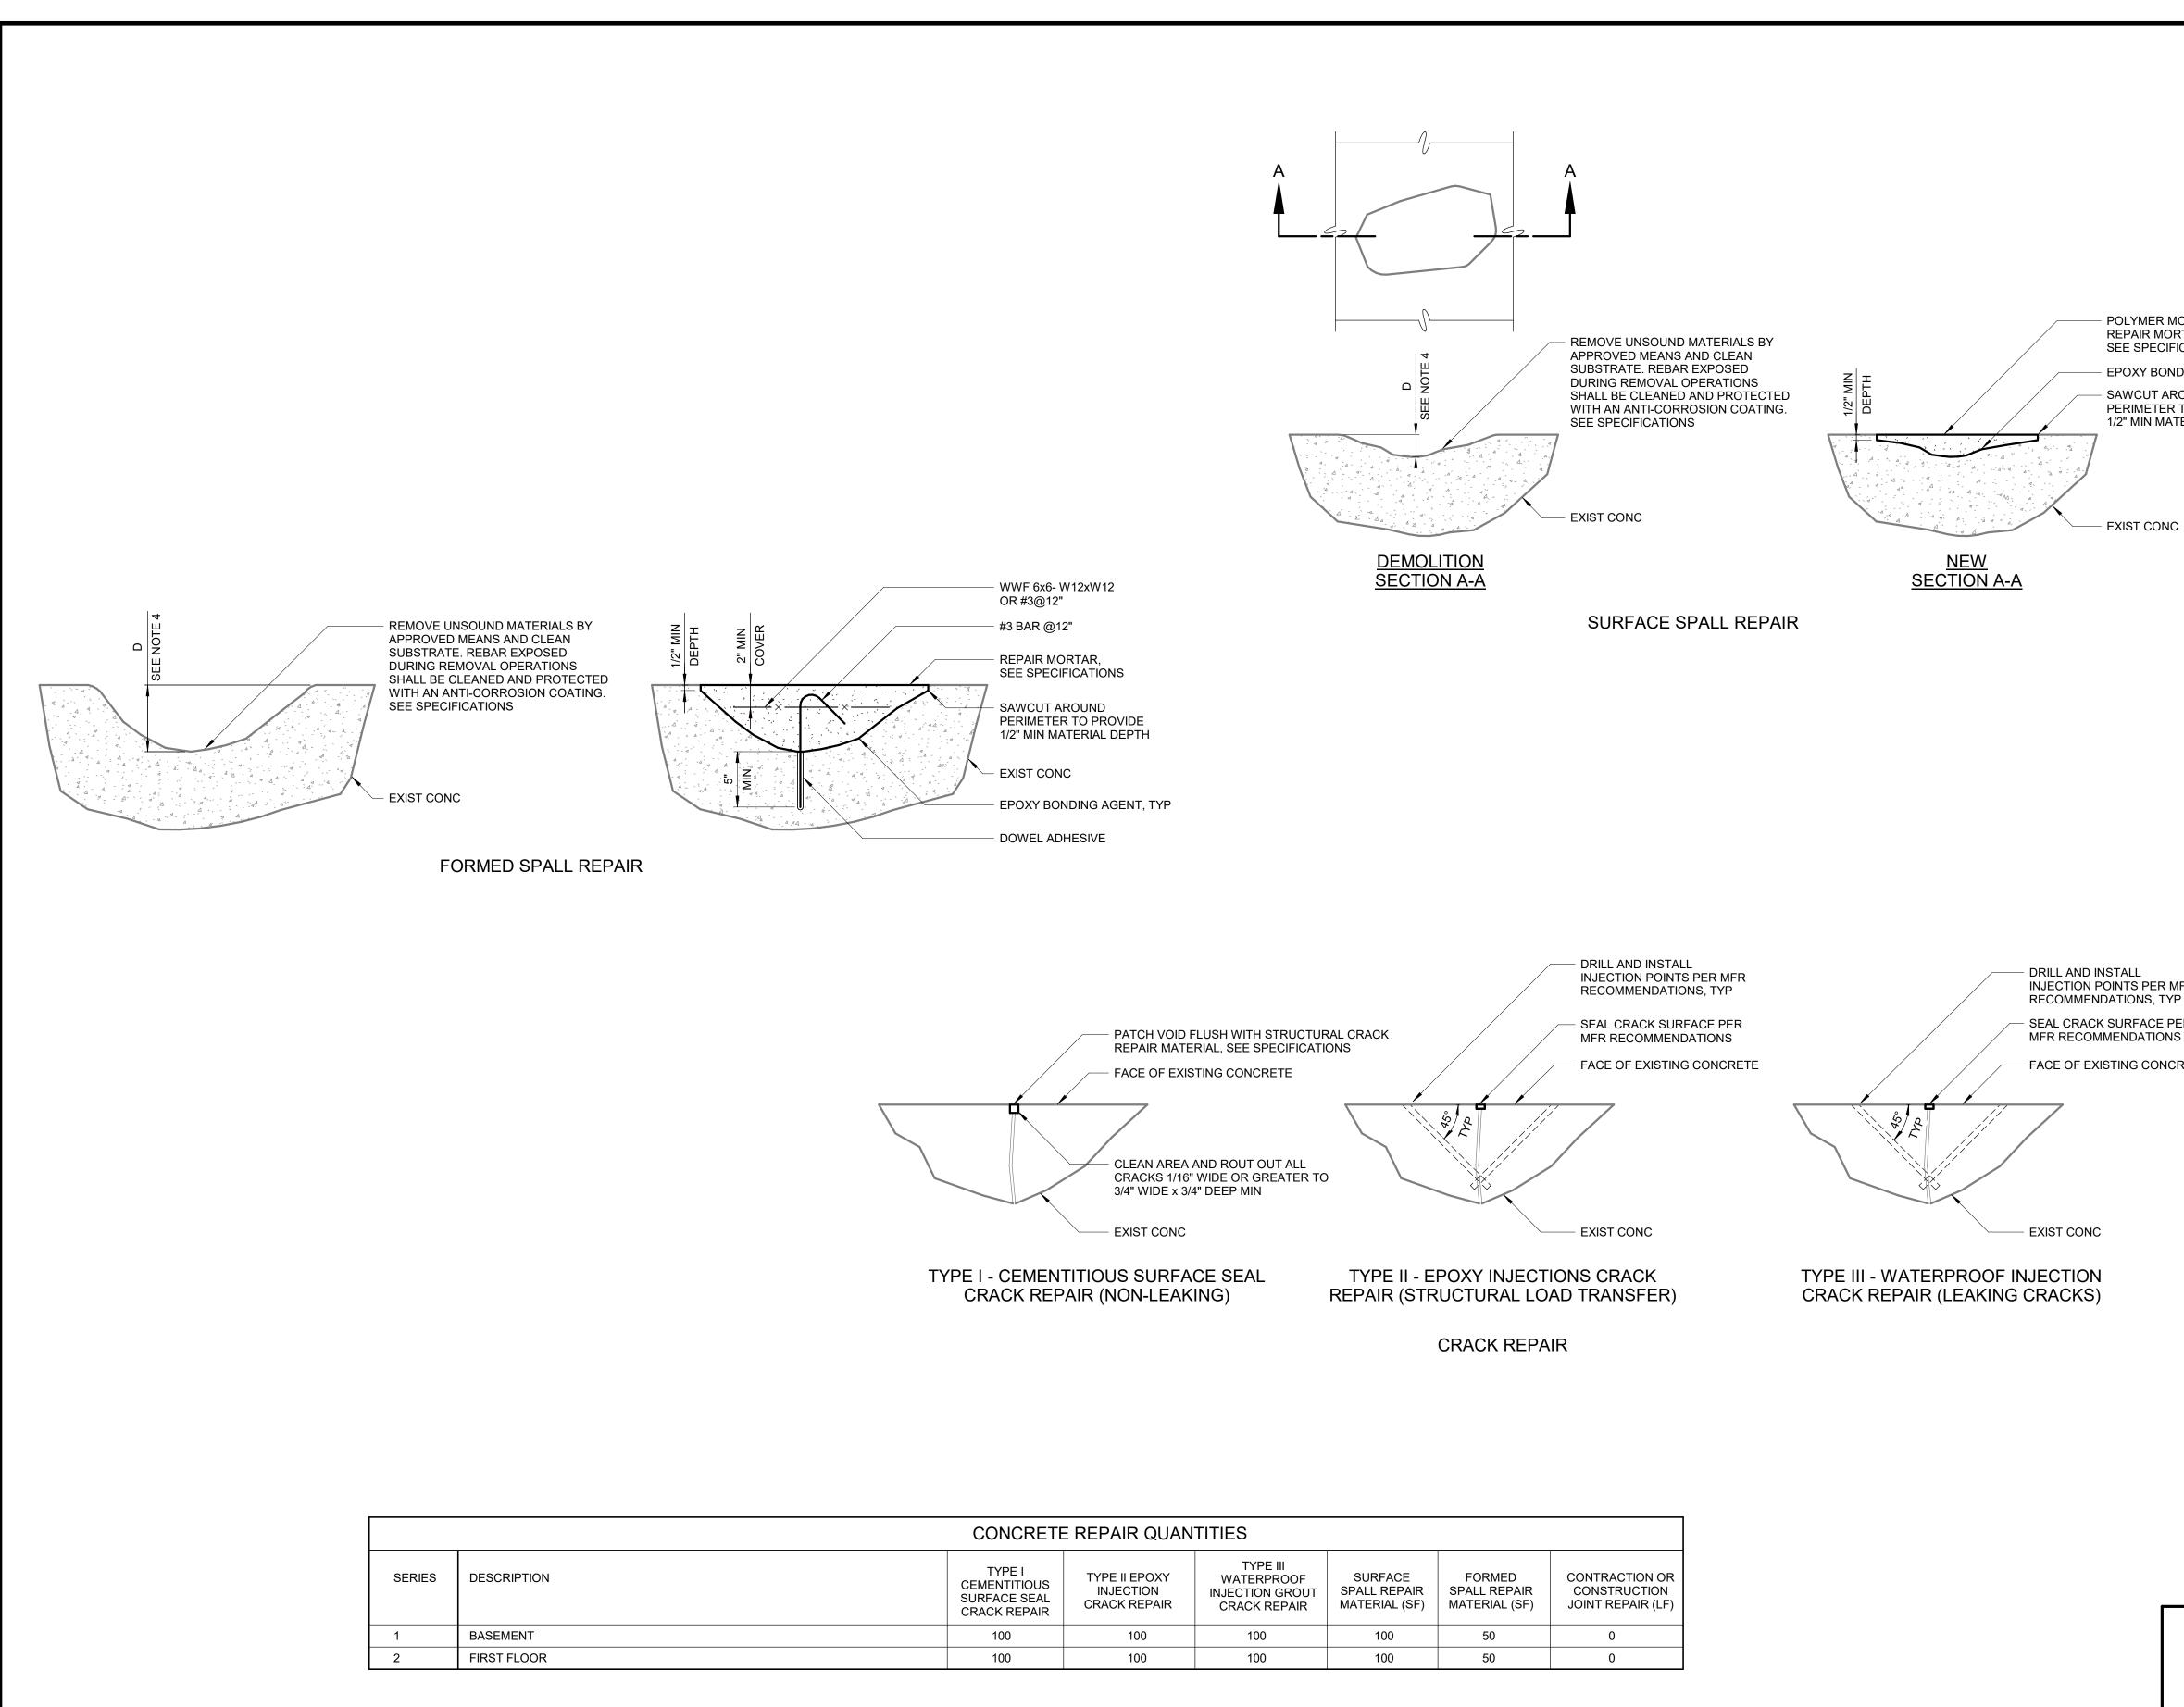
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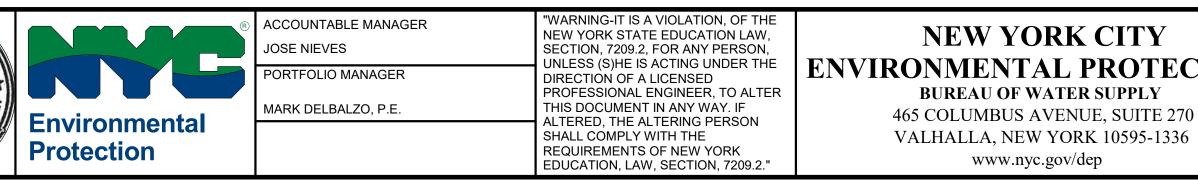
D	ACCOUNTABLE MANAGER
	JOSE NIEVES
	PORTFOLIO MANAGER
	MARK DELBALZO, P.E.



			DESIGNED BY: S. MANZO	DRAWN BY: S. ROESER	ATE OF NEW JOS	
			CHECKED BY: C. PHILLIPS	DESIGN LEAD: E. BARBOE, P.E.		
			F	lazen	5 10 S/ 61 - 1 - 5	
NO. DA	REVISIONS/DESCRIPTION	APPR'D			A CONTRACTOR	
Il inquirie	I inquiries regarding this drawing(s) or project should be made to NYC Environmental Protection, Bureau of Water Supply.					

Auto 5/10

CONCRETE REPAIR QUANTITIES					
CEMENTITIOUS INJECTION INJECTION GROUT SPALL REPAIR SPALL REPAIR CONSTRUCTION					CONTRACTION OR CONSTRUCTION JOINT REPAIR (LF)
100	100	100	100	50	0
100	100	100	100	50	0



NOTES:

- 1. CONCRETE REPAIR WORK SHALL BE PERFORMED PER SPECIFICATION SECTION 03931 AND THE DETAILS ON THIS DRAWING.
- 2. FOR EXISTING STRUCTURES LISTED IN THE TABLE: THE CONTRACTOR, IN CONJUNCTION WITH THE ENGINEER. SHALL DETERMINE THE EXTENT OF CRACKED OR DETERIORATED CONCRETE TO BE REHABILITATED AND/OR RESURFACED. FOR EACH STRUCTURE A SUMMARY OF WORK SHALL BE SUBMITTED TO THE ENGINEER PRIOR TO COMMENCEMENT OF THE WORK.
- 3. SPALLED AND/OR DETERIORATED AREAS WHERE DEPTH "D" TO BE REPAIRED IS LESS THAN OR EQUAL TO 4" SHALL BE REPAIRED PER DETAIL 2. AREAS WHERE DEPTH "D" IS GREATER THAN 4" SHALL BE REPAIRED PER DETAIL 4.
- 4. FOR PAYMENT PURPOSES, THE WIDTH OF CONTRACTION OR CONSTRUCTION JOINT REPAIR SHALL BE LIMITED TO 4 INCHES MAXIMUM MEASURED EITHER WAY FROM THE CENTERLINE OF THE JOINT. DETERIORATED CONCRETE AT A JOINT WIDER THAN 4 INCHES SHALL BE PAID AS A SPALL REPAIR.
- 5. THE CONTRACT LUMP SUM BID PRICE SHALL INCLUDE ALL WORK RELATING TO CONCRETE REPAIRS AS INDICATED HEREIN AND SPECIFIED IN SPECIFICATION SECTION 03931 - CONCRETE REPAIRS. THE LISTED QUANTITIES BY WORK ITEM ARE ESTIMATES. THE BID PRICE SHALL INCLUDE A 25 % INCREASE FOR EACH CONCRETE REPAIR WORK ITEM BASED ON ACTUAL IN-PLACE QUANTITIES. ANY QUANTITIES OF CONCRETE REPAIR WORK ITEMS EXCEEDING THE LISTED QUANTITIES PLUS 25% WILL BE NEGOTIATED AND PAID FOR BY CHANGE ORDER IN ACCORDANCE WITH THE SPECIFICATIONS AS EXTRA WORK.

POLYMER MODIFIED REPAIR MORTAR, SEE SPECIFICATIONS - EPOXY BONDING AGENT


SAWCUT AROUND PERIMETER TO PROVIDE 1/2" MIN MATERIAL DEPTH


- EXIST CONC

INJECTION POINTS PER MFR RECOMMENDATIONS, TYP SEAL CRACK SURFACE PER

- FACE OF EXISTING CONCRETE

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	STRUCTURAL REPAIR SCHEDULE AND DETAILS		drawing no. <b>S-500</b>

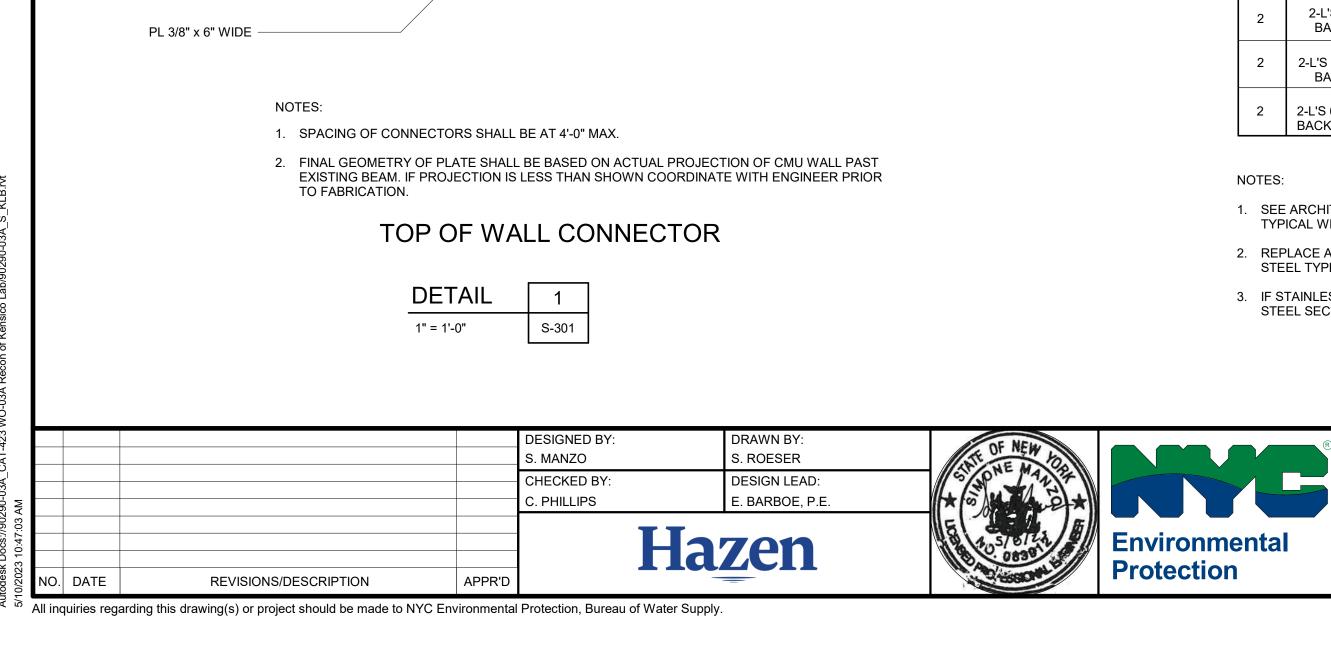


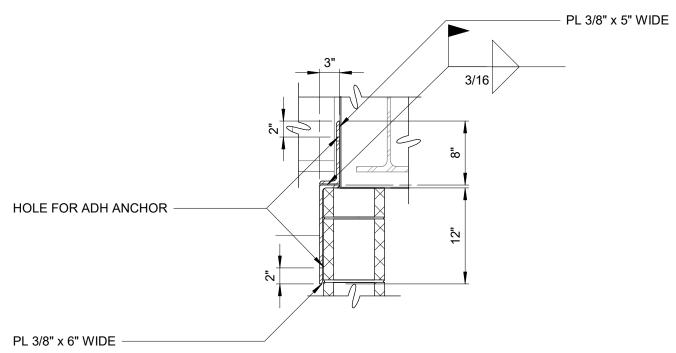

NOTES:

FROM EA. FACE.

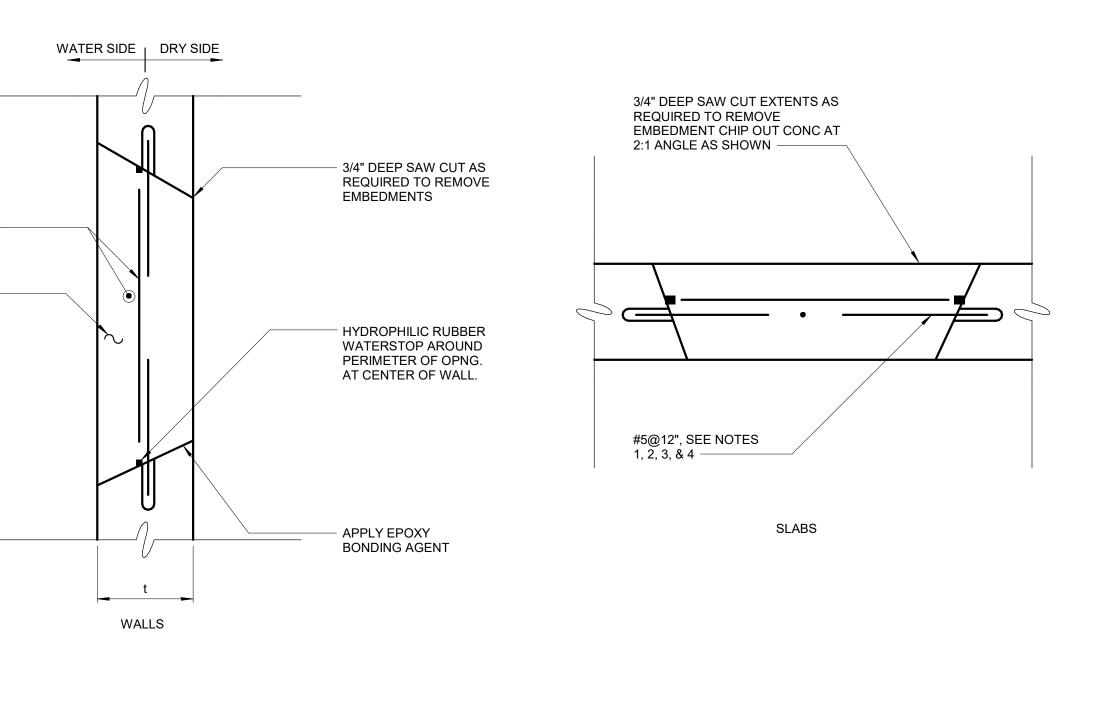DRY SIDE DRY SIDE -3/4" DEEP SAW CUT AS REQUIRED TO REMOVE EMBEDMENTS #5@12" CENTERED ON #5@12" CENTERED ON WALL, SEE NOTES 2,3, &4 WALL, SEE NOTES 2,3, &4 REPAIR MORTAR (U.O.N.) REPAIR MORTAR (U.O.N.) SEE NOTE 1 -SEE NOTE 1 -APPLY EPOXY BONDING AGENT t WALLS



1. HOLES WHICH ARE LESS THAN 12" IN THEIR LEAST DIMENSION SHALL BE FILLED WITH NON-SHRINK GROUT.

2. FOR HOLES WHICH ARE LESS THAN 8" IN THEIR LEAST DIMENSION, REINFORCING NOT REQUIRED.

3. FOR WALLS 12" OR THICKER PROVIDE TWO LAYERS OF #5@12" LOCATED 3"

4. AT HOLES LARGER THAN 8" THE REINF. SHALL BE DRILLED AND GROUTED INTO THE EXISTING CONCRETE USING APPROVED DOWEL ADHESIVE.

## PATCHING OF HOLES IN CONCRETE

NOT TO SCALE

	LINTEL SCHEDULE							
NO.	TYPE	LENGTH	LOCATION					
8	2-L'S 4X3X3/8" + L4x4x3/8 SEE LINTEL DETAIL 1 AND DETAIL 1 -A-621	8'-6"	WINDOWS 103-106 AND 111-114					
23	2-L'S 6X3-1/2X3/8" LLV BACK TO BACK SEE DETAIL 1-A-622	8'-6"	WINDOWS 201-214 AND 101, 102, 107-110, 115-117					
4	2- L'S 6X3-1/2X3/8" LLV BACK TO BACK +L6X3-1/2X3/8" LLV SEE DETAIL 2-A-622	8'-6"	WINDOWS 109, 110, 116, 117					
2	2-L'S 5X3X3/8" LLV BACK TO BACK SEE DETAIL 2-A-631	8'-6"	DOORS SF-01, SF-02 EXTERIOR					
2	2-L'S 6X3-1/2X3/8" LLV BACK TO BACK SEE DETAIL 2-A-633	9'-6"	DOORS SF-03, SF-04					
2	2-L'S 6X3-1/2X3/8" LLV BACK TO BACK SEE DETAIL 1-A-622	8'-6"	DOOR 103B					

L4X3X3/8	1/4
	1/2" Ø S 18" O.C. 18" O.C.
1/4 L4X3X3/8	L4X4X3/

LINTEL DETAIL 1

NOTE: SEE DETAIL 1-A-621

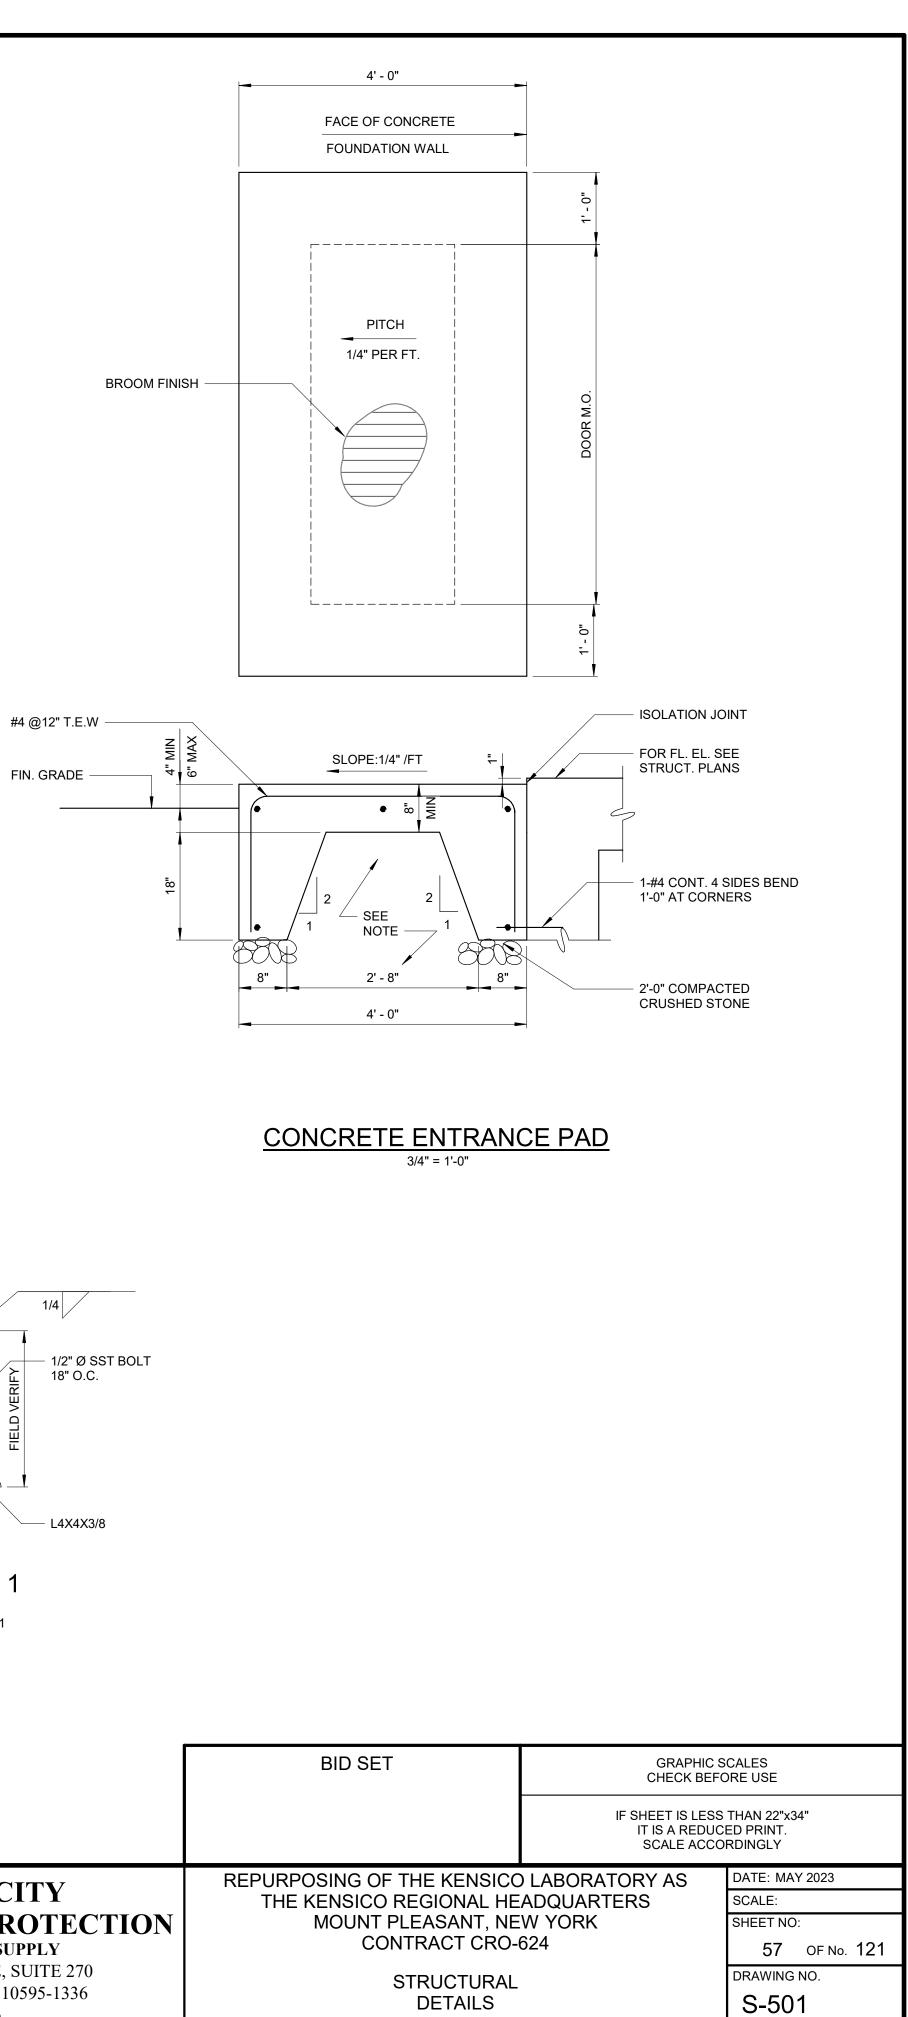
FIN. GRADE

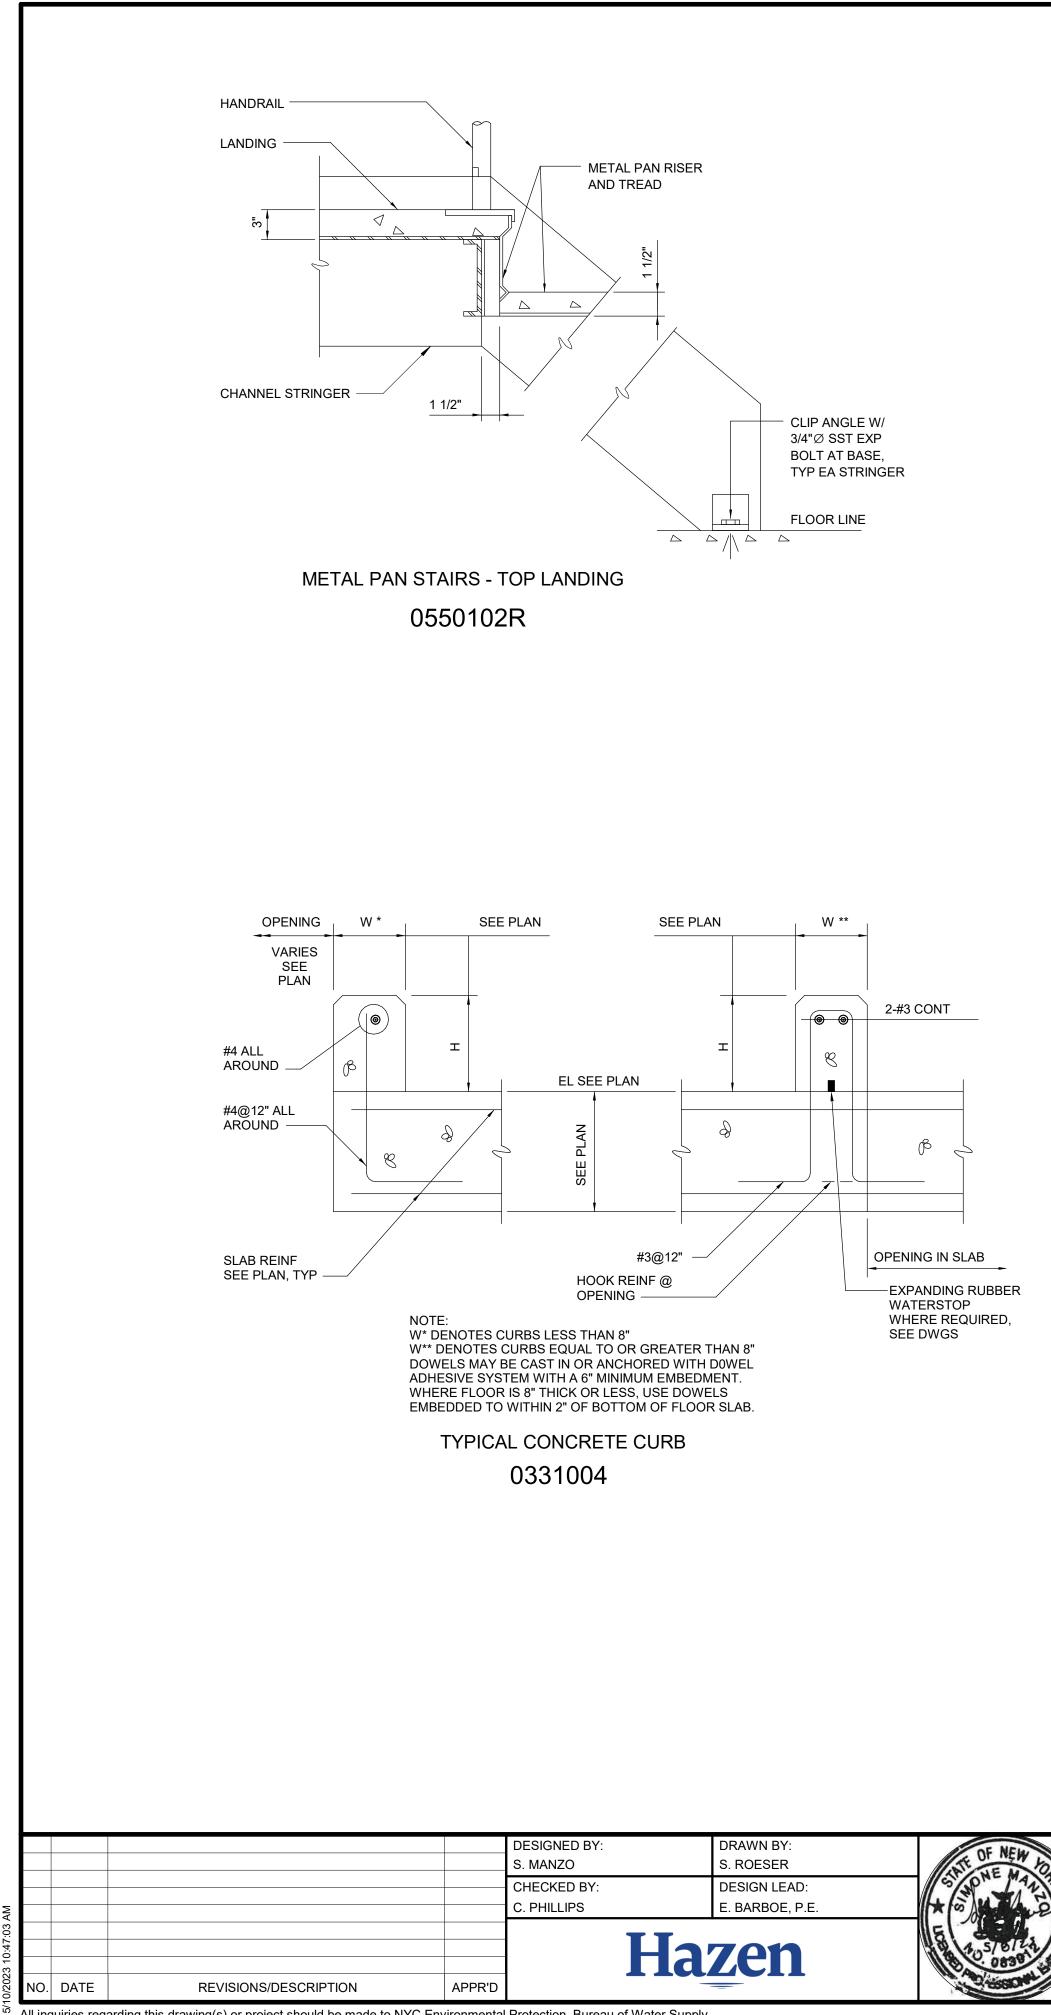
- 1. SEE ARCHITECTURAL DRAWINGS FOR LOCATIONS OF WINDOWS AND DOORS AND TYPICAL WINDOWS AND DOOR SECTIONS.
- 2. REPLACE ALL EXISTING EXTERIOR GALVANIZED STEEL LINTELS WITH STAINLESS STEEL TYPES 316L LINTELS AS INDICATED IN TABLE.
- 3. IF STAINLESS STEEL MEMBERS ARE NOT AVAILABLE PROVIDE EQUIVALENT STAINLESS STEEL SECTIONS, BUILT UP OUT OF STAINLESS STEEL PLATES.

)	ACCOUNTABLE MANAGER
	JOSE NIEVES
	PORTFOLIO MANAGER
	MARK DELBALZO, P.E.

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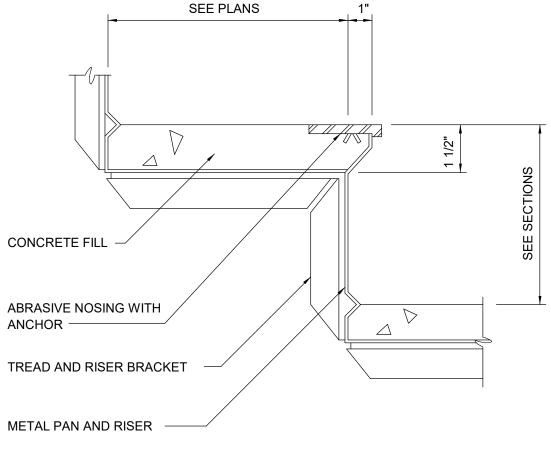
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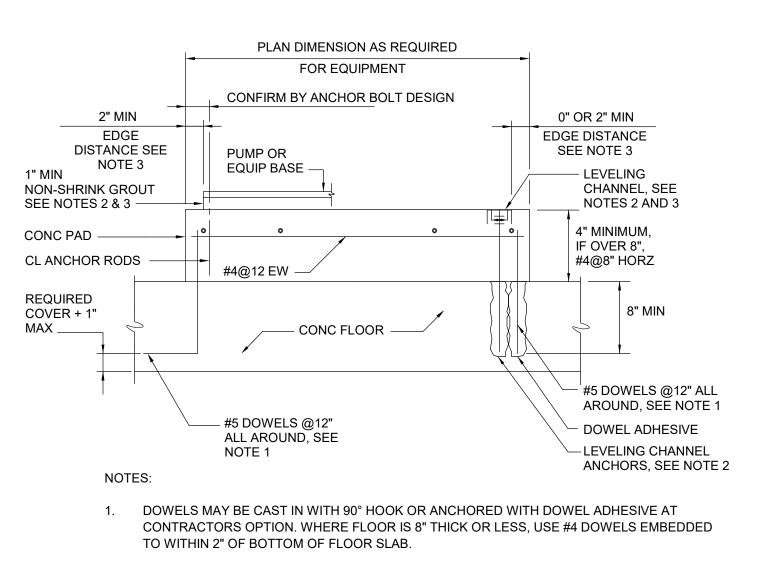
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<sup>6</sup> All inquiries regarding this drawing(s) or project should be made to NYC Environmental Protection, Bureau of Water Supply.



TYP METAL PAN TREAD AND RISER

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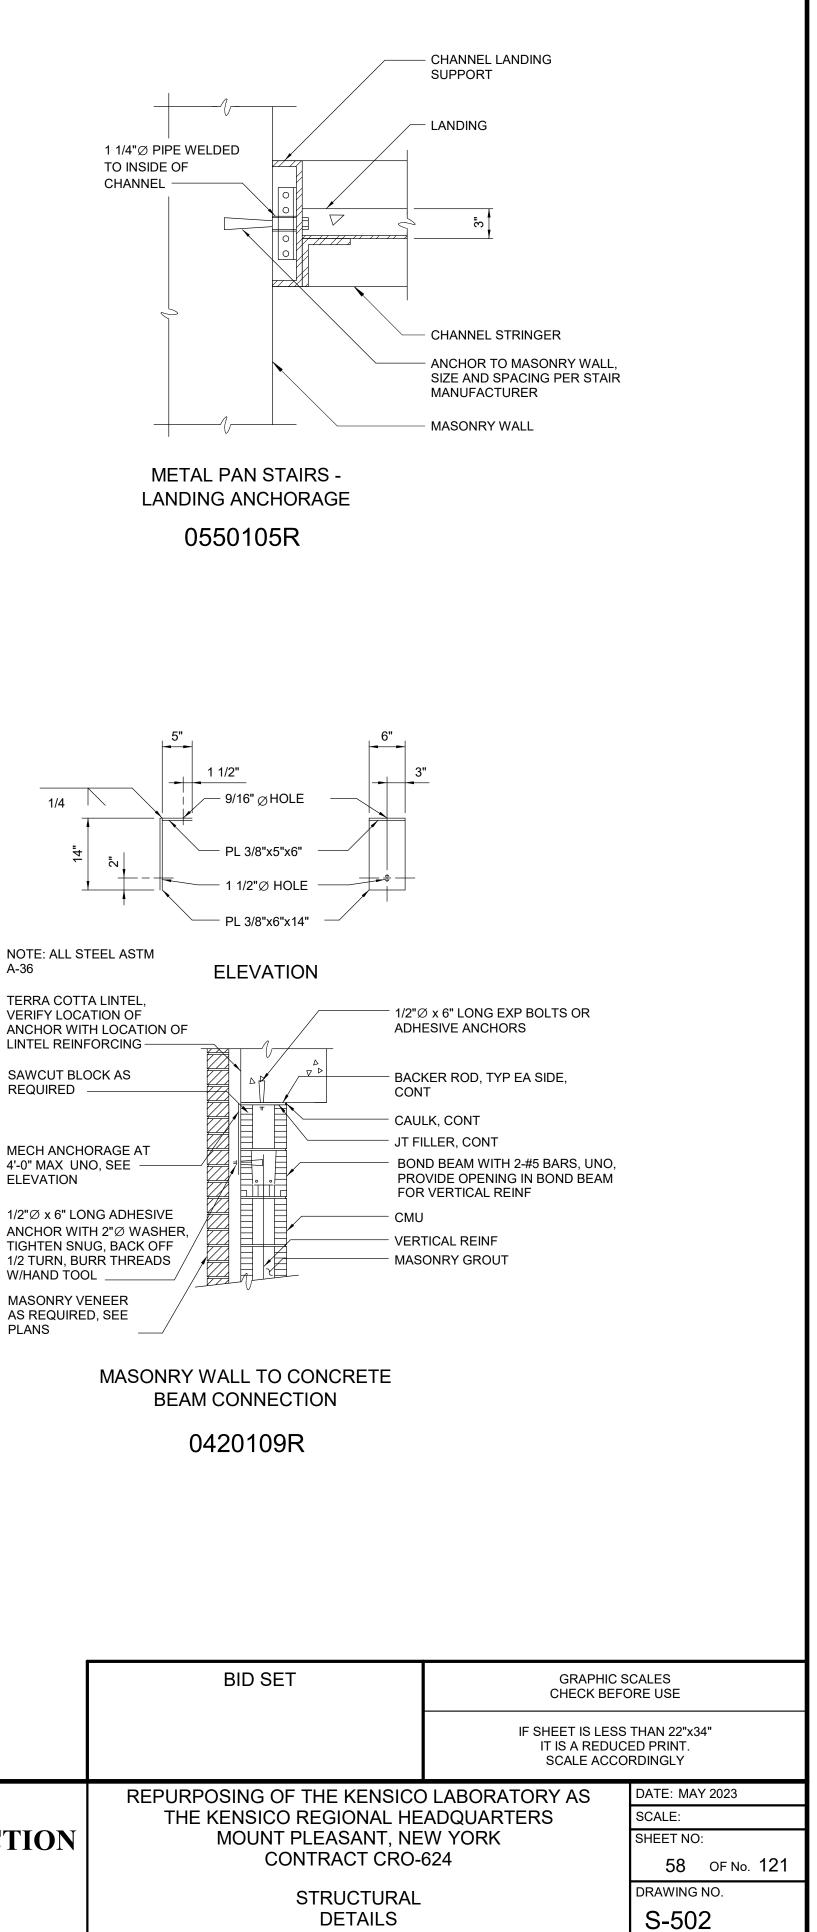
- 2. THE CONTRACTOR SHALL PROVIDE LEVELING CHANNELS AND LEVELING CHANNEL ANCHORS FOR SWITCHGEAR, SWITCHBOARDS, MOTOR CONTROL CENTERS, AND SIMILAR EQUIPMENT WHEN REQUIRED TO MEET EQUIPMENT MANUFACTURER'S LEVELING TOLERANCES. THE CONTRACTOR SHALL PROVIDE 1" MINIMUM NON-SHRINK GROUT FOR PUMPS AND SIMILAR EQUIPMENT WHEN REQUIRED TO MEET EQUIPMENT MANUFACTURER'S UNIFORM BEARING AND LEVELING REQUIREMENTS.
- PRIOR TO PLACING CONCRETE PAD, LEVELING CHANNEL SIZE AND MEANS OF INSTALLATION, ANCHORAGE, GROUT, CONCRETE EDGE DISTANCE, AND CONCRETE BLOCKOUTS REQUIREMENTS SHALL BE COORDINATED WITH EQUIPMENT MANUFACTURER.
- 4. COAT DISSIMILAR MATERIALS PER THE CONTRACT DOCUMENTS.
- 5. STAGGER CHANNEL ANCHORS AND PAD DOWELS.


TYPICAL EQUIPMENT PAD 0331600



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JOSE NIEVES	SECTION, 7209.2, FOR ANY PERSON, UNLESS (S)HE IS ACTING UNDER THE
PORTFOLIO MANAGER	DIRECTION OF A LICENSED PROFESSIONAL ENGINEER, TO ALTER
MARK DELBALZO, P.E.	THIS DOCUMENT IN ANY WAY. IF ALTERED, THE ALTERING PERSON
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LOCATE BEAM REINFORCING PRIOR TO FABRICATION WITH GROUND PENETRATING RADAR OR OTHER ACCEPTABLE MEANS. ADD LENGTH TO CLIP ANGLES AS REQUIRED TO LOWER ANCHORS TO CLEAR REINFORCING WHILE MAINTAINING SPACING AND EDGE DISTANCE AS SHOWN.

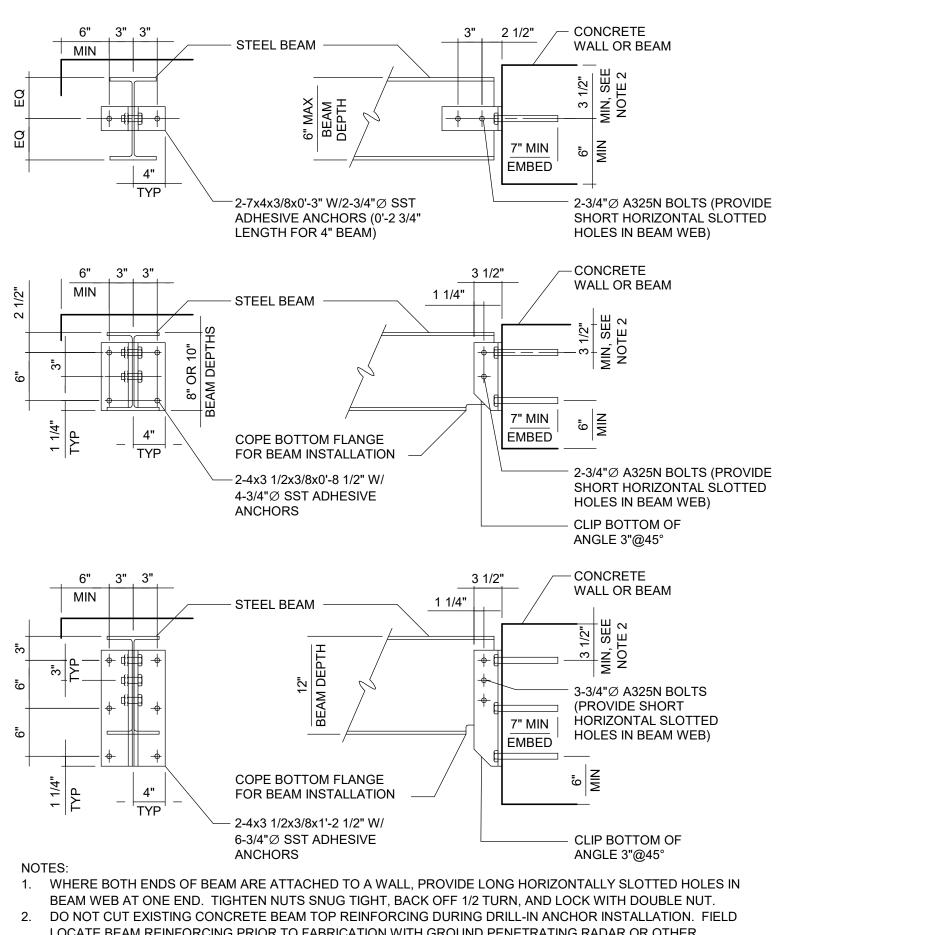STEEL BEAM TO CONCRETE CONNECTION

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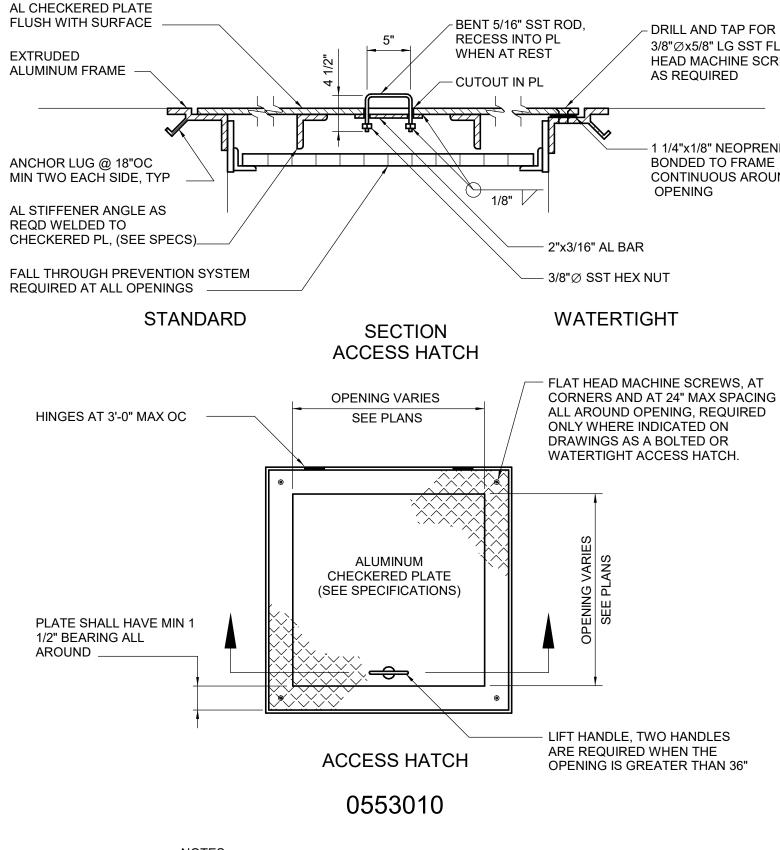
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C. PHILLIPS	E. BARBOE, P.E.	K
CHECKED BY:	DESIGN LEAD:	S P LAN
S. MANZO	S. ROESER	ANT NE M
DESIGNED BY:	DRAWN BY:	OF NEW

All inquiries regarding this drawing(s) or project should be made to NYC Environmental Protection, Bureau of Water Supply.


APPR'D

**REVISIONS/DESCRIPTION** 



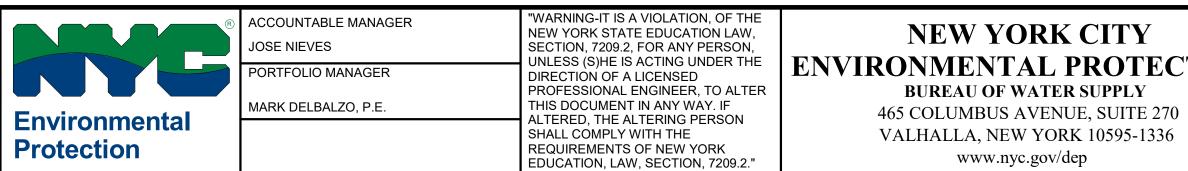NOTES:

1. ACCESS HATCH SUPPORTED ON METAL FRAME SHALL BE SIMILAR. ANCHOR LUG NOT REQUIRED.



	BID SET				
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	REPURPOSING OF THE KENSICC	D LABORATORY AS	DATE: MAY 2023		
	THE KENSICO REGIONAL HE		SCALE:		
TION	MOUNT PLEASANT, NE		SHEET NO:		
	CONTRACT CRO-	59 OF No. 121			
	STRUCTURAL		DRAWING NO.		
	DETAILS		S-503		

LIFT HANDLE, TWO HANDLES ARE REQUIRED WHEN THE OPENING IS GREATER THAN 36"

- 1 1/4"x1/8" NEOPRENE BONDED TO FRAME CONTINUOUS AROUND OPENING

3/8"Øx5/8" LG SST FLAT HEAD MACHINE SCREW TYP AS REQUIRED

- DRILL AND TAP FOR

## **GENERAL NOTES**

- 1. WORK SHALL BE IN CONFORMANCE WITH APPLICABLE REQUIREMENTS OF LOCAL GOVERNING CODES, INCLUDING BUT NOT LIMITED TO N.Y.S DEPT. OF LABO DEPARTMENT REGULATIONS, NFPA, OSHA CODES, ANSI A117.1 (2017), AND NEW YORK STATE UNIFORM FIRE PREVENTION (2020 EDITION) & BUILDING CODE (
- 2. WORK SHALL BE EXECUTED IN FULL COMPLIANCE WITH THE APPLICABLE PROVISIONS OF ALL LAWS, BY-LAWS, STATUTES, ORDINANCES, CODES, RULES, RE PUBLIC AUTHORITIES BEARING ON THE PERFORMANCE AND EXECUTION OF THE WORK.
- 3. CONTRACTOR SHALL PROMPTLY NOTIFY THE ARCHITECT OF ANY PORTIONS OF THE WORK, IN THE CONTRACT DOCUMENTS THAT ARE AT VARIANCE WITH
- 4. ALL PERMITS ISSUED SHALL BE POSTED IN A CONSPICUOUS PLACE OPEN TO THE PUBLIC INSPECTION UNTIL THE COMPLETION OF THE WORK OR THE USE EQUIPMENT OR UNTIL THE EXPIRATION OF THE PERMIT.
- 5. DRAWINGS ARE NOT TO BE SCALED. USE DIMENSIONS ONLY. ALL DIMENSIONS AND CONDITIONS SHOWN ON THE DRAWINGS MUST BE VERIFIED AT THE SITE OR DOING ANY WORK. WHERE DISCREPANCIES OCCUR AND/OR WHERE THERE ARE CONFLICTS OR OMISSIONS IN THE DRAWINGS, SPECIFICATIONS AND AP SHALL NOTIFY THE ARCHITECT IMMEDIATELY AND REFRAIN FROM STARTING AND COMPLETING SUCH WORK, OR DEPENDENT WORK, UNTIL DIRECTED BY AF IN DRAWINGS OR SPECIFICATIONS IS PERMISSIBLE WITHOUT THE WRITTEN CONSENT OF THE ARCHITECT.
- 6. EXTERIOR DIMENSIONS ARE TO THE FACE OF STRUCTURE UNLESS OTHERWISE NOTED.
- 7. MECHANICAL AND ELECTRICAL INDICATIONS ON ARCHITECTURAL DRAWINGS ARE FOR LOCATION PURPOSES ONLY.
- 8. THE HARDWARE AND FIXTURES SHOWNIN DRAWINGS IS FOR GRAPHIC PURPOSES ONLY. REFER TO THE FINISH HARDWARE SCHEDULE IN SPECIFICATIONS.
- 9. ADDITIONAL NOTES APPLICABLE TO THIS PROJECT MAY BE FOUND THROUGHOUT THE CONSTRUCTION DOCUMENTS.
- 10. WHERE MANUFACTURER'S NAMES AND PRODUCT NUMBERS ARE INDICATED ON THE DRAWINGS IT SHALL BE CONSTRUED TO MEAN THE ESTABLISHING OF STANDARDS OF SUCH ITEMS. ALL PRODUCTS MUST BE SUBMITTED TO THE ARCHITECT FOR REVIEW AND APPROVAL BEFORE THEY SHALL BE DEEMED EQU.
- 11. ELEVATIONS GIVEN FOR EXISTING BUILDINGS ARE TO FINISHED FLOOR. THE CONTRACTOR SHALL VERIFY ALL ELEVATIONS FOR EXISTING STRUCTURES PRI WORK.
- 12. THE WORD "PROVIDE" MEANS TO FURNISH AND INSTALL NEW ITEM(S) AND/OR SYSTEM(S).
- 13. CONTRACTOR SHALL KEEP WORK SITE FREE FROM DEBRIS AND ACCUMULATED REFUSE, AND SHALL HAVE SOLE RESPONSIBILITY FOR PROTECTING ALL DA UNAUTHORIZED PARTIES. SITE WILL BE LEFT BROOM CLEAN AT THE END OF EACH WORKING DAY.
- 14. EXISTING AND NEWLY CONSTRUCTED SURFACES SHALL BE PROTECTED FROM DEMOLITION / CONSTRUCTION ACTIVITIES. WHERE EXISTING FINISHES ARE T BE MODIFIED IN SUCH A MANNER THAT AFTER ASSEMBLY THEY WILL PROVIDE A COMPLETE CONTINUOUS FINISHED CONDITION. WHERE ACCESSORIES, EQU REMOVED, ALTERED, ETC., PROVIDE FOR THE PATCHING AND REFINISHING OF MOUNTING POINTS IN THE EXISTING FINISH.
- 15. CONTRACTOR SHALL BE RESPONSIBLE FOR ADEQUATELY BRACING AND PROTECTING WORK AGAINST DAMAGE, BREAKAGE, COLLAPSE, DISTORTIONS, AND CODES AND STANDARDS OF GOOD PRACTICE.
- 16. CONTRACTOR SHALL LAY OUT HIS OWN WORK, AND SHALL PROVIDE ALL DIMENSIONS REQUIRED FOR OTHER TRADES.
- 17. CONTRACTOR SHALL PERFORM ALL CUTTING AND PATCHING REQUIRED TO COMPLETE THE WORK OR TO MAKE ITS PARTS FIT TOGETHER PROPERLY WITH COMPROMISING THE QUALITY OF THE WORK.
- 18. CONTRACTOR SHALL PATCH AND REPAIR FLOORS, WALLS CEILINGS, ETC., DAMAGED OR EXPOSED DUE TO MEP WORK AND FINISH TO MATCH ADJOINING SU THE ARCHITECT AND OWNER. COORDINATE WORK WITH MEP DRAWINGS.
- 19. CONTRACTOR SHALL PATCH AND REPAIR FIREPROOFING DAMAGE INCURRED DURING CONSTRUCTION. FIREPROOF AS REQUIRED BY CODE ALL PENETRAT DESCRIBED IN THESE DOCUMENTS.
- 20. WORK SHALL BE INSTALLED SO THAT ALL PARTS REQUIRED ARE READILY ACCESSIBLE FOR INSPECTION, OPERATION, MAINTENANCE AND REPAIR.
- 21. NEW CONSTRUCTION, PATCHED WORK, AND AREAS AFFECTED BY CONSTRUCTION SHALL BE PAINTED. PAINTING SHALL COVER THE ENTIRE AFFECTED HOR THE CLOSEST CORNER IN ALL FOUR DIRECTIONS. COLOR TO MATCH EXISTING CONDITIONS. WHERE AFFECTED SURFACES ARE MORE THAN 2/3 OF THE TOT WITHIN A ROOM, PAINT ALL PAINTABLE SURFACES.
- 22. CONTRACTOR SHALL BE RESPONSIBLE FOR COORDINATING ALL ASPECTS OF WORK UNDER THIS CONTRACT IN ORDER TO ENSURE THE QUALITY AND TIME!
- 23. EXCEPT FOR MISCELLANEOUS TRIM AND MOLDINGS, ALL NEW WOOD USED SHALL BE FIRE RETARDANT.
- 24. CONTRACTOR SHALL PROVIDE CONCEALED BLOCKING AND/OR GROUNDS WHERE REQUIRED BY CONSTRUCTION AND OWNER SUPPLIED FURNISHINGS AND
- 25. FIRE STOPPING IS REQUIRED AT ALL WALL, FLOOR AND CEILING PENETRATIONS. FIRE STOPPING SHALL MEET THE REQUIRED FIRE RATING OF THE EXISTING
- 26. CONTRACTOR'S EQUIPMENT AND MATERIALS TO REMAIN ON SITE DURING THE COURSE OF WORK SHALL AT THE END OF EACH DAY BE STORED IN THE PRO

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All inquiries regarding this drawing(s) or project should be made to NYC Environmental Protection, Bureau of Water Supply.

## ARCHITECTURAL ABBREVIATIONS

ABOR, HEALTH CODE, FIRE DE (2020 EDITION).	"A"		"G"		"P"	
REGULATIONS AND LAWFUL ORDERS OF	& @	AND AT	GA GALV	GAGE / GAUGE GALVANIZED	PAR PART.	PARALLEL PARTITION
H THE ABOVE.	AB ABR	ANCHOR BOLTS ABRASIVE	GB GL	GRADE BEAM / GRAB BAR GLASS	PERF PF	PERFORATED PURGE FAN
E AND THE OPERATION OF THE	ACT	ACOUSTICAL CEILING TILE	GR	GRADE	PJ	PANEL JOINT
	ADD'L ADJ	ADDITIONAL ADJUSTABLE	GRD GS	GROUND GALVANIZED STEEL	PL PLWD	PLATE PLYWOOD
ITE BEFORE ORDERING ANY MATERIAL	AFF ALT	ABOVE FINISHED FLOOR ALTERNATE	GVL GWB	GRAVEL GYPSUM WALL BOARD	PLUMB. PNL	PLUMBING PANEL
APPLICATIONS, THE CONTRACTOR ARCHITECT TO PROCEED. NO CHANGE	ALUM	ALUMINUM	GVID	GTF SUM WALL BOAND	PR	PAIR
ARCHITECT TO PROCEED. NO CHANGE	APPD ARRROX	APPROVED APPROXIMATE	"H"		PRE PREFAB	POWER ROOF EXHAUSTER PREFABRICATED
	ARCH ASPH	ARCHITECTURAL ASPHALT	HB	HOSE BIBB	PREFIN PRI	PRE FINISHED PRIMARY
	"B"		HD HDW	HEAD HARDWARE	PRMLD	PRE MOLDED
			HGT	HEIGHT	P.T. PT	PRESSURE TREATED PAINT / PAINTED
IS.	B OR BOT B/ OR BO	BOTTOM BOTTOM OF	HM HMD	HOLLOW METAL HOLLOW METAL DOOR	PVC PVT	POLYVINYL CHLORIDE PAVEMENT
	BD BFF	BOARD	HMF HORIZ	HOLLOW METAL FRAME HORIZONTAL	PWE	POWER WALL EXHAUSTER
OF QUALITY AND PERFORMANCE	BIT	BELOW FINISHED FLOOR BITUMINOUS	HP	HIGH POINT		
QUAL.	BLDG BLK	BUILDING BLOCK / BLOCKING	HVAC	HEATING, VENTILATING AND AIR CONDITIONING	"Q"	
PRIOR TO THE COMMENCEMENT OF	BM	BEAM			QUAL QTY	QUALITY QUANTITY
	BOD BOL	BOTTOM OF DUCT BOTTOM OF LOUVER	" "		QTT	QUANTIT
	BOP BRG	BOTTOM OF PIPE BEARING	I.F.	INSIDE FACE	"R"	
DANGEROUS AREAS FROM ENTRY BY	ыко	BEARING	INCL	INCLUDED / INCLUDING	RAD	RADIUS
	"C"		IND INFO	INDUSTRIAL INFORMATION	RB RD	ROOF BEAM ROOF DRAIN
E TO BE CUT OR ALTERED, THEY SHALL			INSUL INT	INSULATION / INSULATED INTERIOR	RECT	RECTANGLE / RECTANGULAR
EQUIPMENT, AND PARTITIONS ARE TO BE	CJ CANTIL	CONTROL JOINT CANTILEVER	INV	INVERT	REF REINF	REFERENCE REINFORCE
ND OFF ALIGNMENTS ACCORDING TO	CEM CHAN	CEMENT CHANNEL			REQ'D REV	REQUIRED
	CHEM	CHEMICAL RESISTANT	"J"		RFG	REVISION / REVISED ROOFING
	CL CLG	CENTERLINE CEILING	JST	JOIST	RM RO	ROOM ROUGH OPENING
TH ADJACENT CONSTRUCTION WITHOUT	CLR CMU	CLEAR CONCRETE MASONRY	JT	JOINT		
	COL	UNITS COLUMN	"K"		"S"	
SURFACES TO THE SATISFACTION OF	COMBO CONC	COMBINATION CONCRETE			S	SOUTH
	CONST	CONSTRUCTION CONSTRUCTION JOINT	KD KFS	KNOCK DOWN KIPS PER SQUARE FOOT	S/C SCH	SITE/CIVIL SCHEDULE
ATIONS GENERATED BY THE WORK	CONT	CONTINUE /	KFT KP	KIP FOOT KICK PLATE	SEC SECT	SECOND SECTION
	CONT'D CONTR	CONTINUOUS CONTINUED CONTRACT / CONTRACTOR			SF	SQUARE FOOT
	COORD	COORDINATE	"L"		SIM SHT	SIMILAR SHEET
ORIZONTAL OR VERTICAL SURFACE TO		CORRIDOR CORRUGATED	L	ANGLE	SIM REV SJ	SIMILAR REVERSED STEEL JOIST
OTAL PAINTABLE SURFACE AREA	CSK CSKSCR	COUNTERSINK COUNTERSUNK SCREW	LAM LB	LAMINATE POUND	SPEC	SPECIFICATION
	CTR	CENTER	LBS	POUNDS	SQ SS	SQUARE STAINLESS STEEL
MELY COMPLETION OF THE WORK.	"D"		LF LG	LINEAR FEET LENGTH / LONG	STA STD	STATION STANDARD
	DEG	DEGREE	LLH LLV	LONG LEG HORIZONTAL LONG LEG VERTICAL	STIFF	STIFFENER
ND EQUIPMENT.	DET DEMO	DETAIL DEMOLISH / DEMOLITION	LP	LOW POINT	STL STOR	STEEL STORAGE
ING OR NEW CONSTRUCTION.	DIA DIAG	DIAMETER DIAGONAL / DIAGRAM	LV	LOUVER	STRU SUSP	STRUCTURE / STRUCTURAL SUSPEND / SUSPENDED
ROVIDED STAGING AREA.	DIM	DIMENSION	"M"		SYM	SYMMETRICAL / SYMMETRICA
	DIV DL	DIVISION DEAD LOAD			"Т"	
	DN	DOWN	MAN. MATL	MANUAL MATERIAL	т	TOP
	DR DWG	DOOR DRAWING	MAX MCP	MAXIMUM METAL CLAD PANEL	T/ OR T.O.	TOP OF
	DWL	DOWEL	MD	METAL DECK	TBD TEMP	TO BE DETERMINED TEMPERATURE
	"E"		MECH MET	MECHANICAL METAL	TH THRD	THICK THREAD / THREADED
	EL	EXPANSION JOINT	MFG MFR	MANUFACTURING MANUFACTURER	ТОВ	TOP OF BLOCK
	EA EF	EACH EACH FACE	MIN	MINIMUM	TOD TOF	TOP OF DUCT TOP OF FOOTING
	EL	ELEVATION	MISC MOD	MISCELLANEOUS MODIFICATION	TOL TOS	TOP OF LOUVER TOP OF SLAB
	ELEC ENGR	ELECTRIC / ELECTRICAL ENGINEER	MO MP	MASONRY OPENING METAL PANEL	тот	TOTAL
	EP EQ	ESCAPE PIPING EQUAL	MS	METAL STUD	TOW TYP	TOP OF WALL TYPICAL
	EQUIP	EQUIPMENT	MTD MTL	MOUNTED METAL	"U"	
	EQUIV ES	EQUIVALENT EXPOSED STRUCTURE	"N"		0	
	EW	EACH WAY			UON U/S	UNLESS OTHERWISE NOTED UNDERSIDE
	EXC EXF	EXCAVATION EXHAUST FAN	N N/A	NORTH NOT APPLICABLE		
	EXS EXH	EXHAUST STACK EXHAUST	NC	NON COMBUSTIBLE	"V"	
	EXP STR	EXPOSED STRUCTURE	NF NIC	NEAR FACE NOT IN CONTRACT	VCT VERT	VINYL COMPOSITION TILE
	EXISTOR	EX EXISTING EXPANSION / EXPOSED	NO. OR # NOM	NUMBER NOMINAL	VP	VENT PIPE
	EXT	EXTERIOR	NS	NEAR SIDE	"W"	
	"F"		NTS	NOT TO SCALE		
	FAC	FACTORY	"O"		W/O W/	WITHOUT WITH
	FD	FLOOR DRAIN / FOOTING DRAIN FOUNDATION	ос	ON CENTER	W WD	WEST WOOD
	FDN FE	FIRE EXTINGUISHER	O.F. OH	OUTSIDE FACE OVERHEAD	WF	WATER FOUNTAIN
	FF FFE	FACTORY FINISH FINISH FLOOR ELEVATION	OPNG	OPENING	WLD WP	WELD / WELDED WATER PROOFING
	FIN GR	FINISHED GRADE	OPP	OPPOSITE	WT	WEIGHT
	FIN FL FIXT	FINISHED FLOOR FIXTURE				
	FIN FL OR FLR	FINISH FLOOR				
	FR	FRAME				
	FS FT	FLUE STACK FEET				



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MARK DELBALZO, P.E.	THIS DOCUMENT IN ANY WAY. IF ALTERED, THE ALTERING PERSON		
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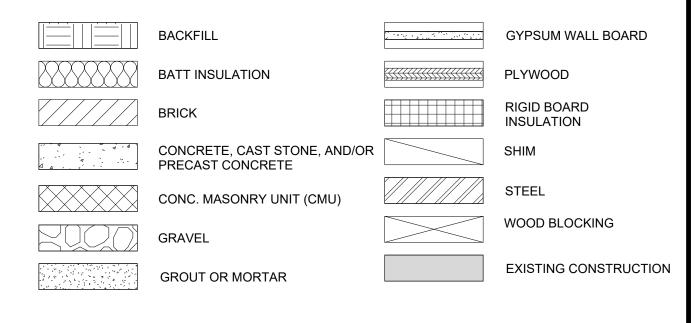
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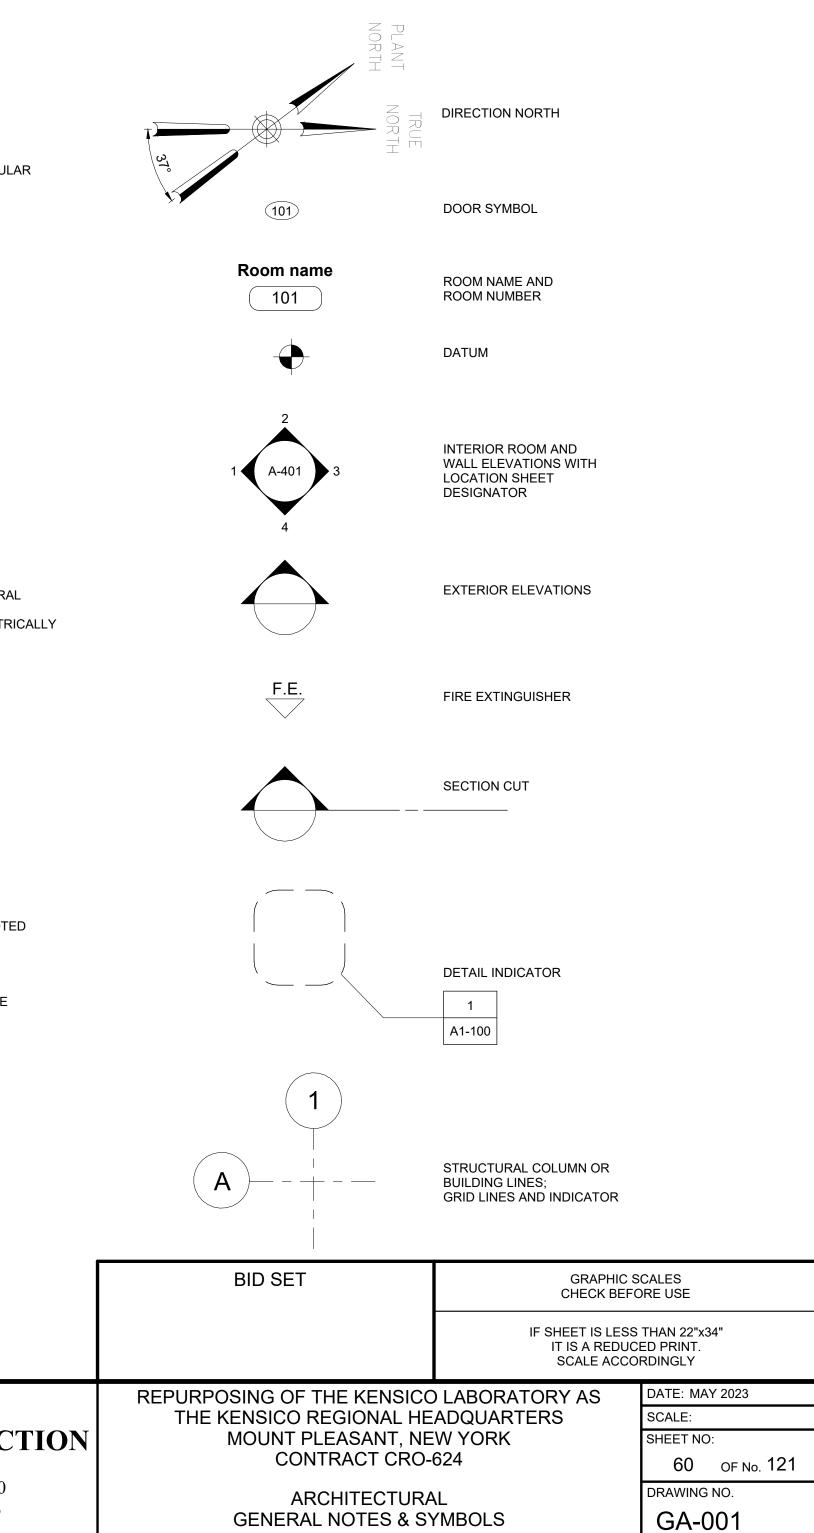
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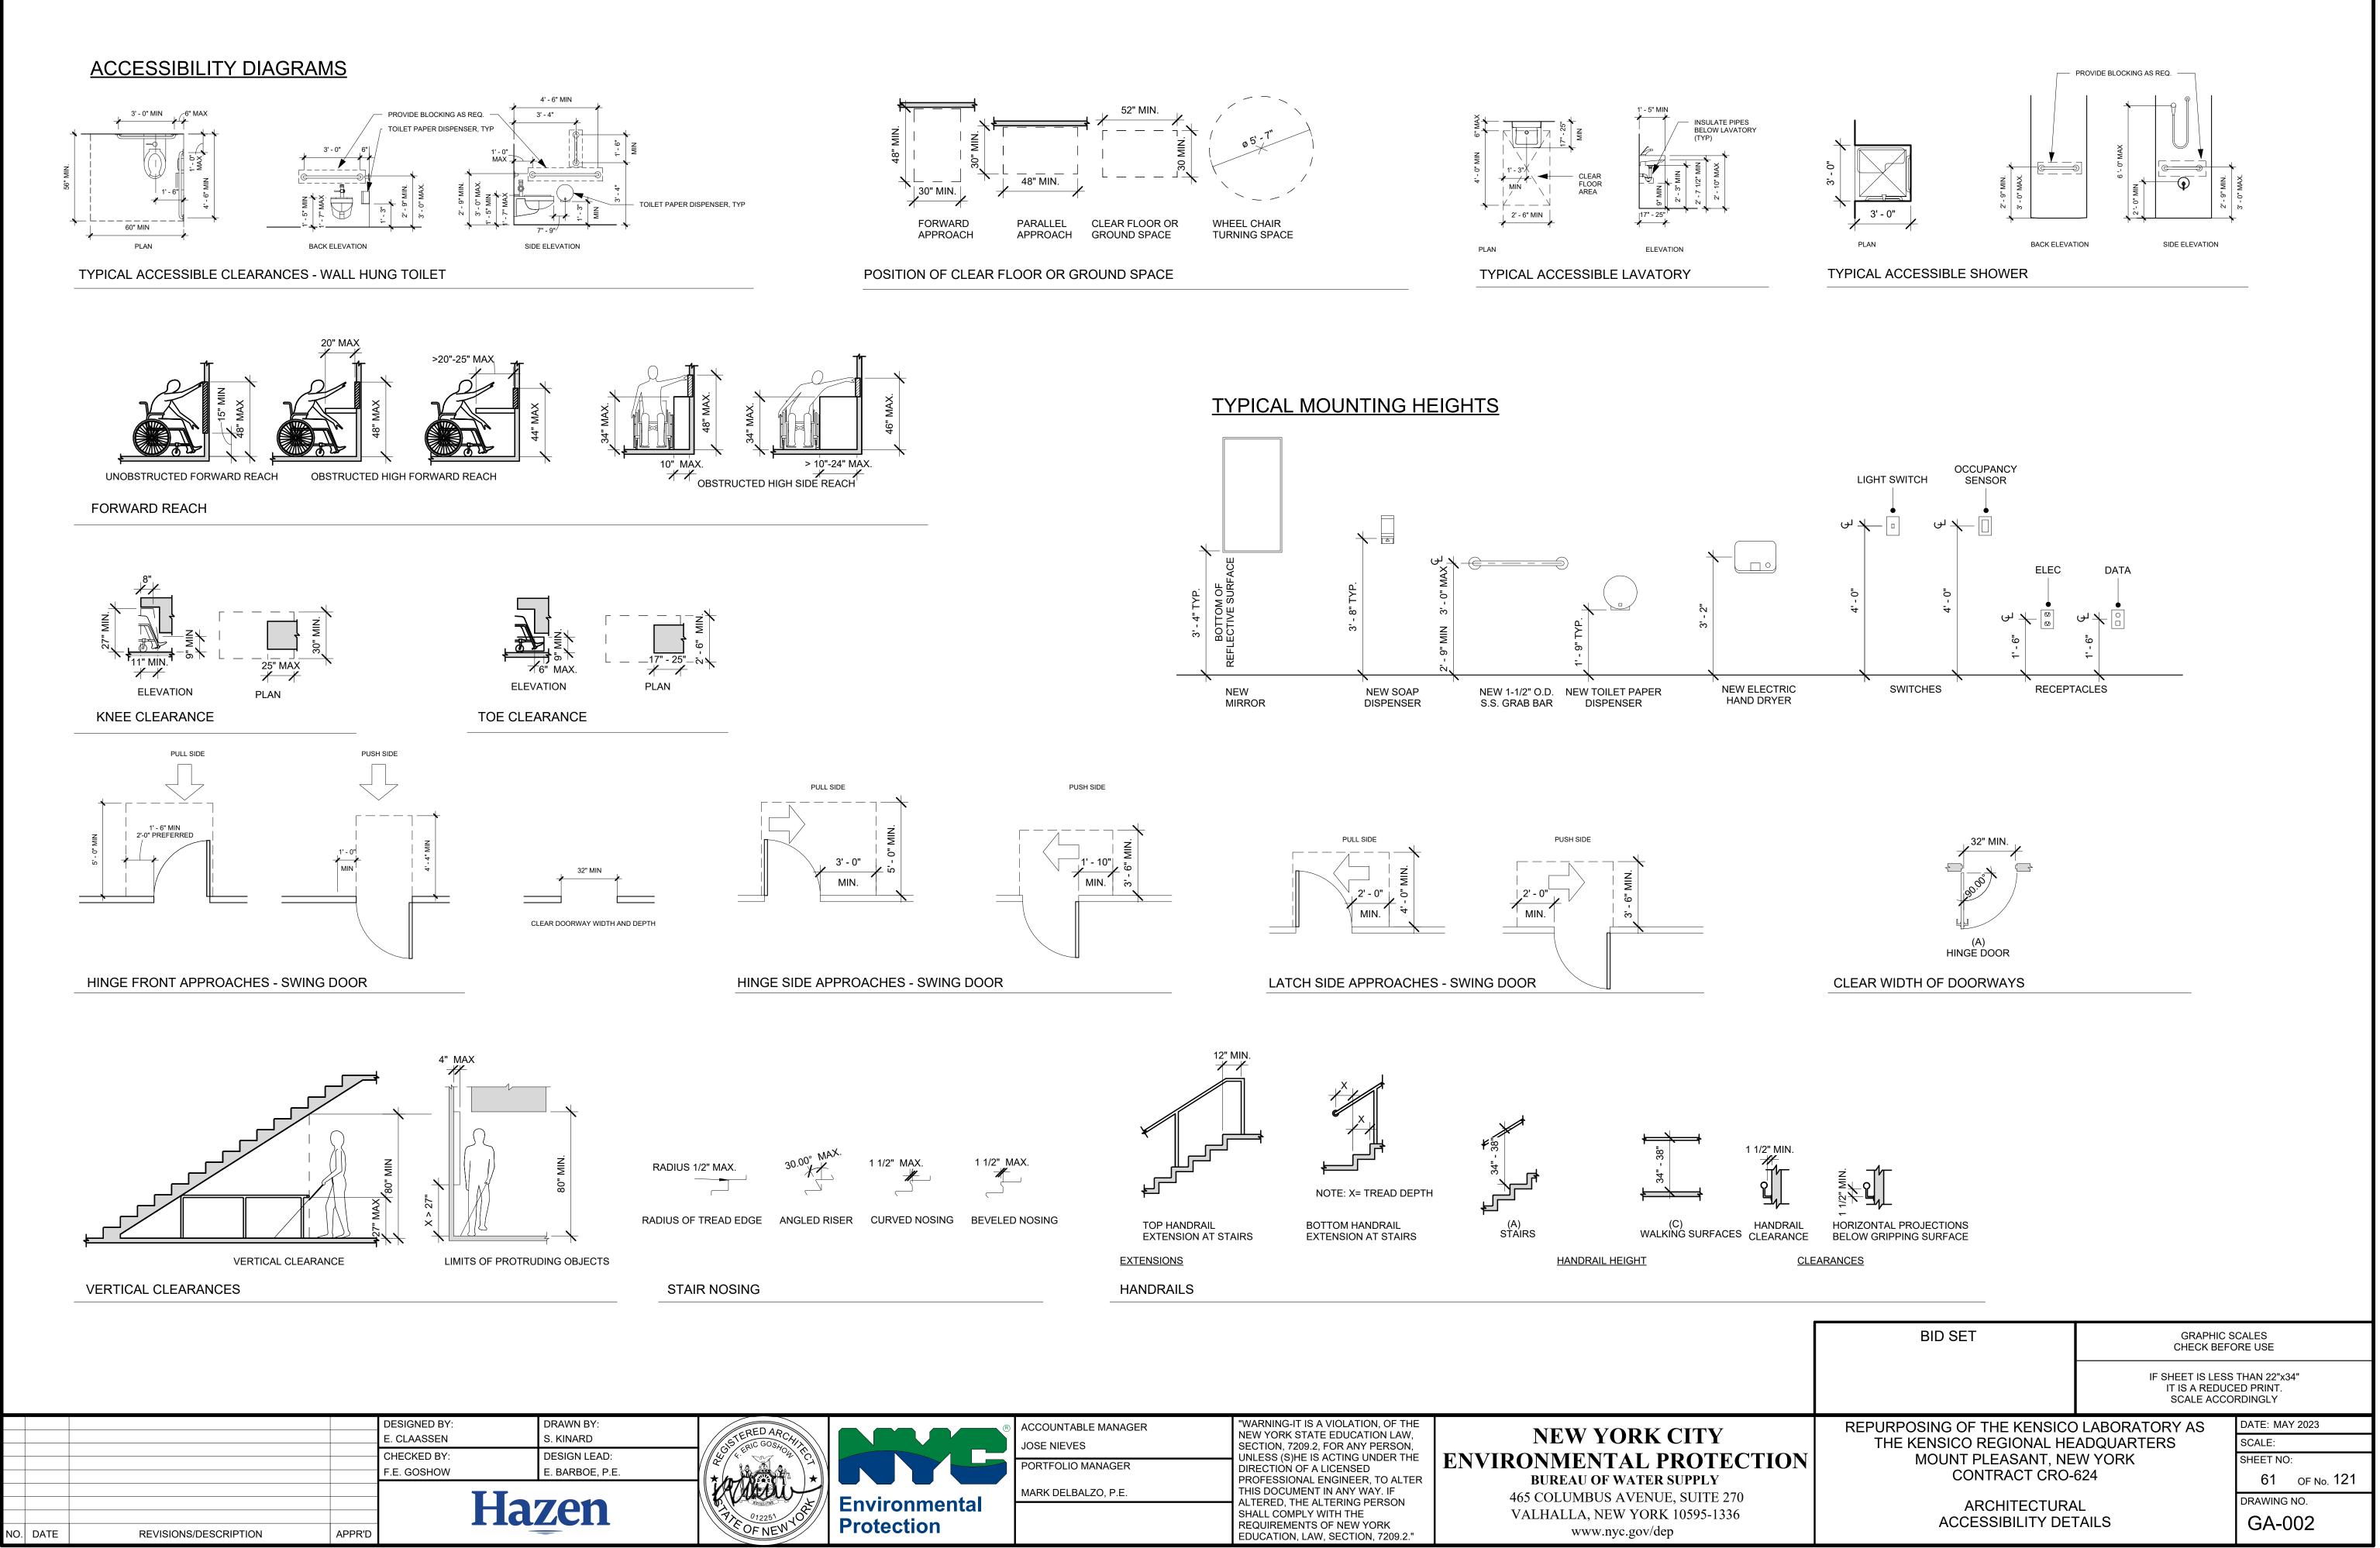
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# ARCHITECTURAL GRAPHIC CONVENTIONS









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APPLICABLE CODES:				EBCNYS SECTION 907.1: ALTER
2020 EXISTING BUILDING CODE OF NEW YORK STATE (EBCNYS) 2020 BUILDING CODE OF NEW YORK STATE (BCNYS) 2020 FIRE CODE OF NEW YORK STATE (FCNYS), NFPA 70 2009 ICC ANSI A117.1				REQUIREMENTS OF THE NEW Y AS IT RELATES TO NEW CONST REFERENCED CODES:
CODE REFERENCE	REQUIREMENT		PROVIDED	<ul> <li>2020 NEW YORK STATE</li> <li>ASHRAE 90.1-2013</li> </ul>
PROVISIONS FOR ALL COMPLIANCE METHODS / EBCNYS CHAPTER 3				CLIMATE ZONE: 4A (NYSECC C
ALTERATION, ADDITION, OR CHANGE OF OCCUPANCY (EBCNYS 301.3)	WORK AREA COMPLIANCE METHOD (EBCN	YS 301.3.2)	WORK AREA EXCEEDS 50% OF THE BUILDING AREA = ALTERATION LEVEL 3 (EBCNYS 604)	OPAQUE THERMAL ENVELOPE REQUIREMENTS
USE AND OCCUPANCY CLASSIFICATION / BCNYS CHAPTER 3		4)		(NYSECC TABLE C402.1.3)
OCCUPANCY AND USE SHALL BE DETERMINED IN ACCORDANCE WITH CHAPTER 3 OF THE BUILDING CODE OF NEW YORK STATE (EBCNYS 302.6)	OCCUPANCY CLASSIFICATION (BCNYS 302	.1)	GROUP B - BUSINESS	WALLS, ABOVE GRADE WALLS, BELOW GRADE
TYPES OF CONSTRUCTION / BCNYS CHAPTER 6	r			FLOORS SLAB-ON-GRADE
FIRE-RESISTANCE RATING REQUIREMENTS FOR BUILDING ELEMENTS / BCNYS-TABLE 601 PRIMARY STRUCTURAL FRAME	TYPE IIB - NONCOMBUSTIBLE FIRE RESISTANCE		TYPE IIB - NONCOMBUSTIBLE FIRE RESISTANCE	BUILDING ENVELOPE FENEST REQUIREMENTS (NYSECC TABLE C402.4)
BEARING WALLS EXTERIOR	(0) HOURS (0) HOURS		(0) HOURS (0) HOURS	FIXED FENESTRATION
INTERIOR	(0) HOURS		(0) HOURS	ENTRANCE DOORS SHGC (PF<0.2)
NONBEARING WALLS AND PARTITIONS EXTERIOR INTERIOR	(0) HOURS (0) HOURS		(0) HOURS (0, 1) HOURS	PROFESSIONAL STATEMENT:
FLOOR CONSTRUCTION	(0) HOURS		(0) HOURS	TO THE BEST OF MY KNOWLED JUDGEMENT, THE SUBMITTED
ROOF CONSTRUCTION	(0) HOURS		(0) HOURS	COMPLIANCE WITH THE 'ENER(
FIRE AND SMOKE PROTECTION FEATURES / BCNYS CHAPTER 7 / EBCNYS SECTION 802				TO ALL PLANS, SPECIFICATION ARCHITECT HAS BEEN APPLIE
EXISTING STAIRWAY ENCLOSURE (EBCNYS 903.1)				WITH APPROPRIATE WORDING LAW FOR ANY PERSON, UNLES
GROUP B OCCUPANCY (EBCNYS 802.2.1)	MIN. 30 MINUTE FIRE RESISTANCE RATED E	INCLOSURE	1 HR FIRE RESISTANCE RATED ENCLOSURE	LICENSED ARCHITECT, TO ALTE THE SEAL OF AN ARCHITECT IS
SHAFT AND FLOOR OPENING ENCLOSURES (EBCNYS 802.2.2)	MIN. 30 MINUTE FIRE RESISTANCE RATING		1 HR FIRE RESISTANCE RATED ENCLOSURE	AFFIX TO HIS ITEM THE SEAL A BY HIS SIGNATURE AND THE D
SUPPLEMENTAL STAIRWAY ENCLOSURE REQUIREMENTS (EBCNYS 802.2.3)	SMOKE-TIGHT CONSTRUCTION		PROVIDED	DESCRIPTION OF THE ALTERAT
INTERIOR FINISHES / BCNYS CHAPTER 8 INTERIOR FINISHES OF WORK AREA SHALL COMPLY WITH REQUIREMENTS OF THE BUILDING CODE ON NEW YORK STATE (EBCNYS 802.4)	GROUP B, NON-SPRINKLERED			
INTERIOR EXIT STAIRWAYS AND EXIT PASSAGEWAYS CORRIDORS AND ENCLOSURES FOR EXIT ACCESS STAIRWAYS AND RAMPS	CLASS A CLASS B		CLASS A CLASS B	
ROOMS AND ENCLOSED SPACES WITHIN WORK AREA	CLASS C		CLASS C	<u>LEGEND</u>
INTERIOR FLOOR FINISH (BCNYS 804.4.2)	CLASS II		CLASS II	<b></b> • <b></b> 1 HR FIRE
WINDOW TRIM / COMBUSTIBLE DECORATIVE MATERIALS (BCNYS 806.7)	TEST 1 OR 2, NFPA 701		TEST 1 OR 2, NFPA 701	COMMON
INTERIOR CEILING HEIGHT OF NEW OCCUPIABLE SPACES & CORRIDORS (EBCNYS 801.3)	MINIMUM 7 FEET		7 FEET MIN.	< ● EGRESS F
FIRE PROTECTION AND LIFE SAFETY SYSTEMS / BCNYS CHAPTER 9				
AUTOMATIC SPRINKLER SYSTEMS -THE WORK AREA IS REQUIRED TO BE PROVIDED WITH AUTOMATIC SPRINKLER PROTECTION IN ACCORDANCE WITH THE BUILDING CODE OF NEW YORK STATE AS APPLICABLE TO NEW CONSTRUCTION (EBCNYS 803.2.2)	GROUP B - NOT REQUIRED (BCNYS 903)		NOT SPRINKLERED	XXX • ALLOWAE XXX • CALCULA XXX • TRAVEL D
MEANS OF EGRESS / BCNYS CHAPTER 10 / EBCNYS SECTION 805				
OCCUPANT LOAD / BCNYS TABLE 1004.5 (EBCNYS 805.3.1)				
BUSINESS AREAS150 GROSSACCESSORY STORAGE / MECH300 GROSSASSEMBLY UNCONCENTRATED15 NETLOCKER ROOMS50 GROSS	SECOND FLOOR ELEC. CLOSET CONFERENCE RM BUSINESS AREA	66 SF / 300 164 SF / 15 1660 SF / 150	1 OCC 11 OCC <u>11 OCC</u> 23 OCC	BUSINES
	FIRST FLOOR		23 000	ASSEMBL
	CONFERENCE RM MEN'S LOCKERS	452 SF / 15 87 SF / 50	31 OCC 2 OCC	
	WOMEN'S LOCKERS BUSINESS AREA	56 SF / 50 2850 SF / 150	2 OCC	LOCKERS
		2000 01 / 100	54 OCC	ACCESSO
	CELLAR	1197 SF / 300	4 OCC	l
MEANS OF EGRESS LIGHTING (EBCNYS 905.2) EXIT SIGNS (EBCNYS 905.3)	REQUIRED		REQUIRED IF EXIT/CORRIDOR SERVES > 30 OCCUPANTS	
NUMBER OF EXITS (EBCNYS 805.3, 805.1)	AS REQUIRED BY BUILDING CODE AT ORIG CONSTRUCTION DATE	INAL	1ST FLOOR: ADD (1) EXIT; TOTAL (3) EXITS 2ND FLOOR: MAINTAIN EXIT QUANTITY; TOTAL (1) EXIT	
EGRESS DOORWAYS (EBCNYS 805.4)	(2) EGRESS DOORWAYS REQUIRED FOR AN OCCUPANT LOAD > 50 PERSONS, O TRAVEL DISTANCE TO EXIT > 75 FE	R	OCCUPANT LOAD FOR ANY ROOM DOES NOT EXCEED 50	
CAPACITY OF NEW EXITS (BCNYS 1005.3) STAIRWAYS	0.3" / OCC (0.3" X 29 OCC = 8.7") 36" MINIMUM (BCNYS 1011.2 EXCEPTION 1)		GREATEST TRAVEL DISTANCE TO EXIT: 72 FEET	
OTHER EGRESS COMPONENTS	0.2" / OCC (0.2" X 55 = 11") DOORS - 32" MIN. CLEAR (BCNYS 1010.1.1)			
DEAD-END CORRIDORS (EBCNYS 805.6)	CORRIDORS - 44" MIN. (BCNYS TABLE 1020. MAXIMUM 35 FEET IN WORK AREA	∠)	23 FEET MAX.	I
HANDRAILS (EBCNYS 805.9.1)	REQUIRED FOR ANY EXIT STAIR $\geq$ 3 RISERS	3	PROVIDED	I
GUARDS (EBCNYS 805.11)	REQUIRED FOR ANY PORTION OF FLOOR > ABOVE FLOOR OR GRADE BELOW		PROVIDED	
ACCESSIBILITY / BCNYS CHAPTER 11	<b></b>			I
A FACILITY THAT IS ALTERED SHALL COMPLY WITH CHAPTER 11 OF THE BUILDING CODE OF NEW YORK			PROVIDED	I

			CHECKED BY: F.E. GOSHOW	DESIGN LEAD: E. BARBOE, P.E.	
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# COMPLIANCE NOTES

ATIONS SHALL CONFORM TO THE ENERGY ORK STATE ENERGY CONSERVATION CODE RUCTION ONLY.

ENERGY CONSERVATION CODE (NYCECC)

801.1)

NSULATION COMPONENT MINIMUM

ABOVE GRADE	R-9.5ci
BELOW GRADE	R-7.5 ci
S	R-10 ci
N-GRADE	R-10, 24"

MASS MASS UNHEATED SLAB

ATION MAXIMUM U-FACTOR AND SHGC

J-0.38 J-0.77

GE, BELIEF, AND PROFESSIONAL LANS AND SPECIFICATIONS ARE IN Y CODE.'

, AND REPORTS TO WHICH THE SEAL OF AN THERE SHALL ALSO BE APPLIED A STAMP WARNING THAT IT IS A VIOLATION OF THE ACTING UNDER THE DIRECTION OF A R AN ITEM IN ANY WAY. IF AN ITEM BEARING LTERED, THE ALTERING ARCHITECT SHALL D THE NOTATION "ALTERED BY" FOLLOWED TE OF SUCH ALTERATION, AND A SPECIFIC ON

	1 HR FIRE RATING
••••	COMMON PATH OF EGRESS TRAVEL
	EGRESS PATH TRAVEL DISTANCE
$\overline{\bigotimes}$	EXIT SIGN
xxx •	- ALLOWABLE OCCUPANTS

-	
<u> </u>	CALCULATED OCCUPANTS
Ś	TRAVEL DISTANCE

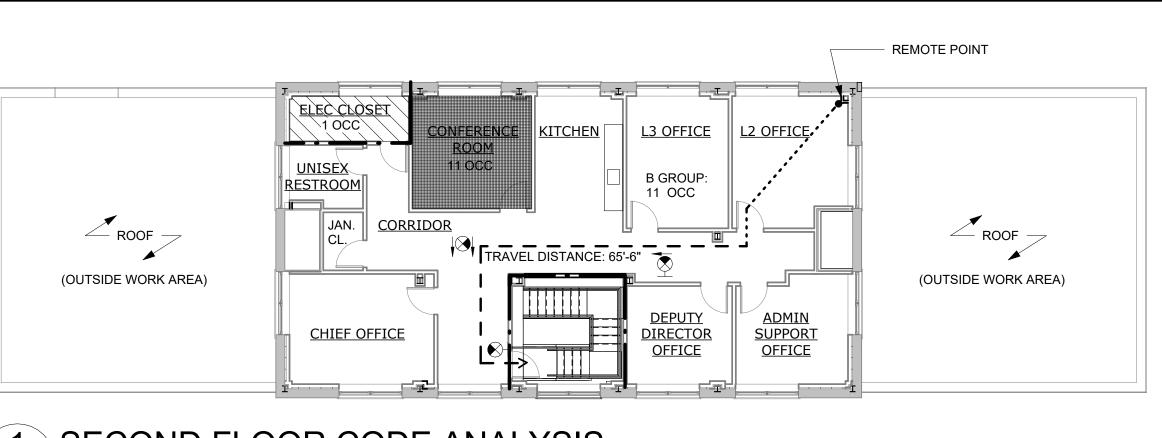
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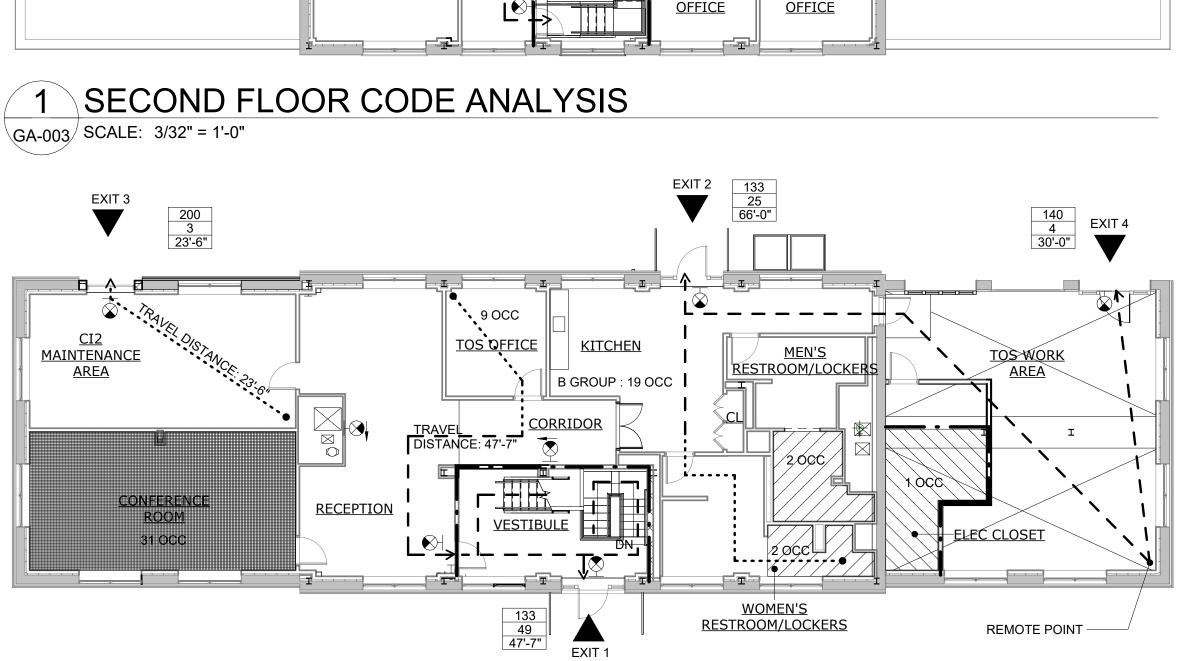
: 150 SF GROSS

(UNCONCENTRATED): 15 SF NET

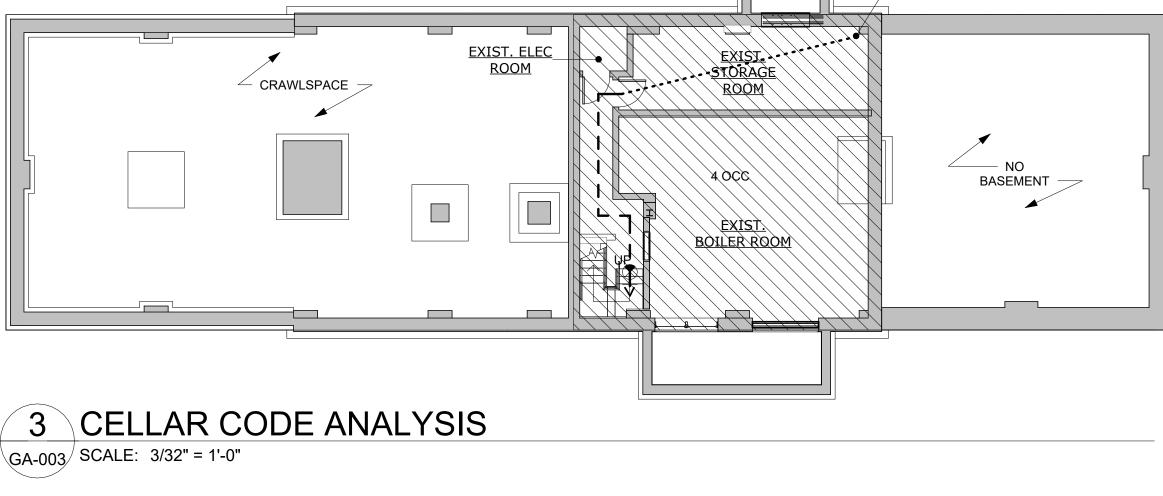
: 50 SF GROSS

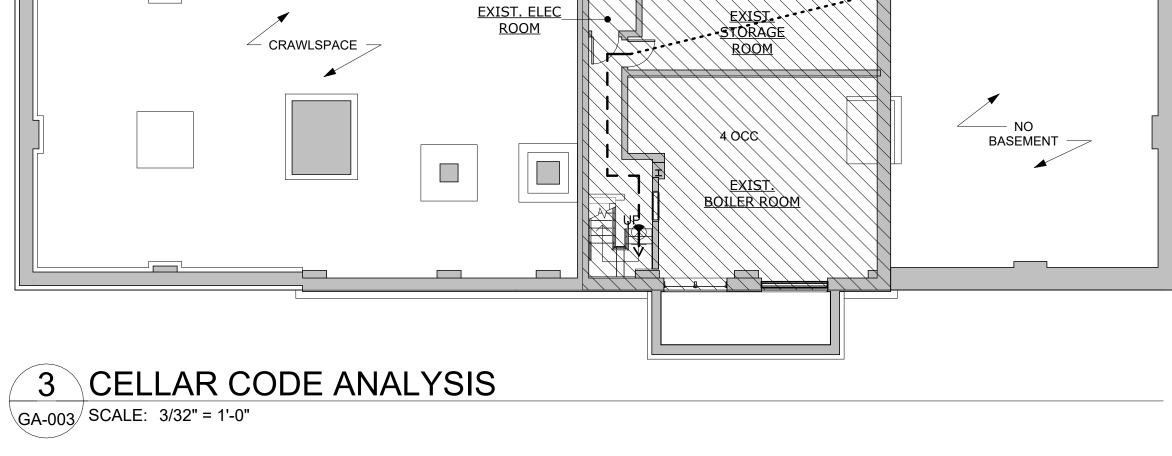
RY STORAGE/MECH: 300 SF GROSS













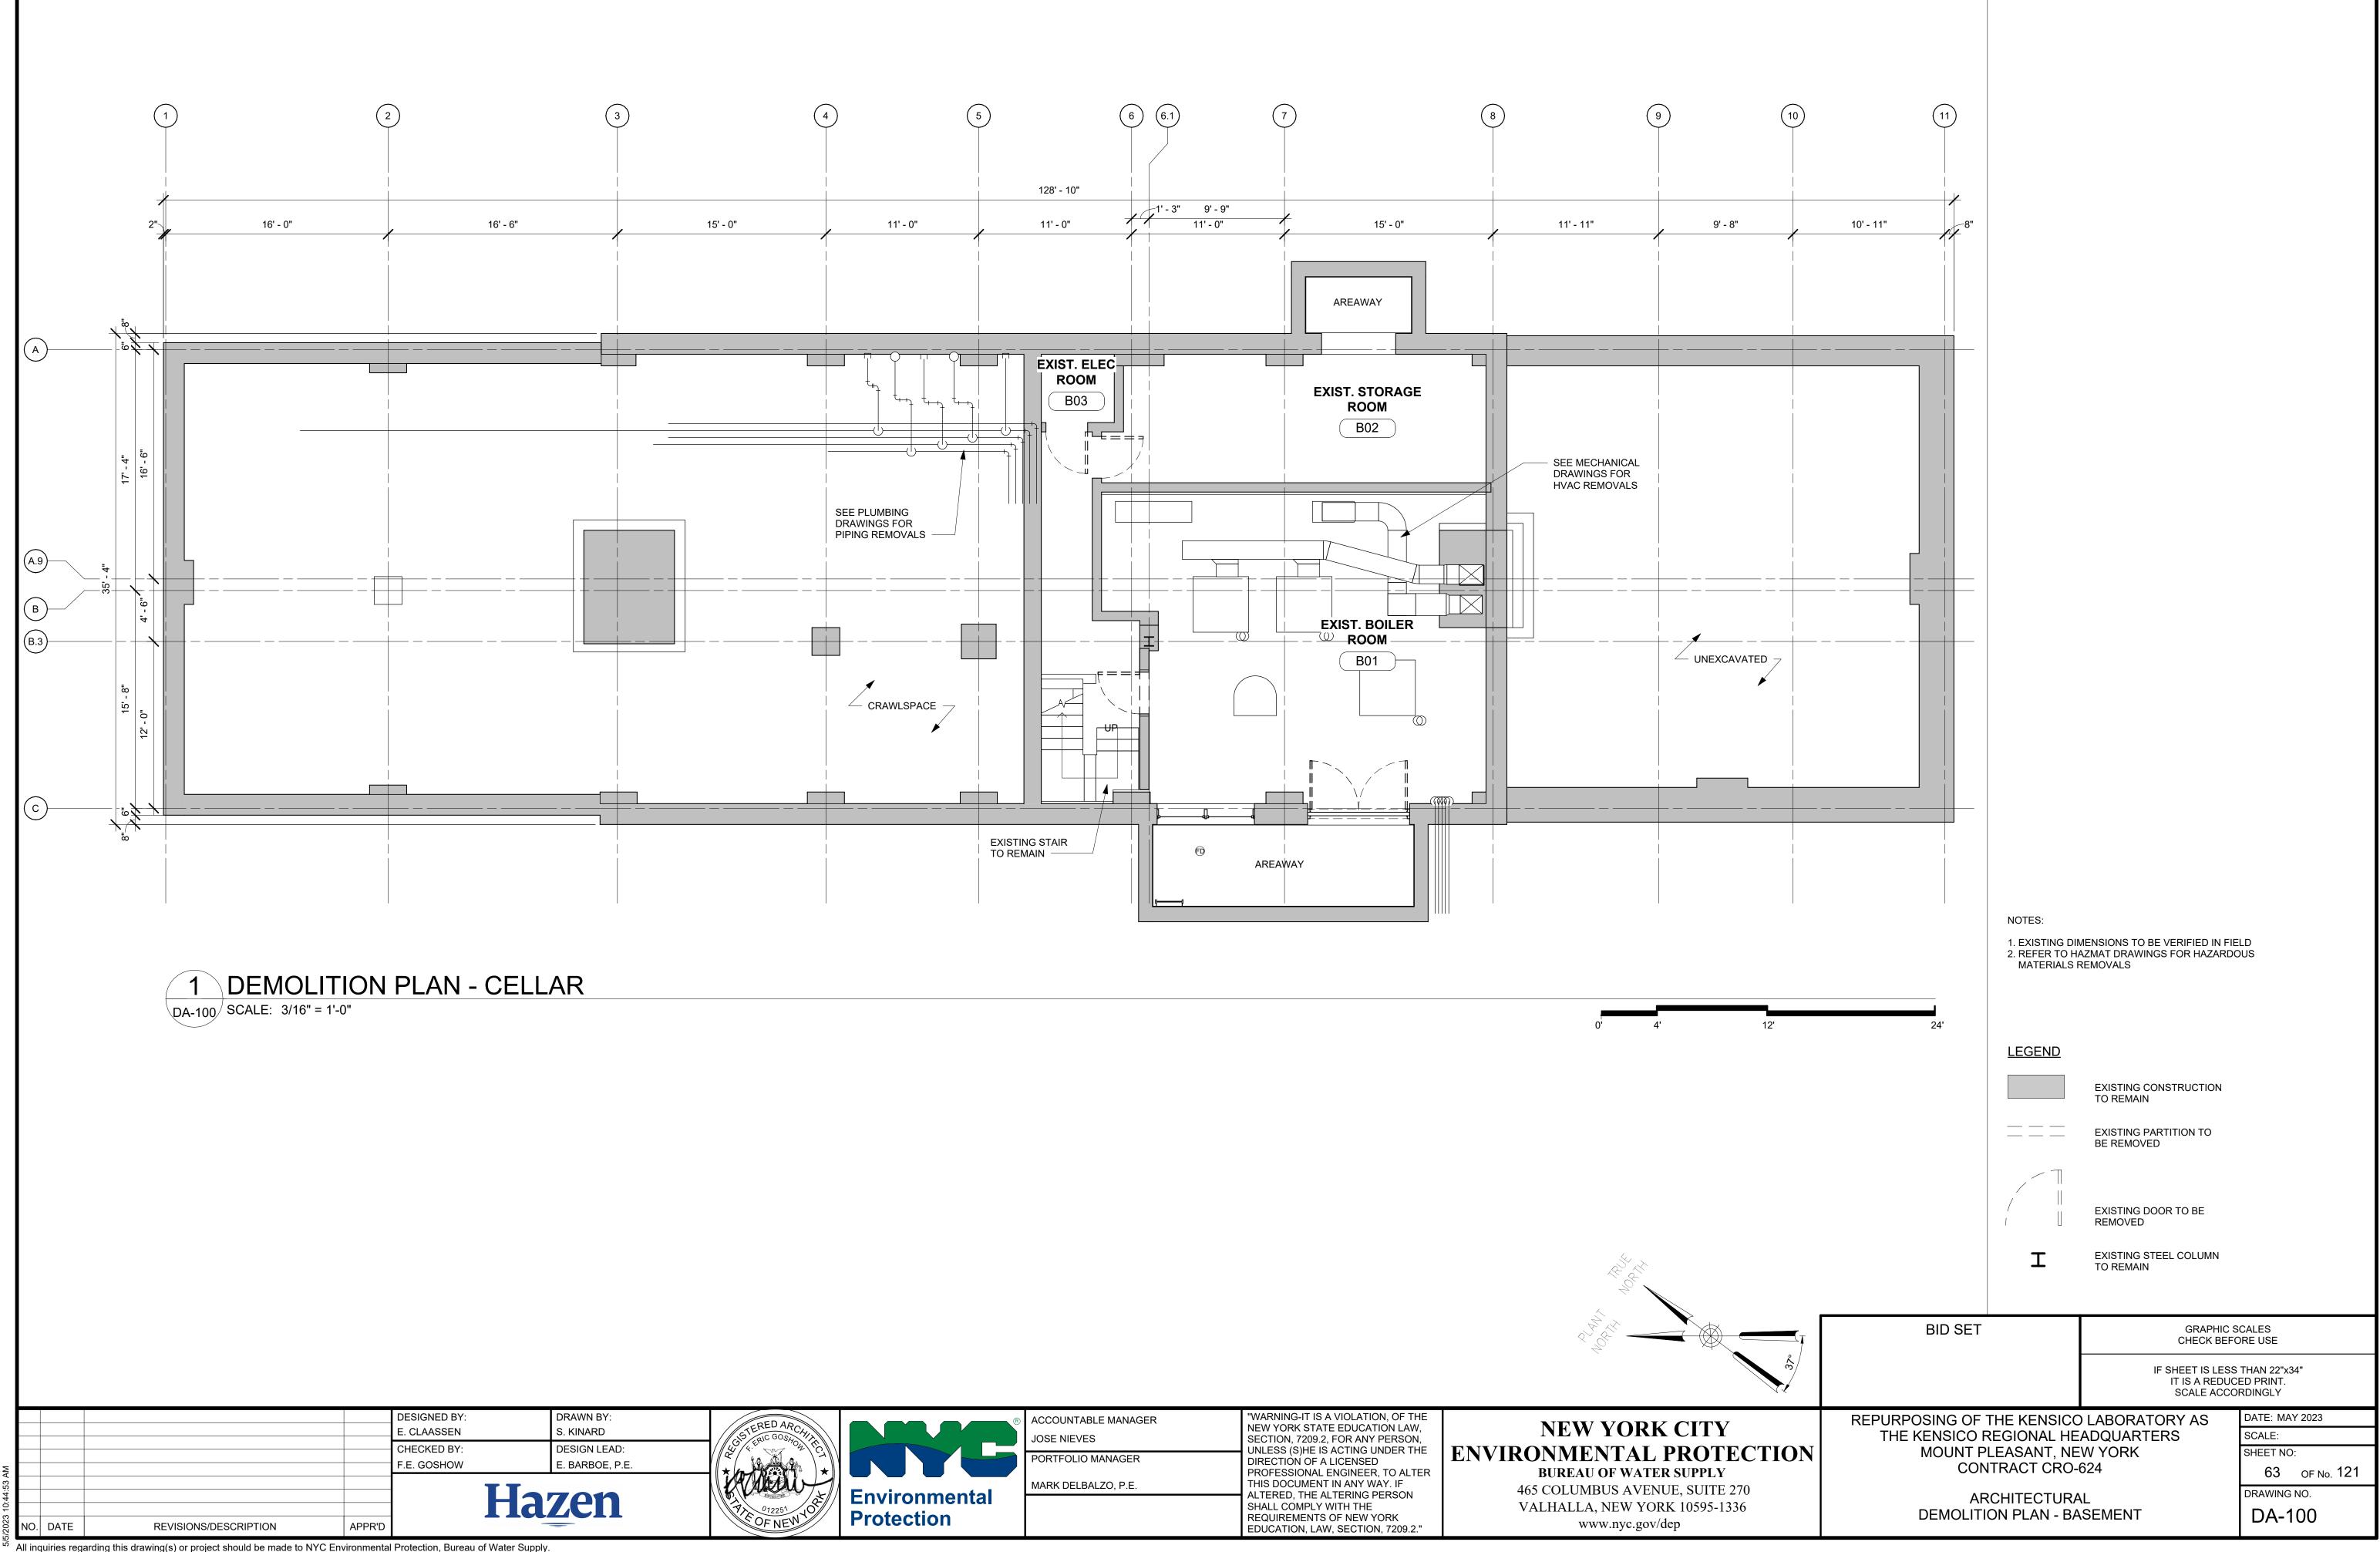
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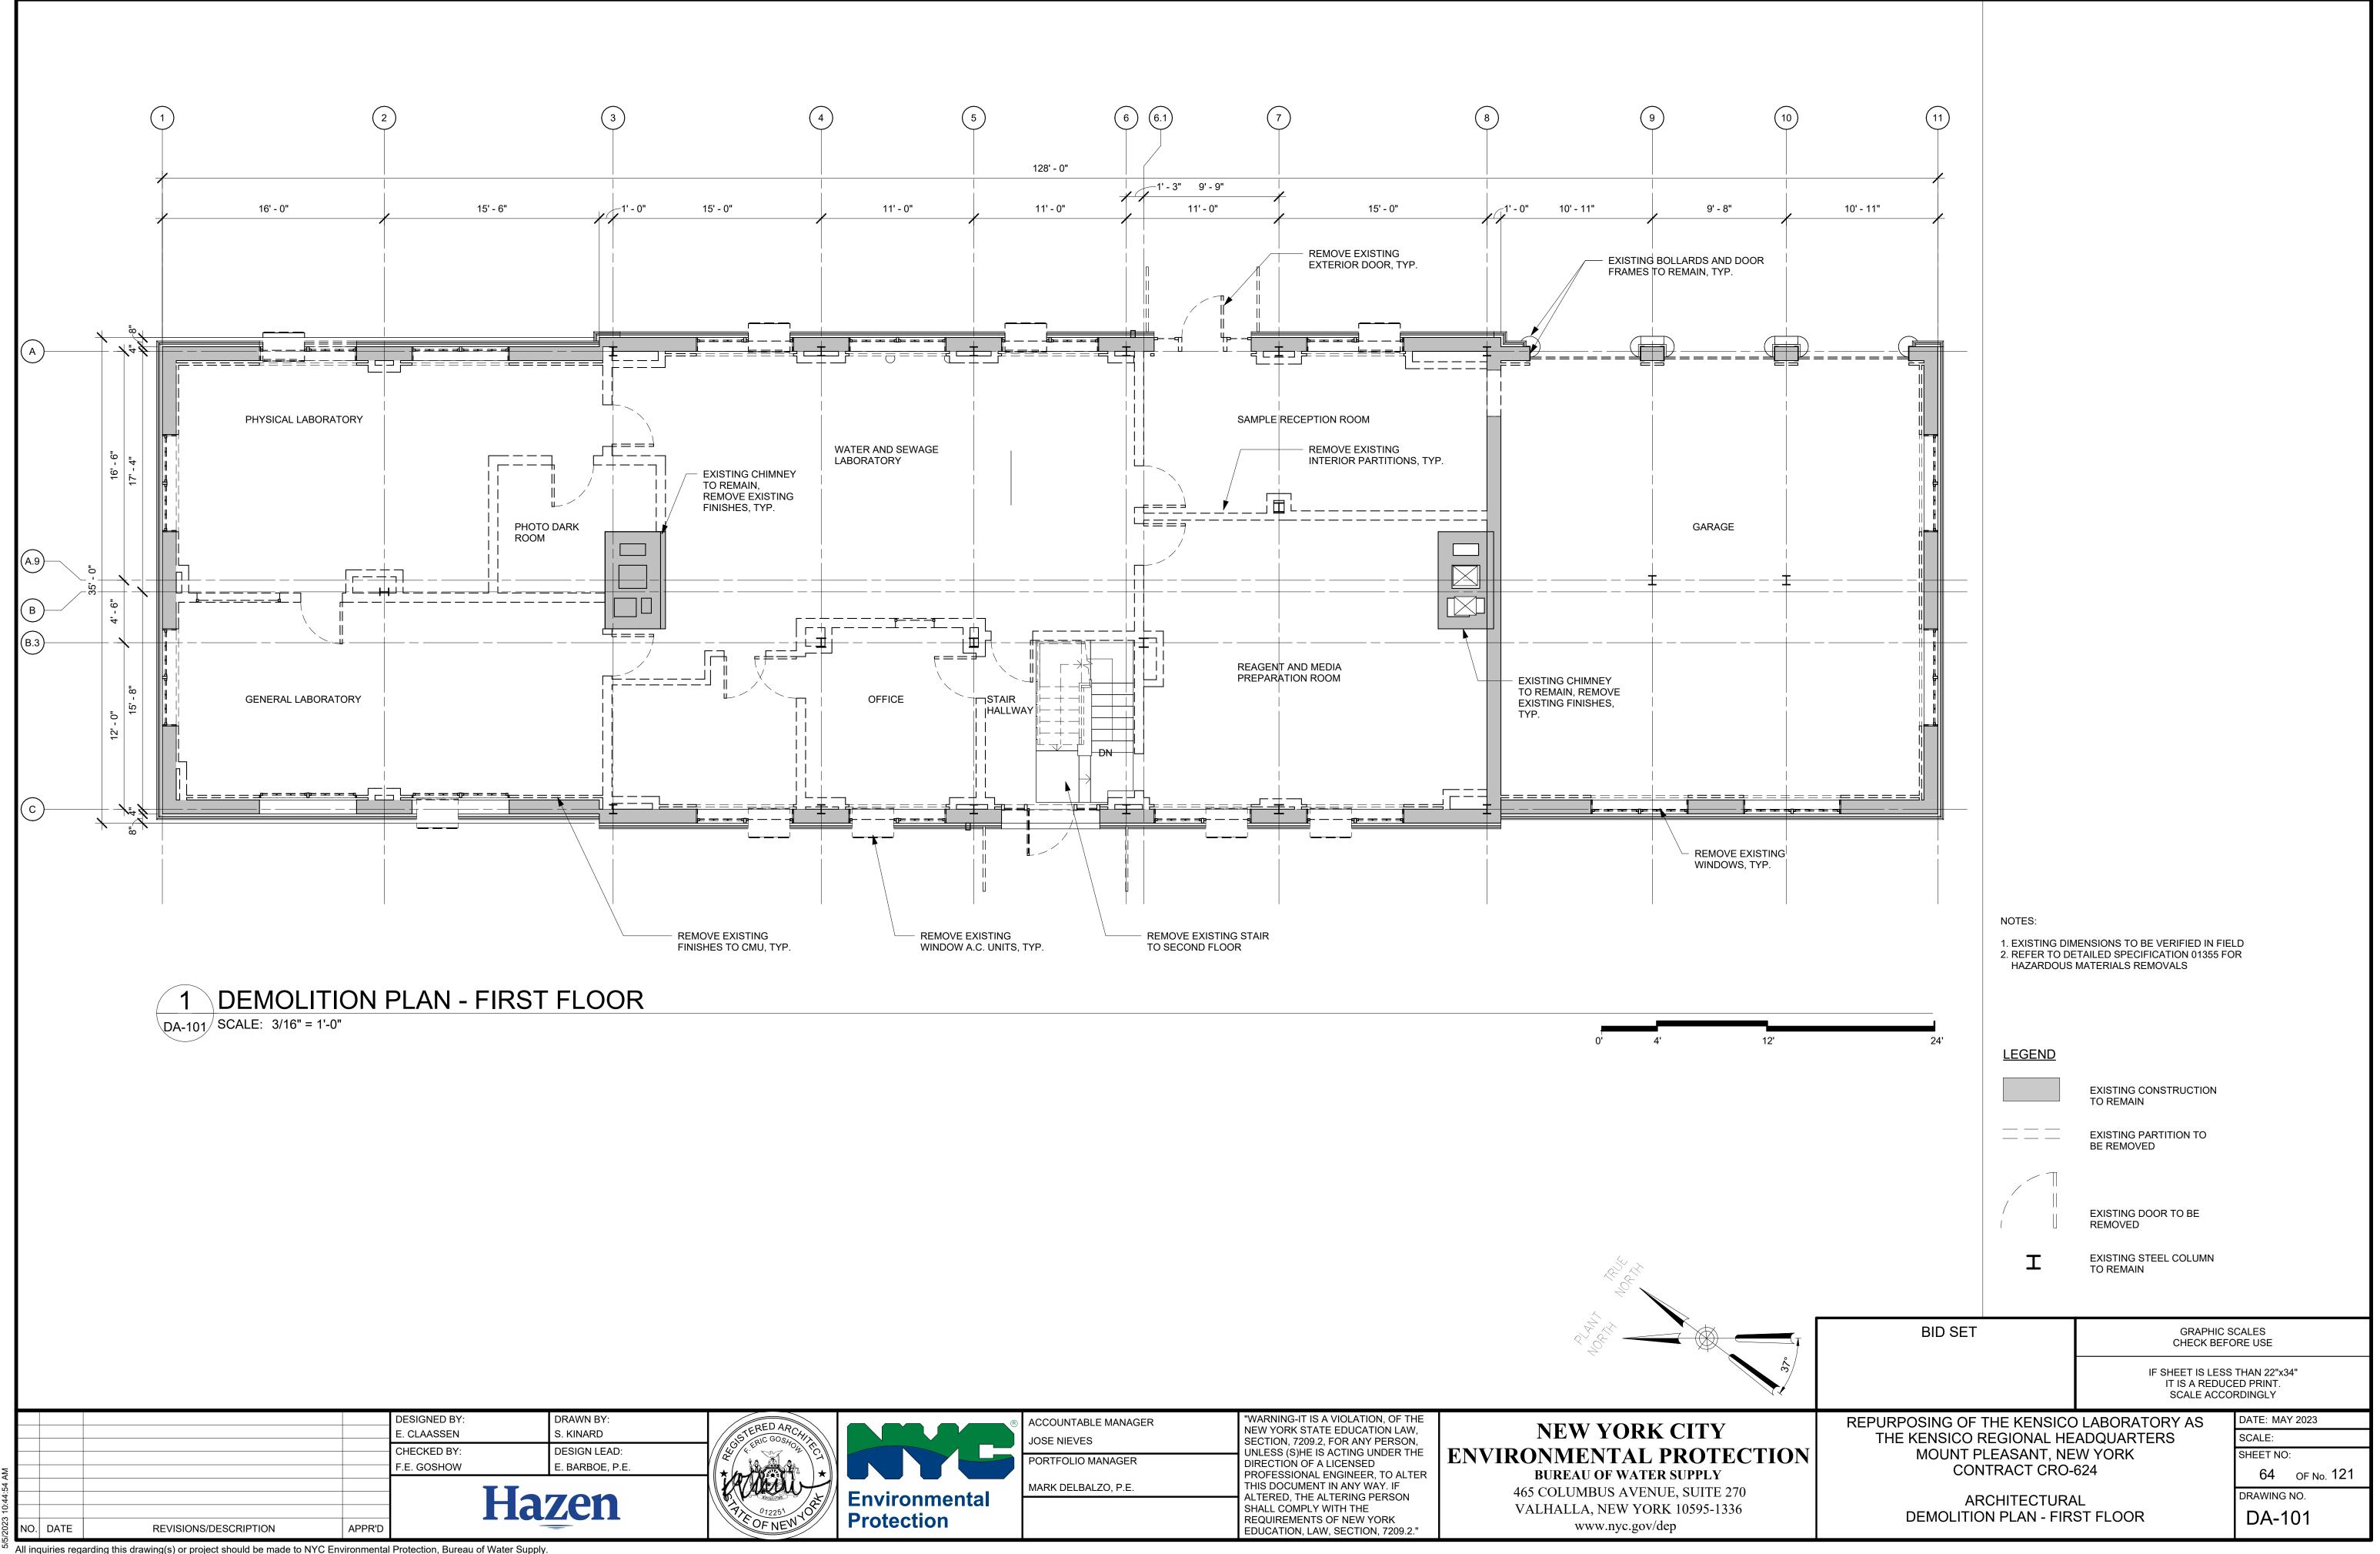
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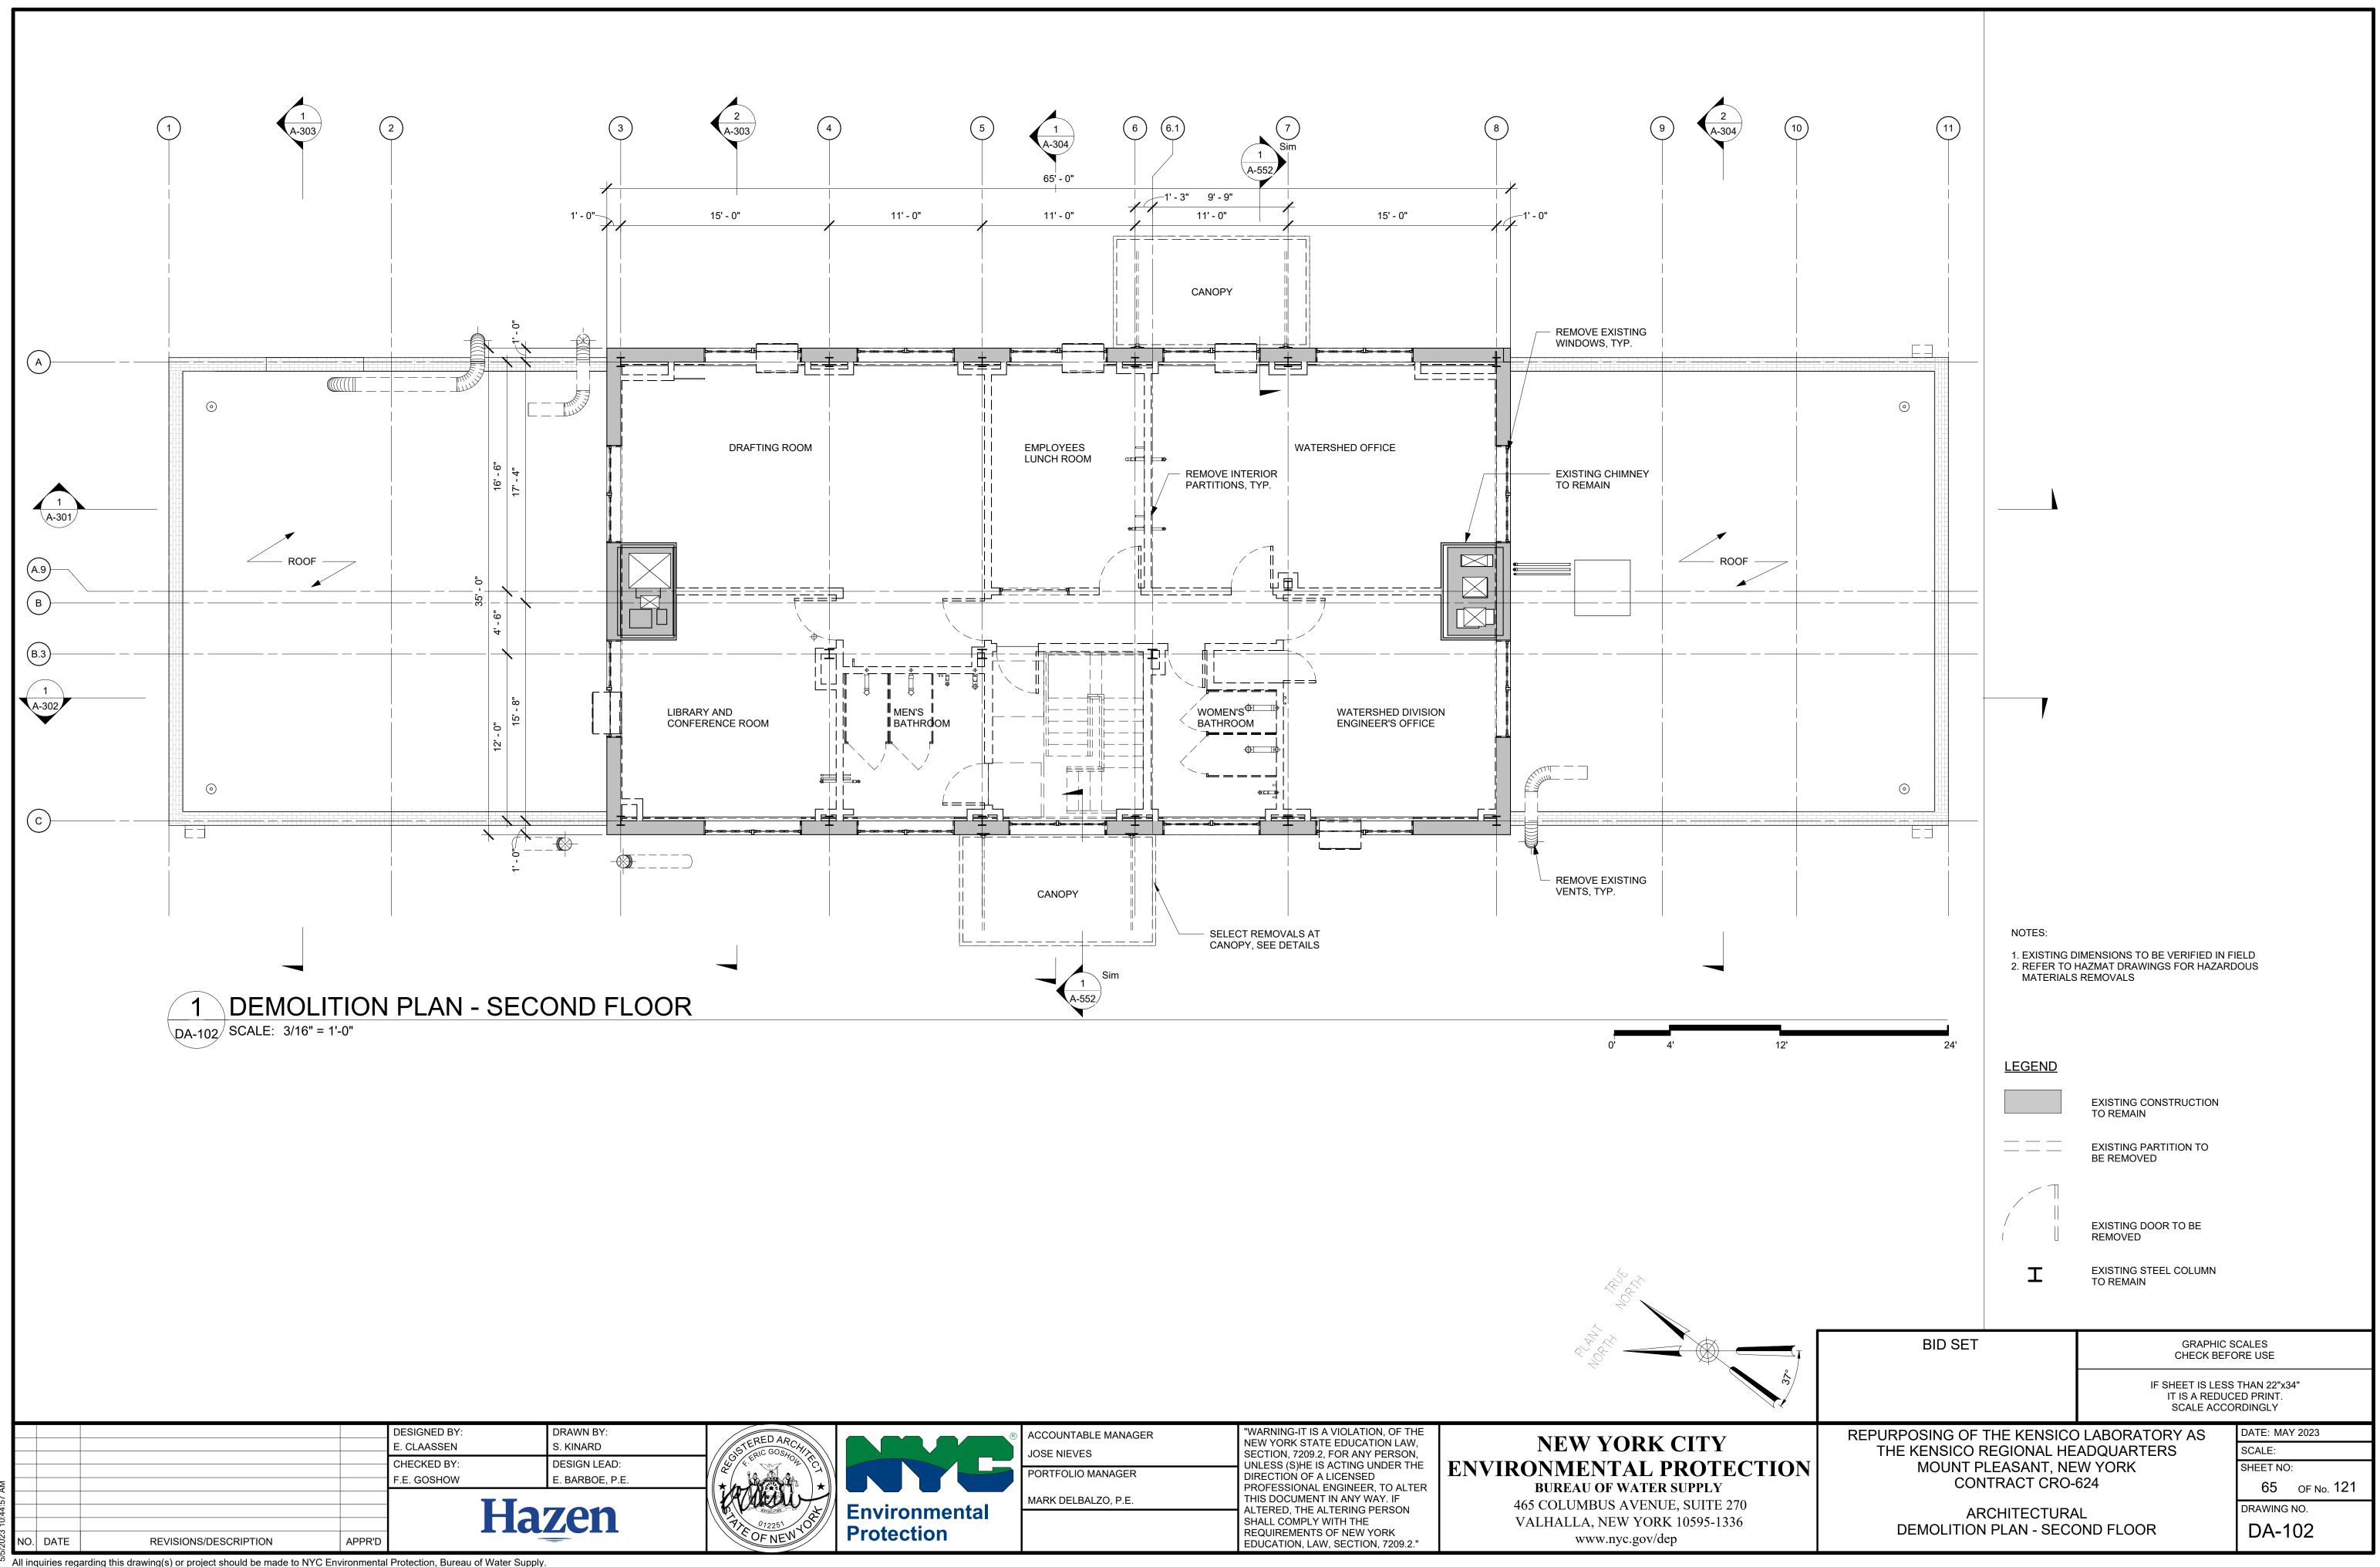
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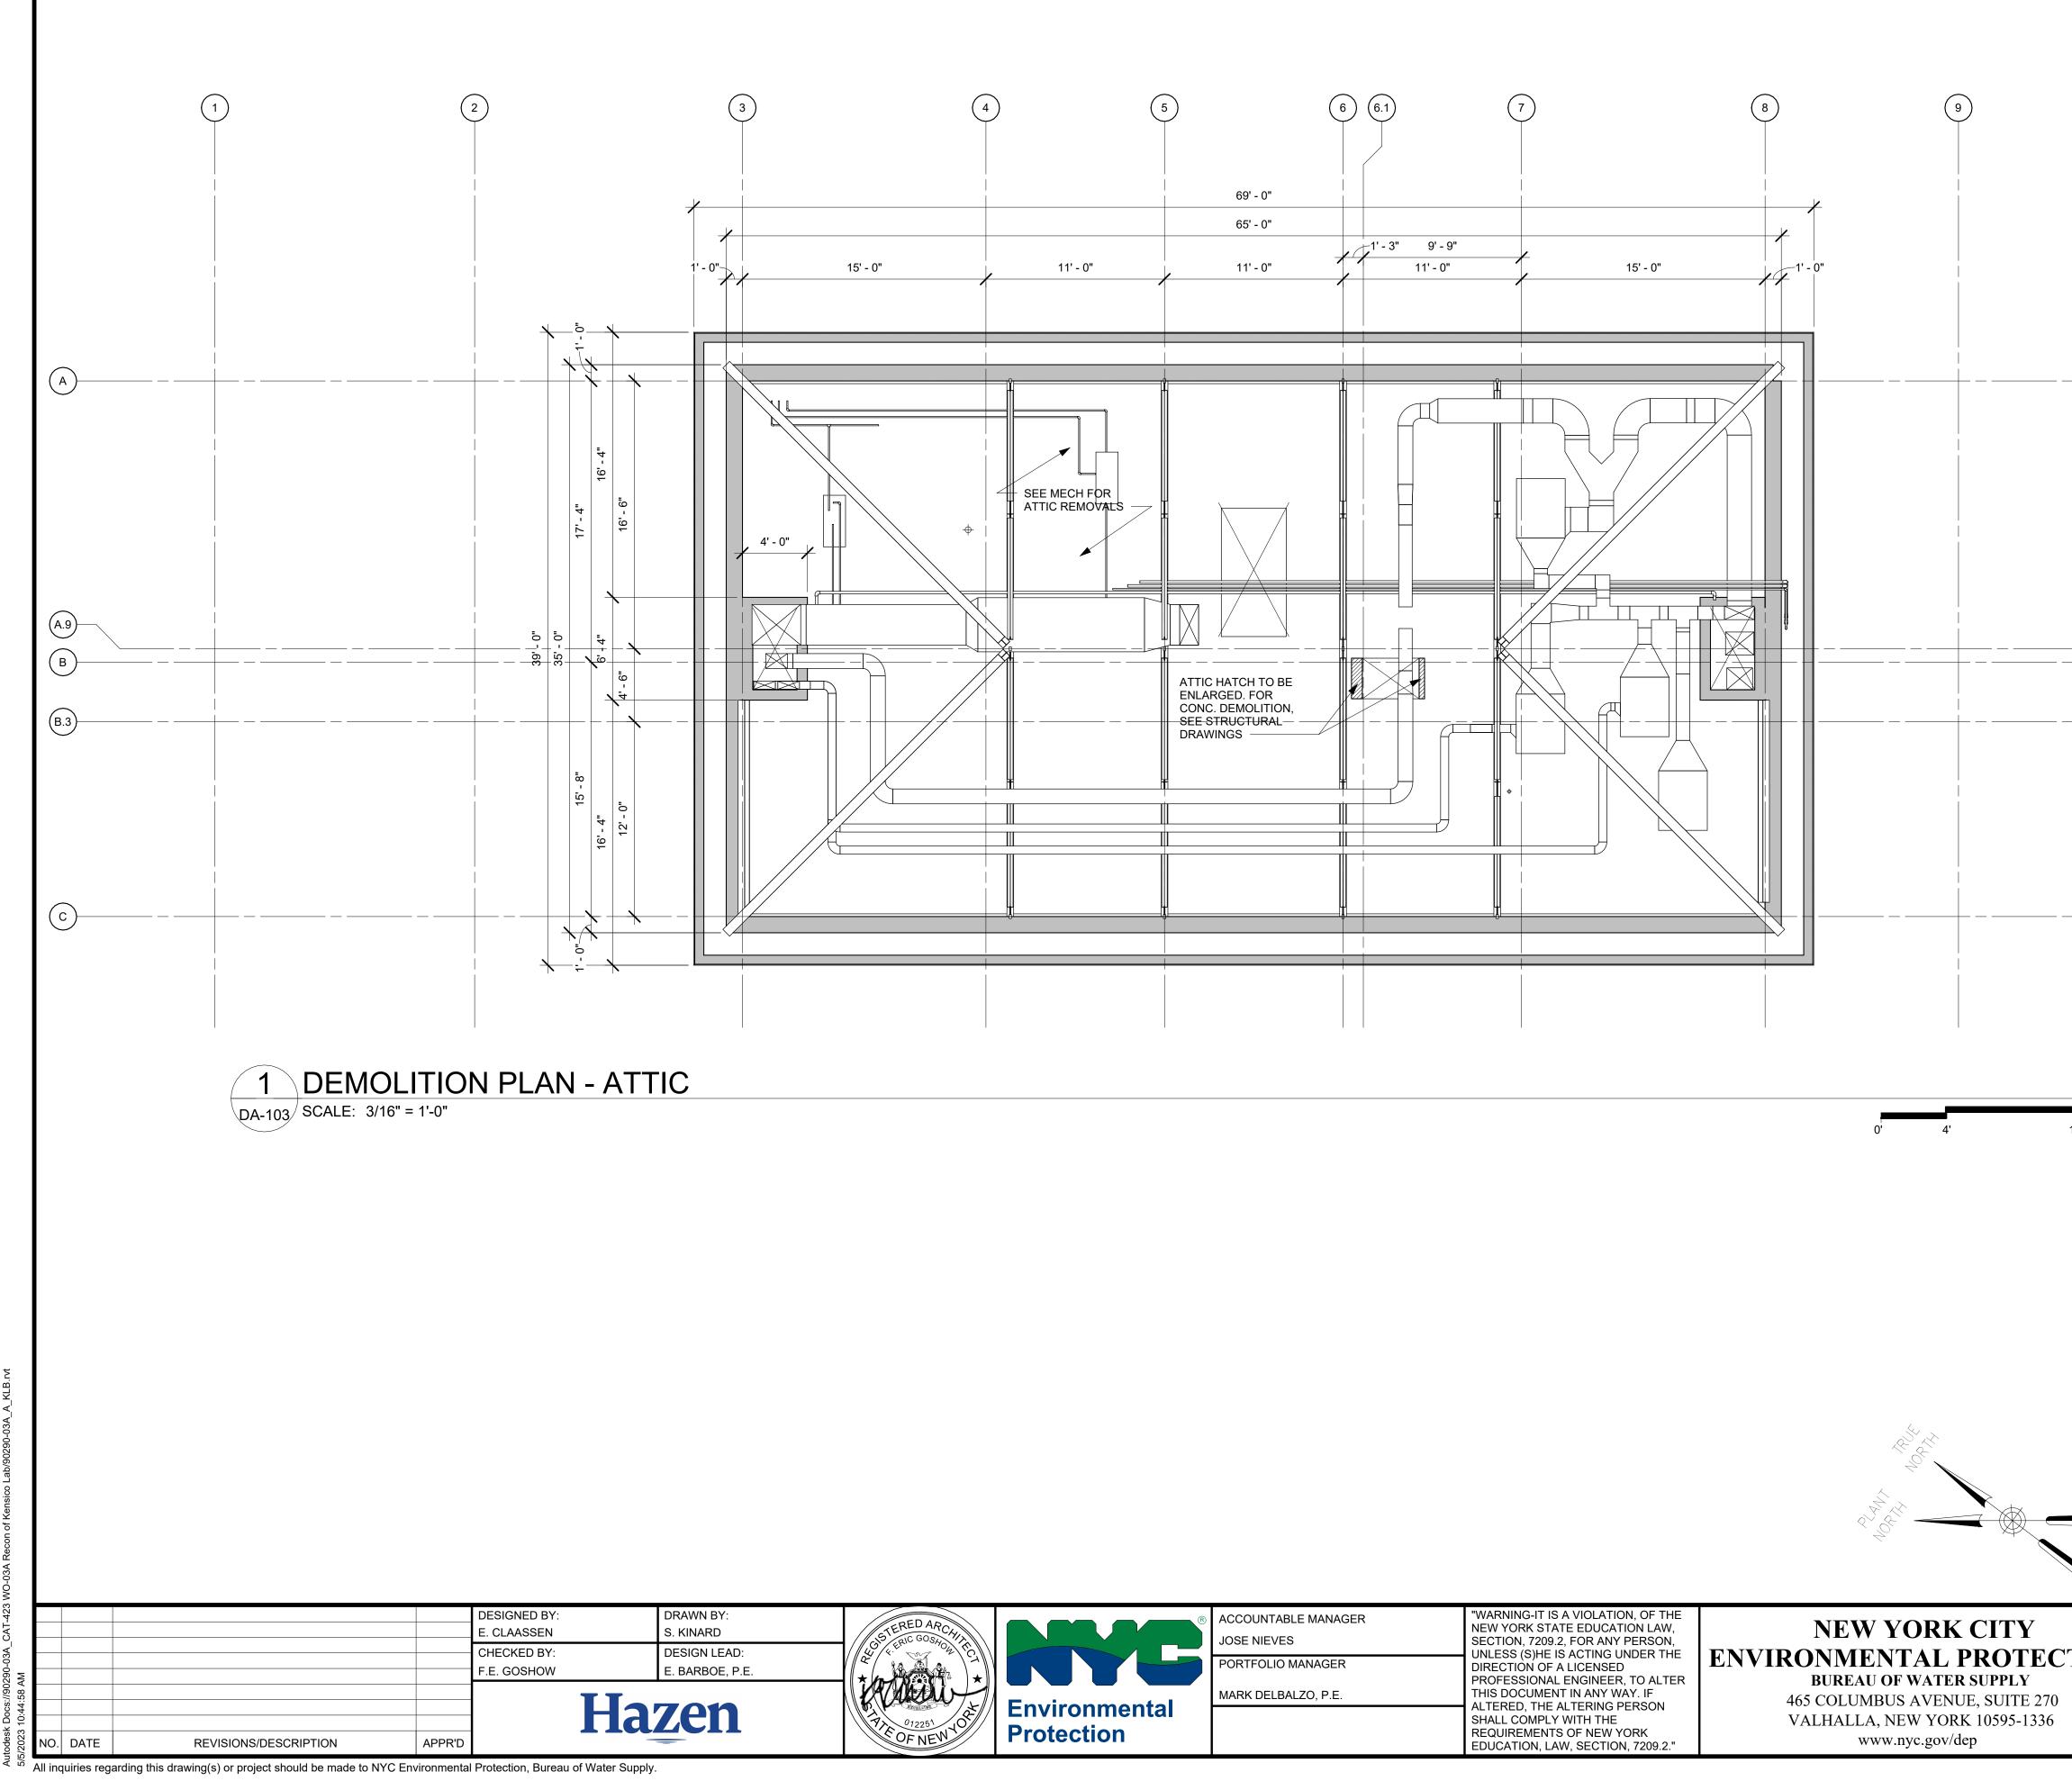
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CTION	REPURPOSING OF THE KENSICO THE KENSICO REGIONAL HE MOUNT PLEASANT, NE CONTRACT CRO-	ADQUARTERS W YORK	DATE: MAY 2023 SCALE: SHEET NO: 62 OF No. 121
	ARCHITECTURAL CODE ANALYSIS		
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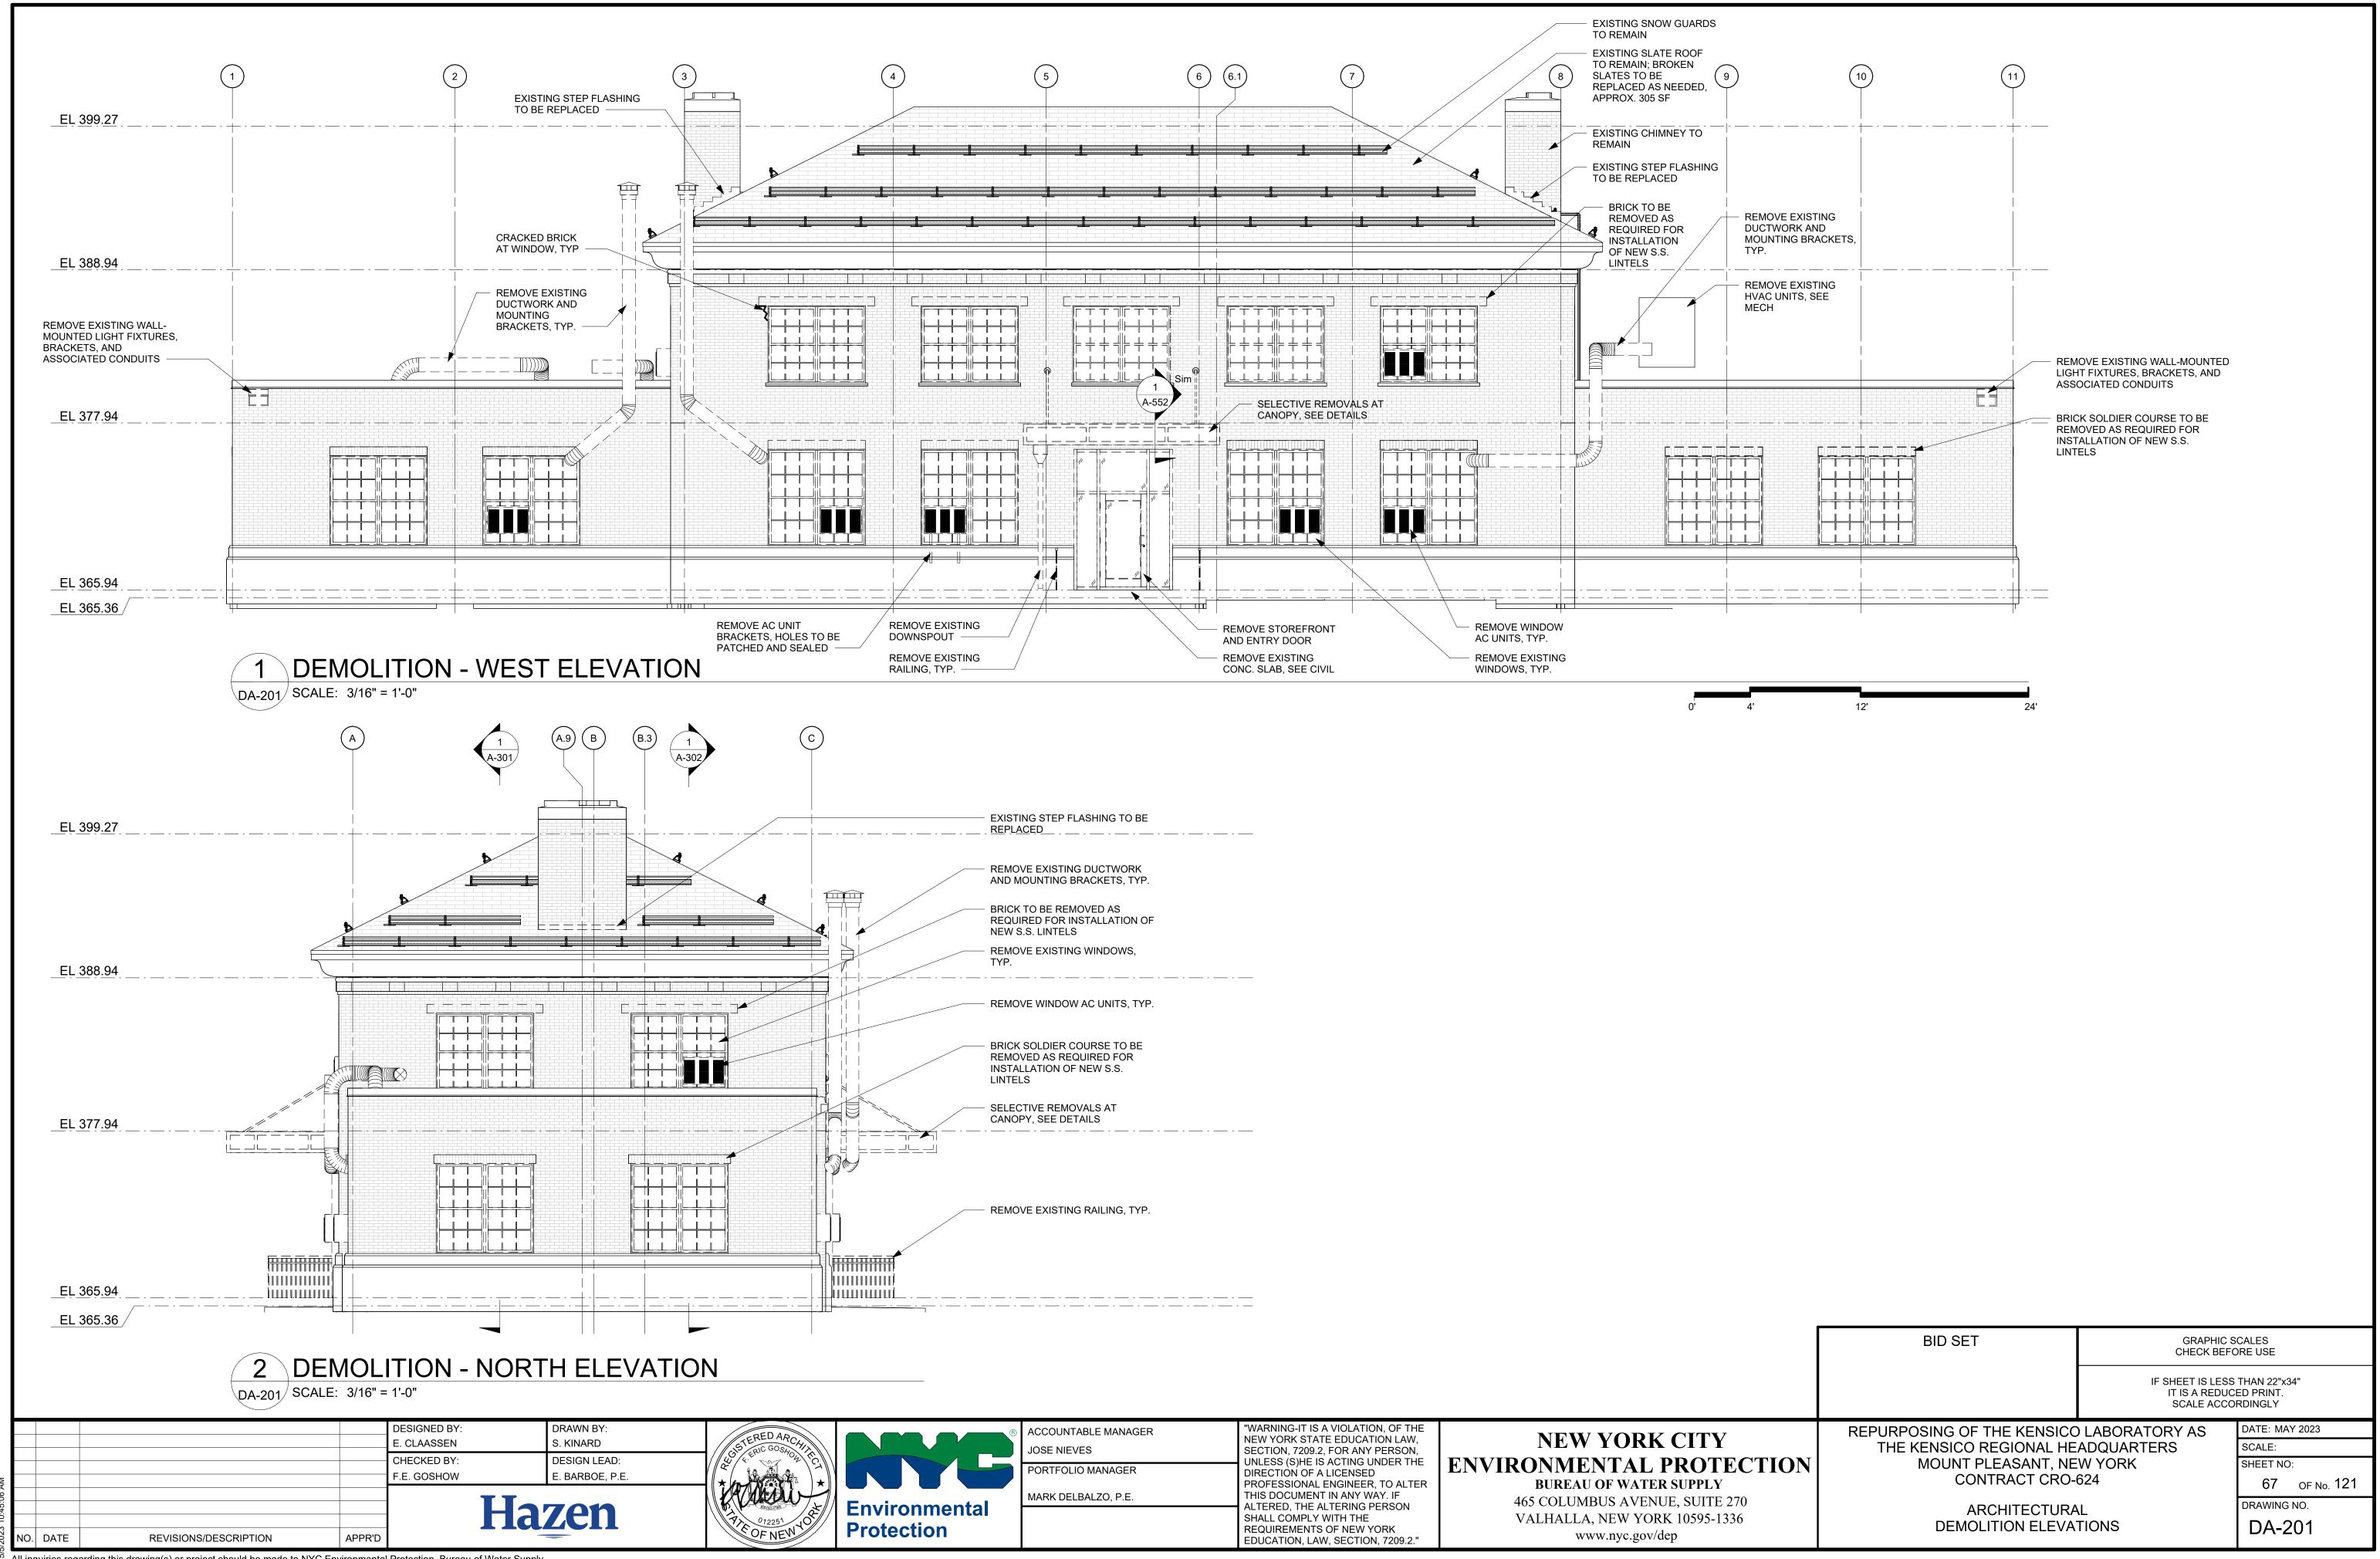










	(11)			
_				
_				
12'		2. REFER TO H	IMENSIONS TO BE VERIFIED IN F IAZMAT DRAWINGS FOR HAZARE REMOVALS	
		LEGEND	EXISTING CONSTRUCTION TO REMAIN	
		===	EXISTING PARTITION TO BE REMOVED	
			EXISTING DOOR TO BE REMOVED	
		I	EXISTING STEEL COLUMN TO REMAIN	
3%	BID SET		GRAPHIC S CHECK BEF( IF SHEET IS LESS	THAN 22"x34"
				RDINGLY DATE: MAY 2023
TION		REGIONAL HE LEASANT, NE ITRACT CRO-(	W YORK	SCALE: SHEET NO: 66 OF No. 121
		CHITECTURA ITION PLAN -		drawing no. DA-103



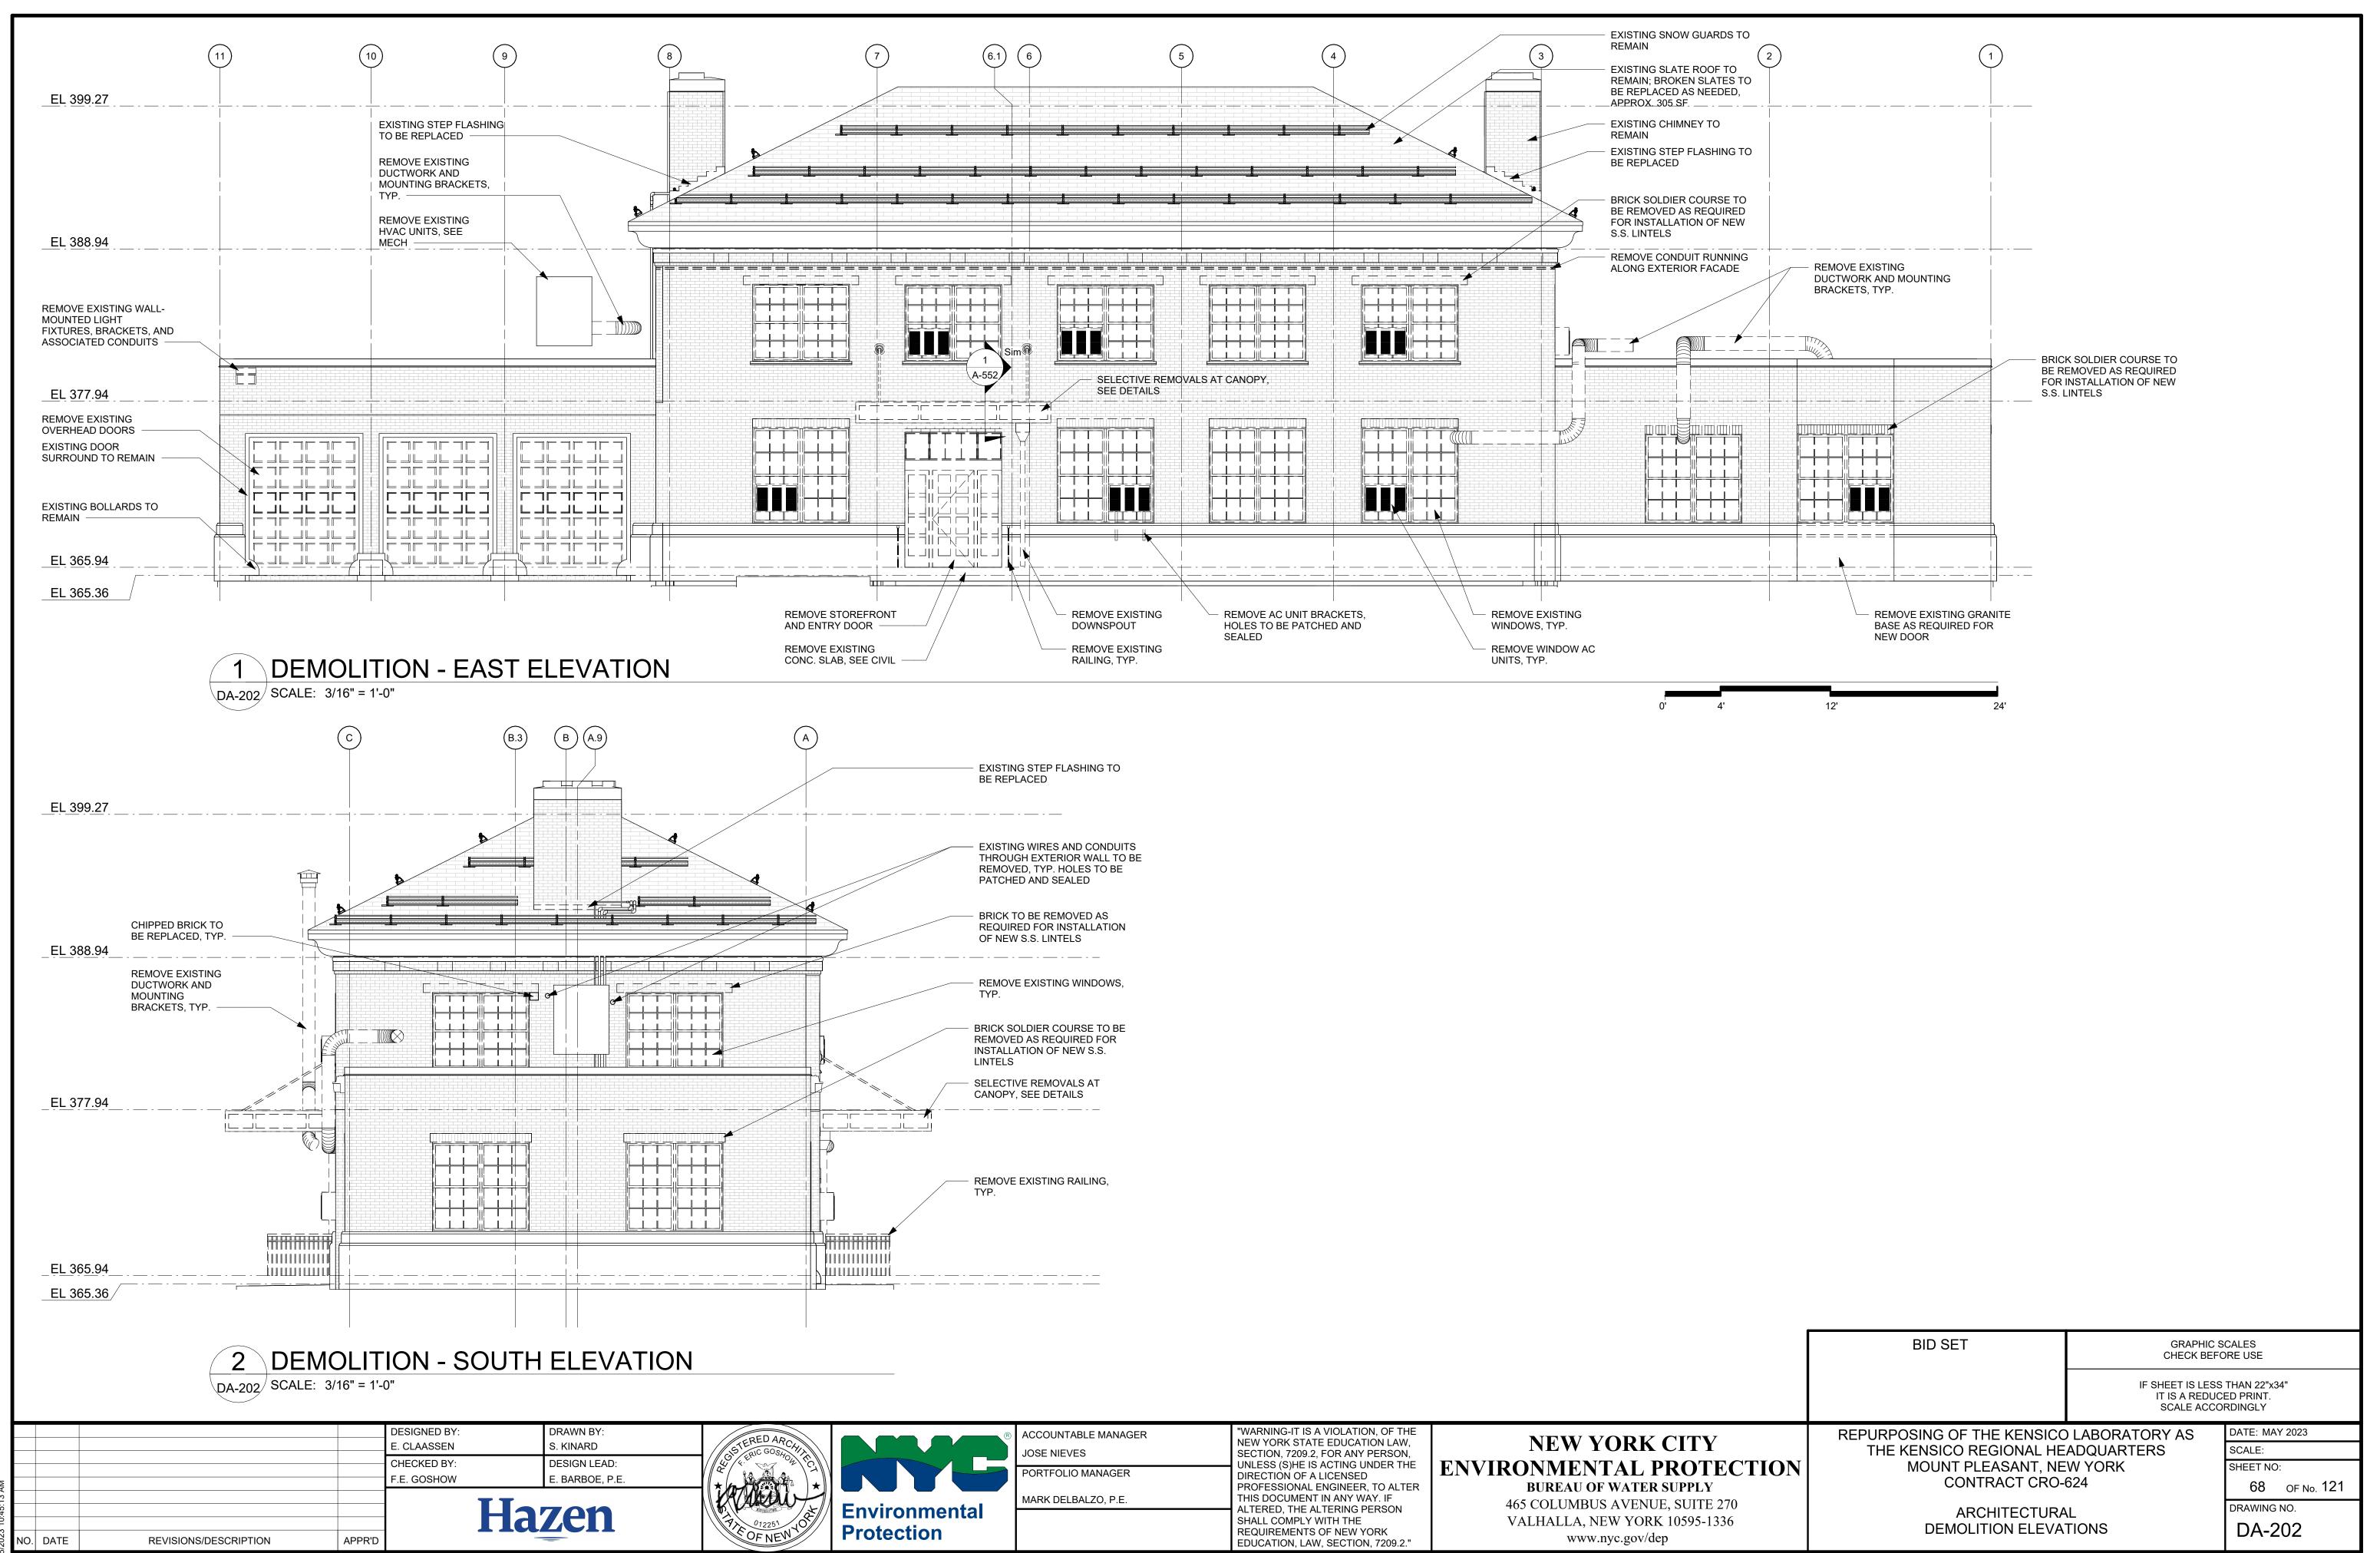


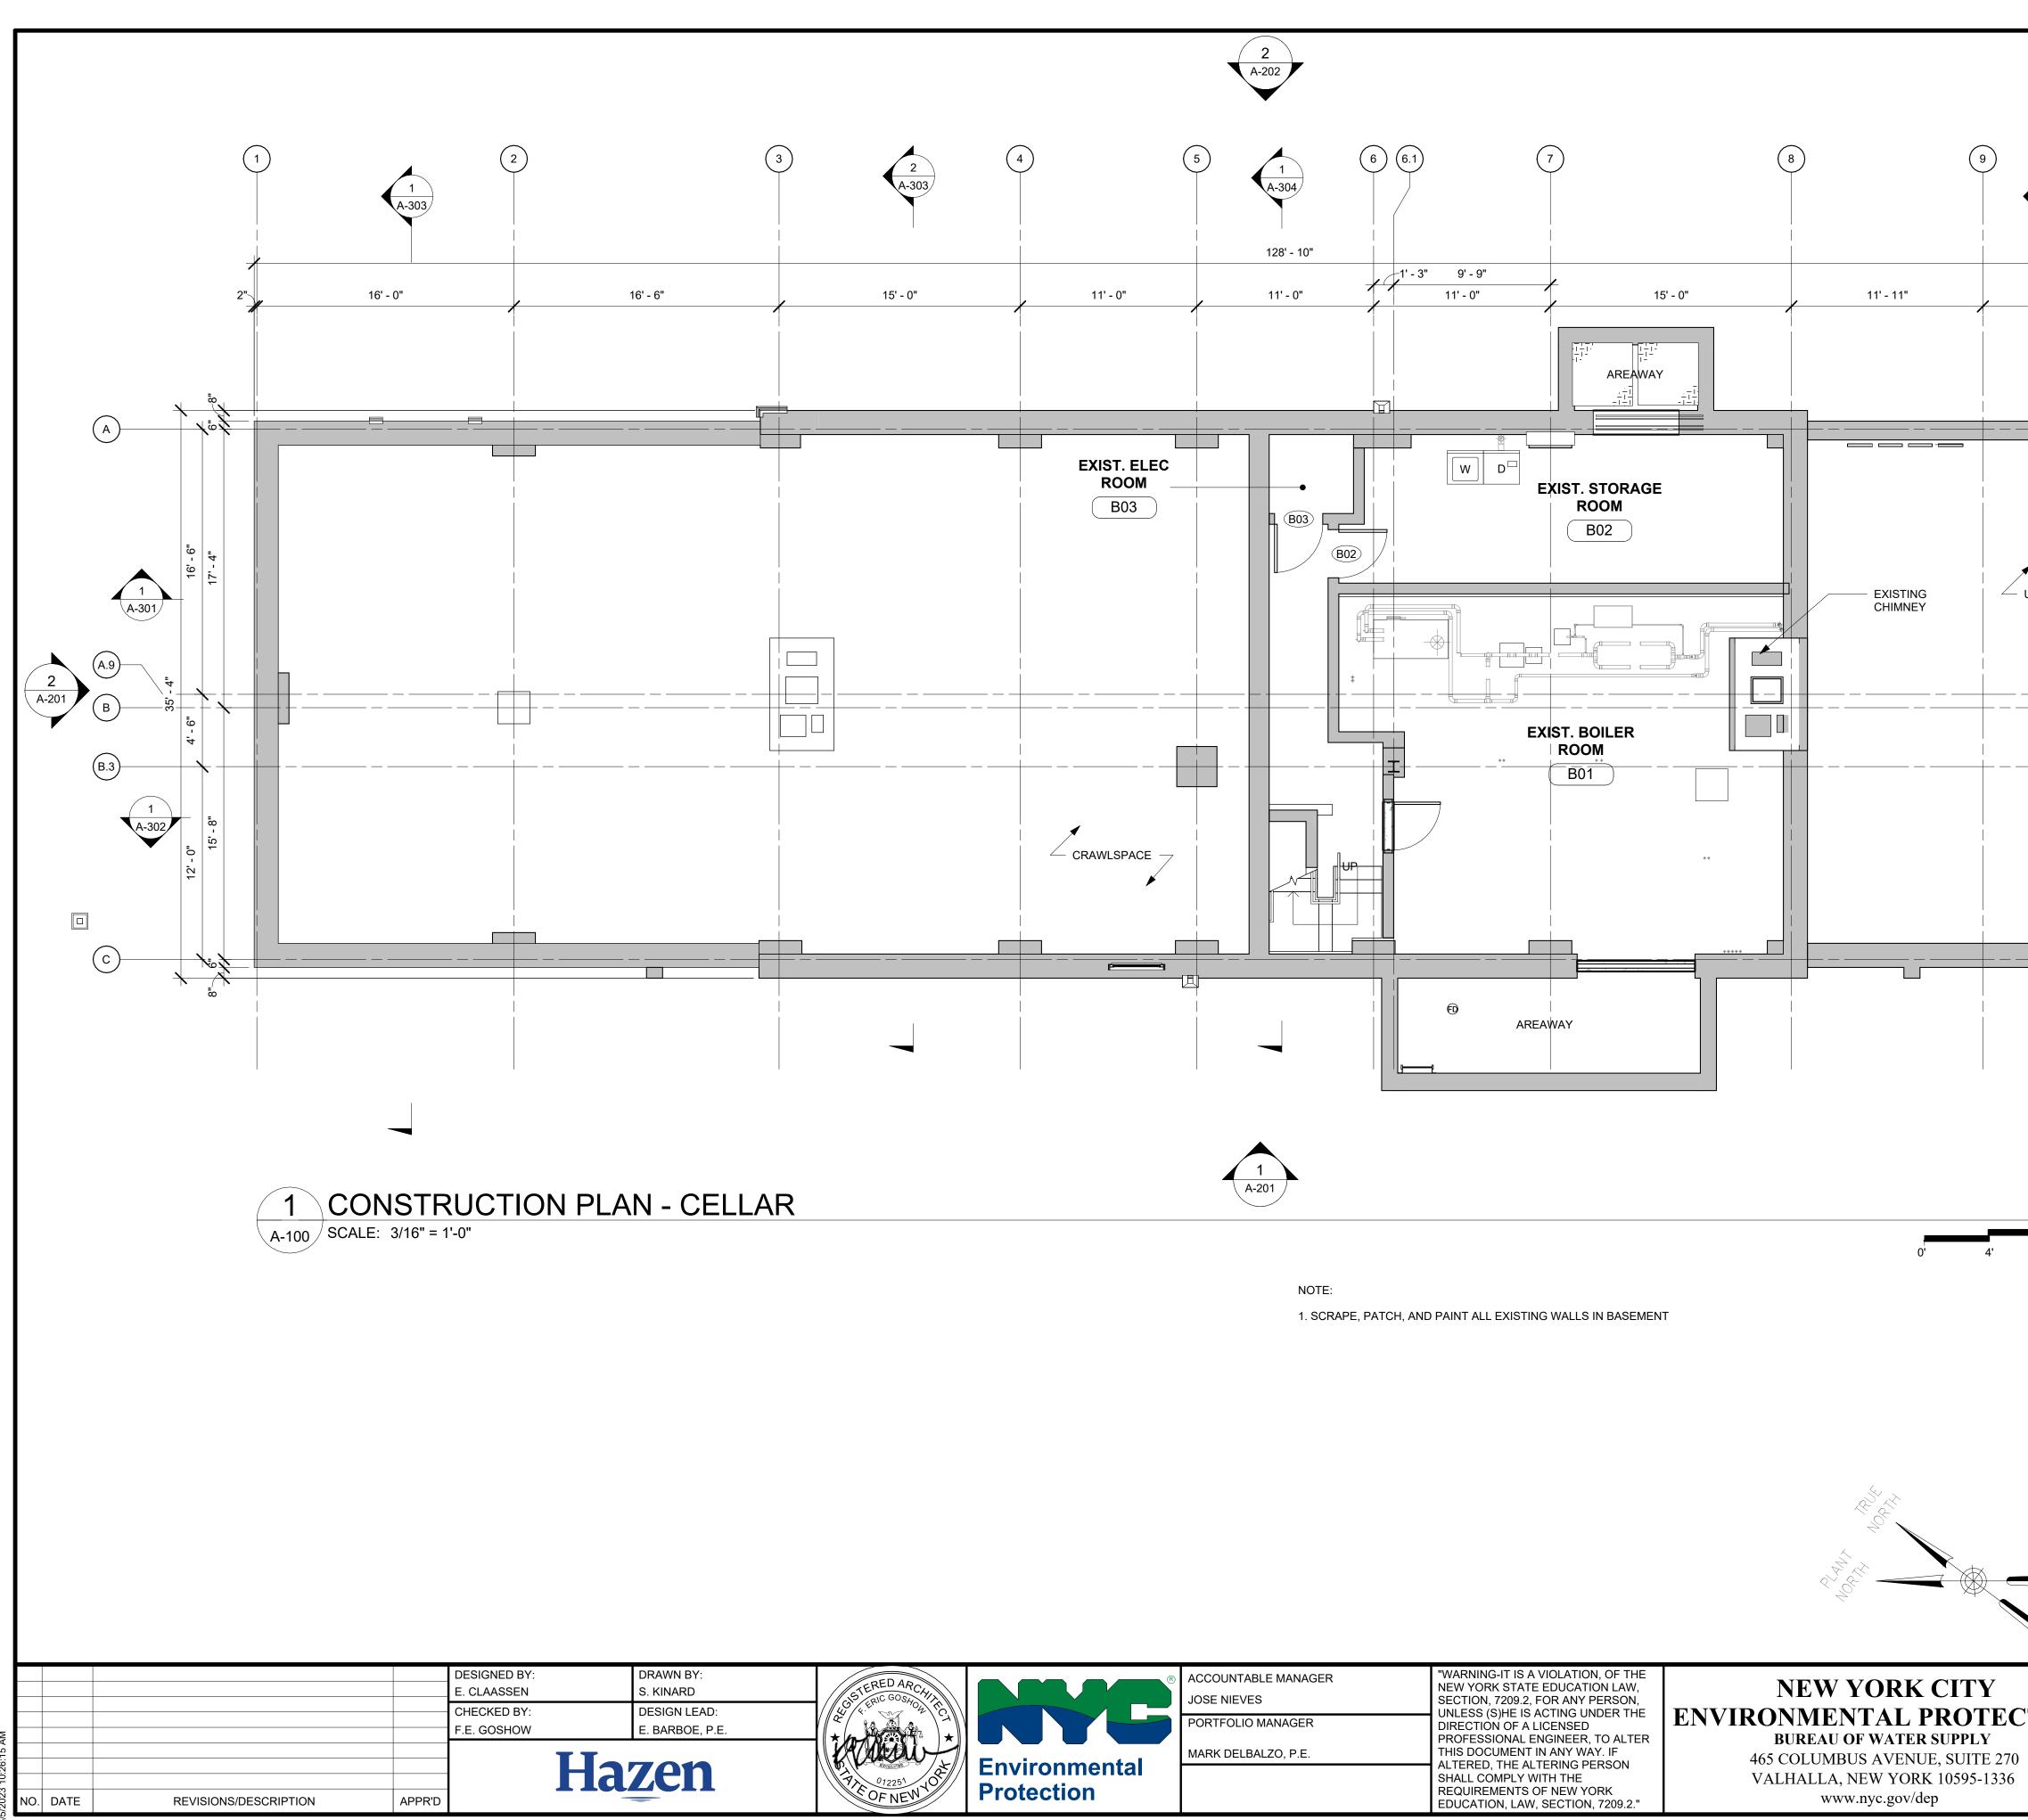ACCOUNTABLE MANAGER
JOSE NIEVES
PORTFOLIO MANAGER
MARK DELBALZO, P.E.




ACCOUNTABLE MANAGER
JOSE NIEVES
PORTFOLIO MANAGER
MARK DELBALZO, P.E.

9' - 8"			
UNEXCAVATE			
320	BID SET	GRAPHIC S CHECK BEFC IF SHEET IS LESS IT IS A REDUCE SCALE ACCOR	PRE USE THAN 22"x34" ED PRINT.
CTION	REPURPOSING OF THE KENSICO THE KENSICO REGIONAL HE MOUNT PLEASANT, NE CONTRACT CRO- ARCHITECTURA CONSTRUCTION PLAN	D LABORATORY AS ADQUARTERS W YORK 624 AL	DATE: MAY 2023 SCALE: SHEET NO: 69 OF No. 121 DRAWING NO. A-100

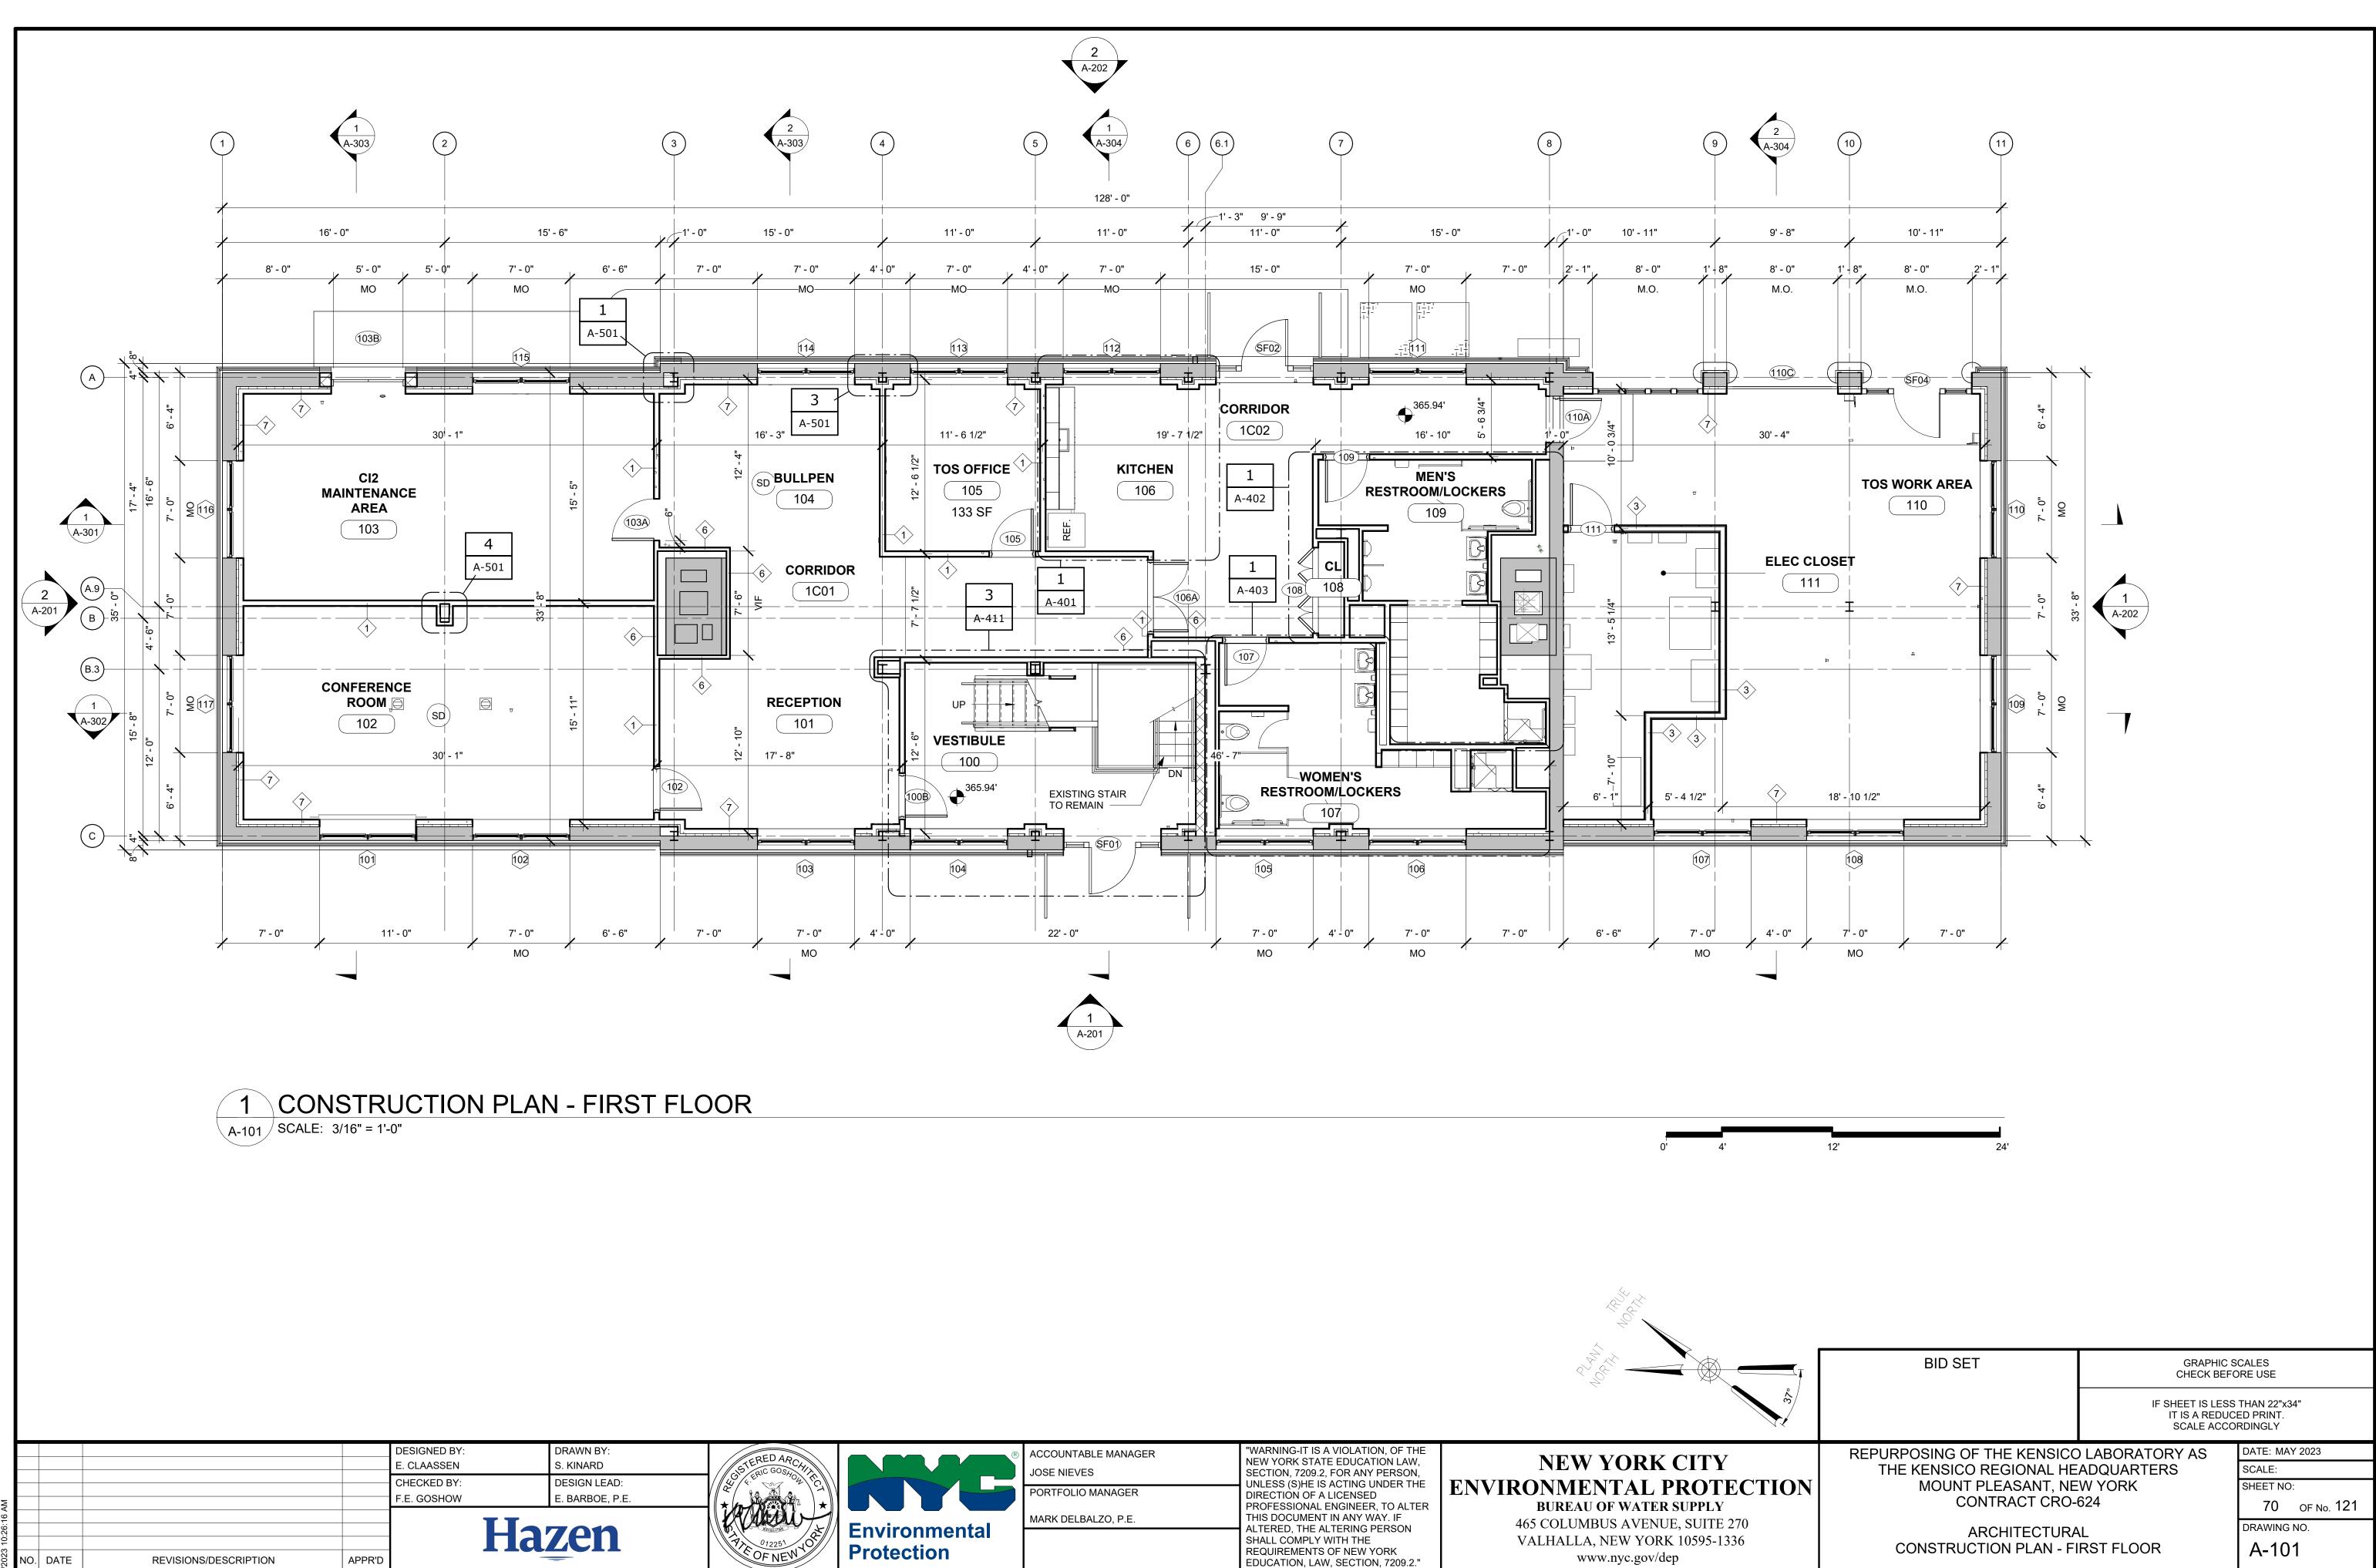


All inquiries regarding this drawing(s) or project should be made to NYC Environmental Protection, Bureau of Water Supply.

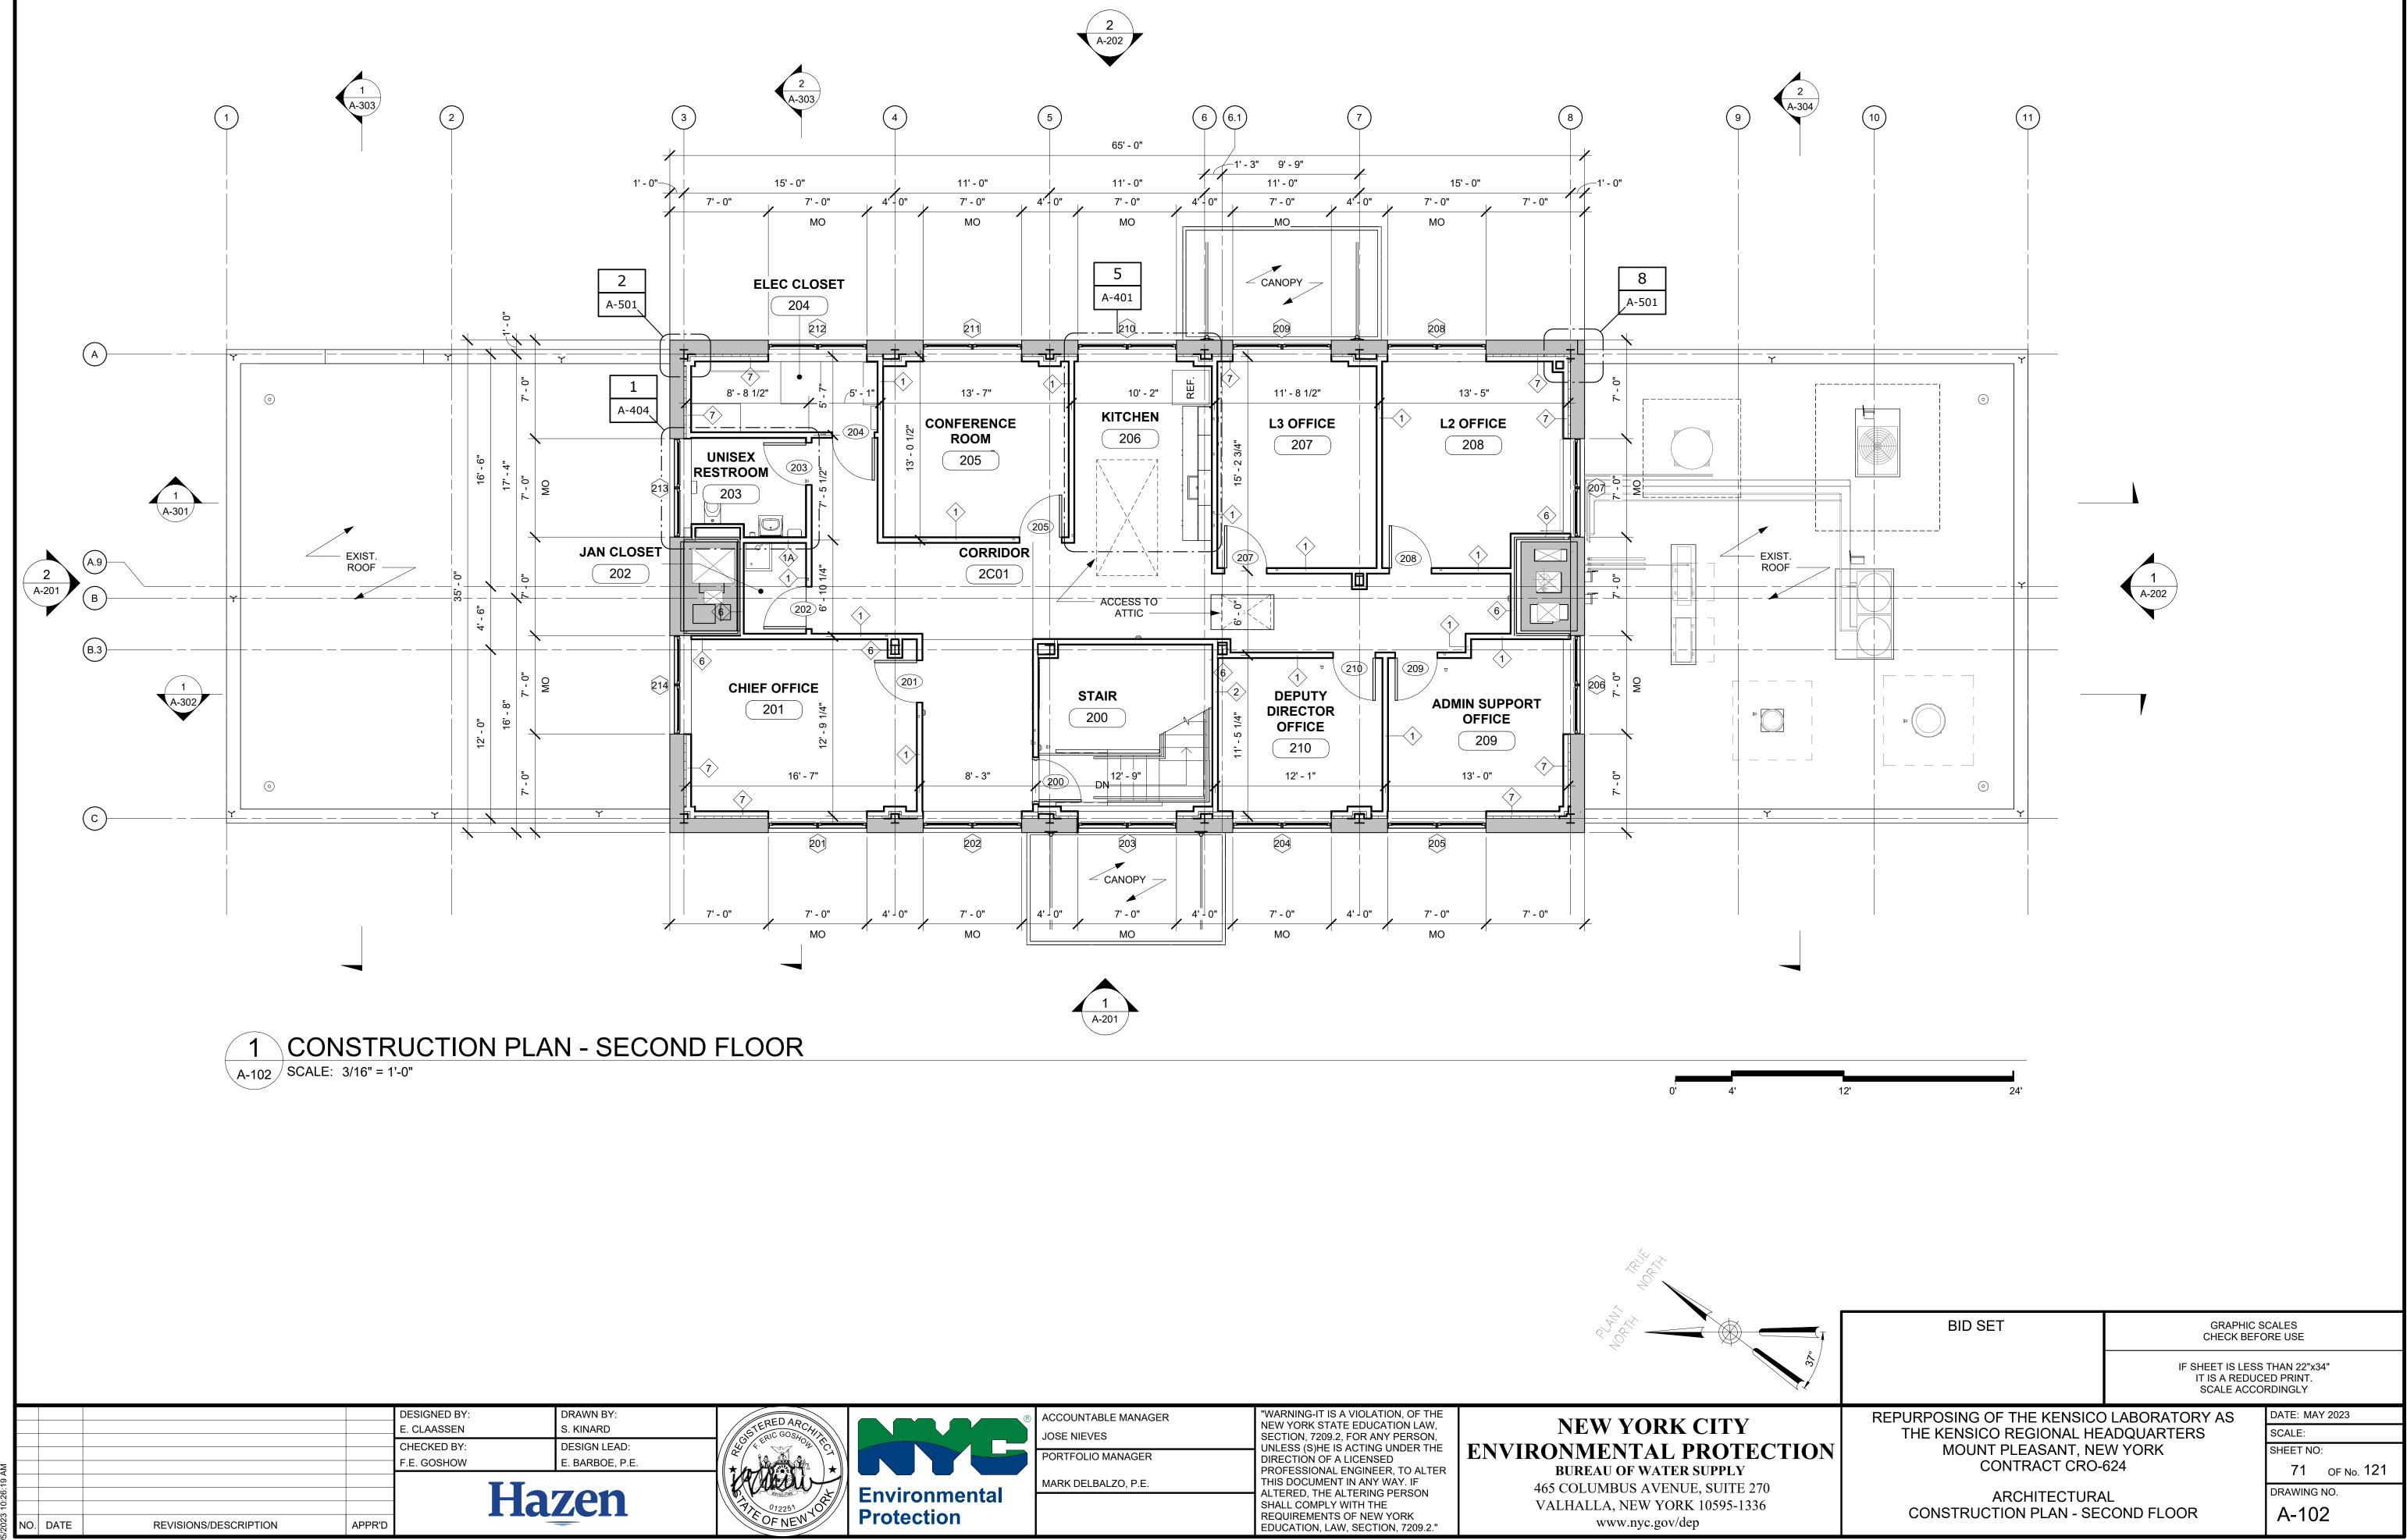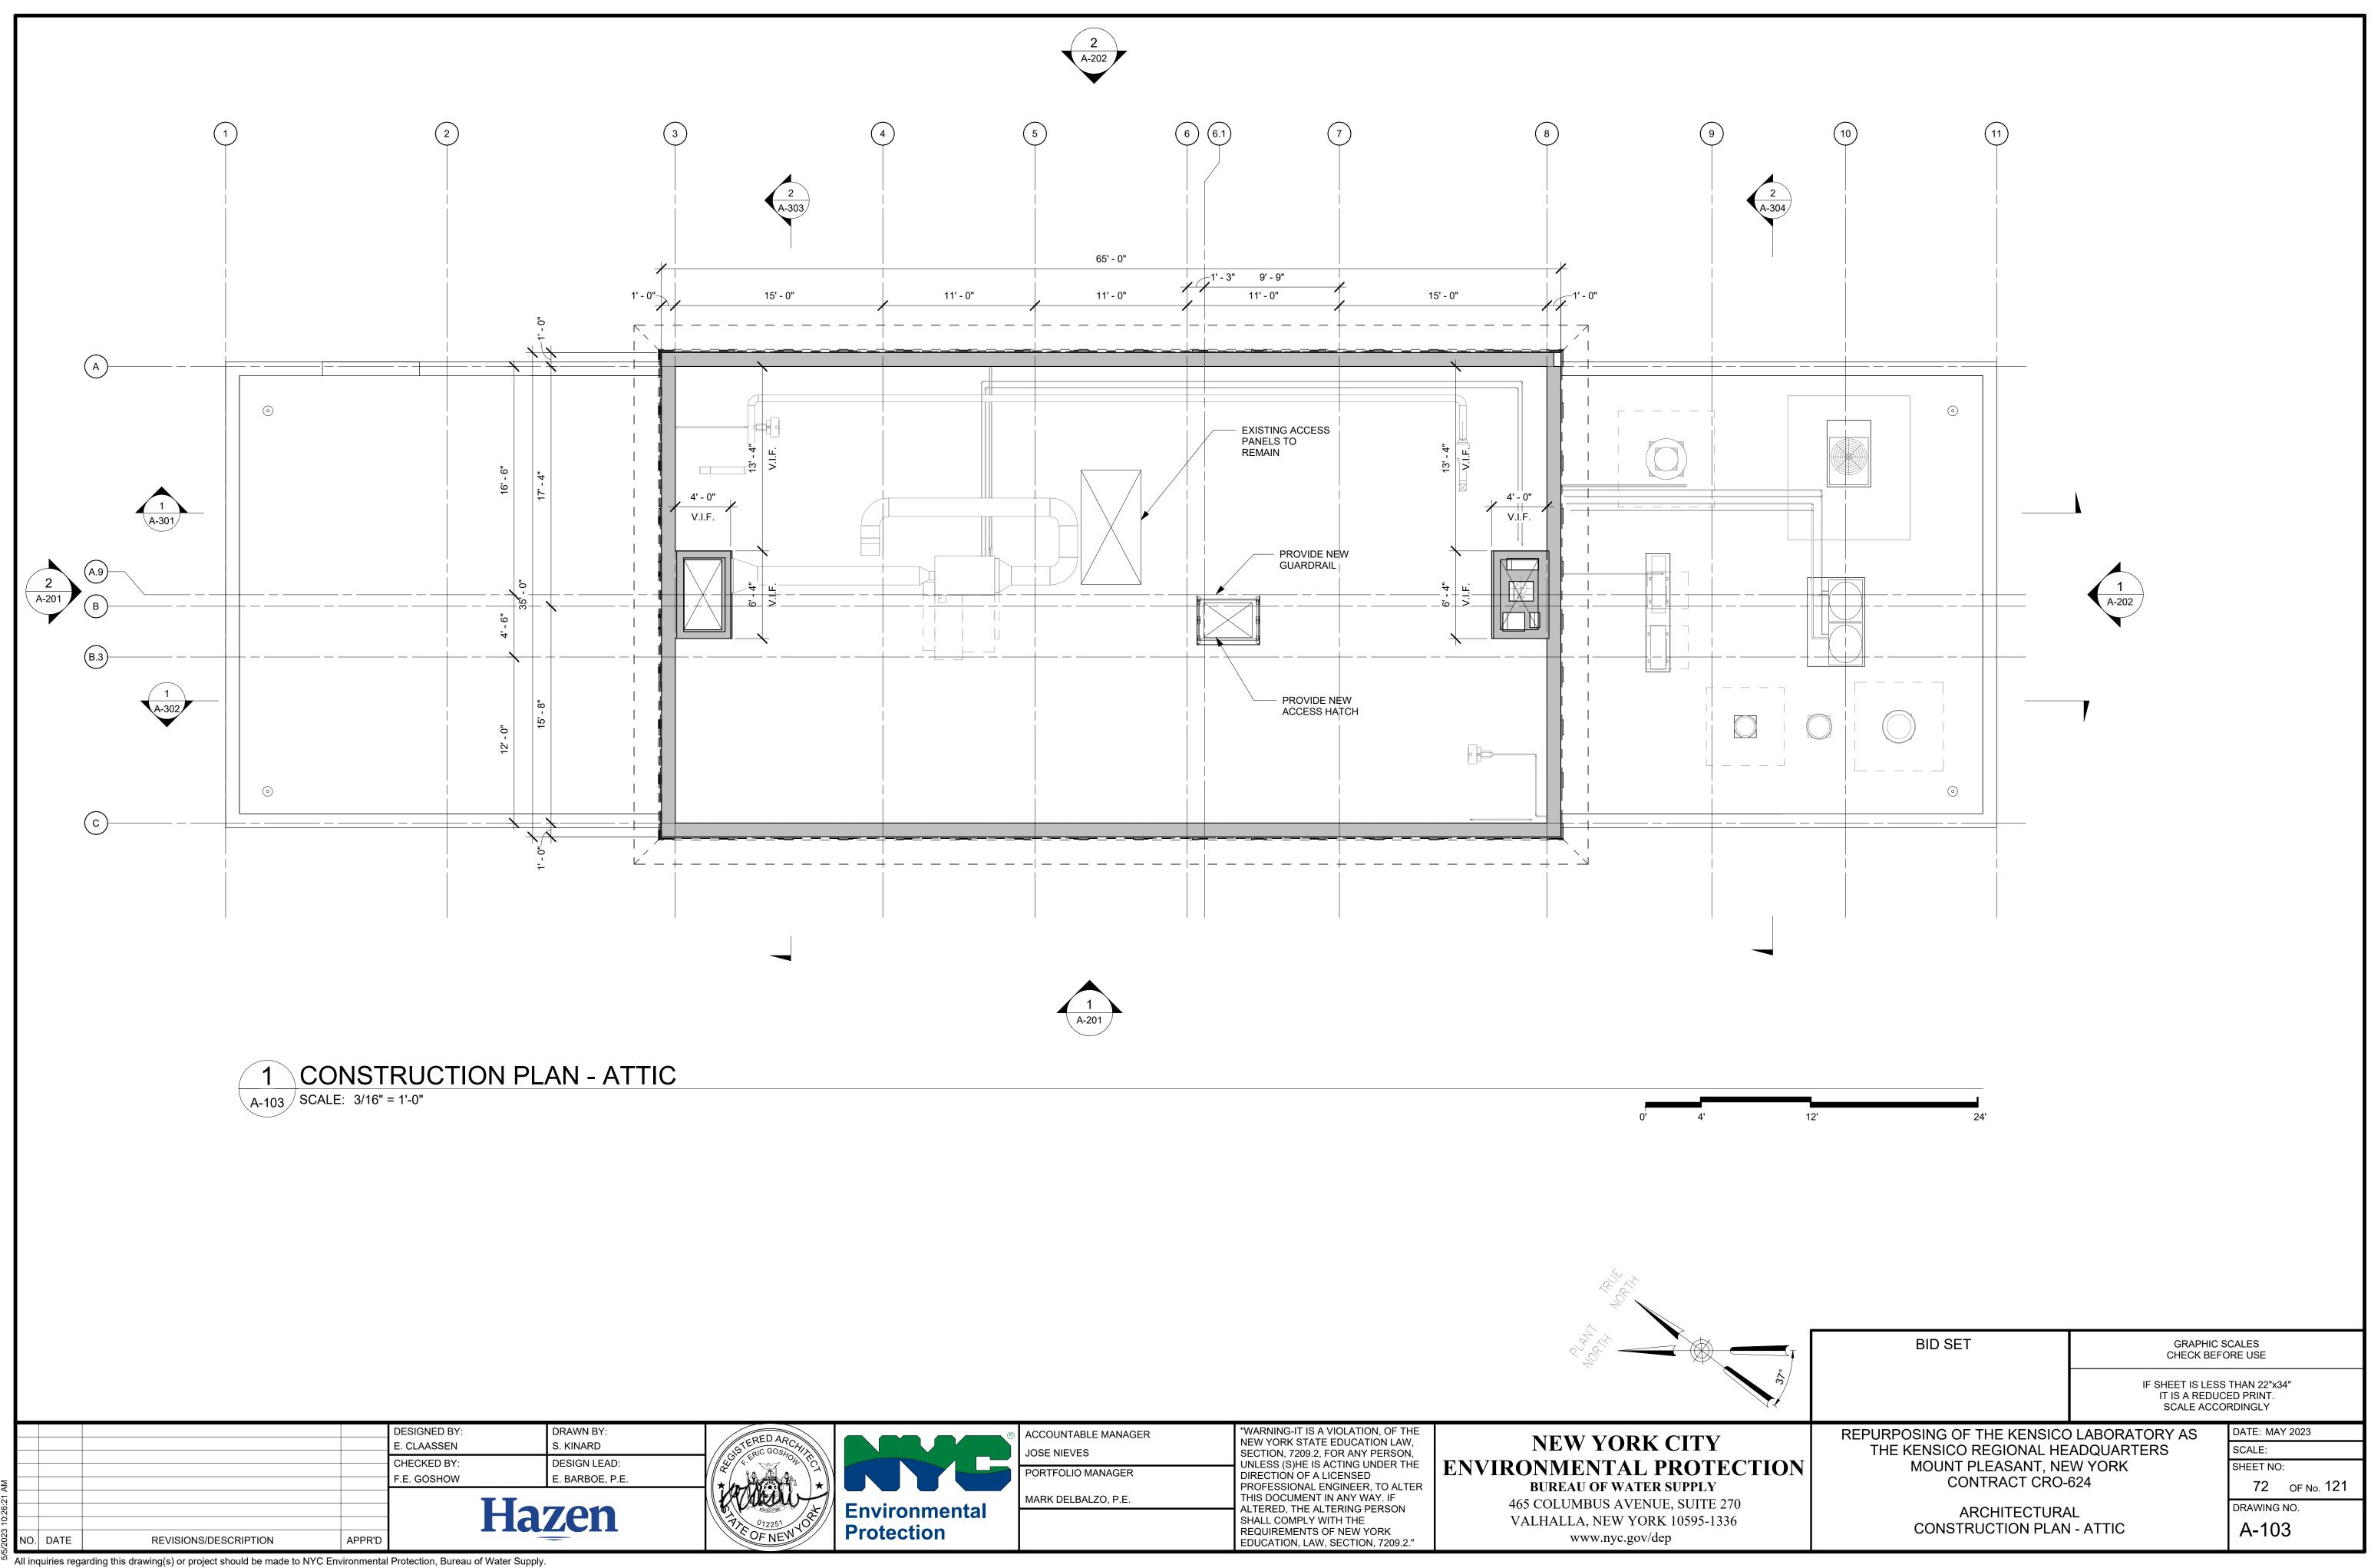
ACCOUNTABLE MANAGER
JOSE NIEVES
PORTFOLIO MANAGER
MARK DELBALZO, P.E.










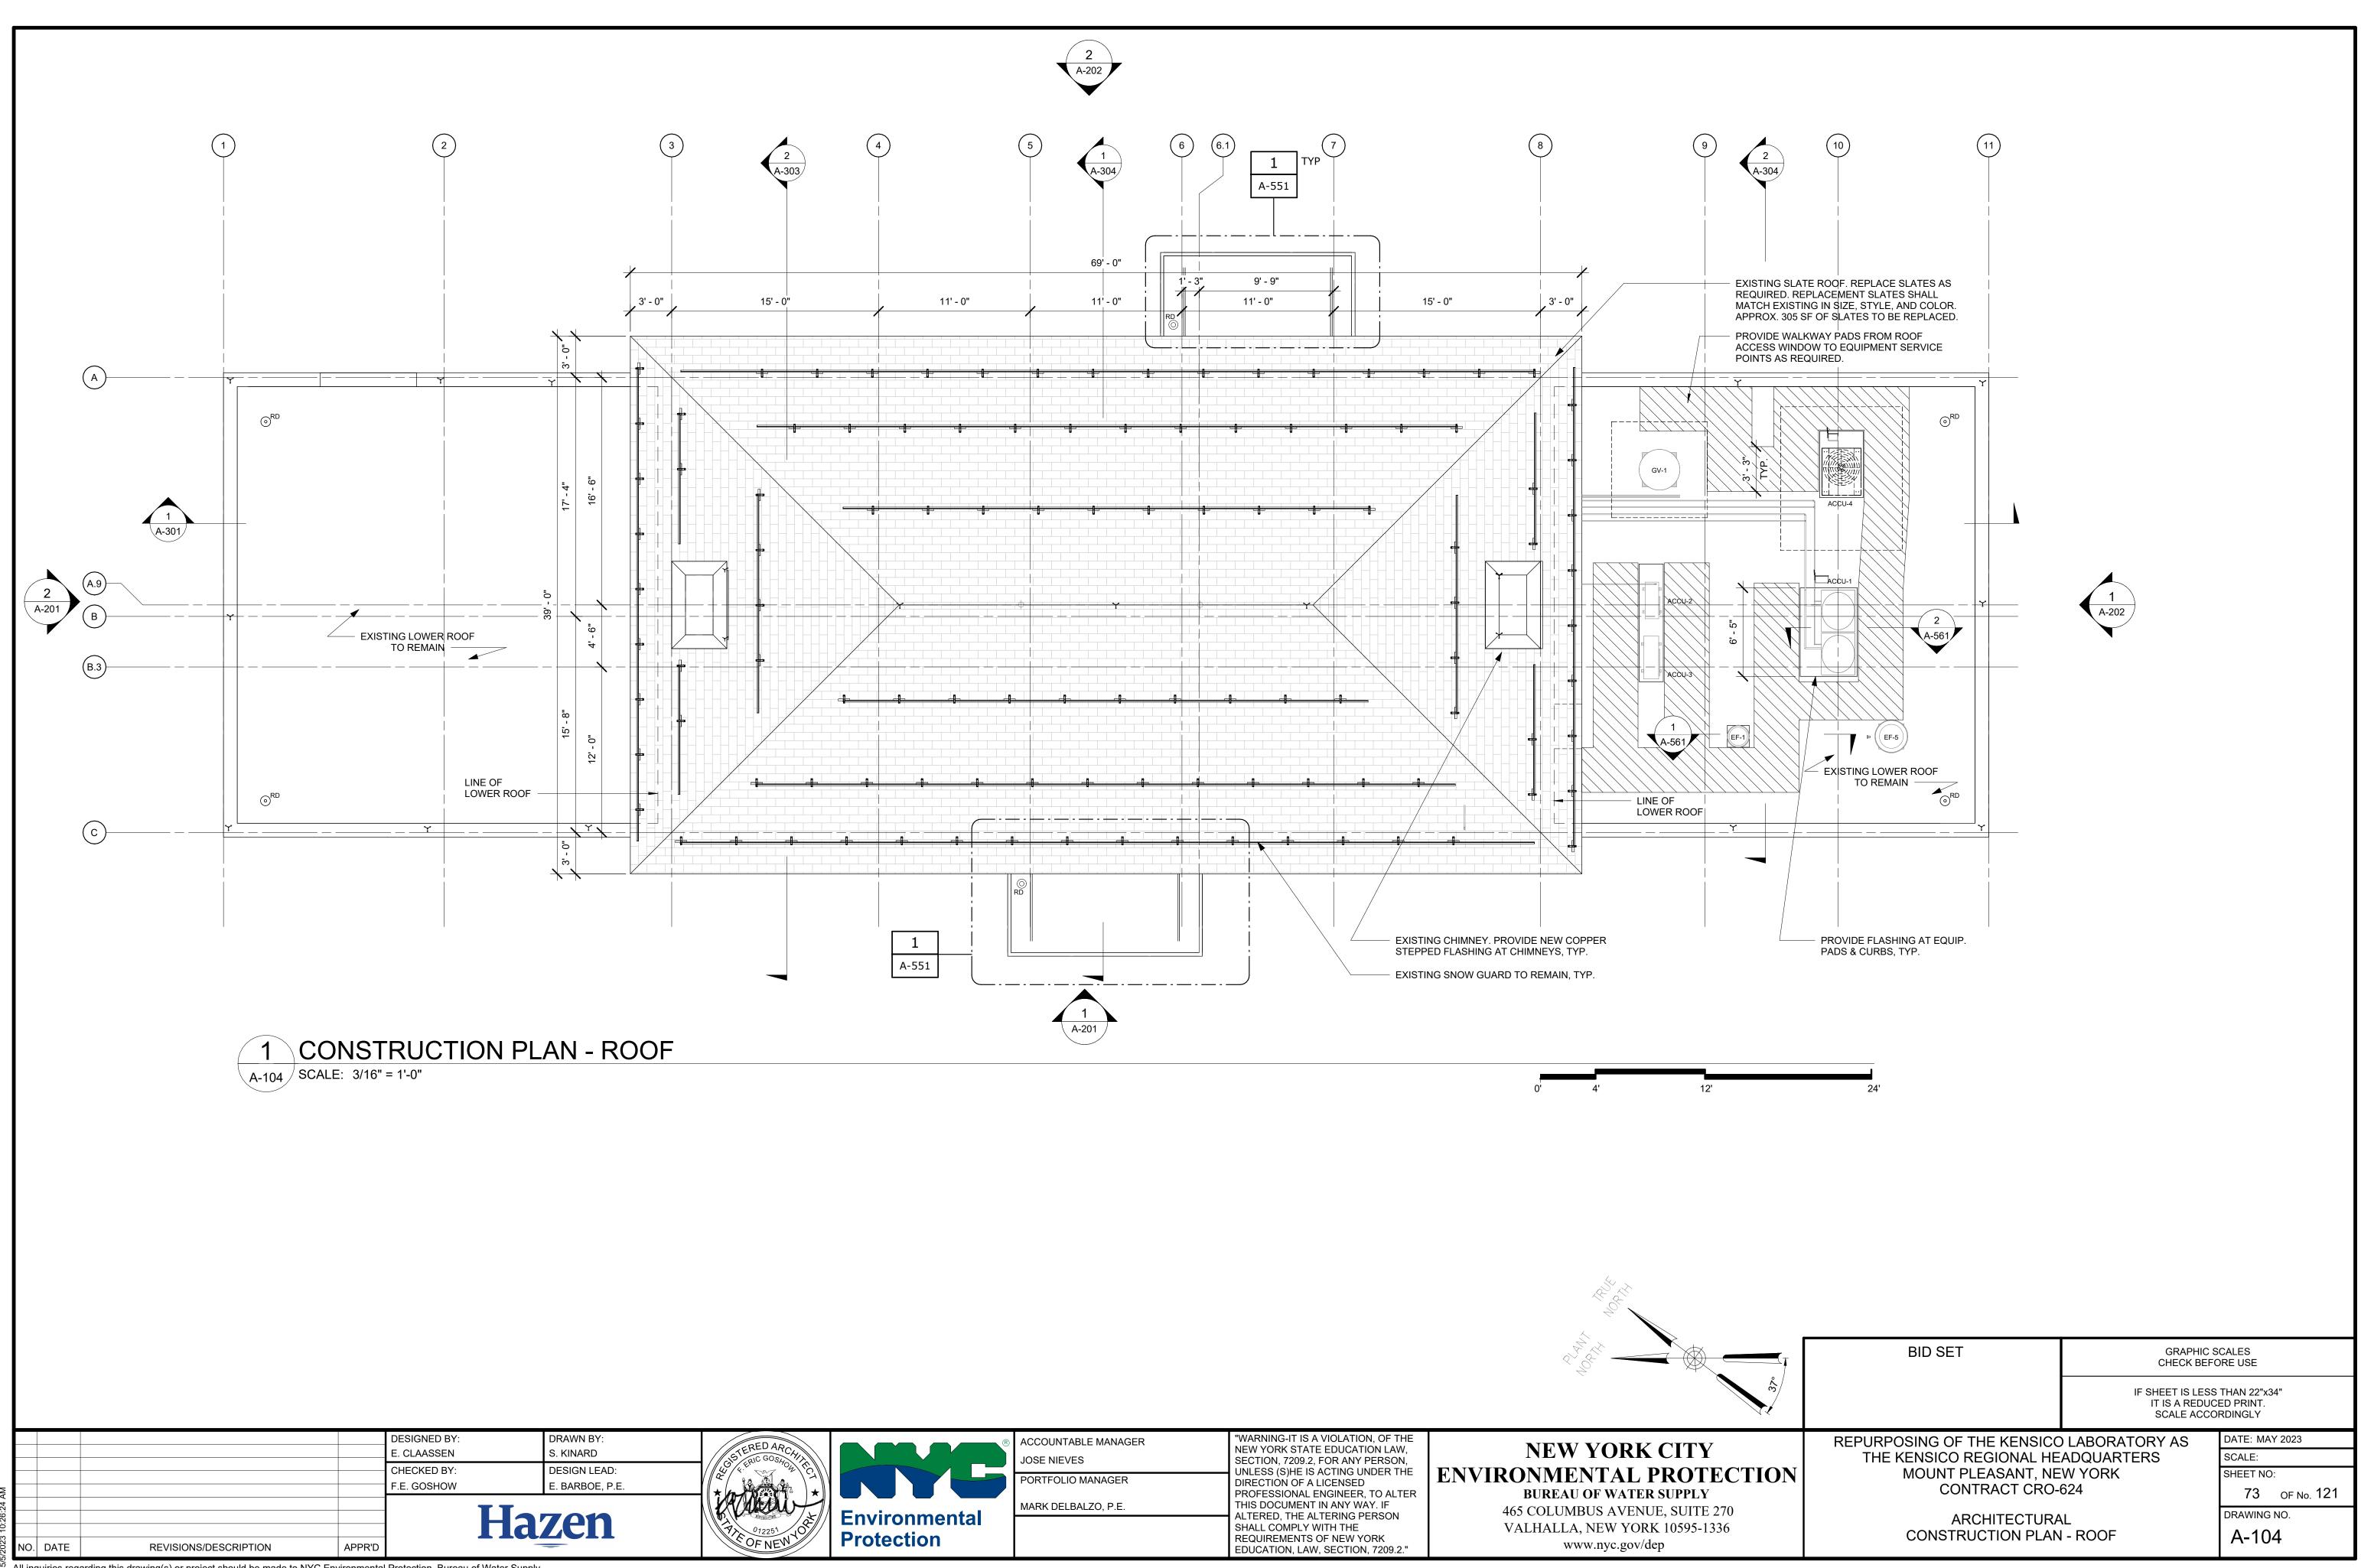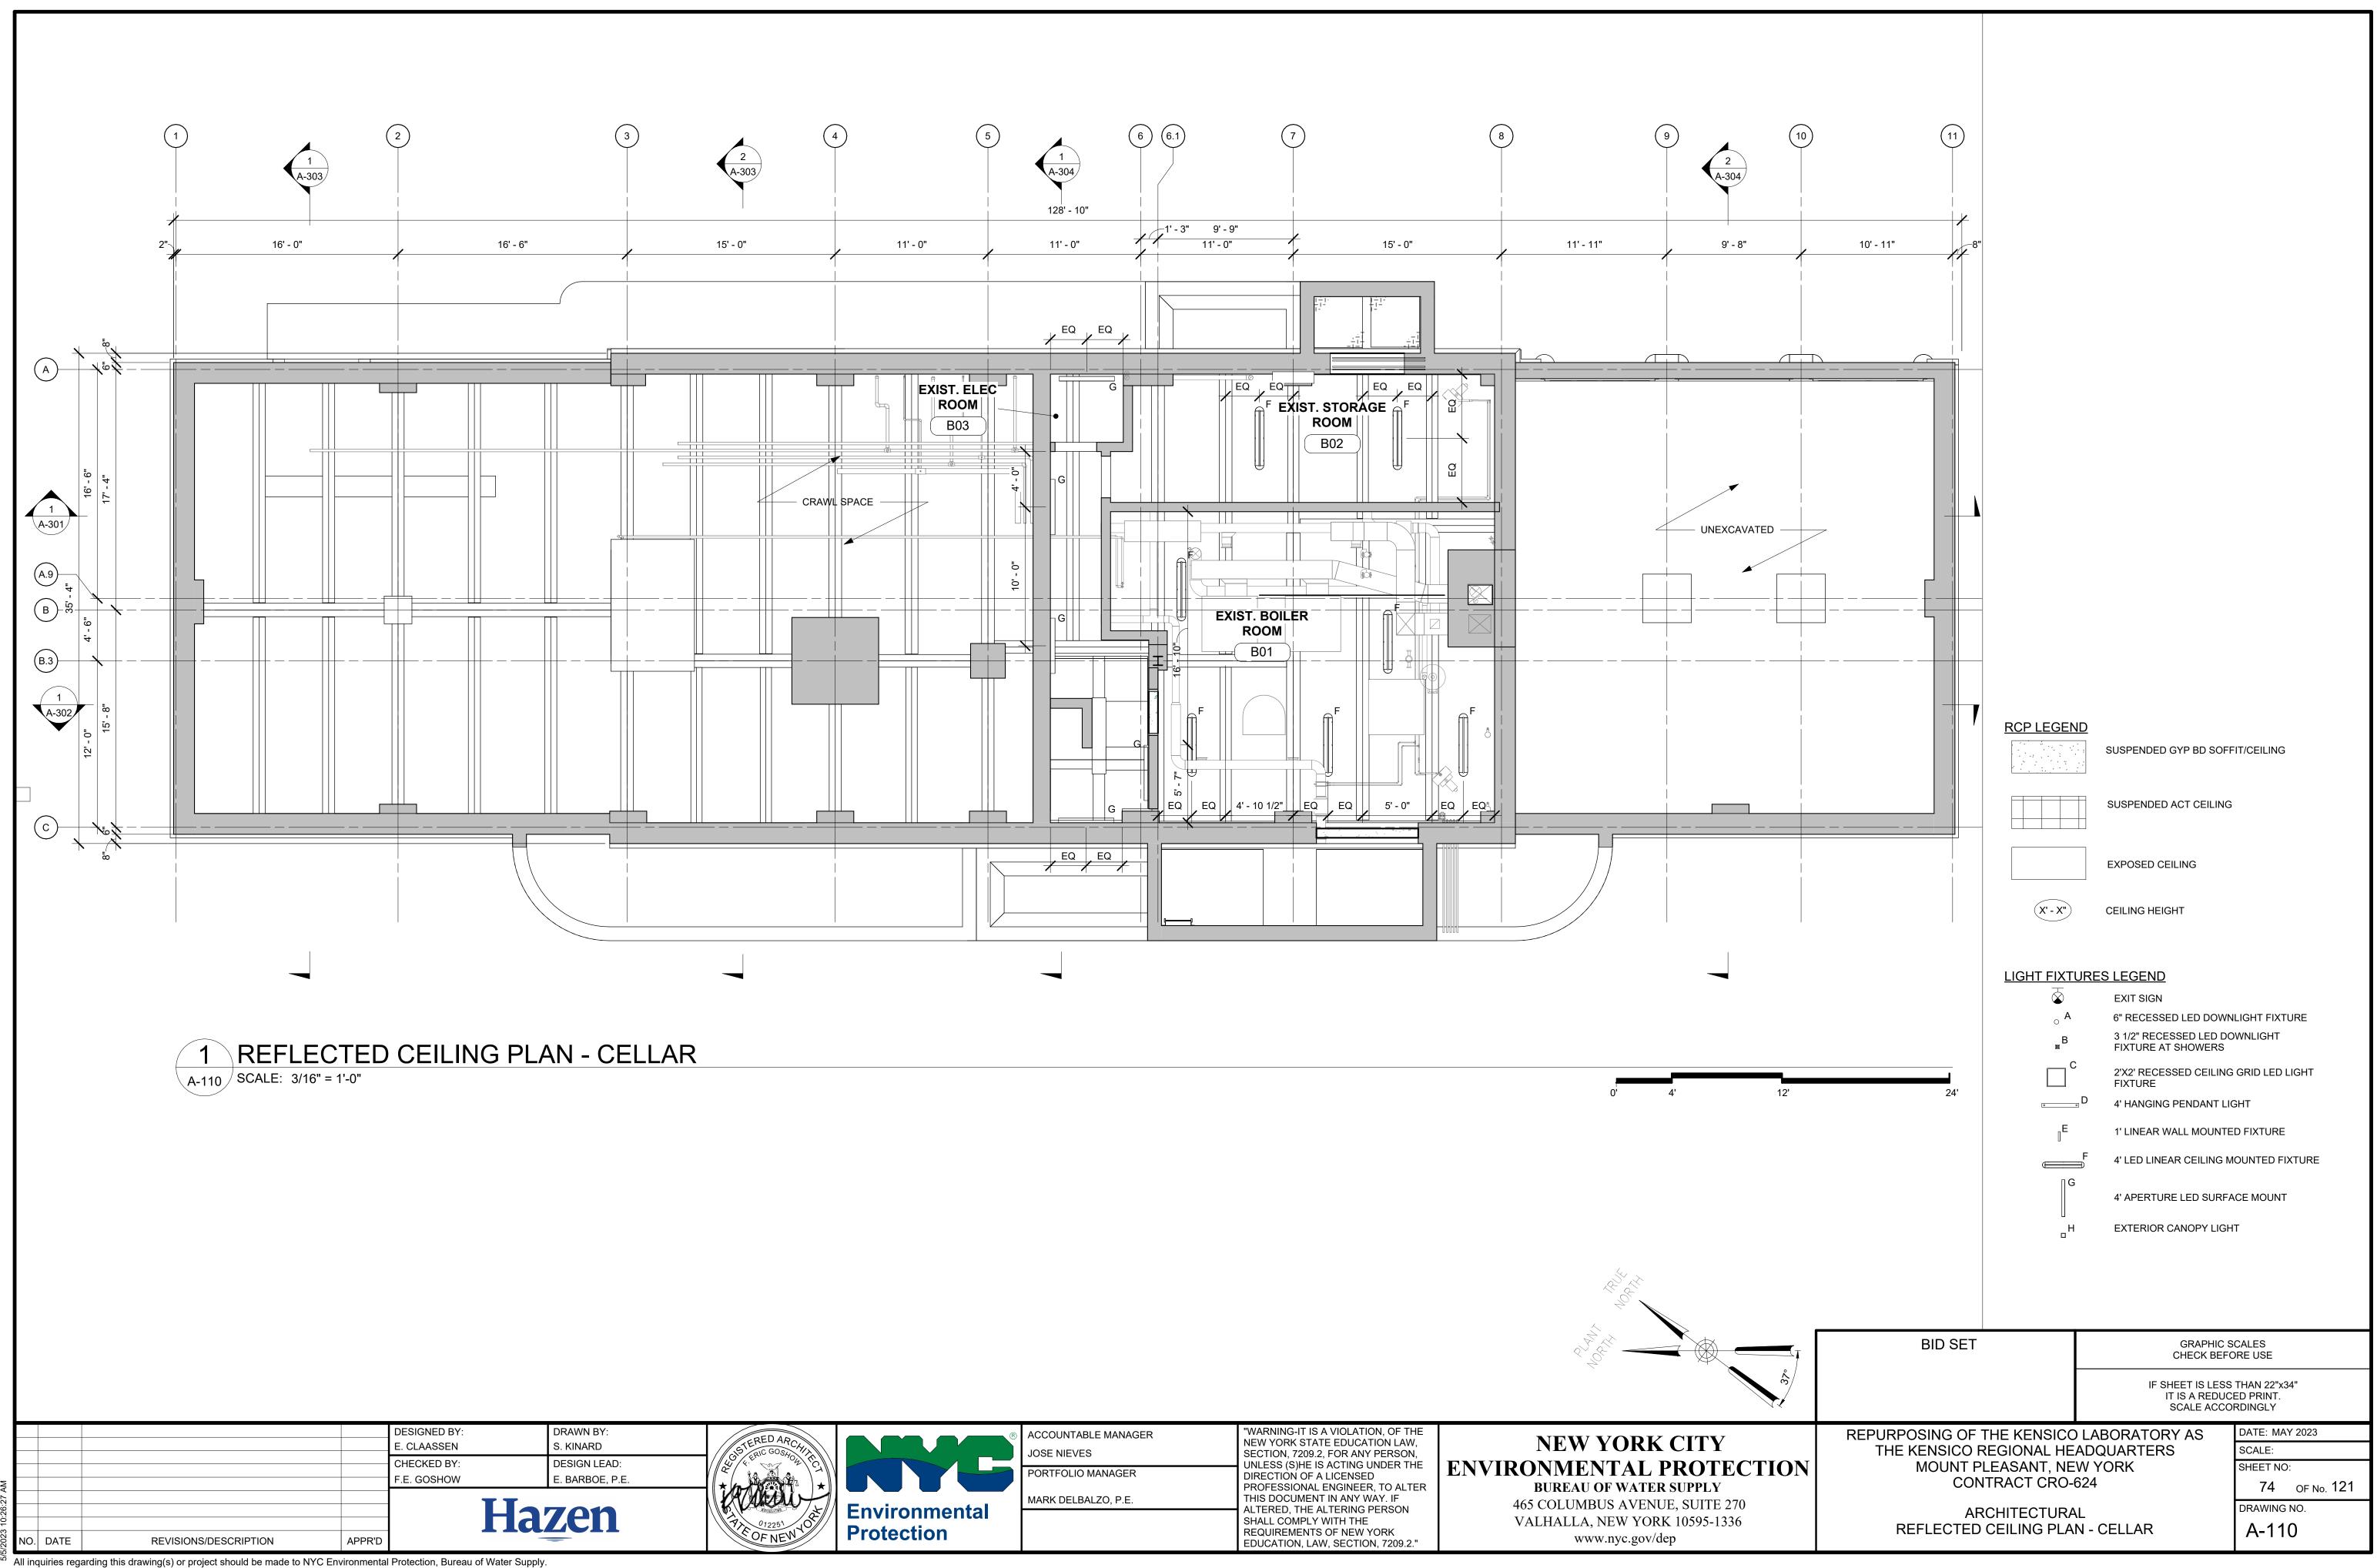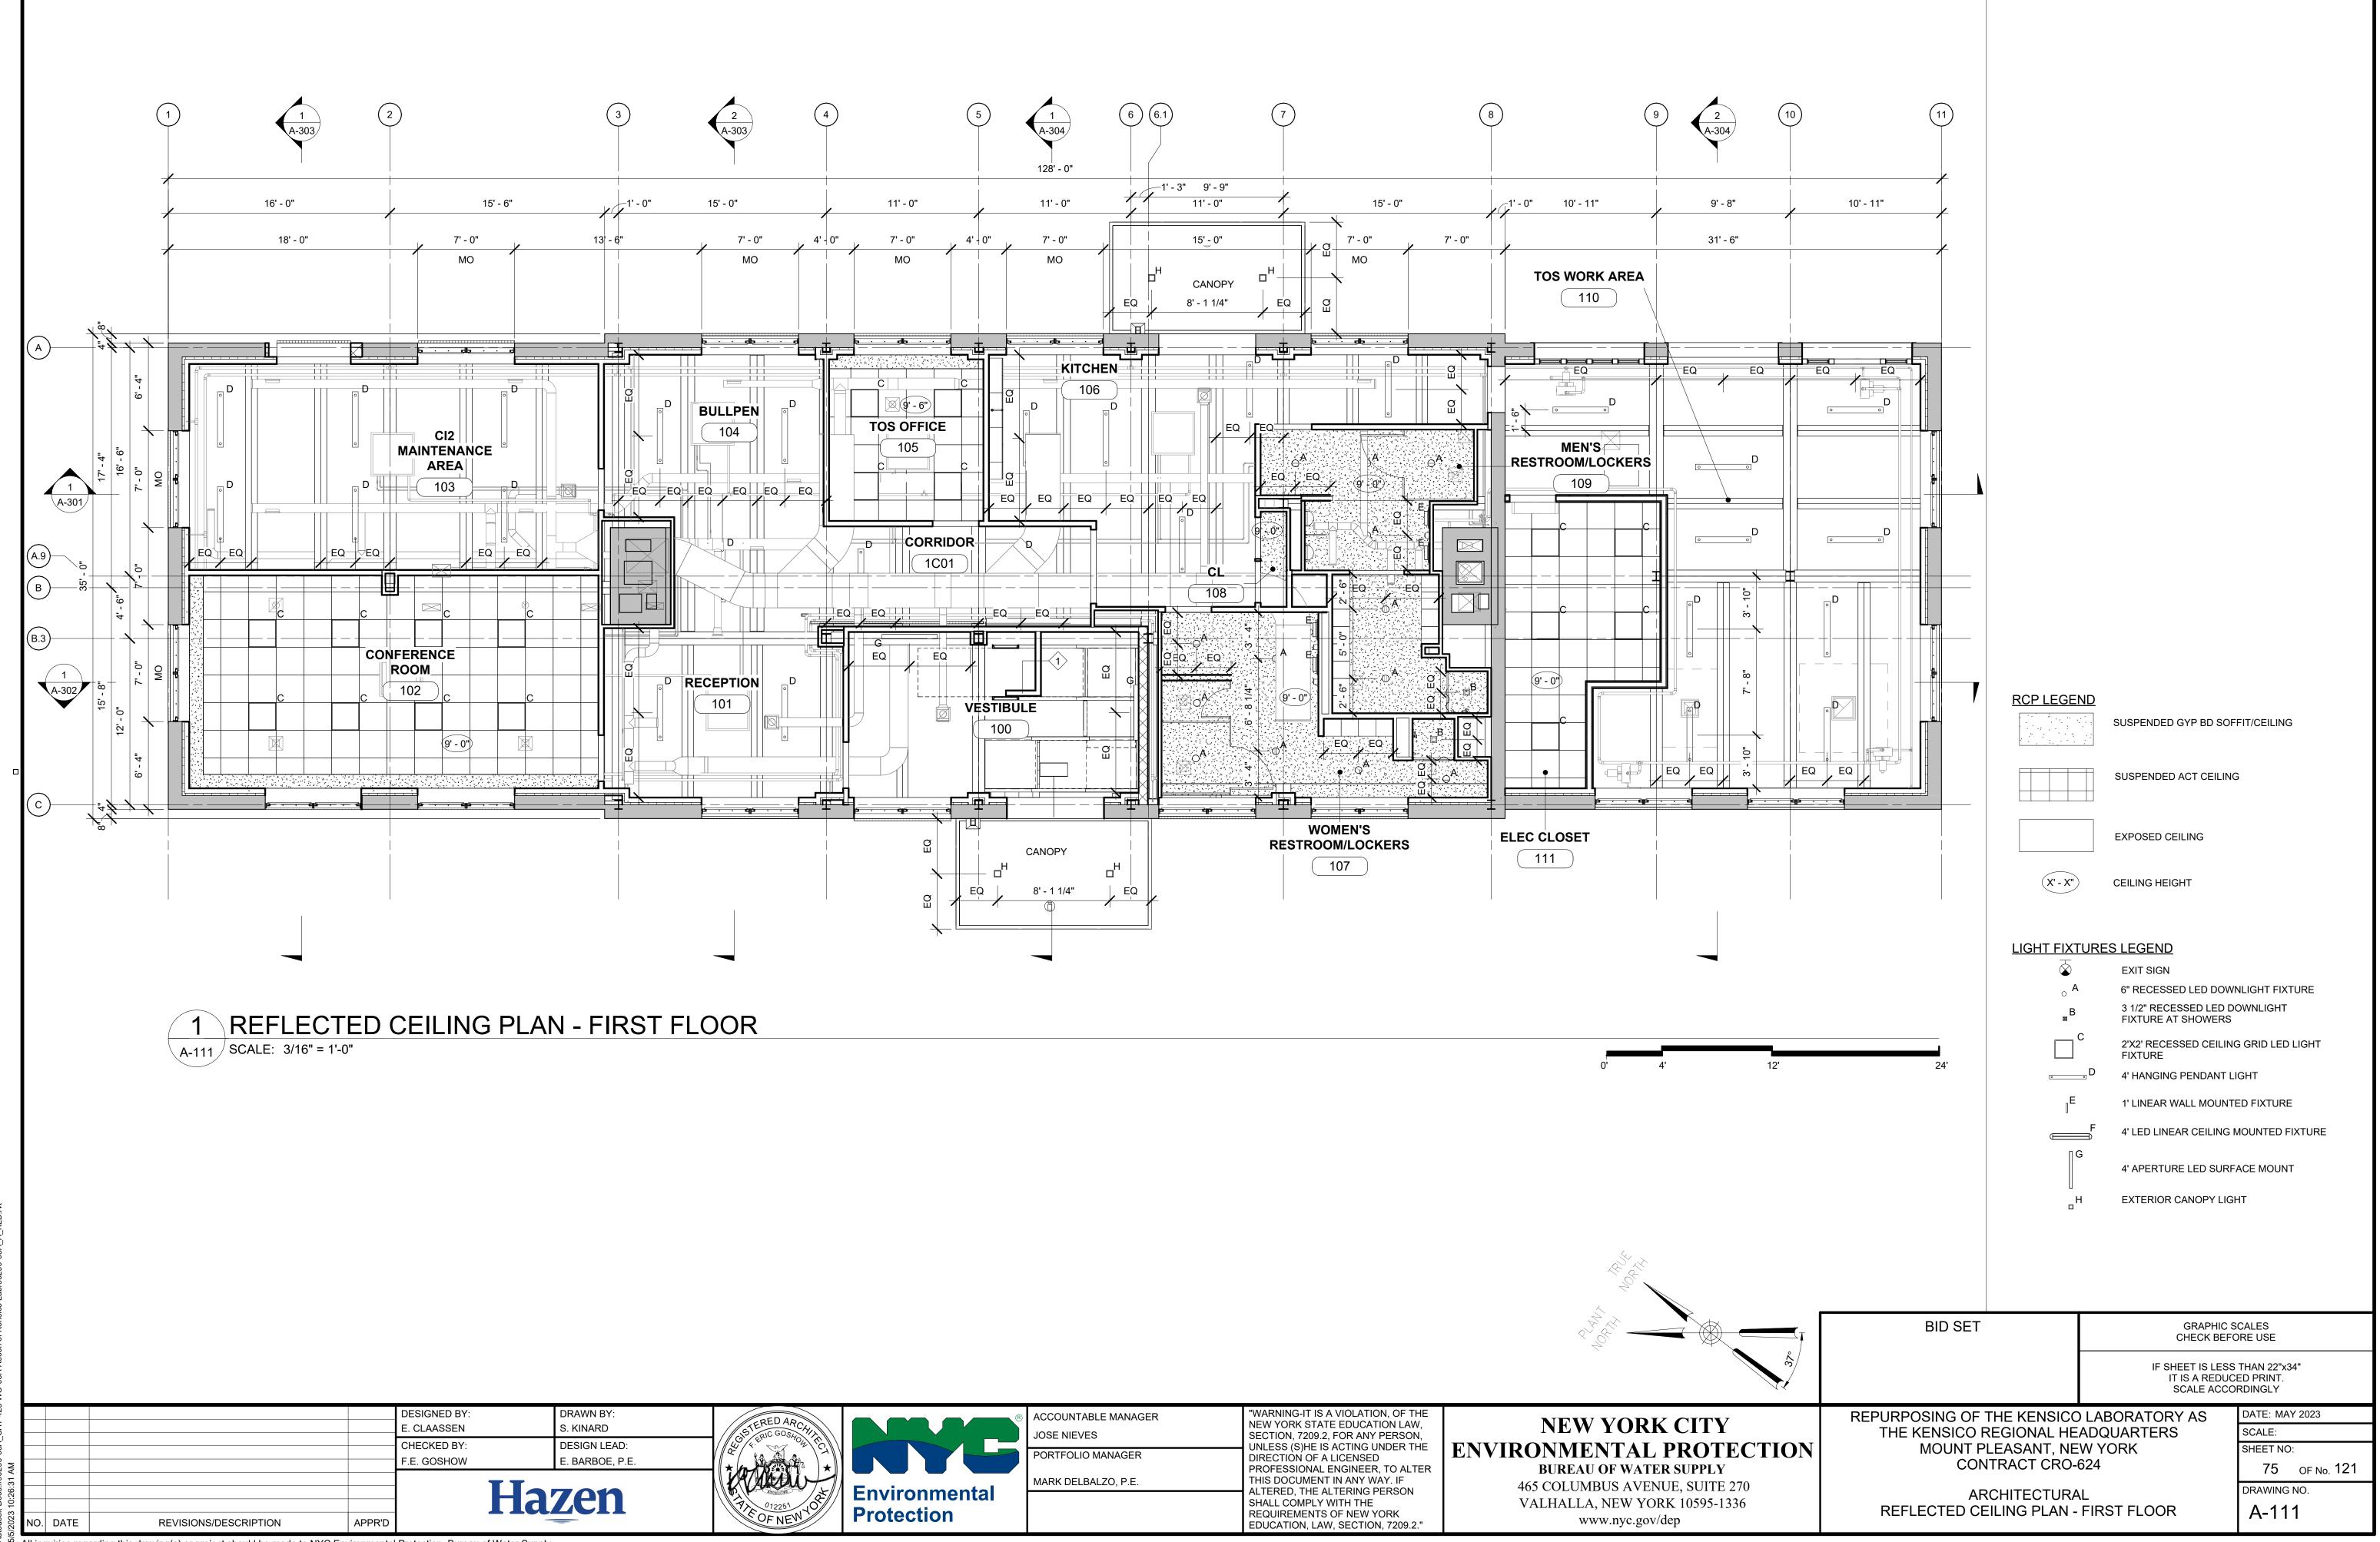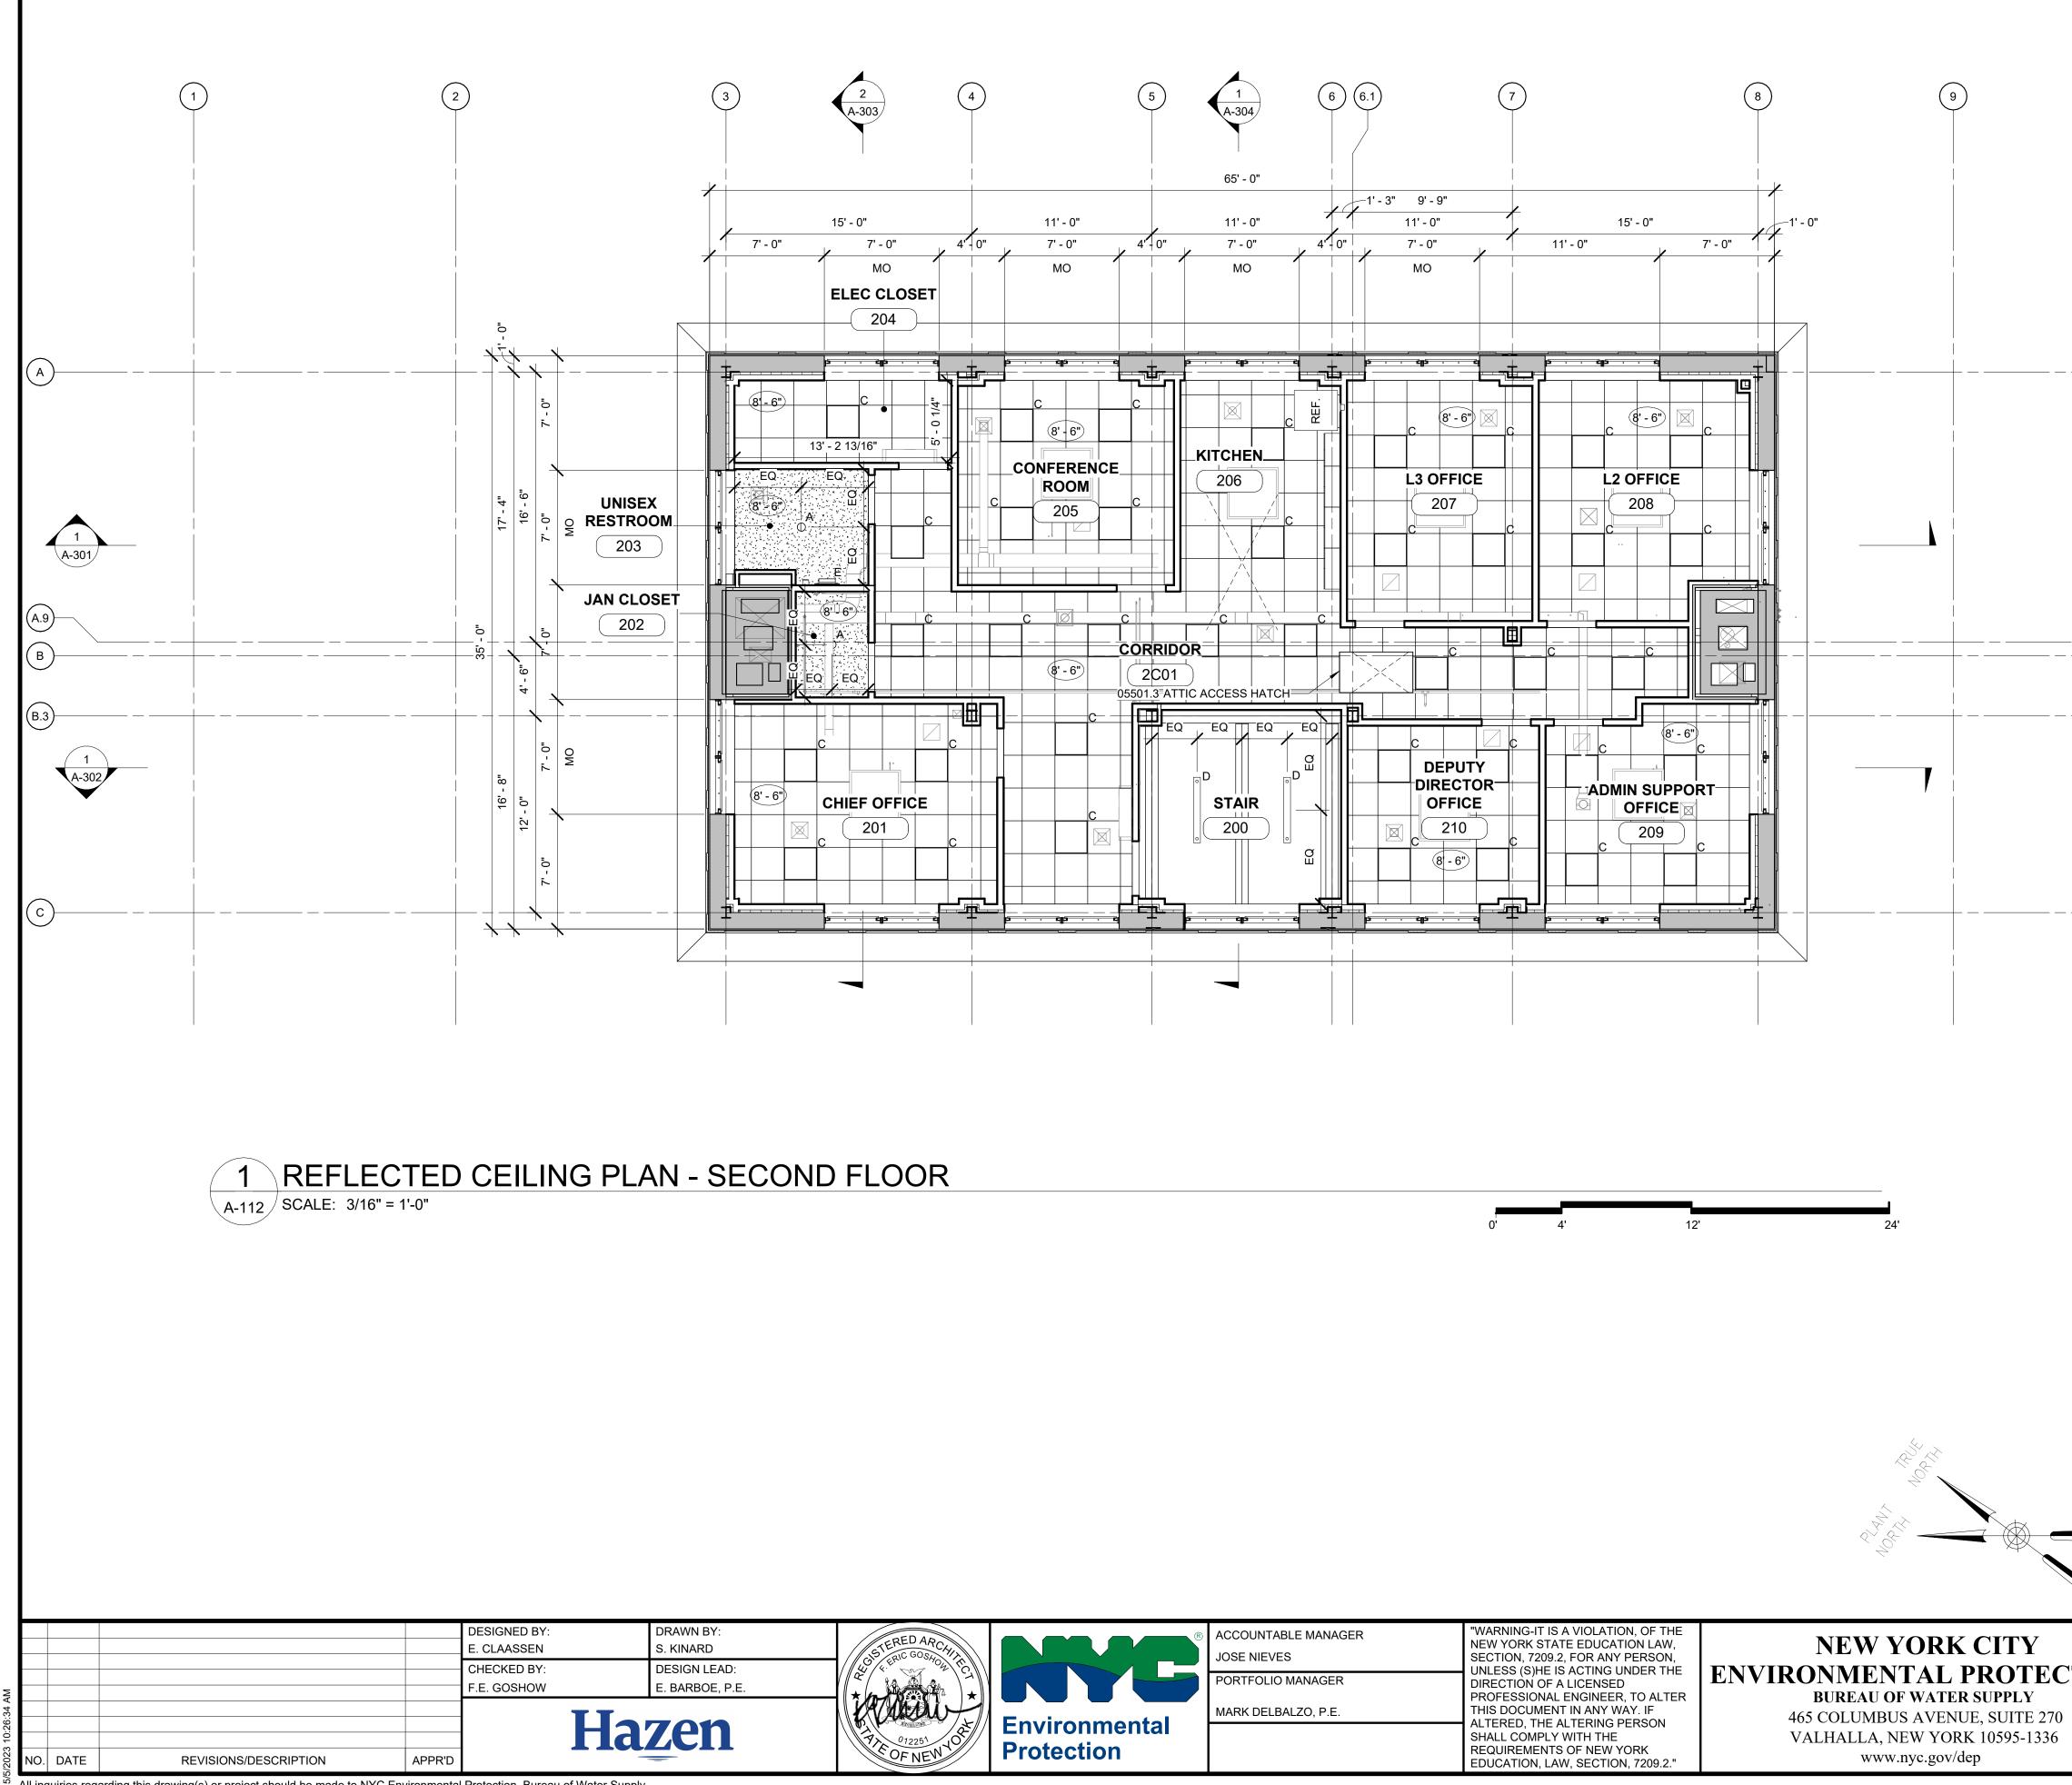ACCOUNTABLE MANAGER
JOSE NIEVES
PORTFOLIO MANAGER
MARK DELBALZO, P.E.











ACCOUNTABLE MANAGER
JOSE NIEVES
PORTFOLIO MANAGER
MARK DELBALZO, P.E.

			SUSPENDED GYP BD SOF	
			EXPOSED CEILING	5
		(X' - X")	CEILING HEIGHT	
		LIGHT FIXTU o A B	JRES LEGEND EXIT SIGN 6" RECESSED LED DOW 3 1/2" RECESSED LED DO FIXTURE AT SHOWERS	
		C 	2'X2' RECESSED CEILING FIXTURE D 4' HANGING PENDANT L 1' LINEAR WALL MOUNT	IGHT
		G	F 4' LED LINEAR CEILING M 4' APERTURE LED SURF	ACE MOUNT
		급변	EXTERIOR CANOPY LIG	ΗT
	BID SET		GRAPHIC CHECK BEF	
320			IF SHEET IS LES IT IS A REDU SCALE ACC	S THAN 22"x34" CED PRINT. ORDINGLY
TION			ADQUARTERS W YORK	DATE: MAY 2023 SCALE: SHEET NO: <b>76</b> OF No. <b>121</b>
	AR REFLECTED CEII	CHITECTURA LING PLAN - S		DRAWING NO. A-112

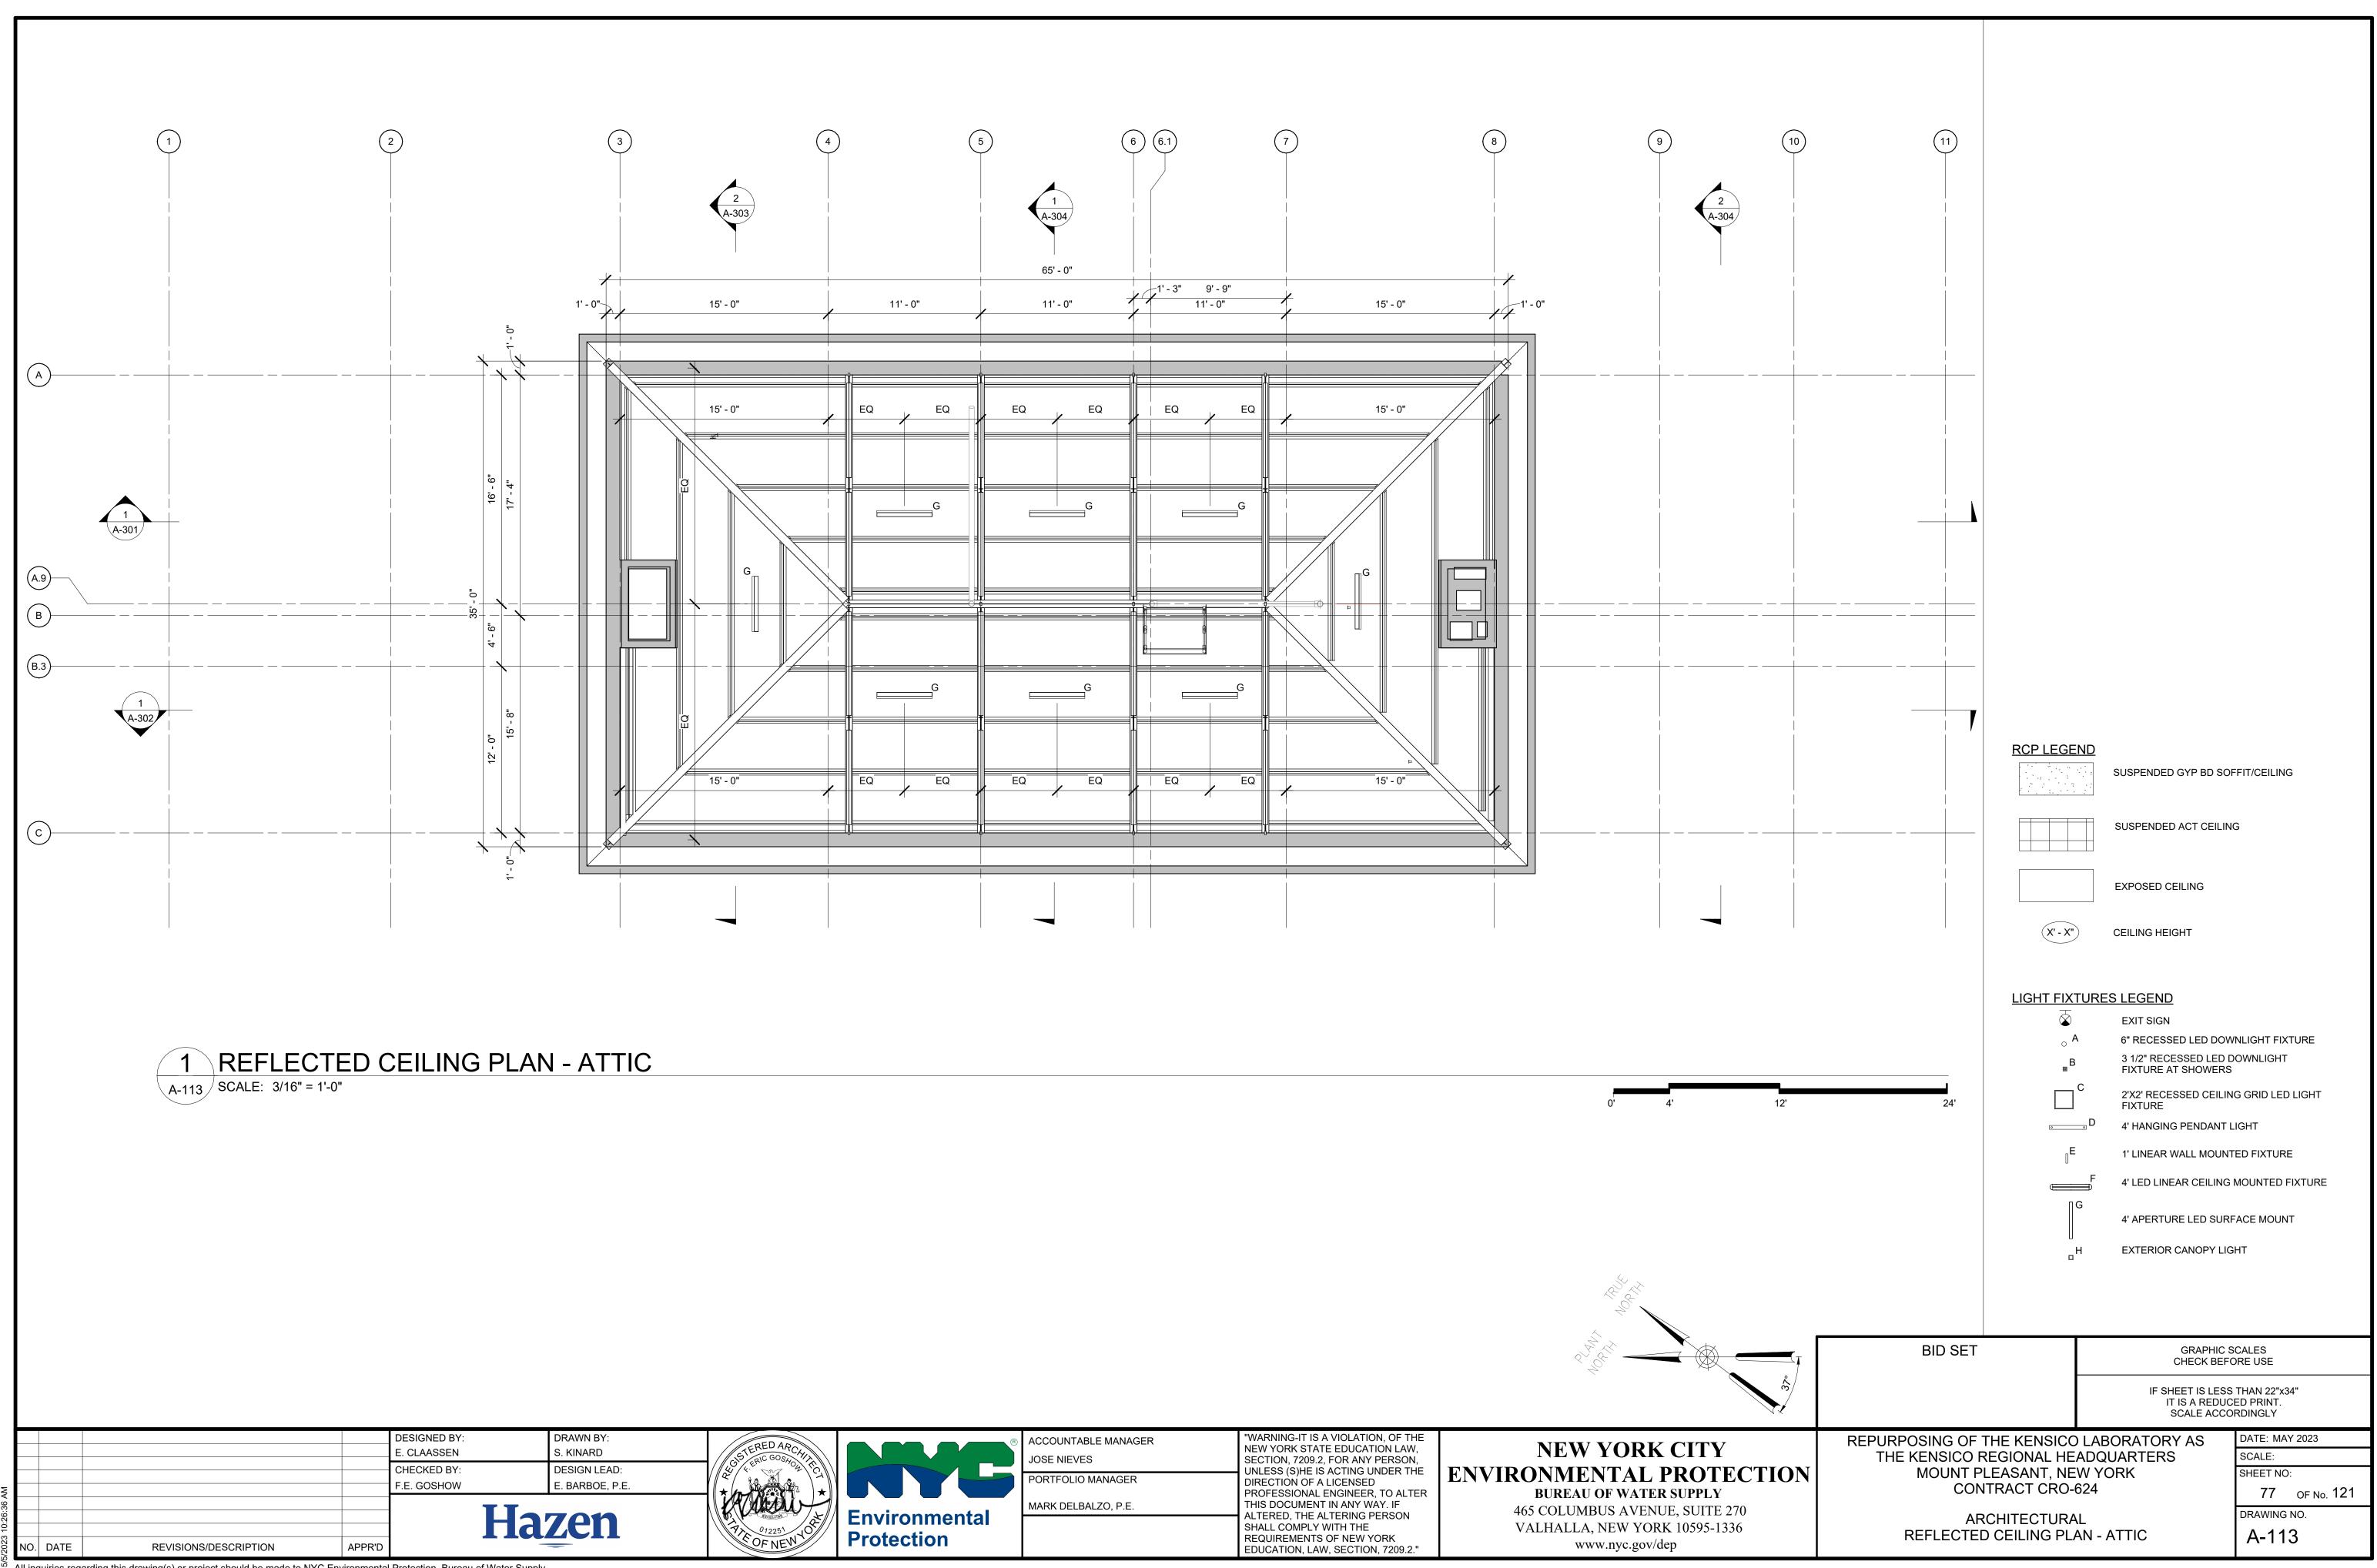

ACCOUNTABLE MANAGER						
JOSE NIEVES						
PORTFOLIO MANAGER						
MARK DELBALZO, P.E.						

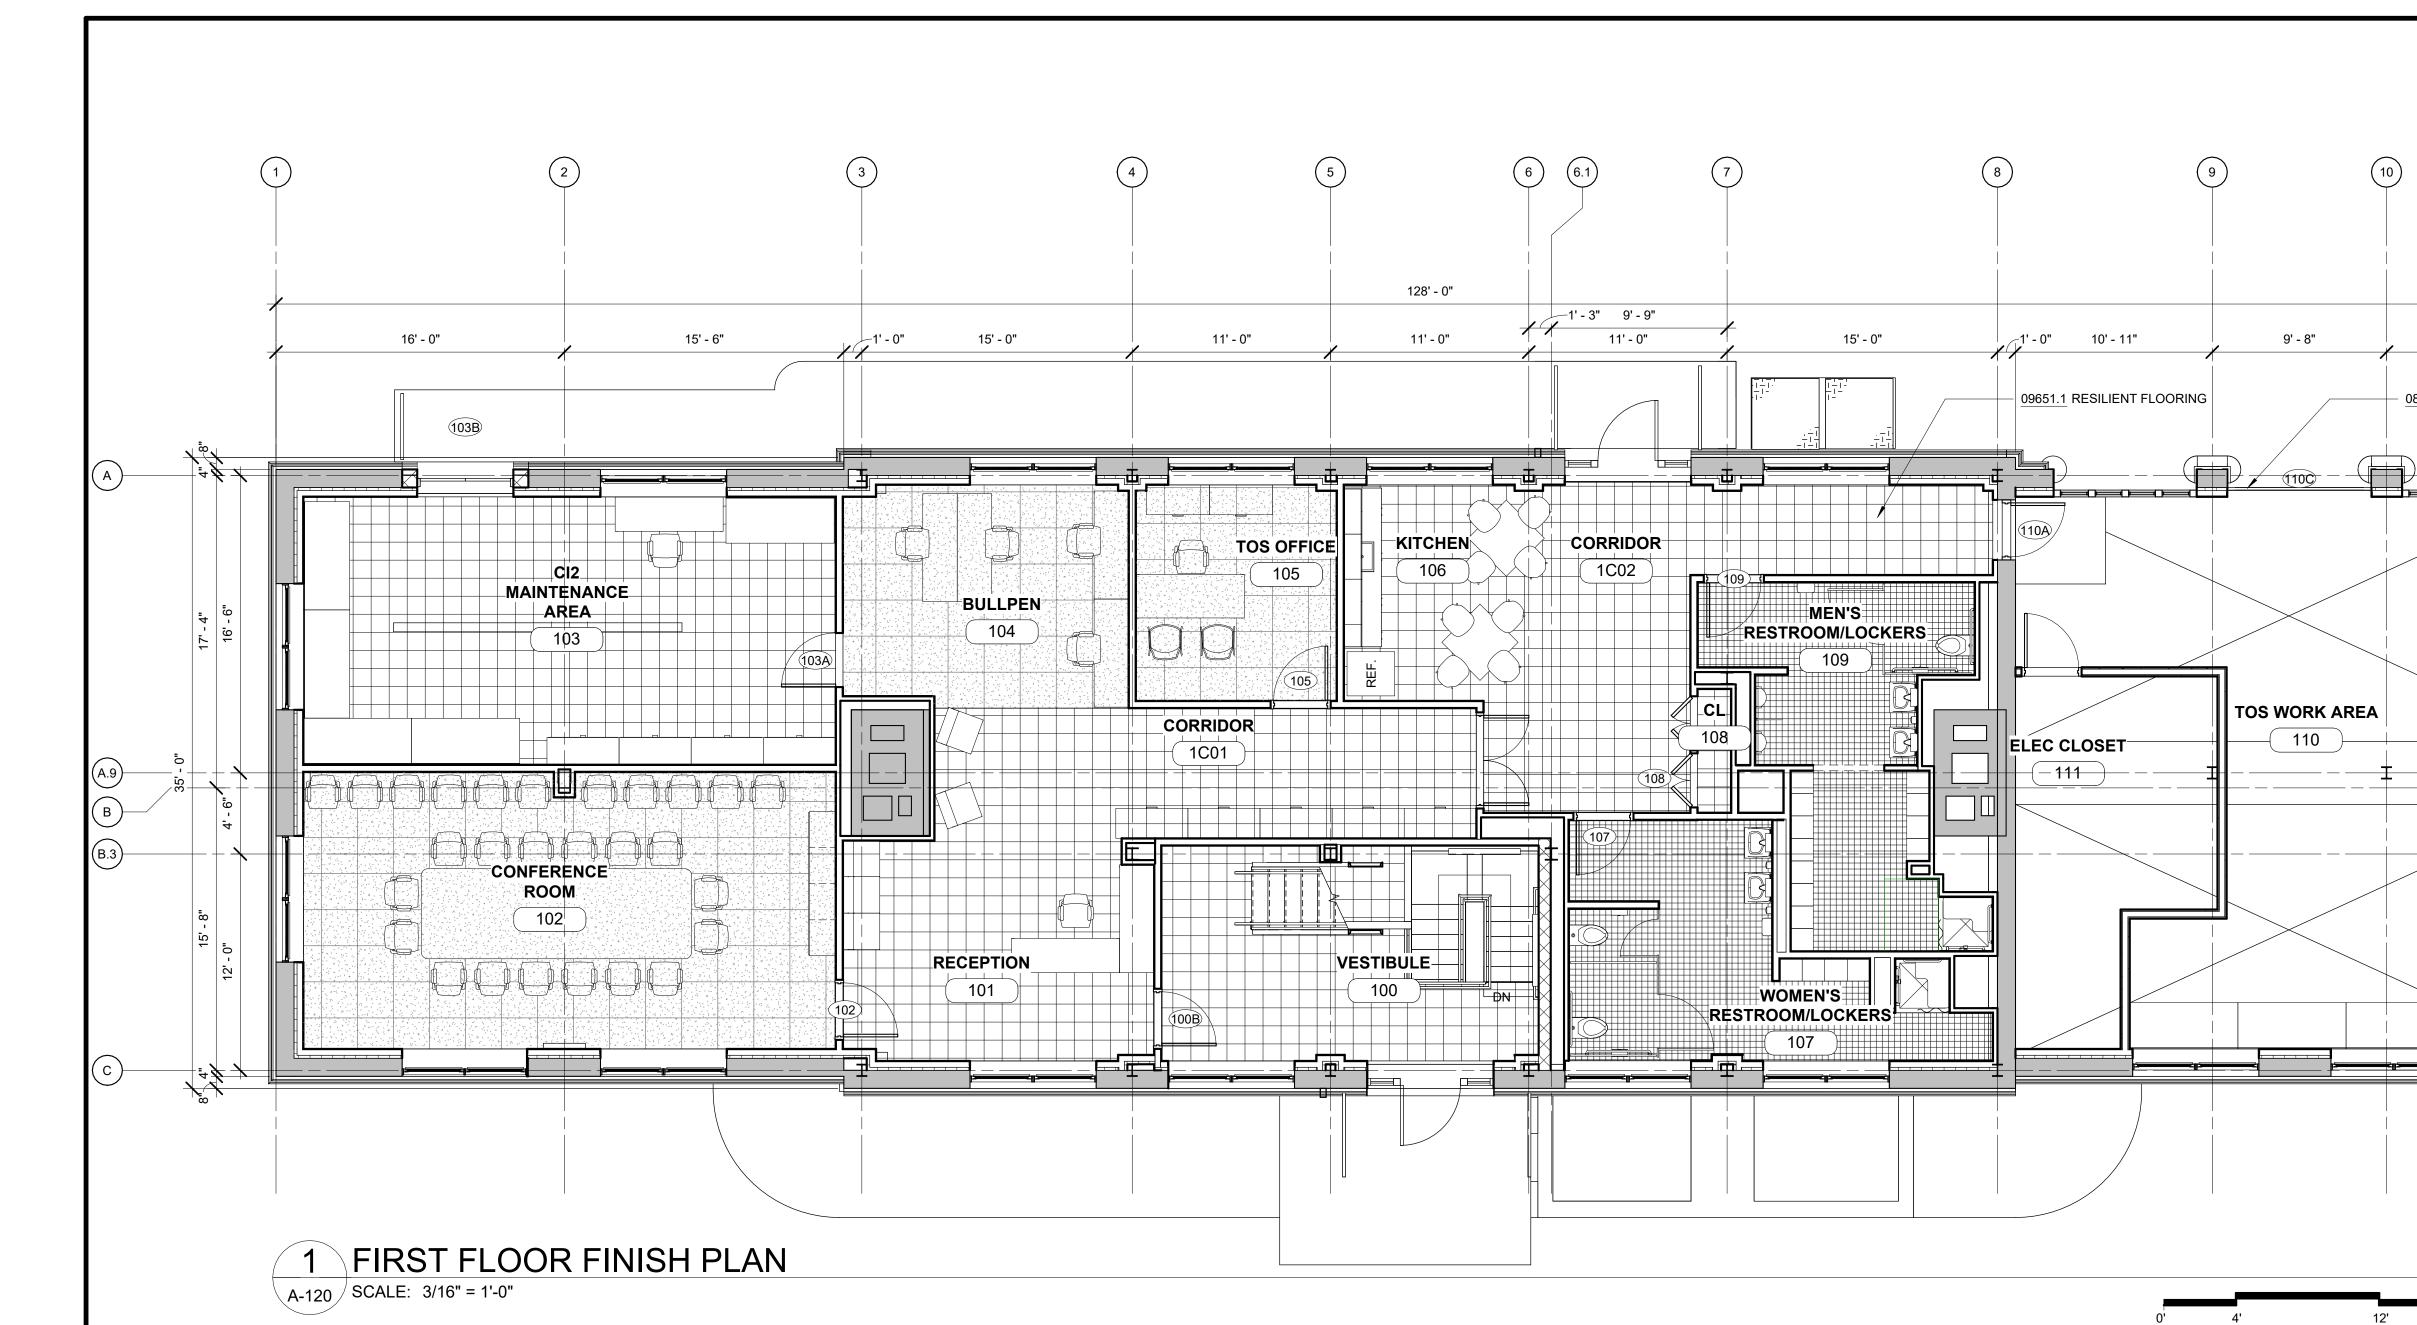


	FIRST FLOOR FINISH SCHEDULE														
NO.	DESCRIPTION	FLOO	FLOOR BA		BASE WALL-NORTH		WALL-EAST WALL-SOUTH		WALL-WEST		CEILING		REMARKS		
NO.	DESCRIPTION	SUBSTRATE	FINISH	FINISH	SUBSTRATE	FINISH	SUBSTRATE	FINISH	SUBSTRATE	FINISH	SUBSTRATE	FINISH	SUBSTRATE	FINISH	HEIGHT
1C01	CORRIDOR	EXIST.	VCT	VB-1	GWB	PT-1	GWB	PT-1	GWB	PT-1	GWB	PT-1	EXIST.	PT-1	-
1C02	CORRIDOR	EXIST.	VCT	VB-1	GWB	PT-1	GWB	PT-1	GWB	PT-1	GWB	PT-1	EXIST.	PT-1	-
100	VESTIBULE	EXIST.	VCT	VB-1	GWB	PT-1	GWB	PT-1	GWB	PT-1	GWB	PT-1	EXIST.	PT-1	-
101	RECEPTION	EXIST.	VCT	VB-1	GWB	PT-1	-	-	GWB	PT-1	GWB	PT-1	EXIST.	PT-1	-
102	CONFERENCE ROOM	EXIST.	CPT	VB-2	GWB	PT-1	GWB	PT-1	GWB	PT-1	GWB	PT-1	ACT-1	-	9' - 0"
103	CI2 MAINTENANCE AREA	EXIST.	VCT	VB-1	GWB	PT-1	GWB	PT-1	GWB	PT-1	GWB	PT-1	EXIST.	PT-1	-
104	BULLPEN	EXIST.	CPT	VB-2	GWB	PT-1	GWB	PT-1	GWB	PT-1	-	-	EXIST.	OPEN	-
105	TOS OFFICE	EXIST.	CPT	VB-2	GWB	PT-1	GWB	PT-1	GWB	PT-1	GWB	PT-1	ACT-1	-	9' - 6"
106	KITCHEN	EXIST.	VCT	VB-1	GWB	CWT-2, PT-1	GWB	PT-1	-	-	GWB	PT-1	EXIST.	PT-1	-
107	WOMEN'S RESTROOM/LOCKERS	EXIST.	CMT	СВ	СМВ	CWT-1, PT-1	СМВ	CWT-1, PT-1	СМВ	CWT-1, PT-1	GWB, CMB	CWT-1, PT-1	GWB	PT-1	9' - 0"
108	CL	EXIST.	VCT	VB-1	GWB	PT-1	GWB	PT-1	GWB	PT-1	GWB	PT-1	GWB	PT-1	9' - 0"
109	MEN'S RESTROOM/LOCKERS	EXIST.	CMT	СВ	GWB, CMB	CWT-1, PT-1	СМВ	CWT-1, PT-1	GWB,CMB	CWT-1, PT-1	СМВ	CWT-1, PT-1	GWB	PT-1	9' - 0"
110	TOS WORK AREA	EXIST.	CONC	-	EXIST	PT-1	GWB	PT-1	GWB	PT-1	GWB	PT-1	EXIST.	PT-1	-
111	ELEC CLOSET	EXIST.	CONC	-	EXIST	EXIST	GWB	PT-1	GWB	PT-1	GWB	PT-1	ACT-1	-	9' - 0"


					DESIGNED BY: E. CLAASSEN	DRAWN BY: S. KINARD	STERED ARCAHA
~					CHECKED BY: F.E. GOSHOW	DESIGN LEAD: E. BARBOE, P.E.	C + FK - 70 H FC
10:26:40 AM					Н	lazen	1225 10 ×
5/2023	NO.	DATE	REVISIONS/DESCRIPTION	APPR'D			OF NEW Y



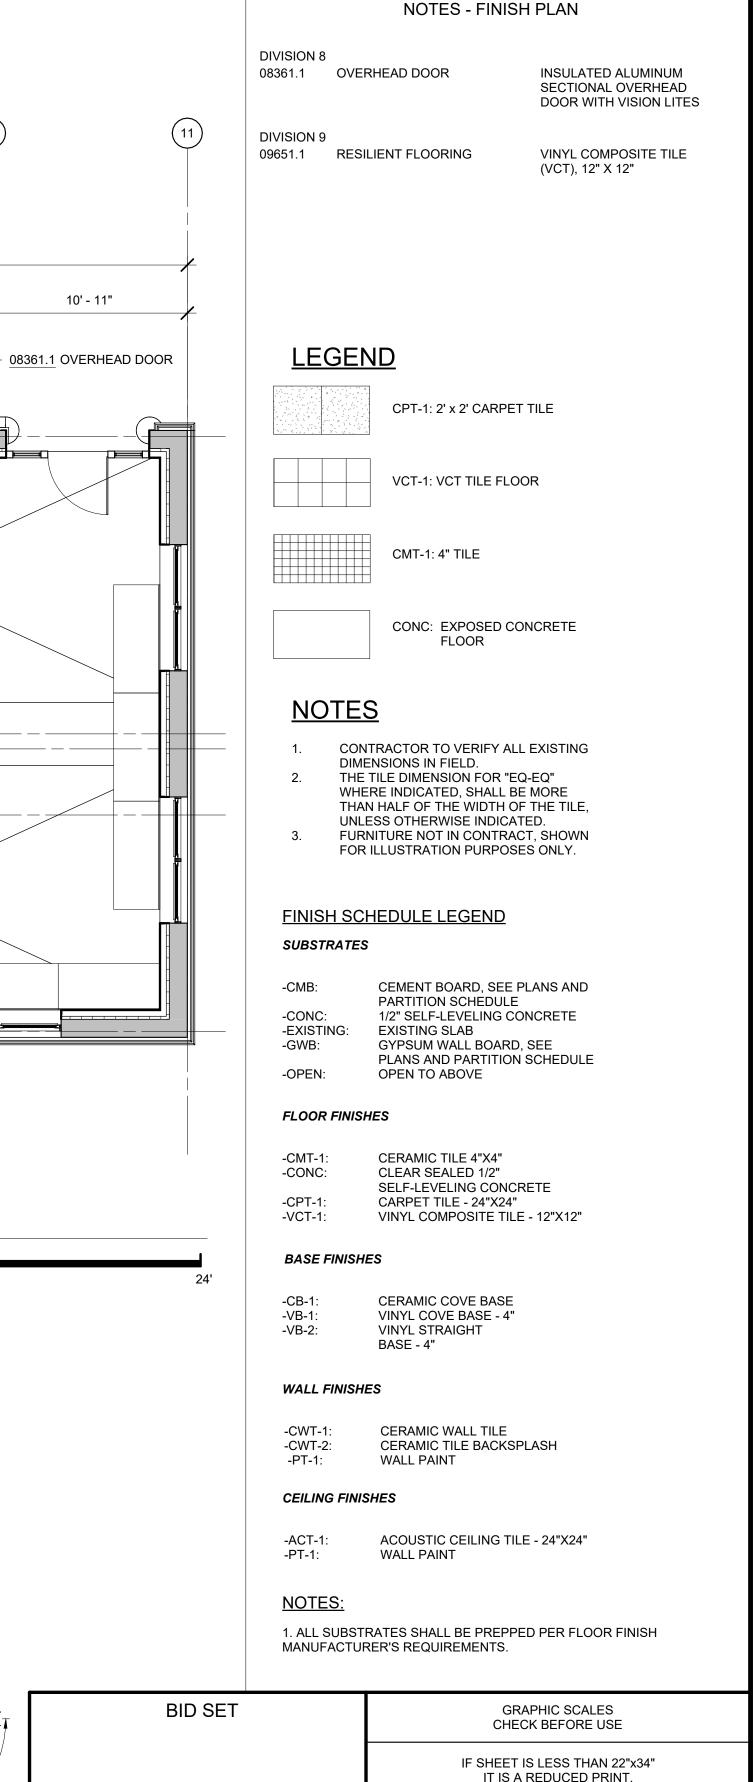ACCOUNTABLE MANAGER JOSE NIEVES PORTFOLIO MANAGER MARK DELBALZO, P.E. "WARNING-IT IS A VIOLATION, OF THE NEW YORK STATE EDUCATION LAW, SECTION, 7209.2, FOR ANY PERSON, UNLESS (S)HE IS ACTING UNDER THE DIRECTION OF A LICENSED PROFESSIONAL ENGINEER, TO ALTER THIS DOCUMENT IN ANY WAY. IF ALTERED, THE ALTERING PERSON SHALL COMPLY WITH THE REQUIREMENTS OF NEW YORK EDUCATION, LAW, SECTION, 7209.2." NEW YORK CITY ENVIRONMENTAL PROTEC BUREAU OF WATER SUPPLY 465 COLUMBUS AVENUE, SUITE 270 VALHALLA, NEW YORK 10595-1336 www.nyc.gov/dep



/								
370		IF SHEET IS LESS IT IS A REDUC SCALE ACCO	ED PRINT.					
	REPURPOSING OF THE KENSICC	) LABORATORY AS	DATE: MAY 2023					
	THE KENSICO REGIONAL HE	THE KENSICO REGIONAL HEADQUARTERS						
CTION	,	MOUNT PLEASANT, NEW YORK						
	CONTRACT CRO-	78 OF No. 121						
)	ARCHITECTURA	<b>NL</b>	DRAWING NO.					
	FINISH PLAN - FIRST	A-120						

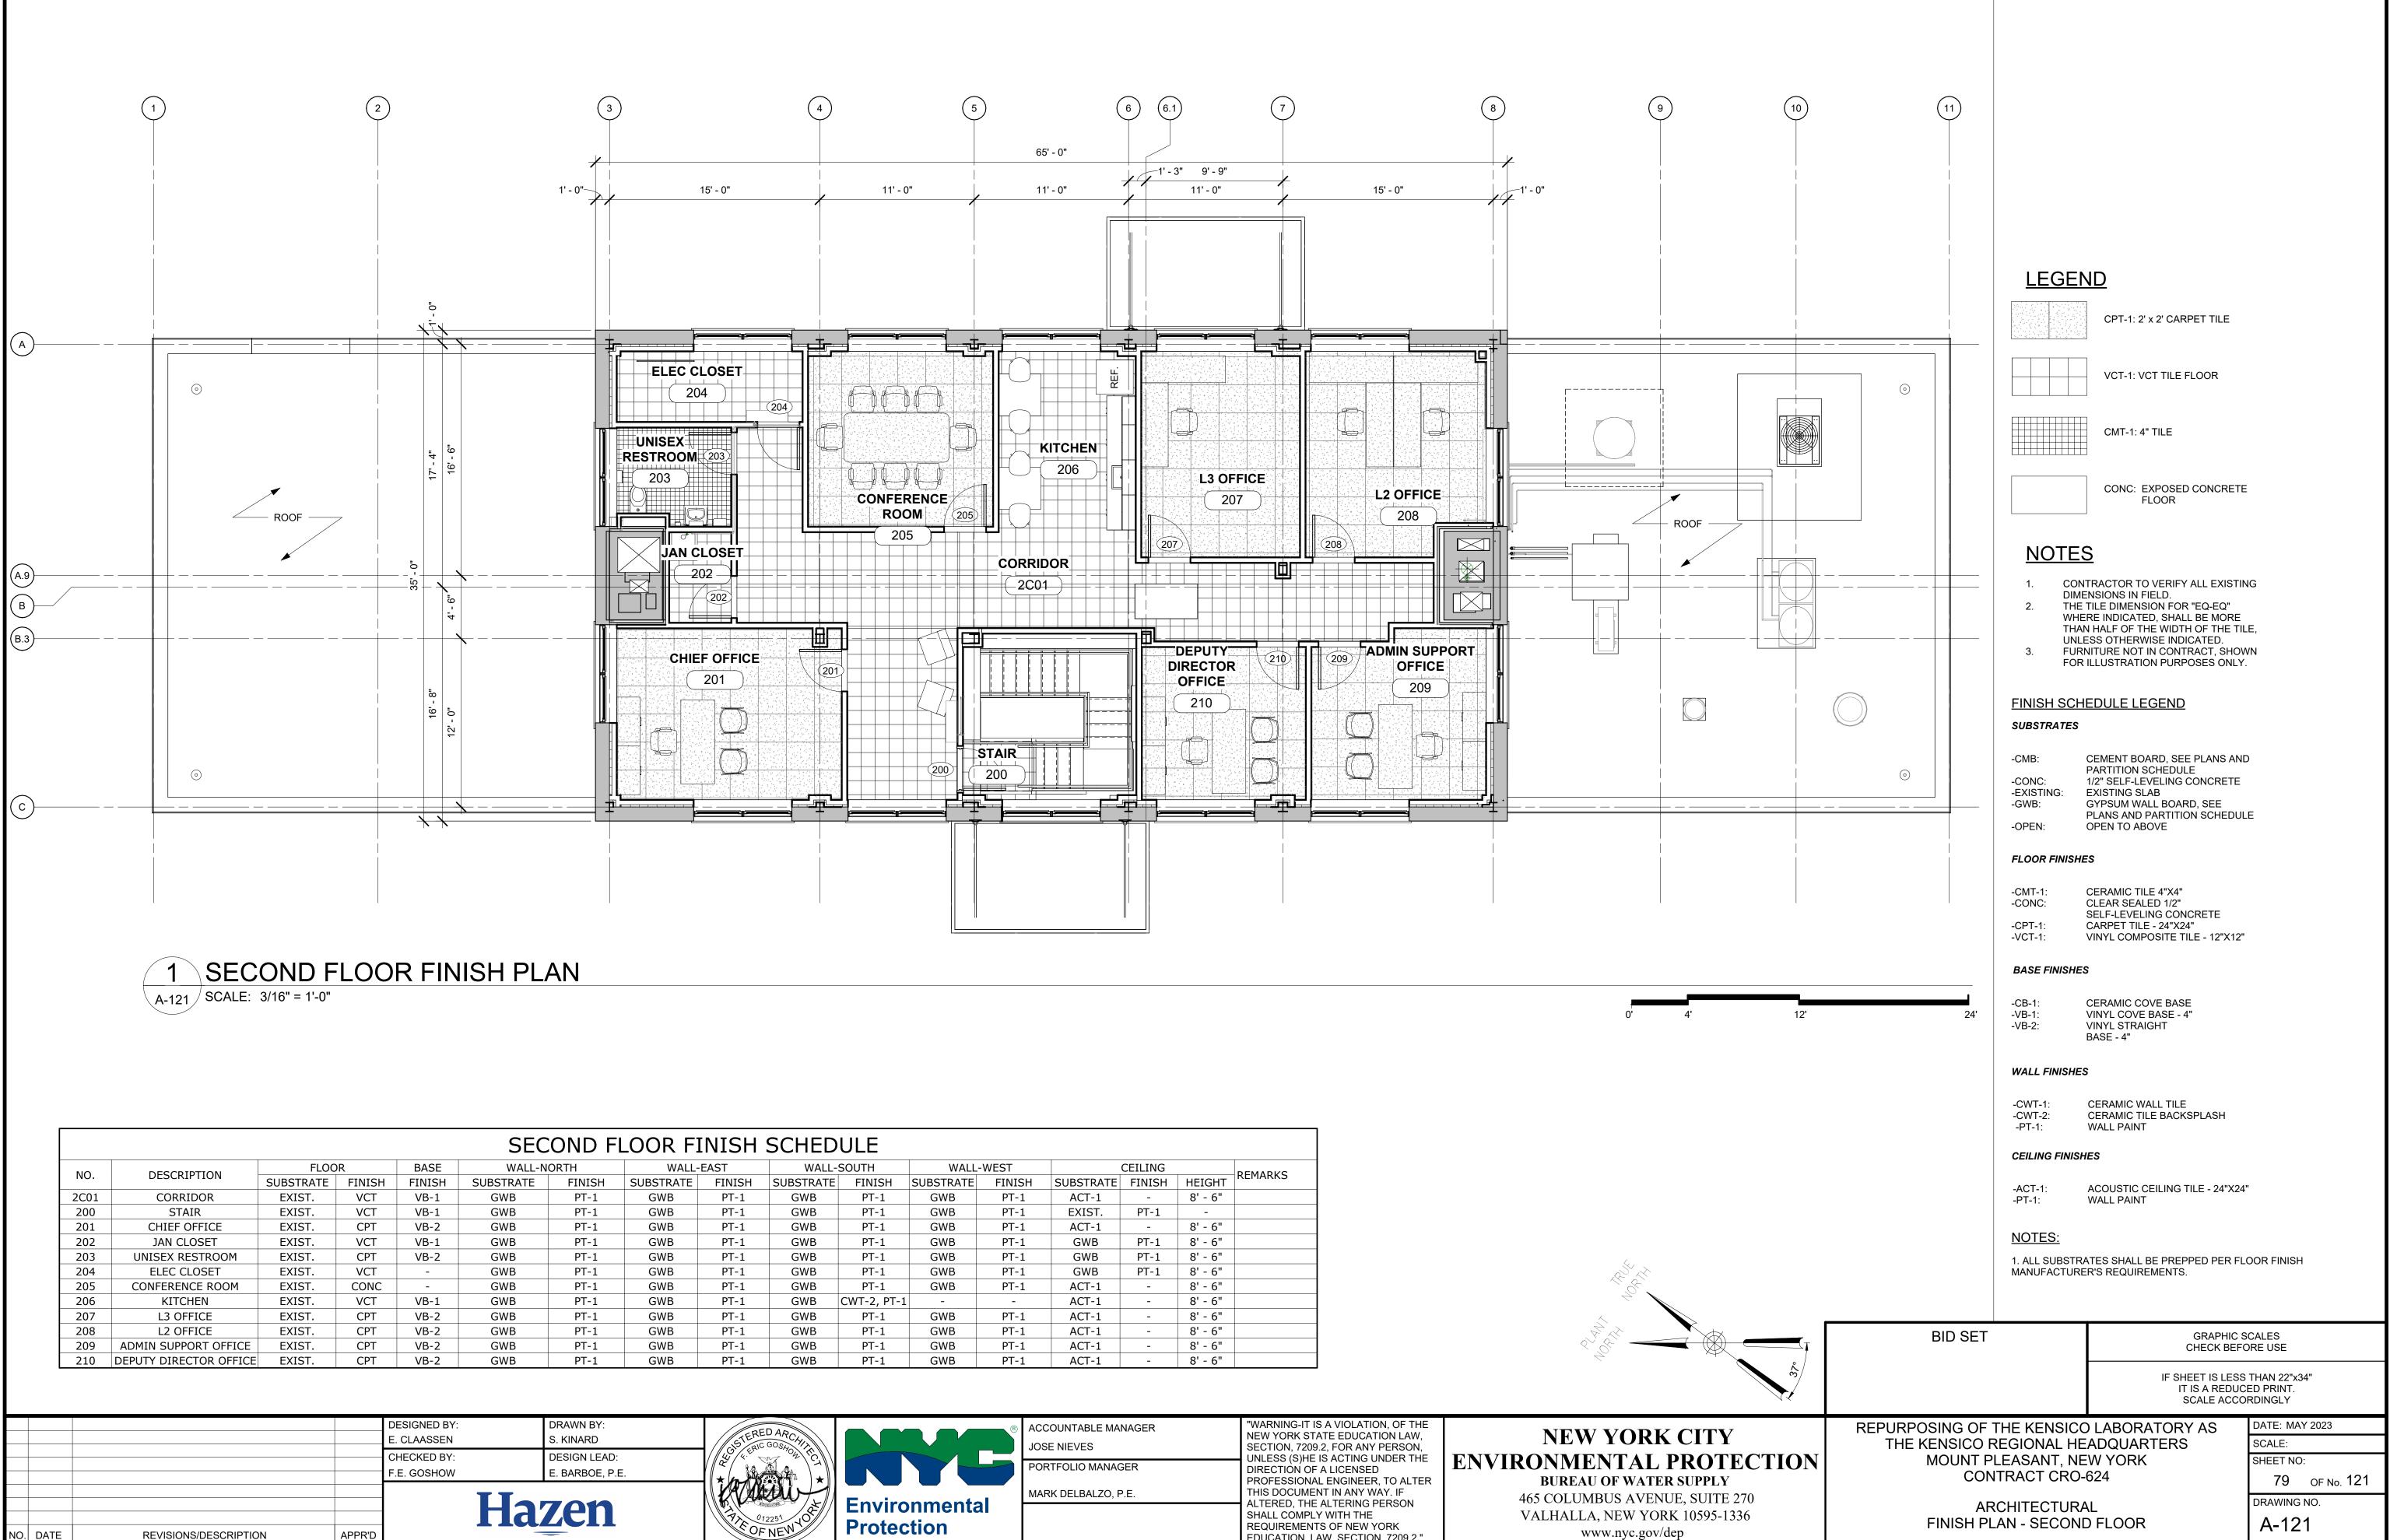

	SECOND FLOOR FINISH SCHEDULE															
NO.	DECOUDTION	FLOO	R	BASE	WALL-NO	DRTH	WALL-I	EAST	WALL-	SOUTH	WALL-	WEST		CEILING		REMARKS
NO.	DESCRIPTION	SUBSTRATE	FINISH	FINISH	SUBSTRATE	FINISH	SUBSTRATE	FINISH	SUBSTRATE	FINISH	SUBSTRATE	FINISH	SUBSTRATE	FINISH	HEIGHT	KEMAKK
2C01	CORRIDOR	EXIST.	VCT	VB-1	GWB	PT-1	GWB	PT-1	GWB	PT-1	GWB	PT-1	ACT-1	-	8' - 6"	
200	STAIR	EXIST.	VCT	VB-1	GWB	PT-1	GWB	PT-1	GWB	PT-1	GWB	PT-1	EXIST.	PT-1	-	
201	CHIEF OFFICE	EXIST.	CPT	VB-2	GWB	PT-1	GWB	PT-1	GWB	PT-1	GWB	PT-1	ACT-1	-	8' - 6"	
202	JAN CLOSET	EXIST.	VCT	VB-1	GWB	PT-1	GWB	PT-1	GWB	PT-1	GWB	PT-1	GWB	PT-1	8' - 6"	
203	UNISEX RESTROOM	EXIST.	CPT	VB-2	GWB	PT-1	GWB	PT-1	GWB	PT-1	GWB	PT-1	GWB	PT-1	8' - 6"	
204	ELEC CLOSET	EXIST.	VCT	-	GWB	PT-1	GWB	PT-1	GWB	PT-1	GWB	PT-1	GWB	PT-1	8' - 6"	
205	CONFERENCE ROOM	EXIST.	CONC	-	GWB	PT-1	GWB	PT-1	GWB	PT-1	GWB	PT-1	ACT-1	-	8' - 6"	
206	KITCHEN	EXIST.	VCT	VB-1	GWB	PT-1	GWB	PT-1	GWB	CWT-2, PT-1	-	-	ACT-1	-	8' - 6"	
207	L3 OFFICE	EXIST.	CPT	VB-2	GWB	PT-1	GWB	PT-1	GWB	PT-1	GWB	PT-1	ACT-1	-	8' - 6"	
208	L2 OFFICE	EXIST.	CPT	VB-2	GWB	PT-1	GWB	PT-1	GWB	PT-1	GWB	PT-1	ACT-1	-	8' - 6"	
209	ADMIN SUPPORT OFFICE	EXIST.	CPT	VB-2	GWB	PT-1	GWB	PT-1	GWB	PT-1	GWB	PT-1	ACT-1	-	8' - 6"	
210	DEPUTY DIRECTOR OFFICE	EXIST.	CPT	VB-2	GWB	PT-1	GWB	PT-1	GWB	PT-1	GWB	PT-1	ACT-1	-	8' - 6"	


OFNEN NO. DATE **REVISIONS/DESCRIPTION** APPR'D

All inquiries regarding this drawing(s) or project should be made to NYC Environmental Protection, Bureau of Water Supply.




ACCOUNTABLE MANAGER						
JOSE NIEVES						
PORTFOLIO MANAGER						
MARK DELBALZO, P.E.						

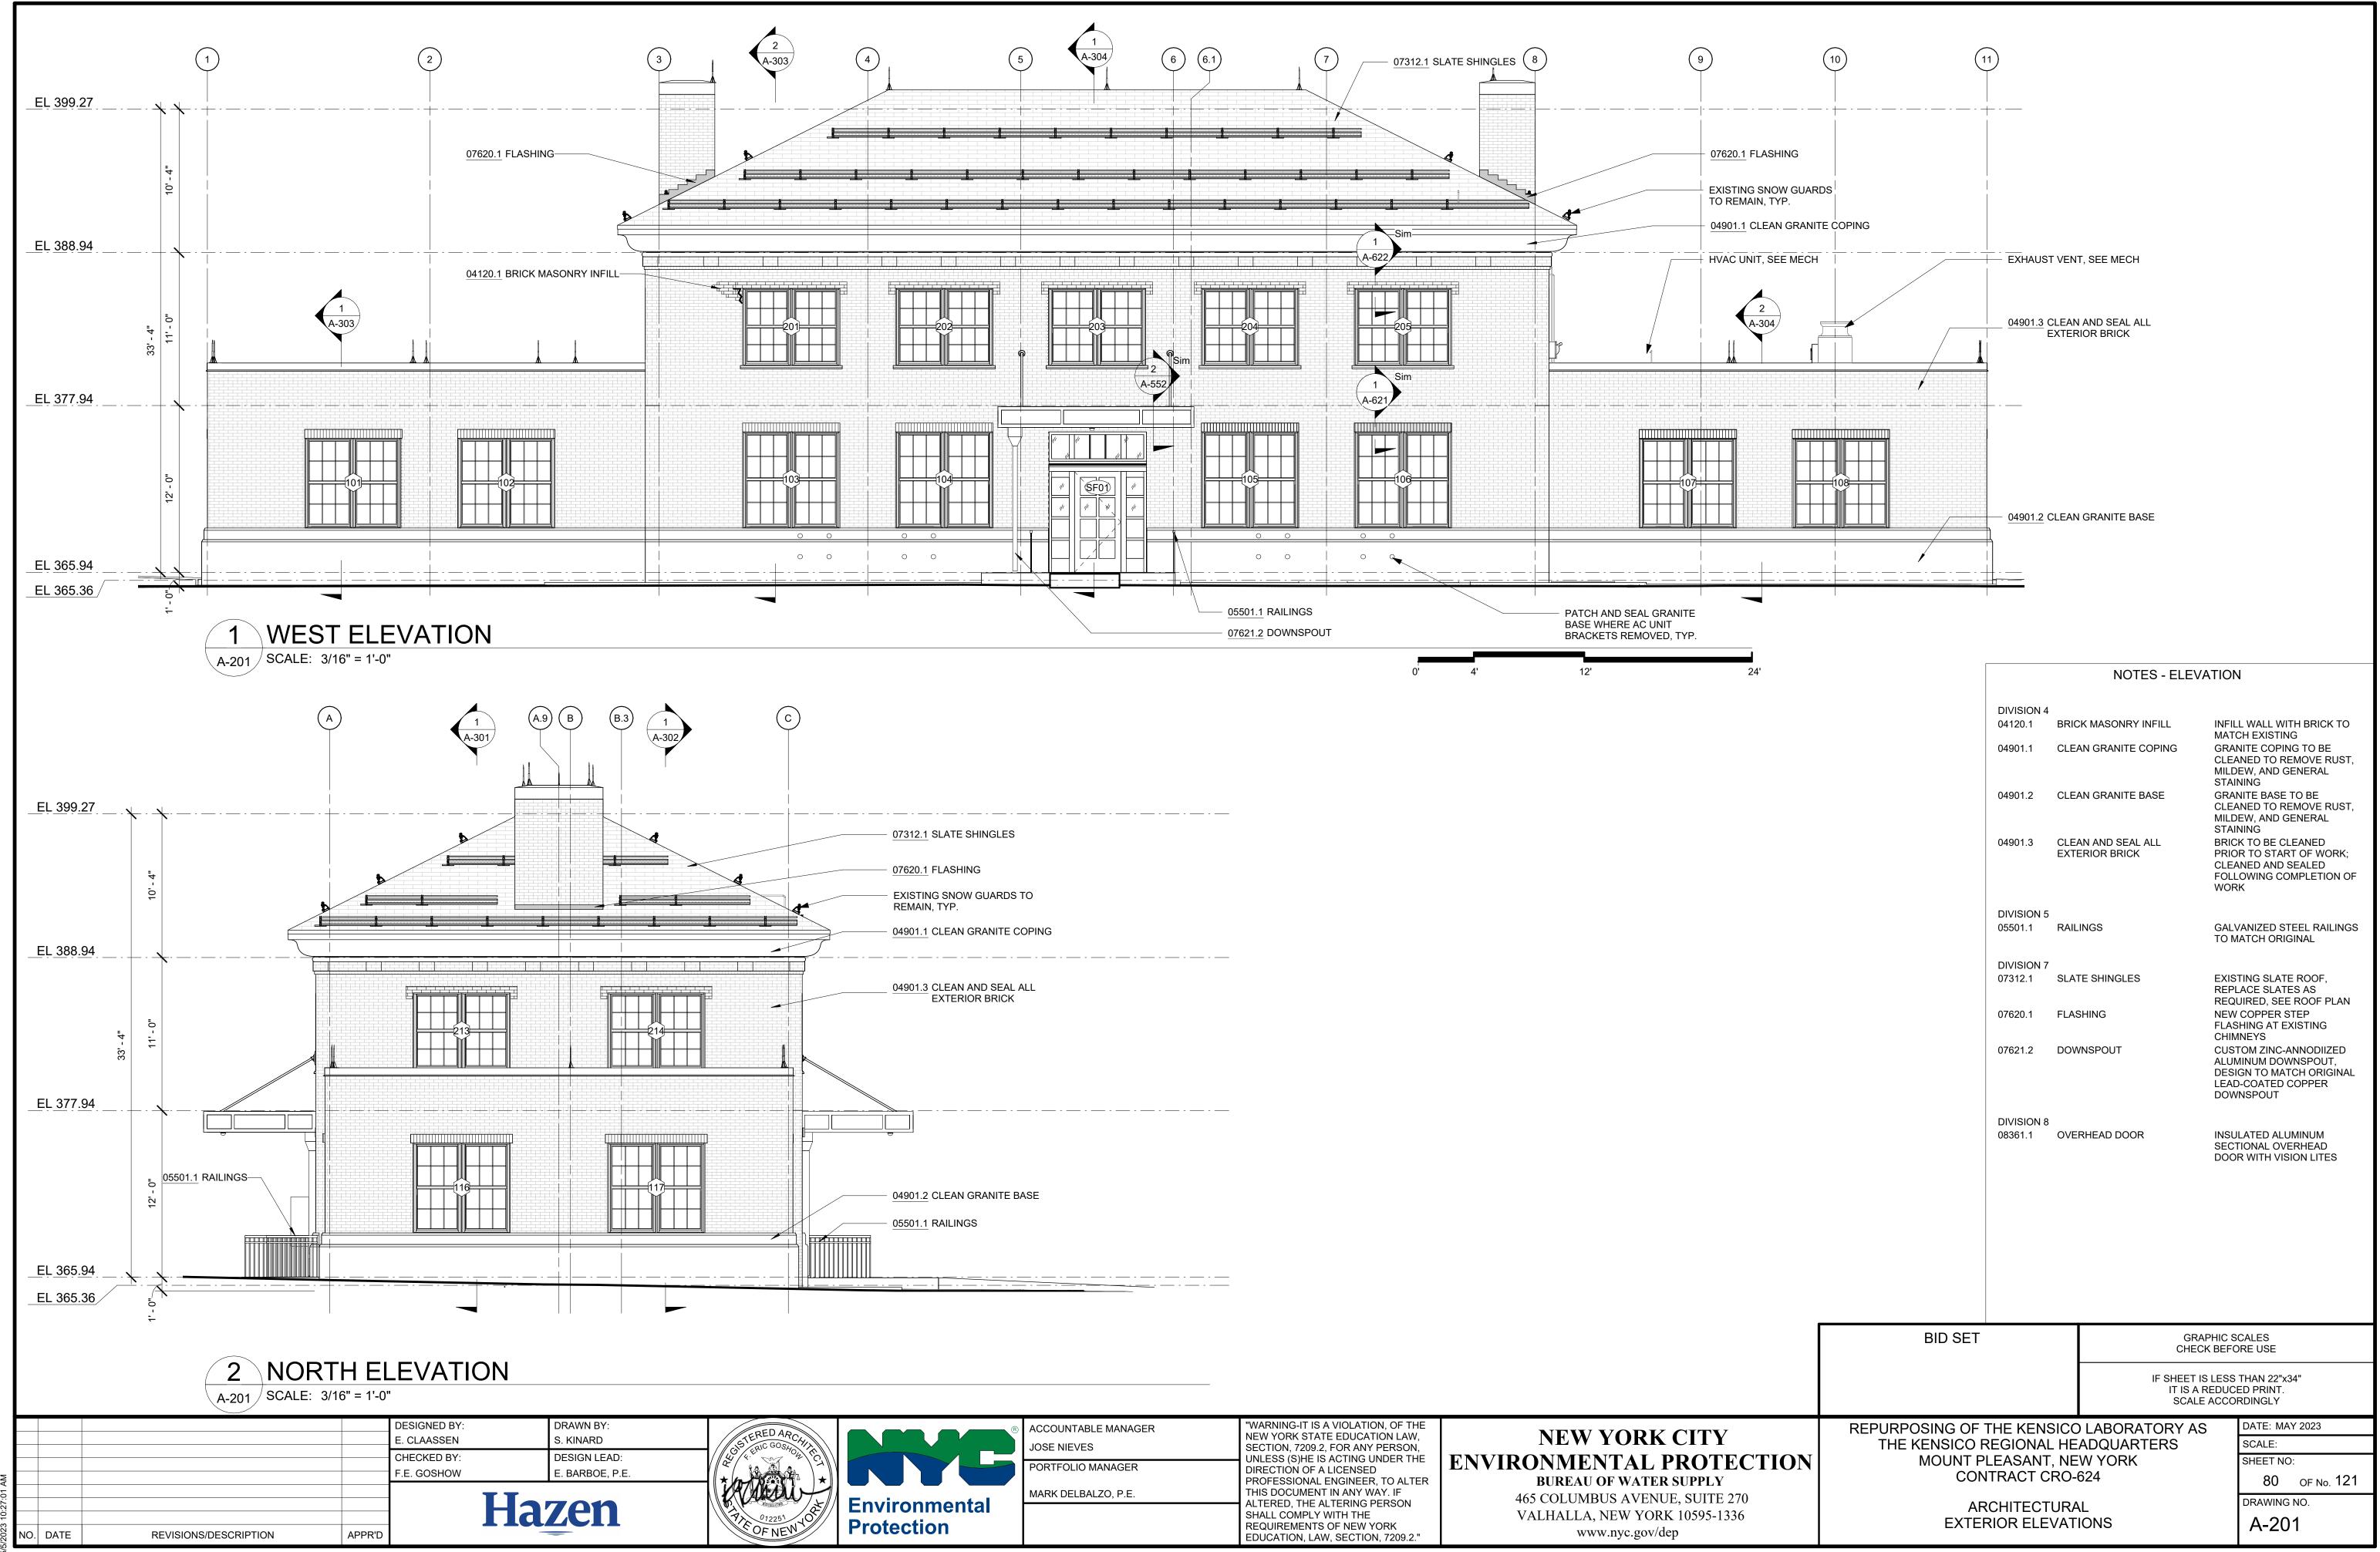EDUCATION, LAW, SECTION, 7209.2."




07312.1 SLATE SHINGLES	
07620.1 FLASHING	
EXISTING SNOW GUARDS TO REMAIN, TYP.	
04901.1 CLEAN GRANITE COPING	
04901.3 CLEAN AND SEAL ALL EXTERIOR BRICK	


			NOTES - E	NOTES - ELEVATION						
	DIVISION 4 04120.1	BRIC	K MASONRY INFILL		INFIL	L WALL WITH BRICK TO				
	04901.1	CLE	AN GRANITE COPINC	G	GRAN CLEA MILDI	CH EXISTING NITE COPING TO BE NED TO REMOVE RUST, EW, AND GENERAL				
	04901.2	CLE	AN GRANITE BASE		CLEA MILDI	NITE BASE TO BE NED TO REMOVE RUST, EW, AND GENERAL				
	04901.3		AN AND SEAL ALL ERIOR BRICK		PRIO CLEA	K TO BE CLEANED R TO START OF WORK; NED AND SEALED OWING COMPLETION OF				
	DIVISION 5 05501.1	RAIL	INGS		·····	ANIZED STEEL RAILINGS ATCH ORIGINAL				
	DIVISION 7 07312.1	SLA	E SHINGLES		REPL	FING SLATE ROOF, ACE SLATES AS				
	07620.1	FLAS	SHING		NEW FLAS	EQUIRED, SEE ROOF PLAN EW COPPER STEP LASHING AT EXISTING HIMNEYS				
	07621.2	DOW	ALU DES LEA		CUST ALUM DESIO	TOM ZINC-ANNODIIZED MINUM DOWNSPOUT, IGN TO MATCH ORIGINAL D-COATED COPPER VNSPOUT				
	DIVISION 8 08361.1	OVE	RHEAD DOOR		SECT	LATED ALUMINUM IONAL OVERHEAD R WITH VISION LITES				
SID SET				GRAPI CHECK		CALES RE USE				
			ľ	T IS A RE	EDUCE	THAN 22"x34" ED PRINT. RDINGLY				
			LABORATOR			DATE: MAY 2023 SCALE:				
OUNT PI	_EASANT, TRACT CI	, NE	W YORK			SHEET NO:				
	JRA				80 OF No. 121 DRAWING NO.					

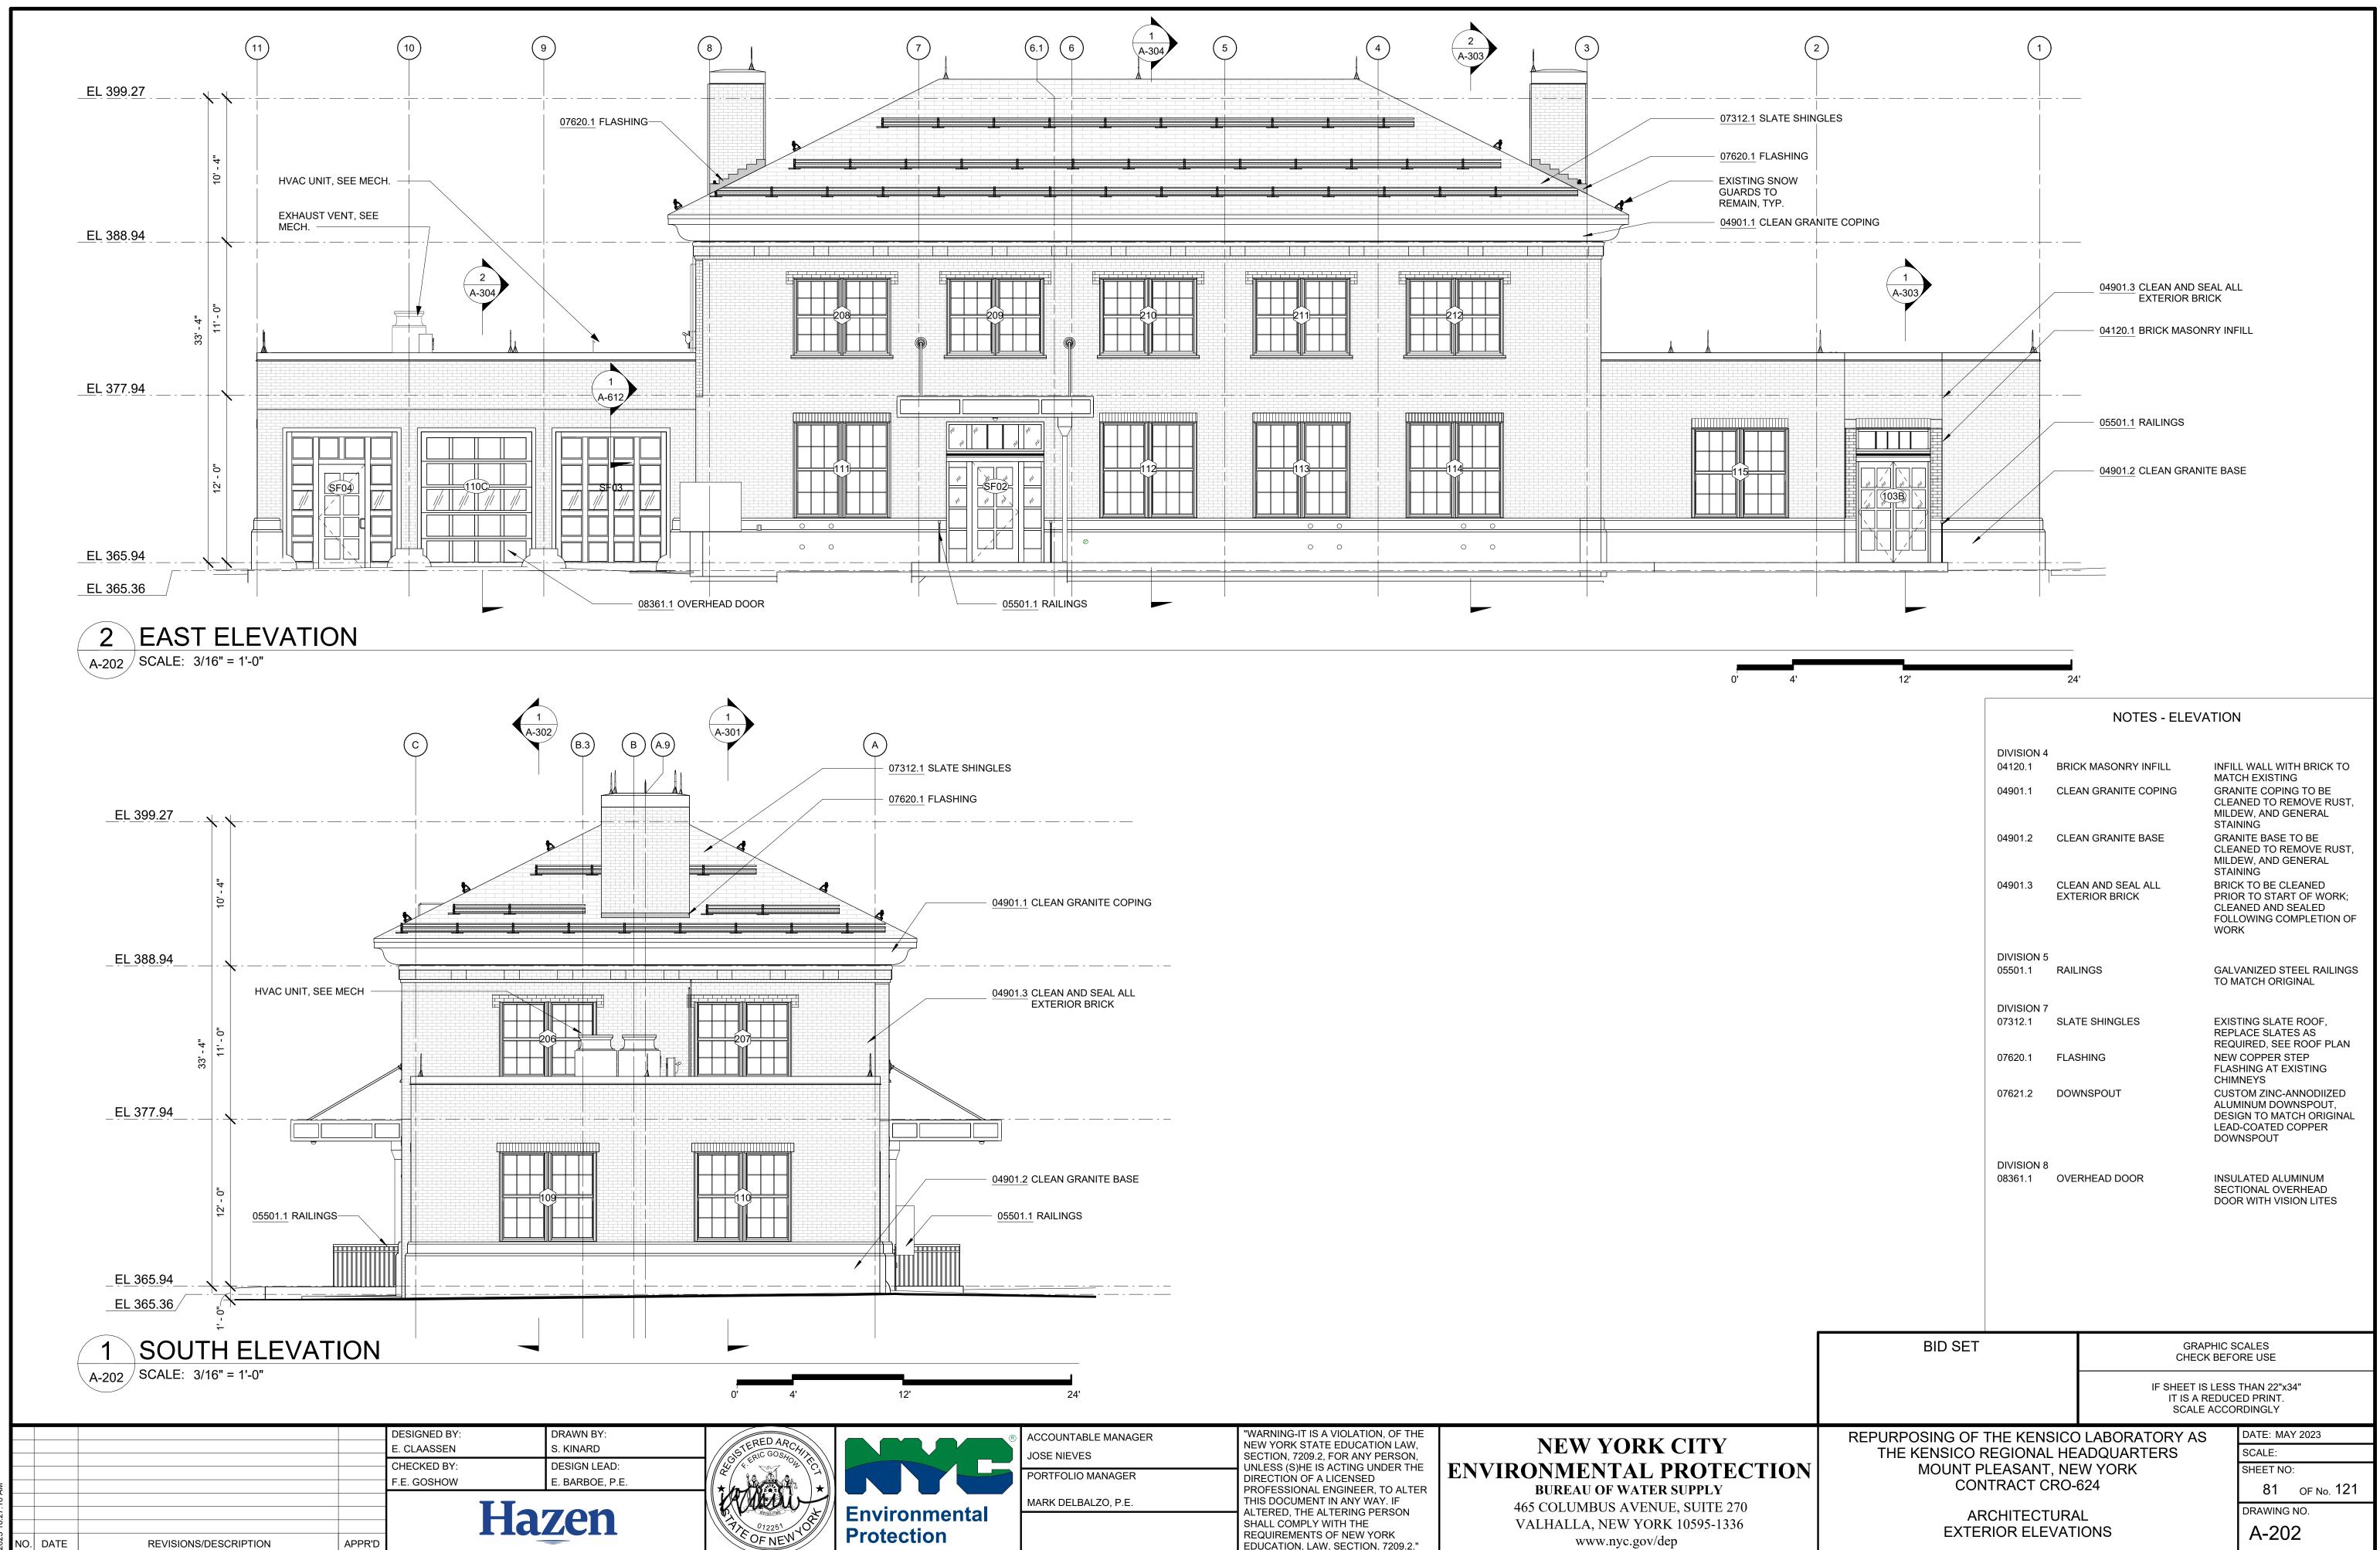


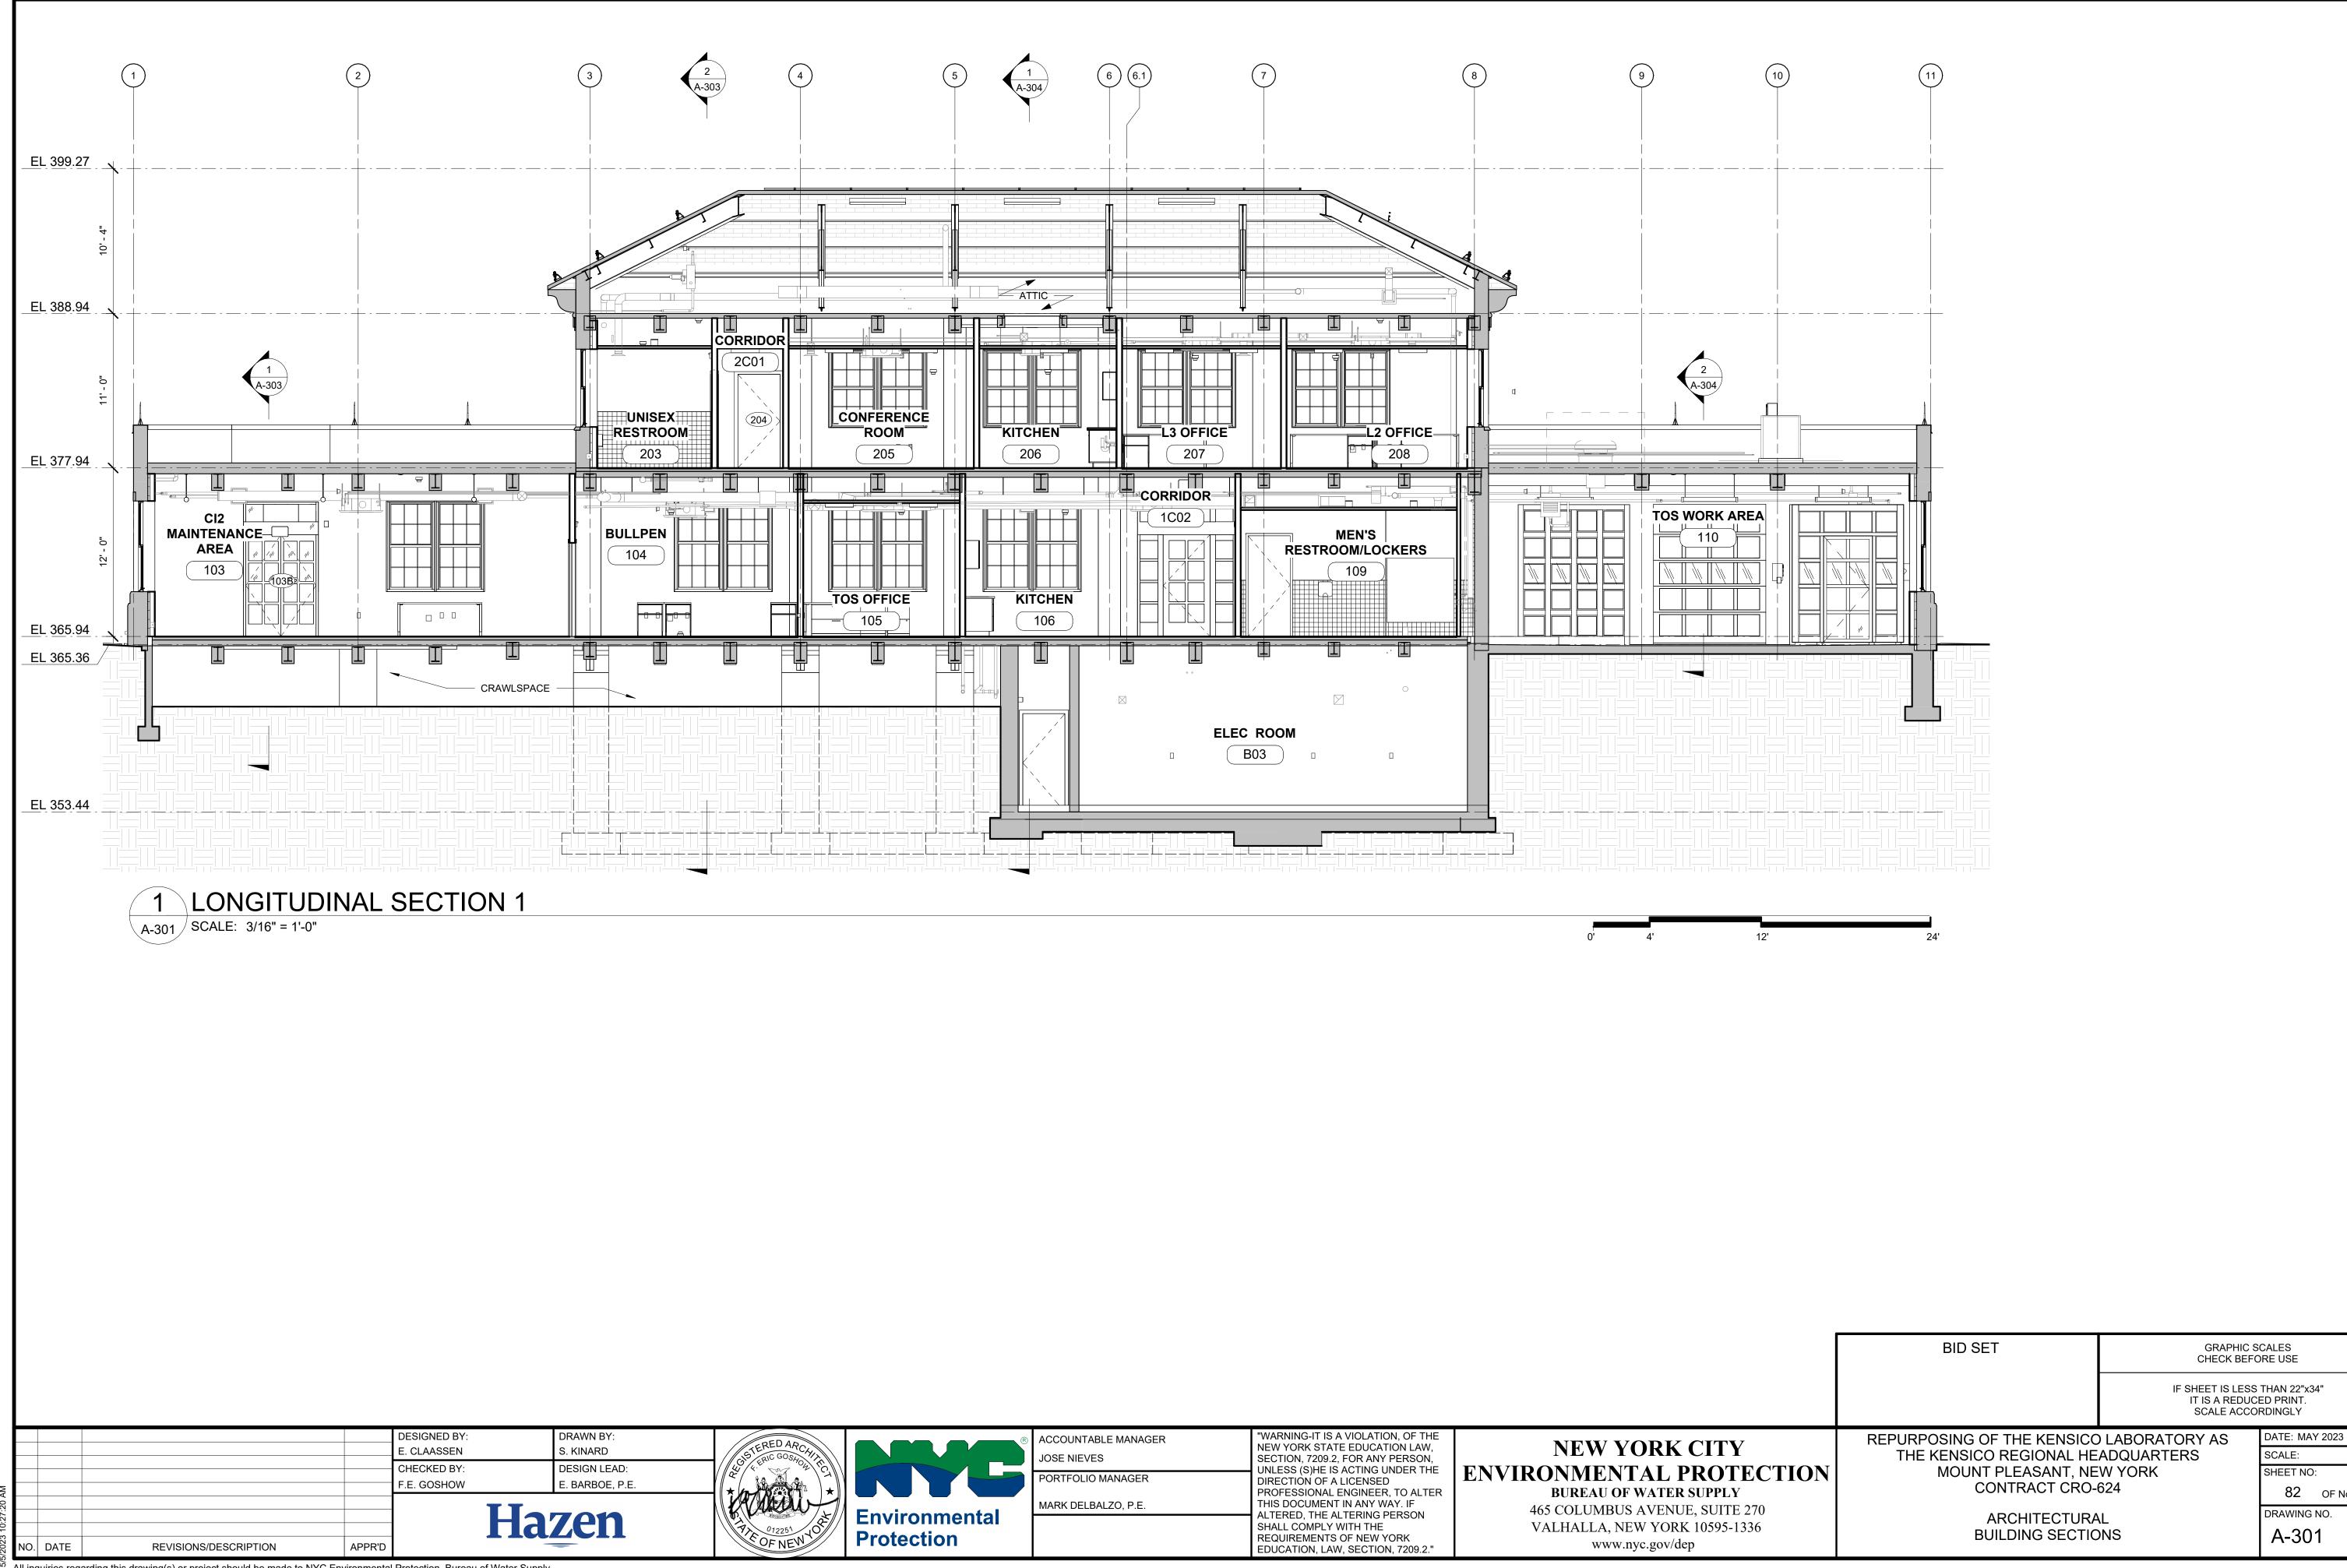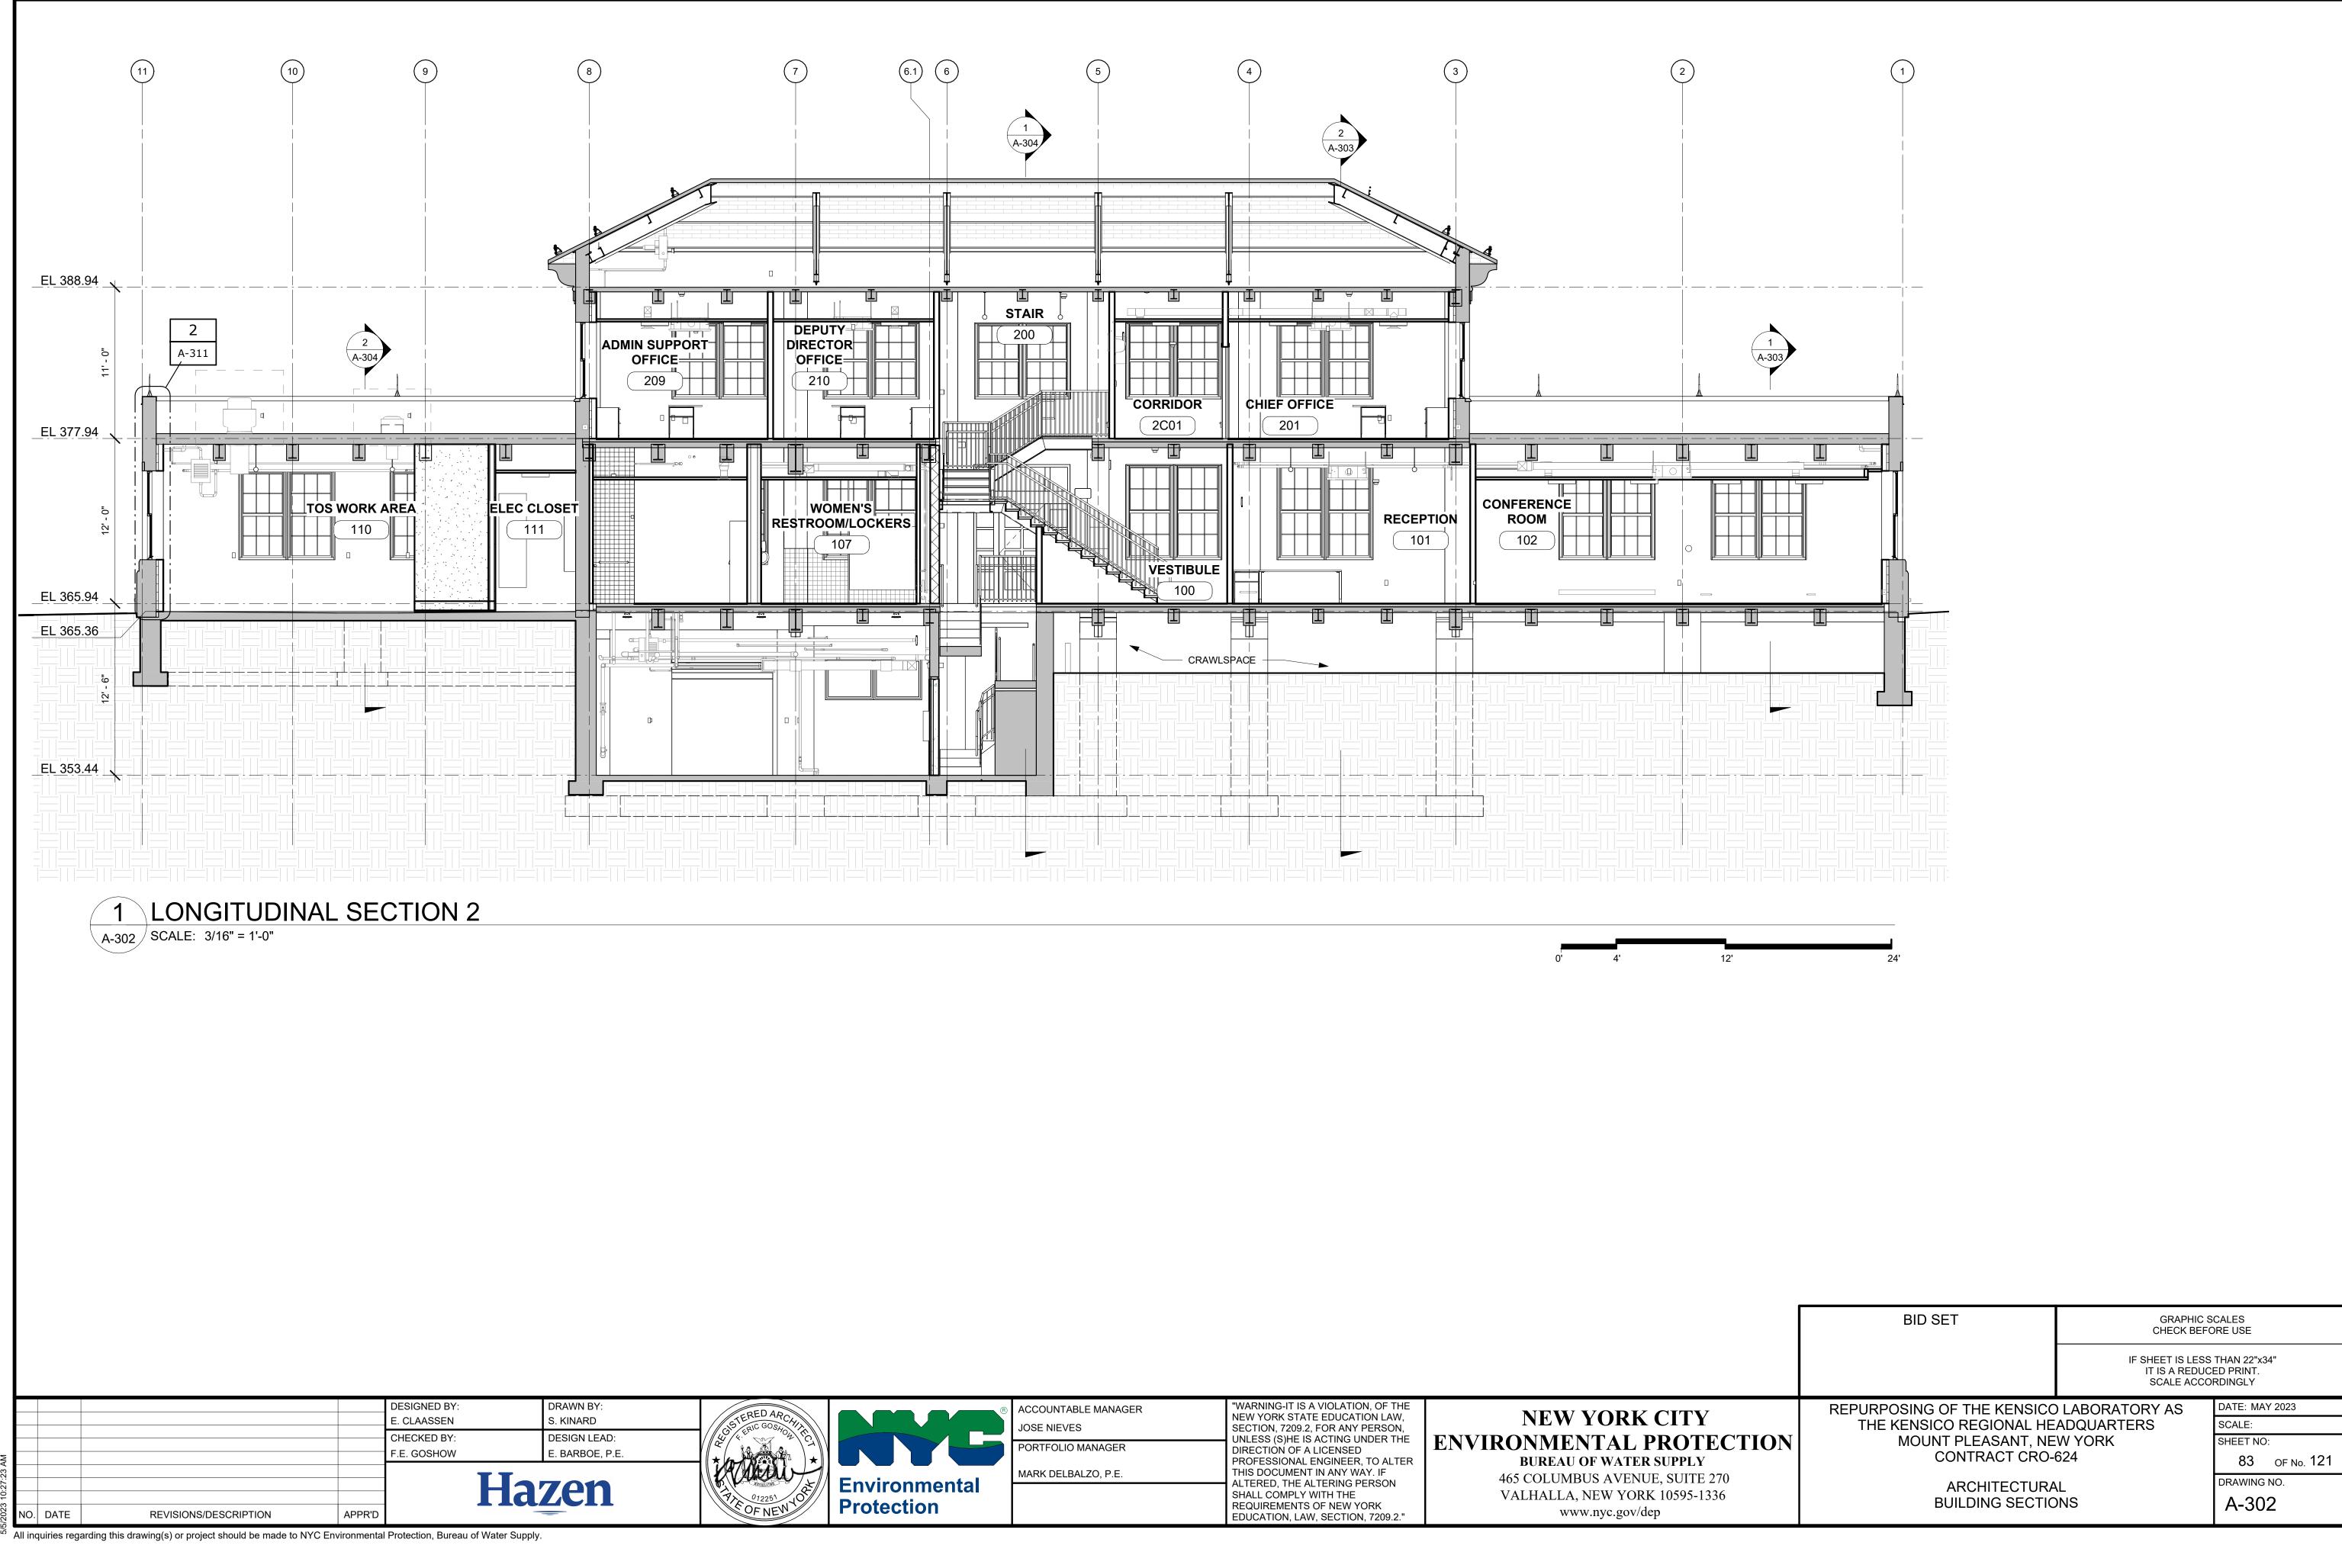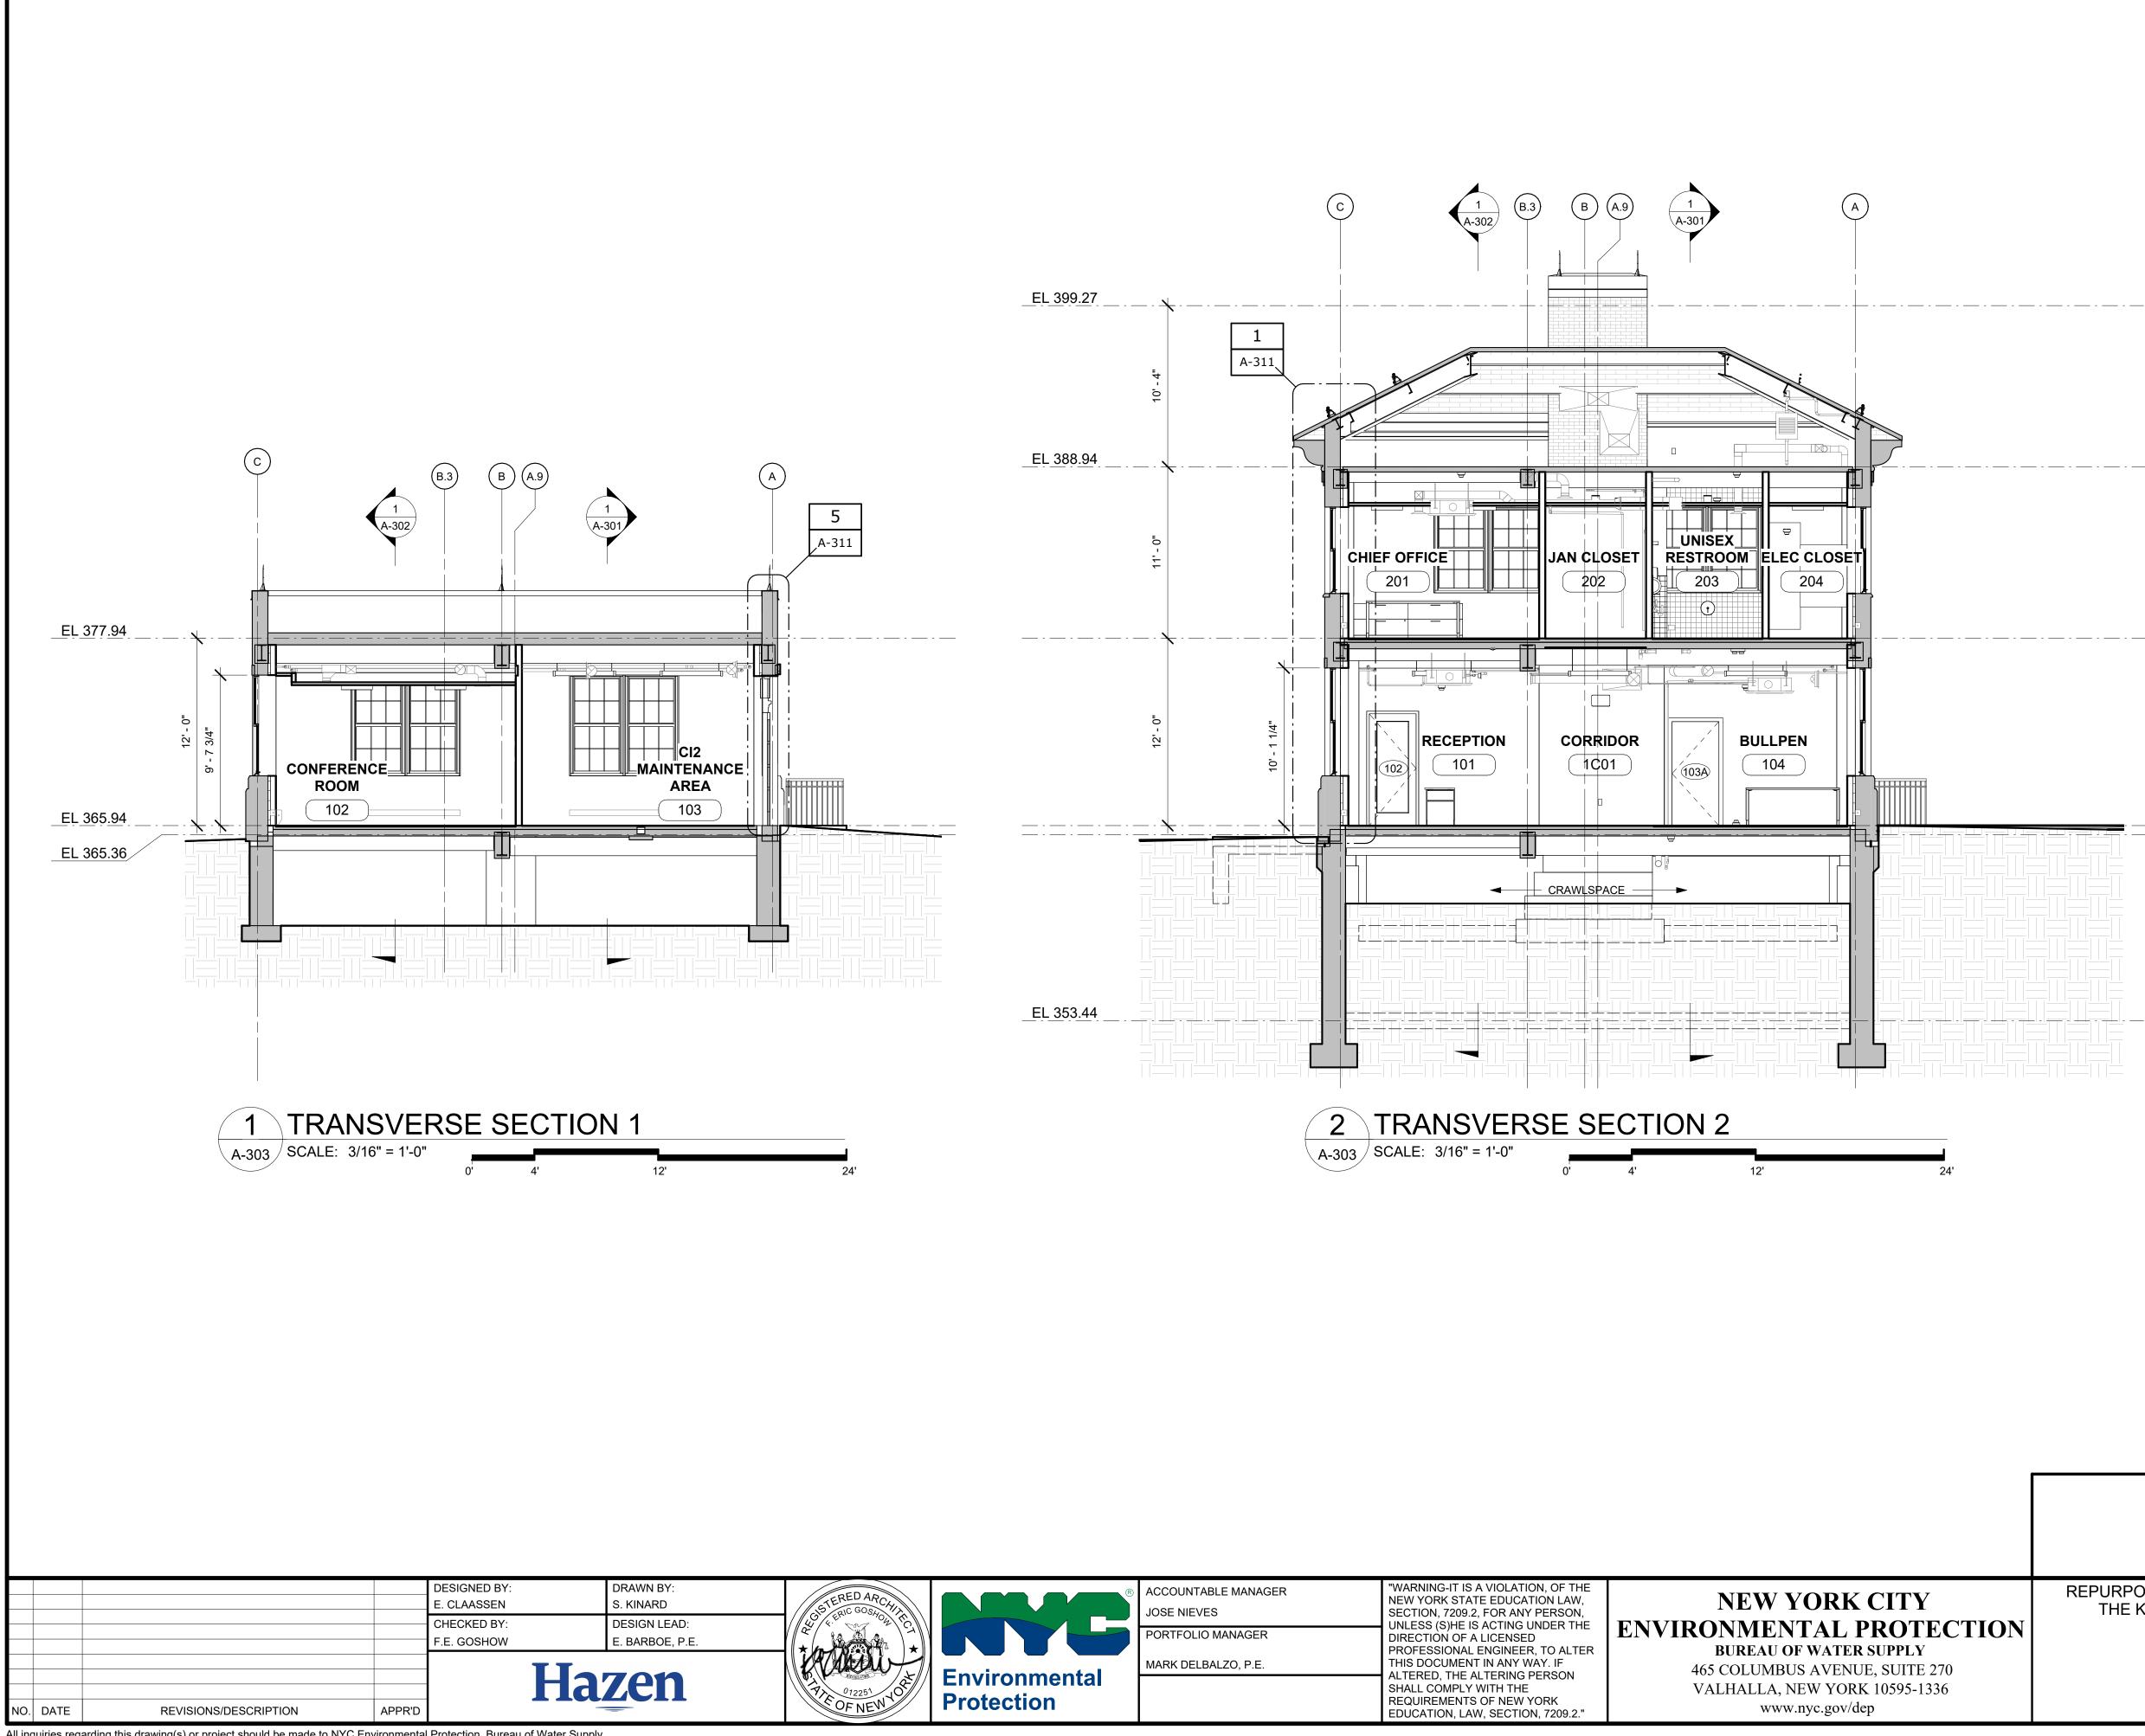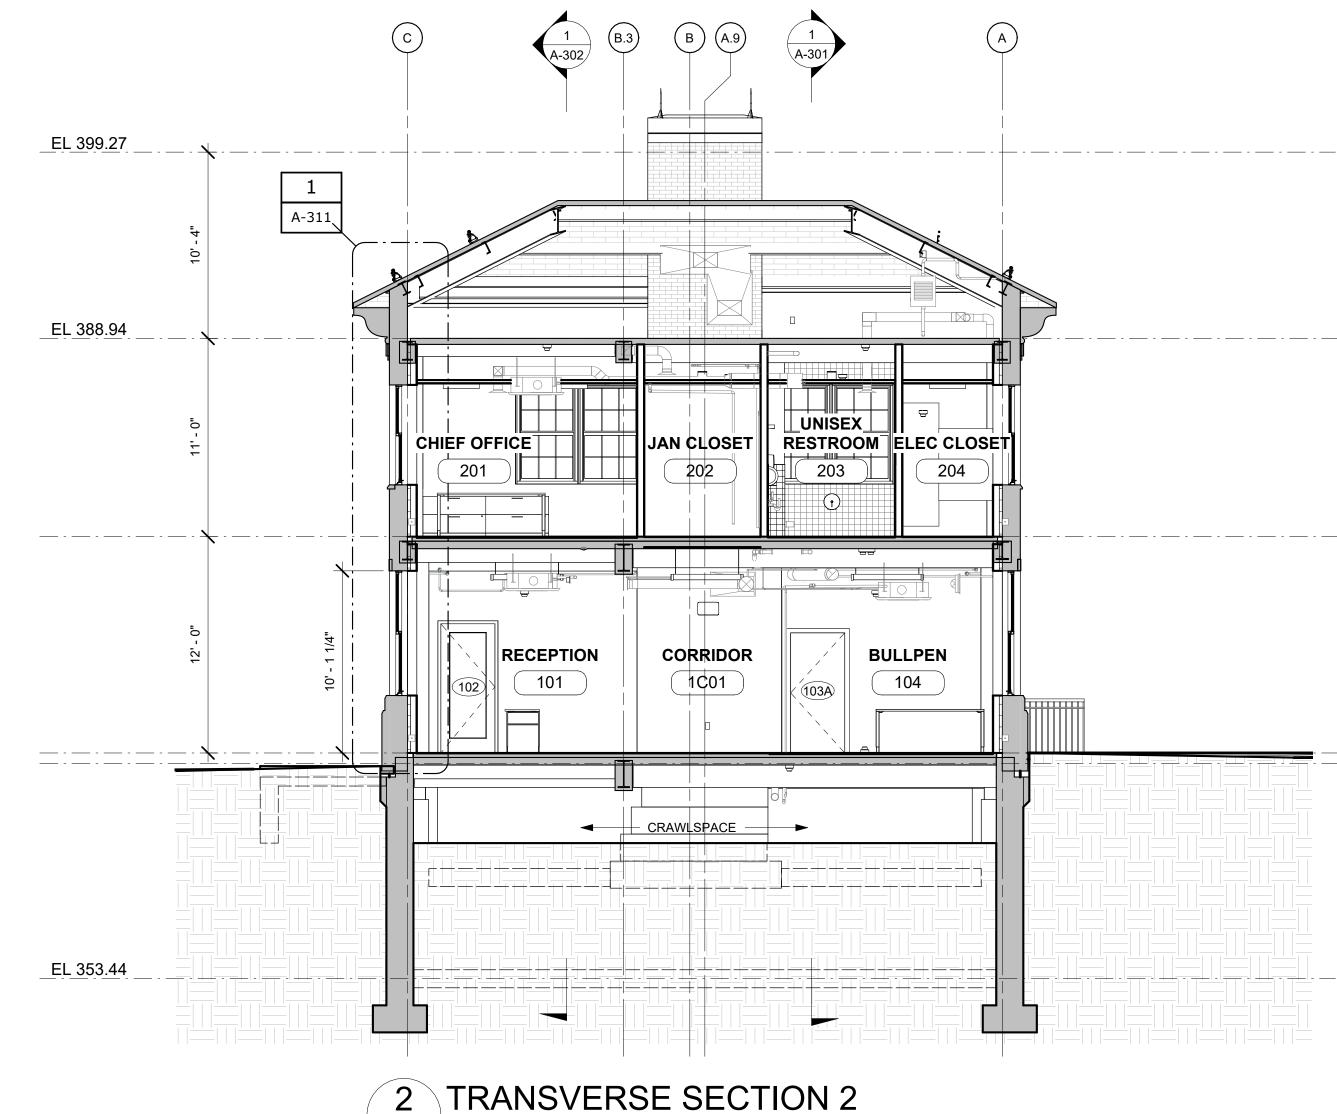
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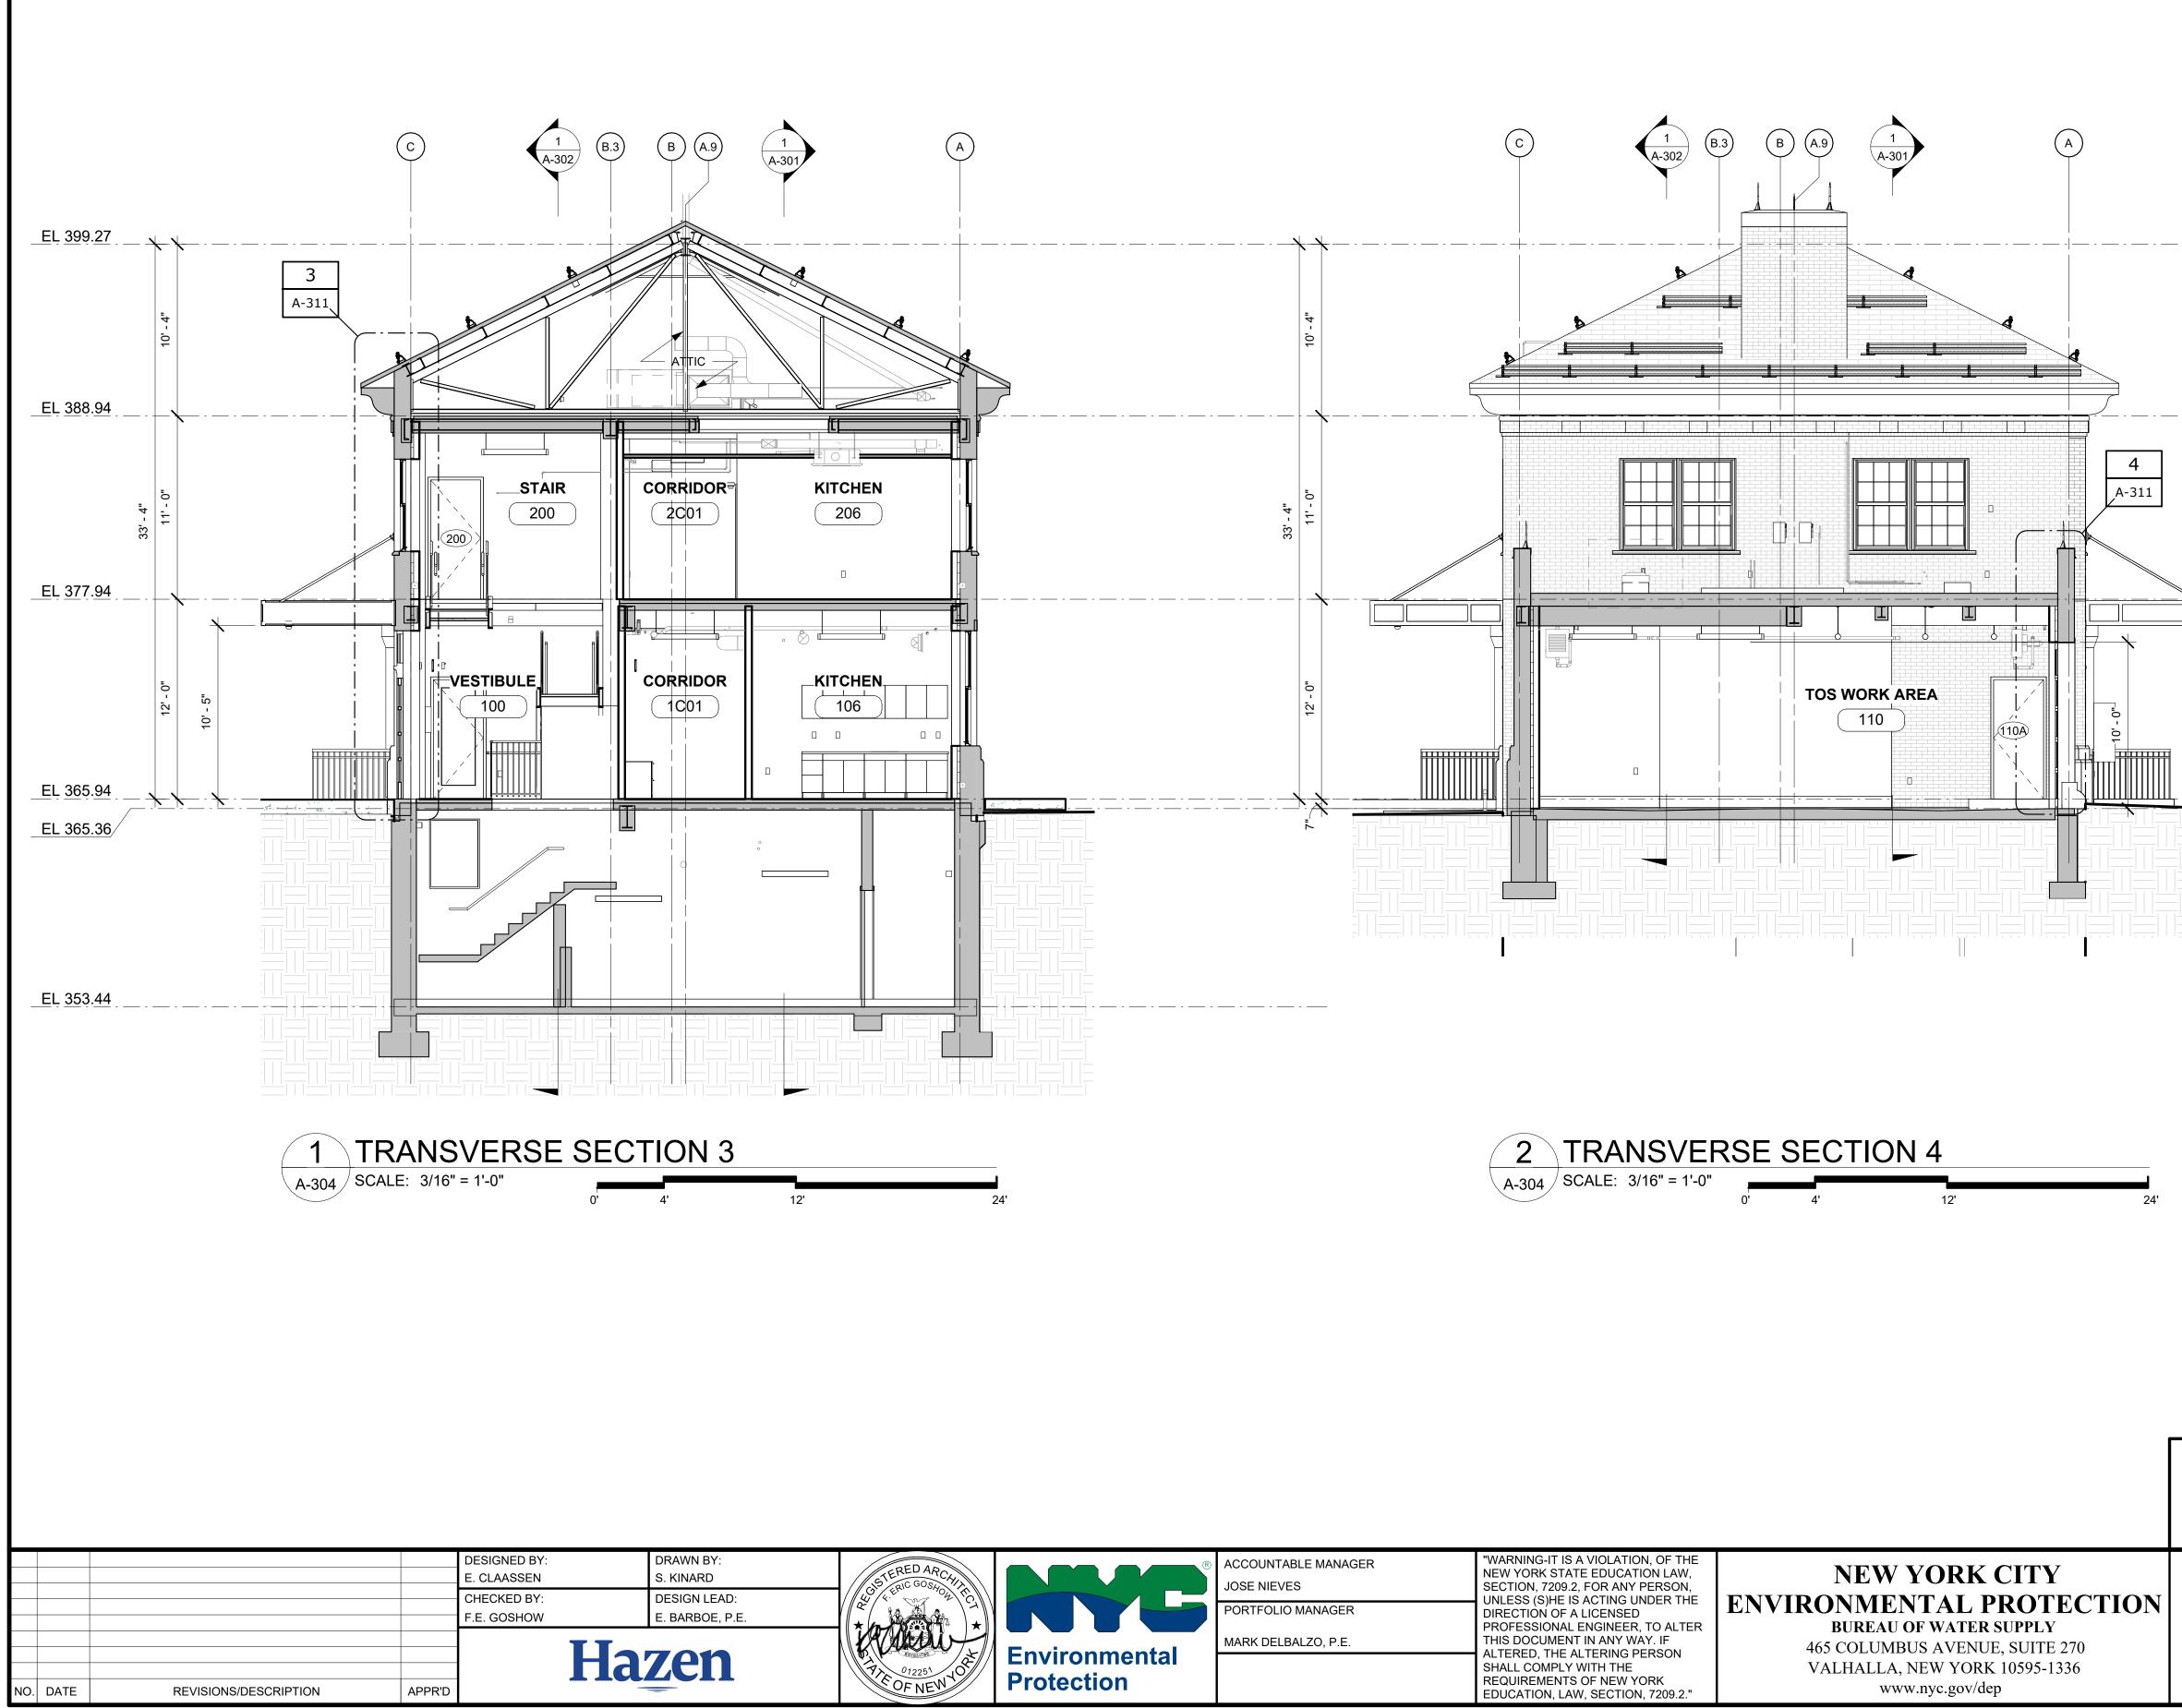
	1 2020						
SCALE:							
SHEET NO	:						
82	OF No. 12						
DRAWING NO.							
A-30	1						








	BID SET	BID SET GRAPHIC SO CHECK BEFO						
		IF SHEET IS LESS IT IS A REDUCI SCALE ACCO	ED PRINT.					
	REPURPOSING OF THE KENSICC	LABORATORY AS	DATE: MAY 2023					
	THE KENSICO REGIONAL HE	SCALE:						
CTION	MOUNT PLEASANT, NE	SHEET NO:						
	CONTRACT CRO-	84 OF No. 121						
	ARCHITECTURA	<b>NL</b>	DRAWING NO.					
	BUILDING SECTIO	A-303						




k Docs://90290-03A\_CAT-423 WO-03A Recon of Kensico Lab/90290-03

4 A-311	

	BID SET	CALES DRE USE	
		THAN 22"x34" ED PRINT. RDINGLY	
	REPURPOSING OF THE KENSICC	DATE: MAY 2023	
	THE KENSICO REGIONAL HE	SCALE:	
CTION	MOUNT PLEASANT, NE	SHEET NO:	
	CONTRACT CRO-	85 OF No. 121	
	ARCHITECTURAL		DRAWING NO.
	BUILDING SECTIONS		A-304

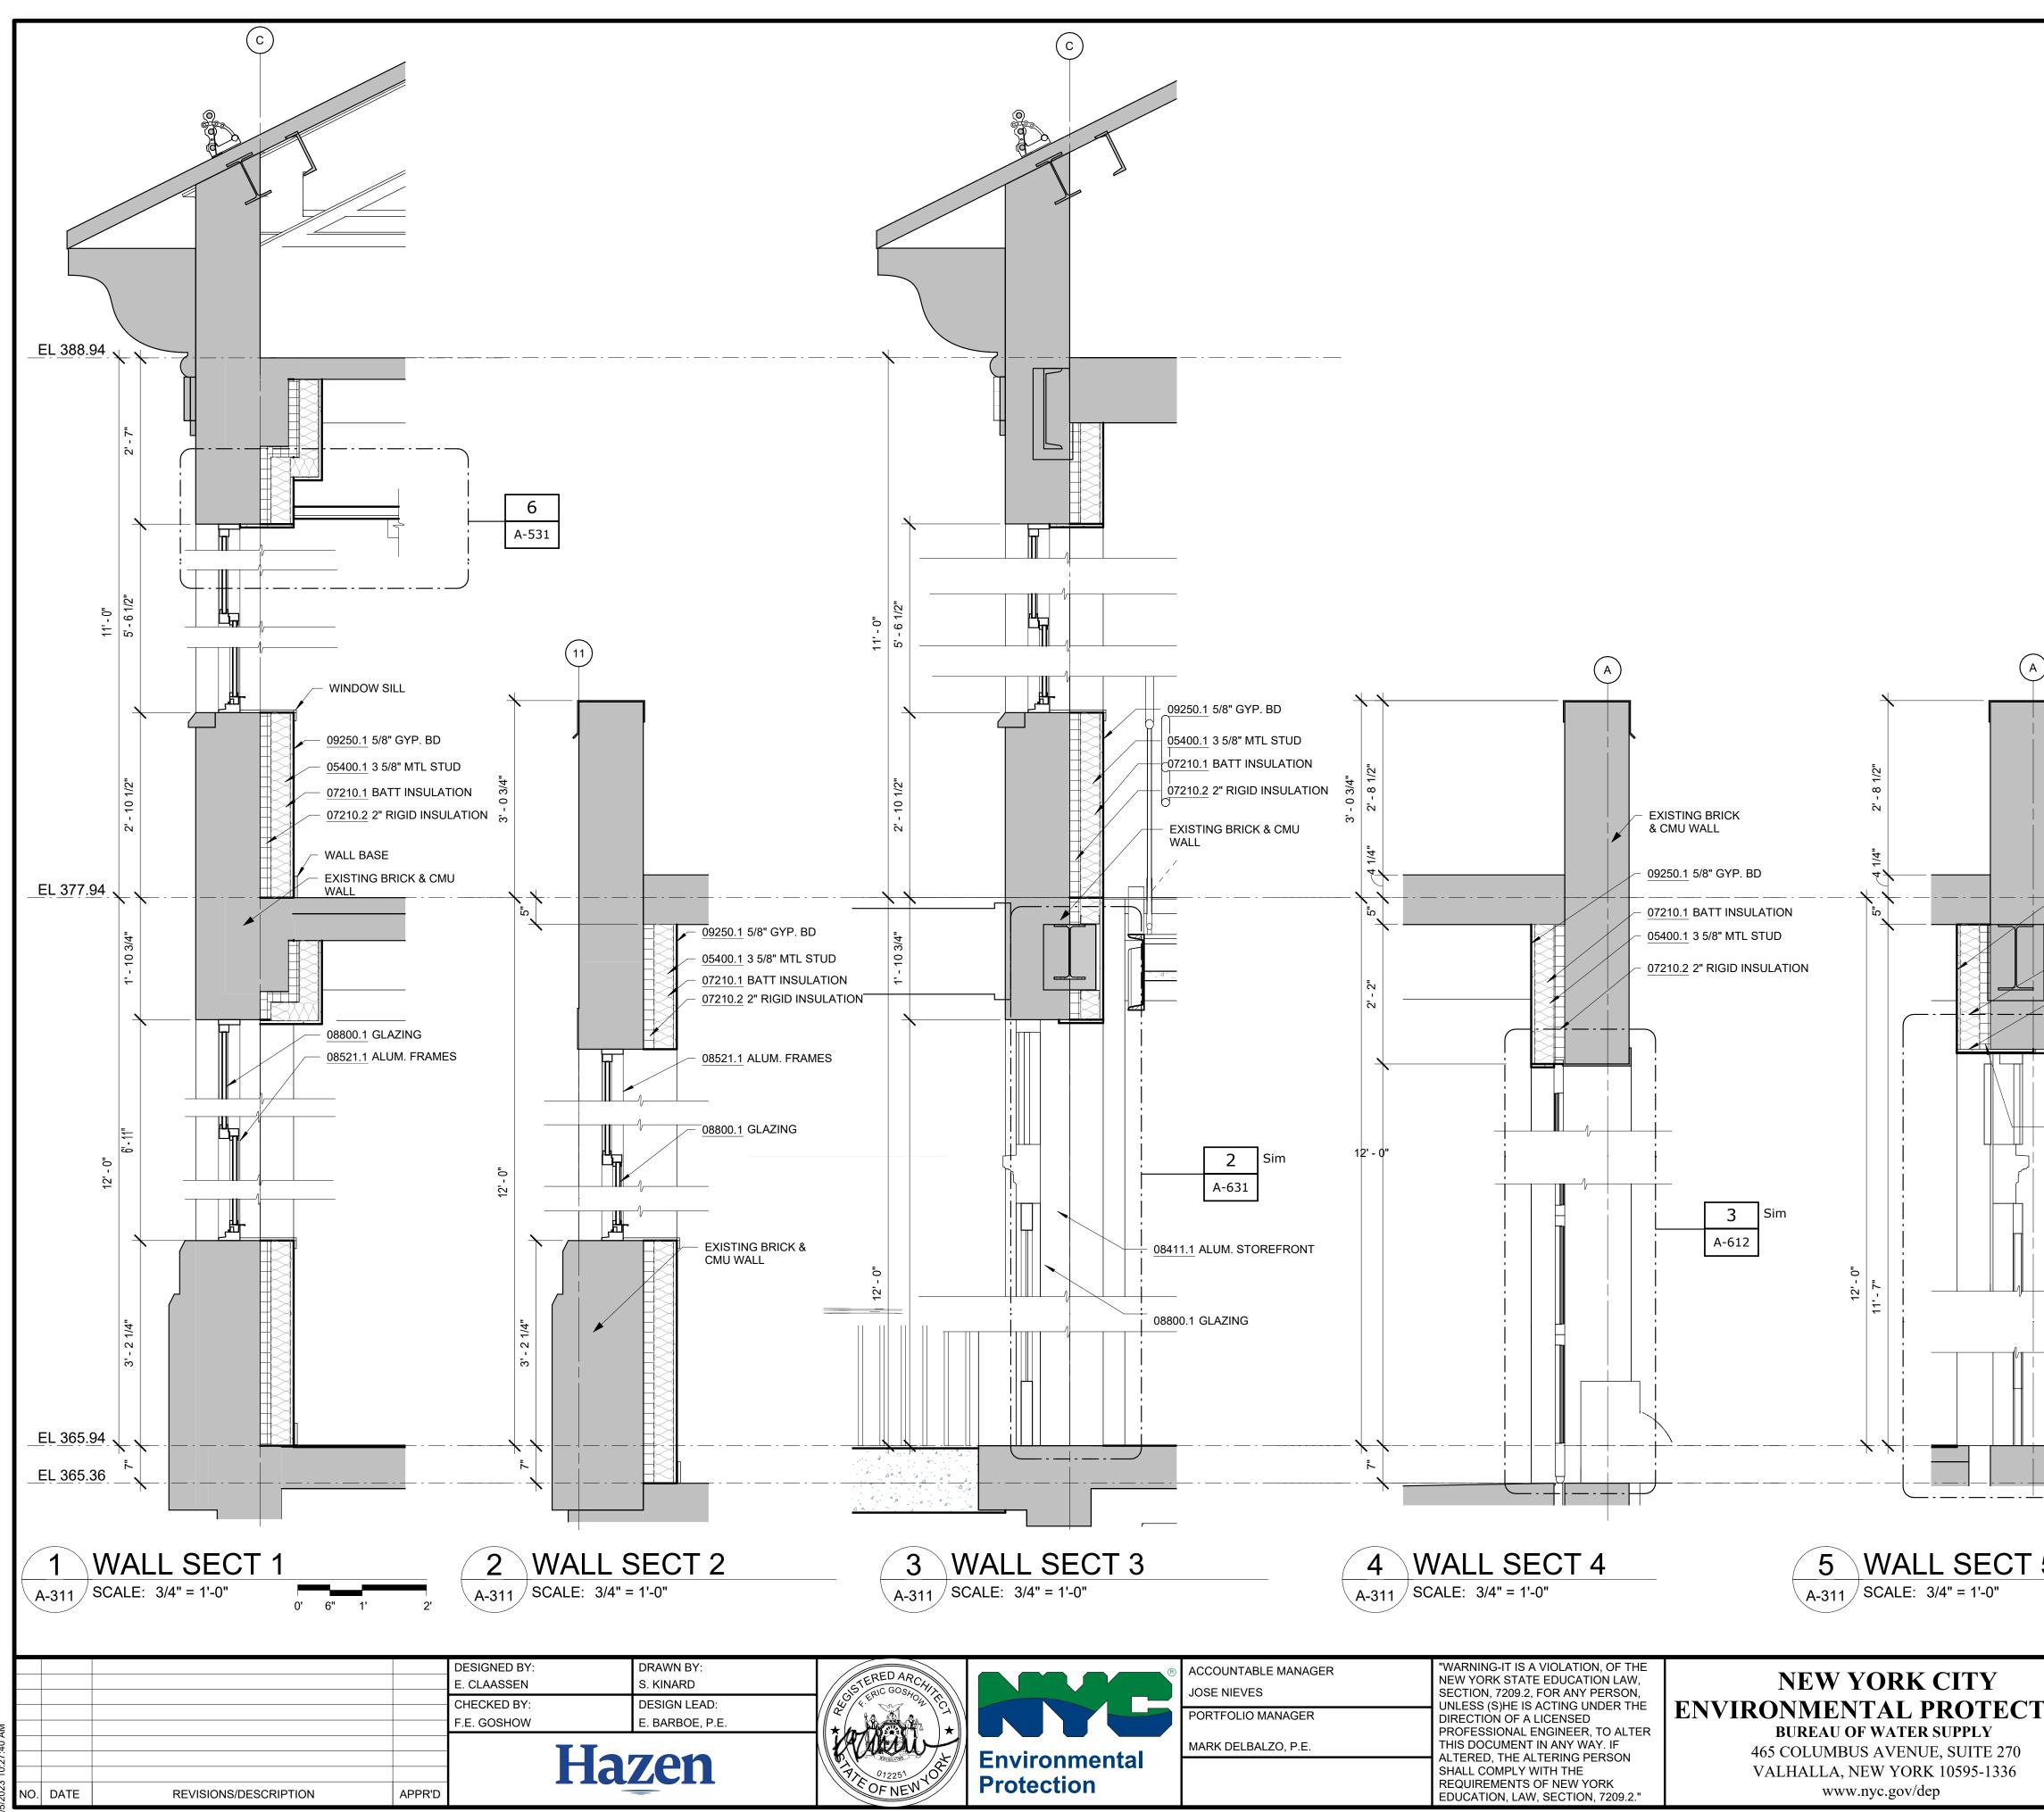

			NOTES - DE	ETAILS	
		DIVISION 4 04120.1	BRICK MASONRY INFILL BEYOND		VALL WITH BRICK TO EXISTING
		DIVISION 5 05400.1	3 5/8" MTL STUD		ETAL STUD @ 16" O.C.
		05400.2	2 1/2" METAL STUD	TYP.	ETAL STUD @ 16" O.C.
		05501.2	ALUMINUM	TYP.	
		05501.3	ATTIC ACCESS HATCH	COMME FOLDIN	NODIZED ALUMINUM RCIAL-GRADE ALUMINUM G STAIRWAY WITH EILING FRAME
		DIVISION 7 07210.1	BATT INSULATION	FIBER E	CED RECYCLED GLASS ATTS FOR INSULATION POR RETARDER
		07210.2	<varies></varies>		XPS INSULATION, R-5
		07540.1	ROOFING		-PLY THERMOPLASTIC EMBRANE ROOFING
		07620.2	FLASHING	STAINLI FLASHII	ESS STEEL SHEET NG
		07621.1	STRAINER ROOF DRAIN		IAMETER CAST IRON Y DRAIN WITH STRAINER
		07621.2	DOWNSPOUT	ALUMIN DESIGN LEAD-C	M ZINC-ANNODIIZED UM DOWNSPOUT, TO MATCH ORIGINAL OATED COPPER
		07900.1	CAULKING		UOUS CAULKING WITH
		07900.2	SEALANT	BACKEF	R ROD W/ SEALANT, TYP.
		07900.3	SEALANT		
		DIVISION 8 08361.1	OVERHEAD DOOR	SECTIO	TED ALUMINUM NAL OVERHEAD DOOR SION LITES
		08411.1 08521.1	ALUM. STOREFRONT ALUM. FRAMES		
		08800.1	GLAZING		LATED GLASS UNIT WITH ROTECTION UV STRIPE
	50.1 5/8" GYP. BD STING BRICK & CMU WALL 10.1 BATT INSULATION	DIVISION 9 09206.1 09206.2 09206.3 09206.4 09206.5	METAL FURRING METAL FURRING CHANNEL CLIP 1 1/2" STEEL RUNNING CHANNEL GAT CLIP MAIN TEE	4B1.5L ( OTHER 24" OC I AS APP FIXTUR	CAT. #16.59.SM (OR APPROVED MEANS) MAX., SHAPE AND DESIGN ROVED (THE RECESSED E MAY BE SUPPORTED BY IN TEES SPACED 2'-0" OR
+		09206.6	<varies></varies>	4'-0" OC <varies></varies>	)
<u>054</u>	00.1 3 5/8" MTL STUD	09250.1 09250.2	5/8" GYP. BD J BEAD		J CASING BEAD, TAPE
		09250.3	TRIM	AND SP	ACKLE
		09250.4	TRIM	1" X 1" ( SEALAN	CORNER TRIM W/ IT BED
	20.1 BRICK MASONRY INFILL BEYOND	09250.5	STEEL ROD	TO EXC	. GALV. STEEL ROD, NOT EED 4'-0" OC
	10.2 2" RIGID INSULATION	09250.6	CEMENT PANELS		ERIOR CEMENT BOARD PANELS
		09511.1 09511.2	ACT CEILING CROSS TEE	1 1/2" H	IGH, 2'-0" OC
	2 Sim A-631				
5	BID SET			RAPHIC S CK BEFC	
			IT IS A		THAN 22"x34" ED PRINT. RDINGLY
			ICO LABORATORY A	S	DATE: MAY 2023 SCALE:
ΓΙΟΝ	MOUNT P	LEASANT,	HEADQUARTERS NEW YORK		SCALE: SHEET NO:
1	CON	TRACT CF	RO-624		86 OF No. 121
		CHITECTU ALL SECTI			drawing no. A-311

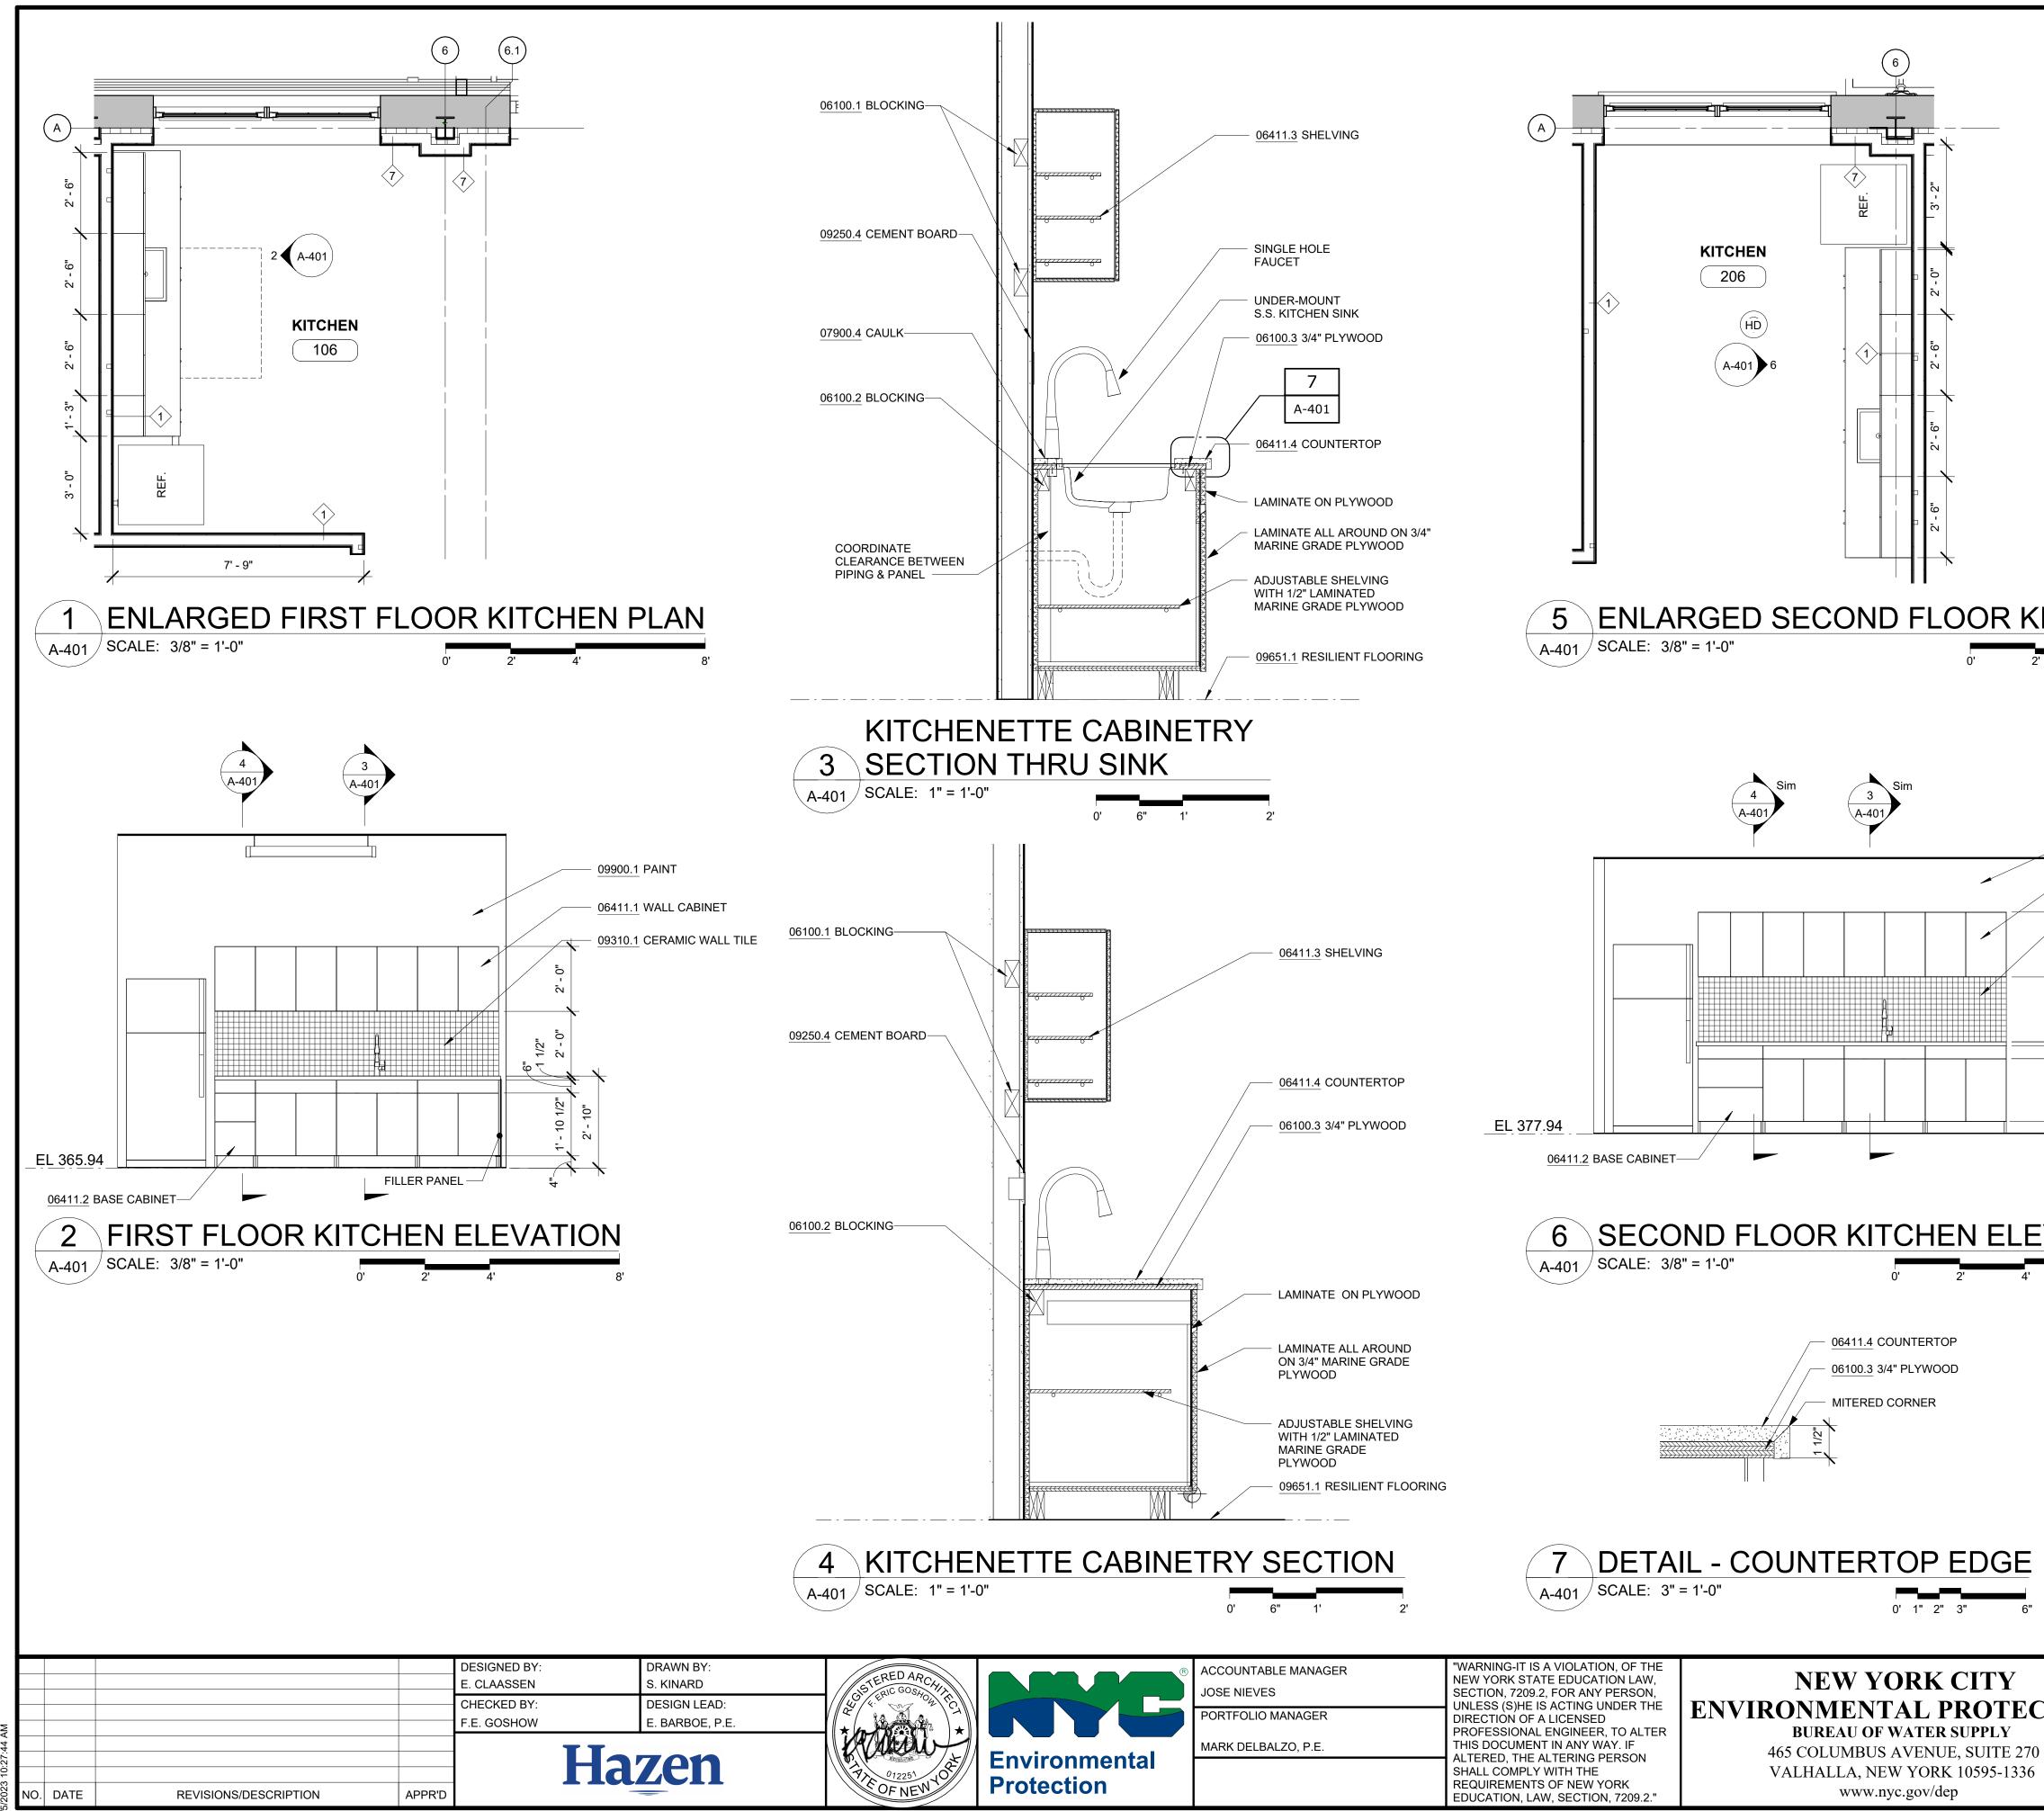

	8'			GRADHIC	SCALES
1	BID SET			GRAPHIC S CHECK BEF	
,			IT	IEET IS LESS I IS A REDUC SCALE ACCC	
	REPURPOSING OF T THE KENSICO R		CO LABORATOR	Y AS	DATE: MAY 2023
CTION	MOUNT PI	LEASANT, N ITRACT CR(	IEW YORK	,	SHEET NO:
'n					
v		- · • ·	<b>\/</b> ¬\∟		87 OF No. 121 DRAWING NO.
<b>CTION</b>	REPURPOSING OF T THE KENSICO R MOUNT PI CON	REGIONAL H LEASANT, N ITRACT CRO	IF SH IT SO LABORATOR IEADQUARTERS IEW YORK D-624	CHECK BEF	ORE USE S THAN 22"x34" CED PRINT. ORDINGLY DATE: MAY 2023 SCALE: SHEET NO:

# NOTES - KITCHEN

PROVIDE CONTINUOUS WOOD

3/4" MARINE GRADE PLYWOOD,

CONTINUOUS WALL CLEAT

ANCHORED TO WALL

BLOCKING

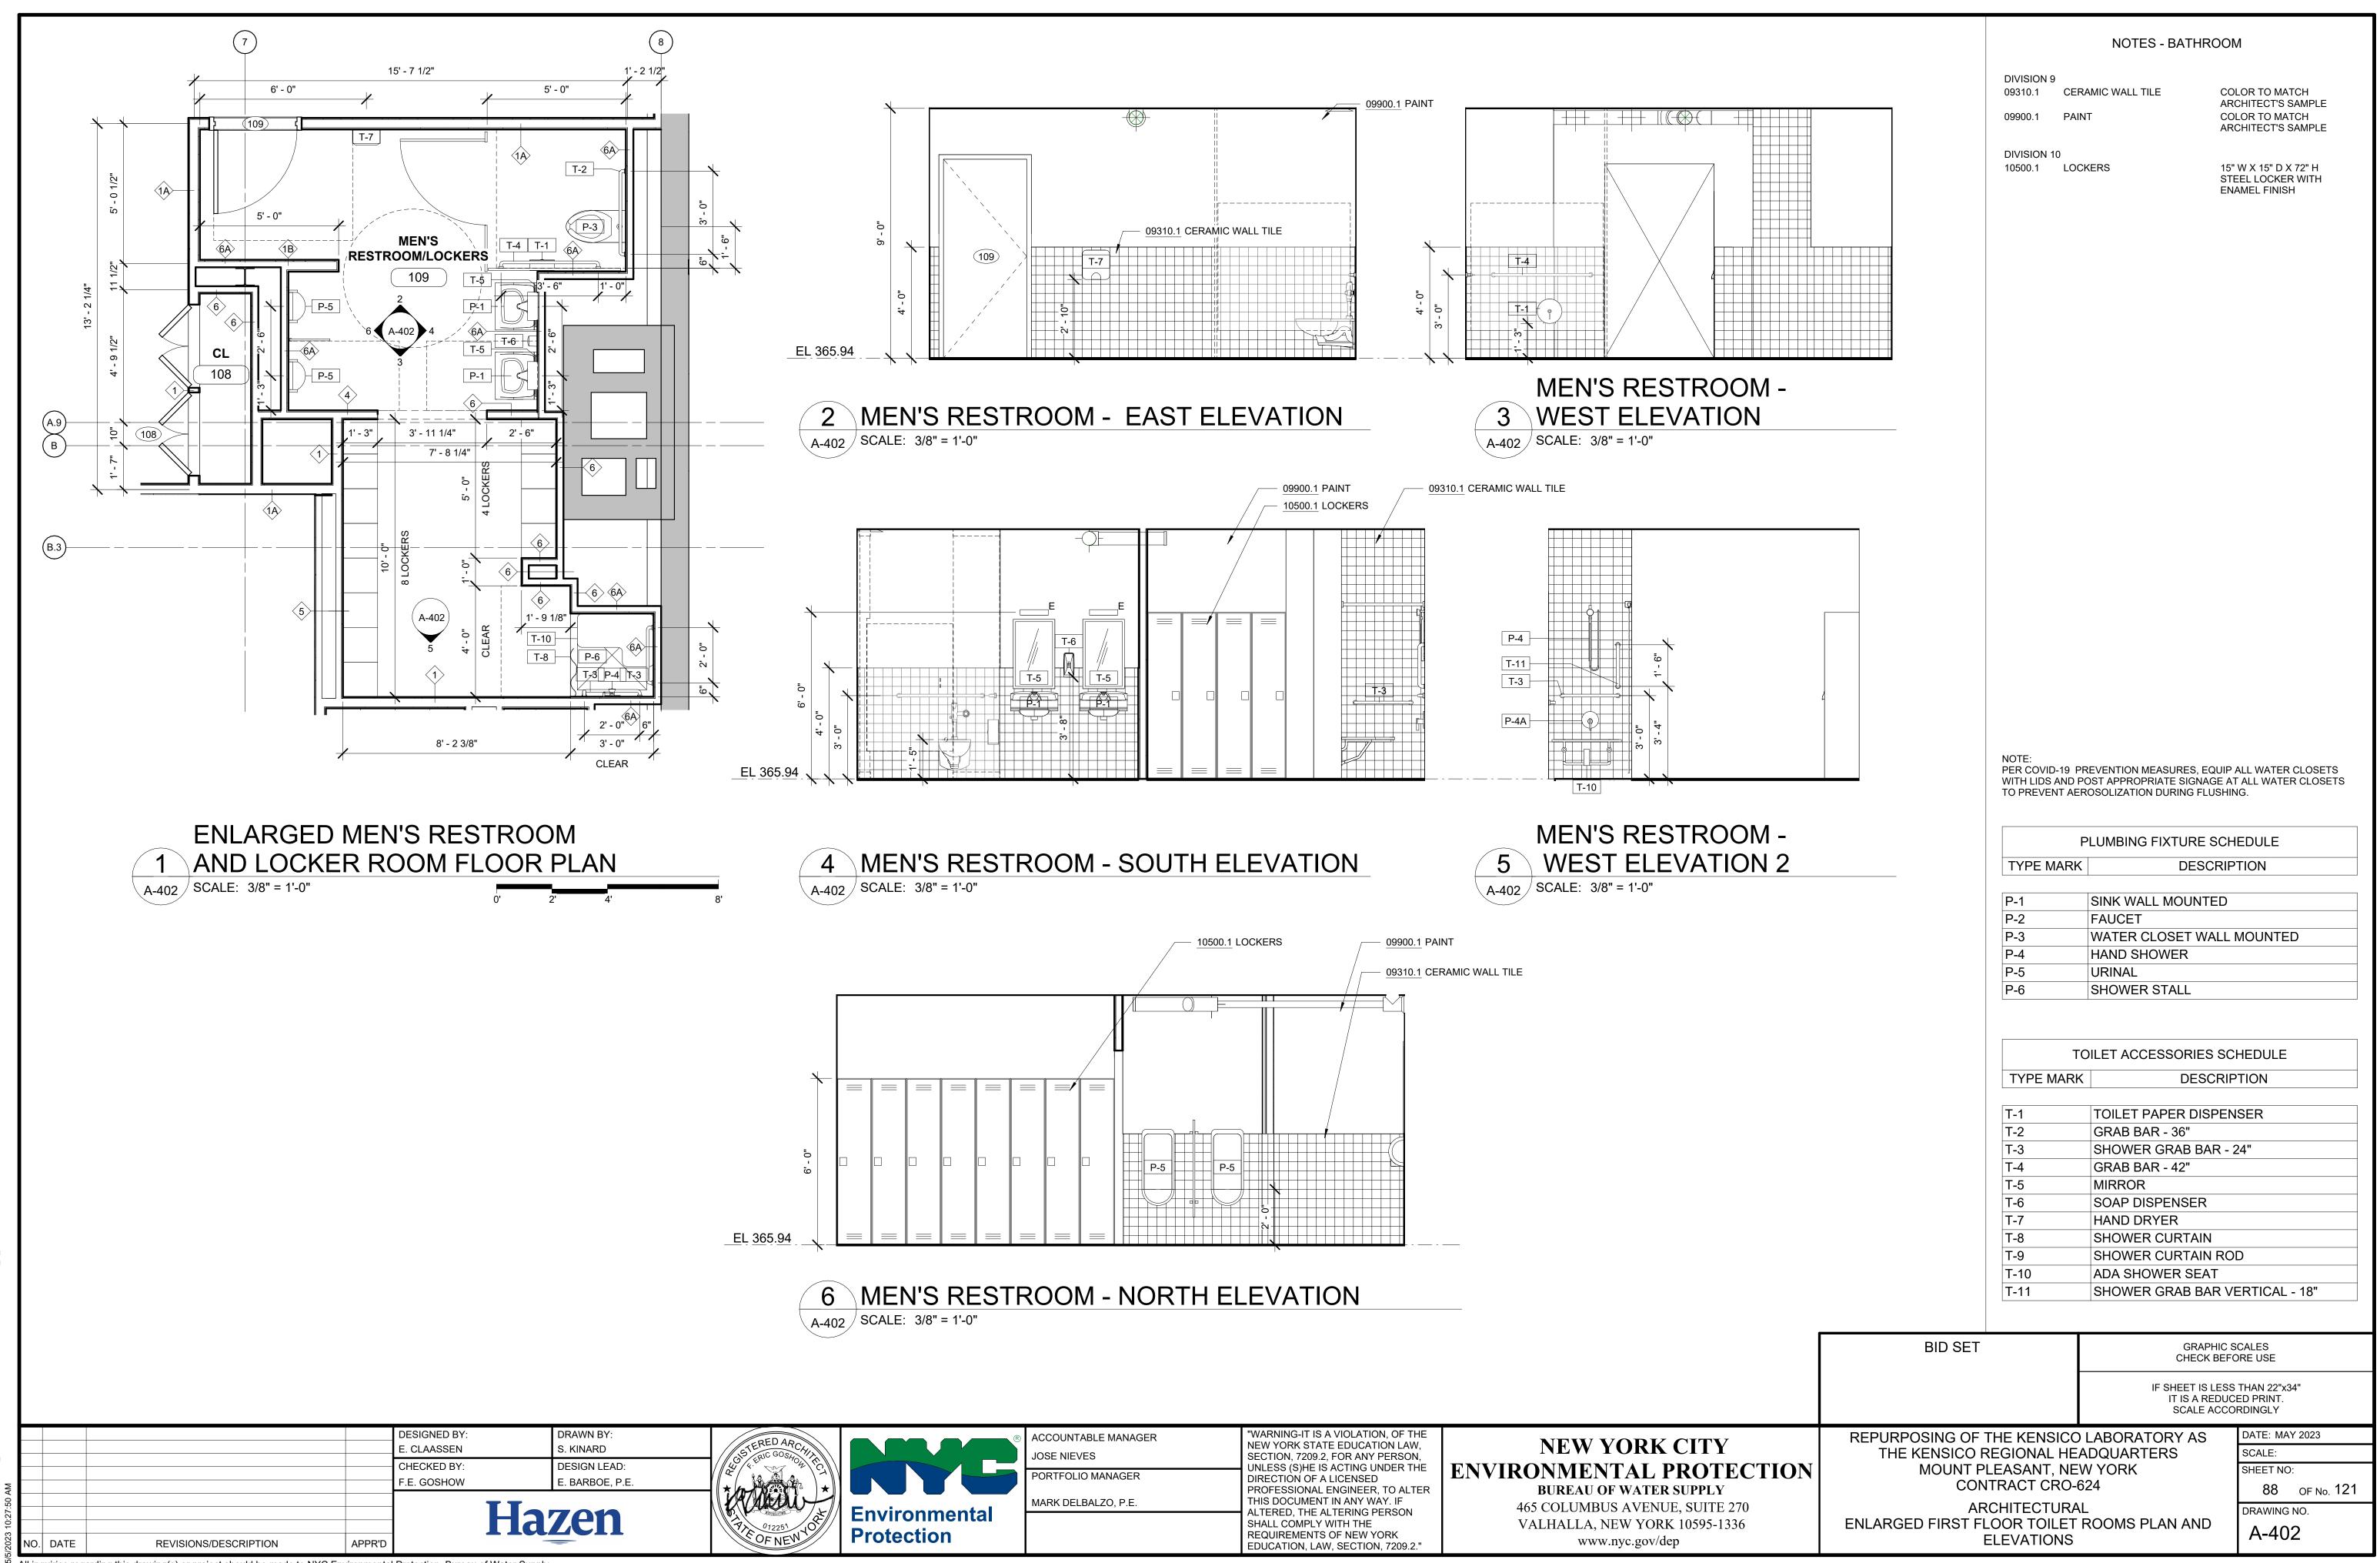
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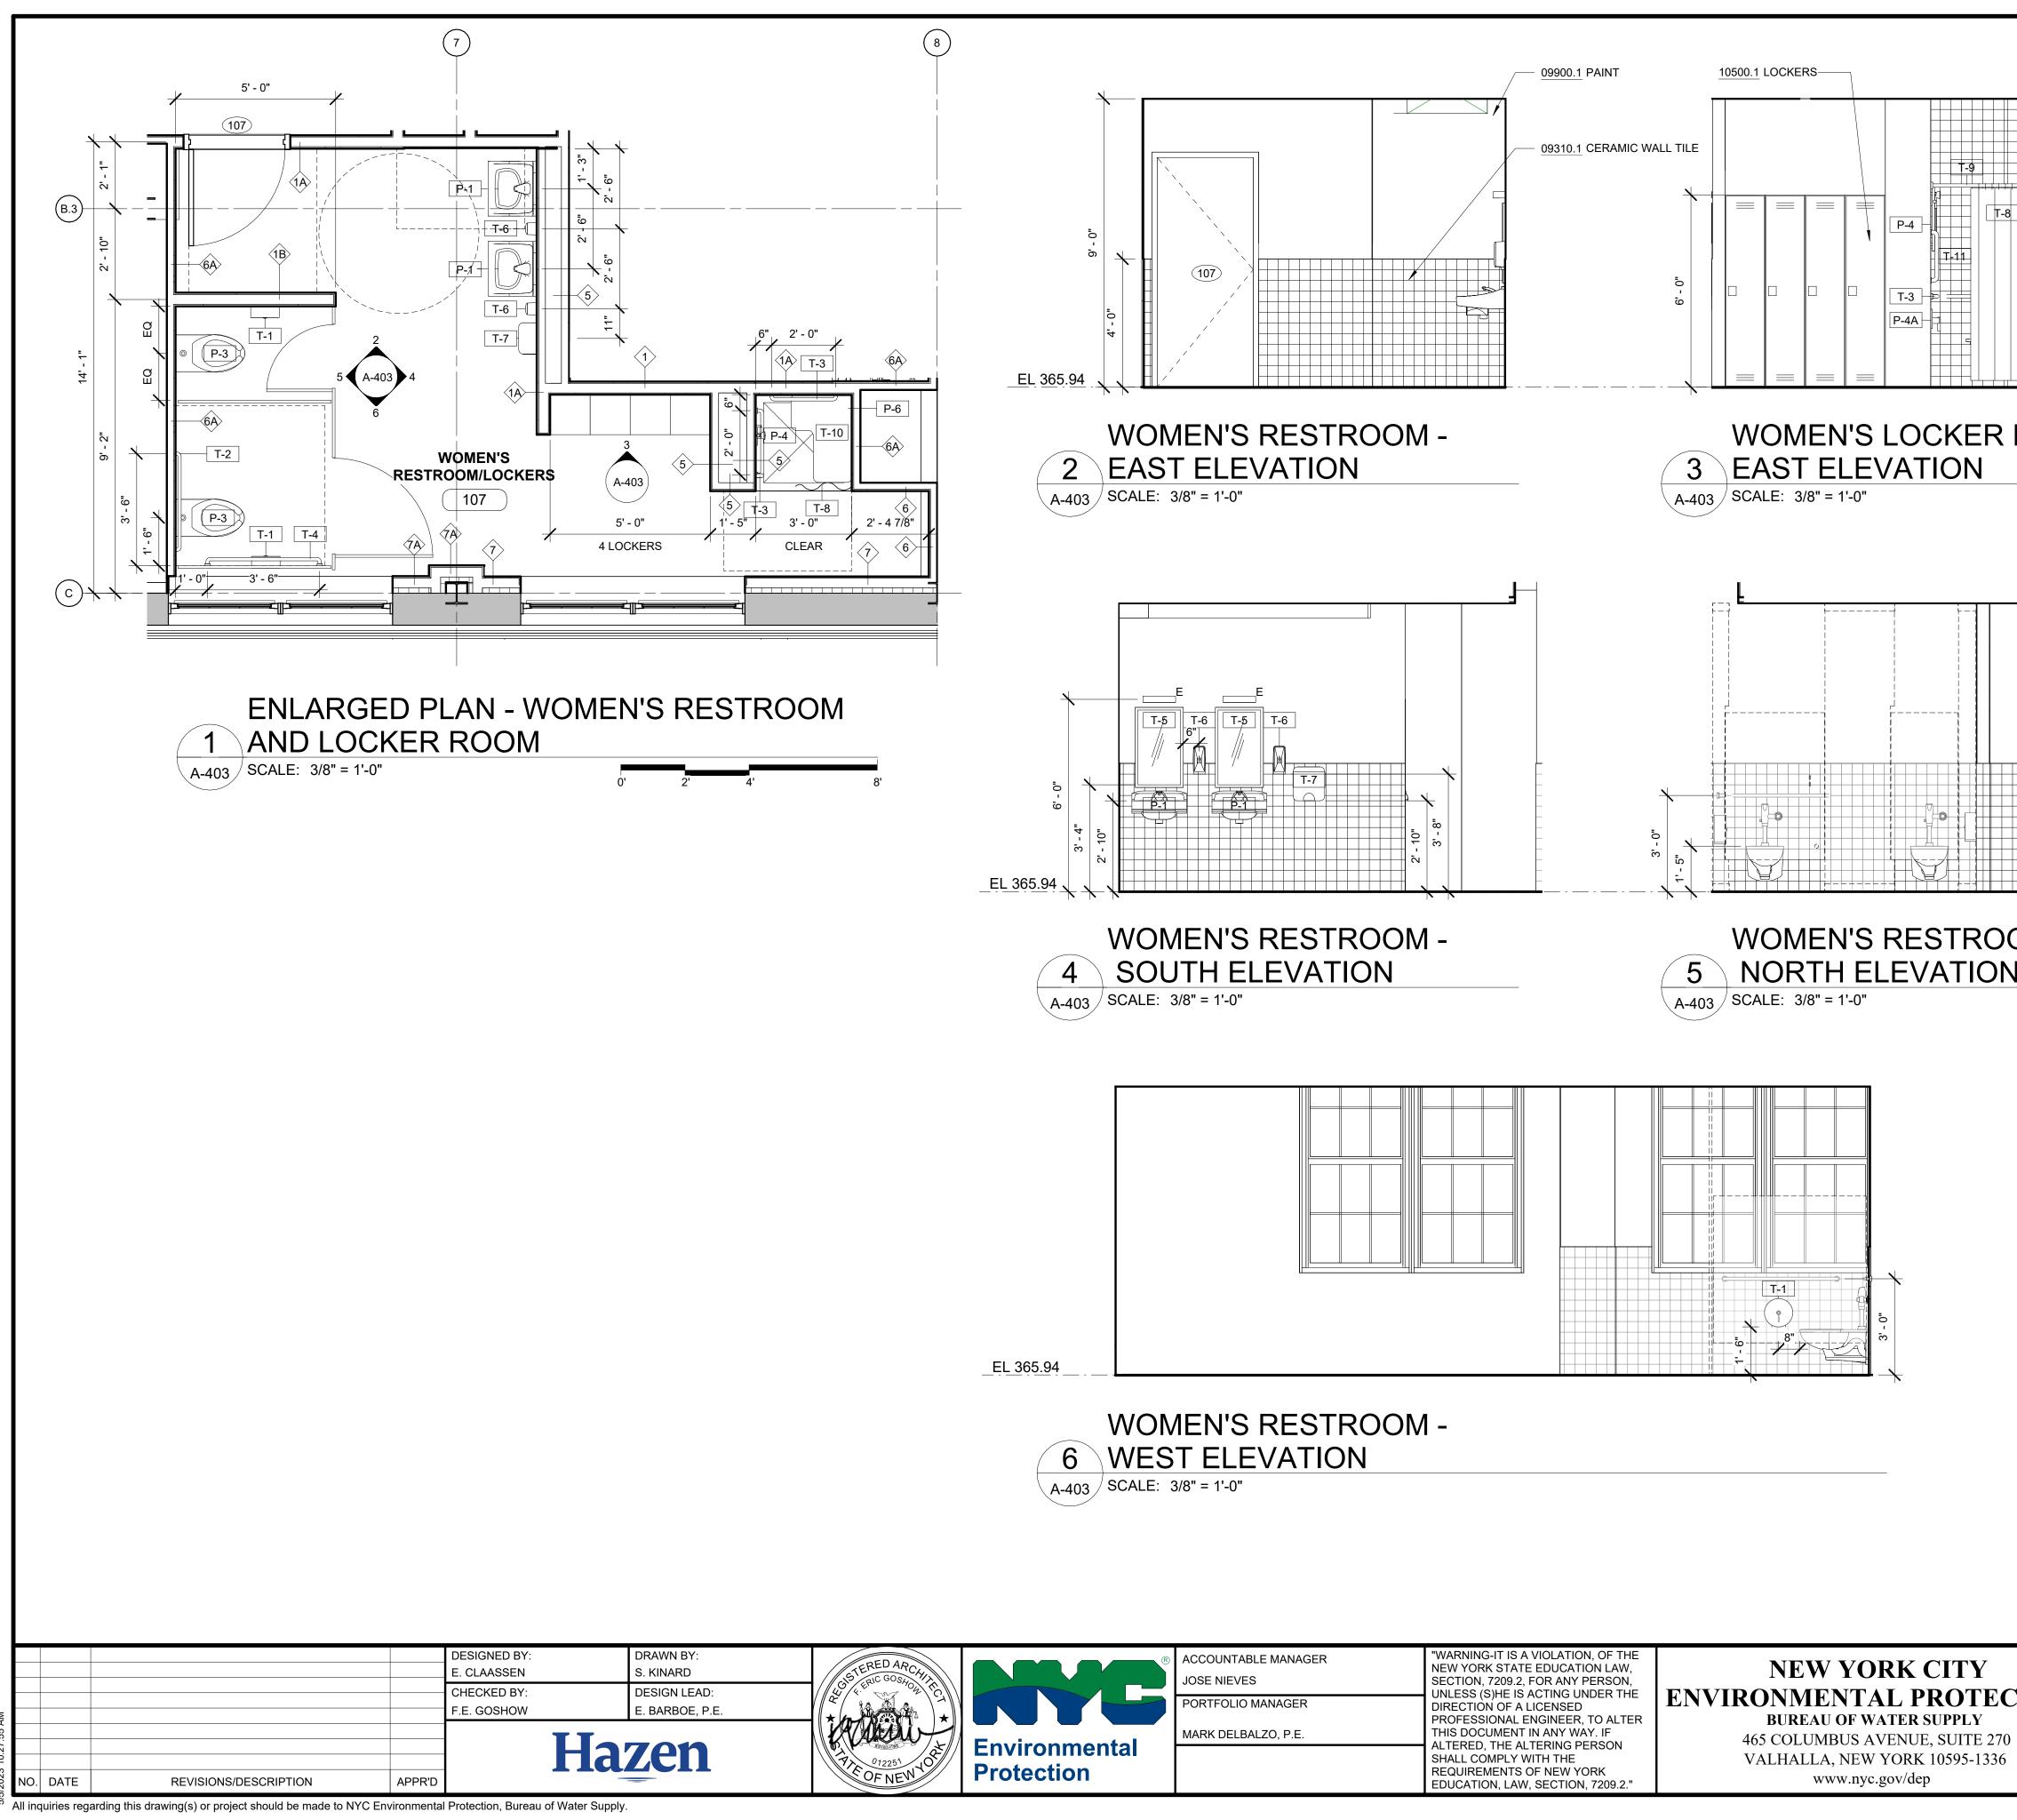
**DIVISION 6** 

06100.1 BLOCKING


06100.2 BLOCKING

06100.3 3/4" PLYWOOD







			NOTES - BATHRO	ОМ
	]	DIVISION 9 09310.1 CER 09900.1 PAIN	١T	COLOR TO MATCH ARCHITECT'S SAMPLE COLOR TO MATCH ARCHITECT'S SAMPLE
		DIVISION 10 10500.1 LOC	:	15" W X 15" D X 72" H STEEL LOCKER WITH ENAMEL FINISH
OM -		WITH LIDS AND P TO PREVENT AEF	REVENTION MEASURES, EQU OST APPROPRIATE SIGNAGE ROSOLIZATION DURING FLUS PLUMBING FIXTURE SO DESCR SINK WALL MOUNTED FAUCET WATER CLOSET WAL HAND SHOWER	AT ALL WATER CLOSETS HING. CHEDULE IPTION
		P-5 P-6	URINAL SHOWER STALL	
		TYPE MARK         T-1         T-2         T-3         T-4         T-5         T-6         T-7         T-8         T-9         T-10         T-11	TOILET PAPER DISPI GRAB BAR - 36" SHOWER GRAB BAR GRAB BAR - 42" MIRROR SOAP DISPENSER HAND DRYER SHOWER CURTAIN SHOWER CURTAIN F ADA SHOWER SEAT SHOWER GRAB BAR	- 24"
	BID SET			C SCALES FORE USE
			IF SHEET IS LE IT IS A RED	SS THAN 22"x34" UCED PRINT. CORDINGLY
CTION	CONT	EGIONAL HEA EASANT, NEV RACT CRO-6 HITECTURAL	ADQUARTERS V YORK 24 -	DATE: MAY 2023 SCALE: SHEET NO: 89 OF No. 121 DRAWING NO.
<b>,</b>		LEVATIONS		A-403

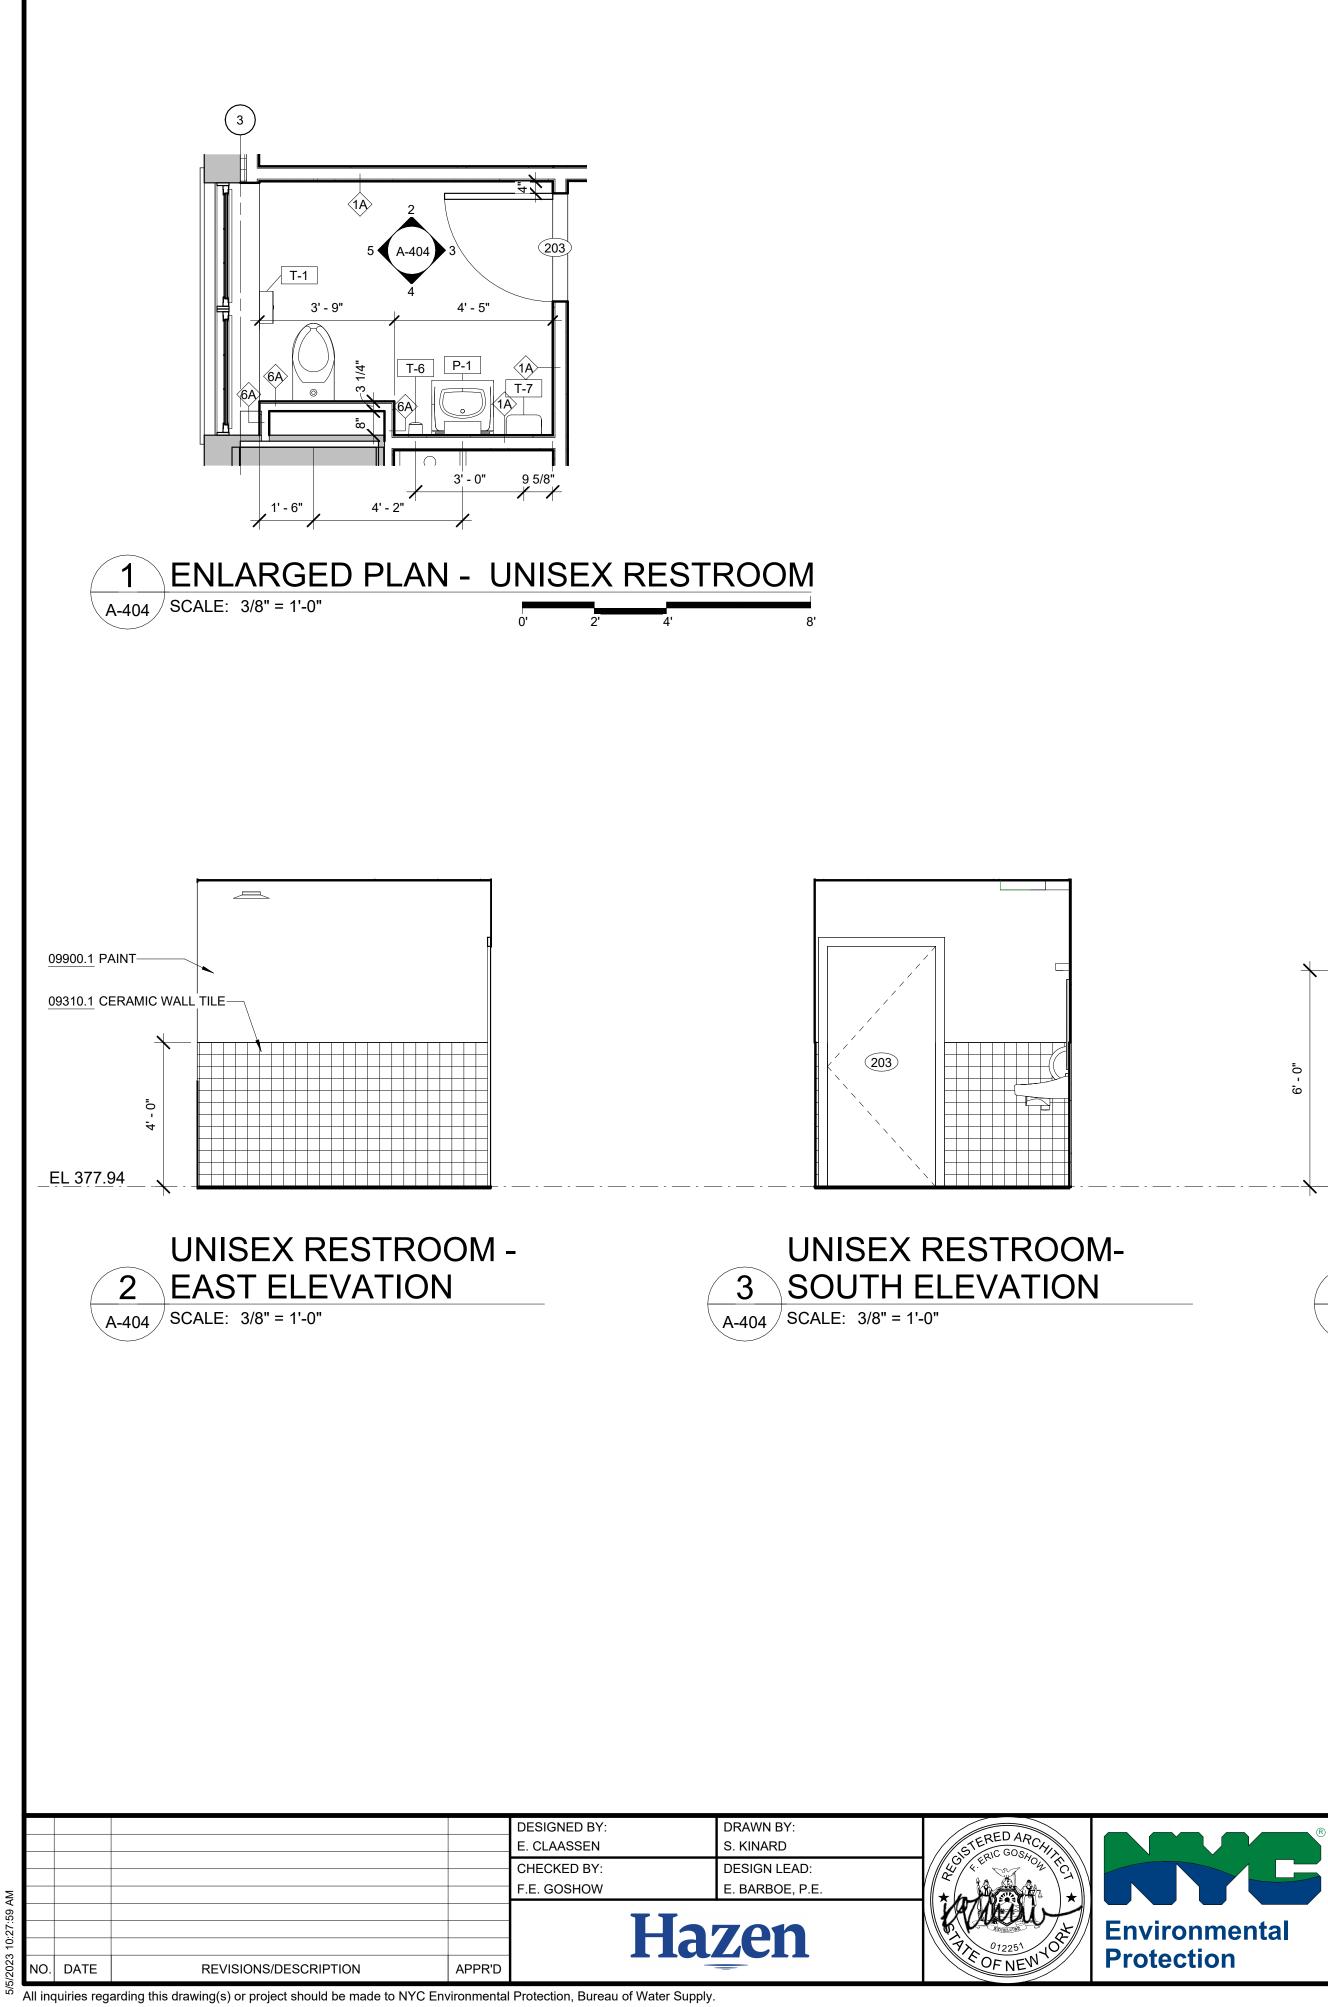





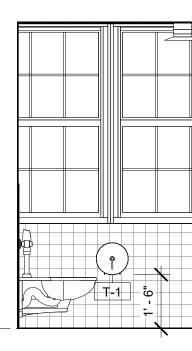

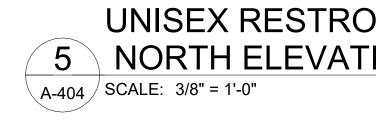


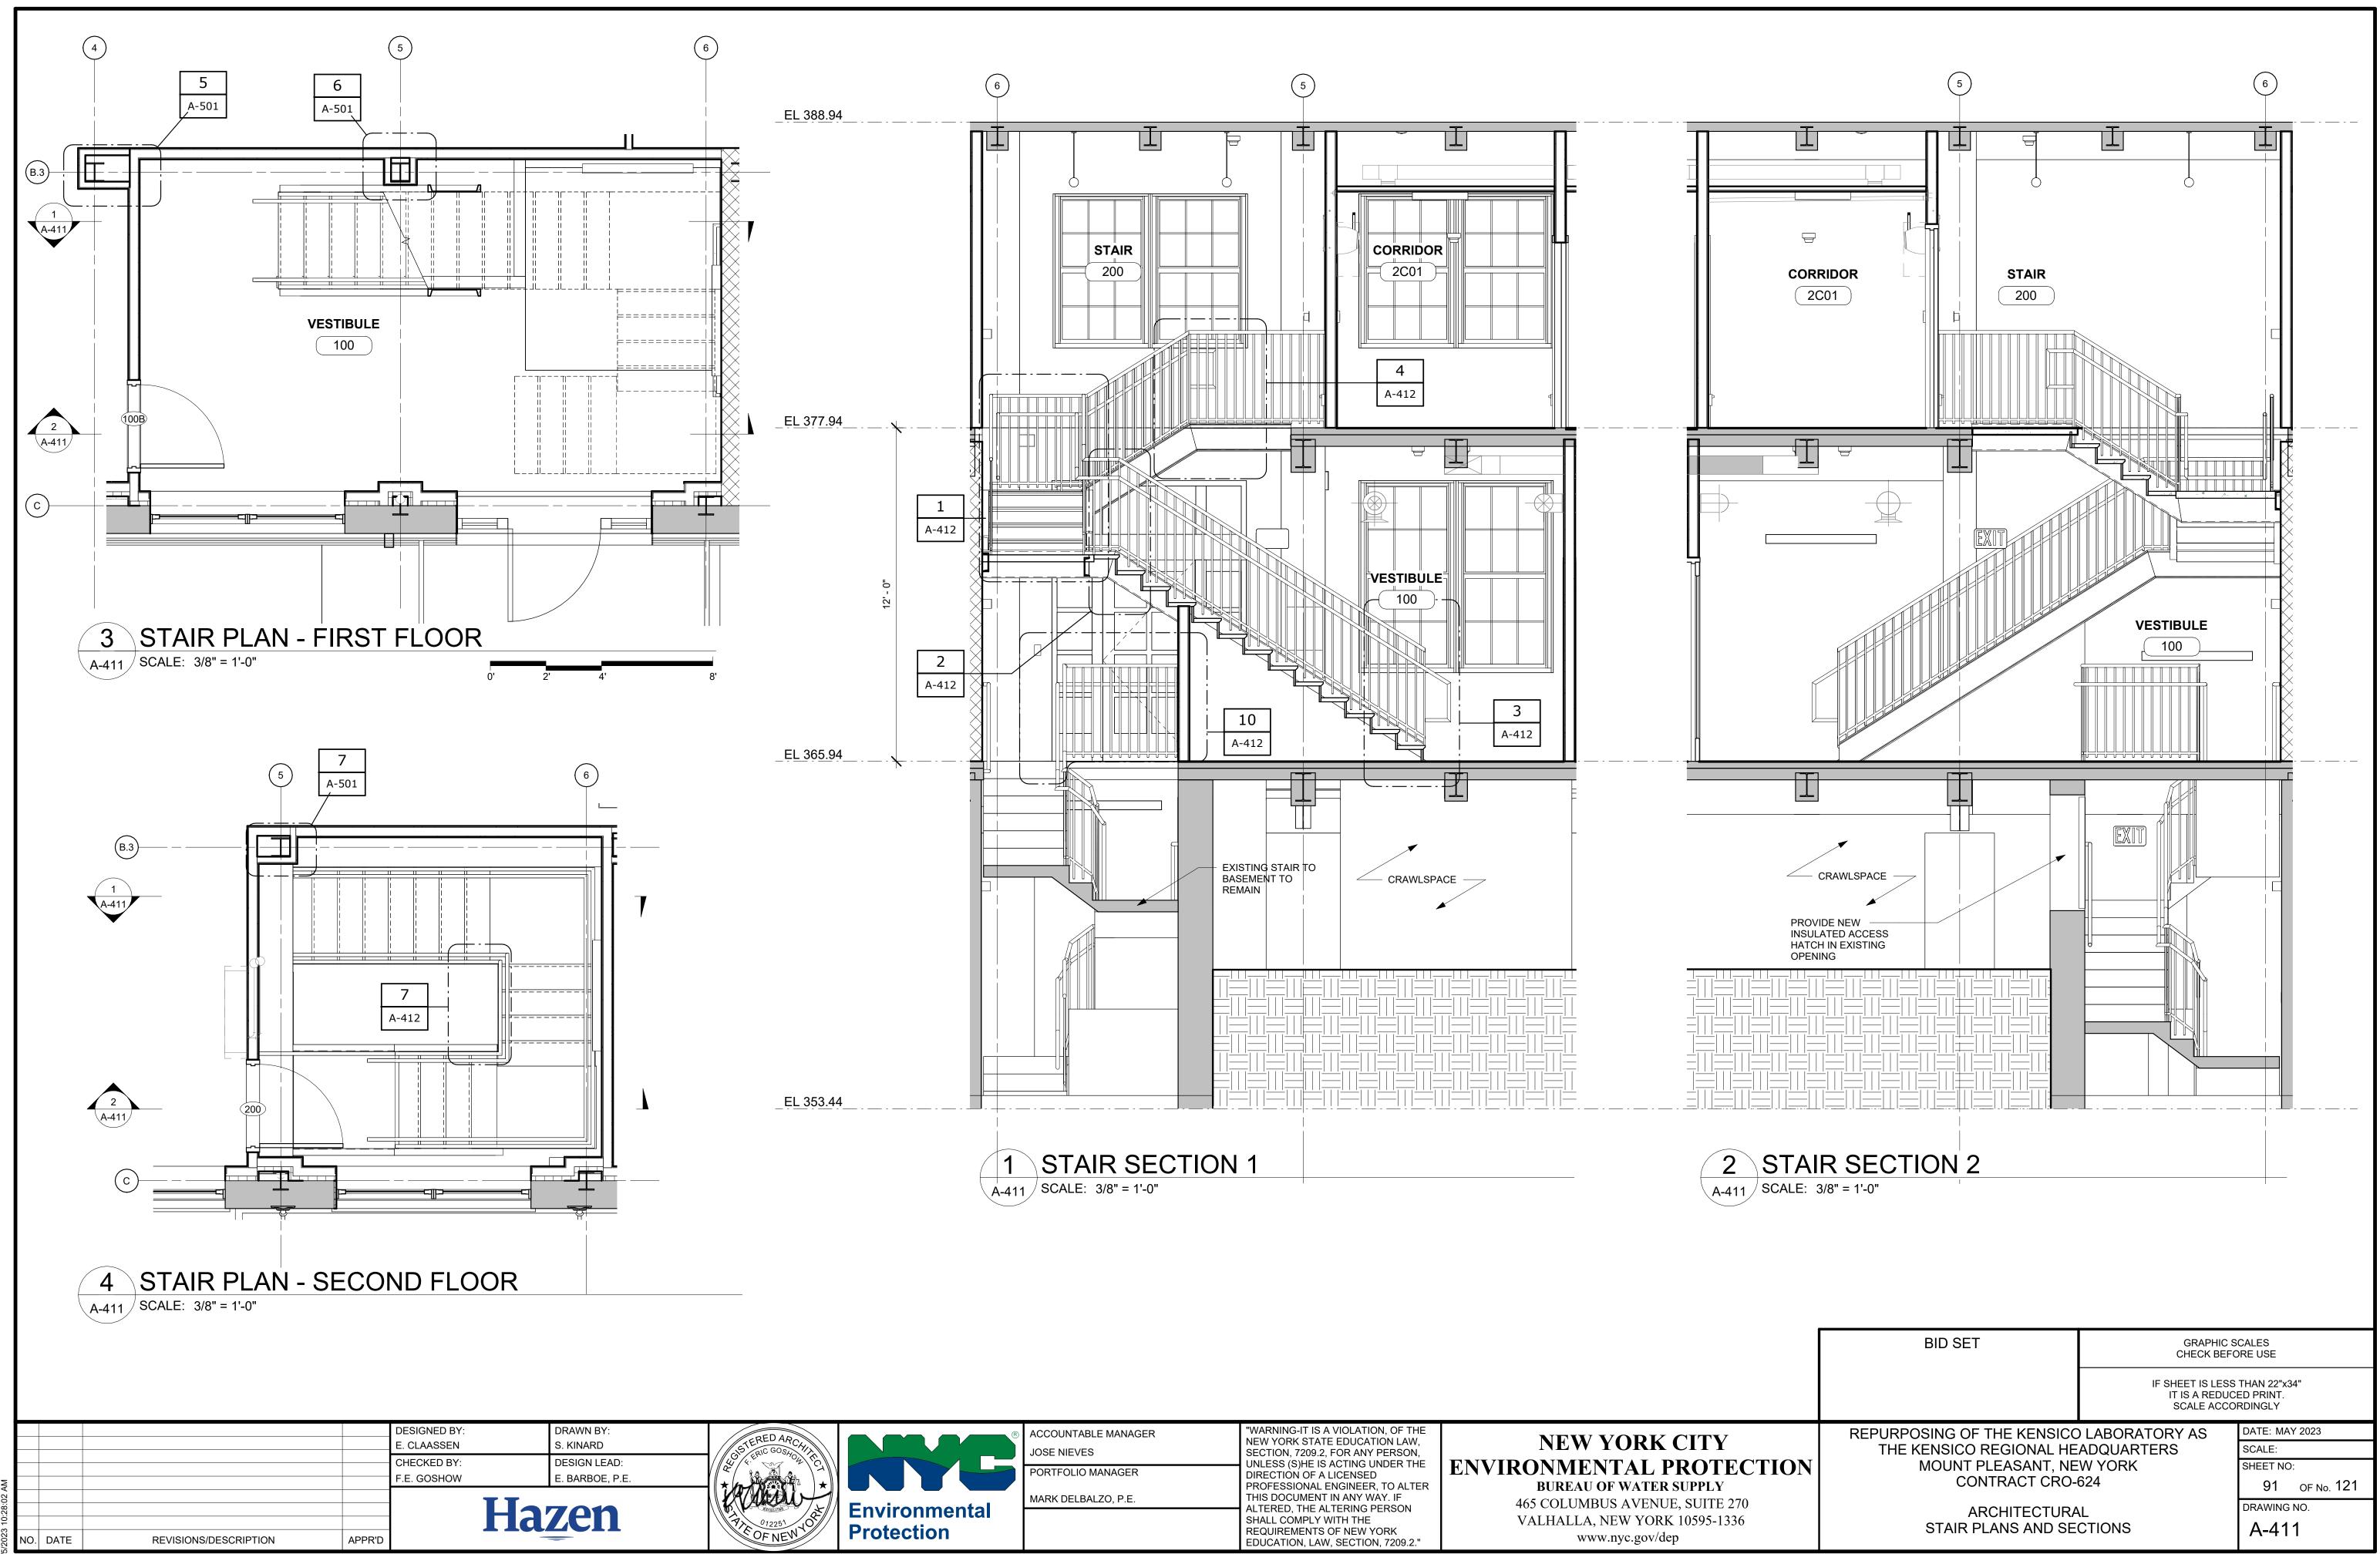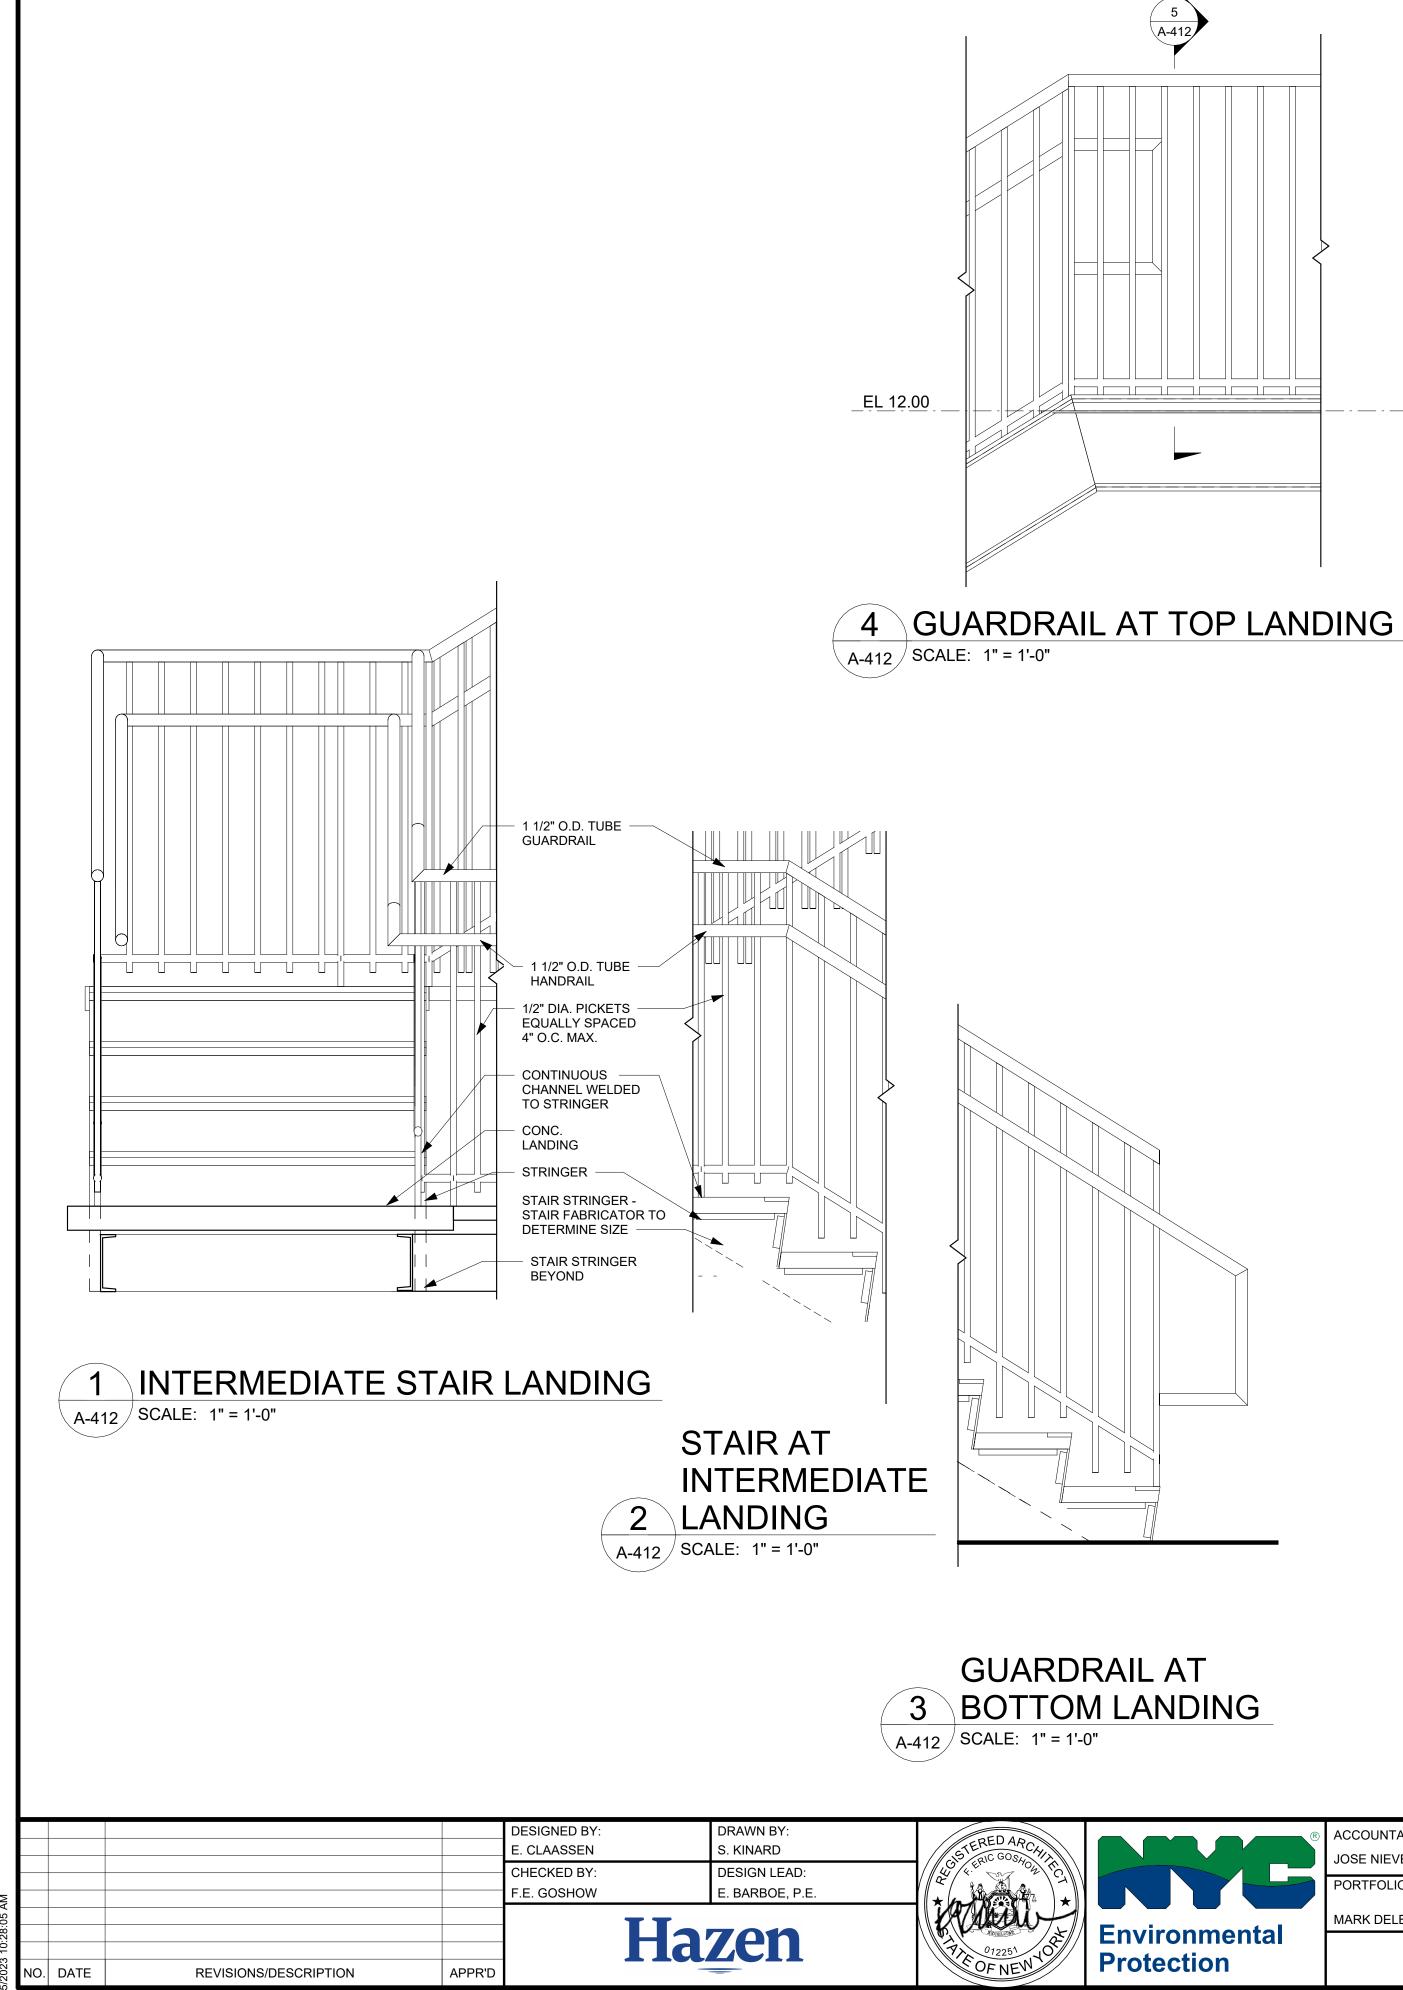
ACCOUNTABLE MANAGER JOSE NIEVES PORTFOLIO MANAGER MARK DELBALZO, P.E.

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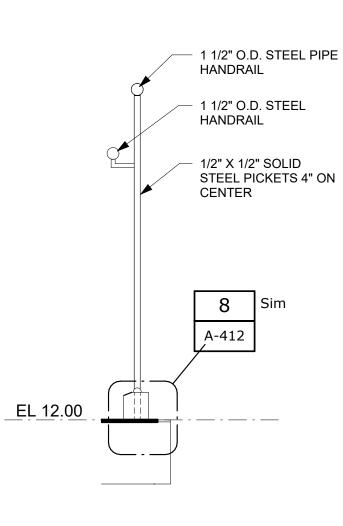
**NEW YORK CITY ENVIRONMENTAL PROTECT BUREAU OF WATER SUPPLY** 465 COLUMBUS AVENUE, SUITE 270 VALHALLA, NEW YORK 10595-1336 www.nyc.gov/dep

			NOTES - BATHR	OOM
		DIVISION 9 09310.1 CER 09900.1 PAIN	AMIC WALL TILE	COLOR TO MATCH ARCHITECT'S SAMPLE COLOR TO MATCH ARCHITECT'S SAMPLE
		DIVISION 10 10500.1 LOC	KERS	15" W X 15" D X 72" H STEEL LOCKER WITH ENAMEL FINISH
		WITH LIDS AND PC	EVENTION MEASURES, EQ DST APPROPRIATE SIGNAG DSOLIZATION DURING FLU:	E AT ALL WATER CLOSETS
		F	PLUMBING FIXTURE	SCHEDULE
		TYPE MARK	DESC	RIPTION
		P-1	SINK WALL MOUNT	ED
		P-2 P-3	FAUCET WATER CLOSET WA	ALL MOUNTED
		P-4	HAND SHOWER	
DOM-		P-5 P-6	URINAL SHOWER STALL	
ION			DILET ACCESSORIES	
		TYPE MARK	DESC	CRIPTION
		T-1 T-2	TOILET PAPER DISI GRAB BAR - 36"	PENSER
		T-3	SHOWER GRAB BA	R - 24"
		T-4 T-5	GRAB BAR - 42" MIRROR	
		T-6	SOAP DISPENSER	
		T-7 T-8	HAND DRYER SHOWER CURTAIN	
		T-9 T-10	SHOWER CURTAIN ADA SHOWER SEA	
		T-11	SHOWER GRAB BA	
_		<u>.</u>		
	BID SET			IIC SCALES BEFORE USE
			IT IS A REI	ESS THAN 22"x34" DUCED PRINT. CCORDINGLY
	REPURPOSING OF T THE KENSICO R			DATE: MAY 2023 SCALE:
TION	MOUNT PL	EGIONAL HEA EASANT, NEW FRACT CRO-62	/ YORK	SHEET NO:
		CHITECTURAL		90 OF No. 121 DRAWING NO.
	ENLARGED SECONE		ET ROOMS PLAN	A-404





		8	TYP. GUARDRAIL MOUNTED TO CO CALE: 3" = 1'-0"		
		STEEL ANGLE BRACKETS, TYP		METAL PAN TREADS AND RISERS WITH 2" CONCRETE- FILLED METAL PAN TREADS, TYP	
AIL AT LANDING			TYPICAL STAIR E CALE: 1" = 1'-0"	DETAIL	
Environmental Protection	ACCOUNTABLE MANAGER JOSE NIEVES PORTFOLIO MANAGER MARK DELBALZO, P.E.		"WARNING-IT IS A VIOLATION, OF THE NEW YORK STATE EDUCATION LAW, SECTION, 7209.2, FOR ANY PERSON, UNLESS (S)HE IS ACTING UNDER THE DIRECTION OF A LICENSED PROFESSIONAL ENGINEER, TO ALTER THIS DOCUMENT IN ANY WAY. IF ALTERED, THE ALTERING PERSON SHALL COMPLY WITH THE REQUIREMENTS OF NEW YORK EDUCATION, LAW, SECTION, 7209.2."	NEW YORK C ENVIRONMENTAL PR BUREAU OF WATER SUL 465 COLUMBUS AVENUE, S VALHALLA, NEW YORK 10 www.nyc.gov/dep	OTEC' PPLY UITE 270



A-412 SCALE: 1" = 1'-0"

EXTRUDED GALV STL

TOEBOARD

5 SECTION - TYP. GUARDRAIL

- EXTRUDED GALV STL ADAPTER

- 1 1/2" GALV STL PIPE POST

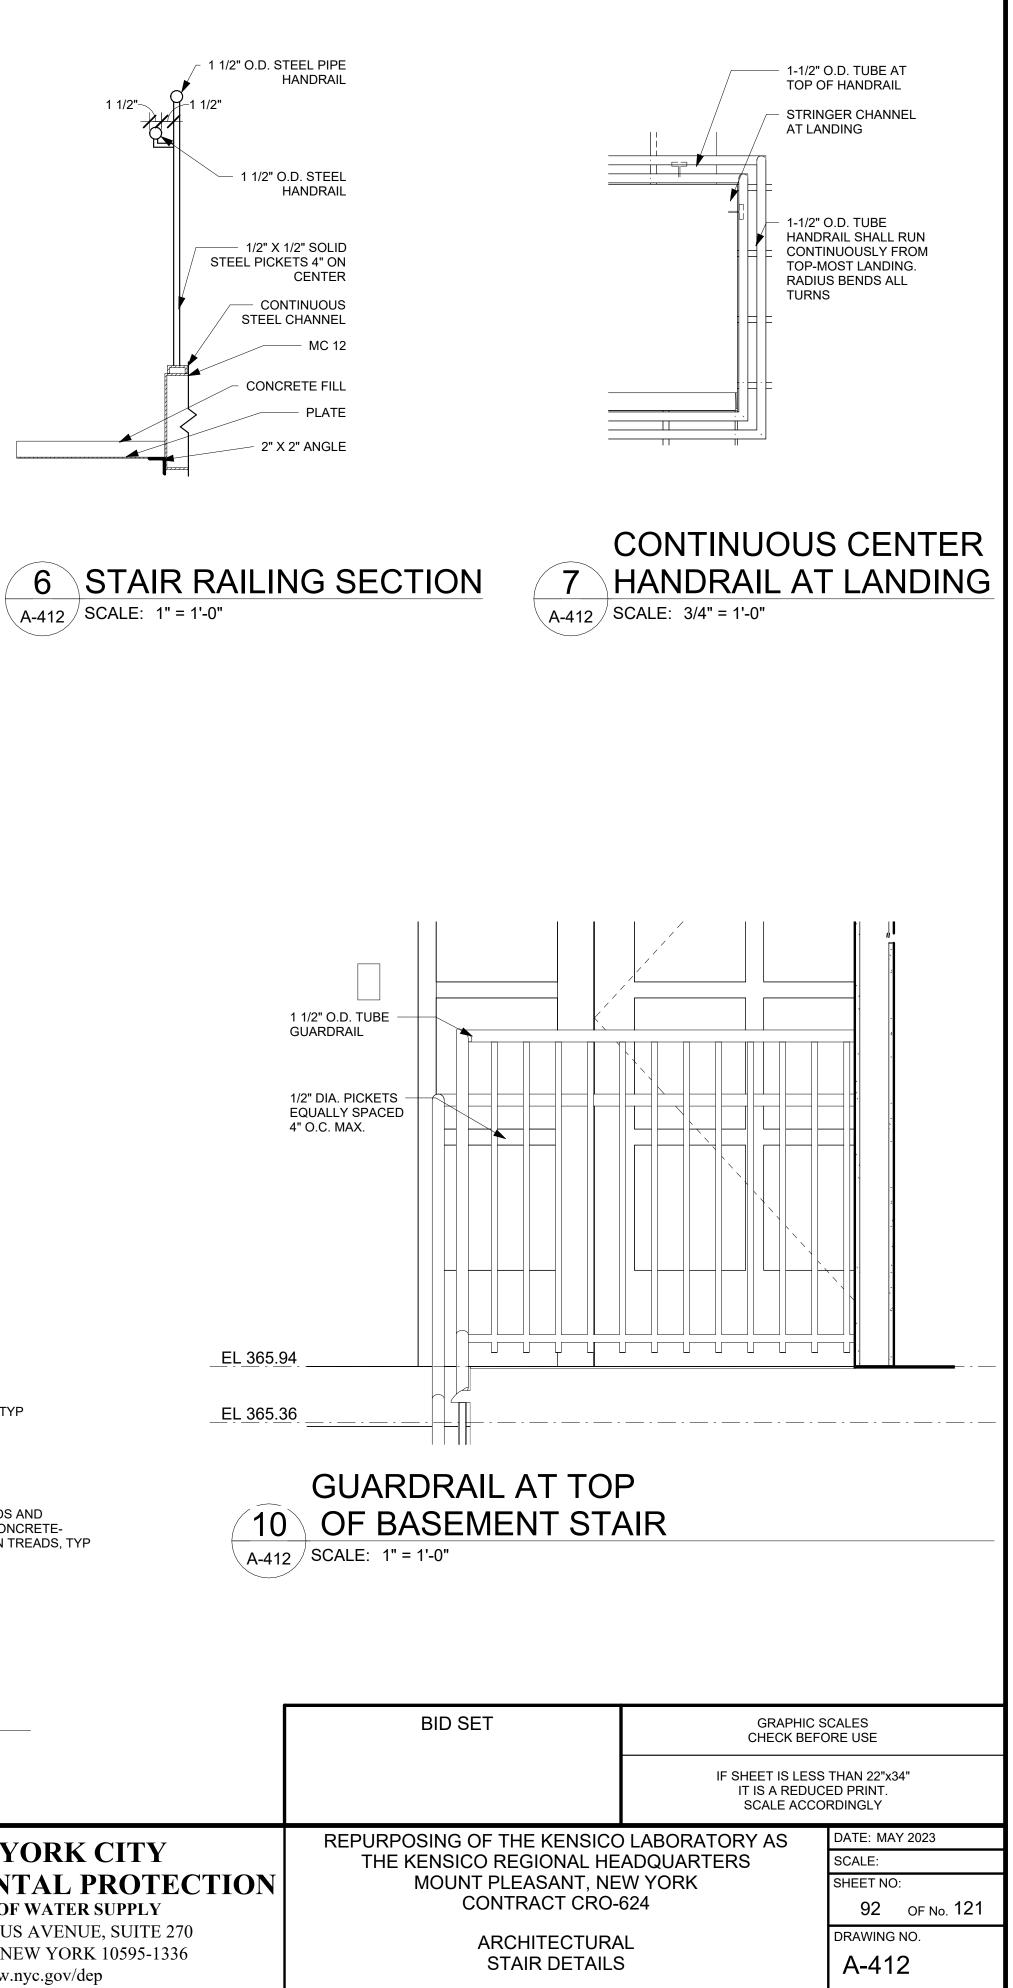
- CAST GALV STL BASE FLANGE

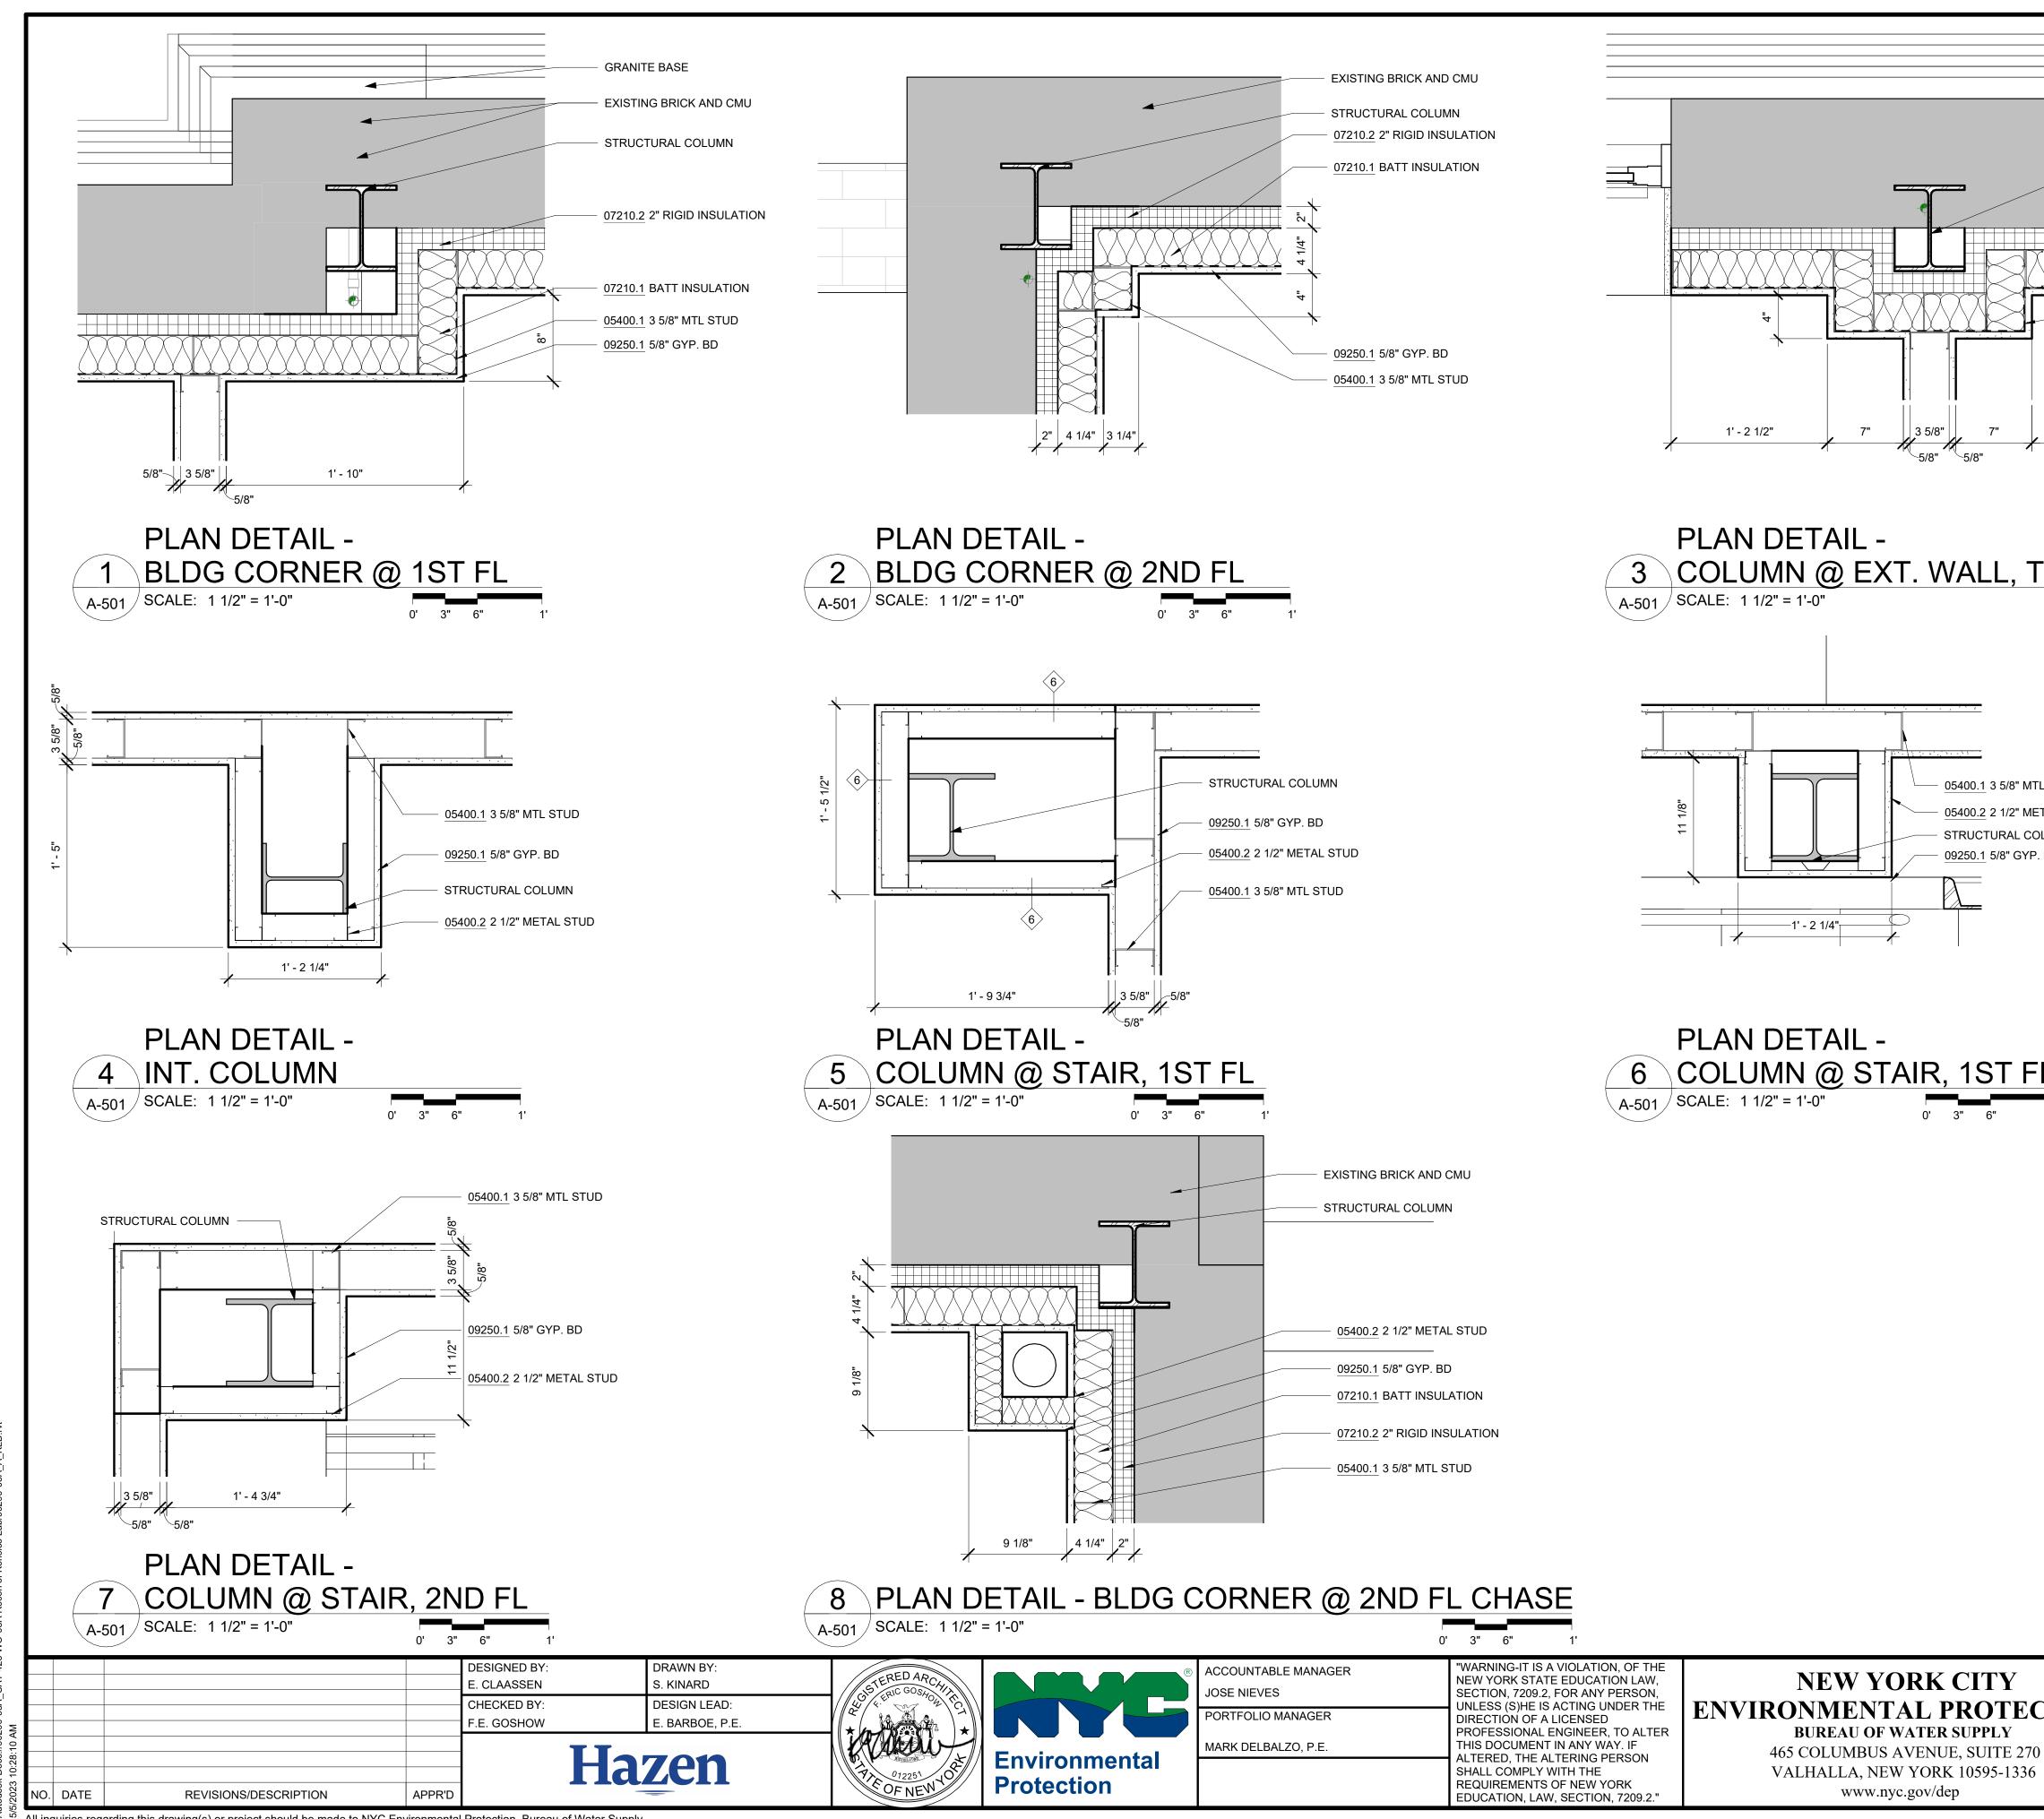
CLAMP

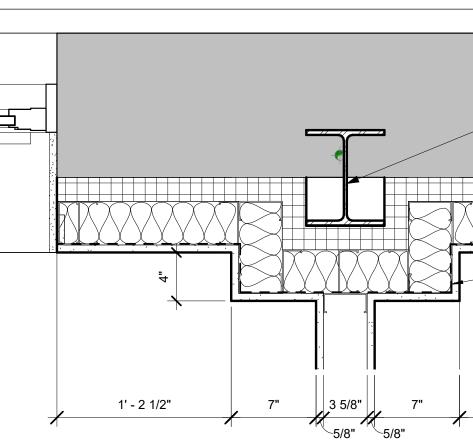
- 4-1/2" SST

– 1 1/2"x1/8" GALV STL


ADHESIVE ANCHORS (MIN 5" EMBEDMENT)









EXISTING BRICK AND CMU STRUCTURAL COLUMN 07210.2 2" RIGID INSULATION 07210.1 BATT INSULATION 07210.1 BATT INSULATION 09250.1 5/8" GYP. BD 05400.1 3 5/8" MTL STUD	$\left  \begin{array}{c} \\ \\ \\ \\ \\ \\ \\ \\ \\ \\ \\ \\ \\ \\ \\ \\ \\ \\ \\$	STRUCTUR 08521.1 ALU 08800.1 GL/ 07210.2 2" F 09250.1 5/8' 07210.1 BA 05400.1 3 5/	UM. FRAMES AZING RIGID INSULATION	ETAILS
DETAIL - CORNER @ 2ND FL $1/2" = 1'-0"$ $\int_{0'}^{1} \frac{1}{3"} = 6"$ 1'	PLAN DETAIL - 3 COLUMN @ EXT. WALL, TYP. A-501 SCALE: 1 1/2" = 1'-0"	DIVISION 5 05400.1 ' 3" 6" 1' 05501.2	BRICK MASONRY INFILL BEYOND	INFILL WALL WITH BRICK TO MATCH EXISTING 3 5/8" METAL STUD @ 16" O.C. TYP. 2 1/2" METAL STUD @ 16" O.C. TYP. CANOPY RECONSTRUCTION ZINC-ANNODIZED ALUMINUM COMMERCIAL-GRADE ALUMINUM FOLDING STAIRWAY WITH DROP-CEILING FRAME
STRUCTURAL COLUMN           09250.1           05400.2           05400.1           3           5/8" MTL STUD	<u>Structural column</u> <u>05400.2</u> 2 1/2" METAL STUD STRUCTURAL COLUMN <u>09250.1</u> 5/8" GYP. BD	07210.2 07540.1 07620.2 07621.1 07621.2 07900.1 07900.2	BATT INSULATION <varies> ROOFING FLASHING STRAINER ROOF DRAIN DOWNSPOUT CAULKING SEALANT SEALANT SEALANT</varies>	FOIL-FACED RECYCLED GLASS FIBER BATTS FOR INSULATION AND VAPOR RETARDER 2" RIGID XPS INSULATION, R-5 PER INCH MIN. SINGLE-PLY THERMOPLASTIC (PVC) MEMBRANE ROOFING STAINLESS STEEL SHEET FLASHING 4-1/2" DIAMETER CAST IRON CANOPY DRAIN WITH STRAINER CUSTOM ZINC-ANNODIIZED ALUMINUM DOWNSPOUT, DESIGN TO MATCH ORIGINAL LEAD-COATED COPPER DOWNSPOUT CONTINUOUS CAULKING WITH BACKER ROD J TRIM W/ SEALANT, TYP.
1'-9 3/4" DETAIL - <u>JMN @ STAIR, 1ST FL</u> 1/2" = 1'-0" 0' 3" 6" 1'	PLAN DETAIL -         6       COLUMN @ STAIR, 1ST FL         A-501       SCALE: 1 1/2" = 1'-0"         0'       3"       6"       1'	08411.1 08521.1	OVERHEAD DOOR ALUM. STOREFRONT ALUM. FRAMES GLAZING	INSULATED ALUMINUM SECTIONAL OVERHEAD DOOR WITH VISION LITES 1" INSULATED GLASS UNIT WITH BIRD PROTECTION UV STRIPE COATING
EXISTING BRICK AND CMU STRUCTURAL COLUMN		09206.2 09206.3 09206.4 09206.5 09206.6 09250.1 09250.2 09250.3 09250.4 09250.5 09250.6 09250.6	METAL FURRING CHANNEL CLIP 1 1/2" STEEL RUNNING CHANNEL GAT CLIP MAIN TEE S/8" GYP. BD J BEAD TRIM TRIM STEEL ROD CEMENT PANELS ACT CEILING CROSS TEE	4B1.5L CAT. #16.59.SM (OR OTHER APPROVED MEANS) 24" OC MAX., SHAPE AND DESIGN AS APPROVED (THE RECESSED FIXTURE MAY BE SUPPORTED BY THE MAIN TEES SPACED 2'-0" OR 4'-0" OC) <varies> GYP BD J CASING BEAD, TAPE AND SPACKLE 1" X 1" CORNER TRIM W/ SEALANT BED 1/4" DIA. GALV. STEEL ROD, NOT TO EXCEED 4'-0" OC 3/4" EXTERIOR CEMENT BOARD SOFFIT PANELS 1 1/2" HIGH, 2'-0" OC</varies>
<u>9 1/8"</u> <u>4 1/4"</u> <u>2"</u> <u>DETAIL - BLDG CORNER @ 2ND FL CHASE</u> <u>1/2" = 1'-0"</u>		BID SET	CHE IF SHEET IT IS A	APHIC SCALES CK BEFORE USE IS LESS THAN 22"x34" A REDUCED PRINT.
0' 3" 6" 0' 0' 3" 6" 0' 0' 3" 6" 0' 0' 3" 6" 0' 0' 0' 0' 0' 0' 0' 0' 0' 0' 0' 0' 0' 0	NEW YORK NEW YORK CITY NEW YORK NUCATION LAW, R ANY PERSON, TING UNDER THE ENSED INEER, TO ALTER ANY WAY. IF RING PERSON I THE NEW YORK NEW YORK NEW YORK NEW YORK	REPURPOSING OF THE KENSI THE KENSICO REGIONAL MOUNT PLEASANT, CONTRACT CR ARCHITECTU PLAN DETA	SCAL ICO LABORATORY A HEADQUARTERS NEW YORK RO-624 JRAL	E ACCORDINGLY

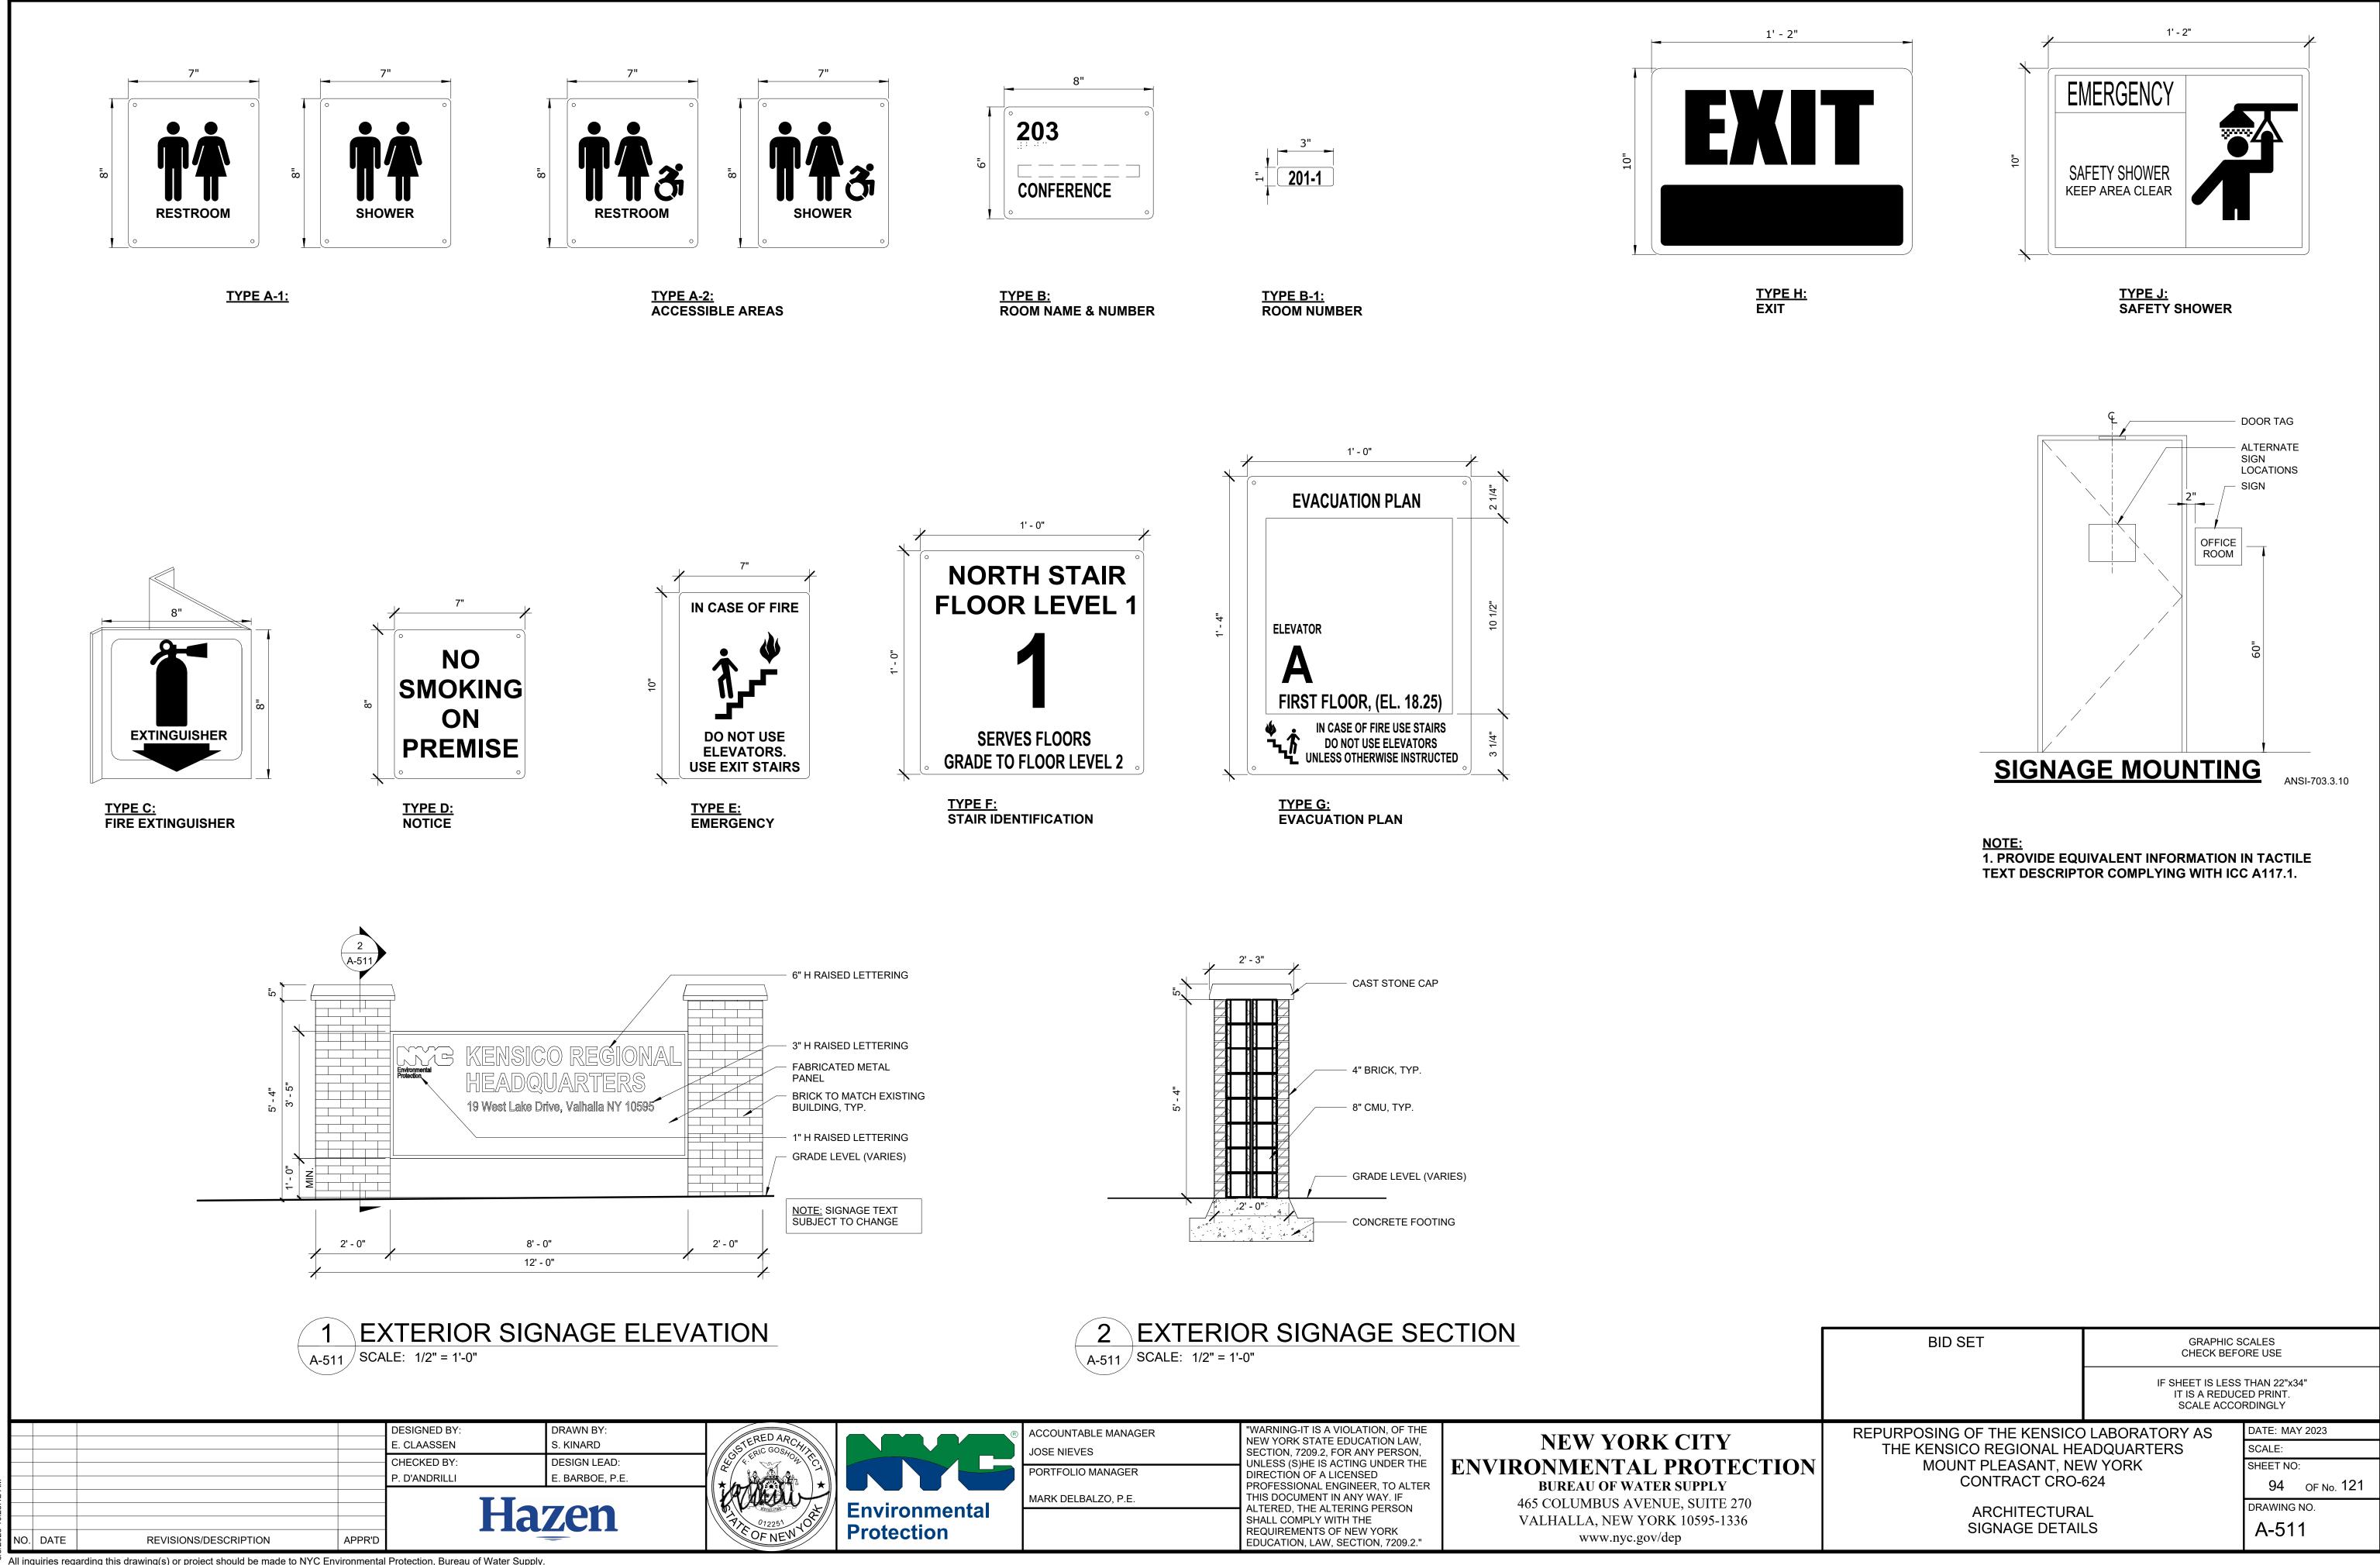

ACCOUNTABLE MANAGER	"WARNING-IT IS A NEW YORK STAT
JOSE NIEVES	SECTION, 7209.2, UNLESS (S)HE IS
PORTFOLIO MANAGER	DIRECTION OF A
MARK DELBALZO, P.E.	THIS DOCUMENT ALTERED, THE A
	SHALL COMPLY N REQUIREMENTS

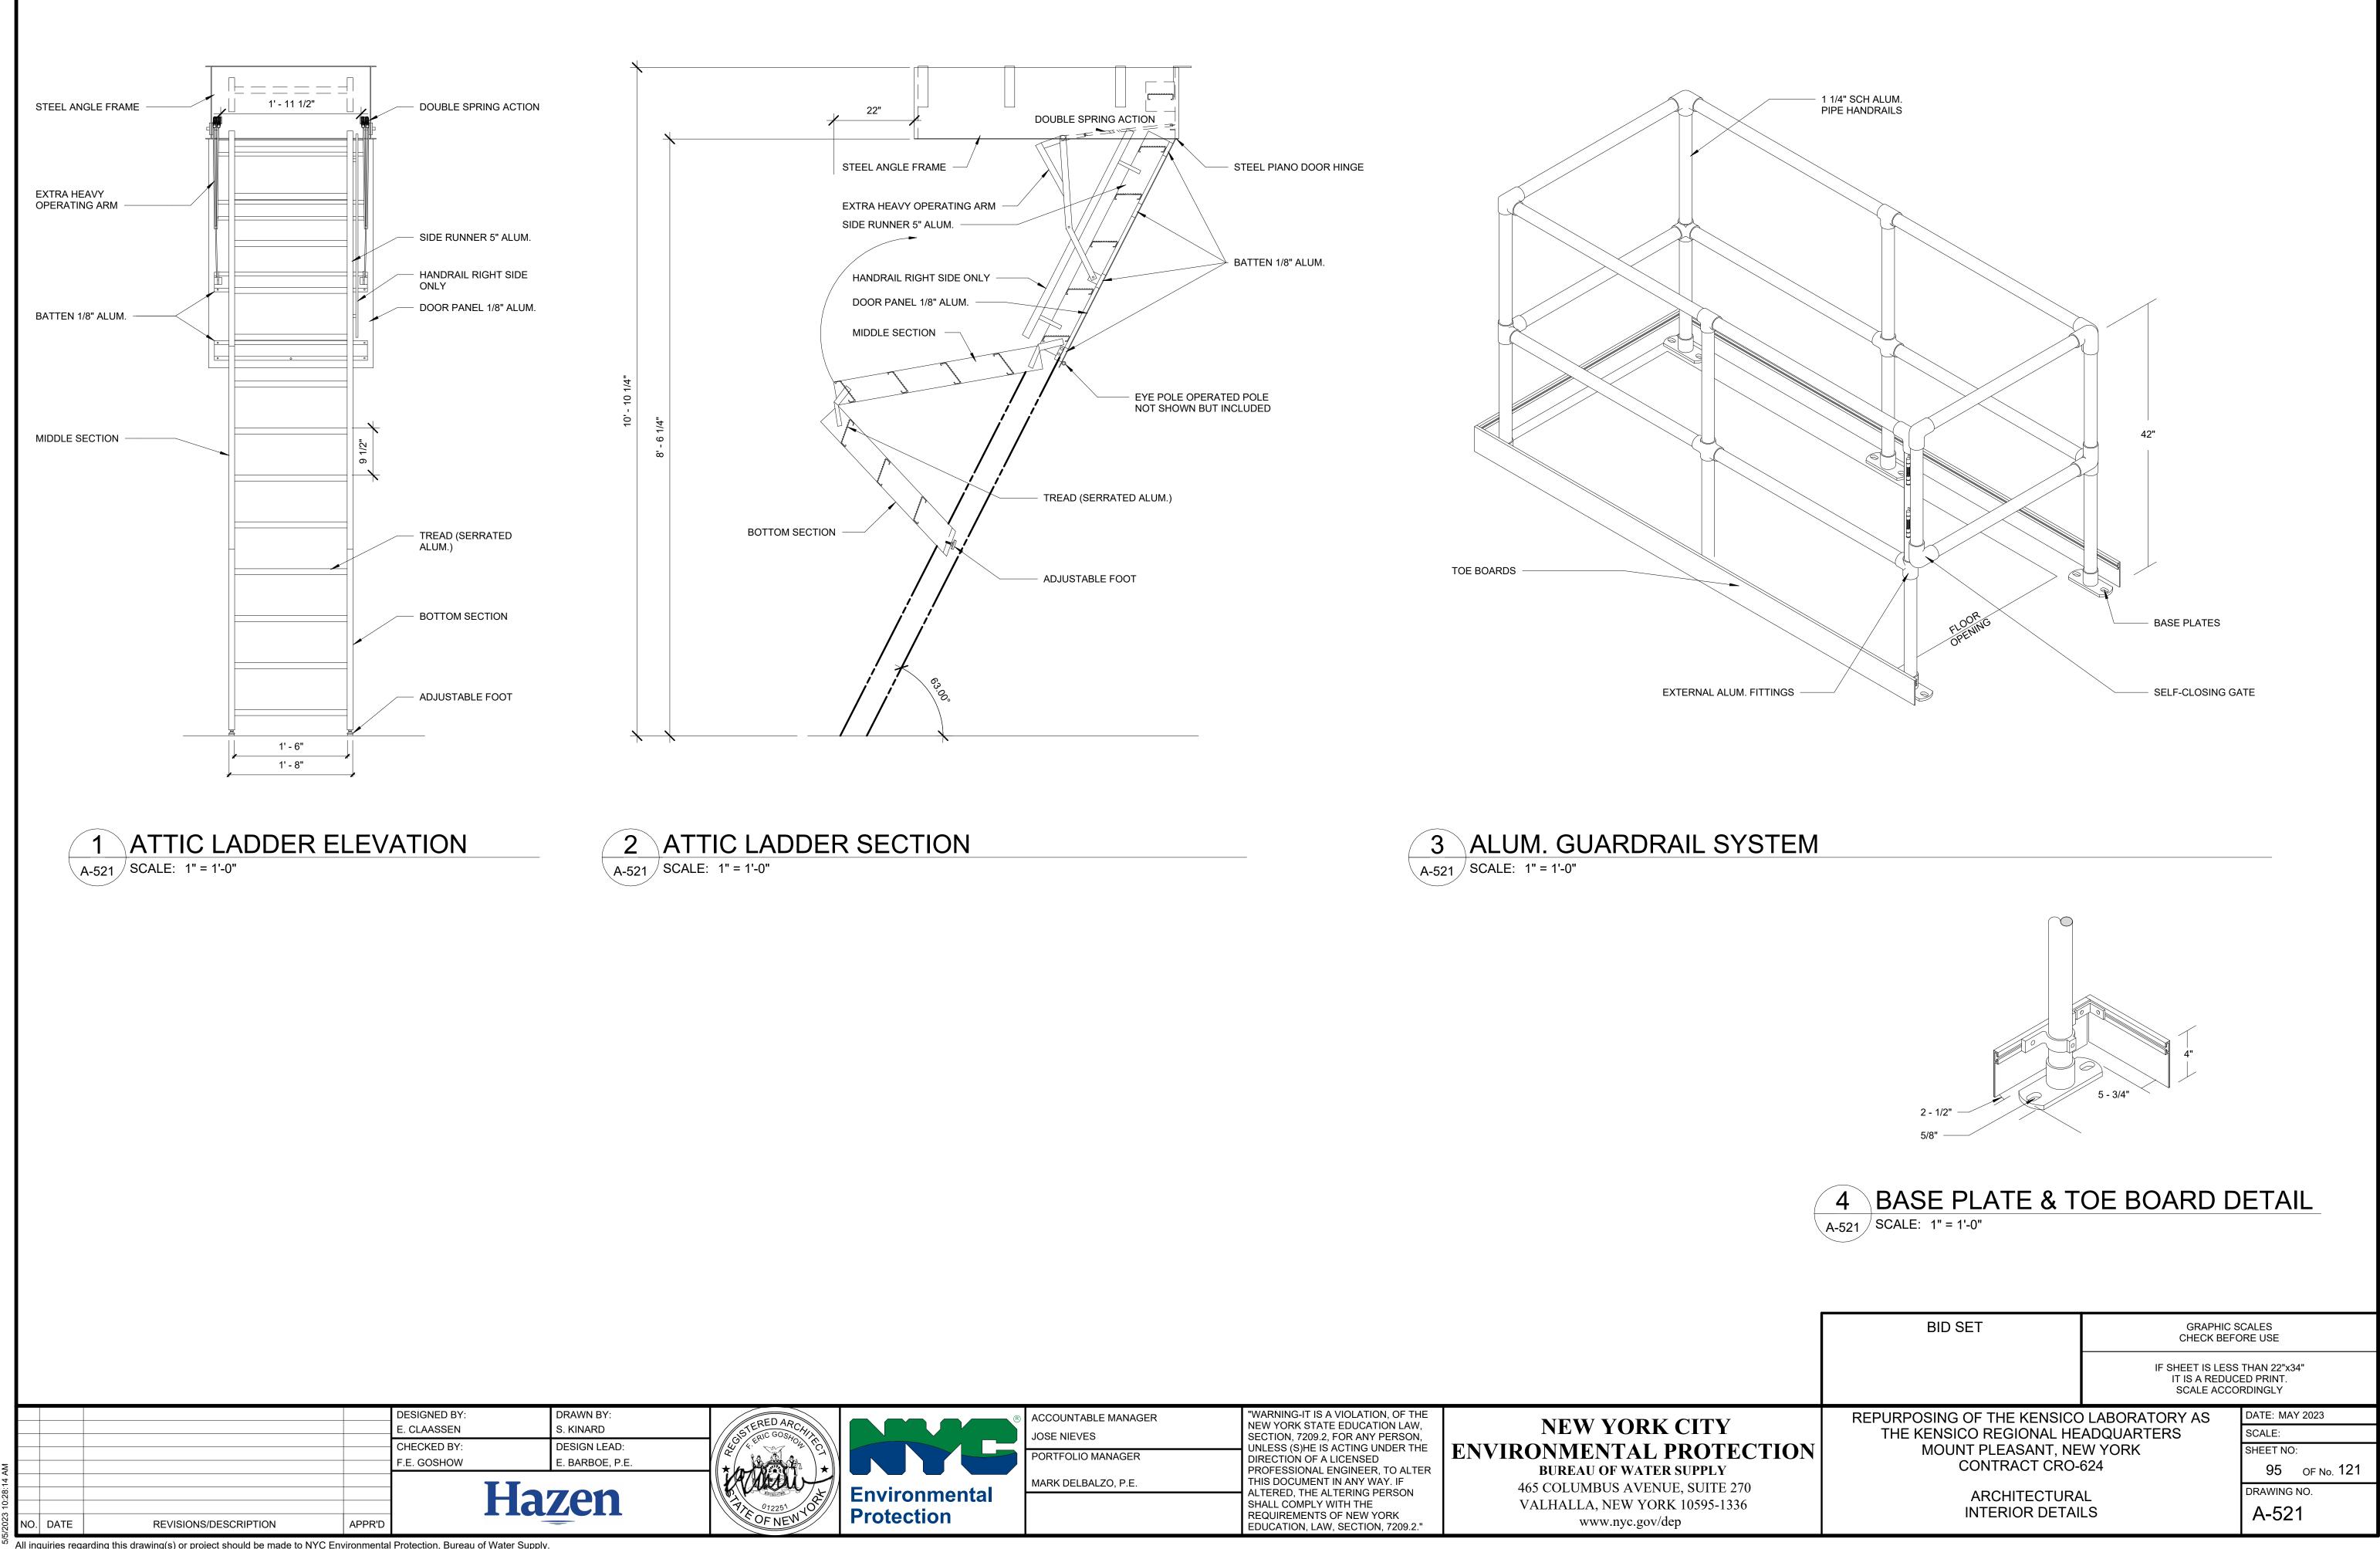

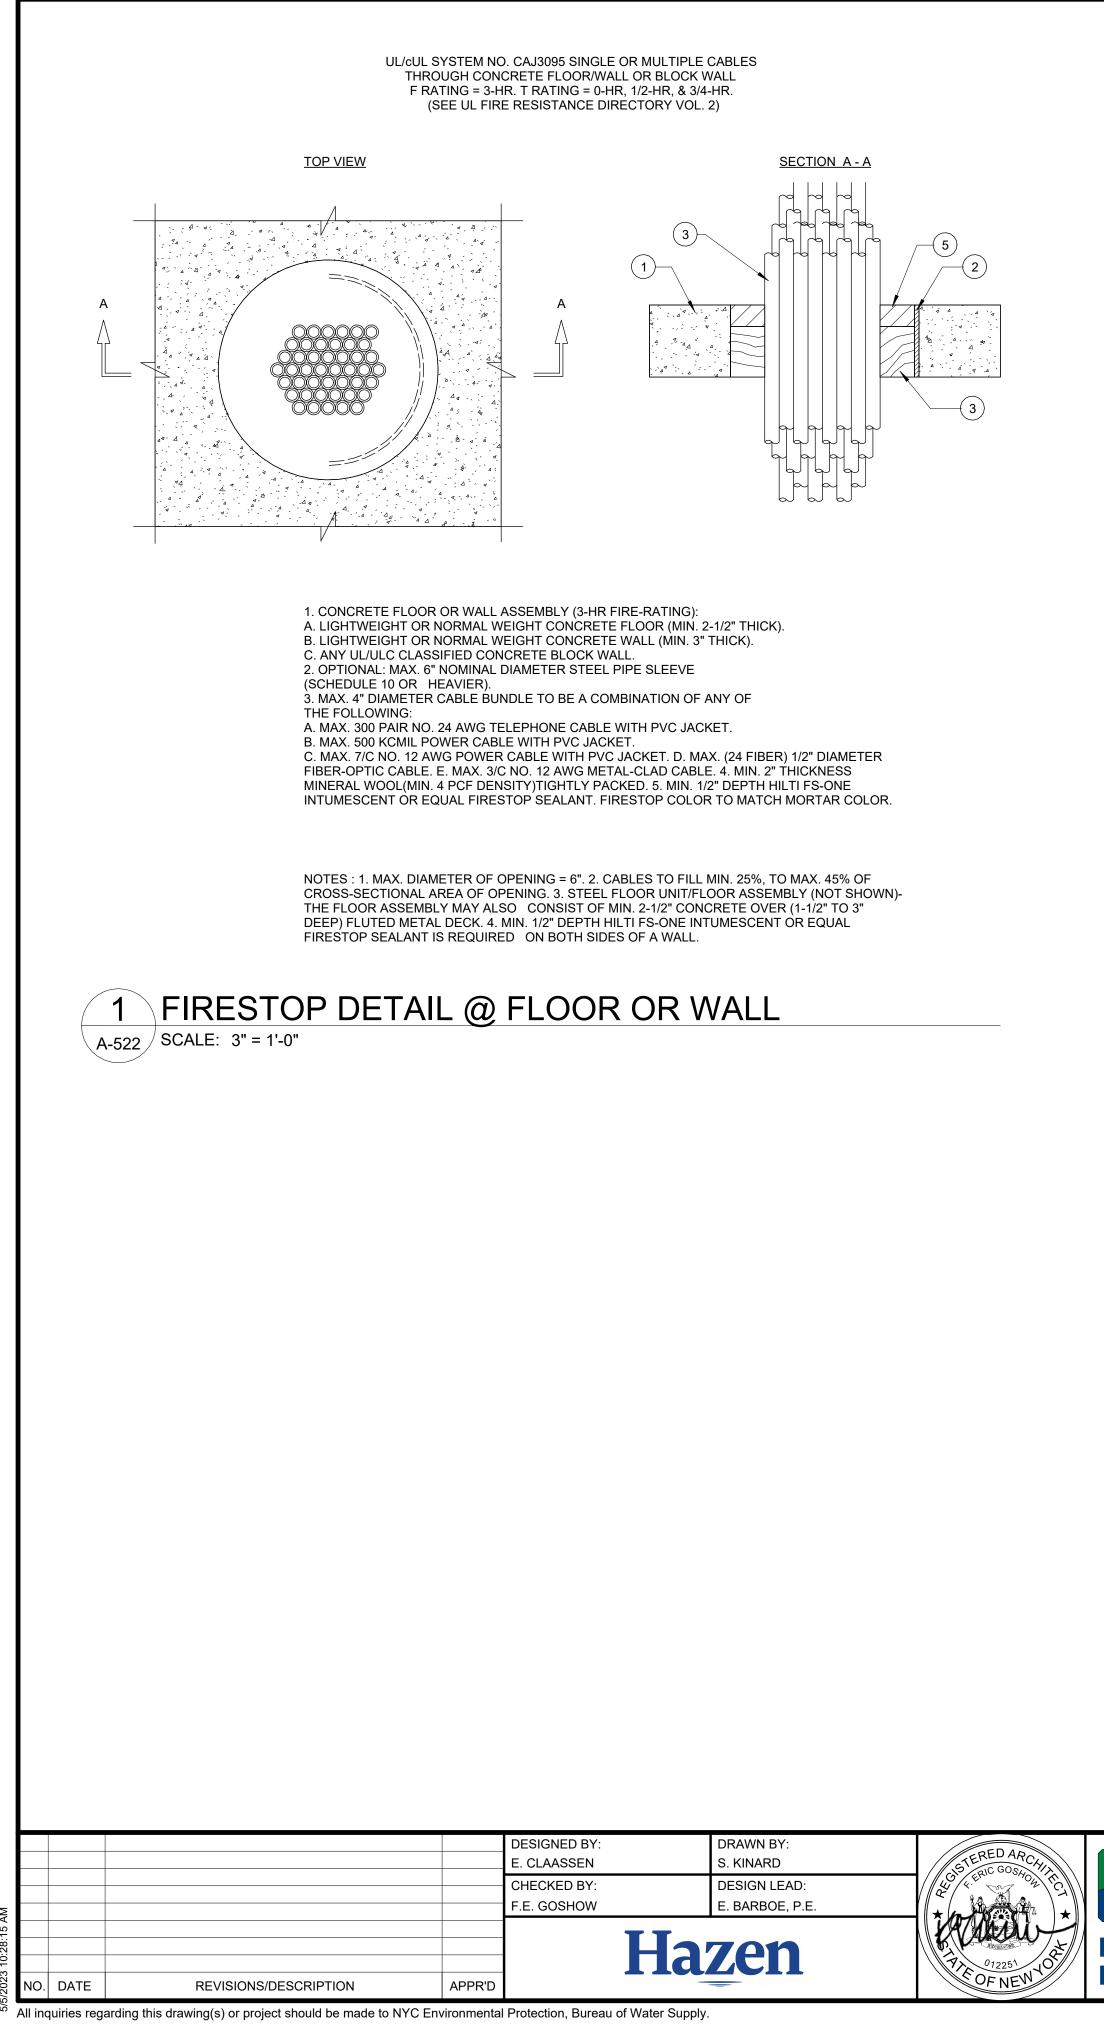




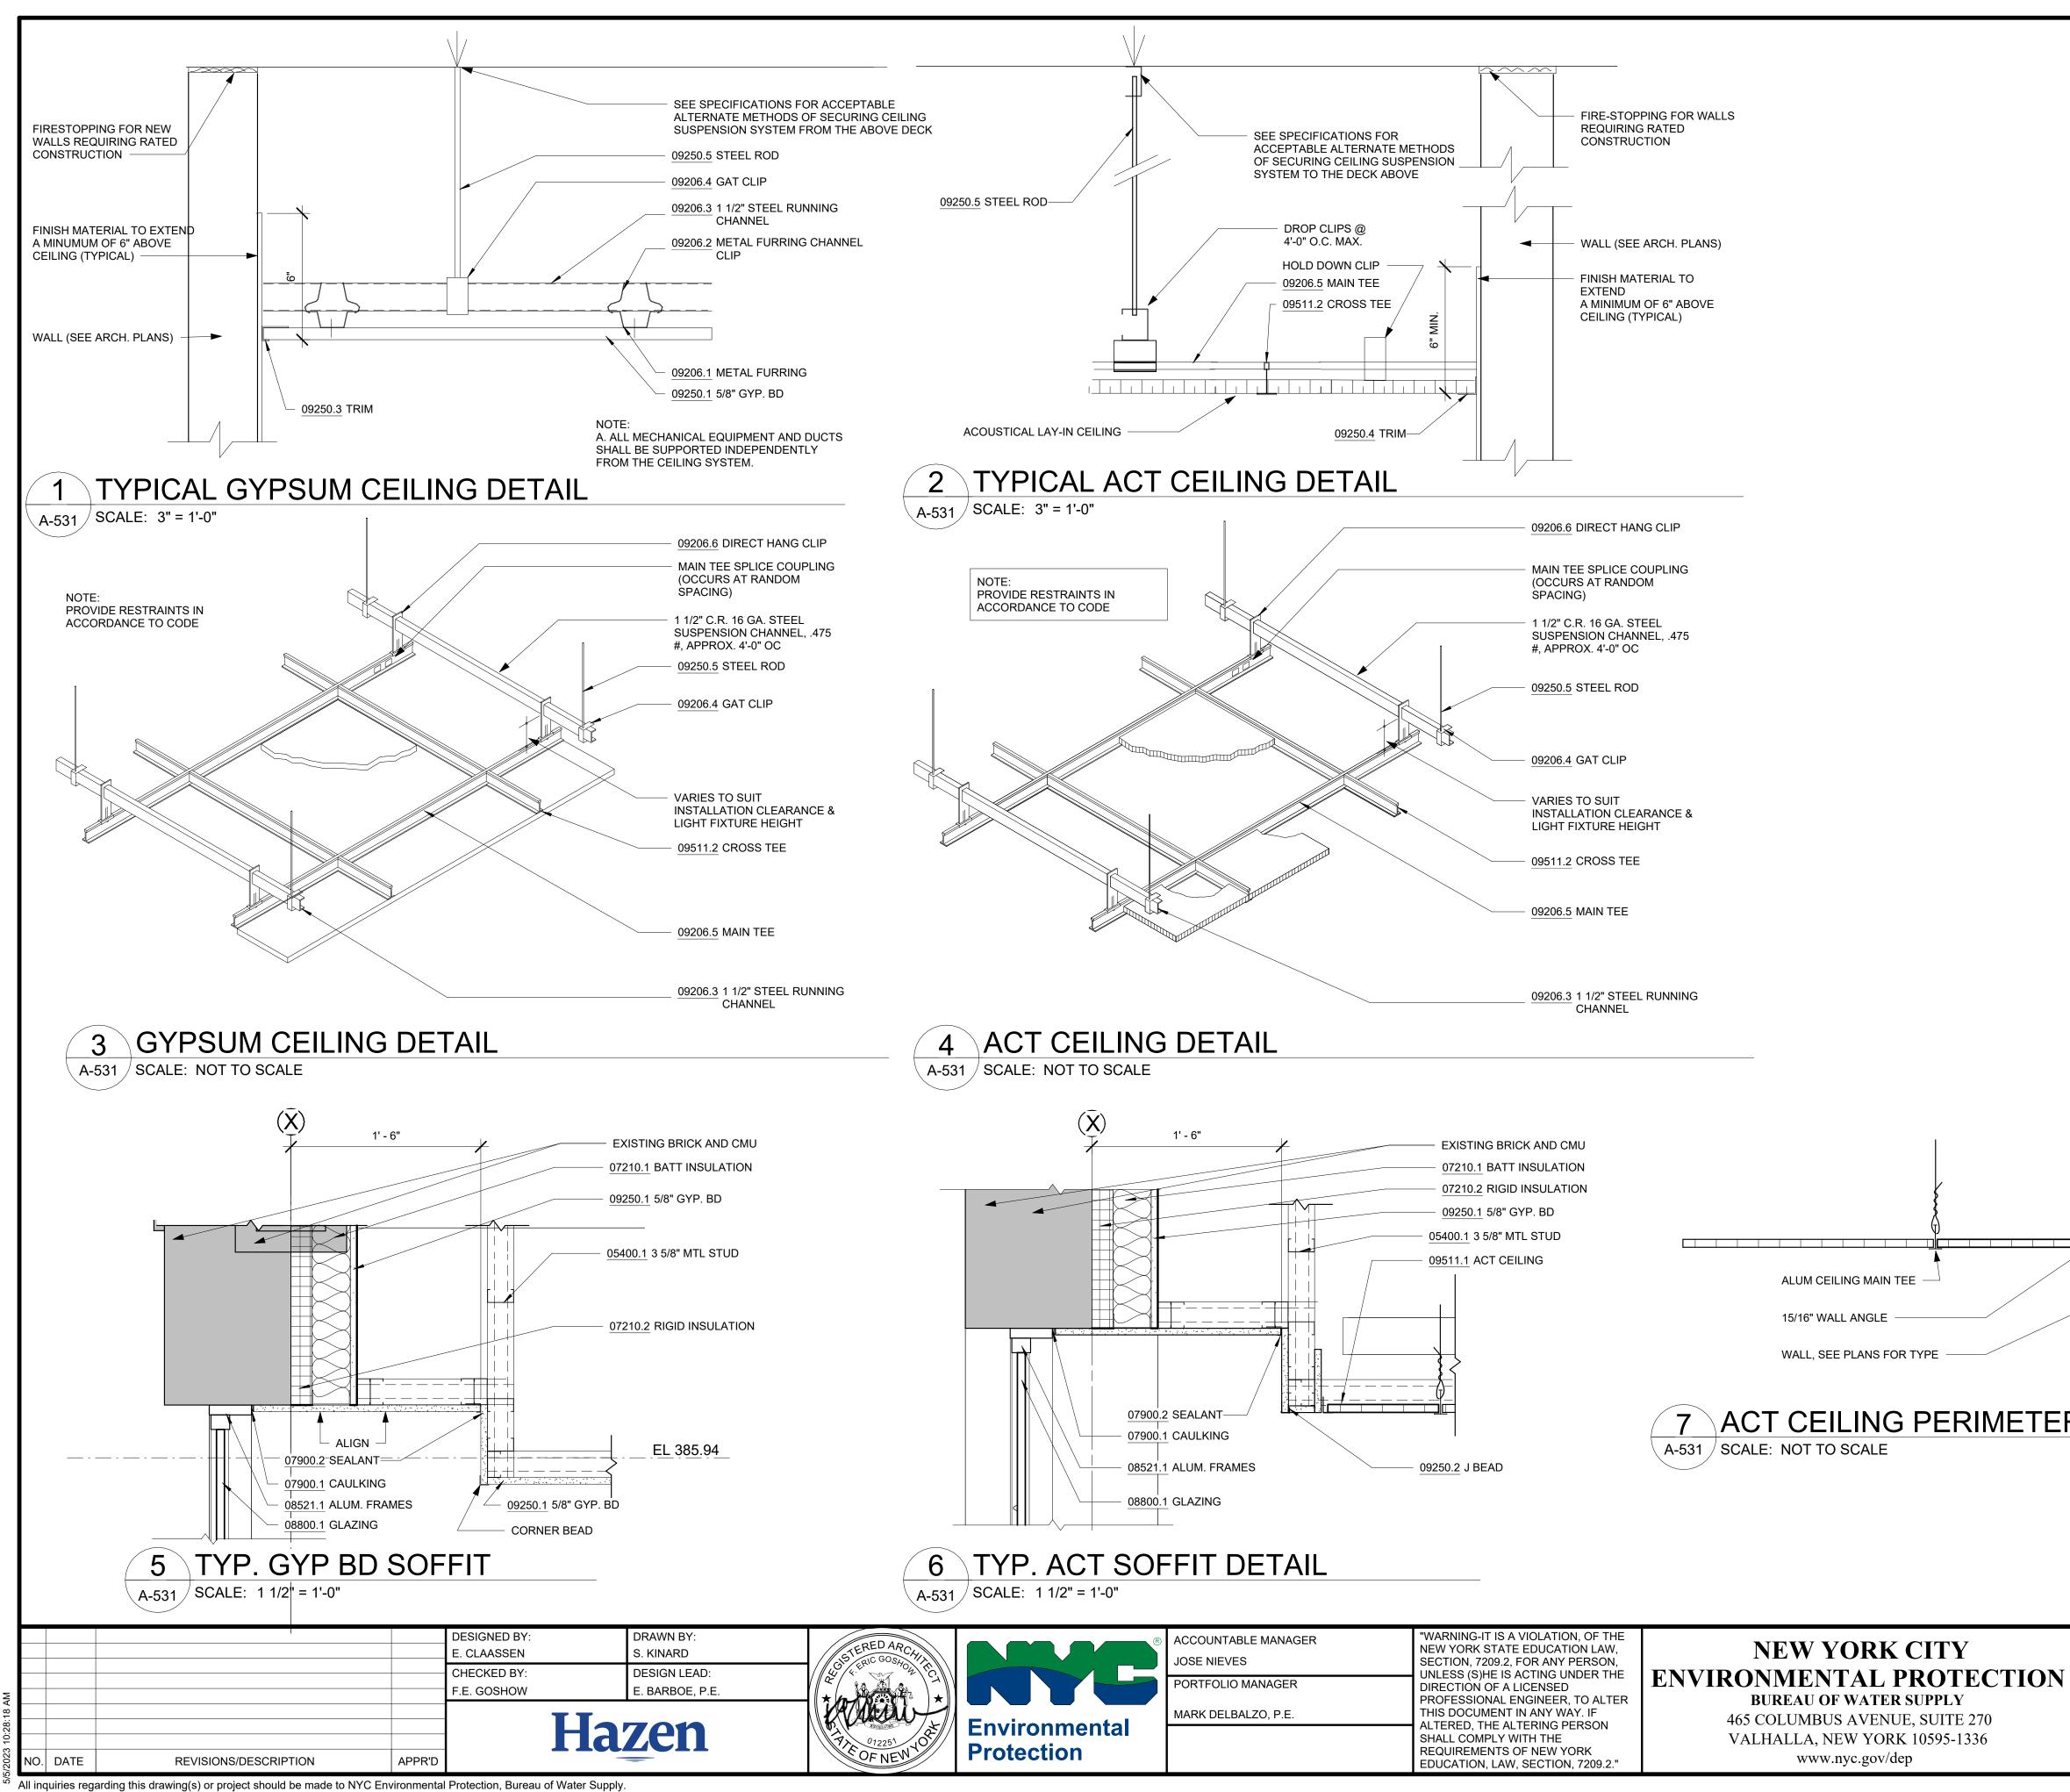ACCOUNTABLE MANAGER JOSE NIEVES PORTFOLIO MANAGER MARK DELBALZO, P.E.

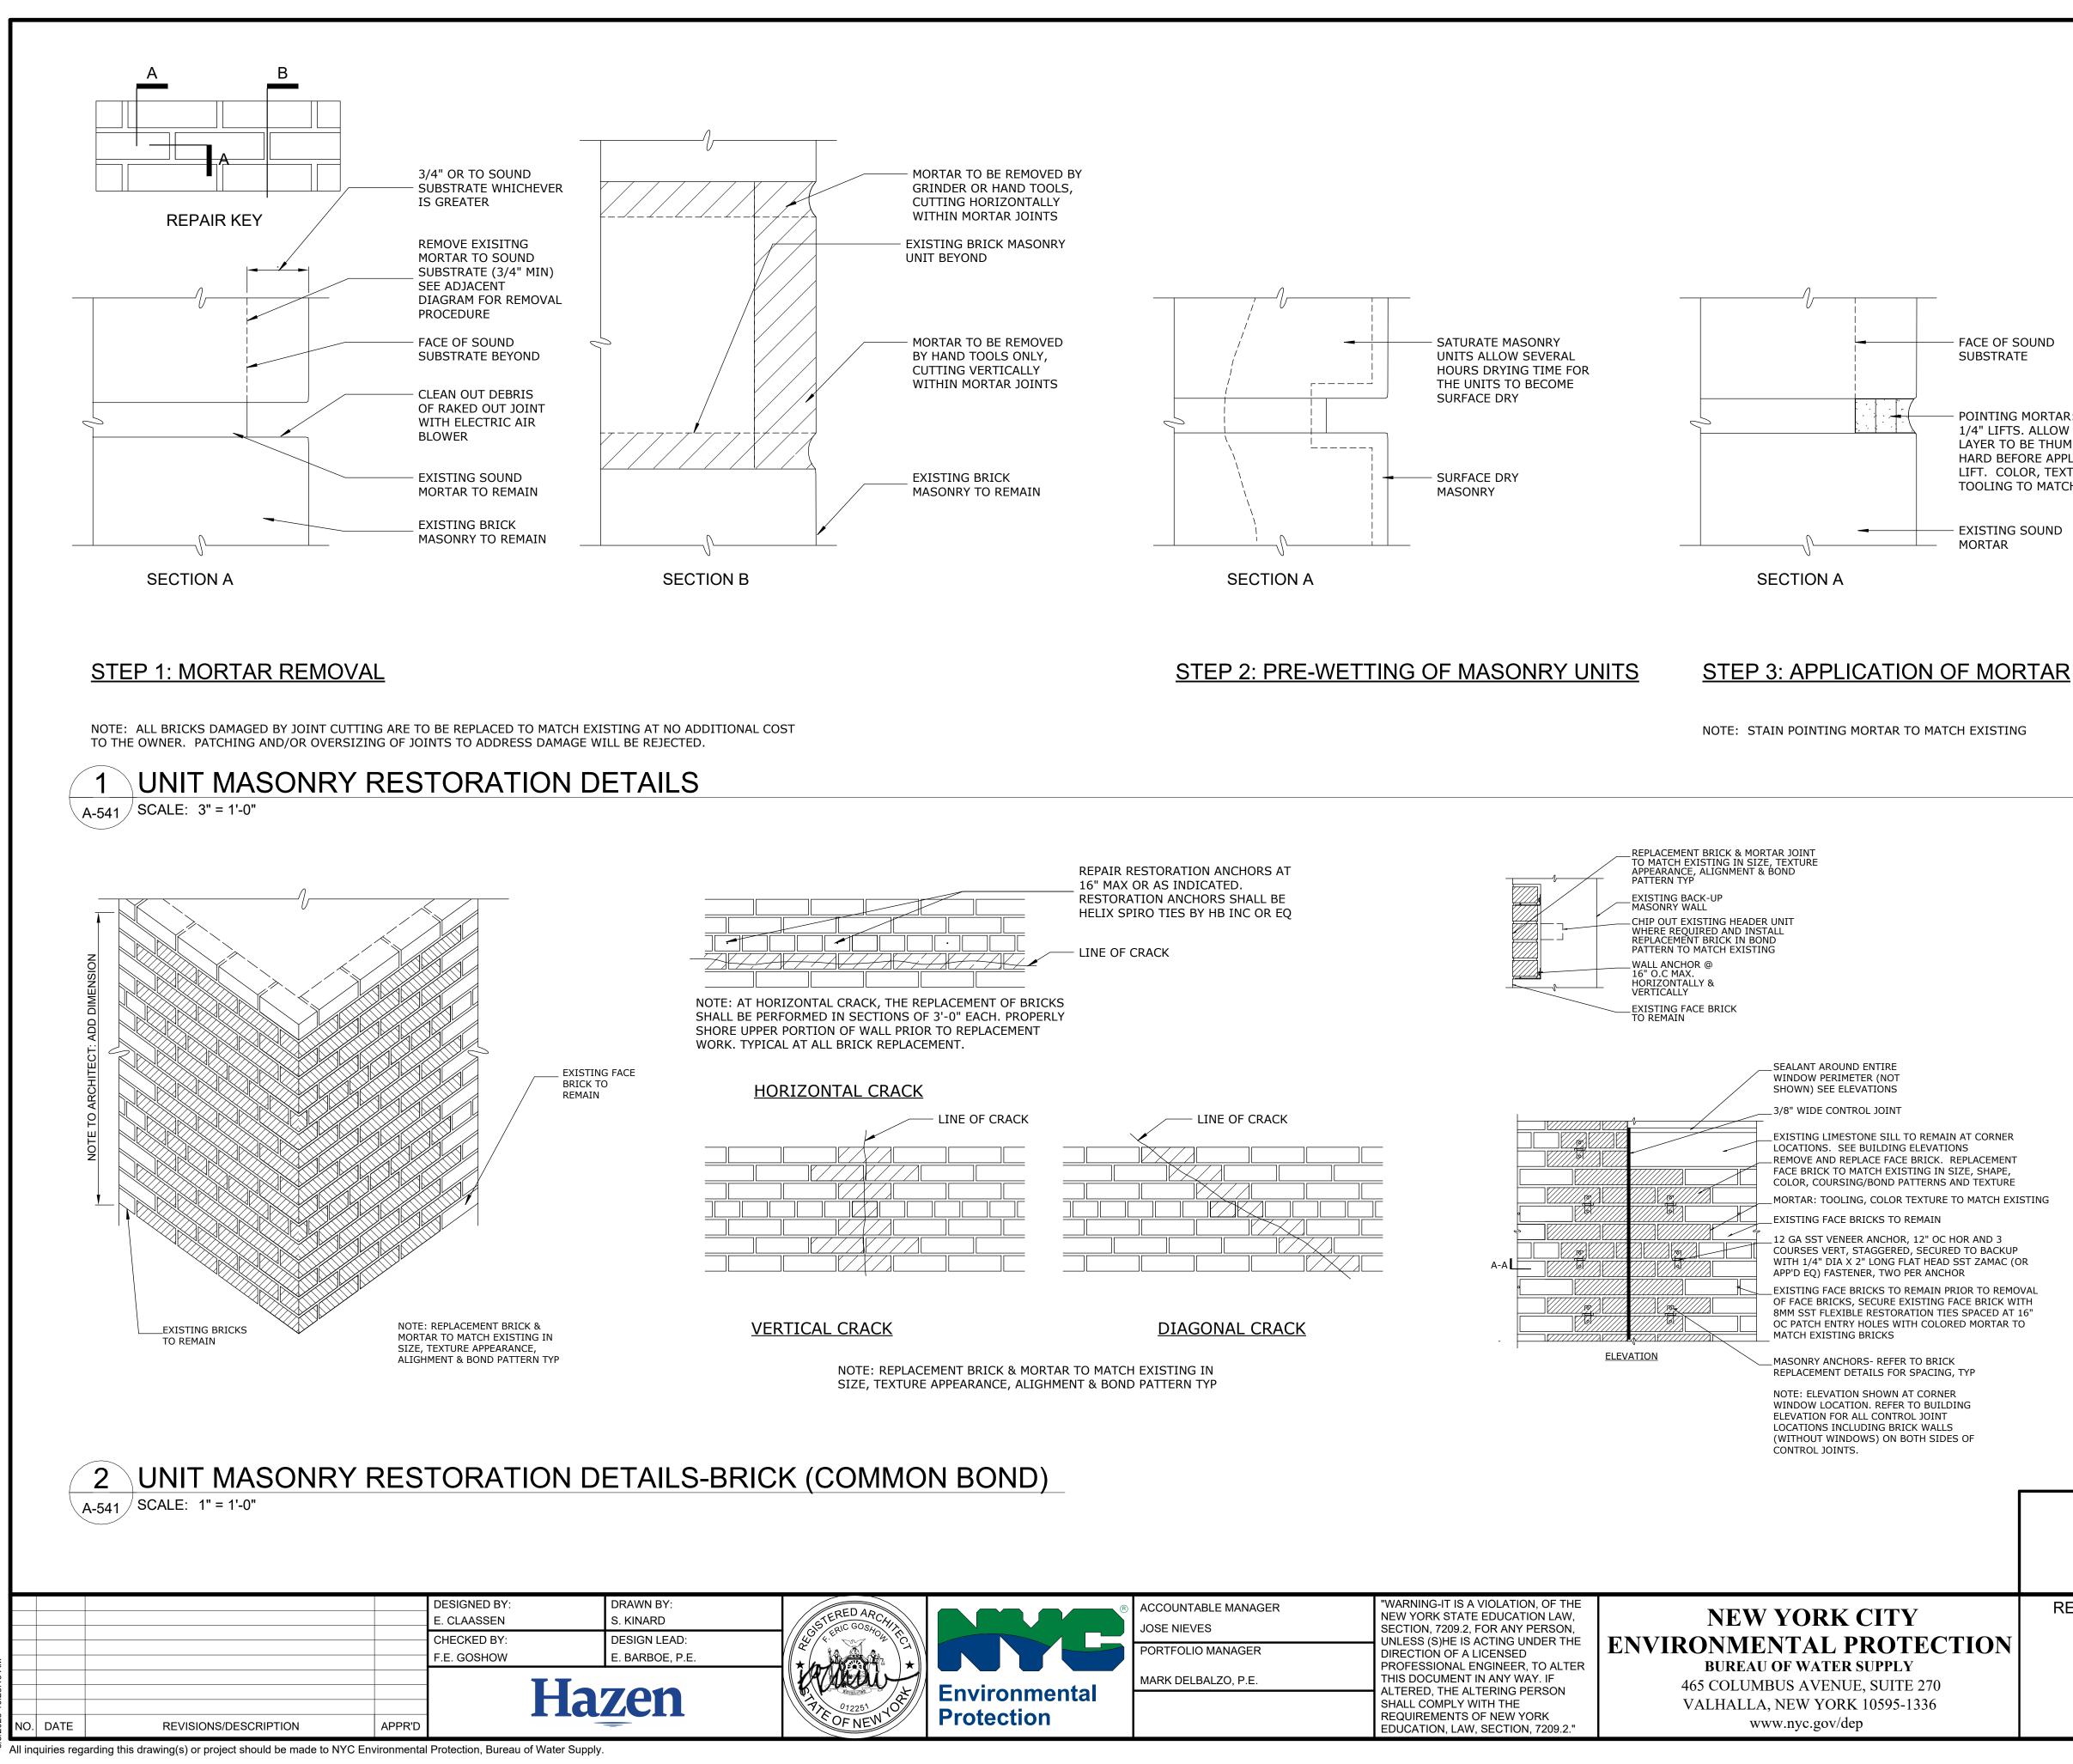
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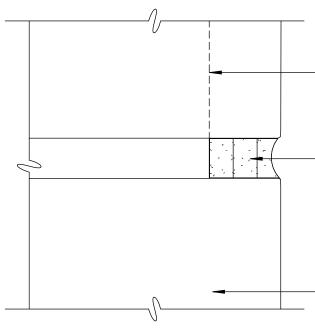
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	BID SET GRAPHIC SC CHECK BEFOR		
		THAN 22"x34" ED PRINT. RDINGLY	
	REPURPOSING OF THE KENSICO LABORATORY AS		DATE: MAY 2023
	THE KENSICO REGIONAL HE	SCALE:	
CTION	MOUNT PLEASANT, NE	SHEET NO:	
	CONTRACT CRO-	96 OF No. 121	
	ARCHITECTURAL		DRAWING NO.
	FIRESTOPPING DETAILS		A-522



				NOTES - DE	TAILS	
		DIVISION 4 04120.1	BRIC BEY(	K MASONRY INFILL DND		ALL WITH BRICK TO
		DIVISION 5 05400.1	3 5/8	" MTL STUD		ETAL STUD @ 16" O.C.
		05400.2	2 1/2	" METAL STUD		ETAL STUD @ 16" O.C.
		05501.2	ALUN	MINUM		
		05501.3	ATTI	C ACCESS HATCH		NODIZED ALUMINUM RCIAL-GRADE ALUMINUM & STAIRWAY WITH EILING FRAME
		DIVISION 7 07210.1	BATT	INSULATION	FIBER B	CED RECYCLED GLASS
		07210.2	<vari< th=""><th>es&gt;</th><th>2" RIGID</th><th>POR RETARDER XPS INSULATION, R-5</th></vari<>	es>	2" RIGID	POR RETARDER XPS INSULATION, R-5
		07540.1	ROO	FING		PLY THERMOPLASTIC
		07620.2	FLAS	HING	STAINLE	EMBRANE ROOFING SS STEEL SHEET
		07621.1	STR	AINER ROOF DRAIN		AMETER CAST IRON
		07621.2	DOW	NSPOUT	CUSTOM ALUMINU DESIGN LEAD-CO	T DRAIN WITH STRAINER I ZINC-ANNODIIZED JM DOWNSPOUT, TO MATCH ORIGINAL DATED COPPER
		07900.1	CAU	_KING		JOUS CAULKING WITH
		07900.2			BACKER J TRIM V	ROD // SEALANT, TYP.
		07900.3	SEAL	AN I		
		DIVISION 8 08361.1		RHEAD DOOR	SECTION	ED ALUMINUM NAL OVERHEAD DOOR SION LITES
		08411.1 08521.1 08800.1		Л. STOREFRONT Л. FRAMES ZING	BIRD PR	ATED GLASS UNIT WITH OTECTION UV STRIPE
		DIVISION 9 09206.1		AL FURRING	COATING	÷
		09206.2	CLIP			
		09206.3	CHA	" STEEL RUNNING NNEL		
		09206.4	GAT		OTHER A	AT. #16.59.SM (OR APPROVED MEANS)
		09206.5	MAIN	ITEE	AS APPF FIXTURE	MAX., SHAPE AND DESIGN ROVED (THE RECESSED E MAY BE SUPPORTED BY N TEES SPACED 2'-0" OR
		09206.6 09250.1 09250.2	<vari 5/8" ( J BE/</vari 	GYP. BD		J CASING BEAD, TAPE
		09250.3 09250.4	TRIM TRIM		AND SPA	ACKLE ORNER TRIM W/
		09250.5		EL ROD	SEALAN	
		09250.6		ENT PANELS	TO EXCE	EED 4'-0" OC ERIOR CEMENT BOARD
		09511.1		CEILING	SOFFIT I	
		09511.2		SS TEE	1 1/2" HI	GH, 2'-0" OC
_	₽					
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: ト	RDETAIL					
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	BID SET				RAPHIC SO ECK BEFO	
				IT IS /		THAN 22"x34" ED PRINT. RDINGLY
	REPURPOSING OF				S	DATE: MAY 2023
<b>1</b>	THE KENSICO F MOUNT P					SCALE: SHEET NO:
۱		ITRACT CI				97 OF No. 121
		CHITECTI				DRAWING NO. A-531
	UL UL			-		



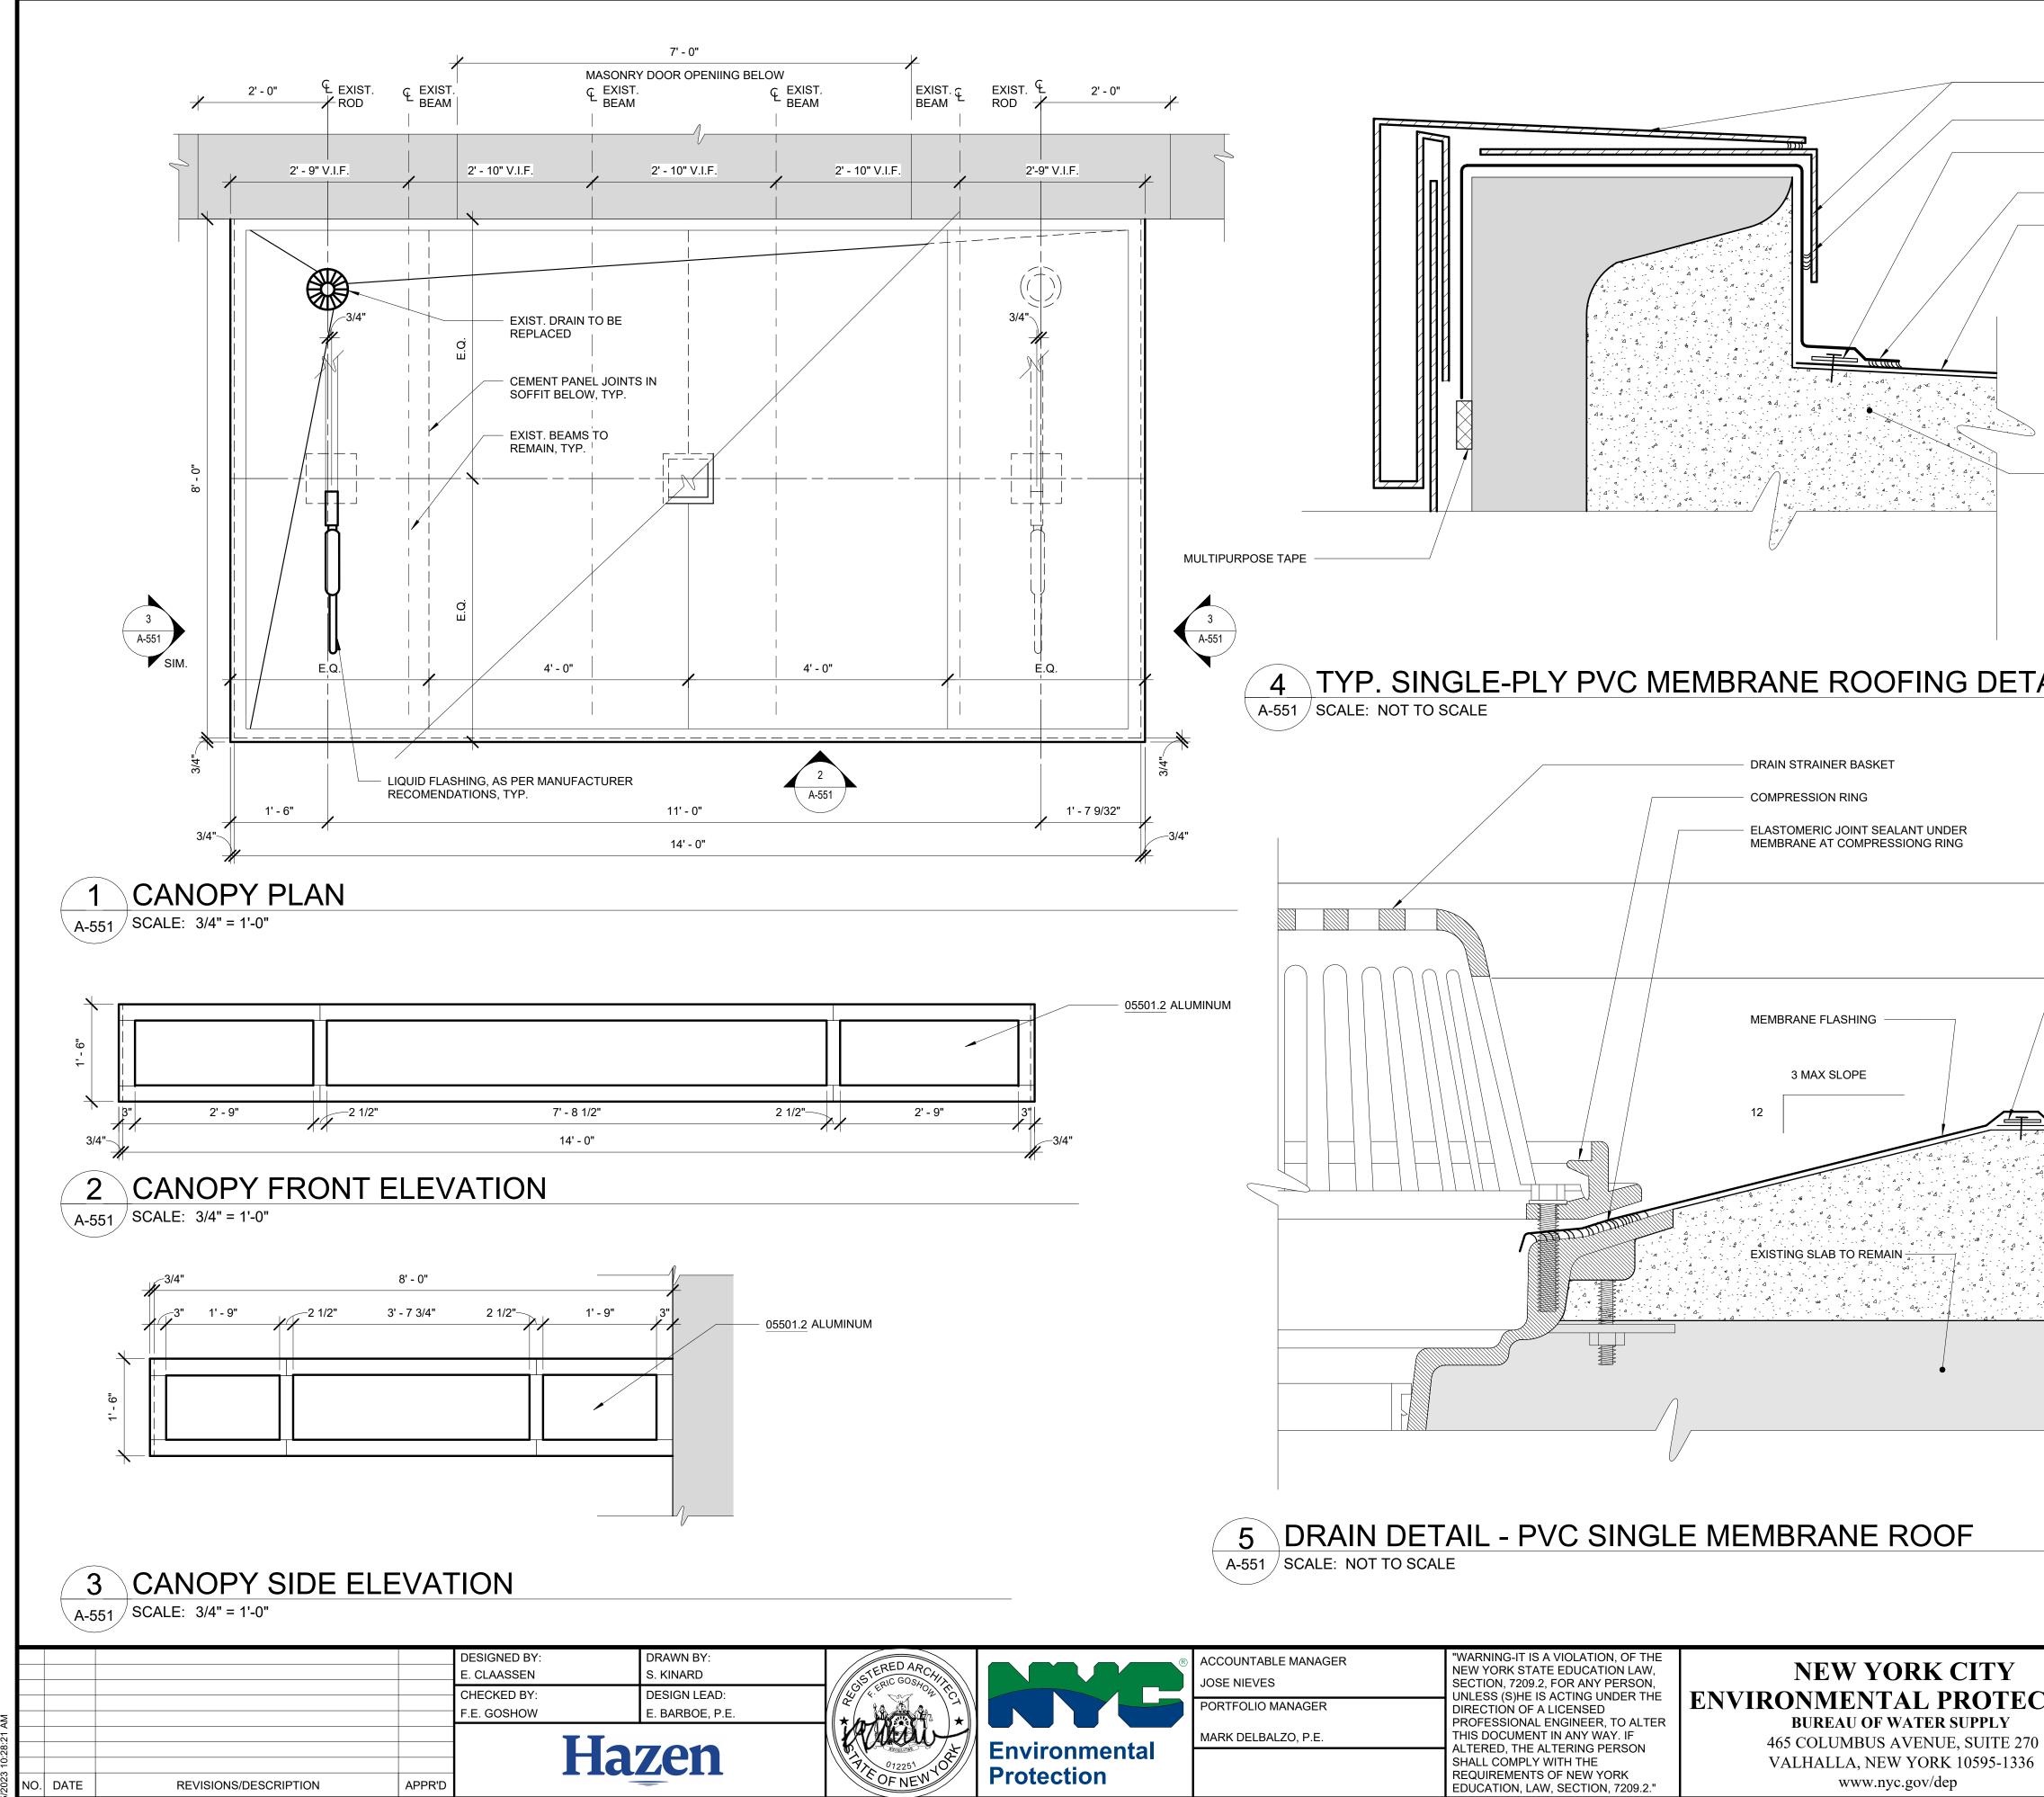


FACE OF SOUND SUBSTRATE

POINTING MORTAR: APPLY IN 1/4" LIFTS. ALLOW EACH LAYER TO BE THUMBPRINT HARD BEFORE APPLYING NEXT LIFT. COLOR, TEXTURE, AND TOOLING TO MATCH EXISTING

EXISTING SOUND MORTAR


EXISTING BACKUP MASONRY TO REMAIN, PROTECT DURING WORK \_PACK COLLAR JOINT SOLID AND PROVIDE CONTINUOUS PARGE OF BACK-UP, TYP \_REMOVE AND REPLACE FACE BRICK. NEW FACE BRICK TO MATCH EXISTING IN SIZE, SHAPE COLOR, TEXTURE, COURSING AND BOND PATTERN EXISTING FACE BRICKS TO REMAIN. PRIOR TO REMOVAL OF FACE BRICKS, SECURE EXISTING FACE BRICK WITH 8MM SST FLEXIBLE / N\_XX RESTORATION TIES SPACED AT 16" OC PATCH ENTRY HOLES WITH COLORED MORTAR TO MATCH EXISTING BRICKS SECTION A-A \_3/8" WIDE CONTROL JOINT EXISTING BACK-UP MASONRY TO BE PARGED WITH MORTAR EXISTING BRICK \_NEW BRICK TO MATCH EXISTING IN SIZE, SHAPE, TEXTURE, COLOR AND BOND PATTERN \_CLOSED CELL JOINT FILLER \_POLYBUTYLENE IMPREGNATED COMPRESSIBLE POLYURETHANE JOINT FILLER SEALANT OR BACKER ROD \_PRIME CONTROL JOINT AND SEAL WITH SEALANT CONTROL JOINT DETAIL BID SET **GRAPHIC SCALES** CHECK BEFORE USE IF SHEET IS LESS THAN 22"x34" IT IS A REDUCED PRINT. SCALE ACCORDINGLY DATE: MAY 2023 REPURPOSING OF THE KENSICO LABORATORY AS THE KENSICO REGIONAL HEADQUARTERS SCALE: MOUNT PLEASANT, NEW YORK SHEET NO: CONTRACT CRO-624 98 OF No. 121 DRAWING NO. ARCHITECTURAL MASONRY RESTORATION DETAILS A-541



	Environmental Protection	
*	Environmental Protection	

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	ALTERED, THE ALTERING PERSON SHALL COMPLY WITH THE REQUIREMENTS OF NEW YORK EDUCATION LAW SECTION 7209.2 "	

ZINC AN	ODIZED ALUMINUM, TYP.		
ELASTO	MERIC JOINT SEALANT		
MANFAC SECURE	CTURER APPROVED		
— MEMBRA	ANE FLASHING, WELDED		
	RETE FILL & SCREED ON		
EXI91	ING SLAB, SLOPE TO DRAIN.		
AIL			
	OF CANOPY		
FASCIA	BEYOND		
	<b>/</b>		
PVC ROC			
MEMBRA			
APPROVI	CTURER ED SECUREMENT		
	WELD		
	BID SET	GRAPHIC CHECK BE	C SCALES FORE USE
		IF SHEET IS LES	SS THAN 22"x34"
		IT IS A REDU	JCED PRINT. CORDINGLY
			DATE: MAY 2023
CTION	THE KENSICO REGIONA MOUNT PLEASAN	T, NEW YORK	SCALE: SHEET NO:
	CONTRACT		99 OF No. 121
	ARCHITEC CANOPY D		drawing no. A-551

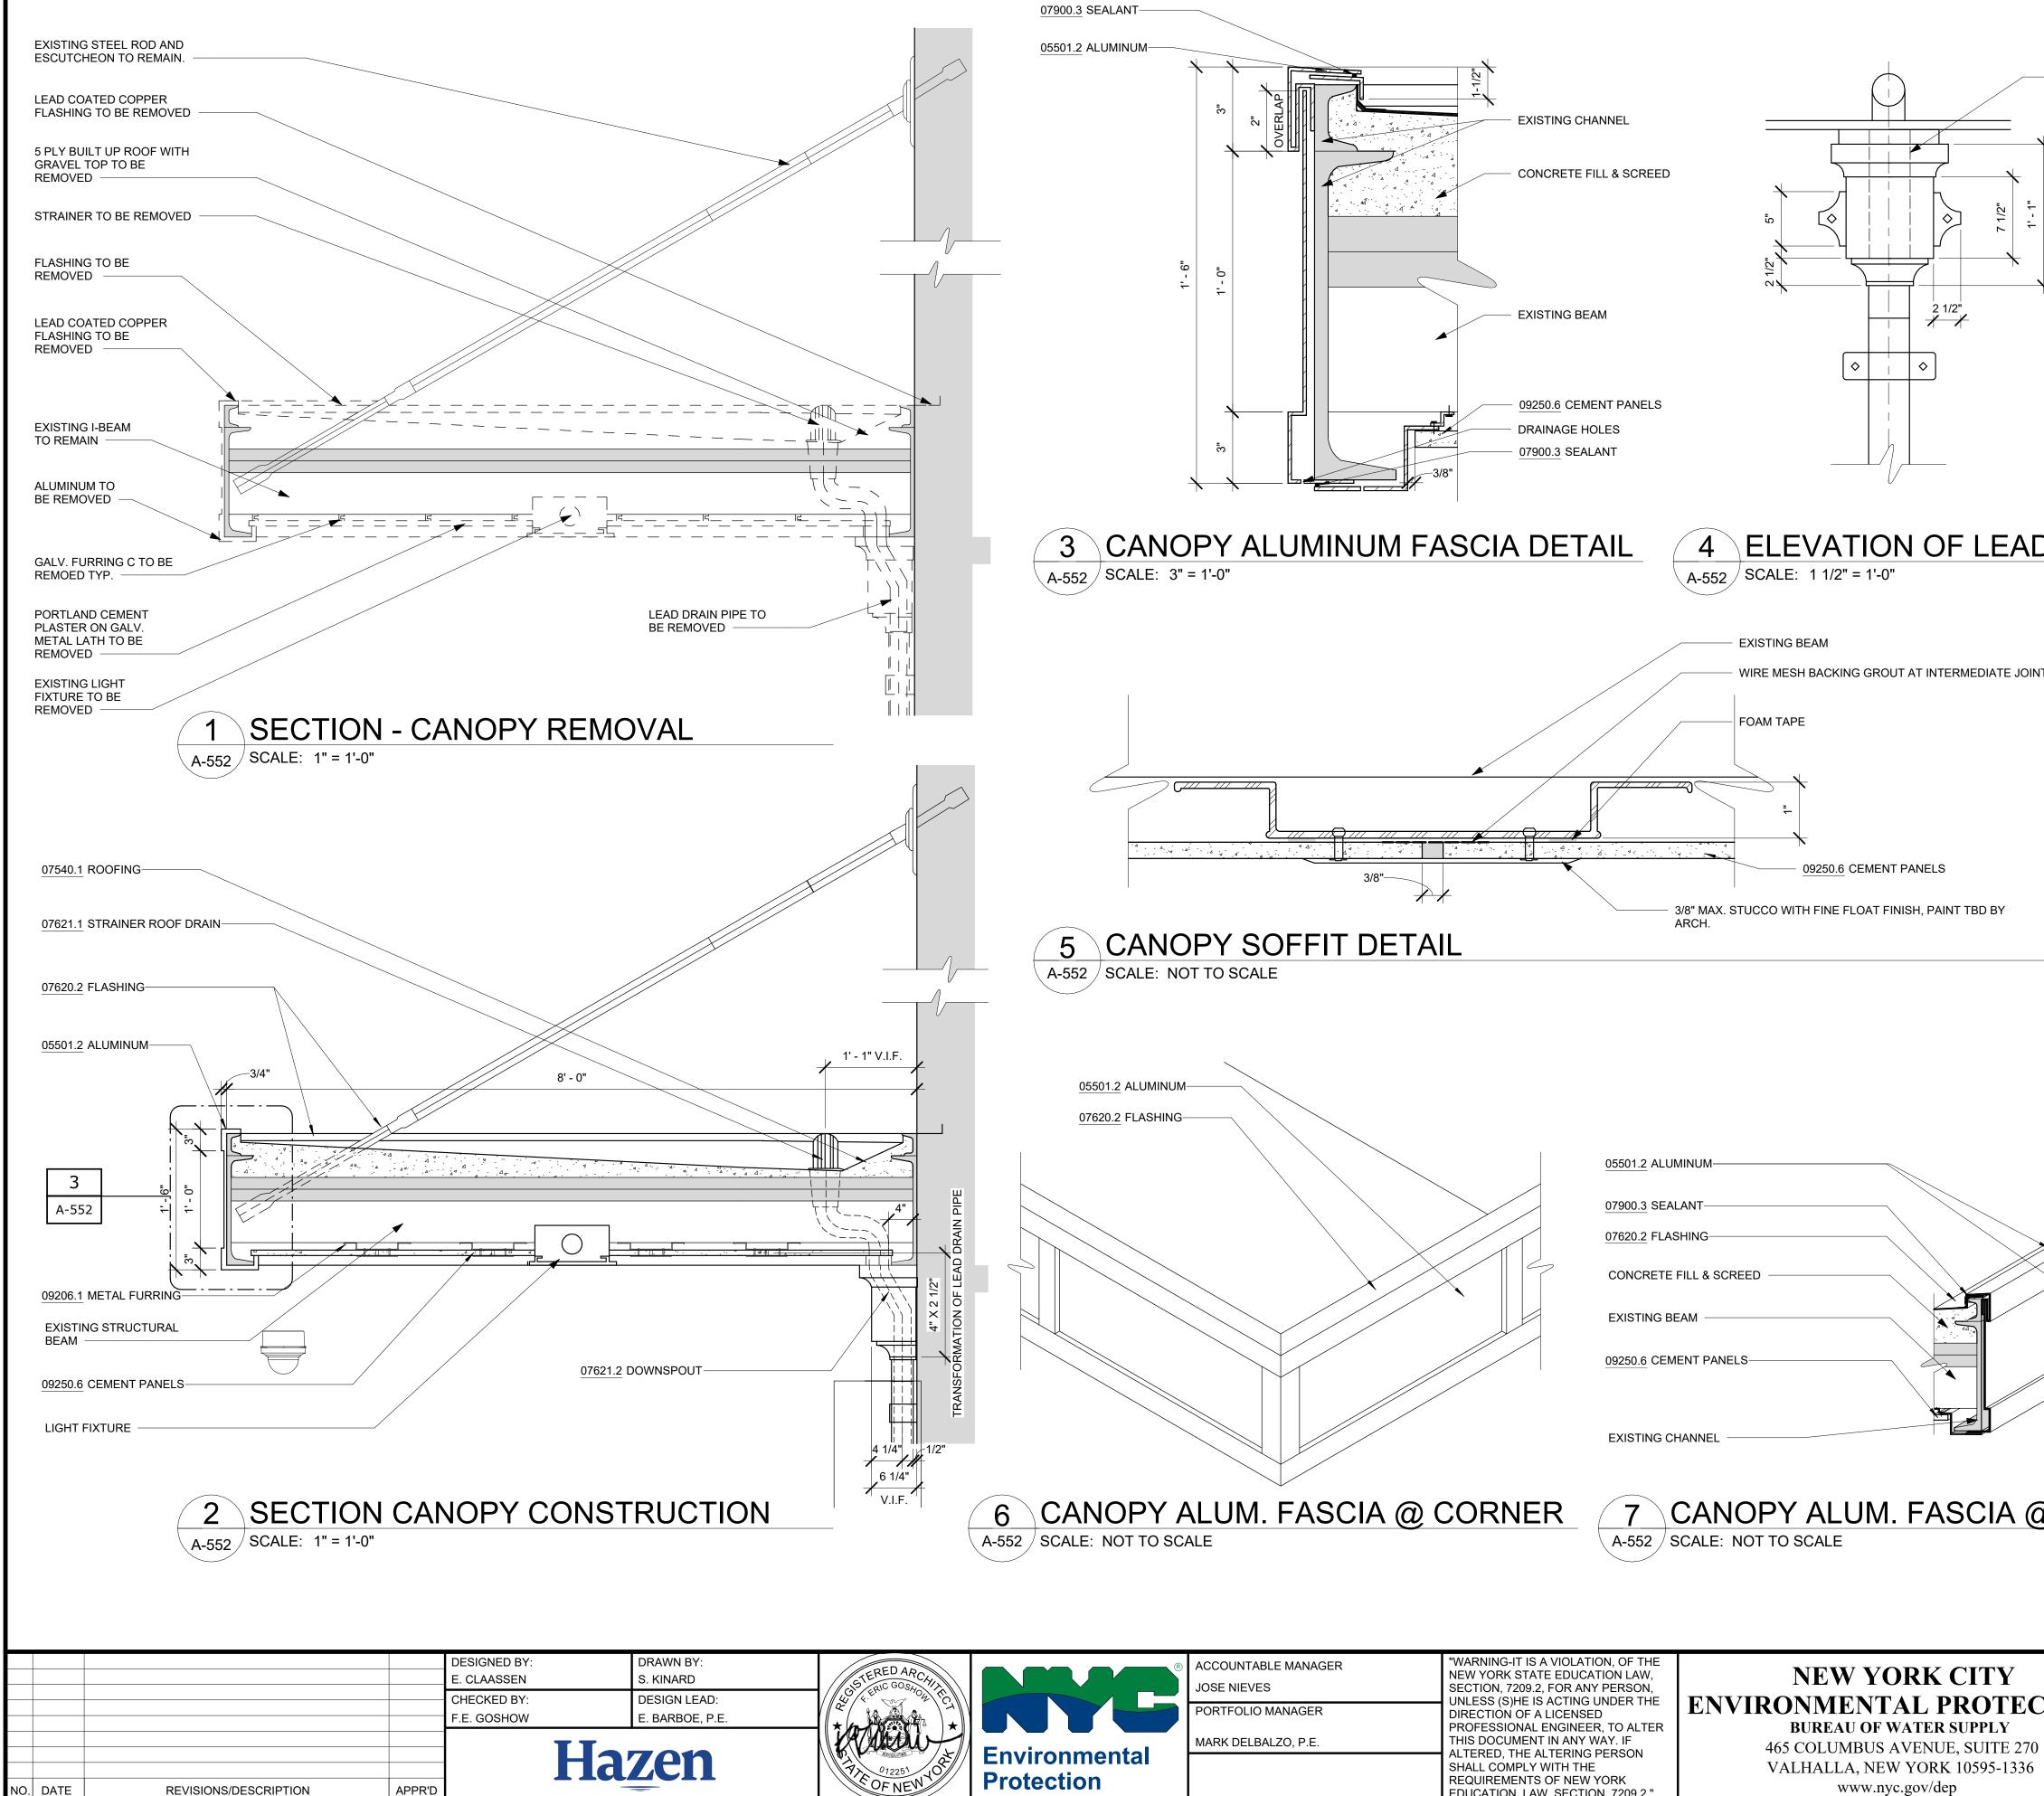

NO. DATE


All inquiries regarding this drawing(s) or project should be made to NYC Environmental Protection, Bureau of Water Supply.

APPR'D

**REVISIONS/DESCRIPTION** 

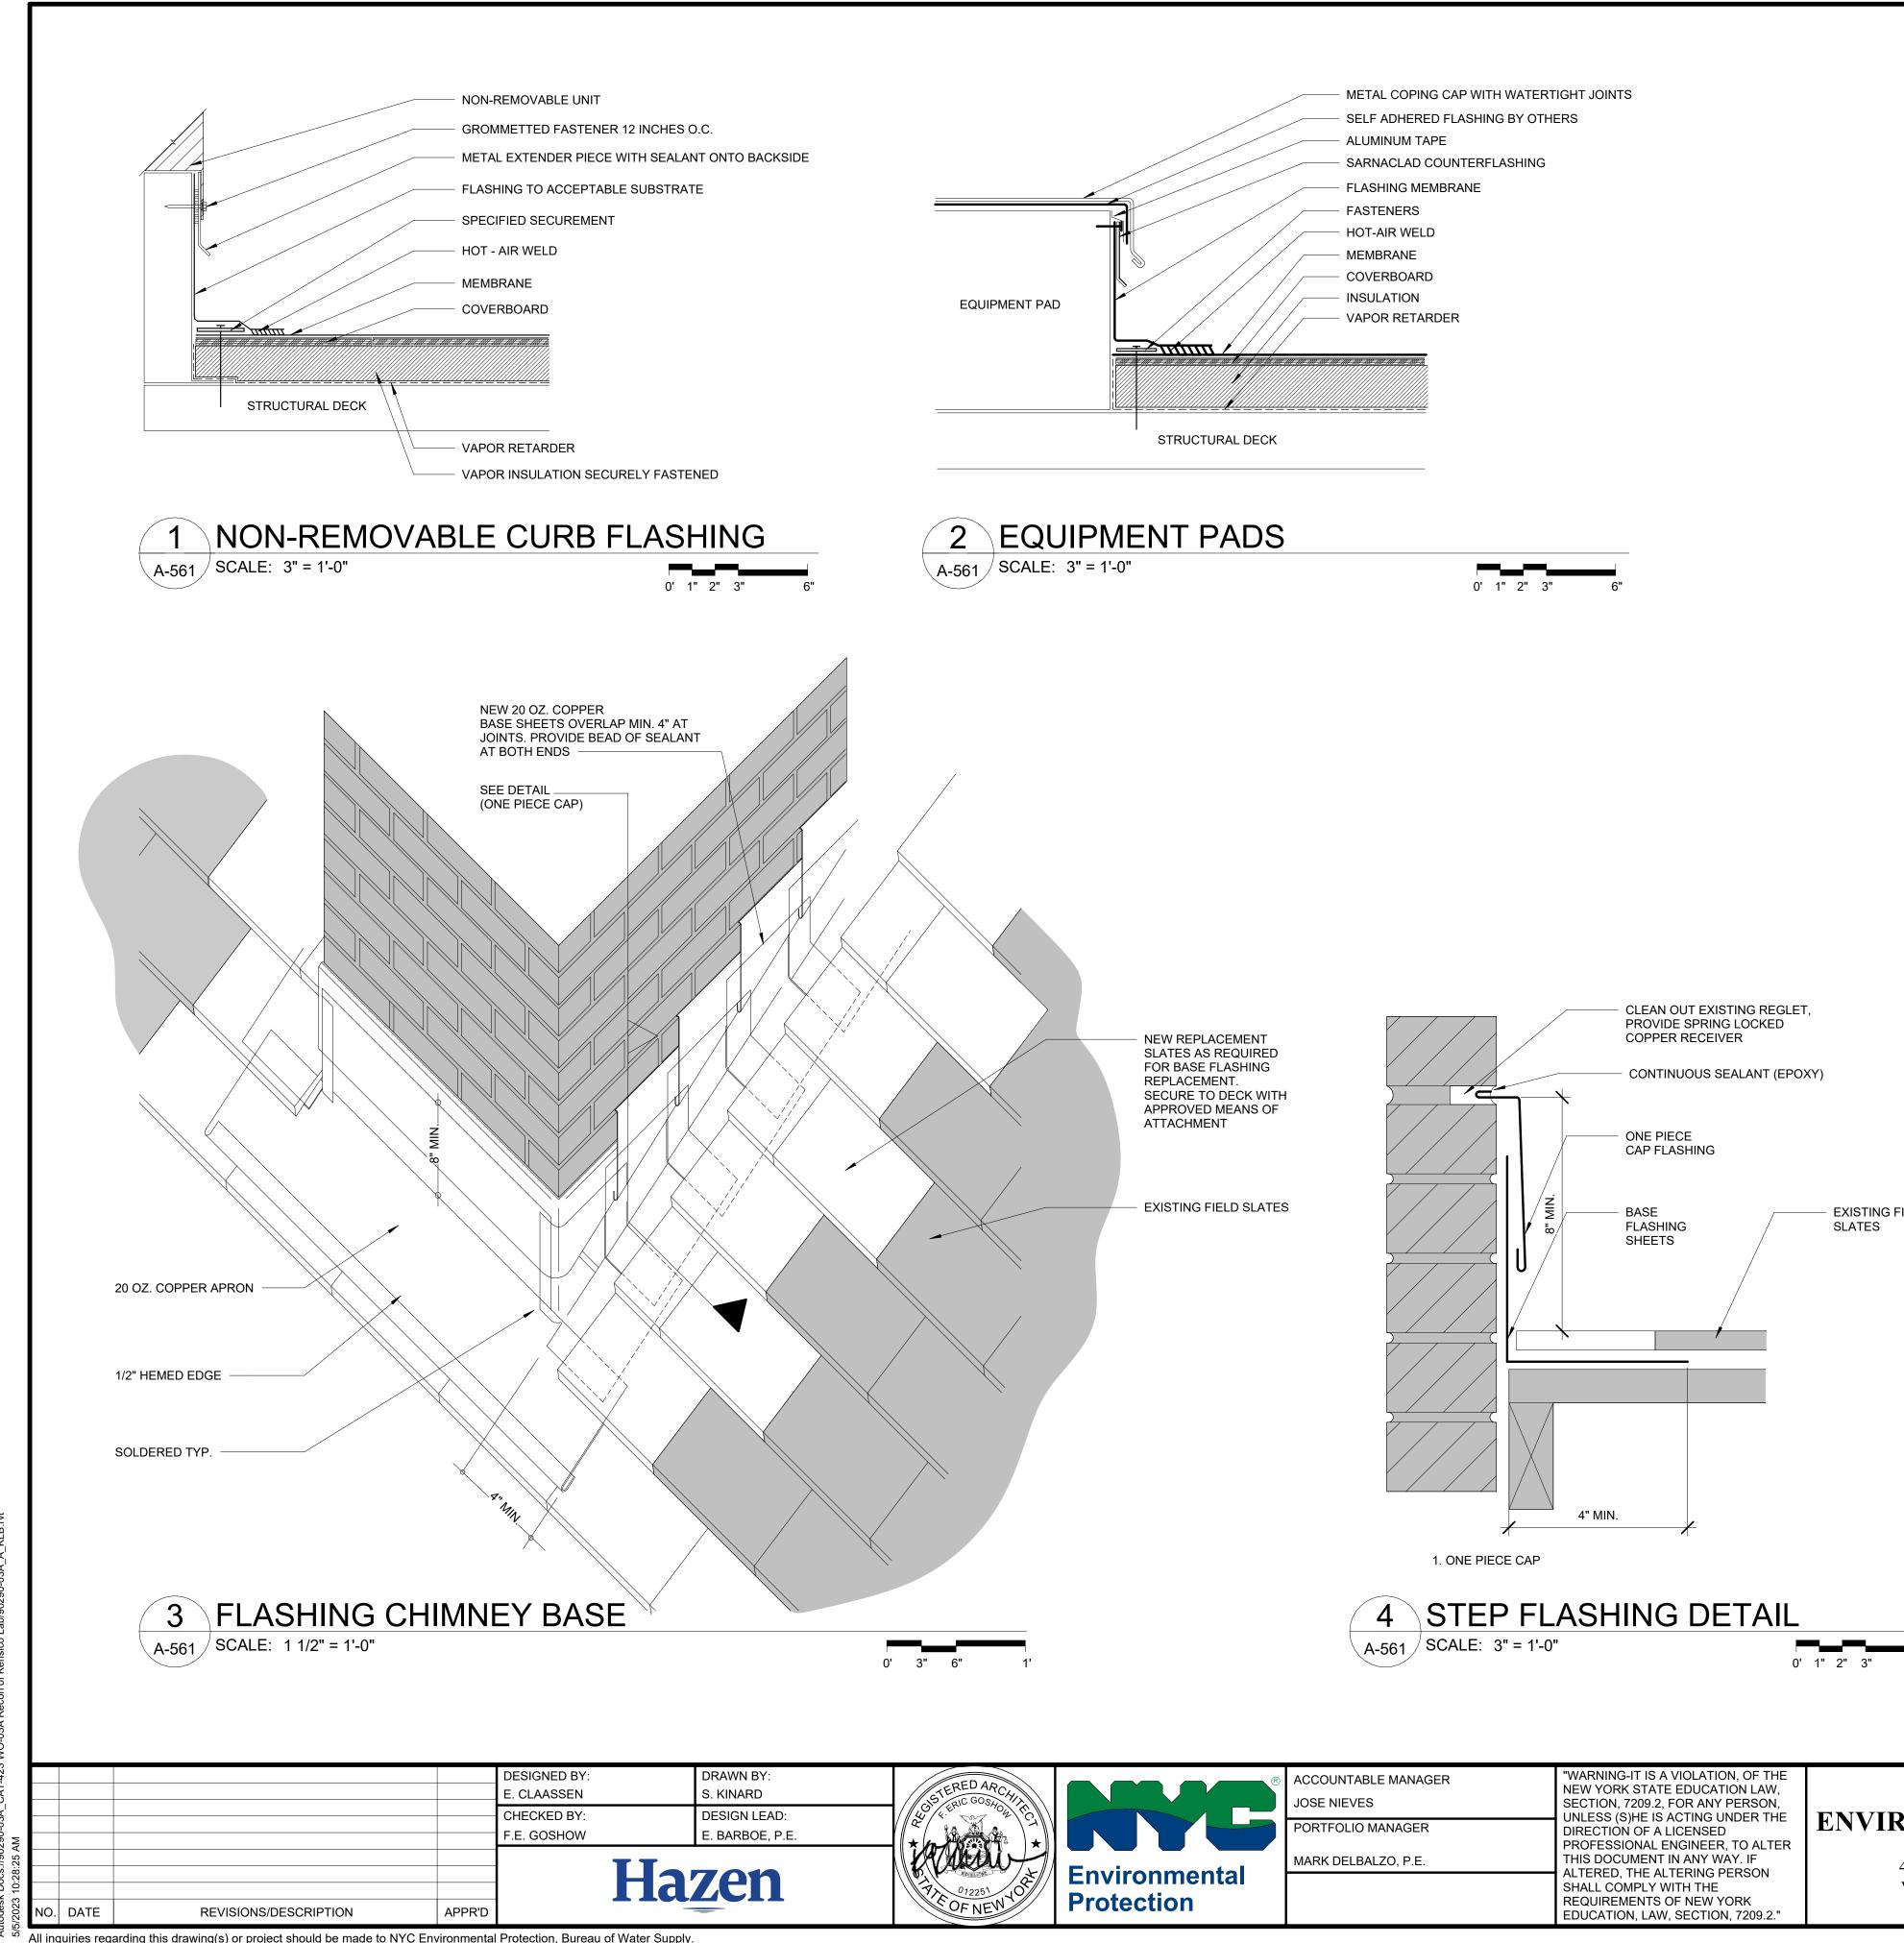REQUIREMENTS OF NEW YORK EDUCATION, LAW, SECTION, 7209.2." www.nyc.gov/dep

		NOTES - D	ETAILS	
3" ALUMINUM DRAIN PIPE	DIVISION 4 04120.1	BRICK MASONRY INFILL BEYOND	INFILL WALL WITH BRICI MATCH EXISTING	КТО
	04120.1 DIVISION 5 05400.2 05501.2 05501.3 DIVISION 7 07210.2 07540.1 07620.2 07621.1 07620.2 07621.1 07621.2 07900.1 07900.1 07900.2 07900.3 DIVISION 8 08361.1 08411.1 08521.1 08800.1 DIVISION 9 09206.3 09206.4 09206.5 09250.3 09250.4 09250.5		MATCH EXISTING 3 5/8" METAL STUD @ 16 TYP. 2 1/2" METAL STUD @ 16 TYP. CANOPY RECONSTRUC ZINC-ANNODIZED ALUM COMMERCIAL-GRADE A FOLDING STAIRWAY WI DROP-CEILING FRAME FOIL-FACED RECYCLED FIBER BATTS FOR INSUL AND VAPOR RETARDER 2" RIGID XPS INSULATIO PER INCH MIN. SINGLE-PLY THERMOPL (PVC) MEMBRANE ROOF STAINLESS STEEL SHEE FLASHING 4-1/2" DIAMETER CAST II CANOPY DRAIN WITH ST CUSTOM ZINC-ANNODIIZ ALUMINUM DOWNSPOU DESIGN TO MATCH ORIO LEAD-COATED COPPER DOWNSPOUT CONTINUOUS CAULKING BACKER ROD J TRIM W/ SEALANT, TYF INSULATED ALUMINUM SECTIONAL OVERHEAD WITH VISION LITES 1" INSULATED GLASS UI BIRD PROTECTION UV S COATING	S" O.C. TION INUM LUMINUM TH GLASS LATION ON, R-5 ASTIC FING ET RON IRAINER ZED T, GINAL G WITH DOOR NIT WITH STRIPE OR NS) D DESIGN CESSED DRTED BY O 2'-0" OR , TAPE
@ JOINTS	09511.1 09511.2 BID SE		SOFFIT PANELS 1 1/2" HIGH, 2'-0" OC GRAPHIC CHECK BEF IF SHEET IS LESS IT IS A REDUC SCALE ACCO	ORE USE S THAN 22"x34" CED PRINT. ORDINGLY
	E KENSICO MOUNT CO	OF THE KENSICO LA D REGIONAL HEADO OPLEASANT, NEW Y ONTRACT CRO-624	QUARTERS	DATE: MAY 2023 SCALE: SHEET NO: 100 OF No. 121 DRAWING NO.
36		ARCHITECTURAL CANOPY DETAILS		A-552




EXISTING FIELD

ACCOUNTABLE MANAGER
JOSE NIEVES
PORTFOLIO MANAGER
MARK DELBALZO, P.E.

**NEW YORK CITY ENVIRONMENTAL PROTEC BUREAU OF WATER SUPPLY** 465 COLUMBUS AVENUE, SUITE 270 VALHALLA, NEW YORK 10595-1336 www.nyc.gov/dep


	BID SET	GRAPHIC S CHECK BEFC	-		
		IF SHEET IS LESS T IT IS A REDUCE SCALE ACCOR			
	REPURPOSING OF THE KENSICC	DATE: MAY 2023			
	THE KENSICO REGIONAL HE	SCALE:			
TION	MOUNT PLEASANT, NE	SHEET NO:			
	CONTRACT CRO-	101 OF No. 121			
	ARCHITECTURA	DRAWING NO.			
	ROOFING DETAI	A-561			

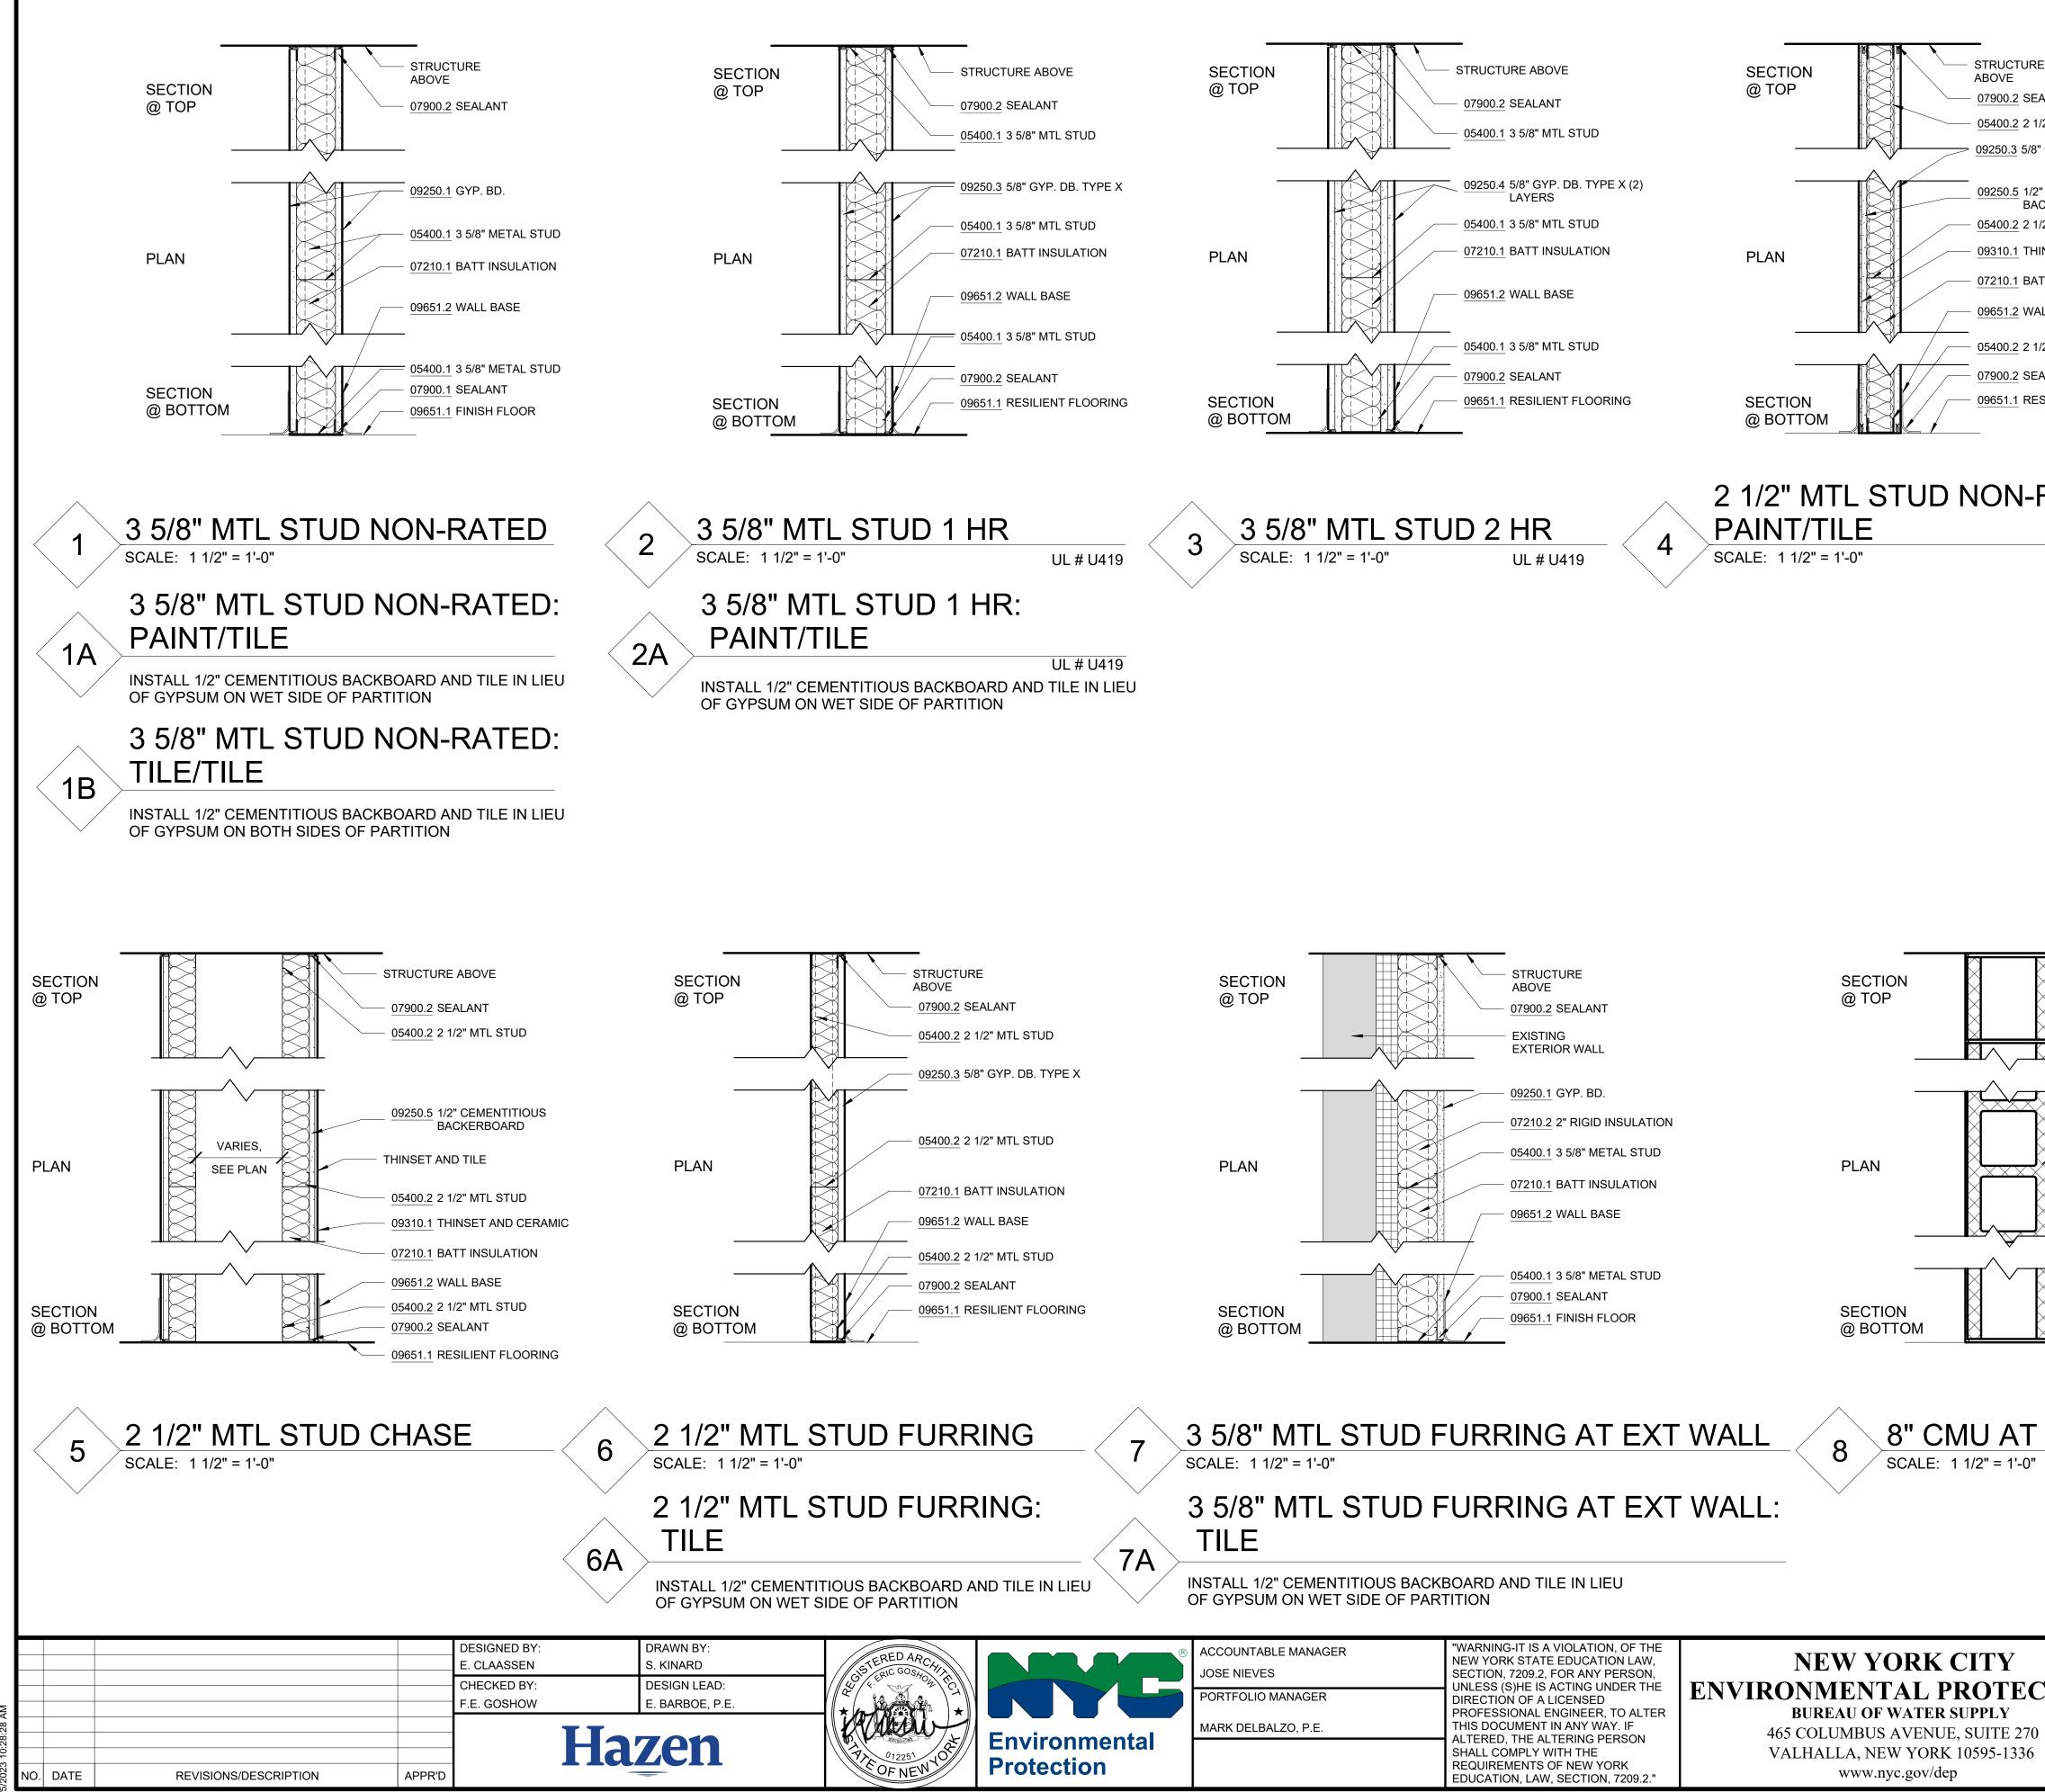


ss://90290-03A\_CAT-423 WO-03A Recon of Kensico Lab/90290-

			NOTES - DET	AILS	
_	DIVISION 4				
	04120.1	BRICK MASONRY INFILL BEYOND	INFILL W	ALL WITH BRICH	K TO MATCH EXISTING
EALANT 1/2" MTL STUD	DIVISION 5 05400.1	3 5/8" MTL STUD	2.5/9" ME	ETAL STUD @ 16	
" GYP. DB. TYPE X		2 1/2" METAL STUD ALUMINUM	2 1/2" ME	ETAL STUD @ 16	
2" CEMENTITIOUS ACKERBOARD	05501.3	ATTIC ACCESS HATCH	ALUMINU COMMEF	JM RCIAL-GRADE AI	LUMINUM FOLDING CEILING FRAME
1/2" MTL STUD	DIVISION 7 07210.1				
IINSET AND CERAMIC	07210.1	BATT INSULATION	INSULAT	ION AND VAPOR	GLASS FIBER BATTS FOR R RETARDER N, R-5 PER INCH MIN.
ALL BASE	07540.1	ROOFING	SINGLE-I ROOFING	PLY THERMOPL	ASTIC (PVC) MEMBRANE
1/2" MTL STUD	07620.2 07621.1	FLASHING STRAINER ROOF DRAIN	4-1/2" DI/		ET FLASHING RON CANOPY DRAIN WITH
EALANT	07621.2	DOWNSPOUT		I ZINC-ANNODIIZ	ZED ALUMINUM O MATCH ORIGINAL
ESILIENT FLOORING	07900.1 07900.2 07900.3	CAULKING SEALANT SEALANT	CONTINU	DATED COPPER JOUS CAULKING // SEALANT, TYF	G WITH BACKER ROD
	DIVISION 8				
RATED:	08361.1	OVERHEAD DOOR		ED ALUMINUM S ITH VISION LITE	SECTIONAL OVERHEAD
	08521.1	ALUM. FRAMES GLAZING	1" INSUL	ATED GLASS UN	NIT WITH BIRD
				TION UV STRIPE	
	DIVISION 9 09206.1 09206.2	METAL FURRING METAL FURRING CHANI CLIP	NEL		
	09206.3	1 1/2" STEEL RUNNING CHANNEL			
	09206.4	GAT CLIP	MEANS)		OR OTHER APPROVED
	09206.5	MAIN TEE	(THE RE	CESSED FIXTUR	D DESIGN AS APPROVED RE MAY BE SUPPORTED CED 2'-0" OR 4'-0" OC)
	09206.6 09250.1	<varies> 5/8" GYP. BD</varies>	<varies></varies>		
	09250.2 09250.3	J BEAD TRIM			, TAPE AND SPACKLE
	09250.4 09250.5	TRIM STEEL ROD		ORNER TRIM W/ GALV. STEEL R	/ SEALANT BED OD, NOT TO EXCEED 4'-0"
	09250.6 09511.1	CEMENT PANELS ACT CEILING		ERIOR CEMENT	BOARD SOFFIT PANELS
	09511.2	CROSS TEE	1 1/2" HIC	GH, 2'-0" OC	
					TIRE
ABOVE		SECTION @ TOP		ABOVE	
<u>×</u>				07900	. <u>1</u> SEALANT
				7/8" HAT	۲ CHANNEL
<u>04200.1</u> CN	ЛU				ONAMAL
		PLAN		<u> 09250.'</u>	1_ GYP. BD.
<u>09900.1</u> PA	AINT				
			-		
8			^\	09651.2	2 WALL BASE
× × × 00651.1 Fil	NISH FLOOR	SECTION		/	
			DM	09651.1	1 RESILIENT FLOORING
	/				
STAIR 1	<		AT CHA	<u> NNEL</u>	
U	L # U905	SCALE: 11	/2" = 1'-0"		
	Ň	~			
	BID SI	ET		GRAPHIC SO	
			IE -	SHEET IS LESS	
			IF ·	IT IS A REDUCE SCALE ACCOF	ED PRINT.
RI		OF THE KENSICO			DATE: MAY 2023
CTION	MOUN	O REGIONAL HE T PLEASANT, NE	W YORK	(5	SCALE: SHEET NO:
	C	CONTRACT CRO-6	-		102 OF No. 121
,		ARCHITECTURA PARTITION TYPE			drawing no. <b>A-601</b>

									DOOR	SCHEDULE							
DOOR	ROOM					DOOR				FRAME		FIRE	HARDWARE		DETAIL		
NUMBER	NUMBER	ROOM NAME	TYPE	TYPE	WIDTH	HEIGHT	FINISH	GLAZING TYPE	TYPE	MATERIAL	FINISH	RATING	SET	HEAD	JAMB	THRESHOLD	COMMENTS
		1			1										1		
100B	100	VESTIBULE		ALUM/ GLASS		7' - 4"	CLEAR	1" INSULATED	WELD		PAINT	1 HR		2/ A1-127	2/ A1-127		
102	102	CONFERENCE ROOM	С	ALUM/ GLASS	3' - 0"	7' - 4"	CLEAR	1" INSULATED	WELD	STL	PAINT	-		2/ A1-127	2/ A1-127		
103A	103	CI2 MAINTENANCE AREA		HM		6' - 8"	PAINT		WELD	STL	PAINT	-		2/ A-611	2/ A-611		
103B	103	CI2 MAINTENANCE AREA	F	ALUM/ GLASS	5' - 0"	6' - 8"	CLEAR	1" INSULATED	-	ALUM	CLEAR	-		2/ A1-127	2/ A1-127		
105	105	TOS OFFICE	С	ALUM/ GLASS	3' - 0"	7' - 4"	CLEAR	1" INSULATED	WELD	STL	PAINT	-		2/ A1-127	2/ A1-127		
106A	1C02	CORRIDOR	D	ALUM/ GLASS	5' - 0"	7' - 4"	CLEAR	<b>1" INSULATED</b>	-	ALUM	CLEAR						
107	107	WOMEN'S RESTROOM/LOCKERS	A	HM	3' - 0"	7' - 4"	PAINT		WELD	STL	PAINT	-		2/ A-611	2/ A-611		
108	108	CL	В	HM	3' - 0"	6' - 8"	PAINT		WELD	STL	PAINT	-		2/ A-611	2/ A-611		
109	109	MEN'S RESTROOM/LOCKERS	A	HM	3' - 0"	7' - 4"	PAINT		WELD	STL	PAINT			2/ A-611	2/ A-611		
110A	110	TOS WORK AREA	A	HM	3' - 0"	7' - 4"	PAINT		WELD	STL	PAINT	-		2/ A-611	2/ A-611		
110C	110	TOS WORK AREA	Н	ALUM/ GLASS	0' - 0"	0' - 0"	CLEAR	1" INSULATED	-	ALUM	CLEAR	-				SEE O	VERHEAD DOOR DETAILS O
111	111	ELEC CLOSET	A	HM	3' - 0"	7' - 4"	PAINT		WELD	STL	PAINT	1 HR		2/ A-611	2/ A-611		
200	200	STAIR	A	HM	3' - 0"	7' - 4"	PAINT		WELD	STL	PAINT	1 HR		2/ A-611	2/ A-611		
201	201	CHIEF OFFICE	A	HM	3' - 0"	6' - 8"	PAINT		WELD	STL	PAINT	-		2/ A-611	2/ A-611		
202	202	JAN CLOSET	A	HM	3' - 0"	6' - 8"	PAINT		WELD	STL	PAINT	-		2/ A-611	2/ A-611		
203	2C01	CORRIDOR	A	HM	3' - 0"	6' - 8"	PAINT		WELD	STL	PAINT	-		2/ A-611	2/ A-611		
204	204	ELEC CLOSET	A	НМ	3' - 0"	6' - 8"	PAINT		WELD	STL	PAINT	1 HR		2/ A-611	2/ A-611		
205	205	CONFERENCE ROOM	A	НМ	3' - 0"	6' - 8"	PAINT		WELD	STL	PAINT			2/ A-611	2/ A-611		
207	207	L3 OFFICE	A	НМ	3' - 0"	6' - 8"	PAINT		WELD	STL	PAINT	-		2/ A-611	2/ A-611		
208	208	L2 OFFICE	A	НМ	3' - 0"	6' - 8"	PAINT		WELD	STL	PAINT	-		2/ A-611	2/ A-611		
209	209	ADMIN SUPPORT OFFICE	A	НМ	3' - 0"	6' - 8"	PAINT		WELD	STL	PAINT	-		2/ A-611	2/ A-611		
210	210	DEPUTY DIRECTOR OFFICE		НМ		6' - 8"	PAINT			STL	PAINT	-		2/ A-611	2/ A-611		
211	108	CL	В			6' - 8"	PAINT			STL	PAINT	-		2/ A-611	2/ A-611		
B02			A			7' - 0"	PAINT		WELD	STL	PAINT	-		2/ A-611	2/ A-611		
B03						7' - 0"	PAINT		WELD	STL	PAINT	-		2/ A-611	2/ A-611		
SF01	100	VESTIBULE		ALUM/ GLASS		7' - 0"	CLEAR	1" INSULATED	-	ALUM	CLEAR					SEE ST	FOREFRONT DETAILS
SF02	1C02	CORRIDOR		ALUM/ GLASS		7' - 0"	CLEAR	1" INSULATED	-	ALUM	CLEAR						
SF04	110	TOS WORK AREA		ALUM/ GLASS			CLEAR	1" INSULATED	-	ALUM	CLEAR						OREFRONT DETAILS

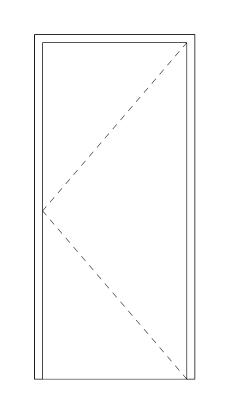


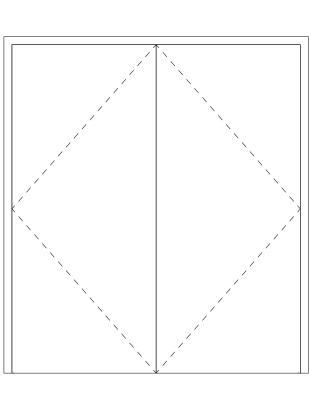

**B** HOLLOW METAL DOOR

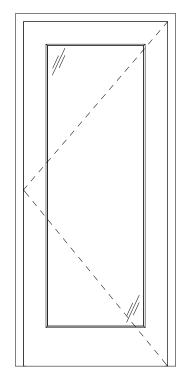A HOLLOW METAL DOOR







**C** 


				DESIGNED BY: E. CLAASSEN		RAWN BY: . KINARD	TERED ARCC	R R	ACCOUNTABLE MANAGER
				CHECKED BY:		ESIGN LEAD:	GIS ERIC GOSHOLI IT		JOSE NIEVES
				F.E. GOSHOW		. BARBOE, P.E.	2 A		PORTFOLIO MANAGER
8:30 AN					<b>!</b>		to and the	Environmentel	MARK DELBALZO, P.E.
2023 10:28 Z	O. DATE	REVISIONS/DESCRIPTION	APPR'D	-	Haz	<i>i</i> en	Prevent of the off off off off off off off off off of	Environmental Protection	
12									

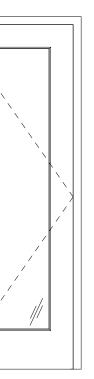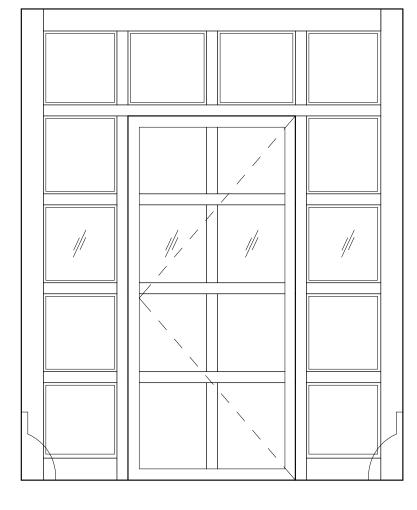All inquiries regarding this drawing(s) or project should be made to NYC Environmental Protection, Bureau of Water Supply.






**E** ALUMINUM STOREFRONT DOOR

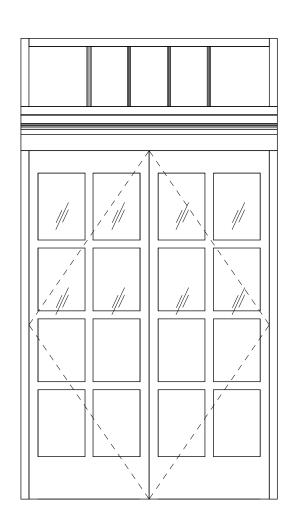


(**F**) ALUMINUM STOREFRONT DOOR

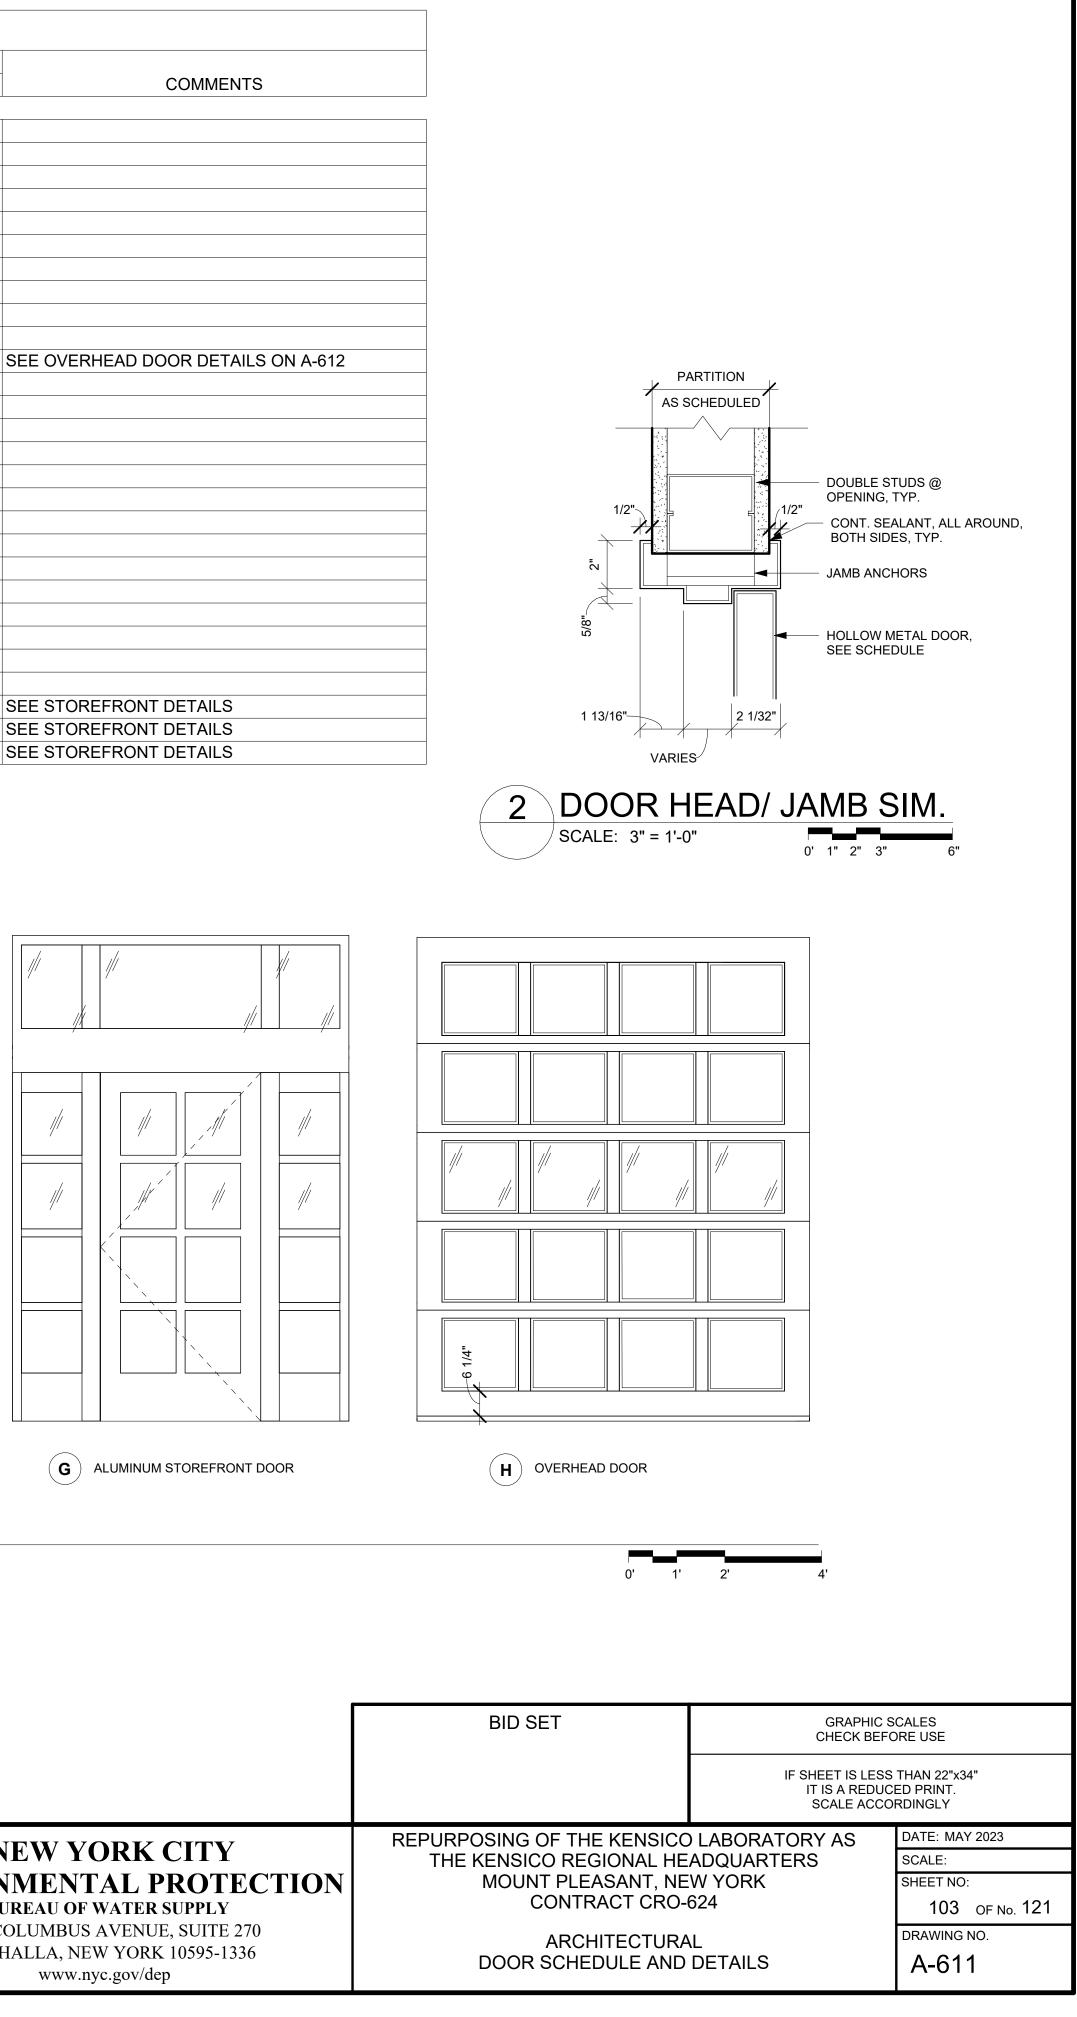

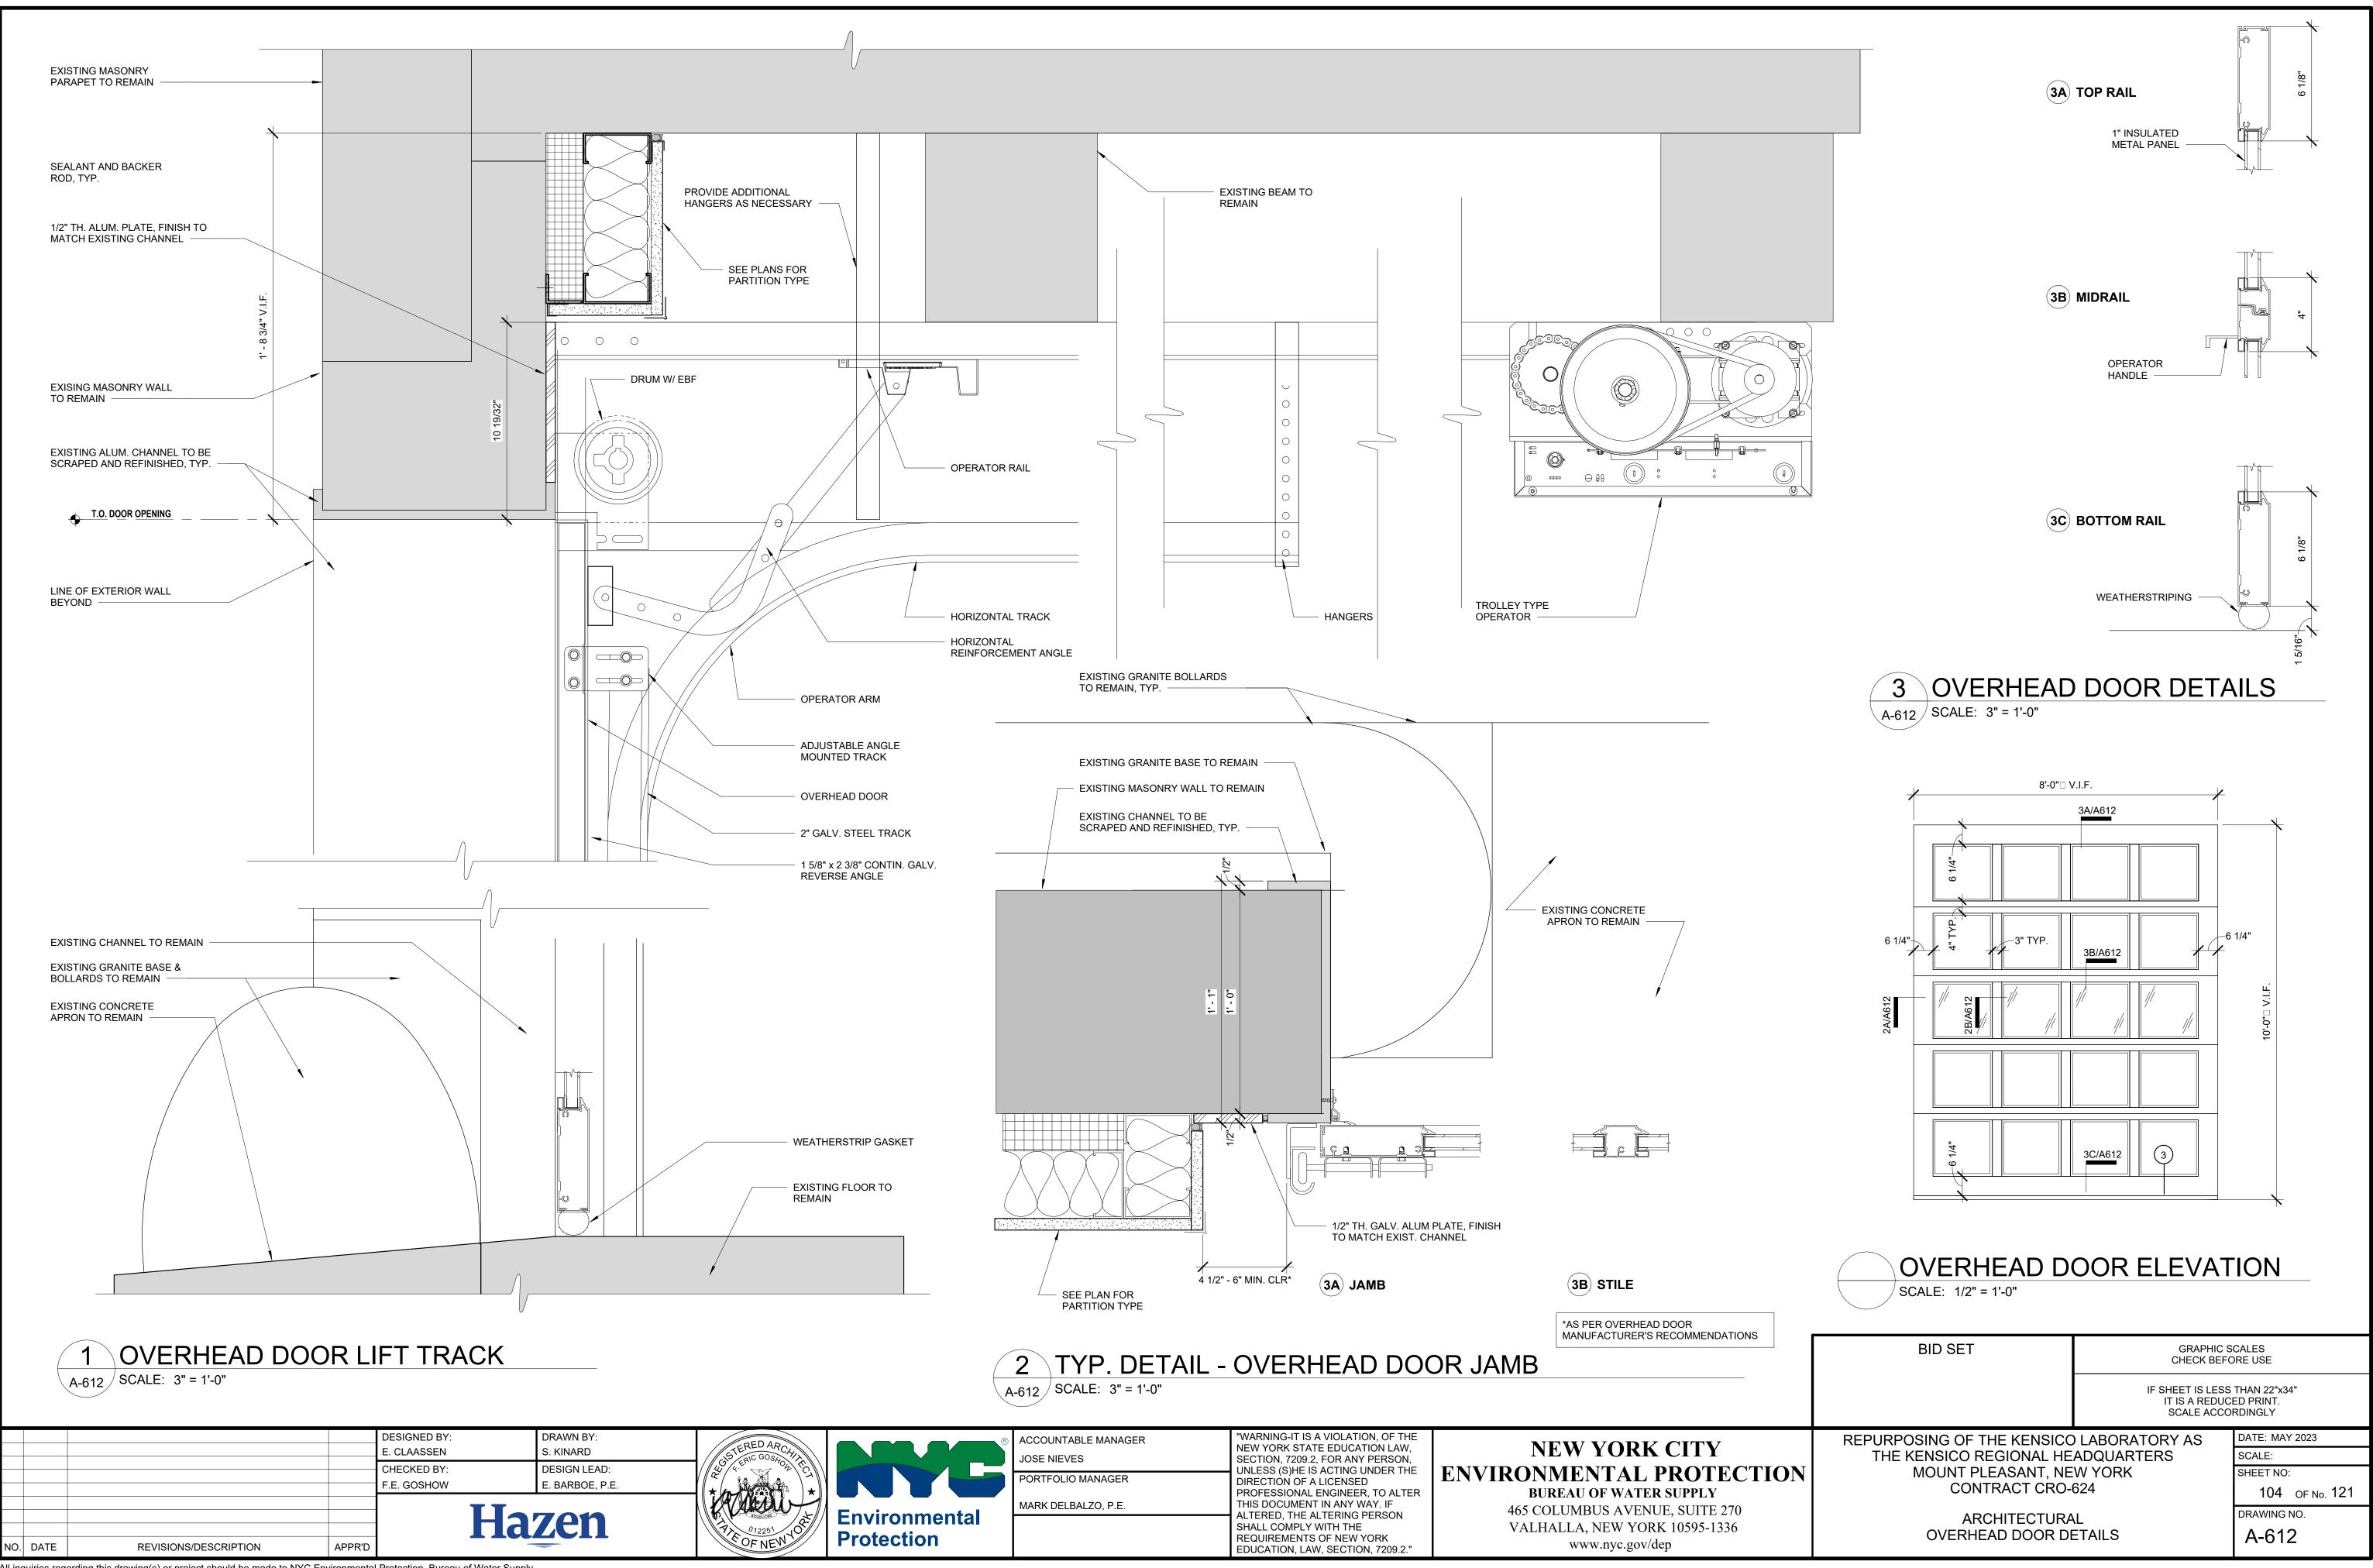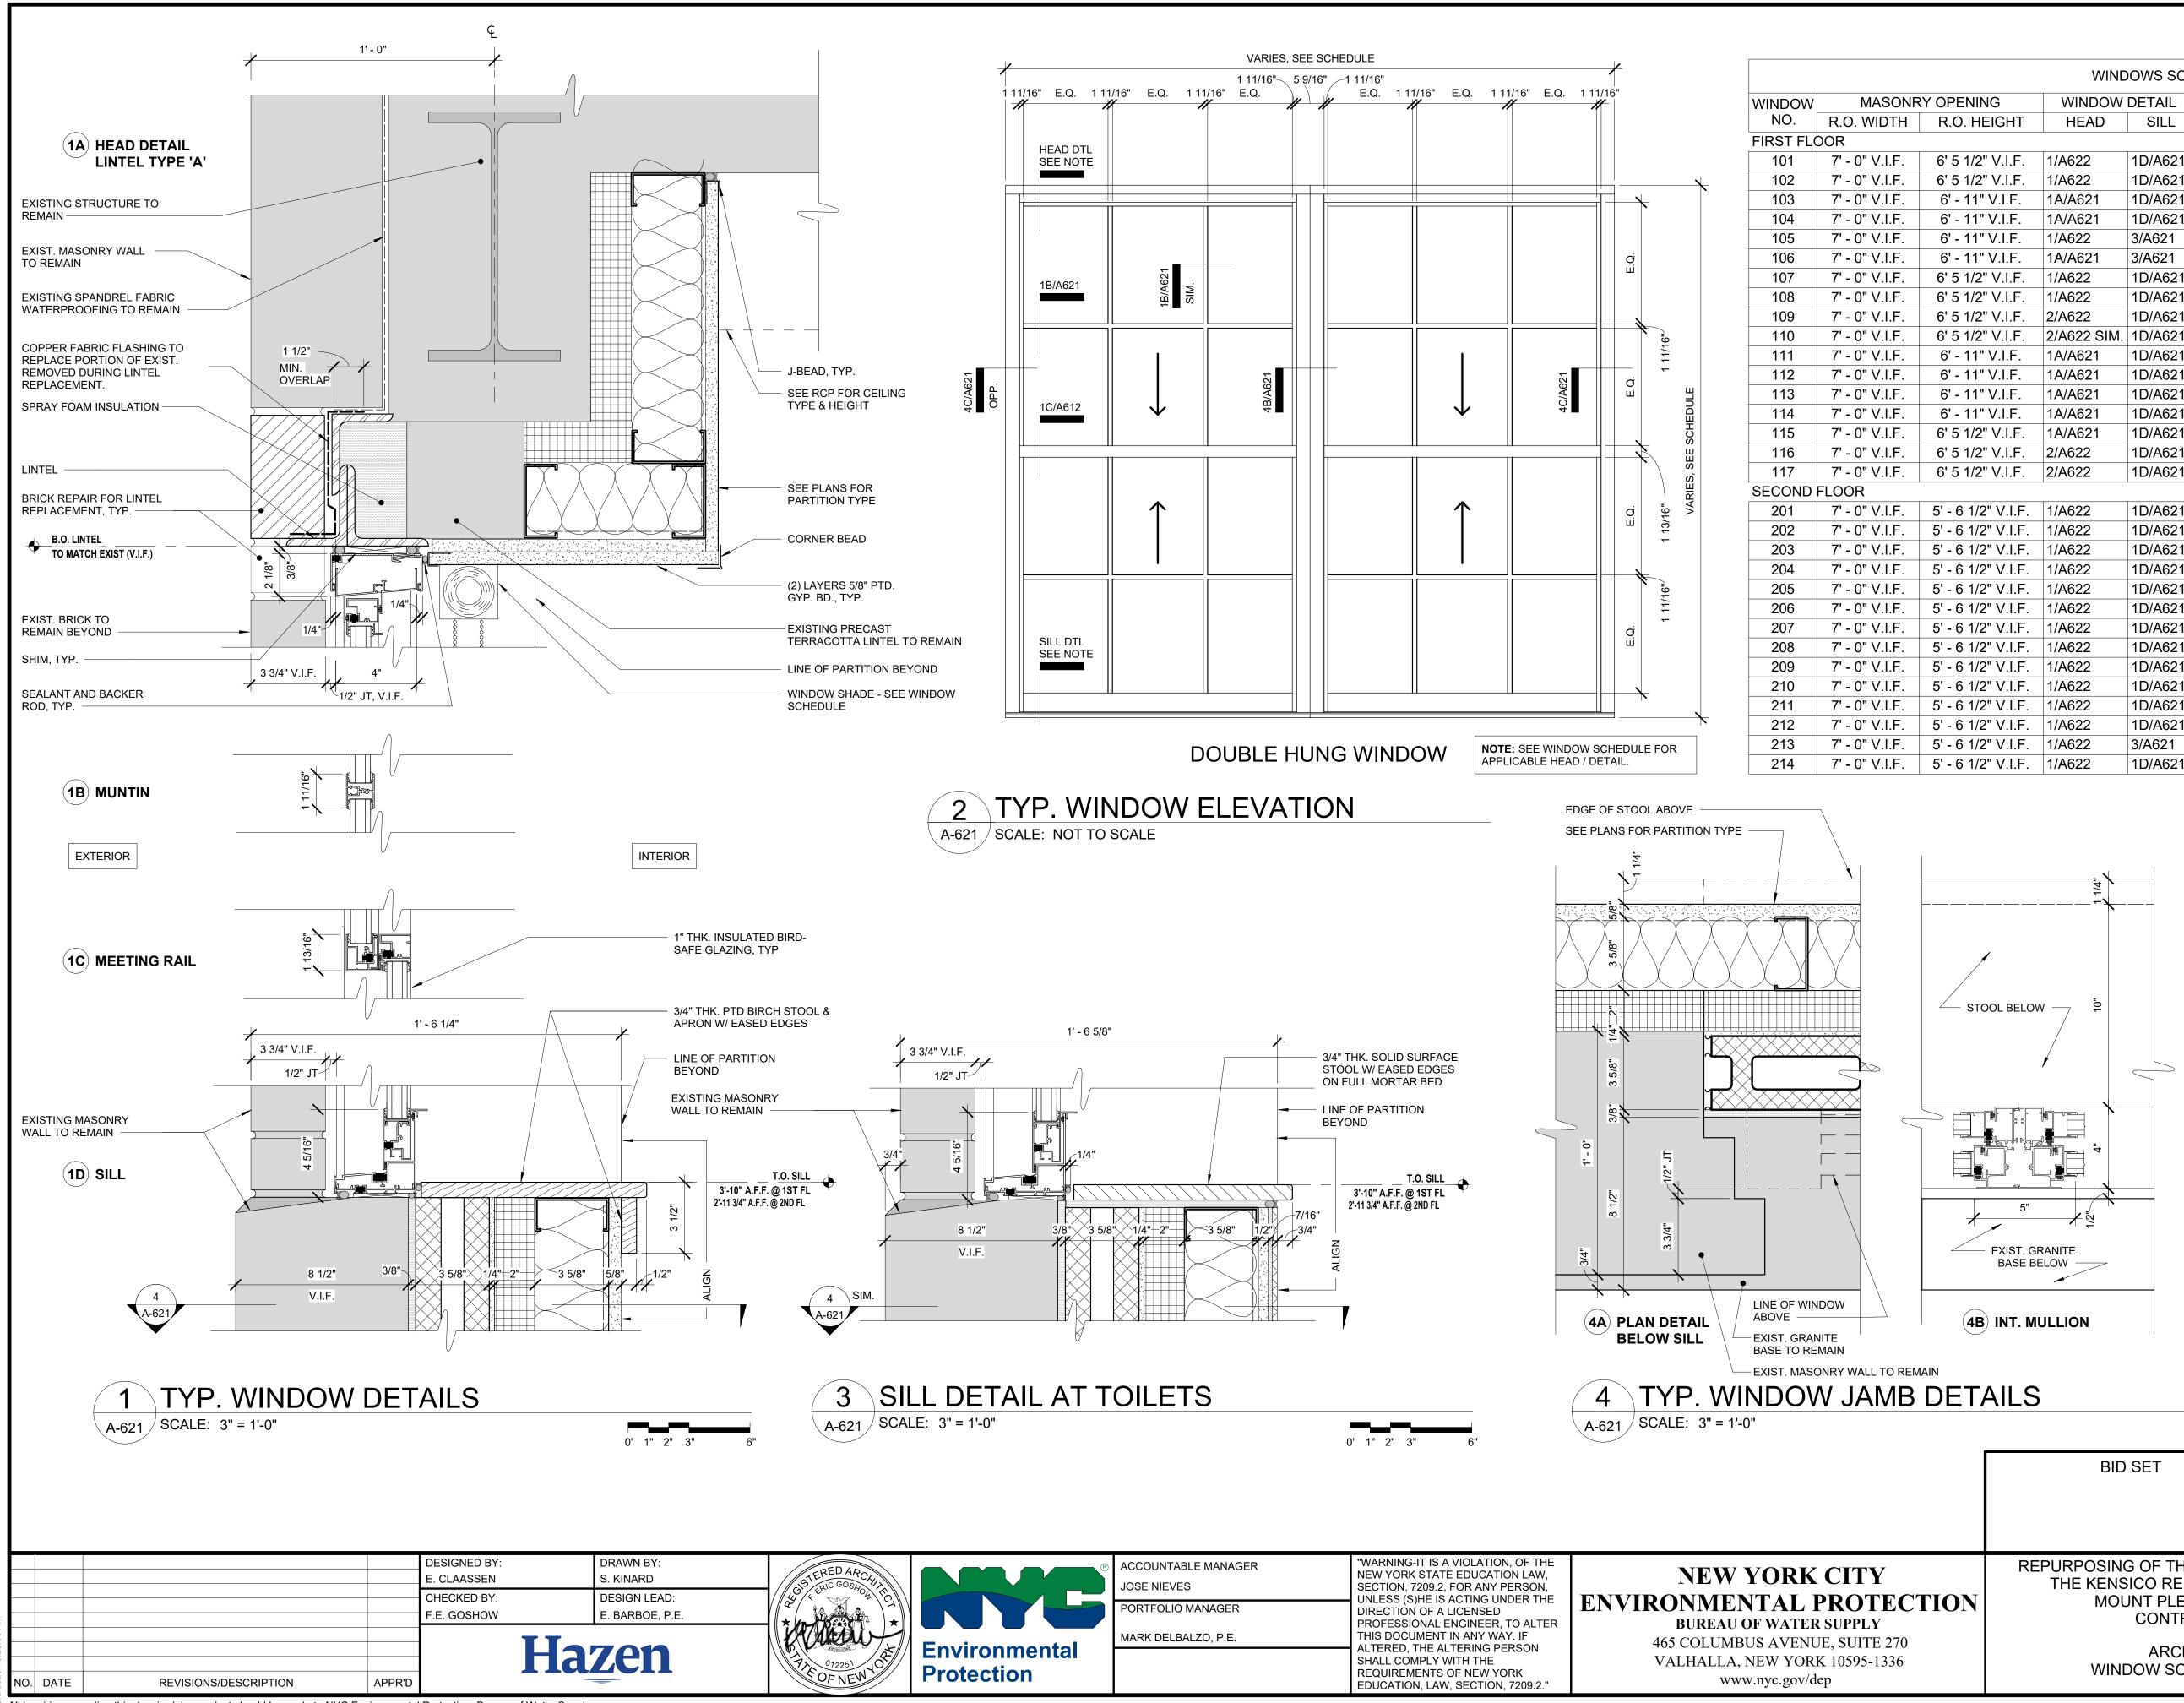
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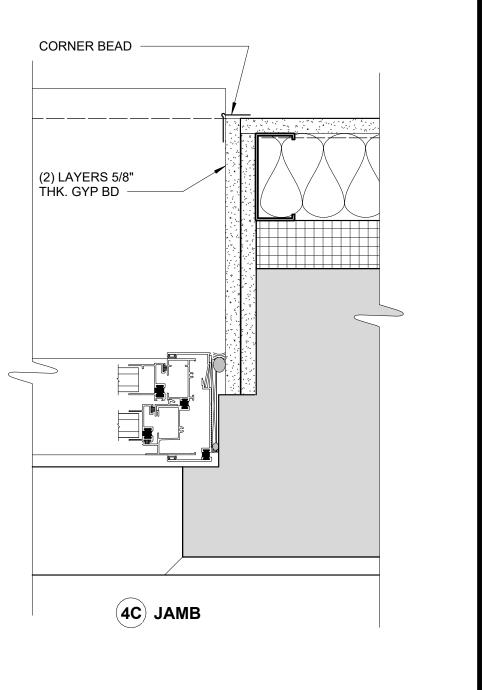
**NEW YORK CITY ENVIRONMENTAL PROTECTION** BUREAU OF WATER SUPPLY 465 COLUMBUS AVENUE, SUITE 270 VALHALLA, NEW YORK 10595-1336




ssk Docs://90290-03A\_CAT-423 WO-03A Recon of Kensico Lab/90290-03A\_A\_KLB.




		WIND	OWS SCH	EDULE			
IR'	Y OPENING	WINDOW	DETAIL		SHADE	INSECT	
	R.O. HEIGHT	HEAD	SILL	GLAZING	SHADE	SCREEN	REMARKS
	6' 5 1/2" V.I.F.	1/A622	1D/A621	Clear	Y	Y	
	6' 5 1/2" V.I.F.	1/A622	1D/A621	Clear	Y	Y	
	6' - 11" V.I.F.	1A/A621	1D/A621	Glass	Y	Y	
	6' - 11" V.I.F.	1A/A621	1D/A621	Glass	N	Y	
	6' - 11" V.I.F.	1/A622	3/A621	Frosted	N	Y	
	6' - 11" V.I.F.	1A/A621	3/A621	Frosted	N	Y	
T	6' 5 1/2" V.I.F.	1/A622	1D/A621	Clear	Y	Y	
T	6' 5 1/2" V.I.F.	1/A622	1D/A621	Clear	Y	Y	
T	6' 5 1/2" V.I.F.	2/A622	1D/A621	Clear	Y	Y	
	6' 5 1/2" V.I.F.	2/A622 SIM.	1D/A621	Clear	Y	Y	
	6' - 11" V.I.F.	1A/A621	1D/A621	Glass	Y	Y	
+	6' - 11" V.I.F.	1A/A621	1D/A621	Glass	Y	Y	
T	6' - 11" V.I.F.	1A/A621	1D/A621	Glass	Y	Y	
	6' - 11" V.I.F.	1A/A621	1D/A621	Glass	Y	Y	
	6' 5 1/2" V.I.F.	1A/A621	1D/A621	Clear	Y	Y	
	6' 5 1/2" V.I.F.	2/A622	1D/A621	Clear	Y	Y	
	6' 5 1/2" V.I.F.	2/A622	1D/A621	Clear	Y	Y	
	5' - 6 1/2" V.I.F.	1/A622	1D/A621	Glass - Storefront	Y	Y	
	5' - 6 1/2" V.I.F.	1/A622	1D/A621	Glass - Storefront	Y	Y	
	5' - 6 1/2" V.I.F.	1/A622	1D/A621	Glass - Storefront	N	Y	
	5' - 6 1/2" V.I.F.	1/A622	1D/A621	Glass - Storefront	Y	Y	
	5' - 6 1/2" V.I.F.	1/A622	1D/A621	Glass - Storefront	Y	Y	
	5' - 6 1/2" V.I.F.	1/A622	1D/A621	Glass - Storefront	Y	Y	
1	5' - 6 1/2" V.I.F.	1/A622	1D/A621	Glass - Storefront	Y	Y	
Ť	5' - 6 1/2" V.I.F.	1/A622	1D/A621	Glass - Storefront	Y	Y	
Ť	5' - 6 1/2" V.I.F.	1/A622	1D/A621	Glass - Storefront	Y	Y	
1	5' - 6 1/2" V.I.F.	1/A622	1D/A621	Glass - Storefront	Y	Y	
1	5' - 6 1/2" V.I.F.	1/A622	1D/A621	Glass - Storefront	Y	Y	
+	5' - 6 1/2" V.I.F.	1/A622	1D/A621	Glass - Storefront	Y	Y	
+	5' - 6 1/2" V.I.F.	1/A622	3/A621	Frosted	N	Y	
T	5' - 6 1/2" V.I.F.	1/A622	1D/A621	Glass - Storefront	Y	Y	



		0' 1" 2" 3"	6"			
	BID SET	BID SET GRAPHIC S CHECK BEFC				
		IF SHEET IS LESS IT IS A REDUC SCALE ACCO	CED PRINT.			
C <b>TION</b>	REPURPOSING OF THE KENSICO THE KENSICO REGIONAL HE MOUNT PLEASANT, NE CONTRACT CRO- ARCHITECTURA WINDOW SCHEDULE &	ADQUARTERS W YORK 624 AL	DATE: MAY 2023 SCALE: SHEET NO: 105 OF No. 121 DRAWING NO. A-621			

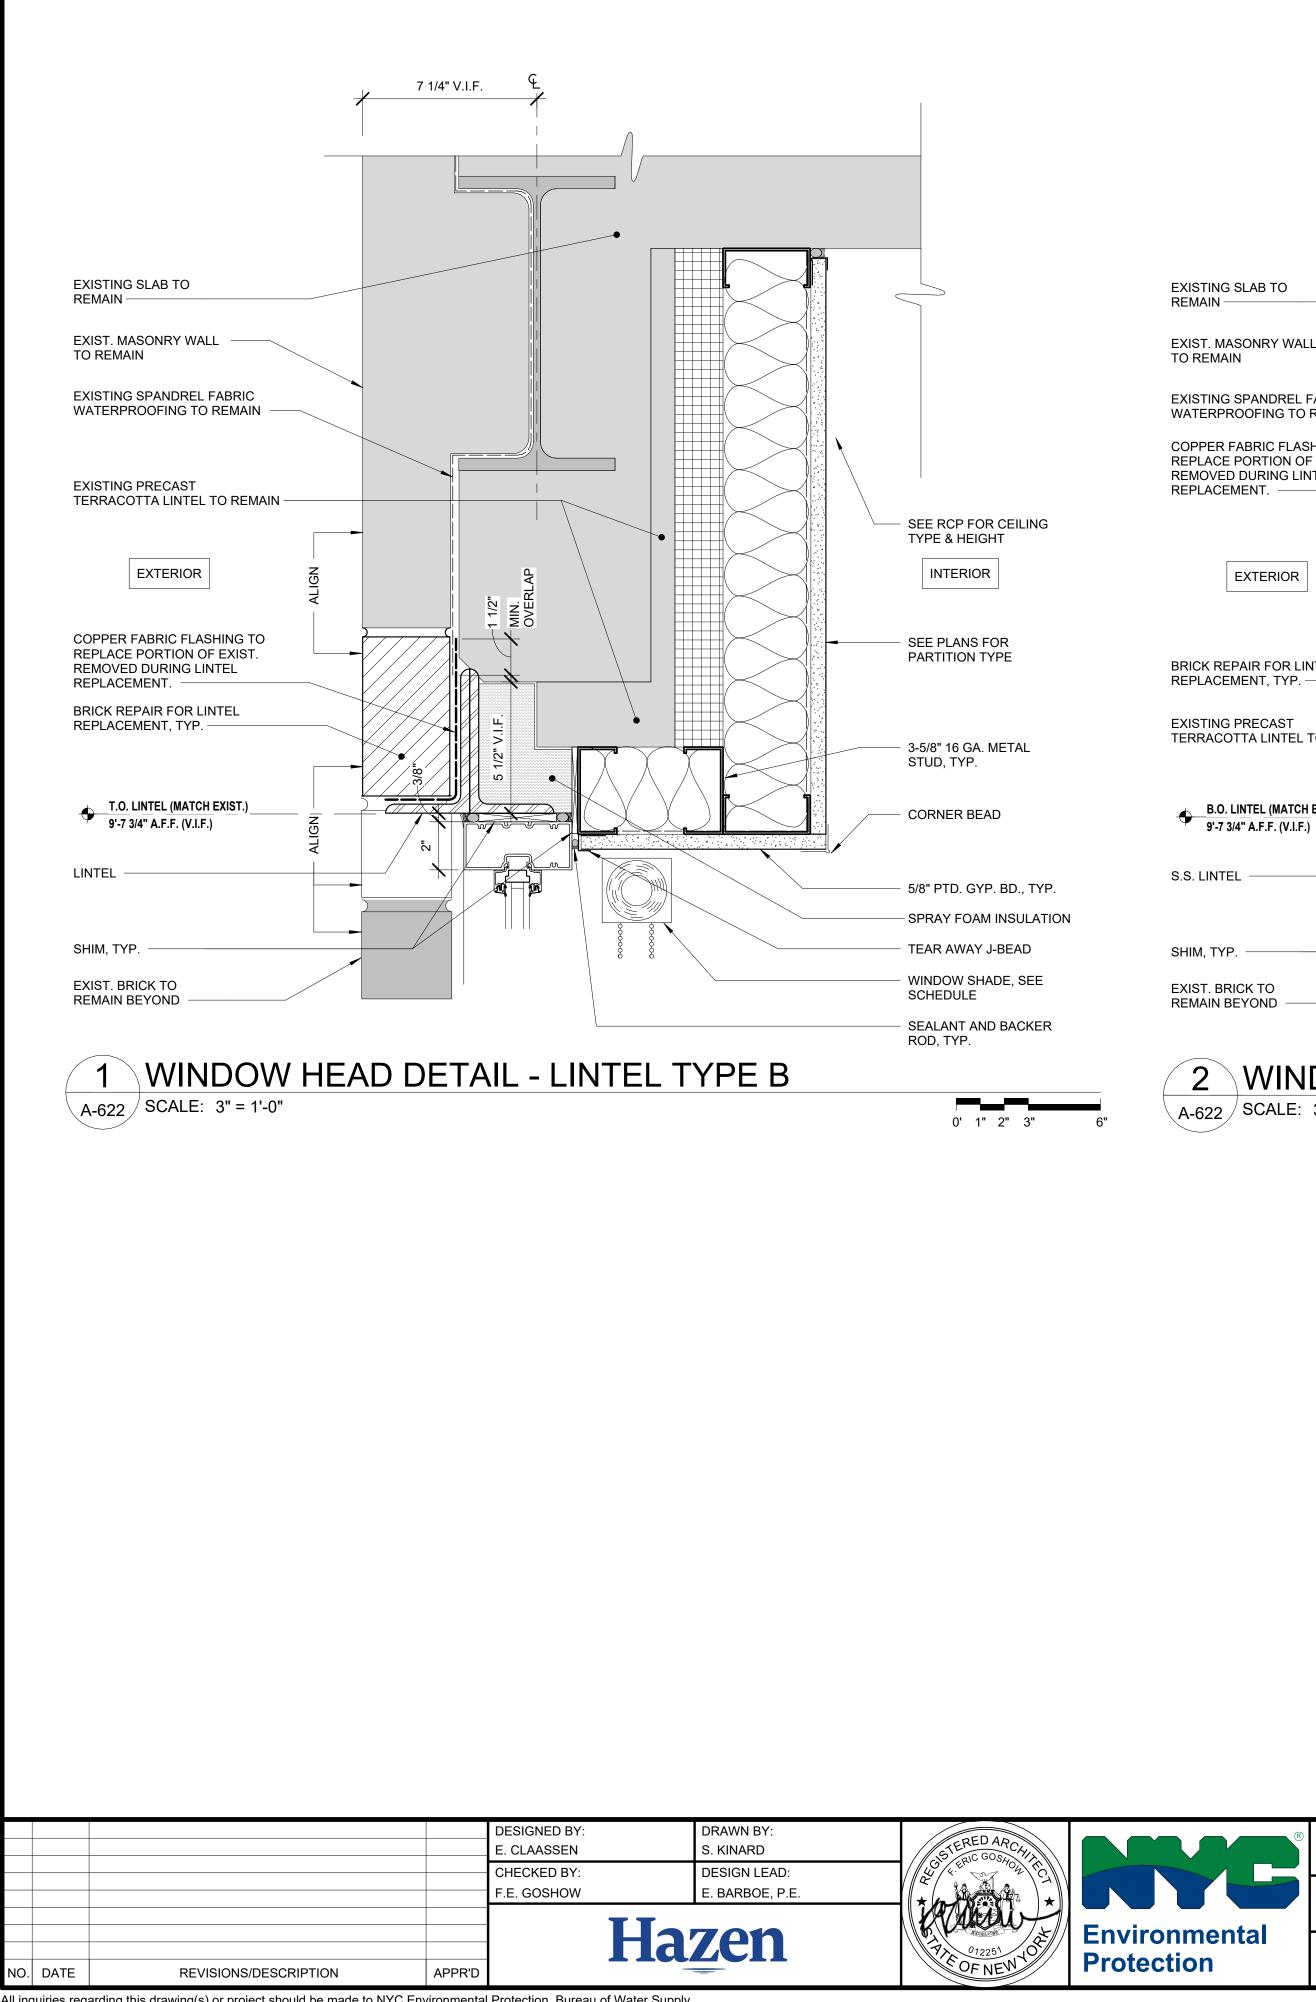

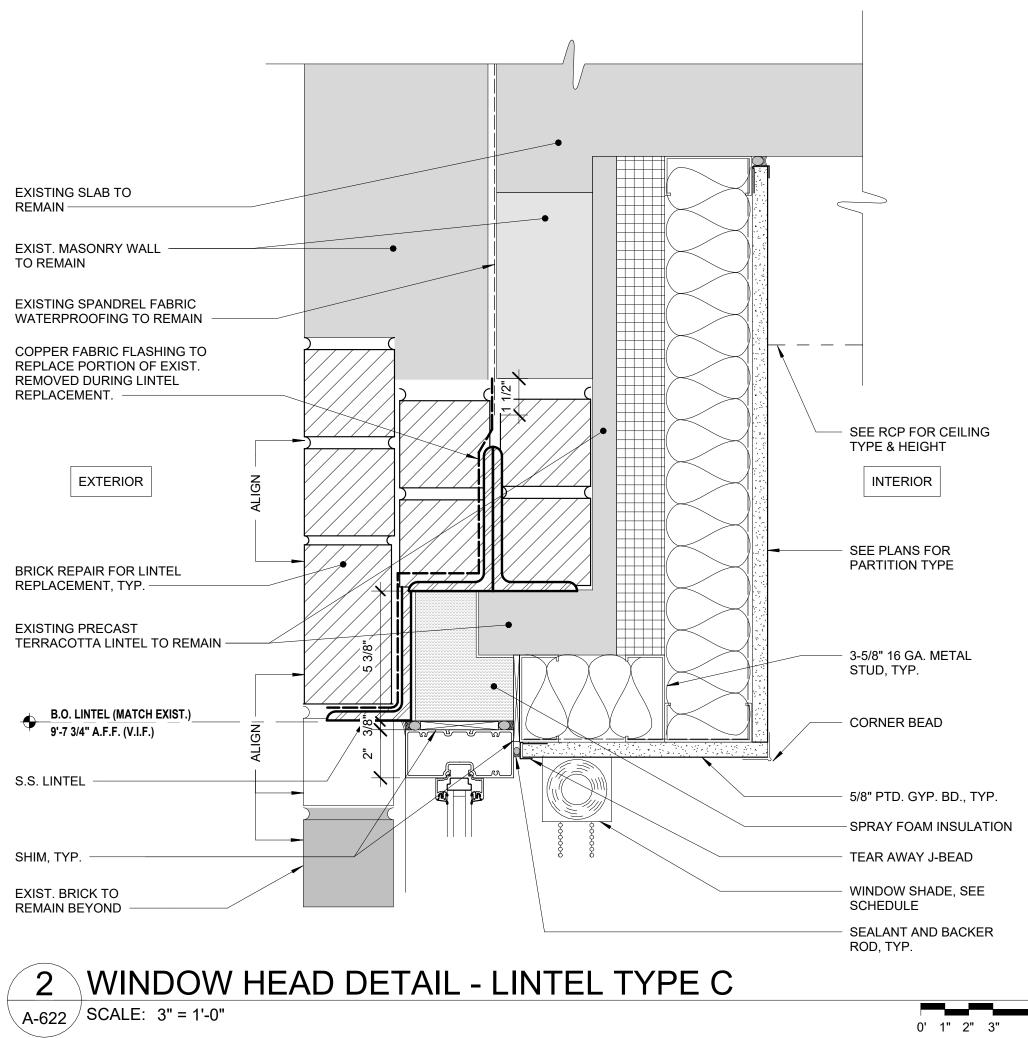


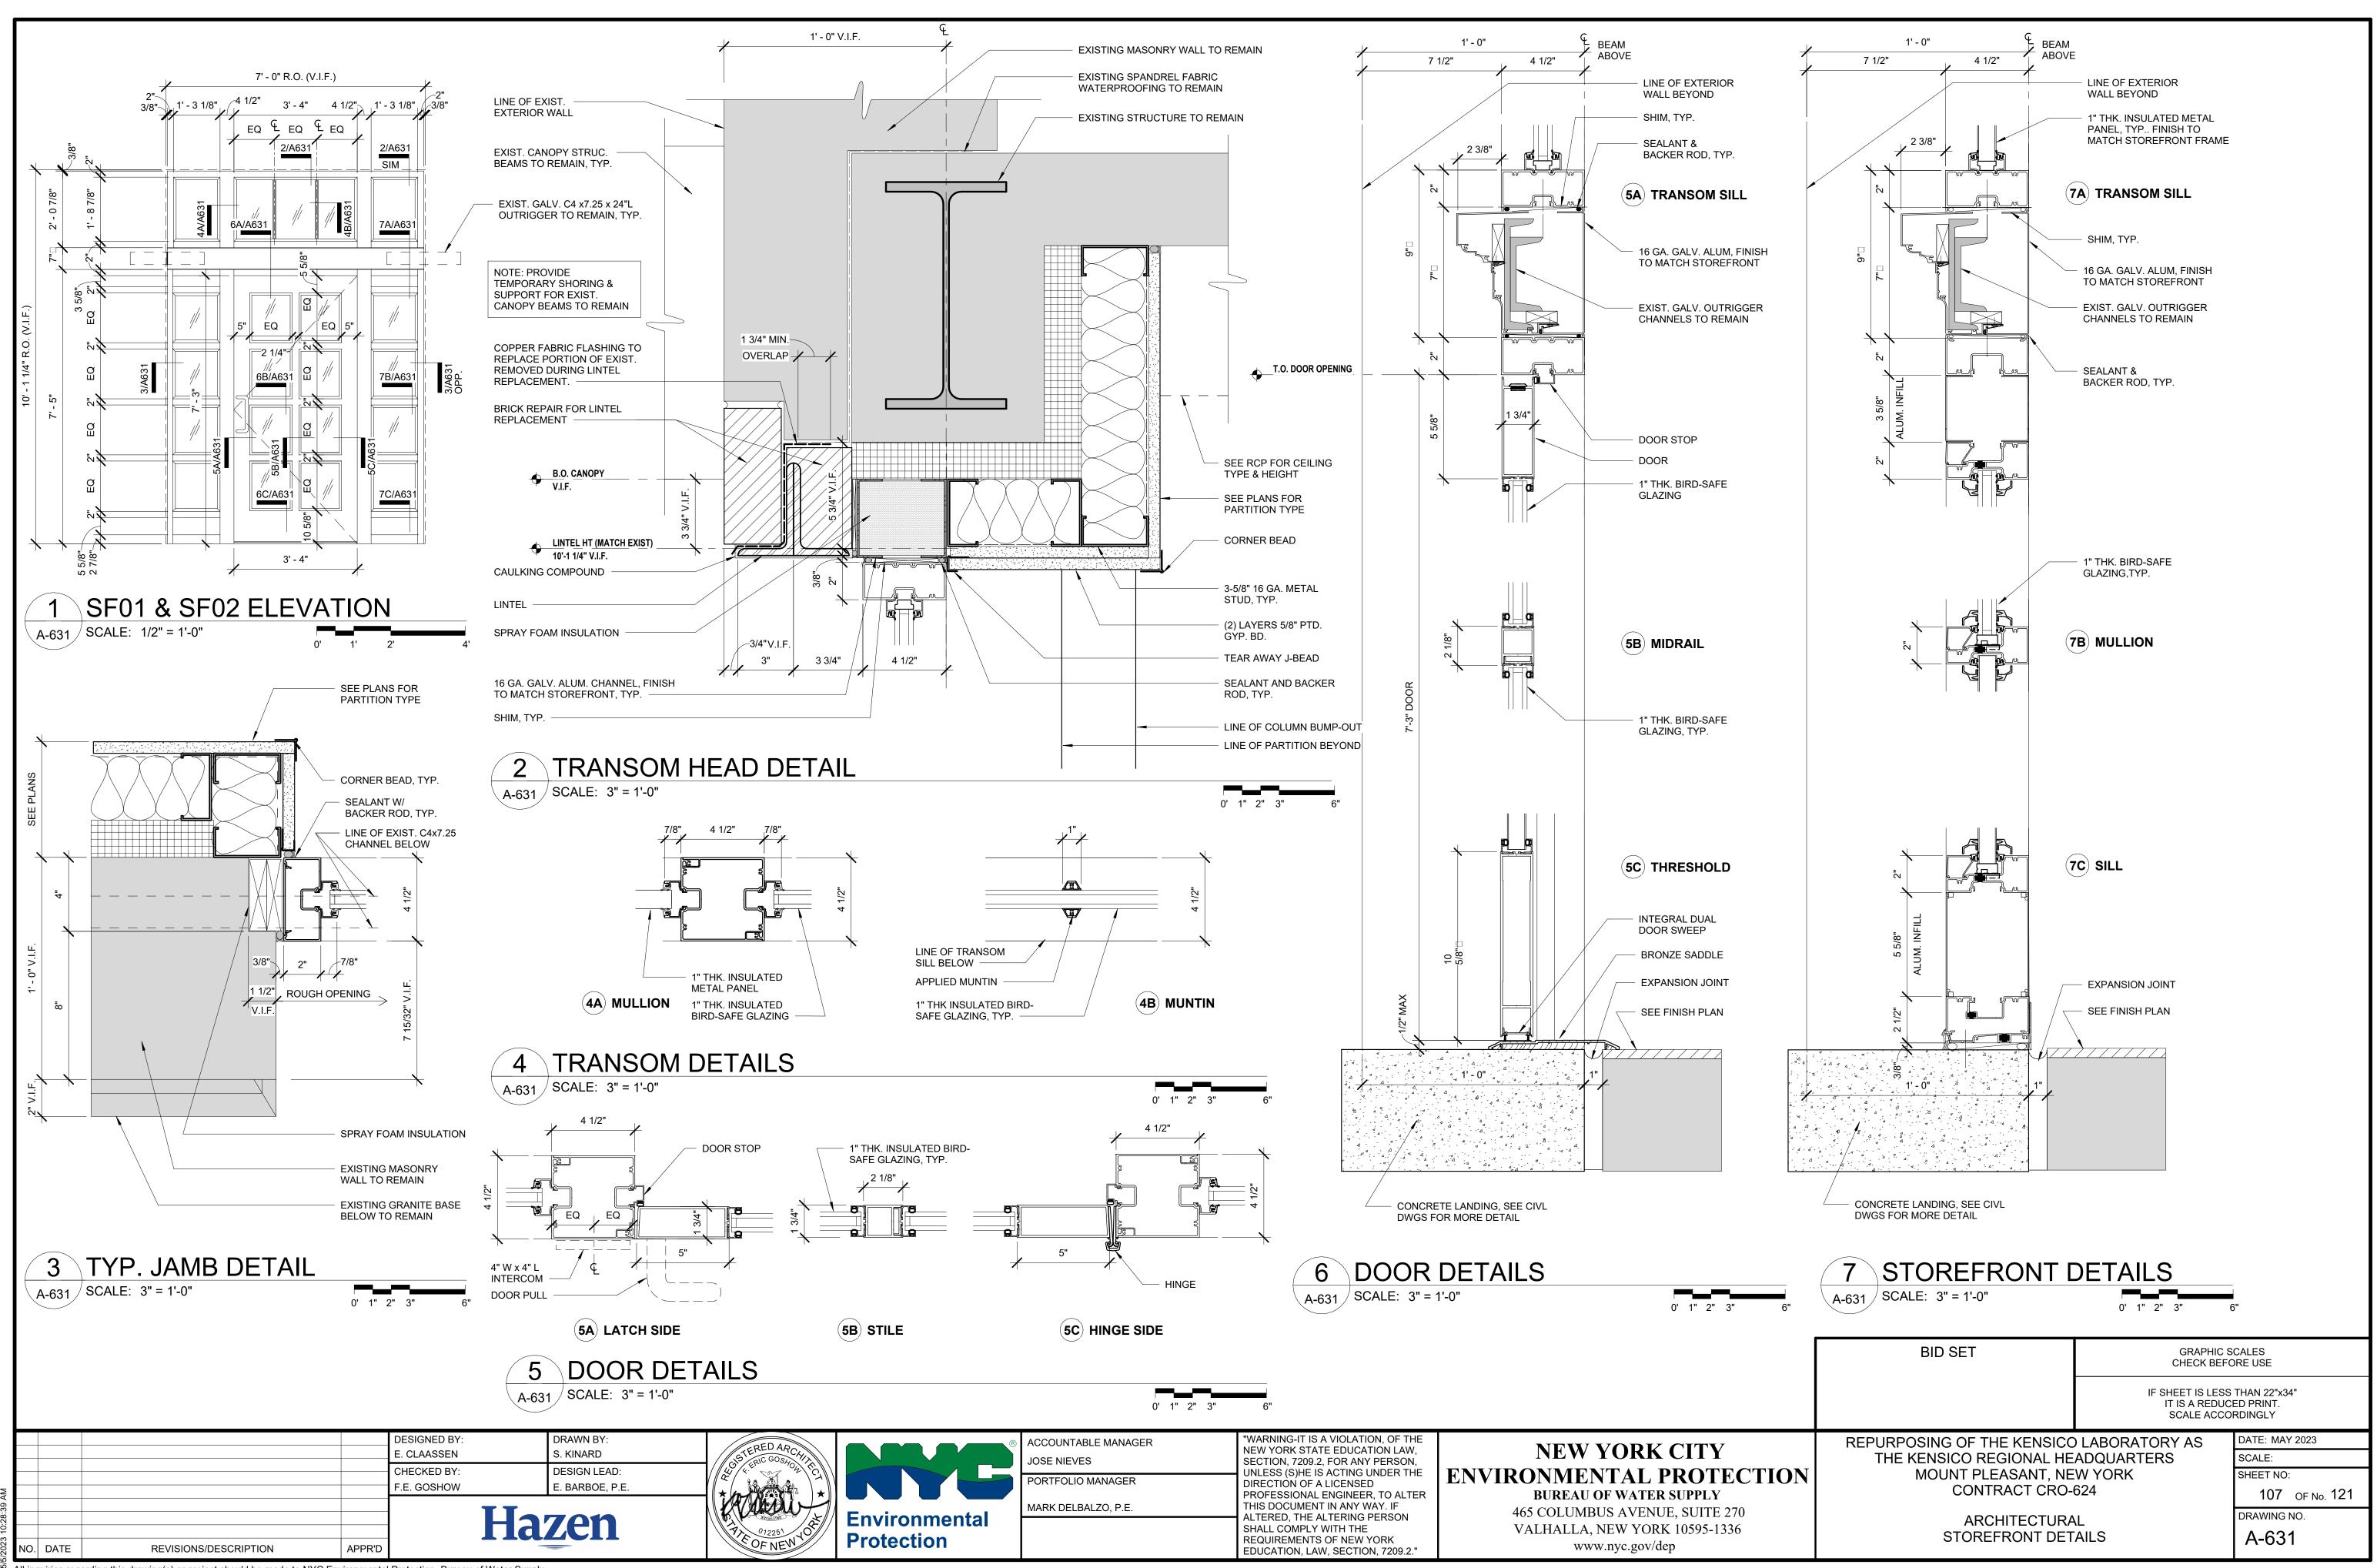ACCOUNTABLE MANAGER
JOSE NIEVES
PORTFOLIO MANAGER
MARK DELBALZO, P.E.

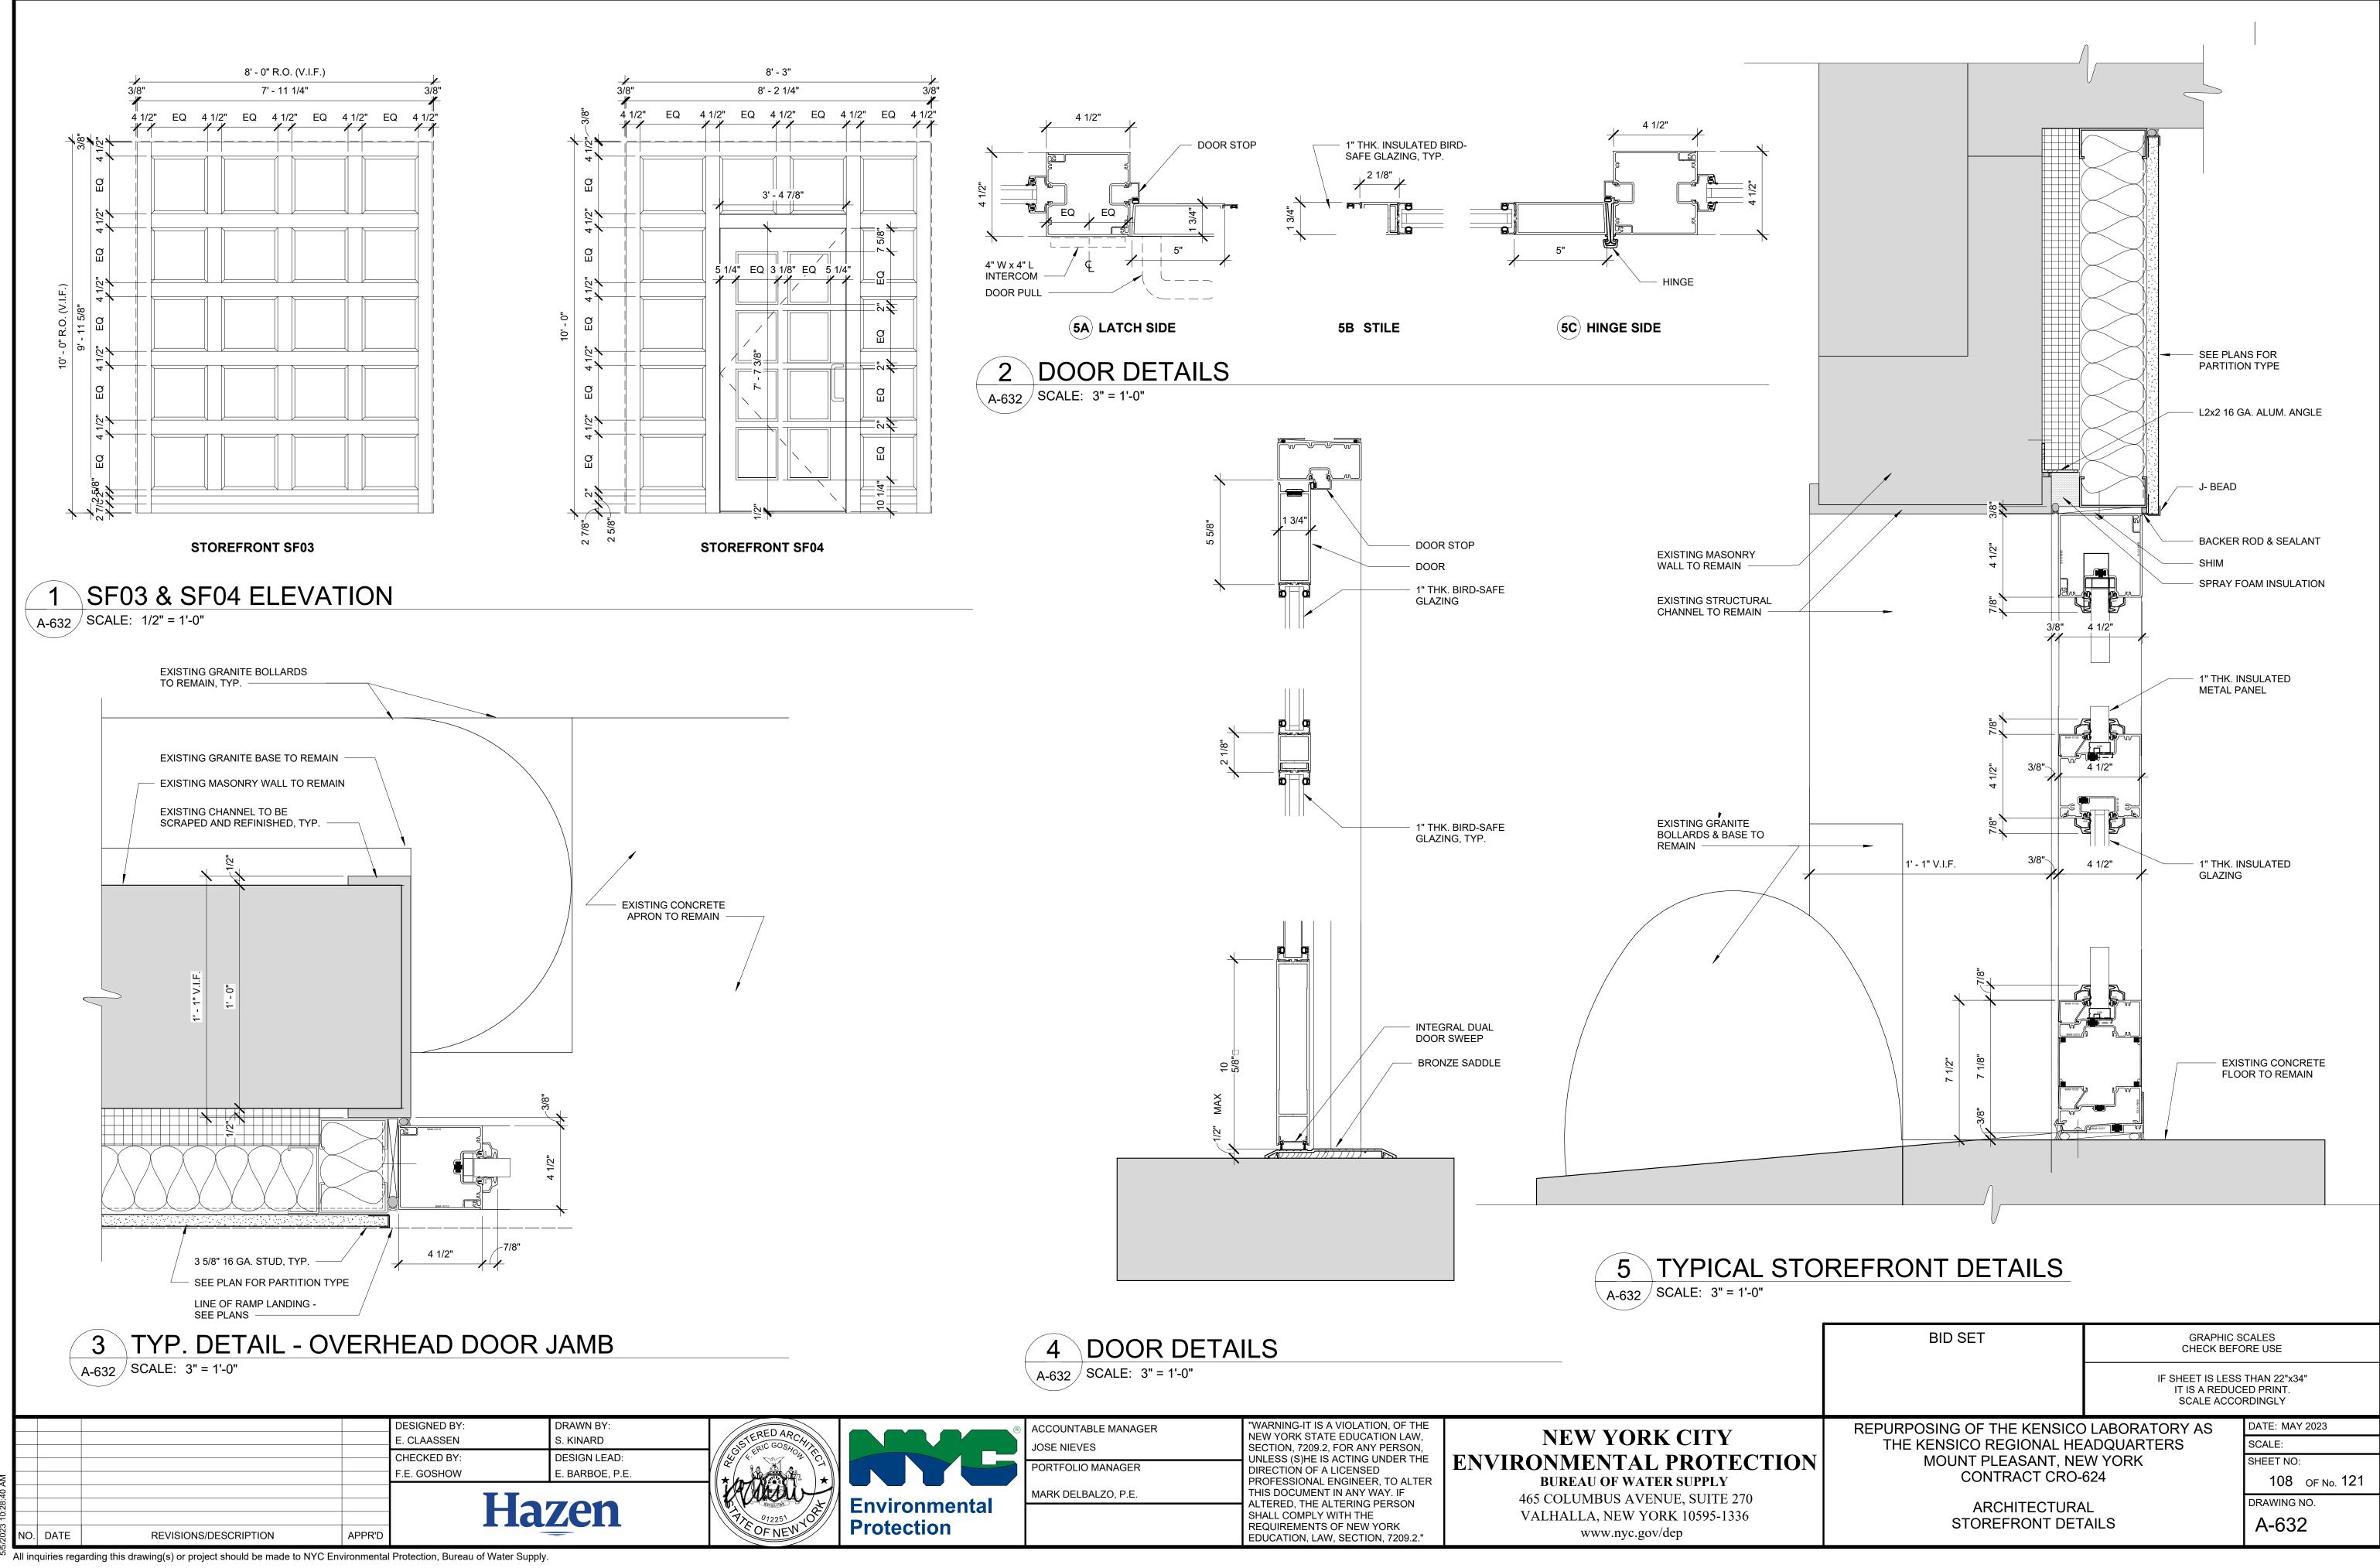
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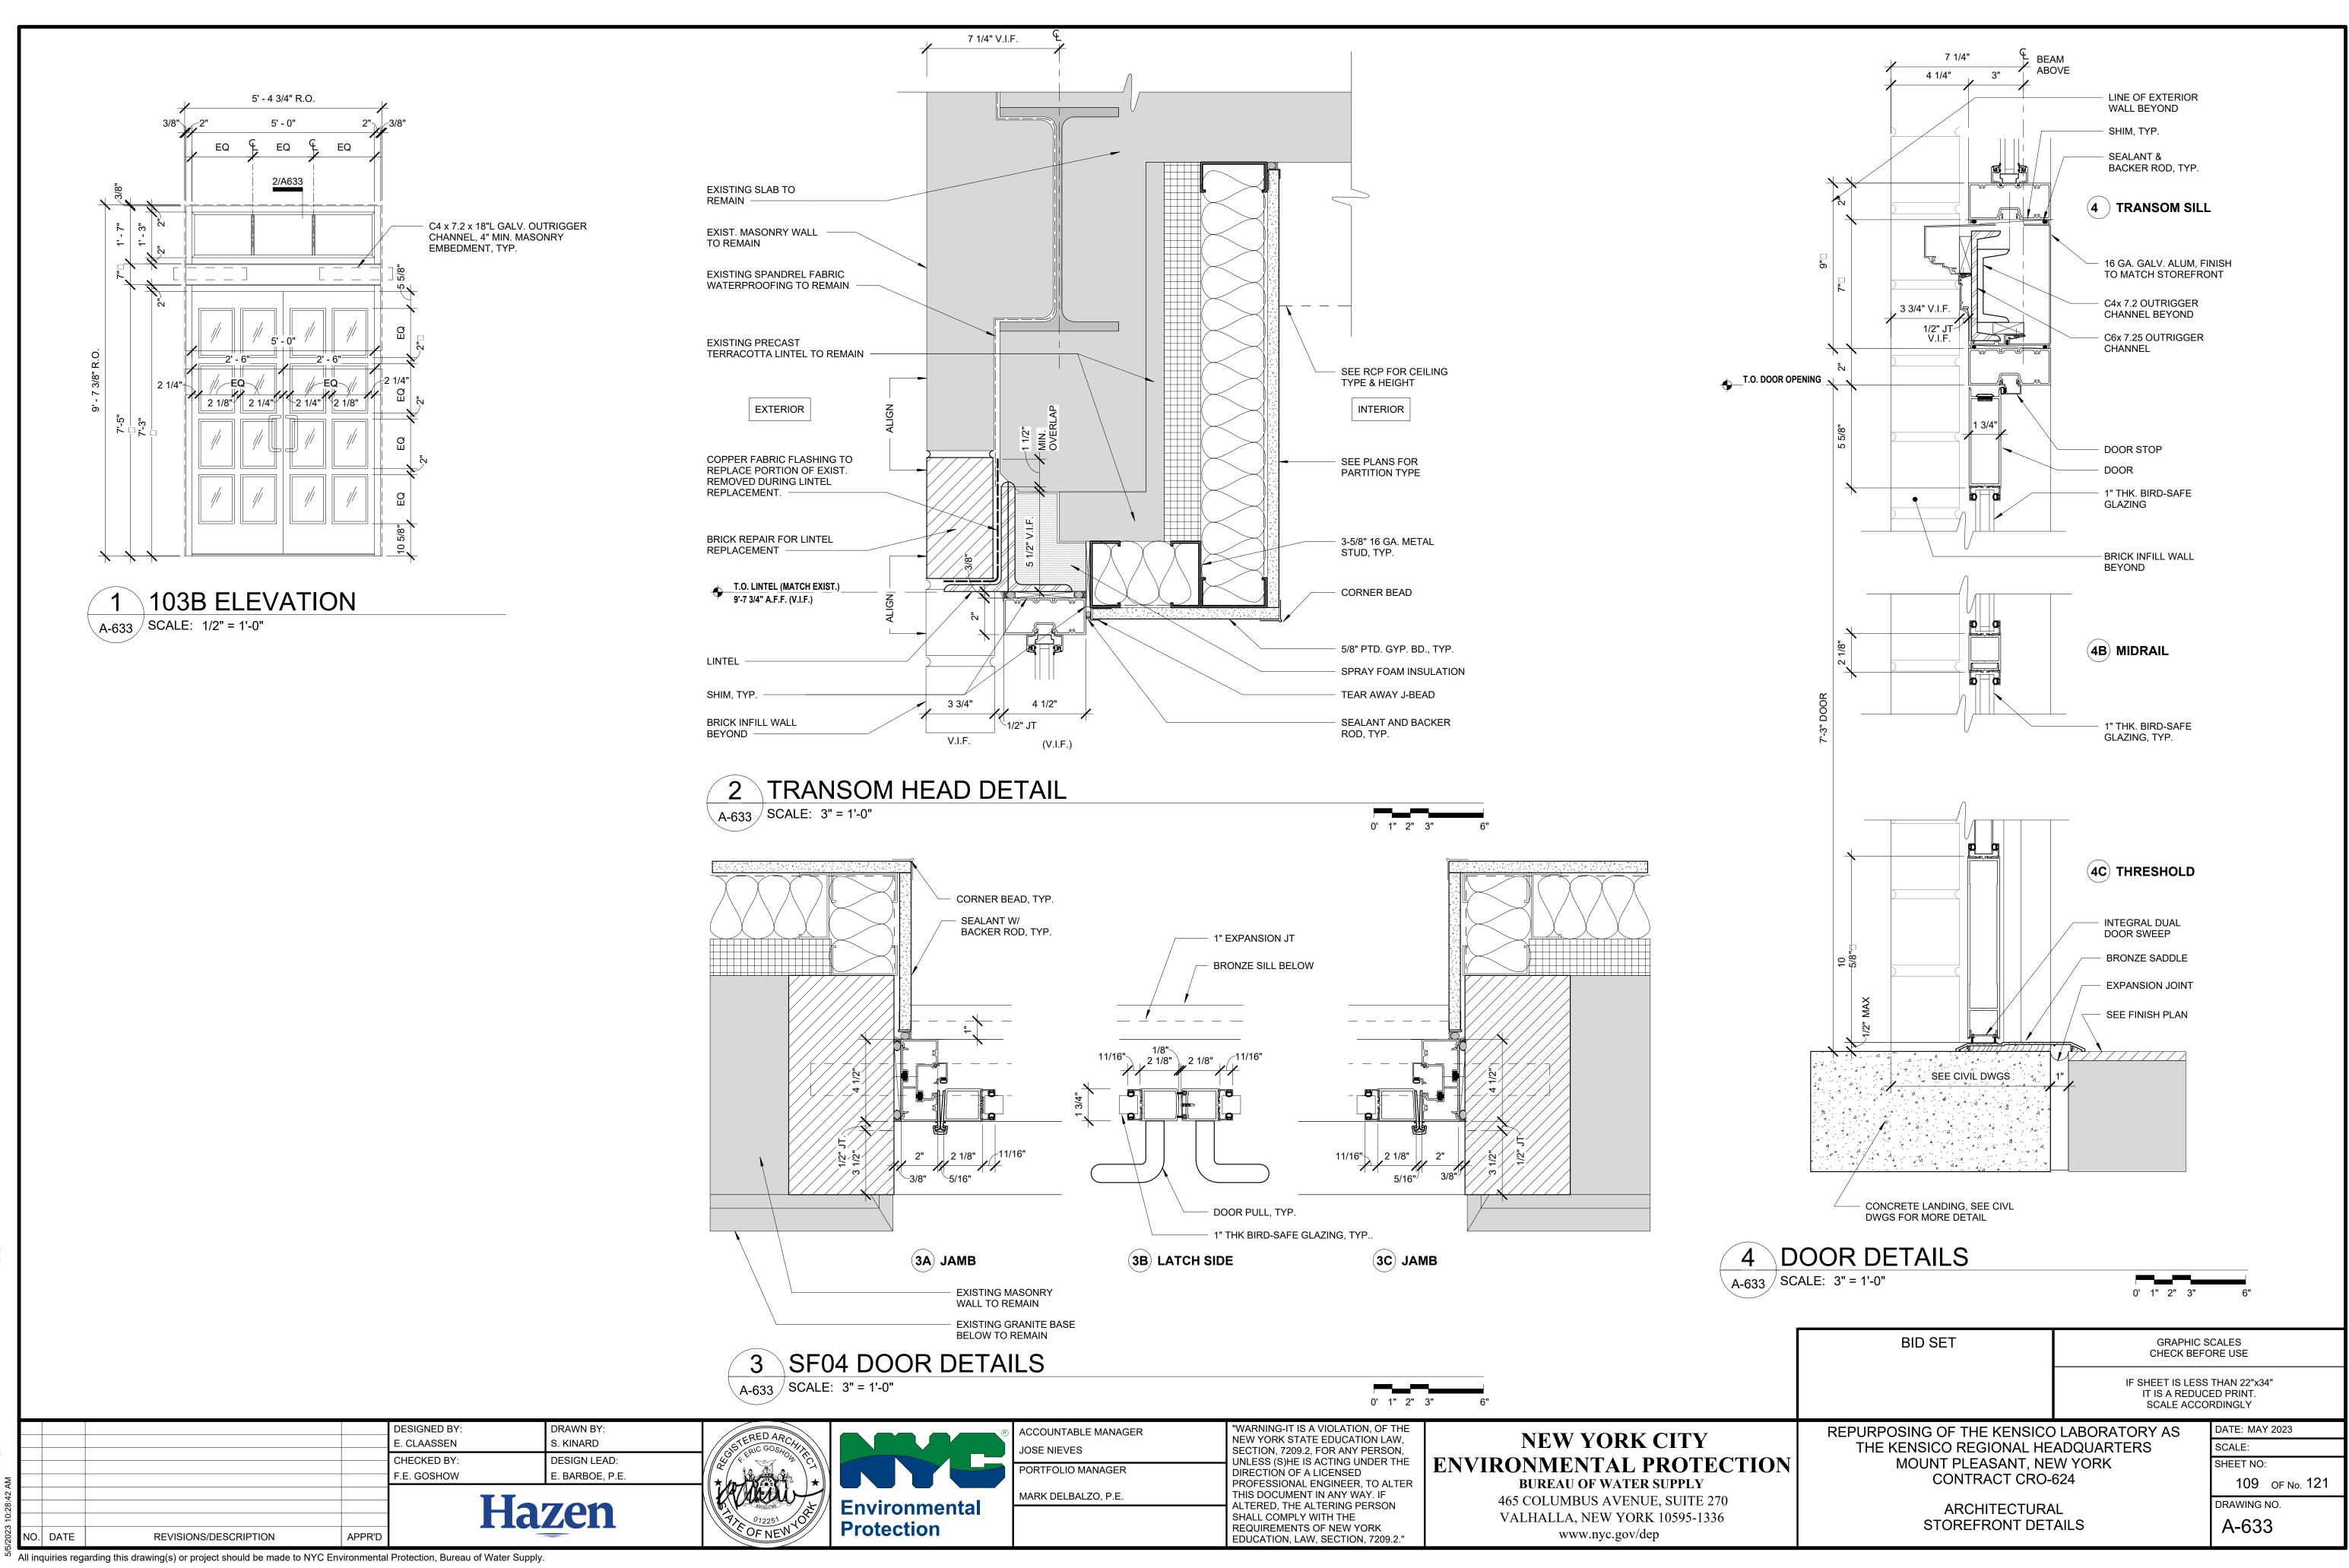
**NEW YORK CITY ENVIRONMENTAL PROTEC BUREAU OF WATER SUPPLY** 465 COLUMBUS AVENUE, SUITE 270 VALHALLA, NEW YORK 10595-1336 www.nyc.gov/dep

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	REPURPOSING OF THE KENSICC	DATE: MAY 2023			
	THE KENSICO REGIONAL HE	SCALE:			
TION	MOUNT PLEASANT, NE	SHEET NO:			
	CONTRACT CRO-	106 OF No. 121			
	ARCHITECTURA	DRAWING NO.			
	WINDOW DETAIL	A-622			

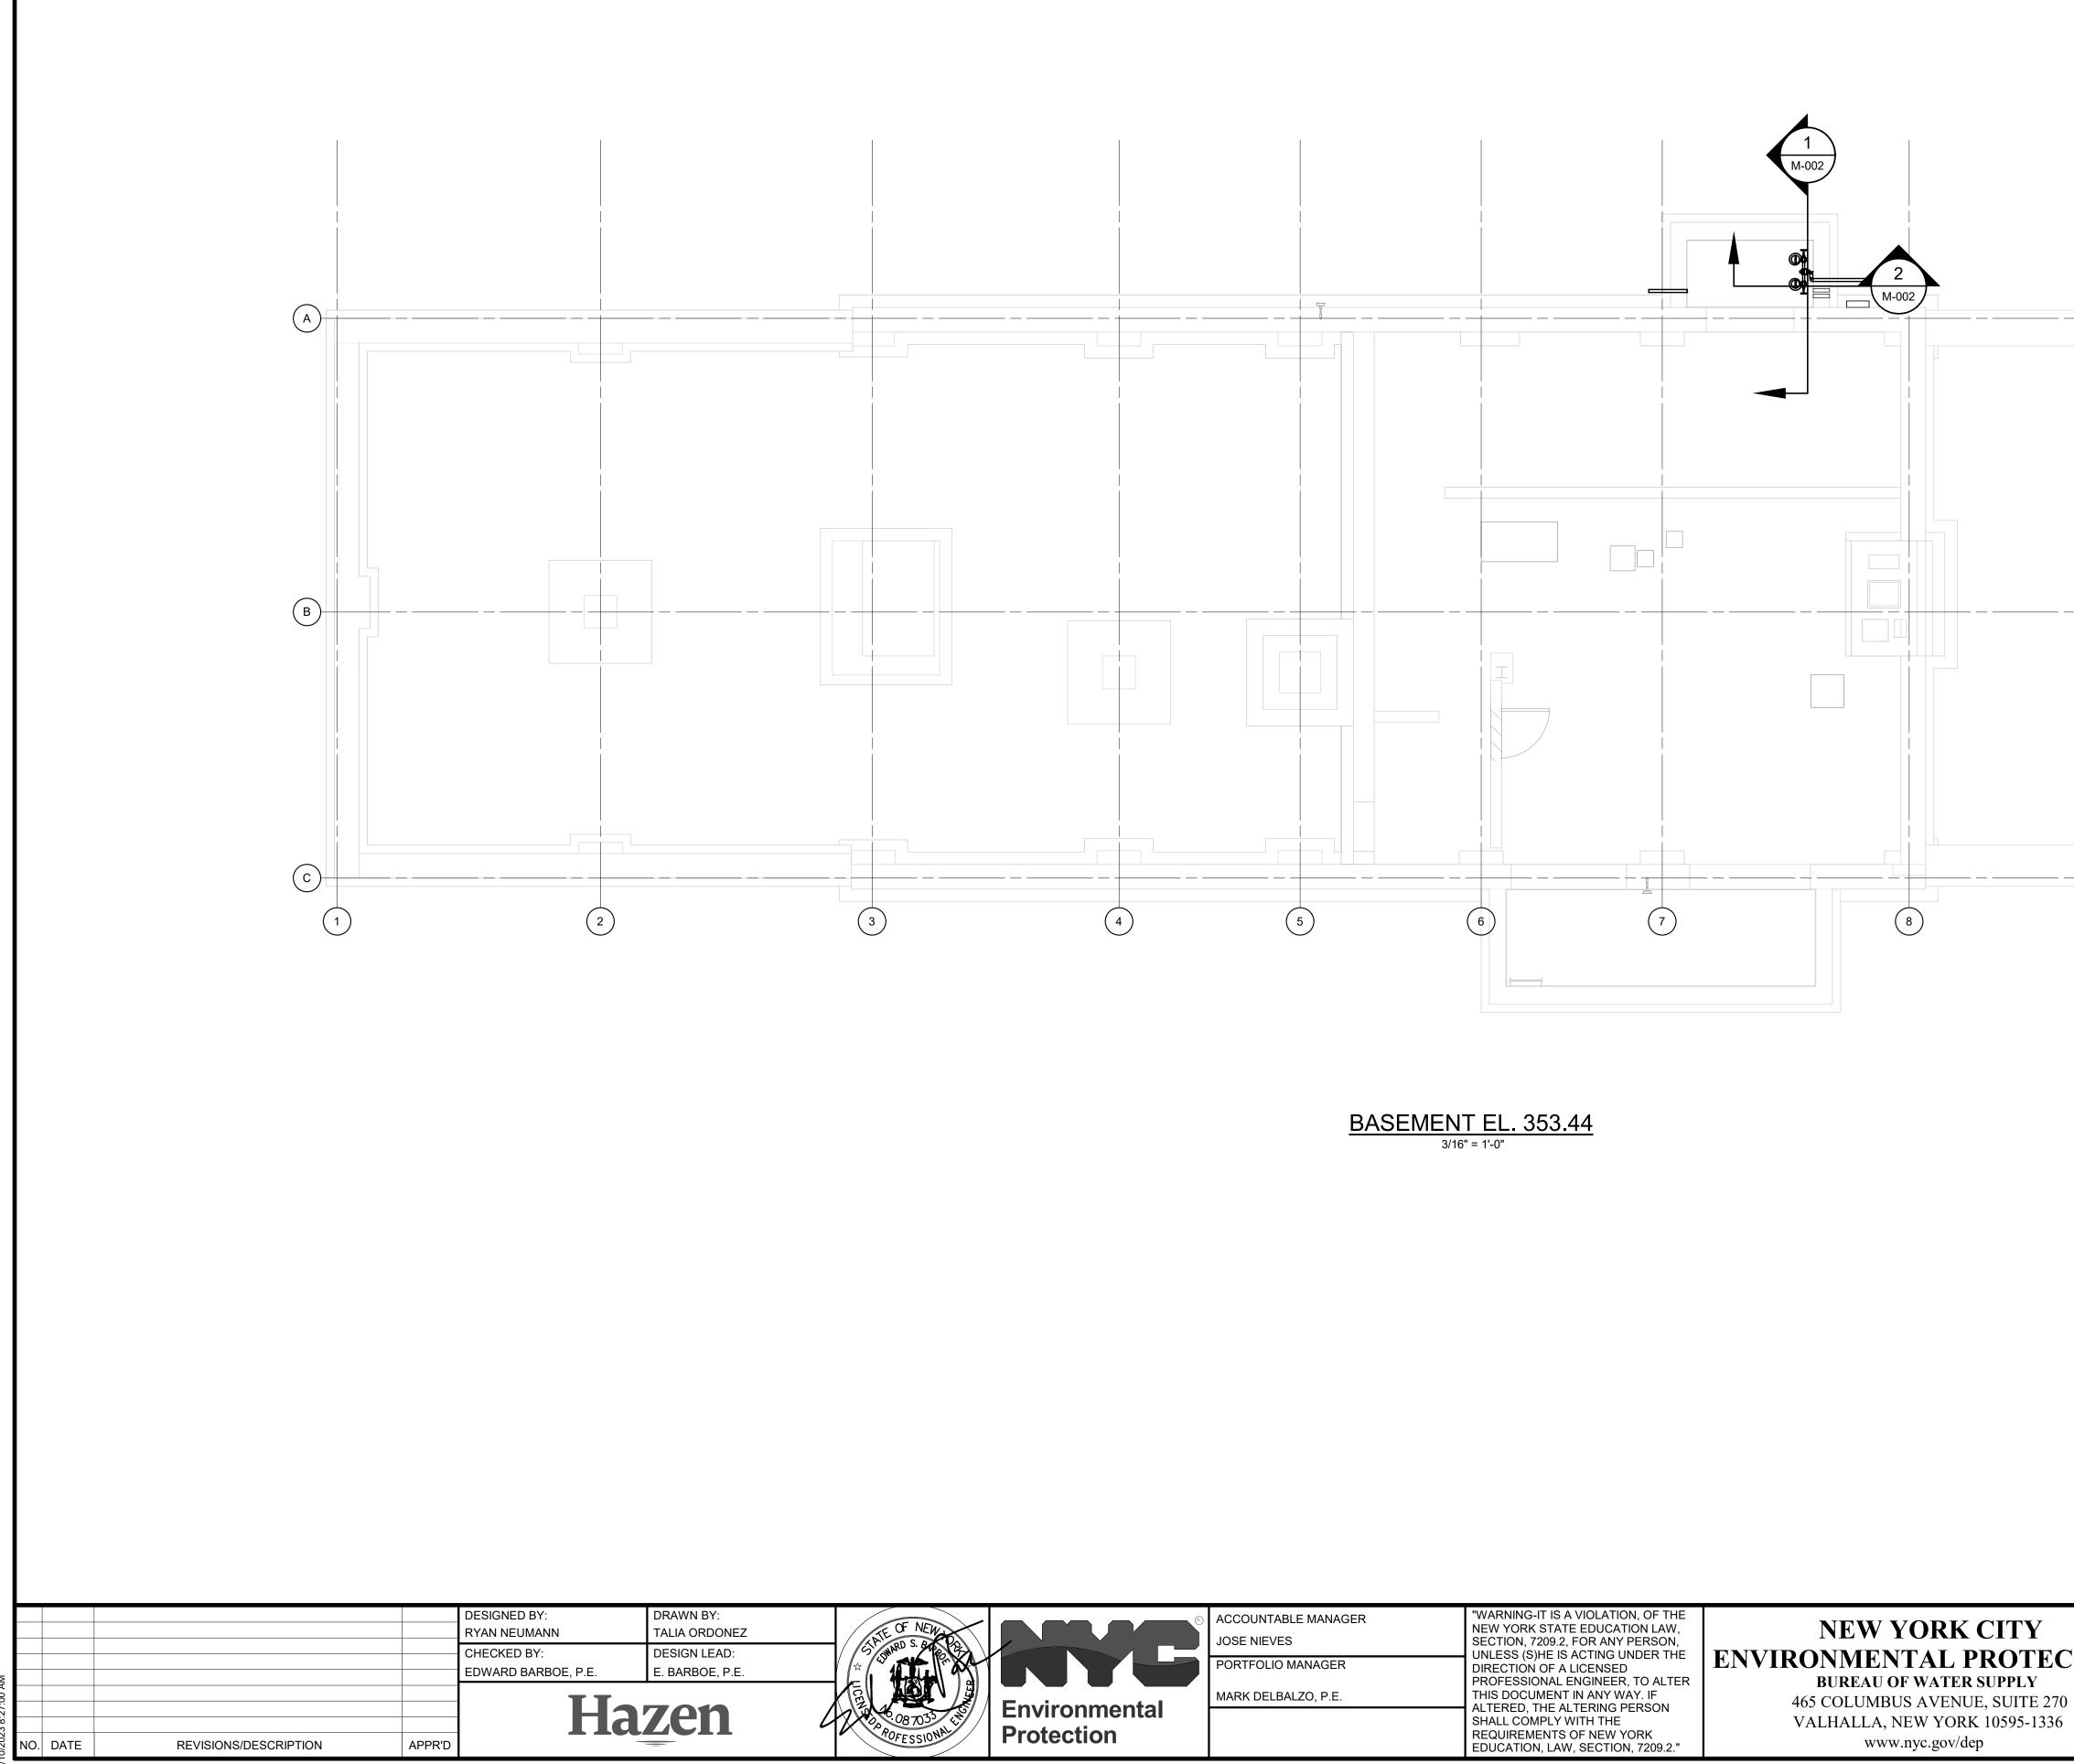


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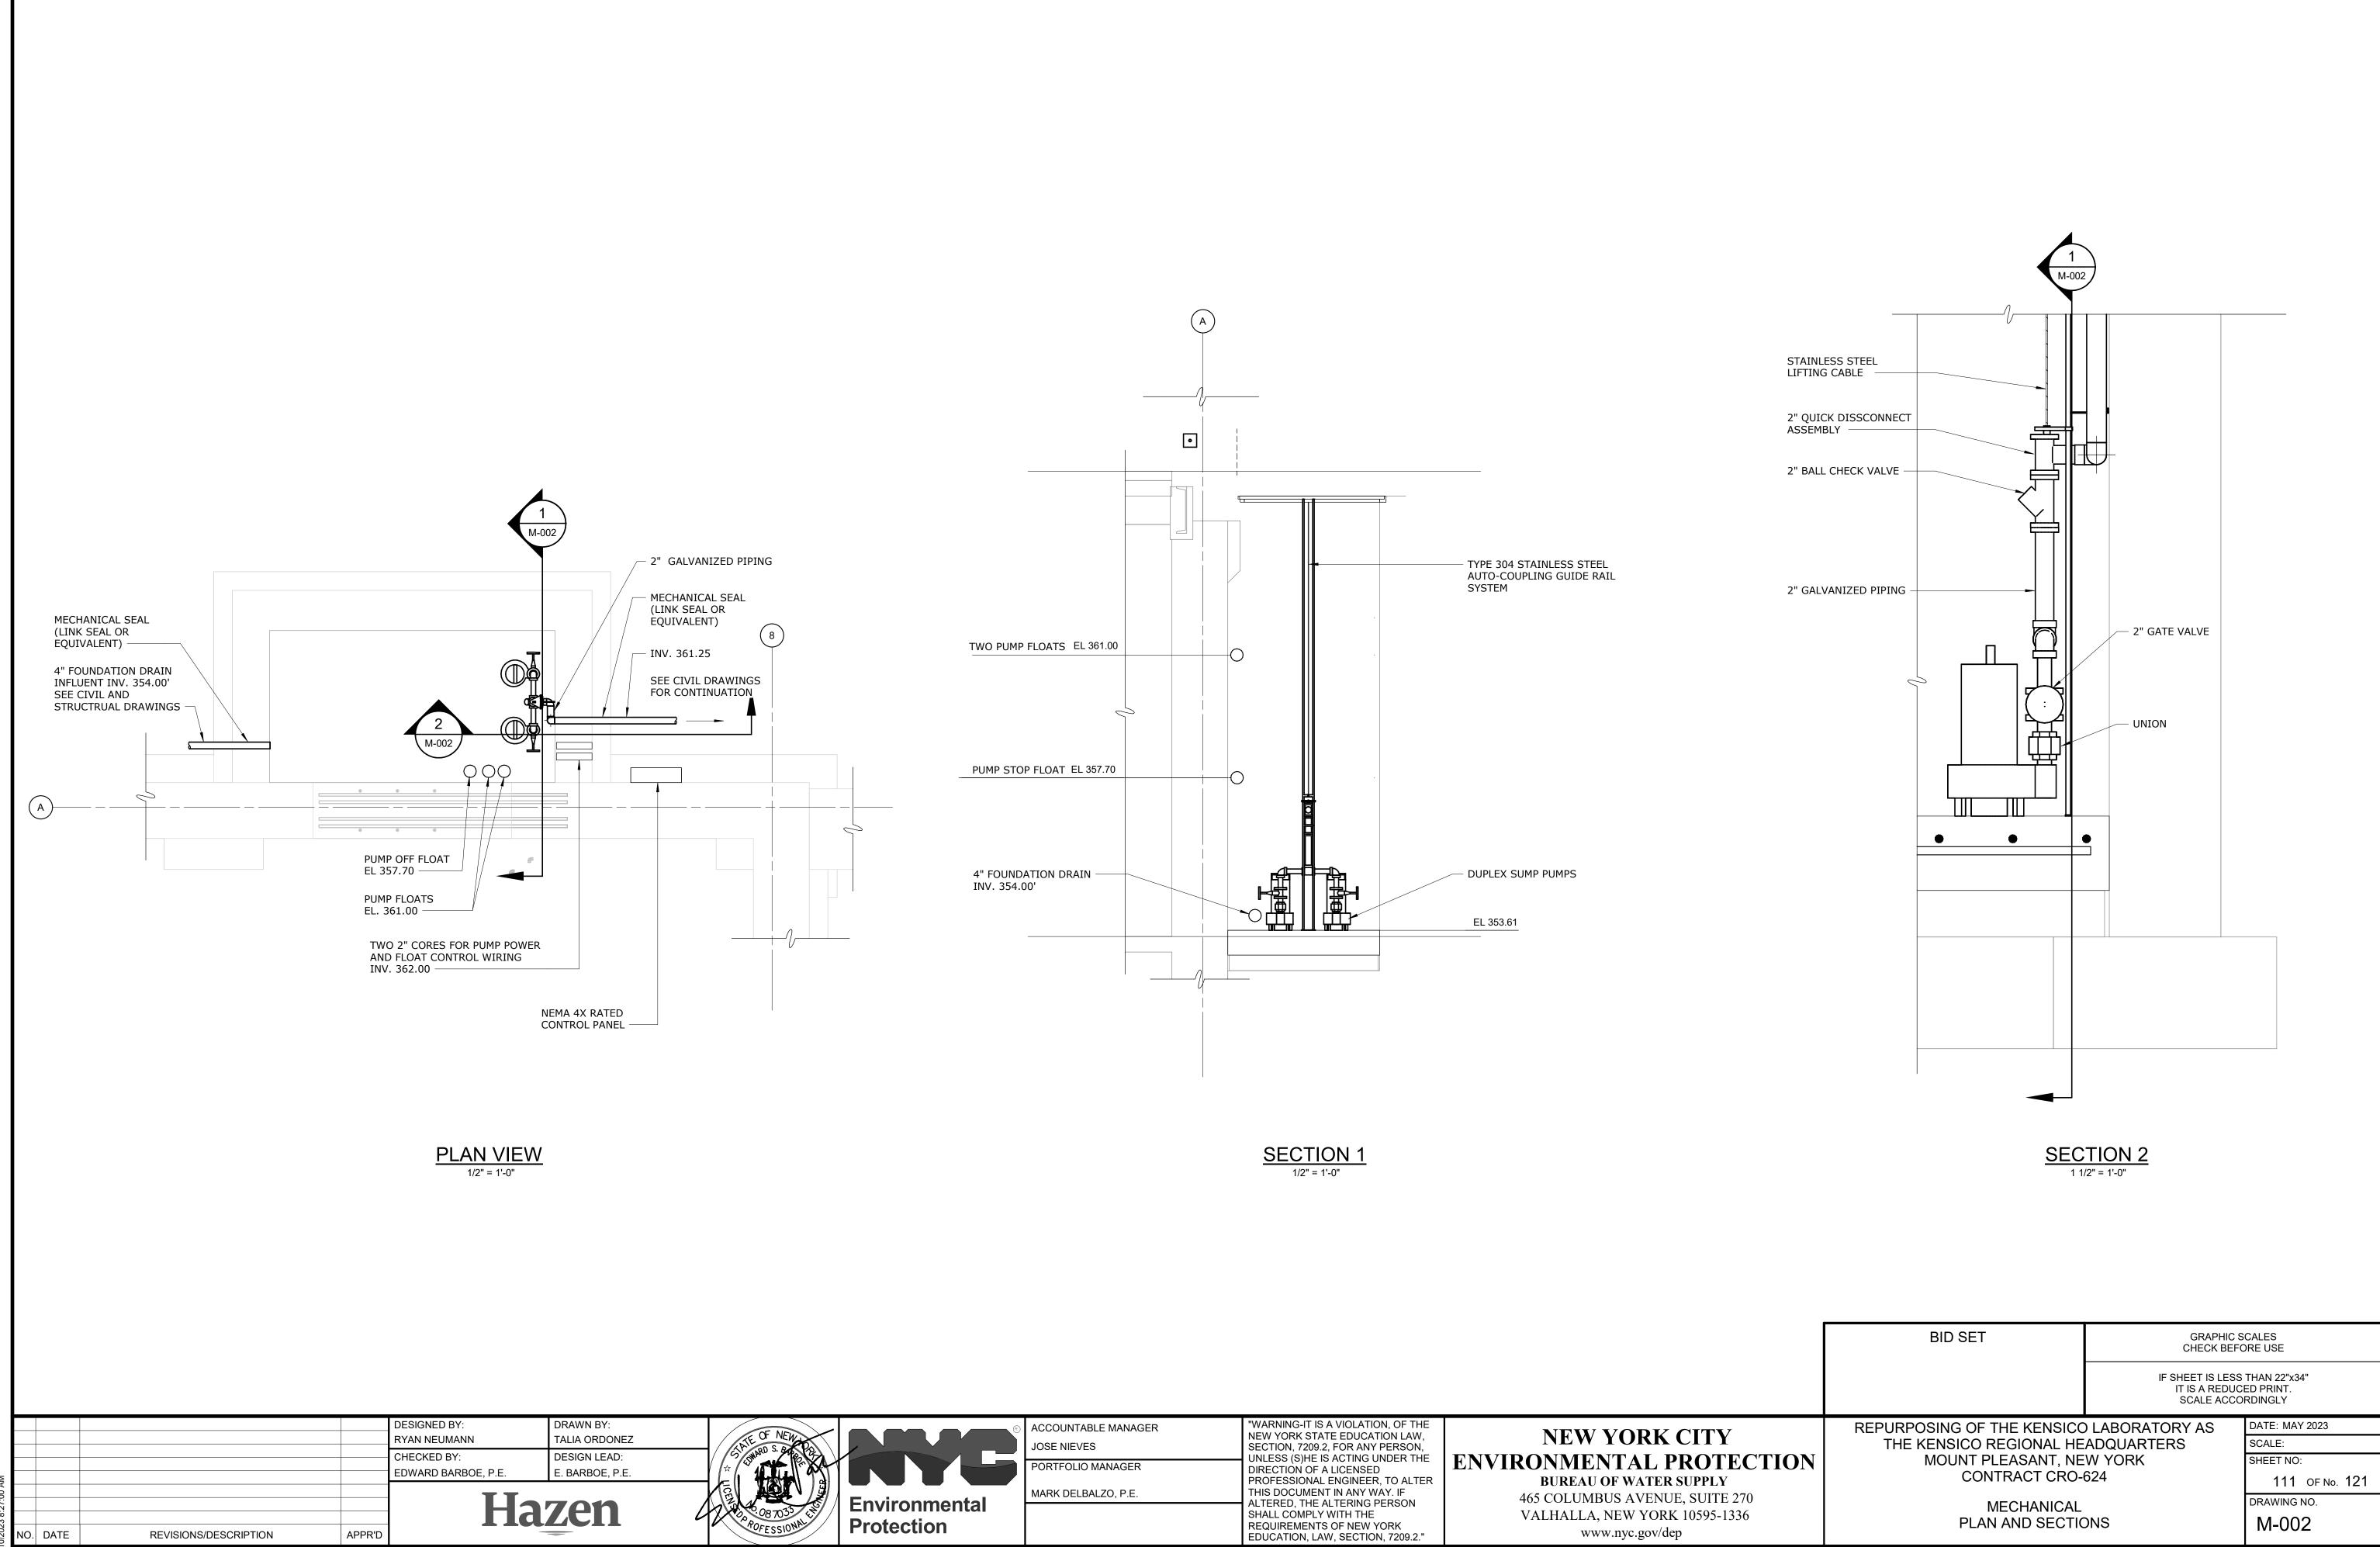


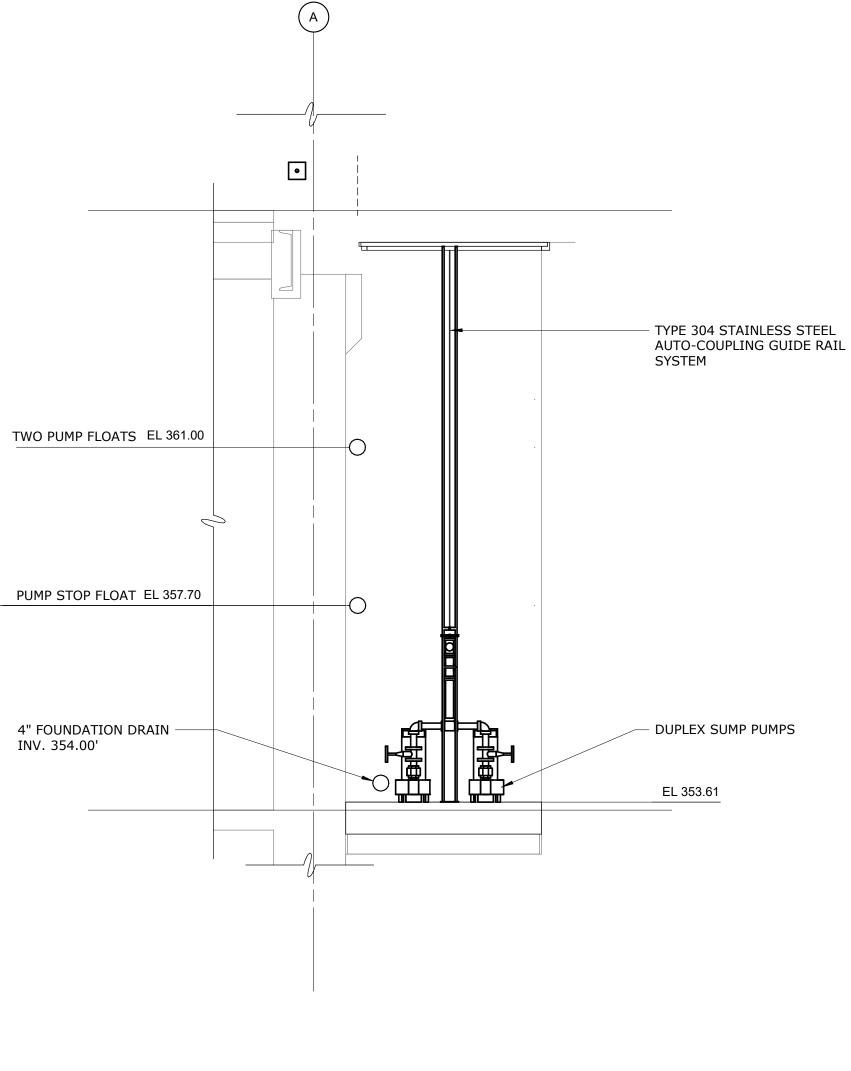


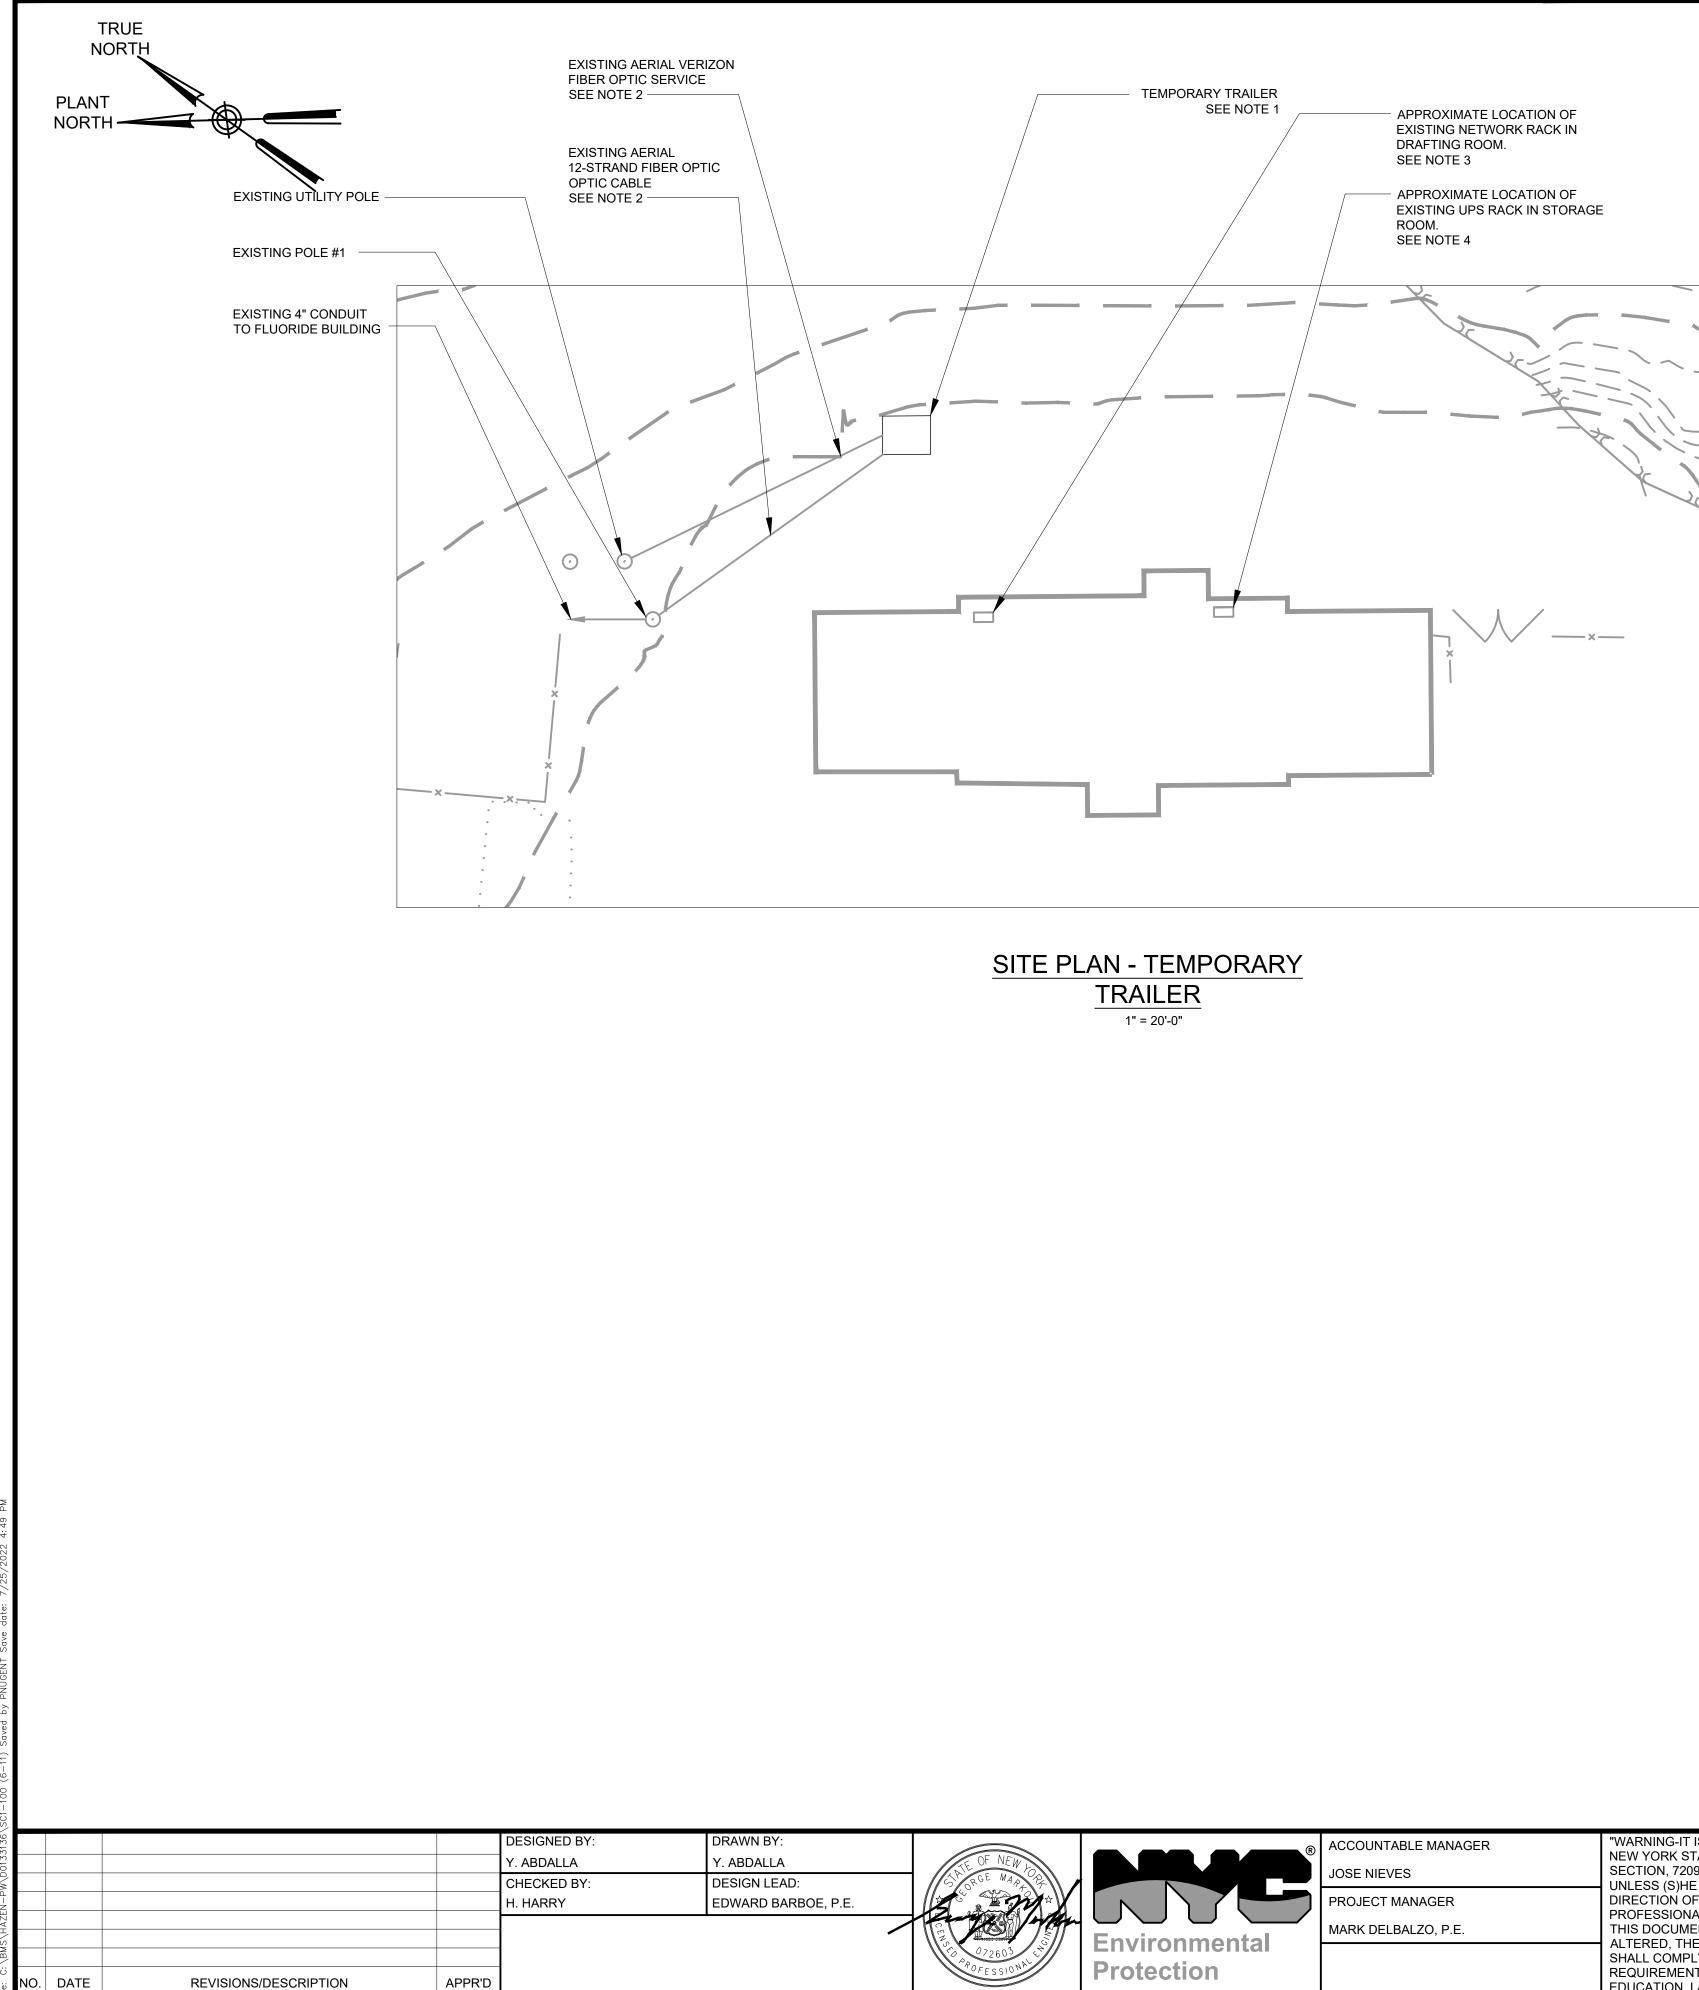
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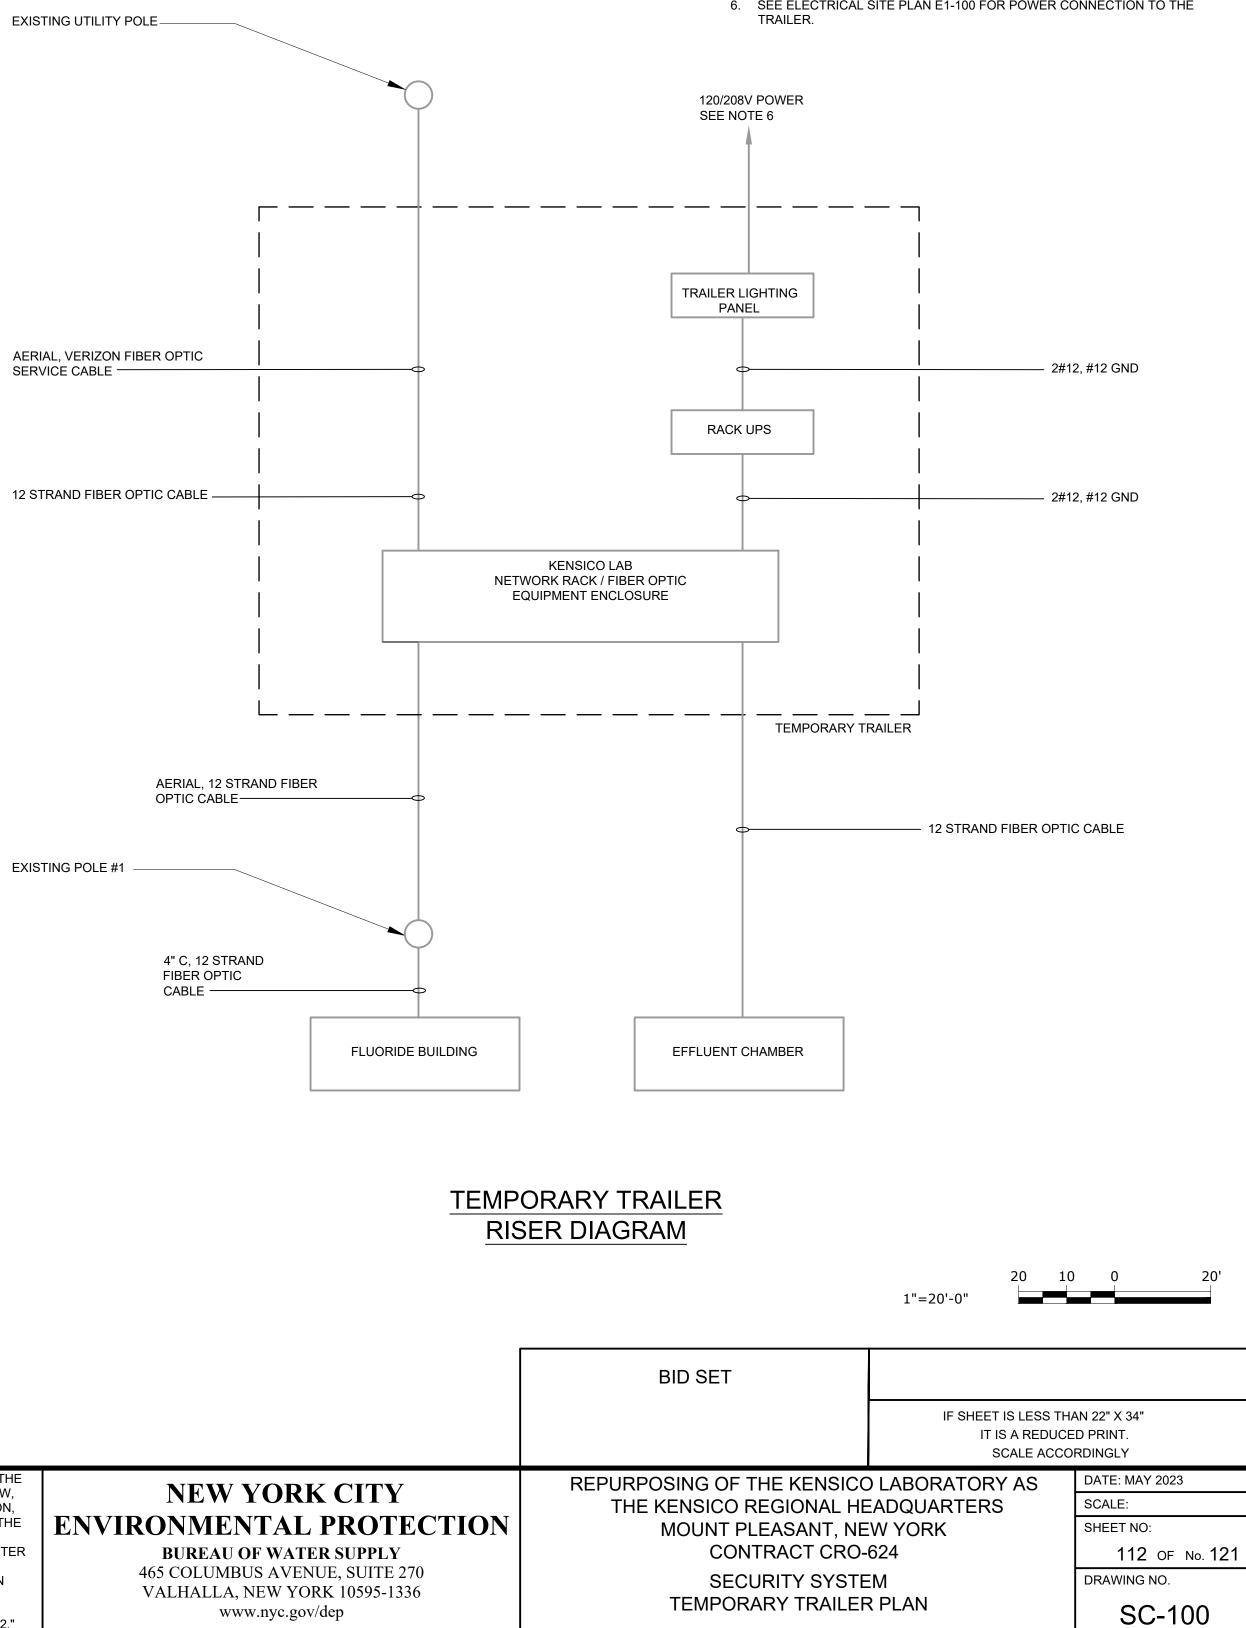


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	BID SET	GRAPHIC S CHECK BEFC	CALES DRE USE
		IF SHEET IS LESS IT IS A REDUC SCALE ACCO	ED PRINT. RDINGLY
CTION	REPURPOSING OF THE KENSICO THE KENSICO REGIONAL HE MOUNT PLEASANT, NE CONTRACT CRO-	ADQUARTERS W YORK	DATE: MAY 2023 SCALE: SHEET NO: 110 OF No. 121
	MECHANICAL FOUNDATION PL		drawing no. M-001










		ACCOUNTABLE MANAGER	"WARNING-IT IS A VIOLATION, OF THE NEW YORK STATE EDUCATION LAW,	NEW YORK CITY
	JOSE NIEVES	SECTION, 7209.2, FOR ANY PERSON,	SECTION, 7209.2, FOR ANY PERSON,	
$\langle$		PROJECT MANAGER	DIRECTION OF A LICENSED	ENVIRONMENTAL PROTECT
h		MARK DELBALZO, P.E.	PROFESSIONAL ENGINEER, TO ALTER THIS DOCUMENT IN ANY WAY. IF	BUREAU OF WATER SUPPLY 465 COLUMBUS AVENUE, SUITE 270
	Environmental Protection		ALTERED, THE ALTERING PERSON SHALL COMPLY WITH THE REQUIREMENTS OF NEW YORK	VALHALLA, NEW YORK 10595-1336
			EDUCATION, LAW, SECTION, 7209.2."	www.nyc.gov/dep


# NOTES:

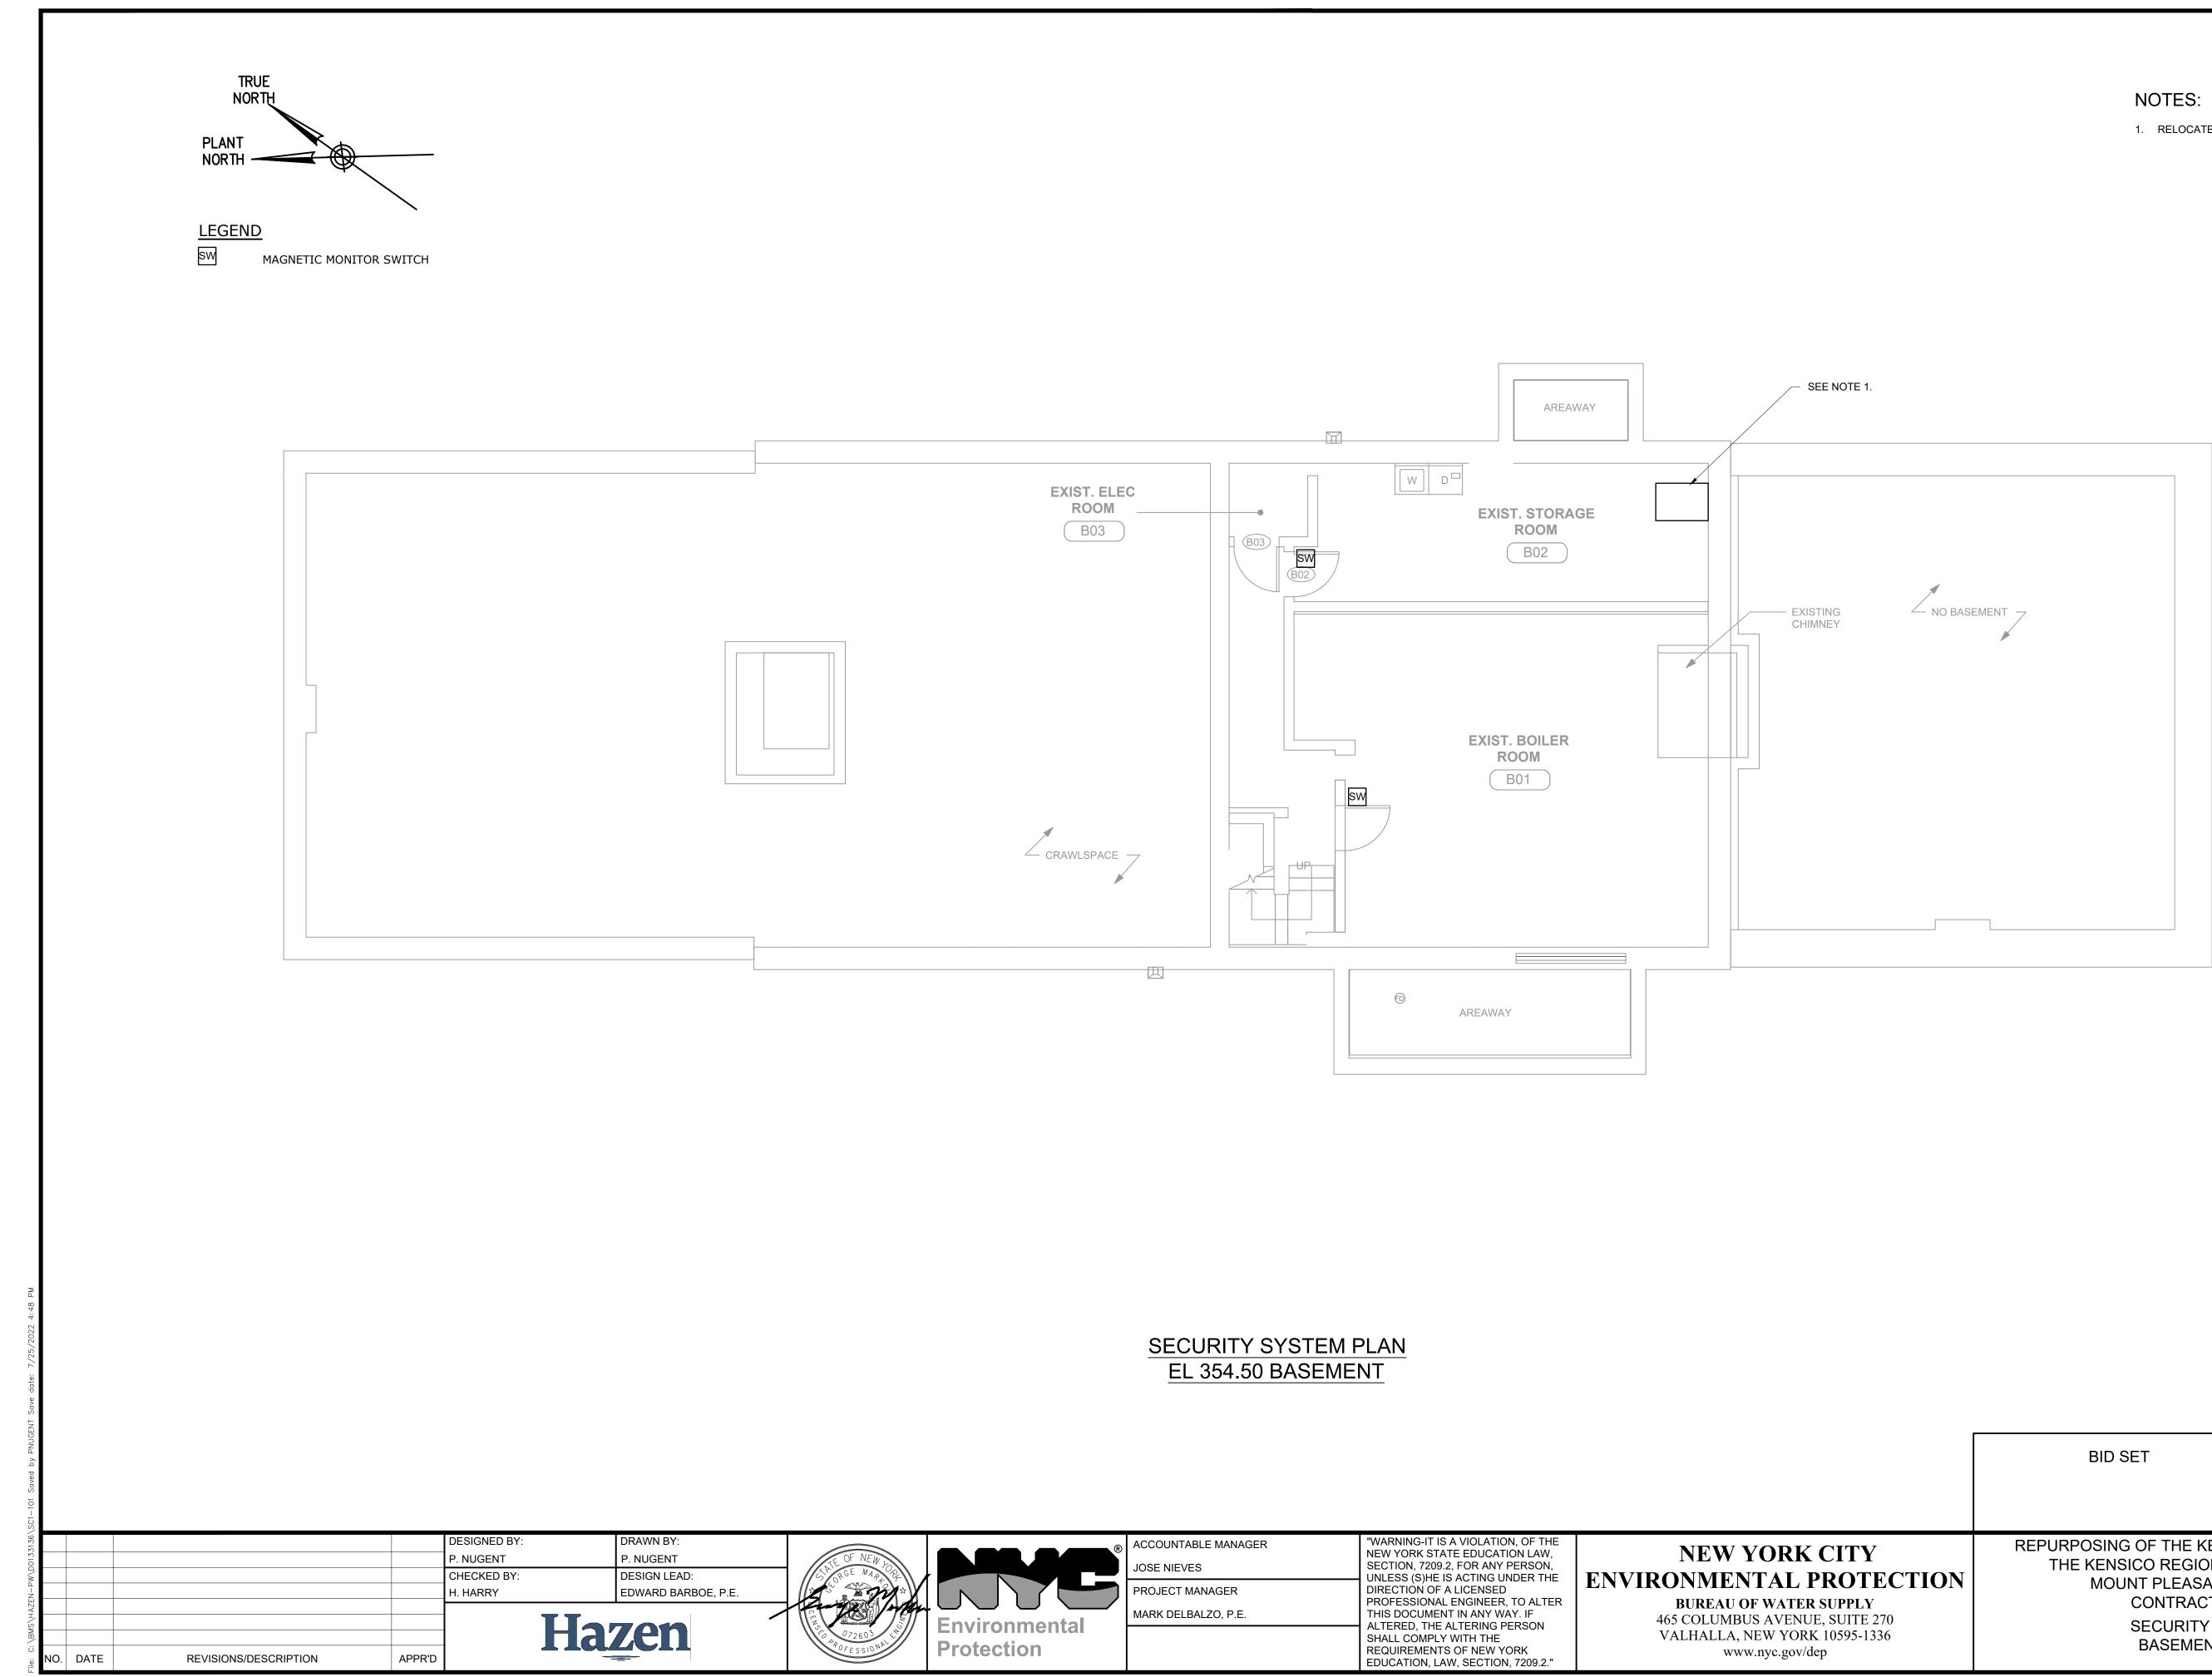- 1. FURNISH AND INSTALL TRAILER TO HOUSE THE EXISTING NETWORK
- RACK AND UPS RACK DURING CONSTRUCTION. 2. REROUTE 12-STRAND FIBER OPTIC CABLE AND VERIZON FIBER OPTIC
- CABLE FROM THE BUILDING TO THE TRAILER. 3. EXISTING NETWORK RACK AND EXISTING VERIZON EQUIPMENT TO BE MOVED FROM THE DRAFTING ROOM TO THE TRAILER. CONTRACTOR
- TO RELOCATE EQUIPMENT, WIRING AND OTHER ITEMS ASSOCIATED WITH THE RELOCATION IN COORDINATION WITH NYC-DEP & VERIZON. 4. EXISTING UPS RACK TO BE MOVED FROM THE STORAGE ROOM IN THE
- BASEMENT TO THE TRAILER. 5. COORDINATE SERVER DOWNTIME WITH THE D.E.P. DOWNTIME CAUSED BY THE RELOCATION OF THE NETWORK RACK & UPS NOT TO
- EXCEED 24 CONSECUTIVE HOURS. A MINIMUM OF 96 HOURS OF CONTINUOUS NETWORK OPERATION IS TO BE PROVIDED BETWEEN EACH DOWNTIME PERIOD. PROVIDE MINIMUM SEVEN (7) DAYS NOTICE OF ANY DOWNTIME.
- 6. SEE ELECTRICAL SITE PLAN E1-100 FOR POWER CONNECTION TO THE TRAILER.



1. RELOCATE EXISTING UPS RACK IN TO ELEC ROOM 111.

	3/16"=1'−0"	5 10 FT.
BID SET		
	IF SHEET IS LESS TH IT IS A REDUCE SCALE ACCC	ED PRINT.
REPURPOSING OF THE KENSICO LABORATORY AS THE KENSICO REGIONAL HEADQUARTERS MOUNT PLEASANT, NEW YORK CONTRACT CRO-624 SECURITY SYSTEM BASEMENT PLAN		DATE: MAY 2023 SCALE: SHEET NO:
		113 ог №.121 Drawing no. SC-101
	REPURPOSING OF THE KENSICO THE KENSICO REGIONAL HE MOUNT PLEASANT, NE CONTRACT CRO- SECURITY SYSTE	BID SET IF SHEET IS LESS TH IT IS A REDUCE SCALE ACCO REPURPOSING OF THE KENSICO LABORATORY AS THE KENSICO REGIONAL HEADQUARTERS MOUNT PLEASANT, NEW YORK CONTRACT CRO-624 SECURITY SYSTEM

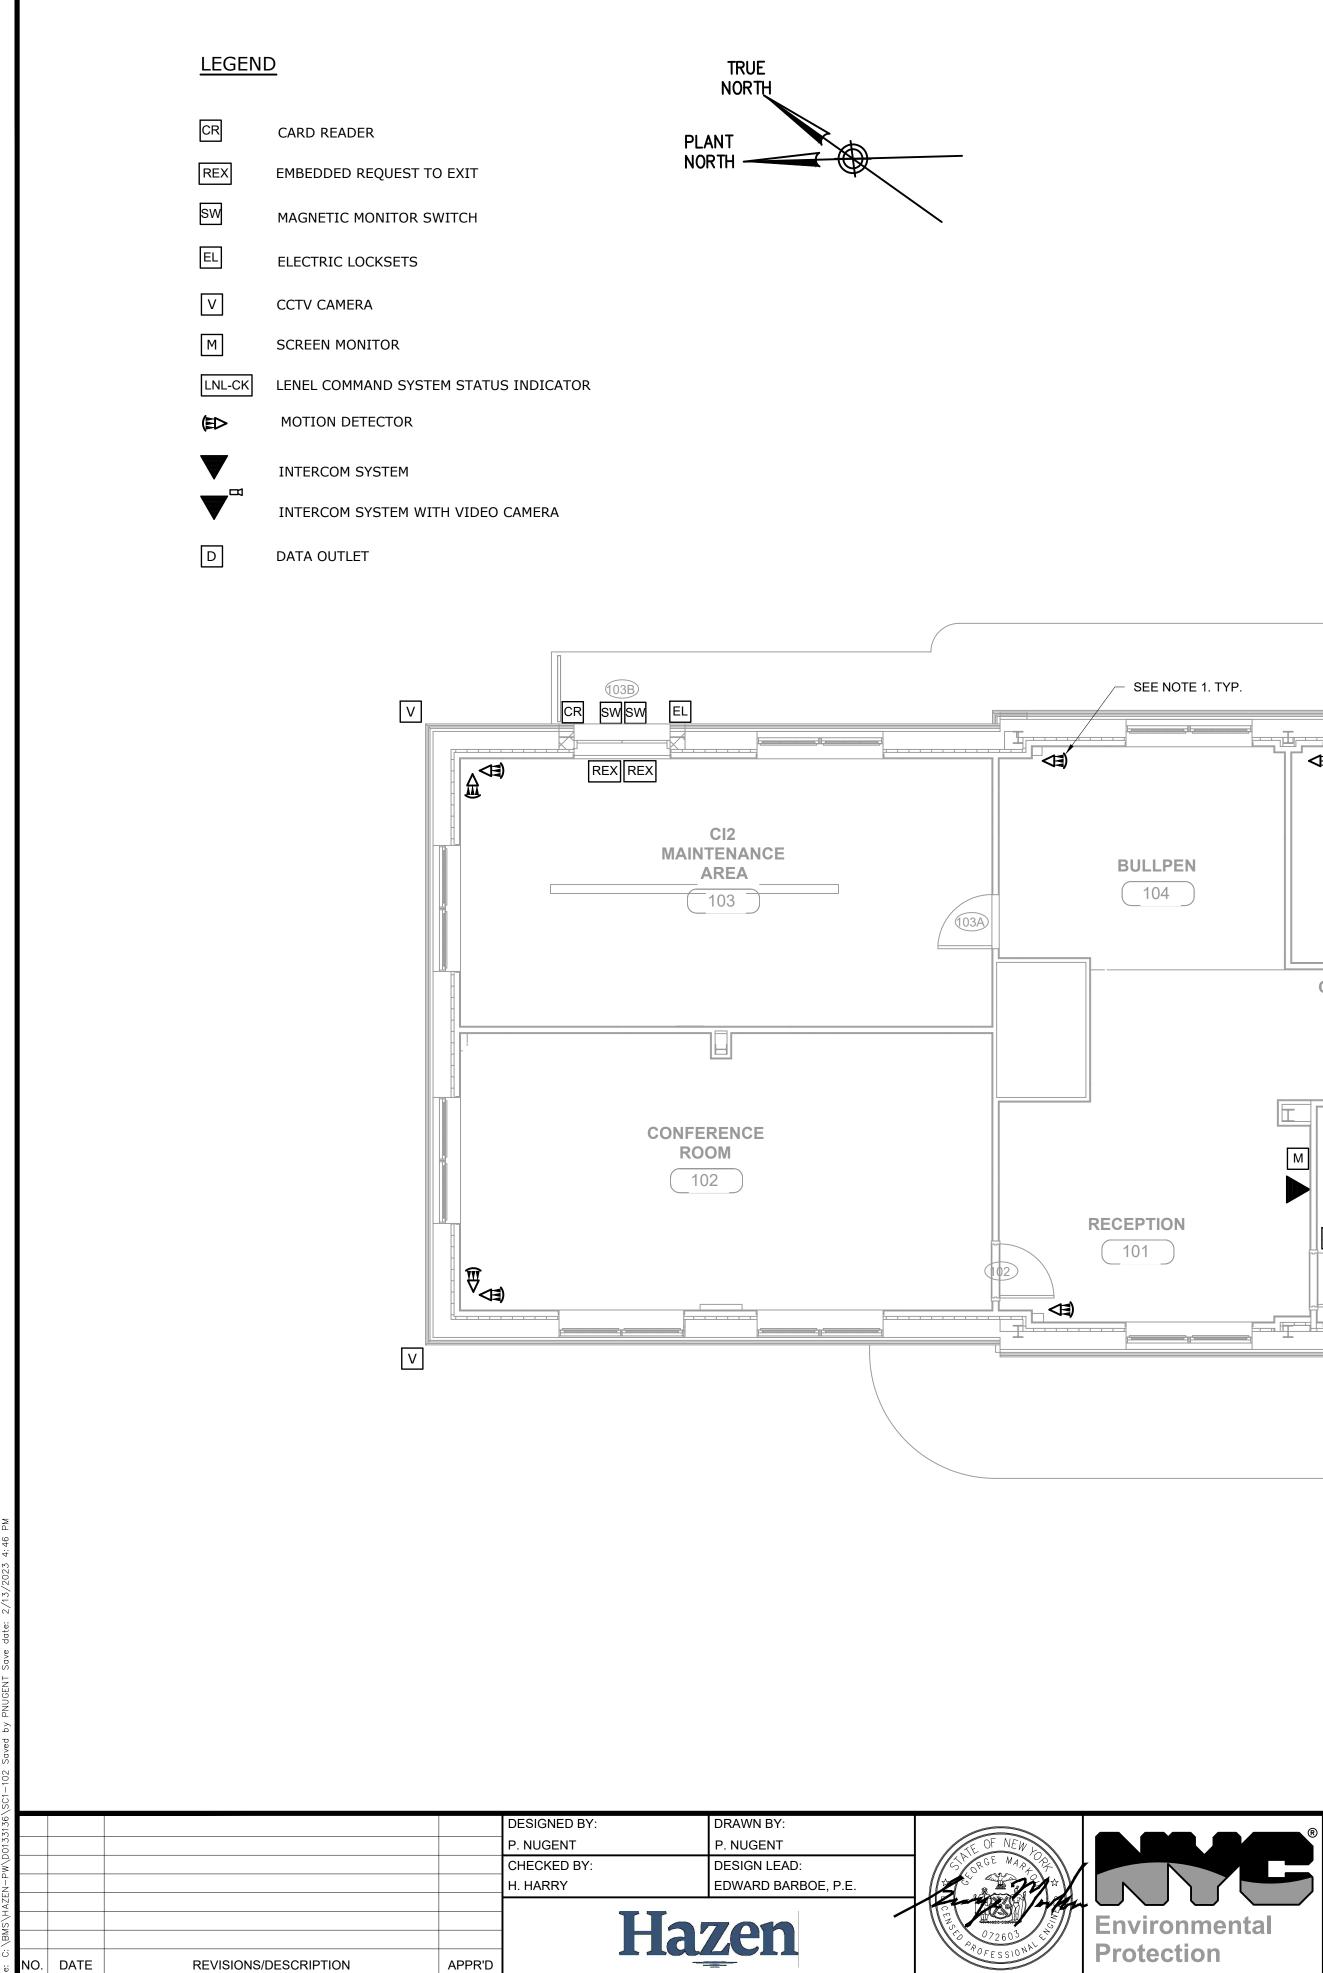

All inquiries regarding this drawing(s) or project should be made to NYC Environmental Protection, Bureau of Water Supply.

		n			
- SEE NOTE 1. TYP.					
et la			REX		
	TOS OFFICE		CORRIDOR		110A
			(1C02)	15 (20)	SW
BULLPEN				MEN'S	
104				RESTROOM/LOCKER	RS
	(105)				
			CL		SW SW
	CORRIDOR				ELEC CLOSE
	(1C01)		108		
			100		
	M				SEE
RECEPTION	sw	ESTIBULE			
101				WOMEN'S	
	100B			ESTROOM/LOCKERS	
<b>(5)</b>					
		SW CR L	V		

# SECURITY SYSTEM PLAN EL 367.00 GROUND FLOOR

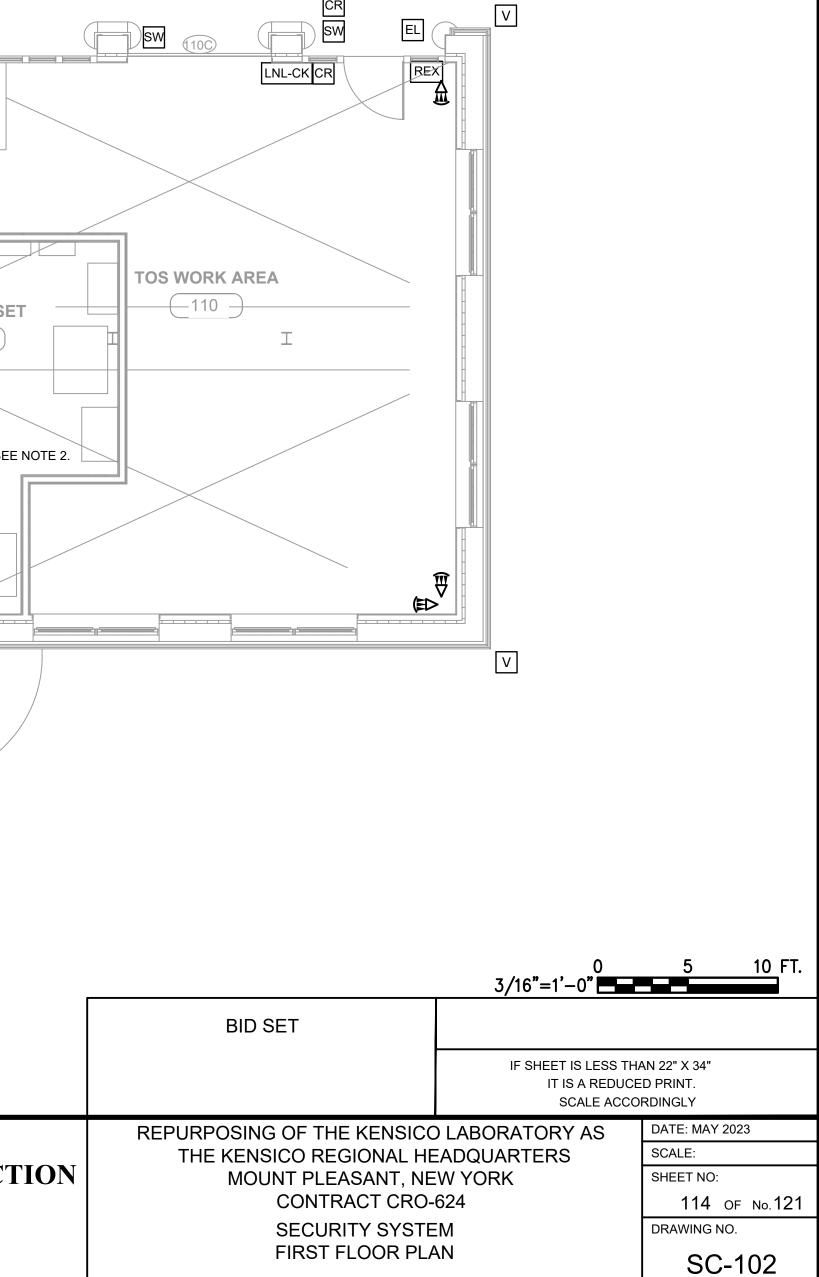
ACCOUNTABLE MANAGER
JOSE NIEVES
PROJECT MANAGER
MARK DELBALZO, P.E.

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# NOTES:

- 1. MOTION DETECTORS SHALL BE MOUNTED FACING WINDOWS.
- 2. RELOCATE EXISTING UPS RACK IN EXIST. STORAGE ROOM B02 TO ELEC ROOM 111.



## <u>LEGEND</u>


CR	CARD READER
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sw MAGNETIC MONITOR SWITCH


EL ELECTRIC LOCKSETS


М SCREEN MONITOR

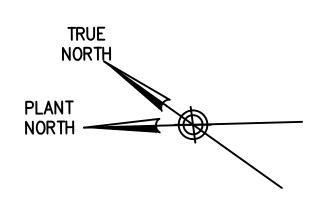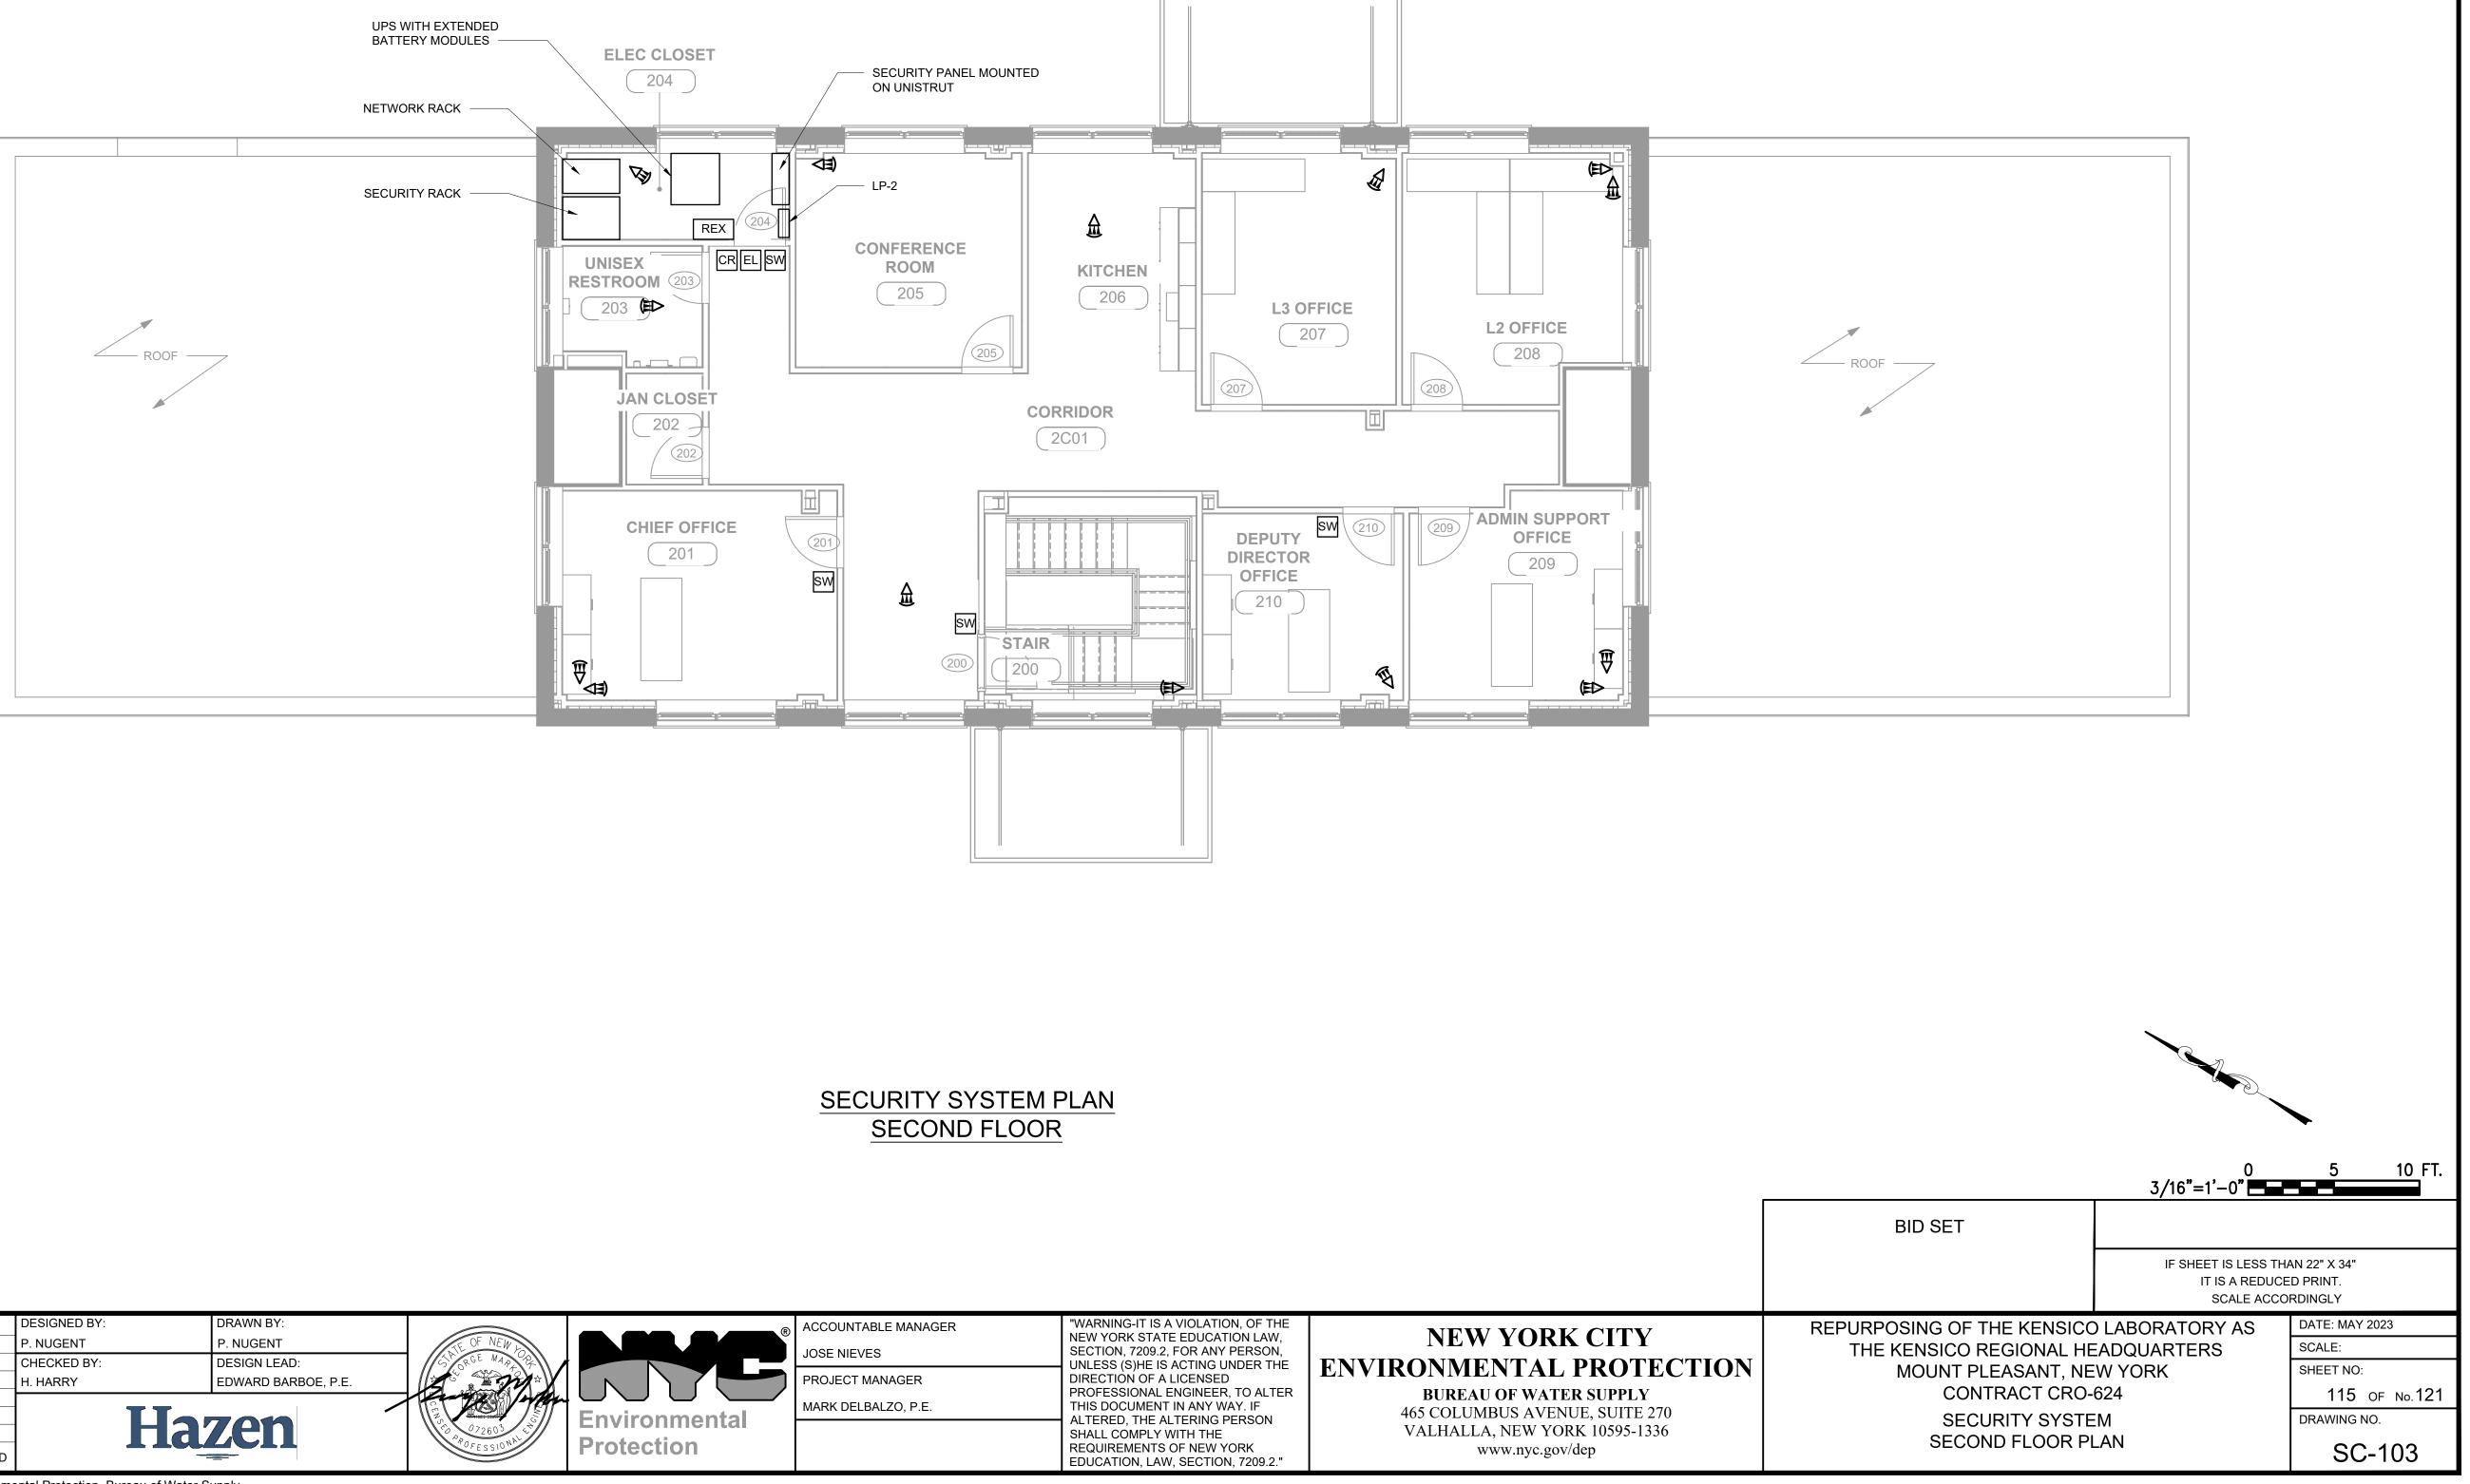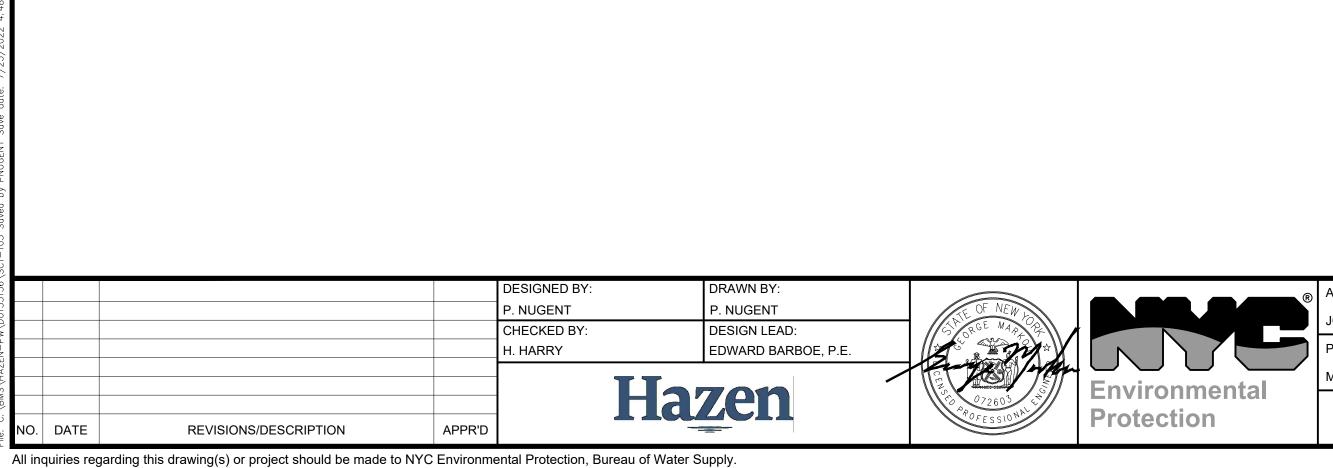MOTION DETECTOR 










ACCOUNTABLE MANAGER	
JOSE NIEVES	
PROJECT MANAGER	
MARK DELBALZO, P.E.	

# NOTES:

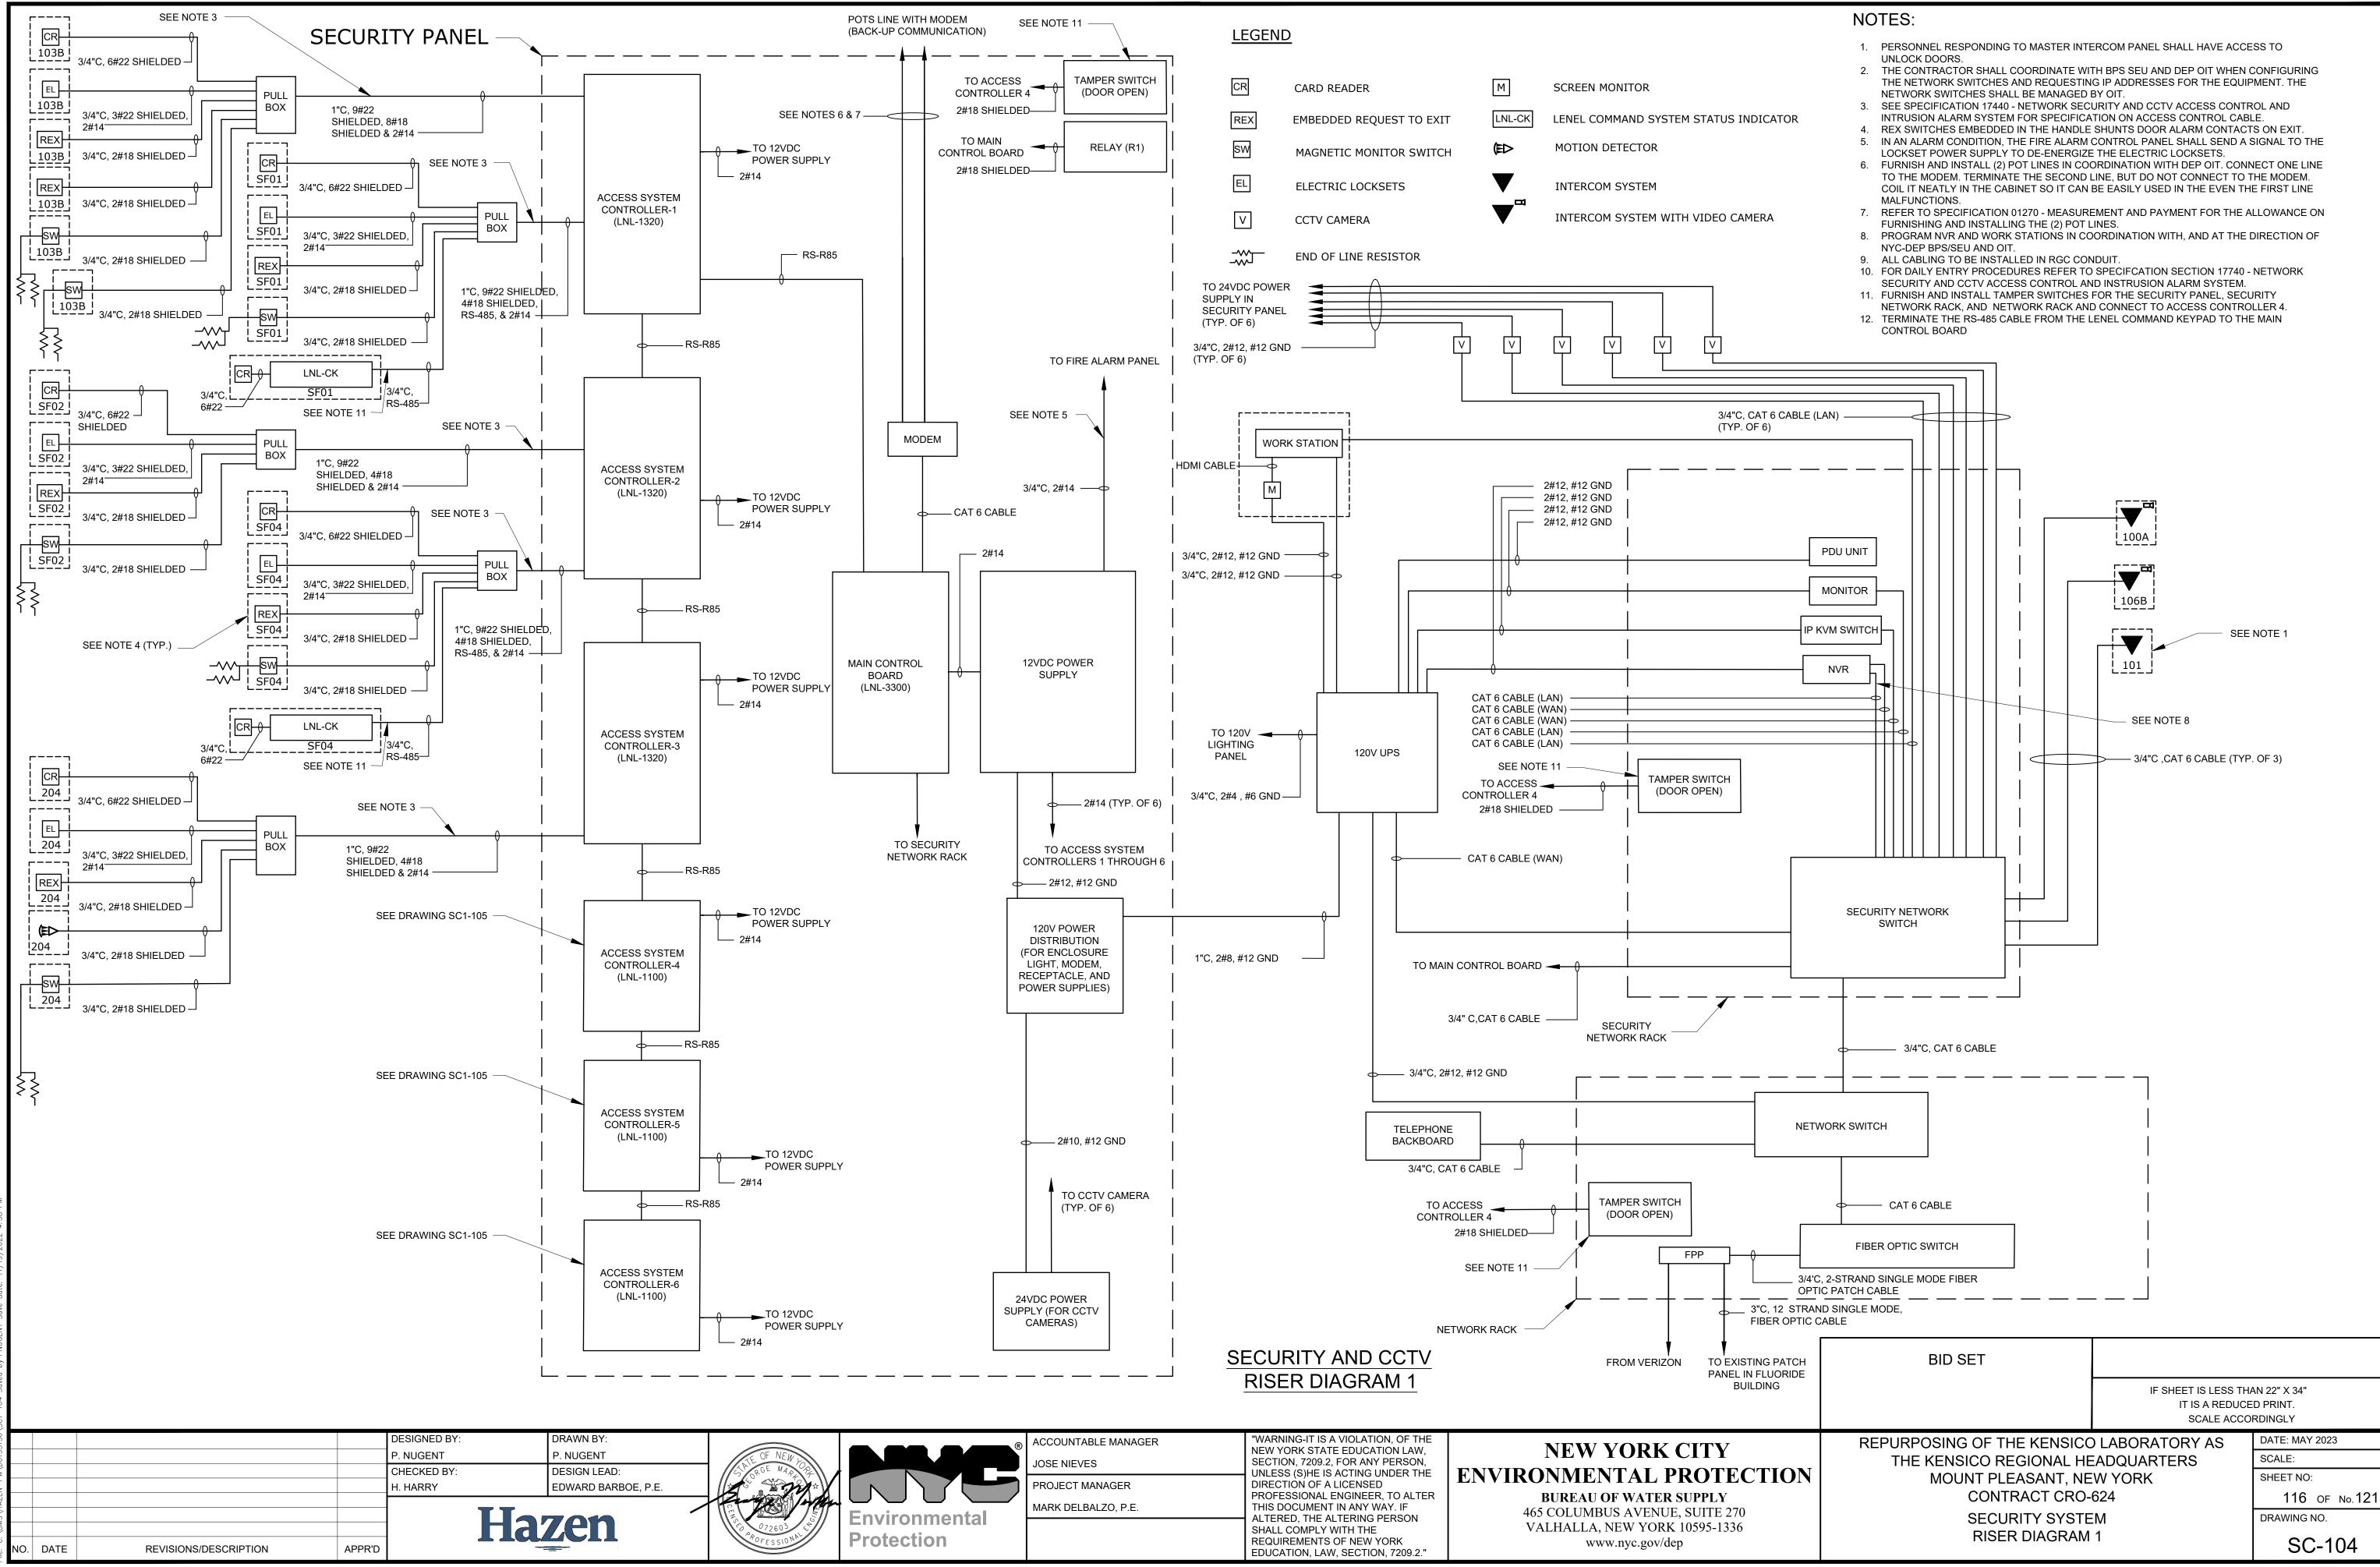- 1. PROVIDE INTRUSION DETECTION TAMPER SWITCHES FOR SECURITY PANEL, THE SECURITY
- NETWORK RACK, AND THE NETWORK RACK. 2. MOTION DETECTORS SHALL BE MOUNTED FACING WINDOWS.





NO	TES:
1.	PERSONNEL RESPONDING TO MAST

## LEGEND

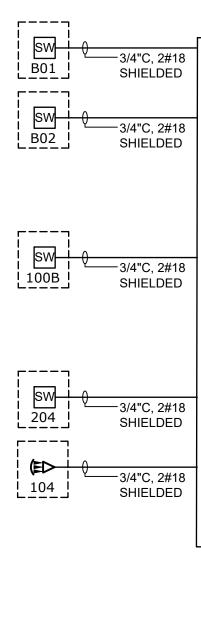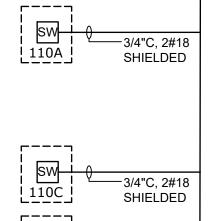SW MAGNETIC MONITOR SWITCH


MOTION DETECTOR 







SW 3/4"C, 2#18 111 SHIELDED

		H. HARRY	EDWARD BARBOE, P.E.	
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		CHECKED BY:	DESIGN LEAD:	- I AR GE MAN PR
		P. NUGENT	P. NUGENT	TE OF NEW LA
		DESIGNED BY:	DRAWN BY:	

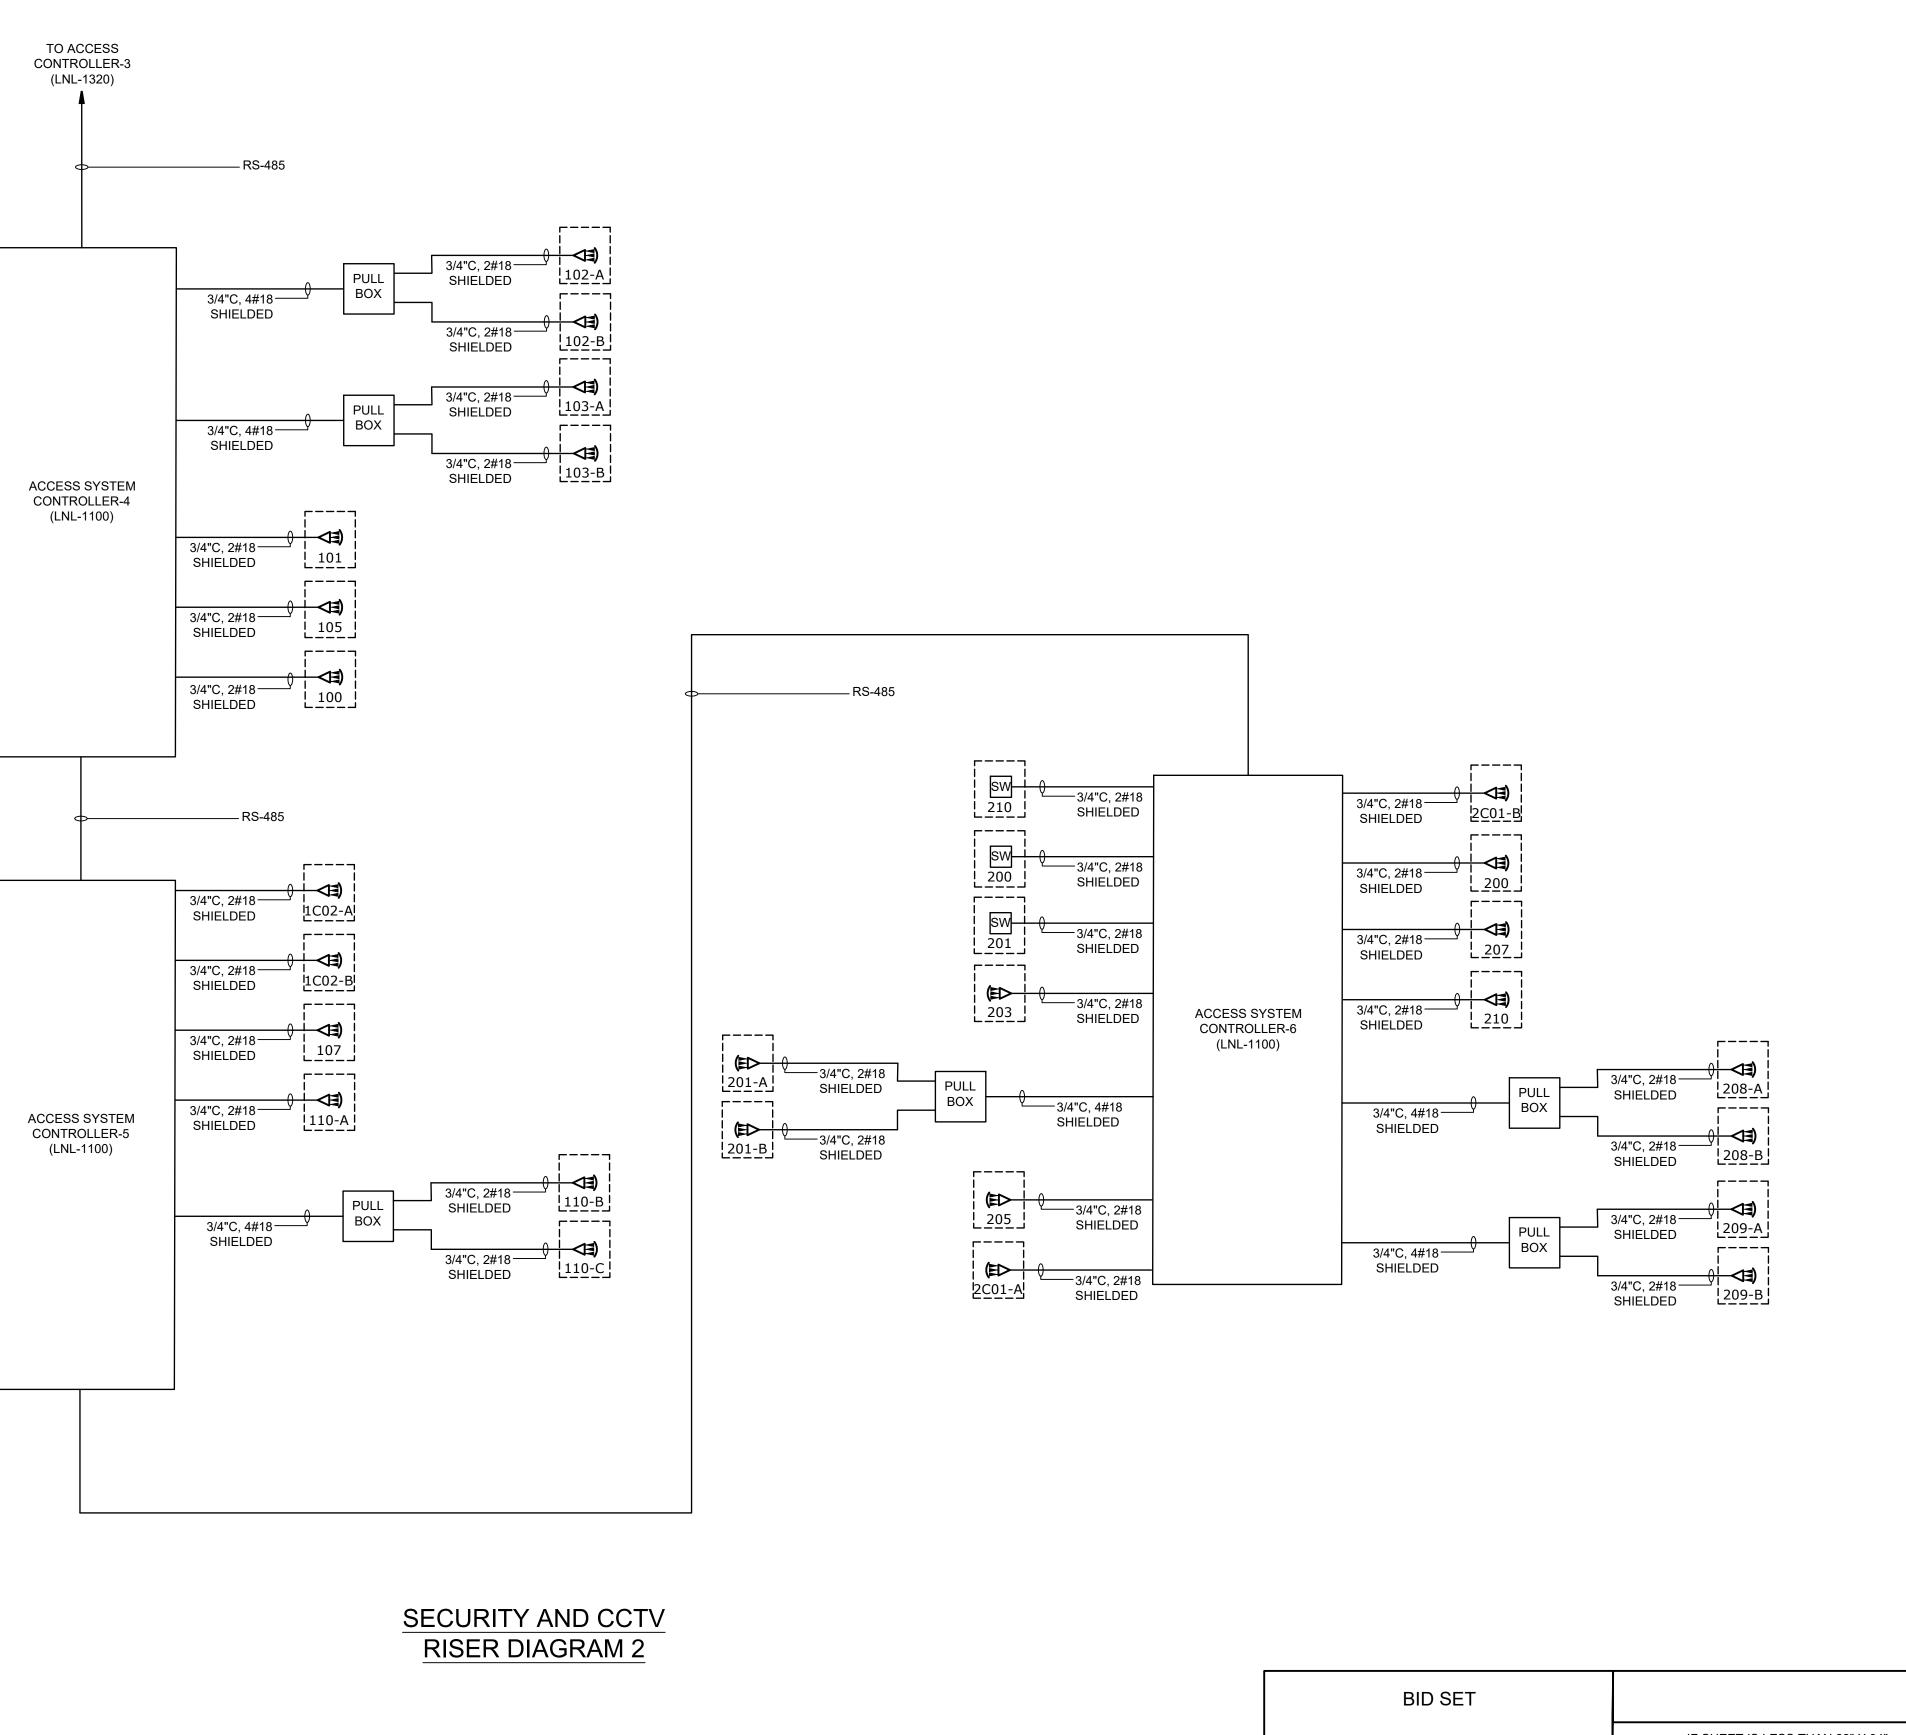


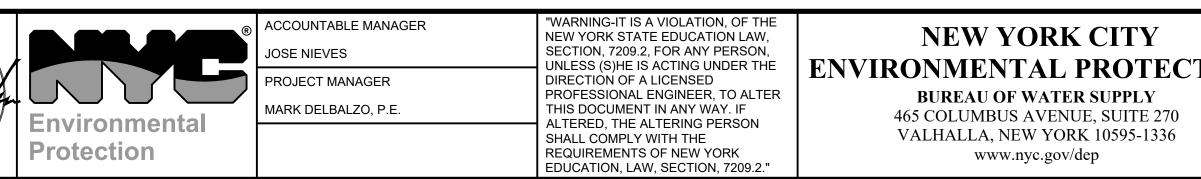


	BID SET		
		IF SHEET IS LESS THA IT IS A REDUCE SCALE ACCO	D PRINT.
	REPURPOSING OF THE KENSICC	LABORATORY AS	DATE: MAY 2023
	THE KENSICO REGIONAL HE	EADQUARTERS	SCALE:
ΓΙΟΝ	N MOUNT PLEASANT, NEW YORK CONTRACT CRO-624 SECURITY SYSTEM RISER DIAGRAM 2		SHEET NO:
			117 OF No.121
			DRAWING NO.
			SC-105

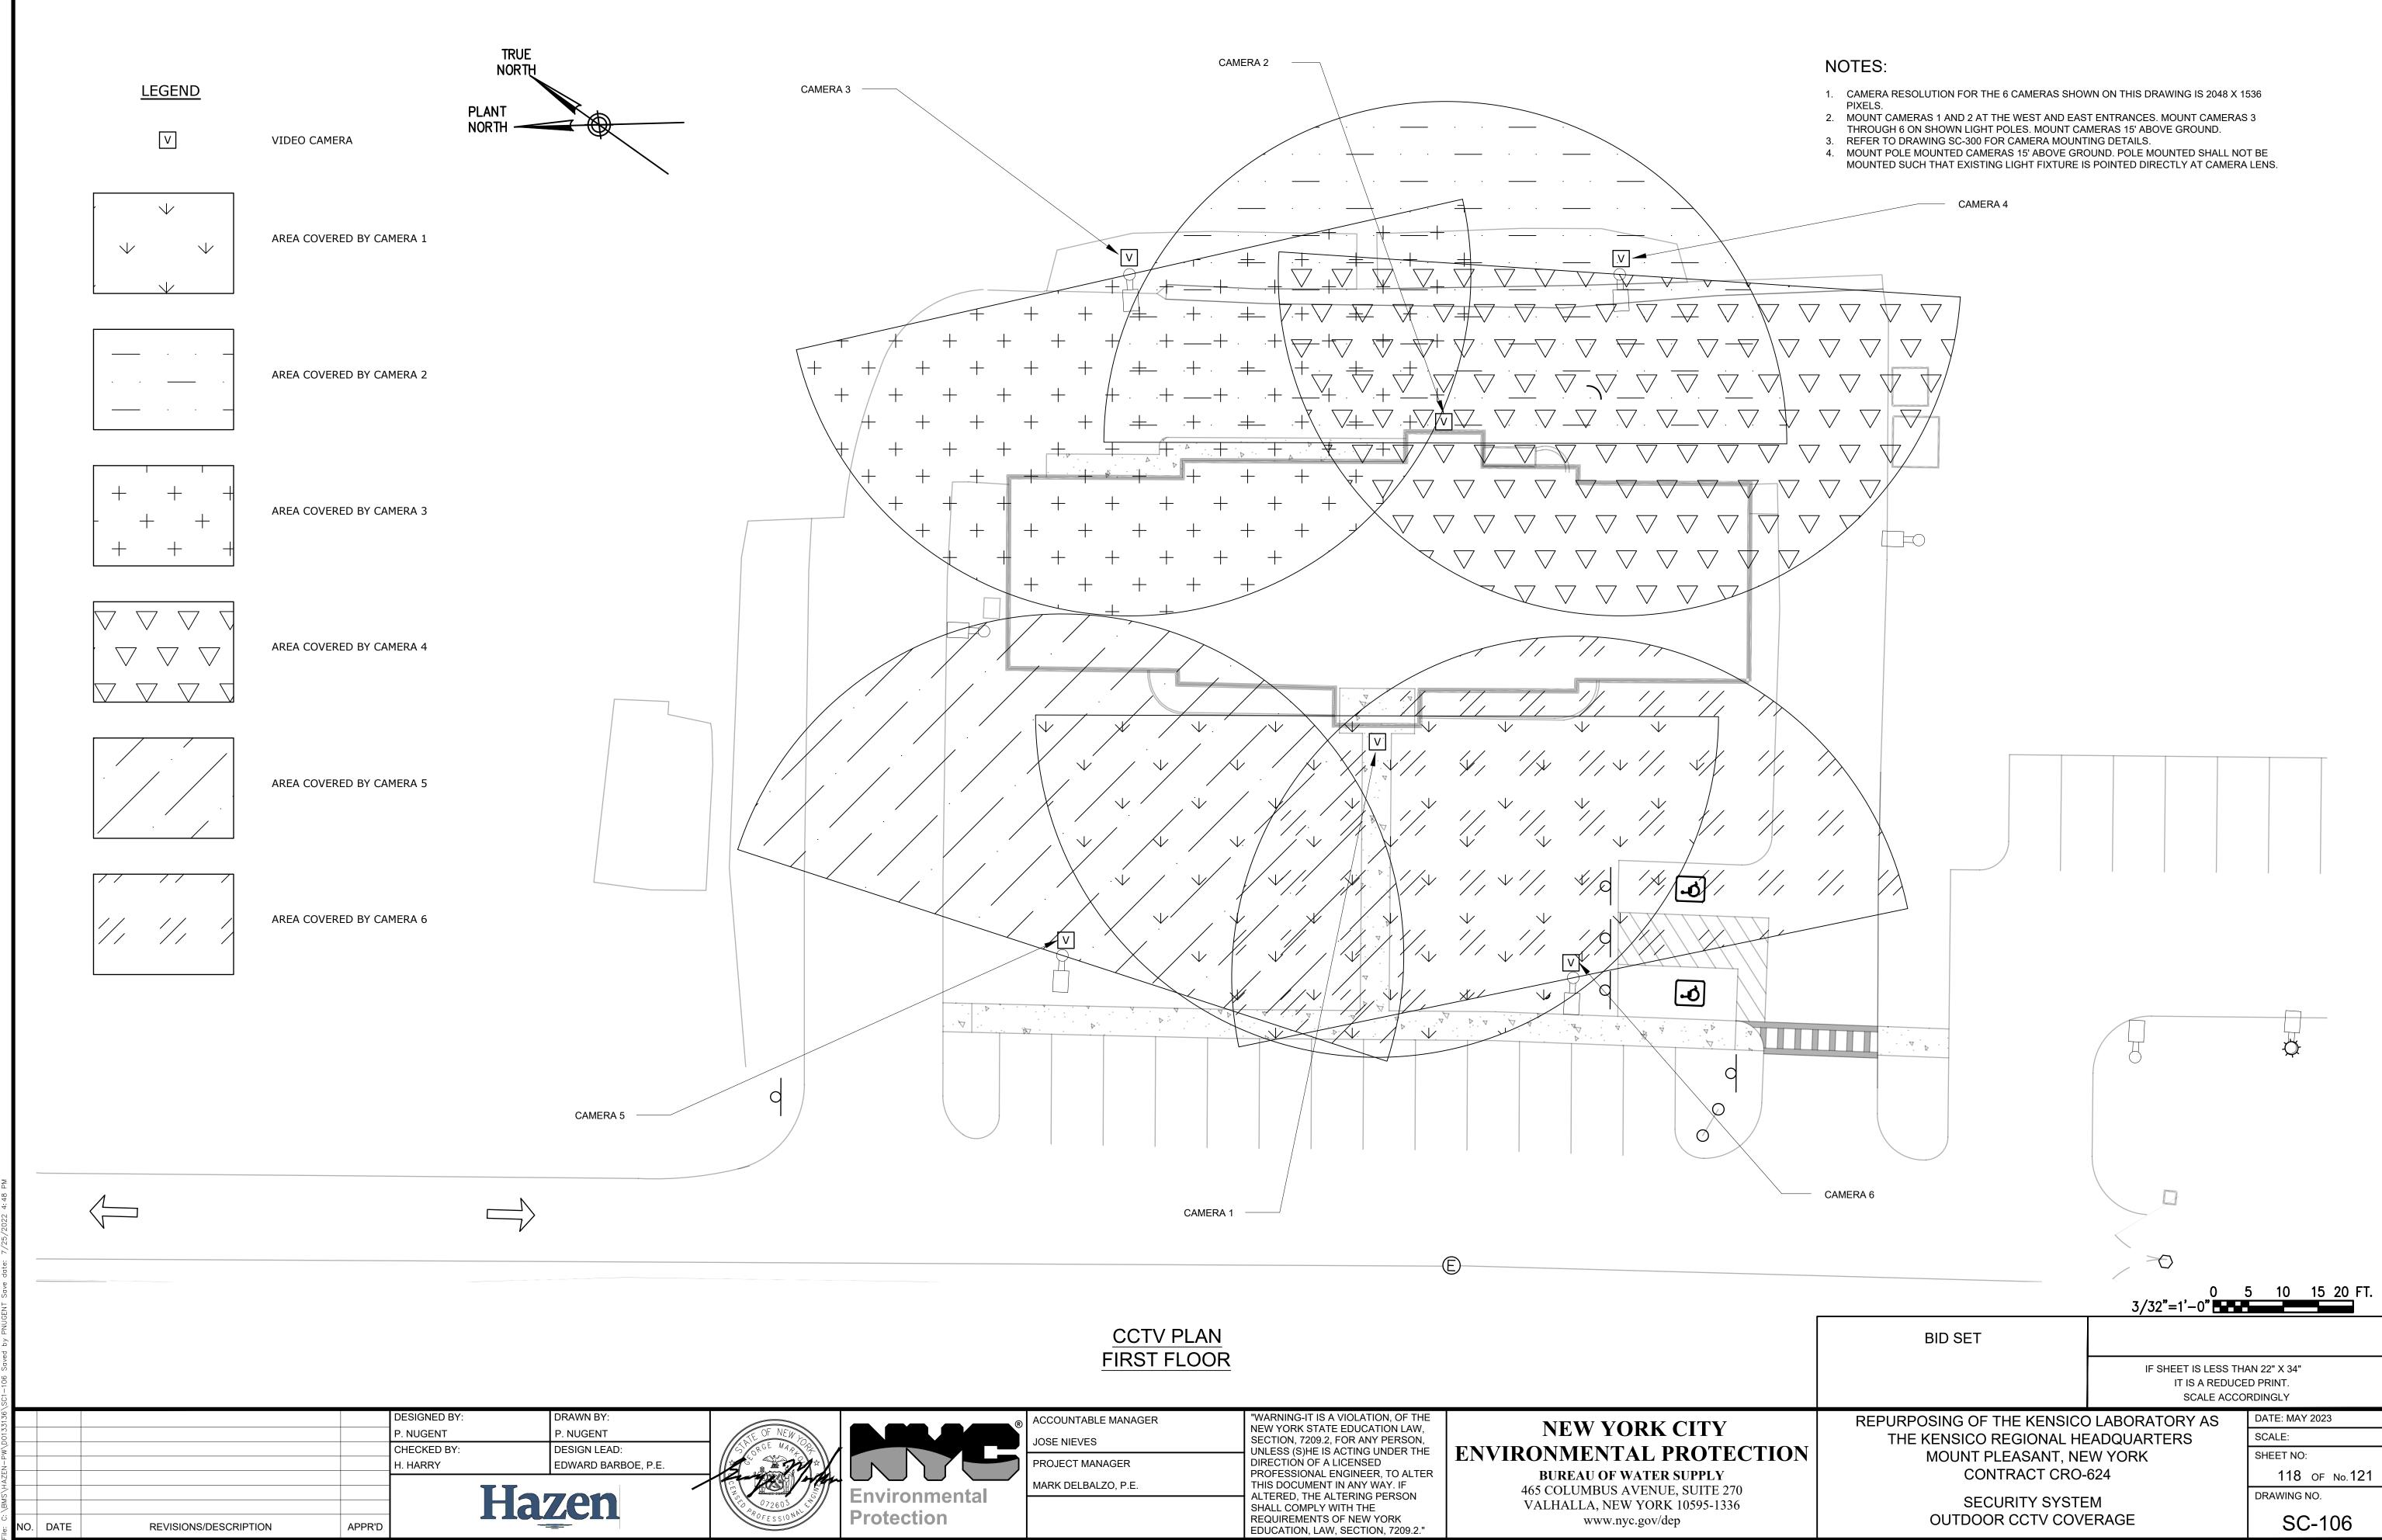


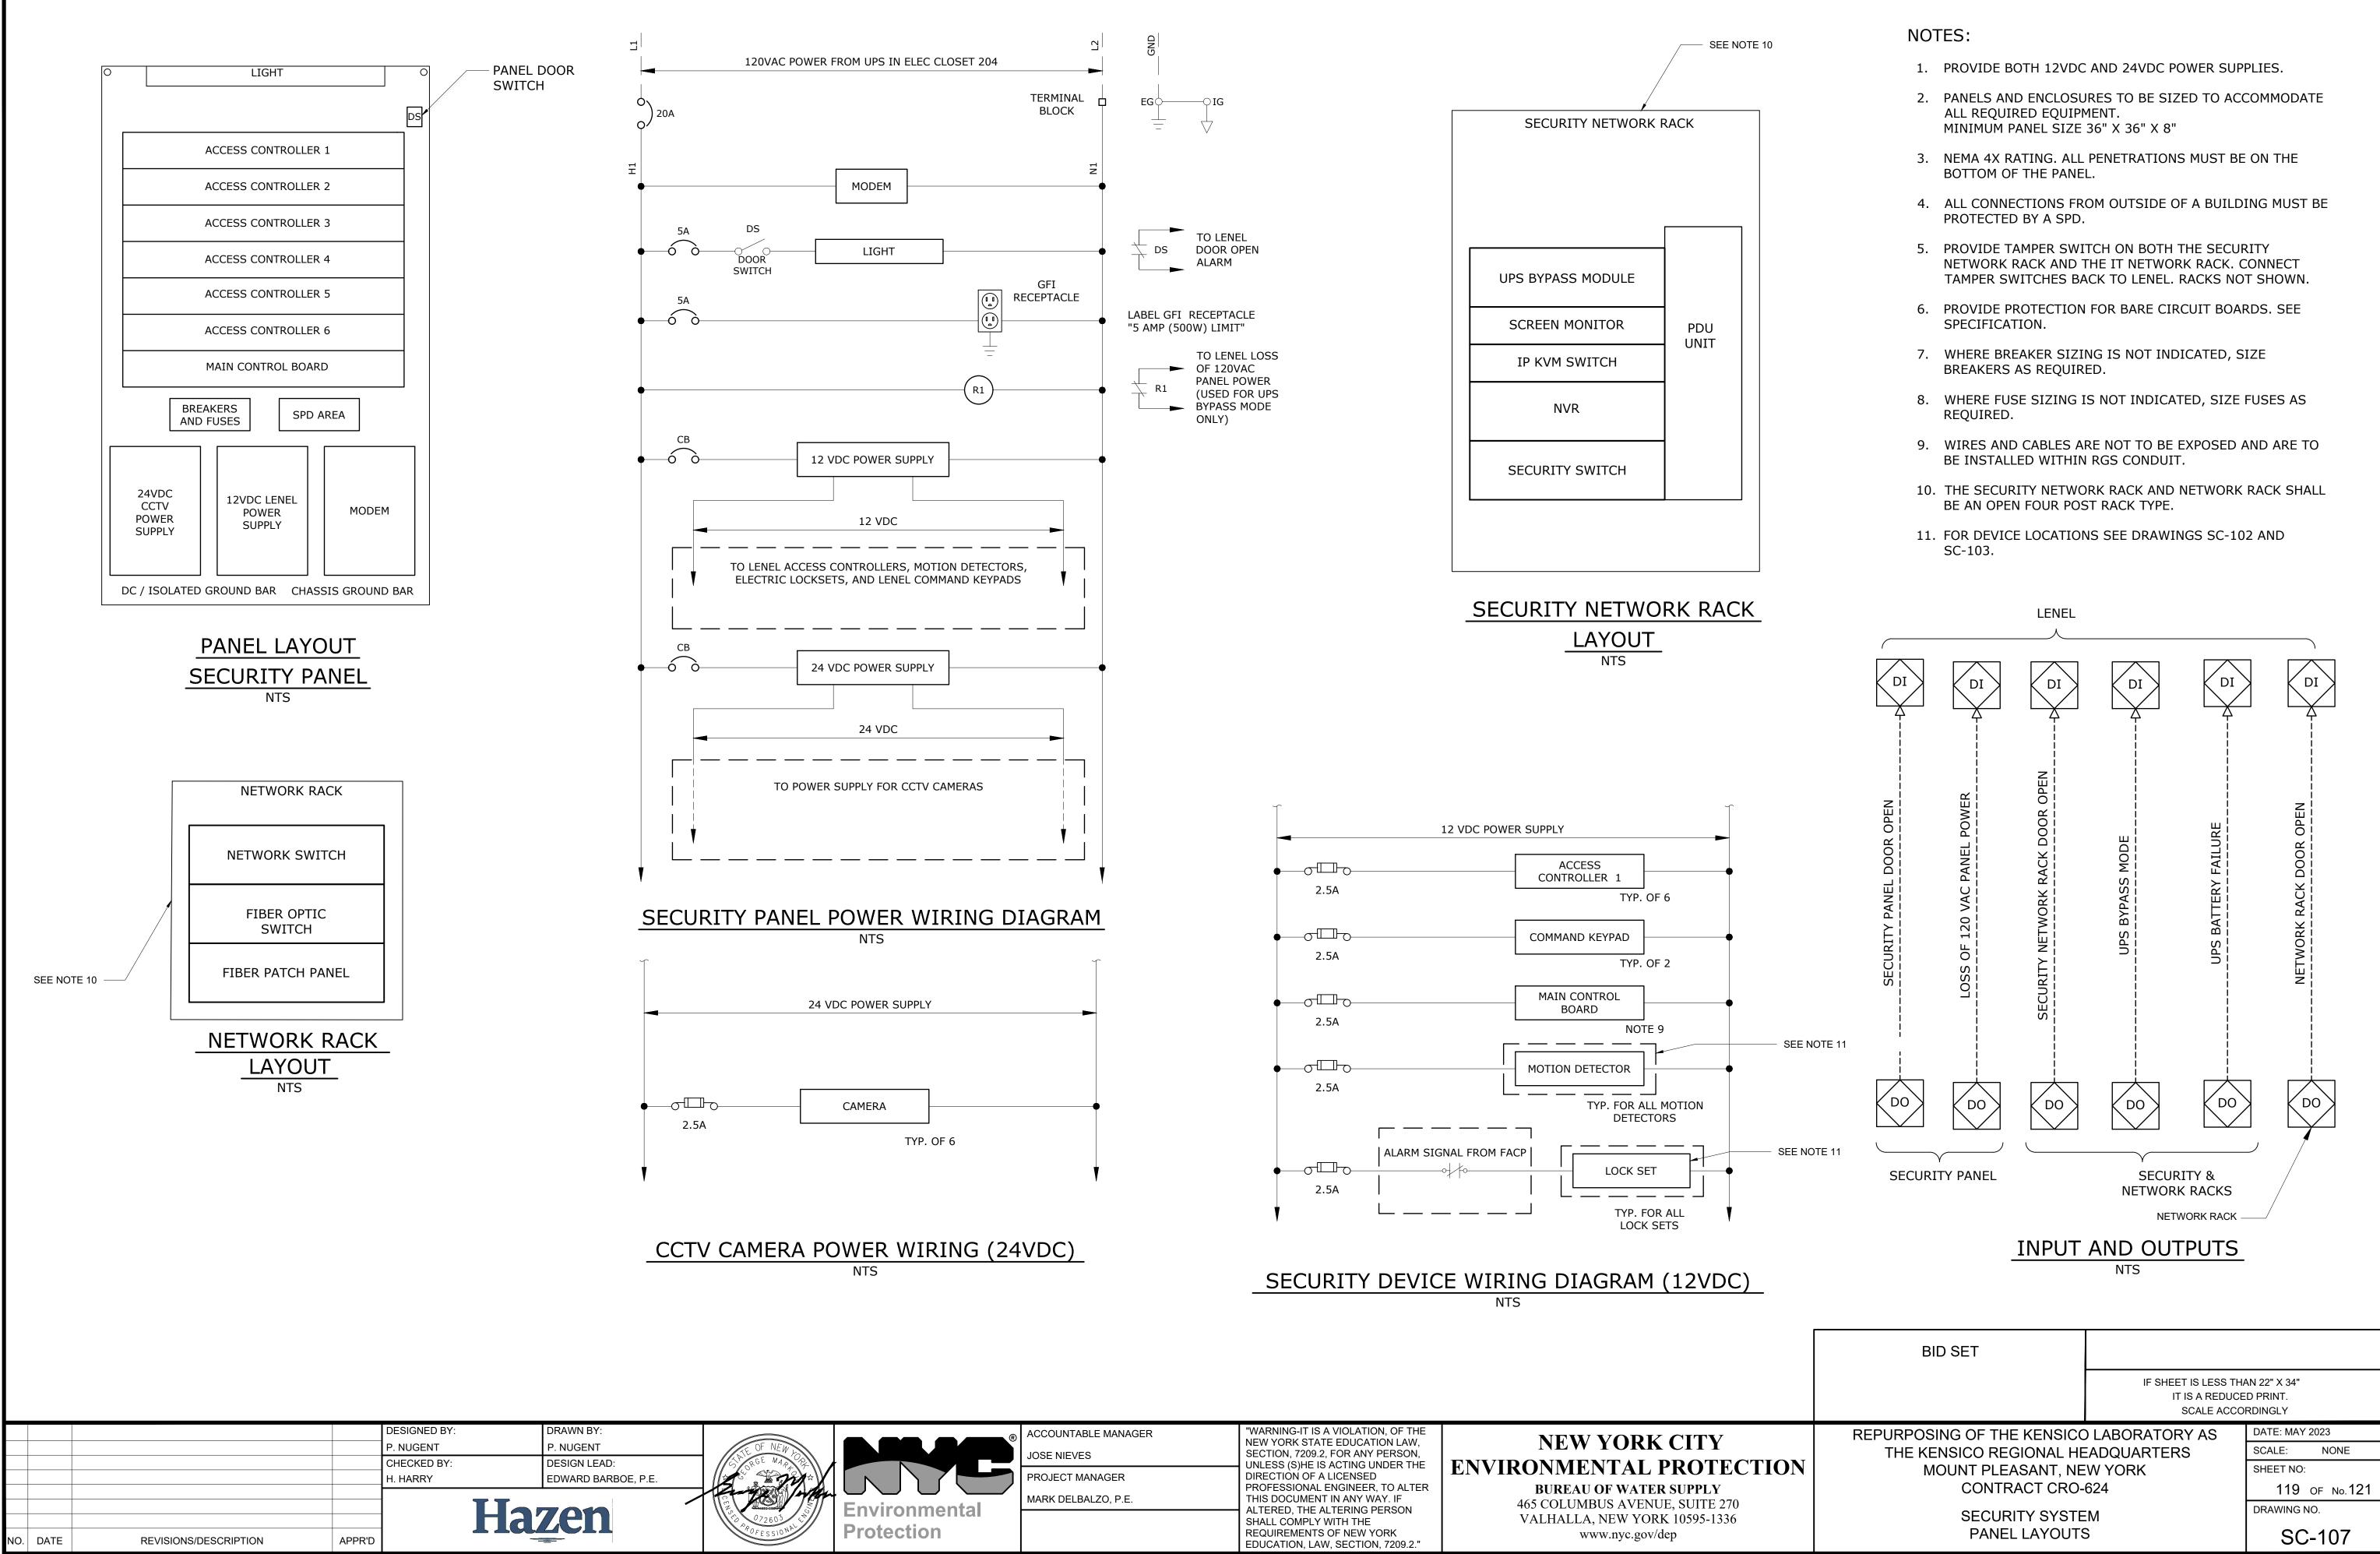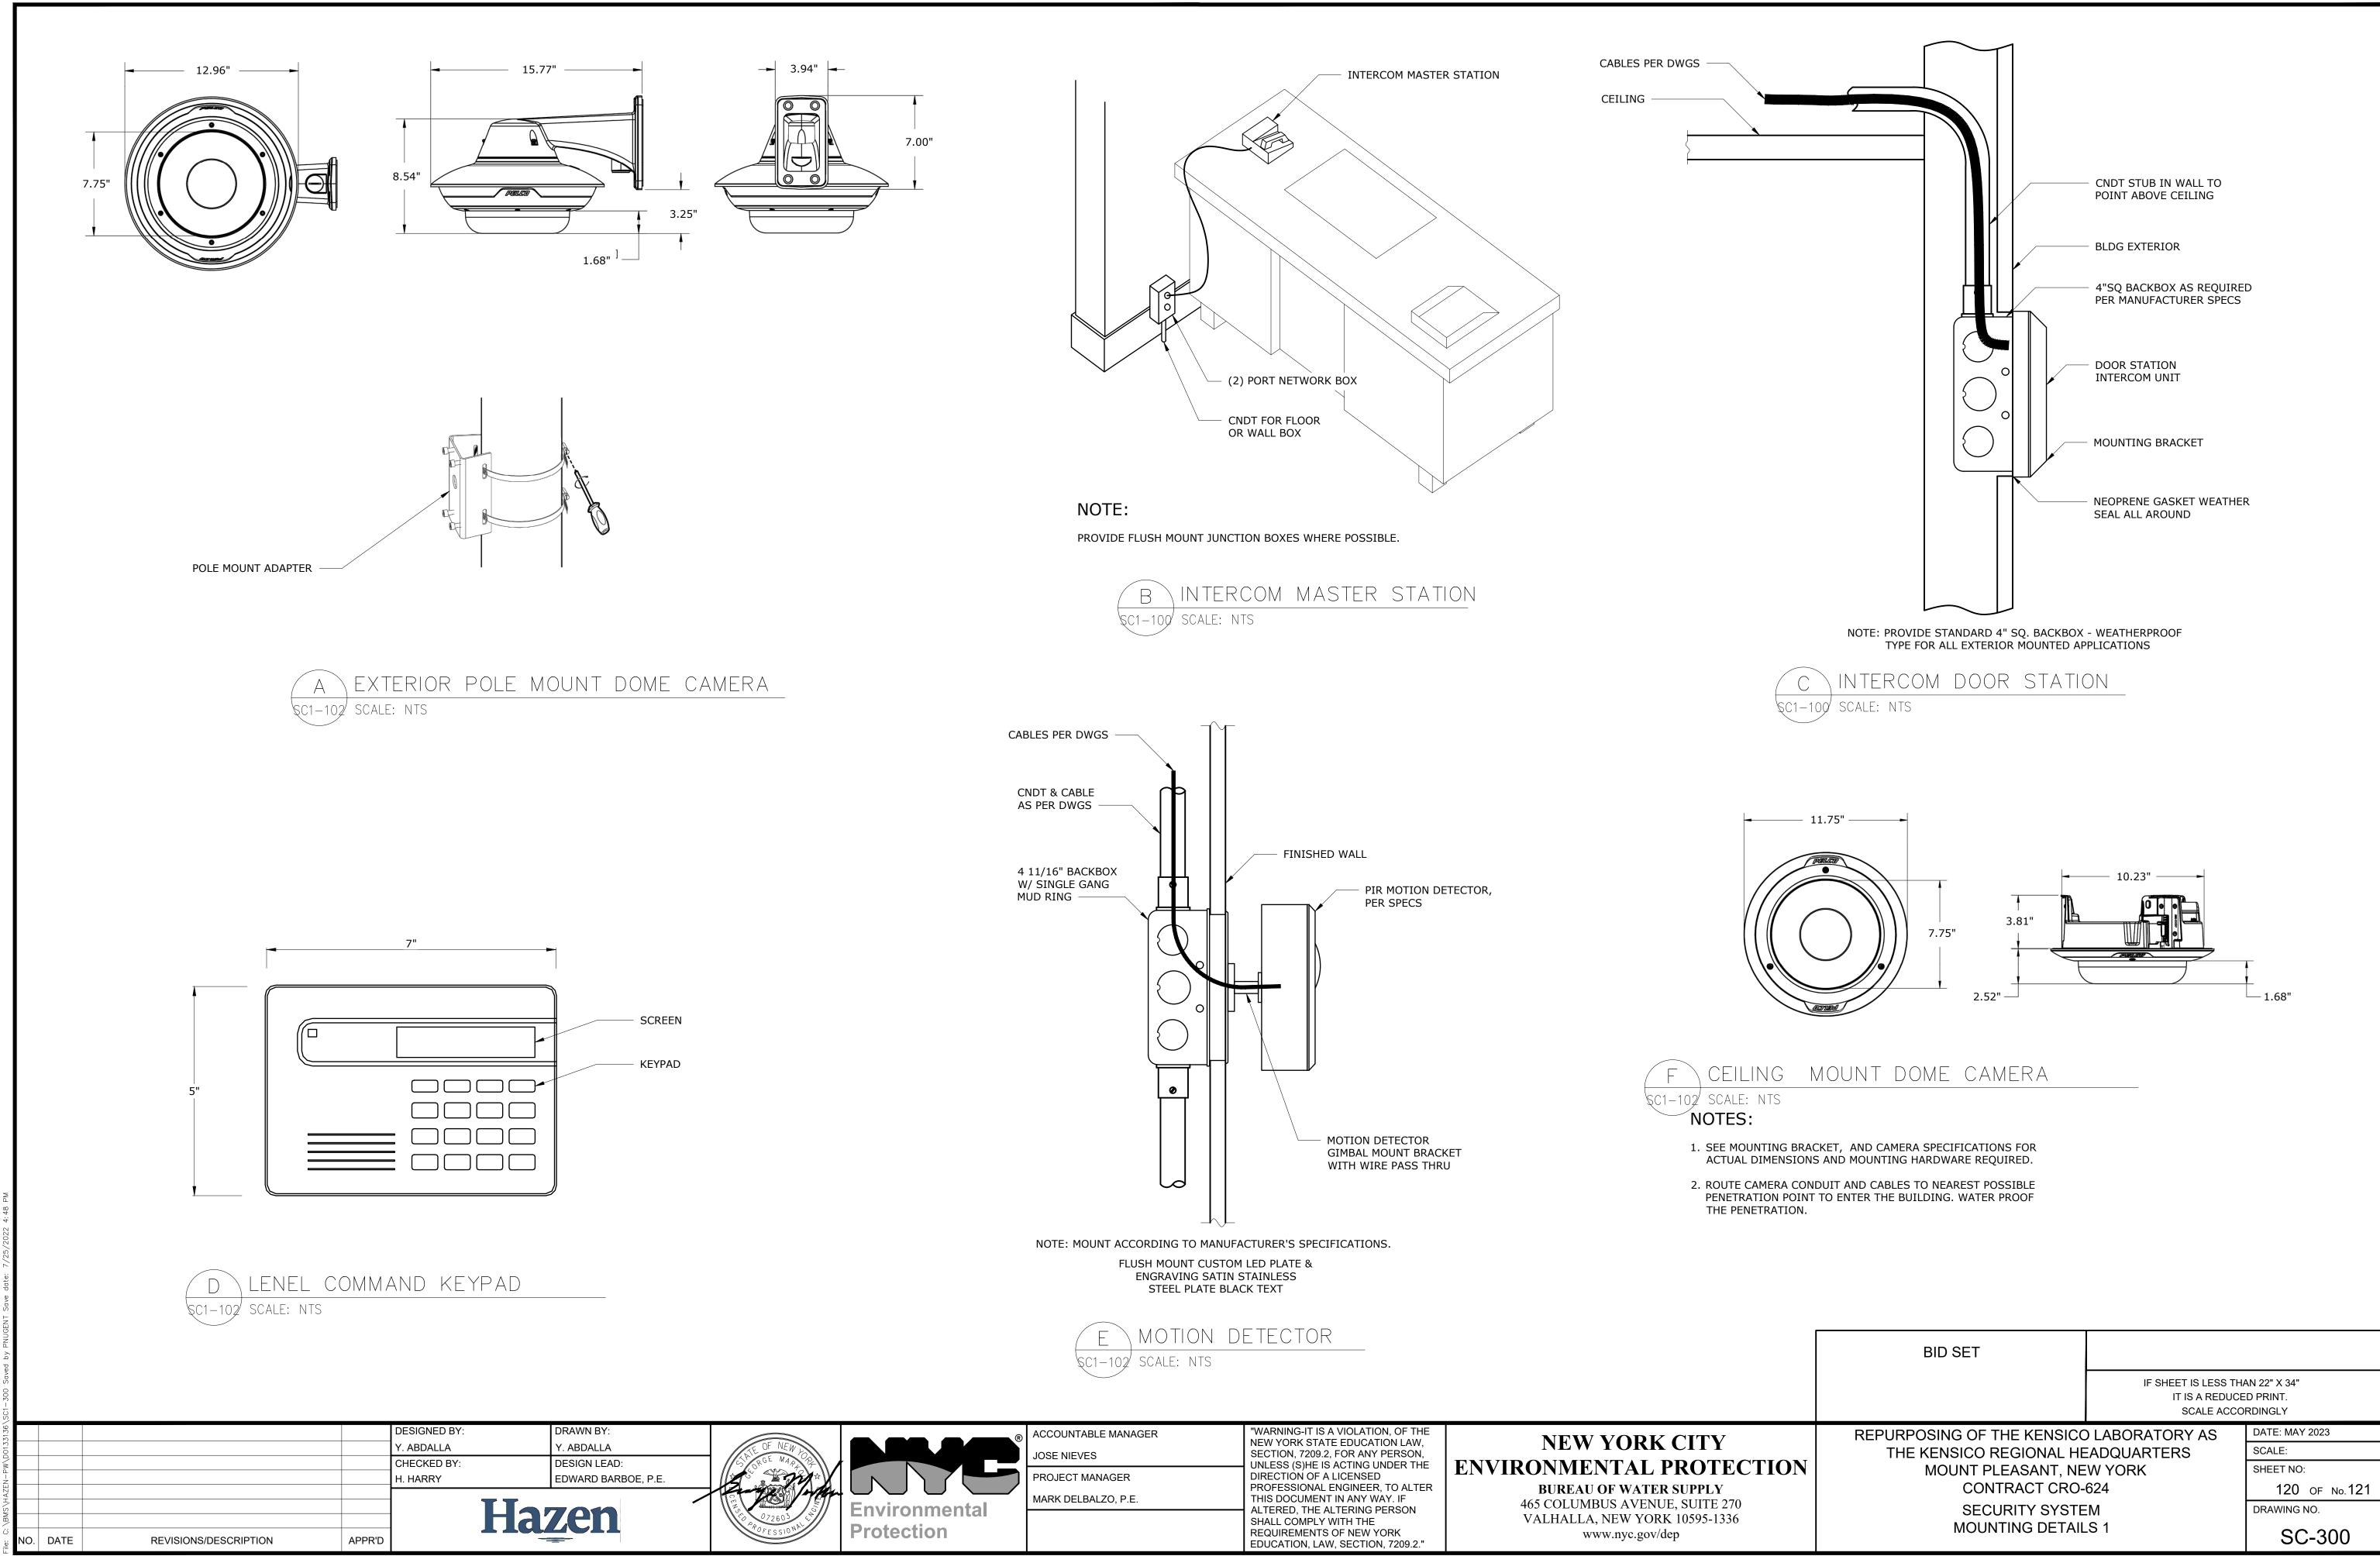ACCOUNTABLE MANAGER
JOSE NIEVES
PROJECT MANAGER
MARK DELBALZO, P.E.





COUNTABLE MANAGER	"WARNING-IT IS A VIOLATION, OF THE NEW YORK STATE EDUCATION LAW,	NEW YO
SE NIEVES	SECTION, 7209.2, FOR ANY PERSON, UNLESS (S)HE IS ACTING UNDER THE	
OJECT MANAGER	DIRECTION OF A LICENSED	ENVIRONMENTA
RK DELBALZO, P.E.	PROFESSIONAL ENGINEER, TO ALTER THIS DOCUMENT IN ANY WAY. IF	BUREAU OF W 465 COLUMBUS A
	ALTERED, THE ALTERING PERSON SHALL COMPLY WITH THE	VALHALLA, NEW
	REQUIREMENTS OF NEW YORK	www.nyc

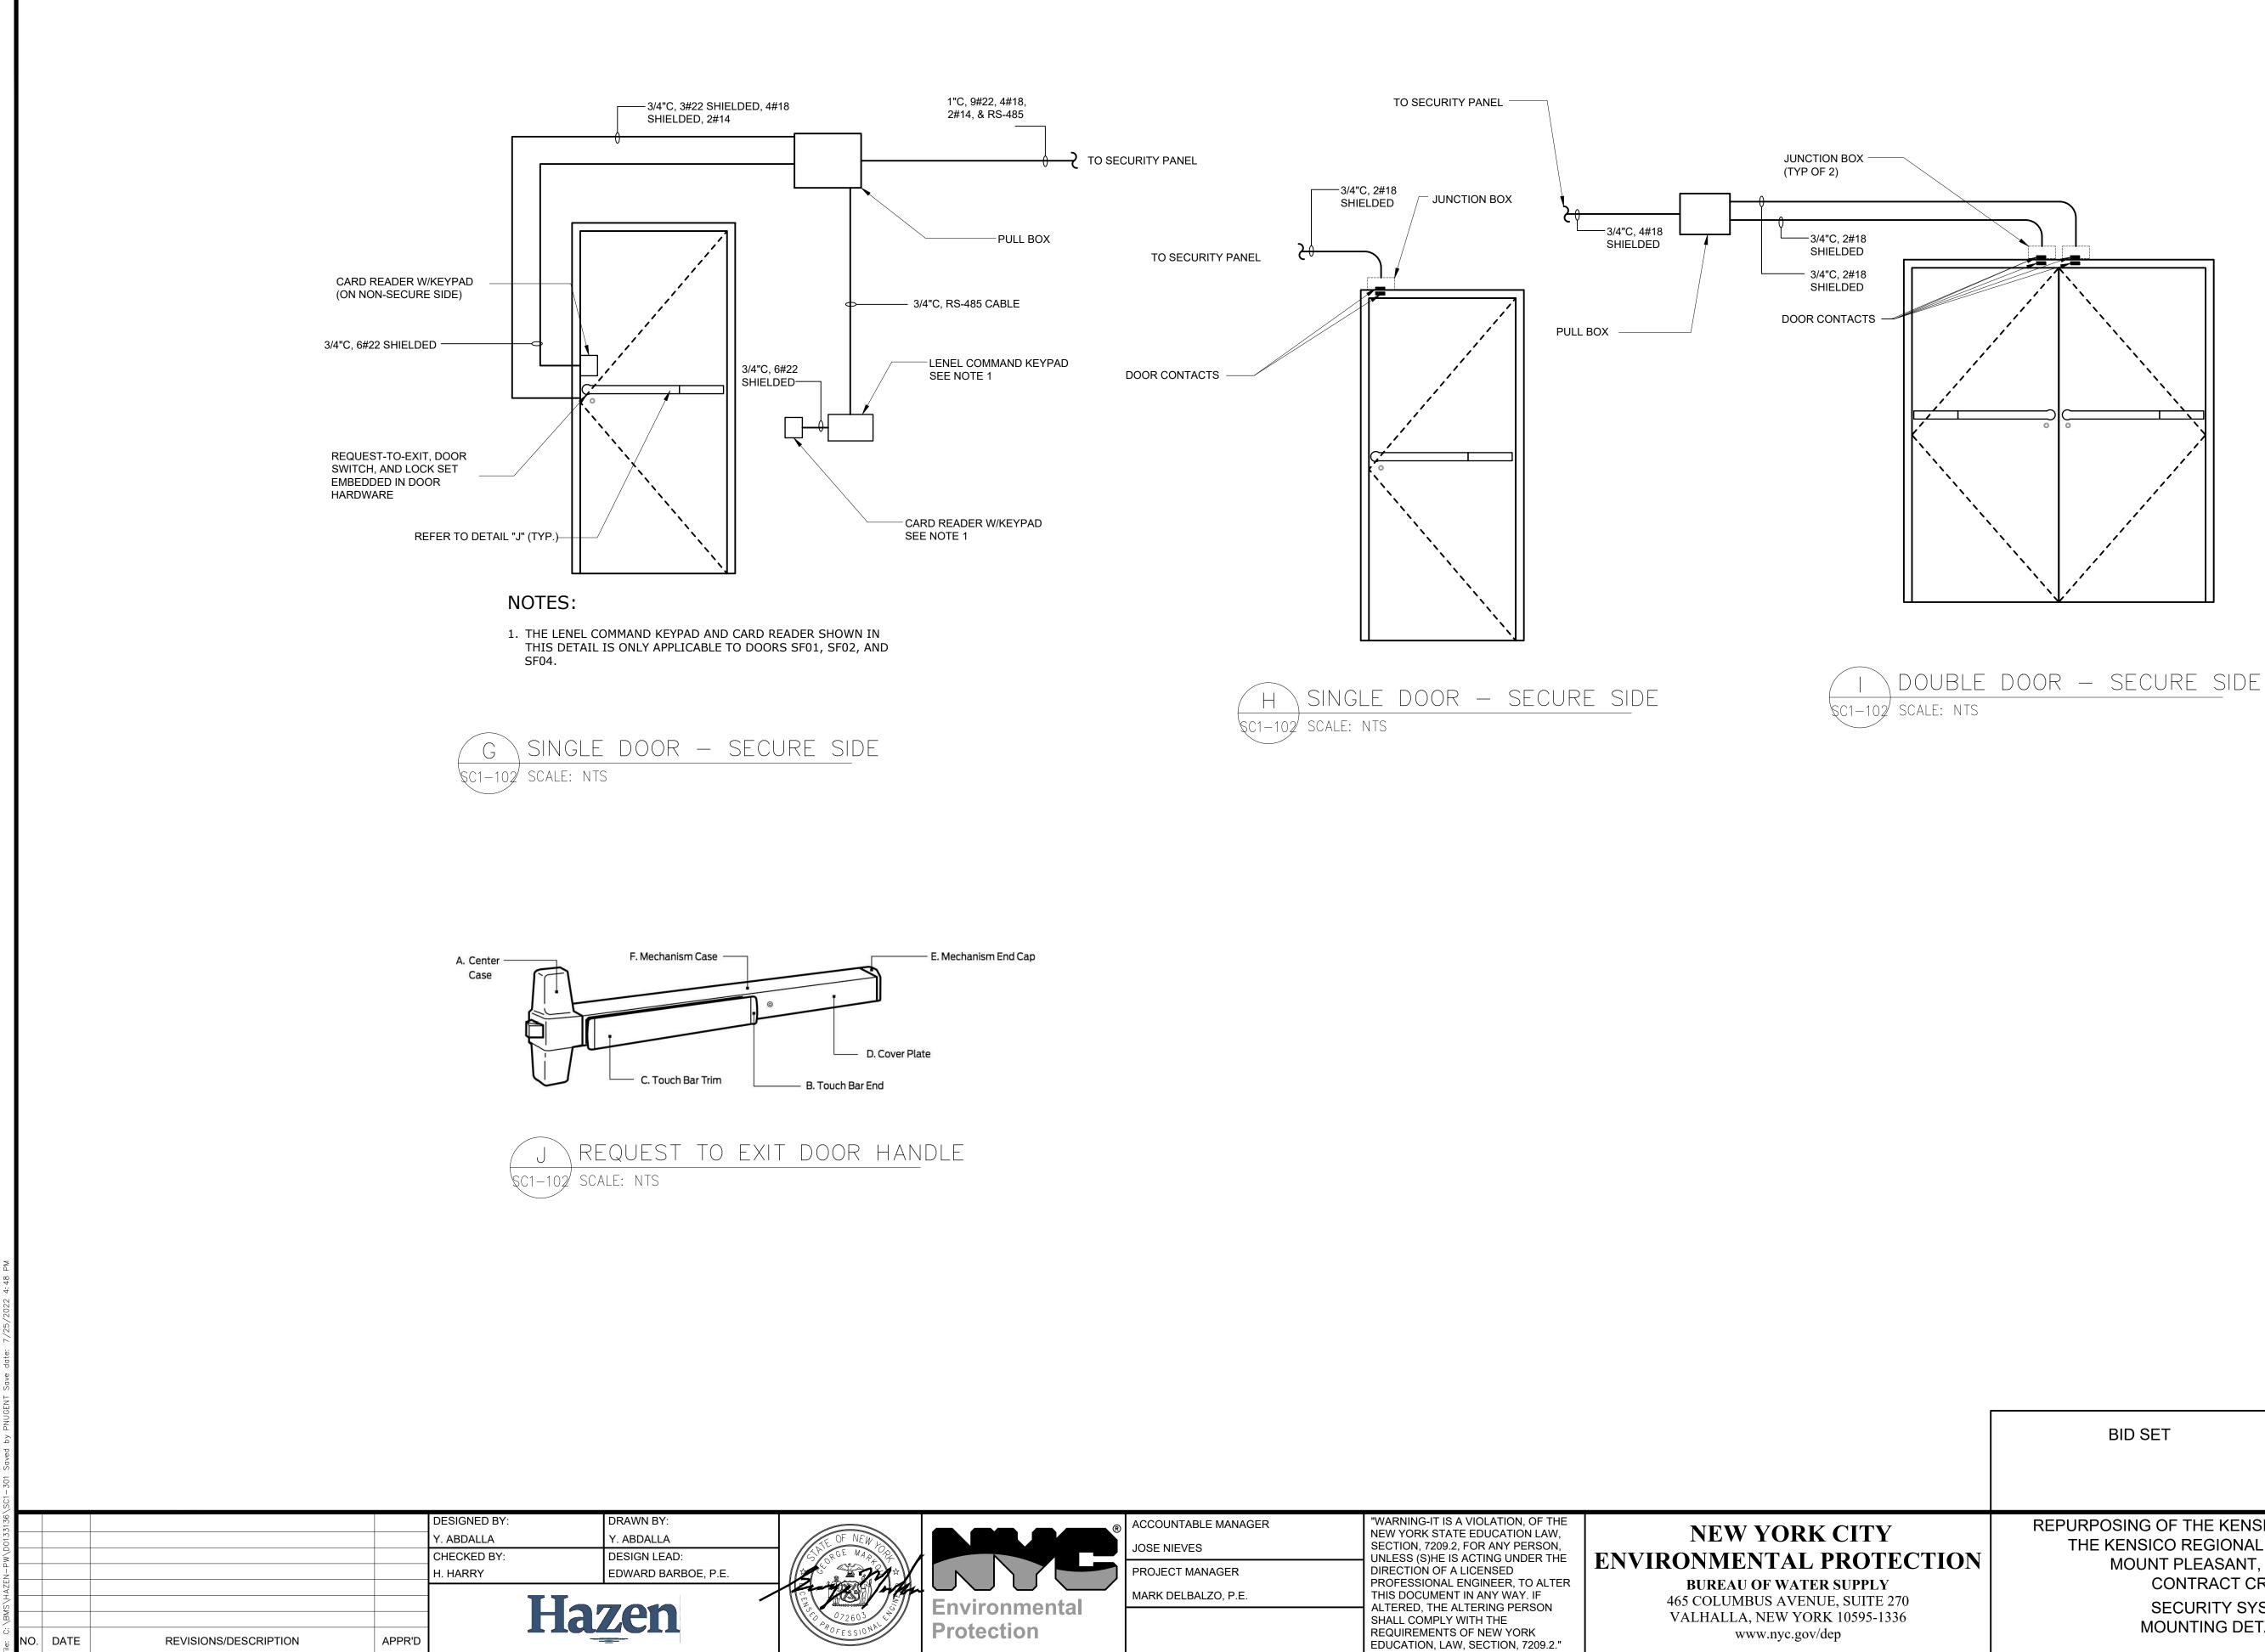

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		IF SHEET IS LESS THAN 22" X 34" IT IS A REDUCED PRINT. SCALE ACCORDINGLY	
	REPURPOSING OF THE KENSICO LABORATORY AS THE KENSICO REGIONAL HEADQUARTERS MOUNT PLEASANT, NEW YORK CONTRACT CRO-624		DATE: MAY 2023 SCALE:
TION			SHEET NO: 121 OF No.121
	SECURITY SYSTEM MOUNTING DETAILS 2		DRAWING NO.
			SC-301