

# Architecture Planning Interiors

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# **Town of Montgomery Police Station**

106 Bracken Road, Montgomery New York, 12549

# ADDENDUM #2: April 17, 2025

# **General Summary:**

- 1. **As a notification,** specification section 00 01 10 Table of Contents has been updated and included for reference purposes.
- 2. **As a notification,** specification sections 00 43 23 Alternates Form and 01 23 00 Alternates have been revised to include the nine alternates.
- 3. **As a notification,** specification section 00 43 25 Substitution Request Form During Procurement, CSI Form 1.5C Substitution Request (During the Bid Period) is being provided for substitution requests during the bid.
- 4. **As a notification,** specification section 32 35 00 Screening Devices has been added for the sound barrier fencing per the site plan.
- 5. **As a notification,** architectural drawing A-002 Drawing List has been updated and included for reference purposes.
- 6. **As a notification,** A-005 First Floor Life Safety Plan, A-201 First Floor Plan, A-204 First Floor RCP, A-504 Break Room Interior Elevation, A-700 First Floor Finish Plan, A-703 First Floor Paint Plan, A-900 First Floor Furniture Plan, and A-902 Interior Sign Schedule were updated to adjusted break room casework layout.
- 7. **As a notification,** architectural drawing A-010 Staging Plan was added to show the construction staging area.
- 8. **As a notification,** architectural drawing A-100-ED Existing Demolition Bench Plan has been updated.
- 9. **As a notification,** architectural drawing A-702 Finish Schedule was updated to show stainless steel casework in Room 120-Booking.
- 10. **As a notification,** architectural drawings A-903 First Floor IT-AV Plan and A-904 Second Floor IT-AV Plan have been updated to delineate the work to be included in the GC Bid and what the owner will be providing as related to IT/AV.
- 11. **As a notification,** civil drawings 1 of 6 Existing Conditions and Demolition Plan, 2 of 6 Site Plan, 3 of 6 Grading, Utility, and Lighting Plan, and 4 of 6 Overall Site Plan have been updated to include additional tree removal, fencing, and light/pole specifications and base details.

- 12. **As a notification,** electrical drawings E-001 Electrical Legend & Abbreviations, E-202 Second Floor Plan Lighting, and E-601 Electrical Oneline Diagram have been updated to clarify lighting and component labels.
- 13. **As a notification**, any outstanding questions that have been submitted prior to the issuance of this Addendum will be addressed in a forthcoming addendum.

#### **Contractor Questions:**

1. Is owner supplying & installing Furniture?

**RESPONSE:** The owner is responsible for supplying and installing all furniture.

2. What is to be included in the General Construction Bid for IT/AV?

**RESPONSE:** The construction notes on drawings A-903 - First Floor IT-AV Plan and A-904 - Second Floor IT-AV Plan have been revised to delineate the work to be included in the GC Bid and what the owner will be providing as it related to IT/AV.

3. What is the estimated budget for this project?

**RESPONSE:** The owner has elected not to disclose the budget.

4. Is it allowable to print the plans in A3 and A1 sizes?

**RESPONSE:** All drawings are to be printed at 1:1 scale. The ASMEP drawings are on 30"x42" sheets and the civil drawings are 24"x36" sheets.

5. How should a product substitution be submitted with a bid?

**RESPONSE:** If a product substitution is to be offered during the bid, please submit substitution requests using the attached specification section 00 43 25 Substitution Request Form – During Procurement, CSI Form 1.5C Substitution Request (During the Bid Period).

- Are there any design models associated with this project that can be shared with bidders?
   RESPONSE: Proprietary design models are not shared with bidders during the bidding process.
- 7. Drawing S101 Low Roof Framing indicates detail 5 on S301 Sections and Details shows nelson studs. Please provide the size of the studs, spacing, and if all beams on this level receive nelson studs.

**RESPONSE:** Nelson studs are not required. Beams are designed as non-composite.

8. There are new building columns that indicate web stiffeners. Please provide a detail showing the extent/size of these stiffeners.

**RESPONSE:** Stiffeners are shown on 2/S301 Sections and Details. The required stiffener thickness is 3/8".



- Are the electrical wires to be contained totally within piping, even above ceilings?
   RESPONSE: Yes, all wiring needs to be in conduit, the only exception is low voltage lighting control wiring in certain spaces. (See additional information in response to question #11 below.)
- 10. We would like to confirm both specification and fire alarm note for all fire alarm cabling to be installed all in conduit, and that plenum cabling above an accessible ceiling is an accepted wiring method.

**RESPONSE:** Yes, all the wiring needs to be in conduit. (*See* additional information in response to question #11 below)

11. The same question applies for power circuitry to be completely in conduit (outlet to outlet) and that MC cabling will not be an acceptable method.

**RESPONSE:** GC to submit an alternate to run all branch wiring in MC cable and all plenum rated low voltage & fire alarm wiring above the walls without conduit. Conduit to be used within walls. Please see revised specification sections 01 23 00 and 00 43 23.

12. Are both lights in room 203 to be B2?

**RESPONSE:** Correct, electrical drawing E-202 Second Floor Plan – Lighting has been updated to include the lighting label.

13. What type B fixtures should the (2) lights in room #204 be?

**RESPONSE:** Both fixtures are type B2. Electrical drawing E-202 Second Floor Plan – Lighting has been updated accordingly.

14. How are the utility company fees and coordination to be handled?

**RESPONSE:** The GC is responsible for all coordination with the utility companies at the signing of the construction contract. All required fees are to be paid by the Town of Montgomery once the GC communicates those fees to The Town. Please note, the Electrical engineer has submitted an application to Central Hudson and has started the initial review process. The electrical application and pertinent communication will be provided to the GC at the start of the construction contract.

- 15. In room 105 on page E-101 First Floor Plan Power & Systems please confirm label GRA.
  RESPONSE: Label GRA is the Generator Remote Annunciator Panel. Electrical drawing E-001 Electrical Legend & Abbreviations has been updated.
- 16. On drawings E-101 First Floor Plan Power & Systems, in the fitness and training room, there is a note of a (S) in a circle that does not appear to be on the legends.

**RESPONSE:** The symbol "S" with a circle around it is to reference a ceiling speaker location. The speakers are shown for coordination purposes only and not part of the construction bid. Electrical drawing E-001 - Electrical Legend & Abbreviations has been updated.



17. Could you please clarify the scope of Data/Communications? Specifically, is the contractor responsible only for installing boxes and stubs up to the accessible ceiling? There seem to be conflicting notes regarding the responsibilities: is the cabling and plates provided by the owner? Is the equipment also provided by the owner?

**RESPONSE:** The general notes on drawings A-903 & A-904 have been updated to delineate the work to be included in the GC Bid and what the owner will be providing as it related to IT/AV.

18. It looks that on E-601 Electrical Oneline Diagram on the one line that the ATS to generator is 1 pipe feed short. Should there be 2 pipes to the 600 amp generator?

**RESPONSE:** Between the ATS and generator provide (1) conduit for power feed from generator to ATS and (1) 1-1/2" conduit for all associated communication cabling between generator and ATS. See updated electrical drawing E-601 Electrical Oneline Diagram.

19. Are there Fire Alarm (FA) drawings for this project?

**RESPONSE:** The fire alarm details are included on electrical drawings E-001 Electrical Legend & Abbreviations, E-101 First Floor Plan – Power & Systems, and E-102 Second Floor Plan – Power & Systems.

20. Please confirm the pole lights.

**RESPONSE:** There are (2) new pole lights shown on the civil drawings. The light/pole specifications and base details have been added to the civil drawings.

21. What camera and recorder brands are specified for this project? What brands are acceptable to the end client?

**RESPONSE:** All cameras and associated systems are to be owner provided and installed.

22. Section 01 23 00 Alternates references eight (8) Alternates, but section 00 43 23 Alternates Form shows only six (6) items. Please confirm.

**RESPONSE:** Section 00 43 23 Alternates Form has been revised to show all (8) alternates, as well as an additional ninth alternate for the electrical wiring changes explained in response to question #11 above. *See* also section 00 23 00 Alternates.

23. How many full-time staff are required for this project, such as Project Manager, Supervisor, and Security personnel?

**RESPONSE:** The responsibility for staffing personnel levels lies with the selected General Contractor (GC). The GC is obligated to appropriately staff and manage a project of this size and scope and to meet the requirements described in the project specifications.



24. Are there any landscape plans available? If so, please provide them.

**RESPONSE:** There is no additional landscaping proposed beyond what is shown on sheets 2 and 3 of the civil drawings. Landscaping will be handled by the Town of Montgomery separately.

25. Please clarify the casework finishes in the booking room.

**RESPONSE:** Drawing A-702 Finish Schedule which has been revised to include the casework finishes in the booking room.

26. Please confirm below items are provided by the owner and installed by the General Contractor (GC) A: Booking Bench (A-201), B: Kitchen Appliances (Refrigerator, Microwave, Vending Machines, etc.), C: All metal lockers at the Evidence Room, Armory, and Men's & Women's Locker Rooms (10 51 13).

RESPONSE: A: The booking bench is supplied by the owner and the GC is responsible for the necessary modifications which are detailed on drawings A-100-ED Existing/Demolition Bench Plan & A-511 New Bench Plan & Elevations.

B: The appliance purchase and installation is to be included in the bid. The appliance specifications are included in section 11 30 13 Appliances.

C: Pricing is to be provided as noted in alternate no. 2 of Section 01 23 00 Alternates of the bid specifications.

27. Is the bullet-resistant window limited to only one window of Type-F? Are all other window types soundproof only?

**RESPONSE:** Correct, only window Type F is bullet resistant. All other interior window types should be soundproof.



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- 00 43 30 Non-Collusive Bidding Certification
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#### **AIA Documents**

- A101-2017 Standard Form of Agreement Between Owner and Contractor
- A101-2017 A101 Exhibit A: Insurance and Bonds
- A201-2017 General Conditions of the Contract for Construction
- A305-2020 Contractor's Qualification Statement, including Exhibits A E
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Comcheck

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# **END OF SECTION 00 01 10**

# SECTION 00 43 23 ALTERNATES FORM

PARTICULARS	
THE FOLLOWING IS THE LIST OF ALTERNATES REFERENCED IN THE BID SUB	MITTED BY:
(Bidder)	
TO (Owner ): Town of Montgomery	
Dated and which is an integral part of the Bid Form.	
ALTERNATES LIST	
THE FOLLOWING AMOUNTS SHALL BE ADDED TO OR DEDUCTED FROM THE ERFER TO SECTION 01 23 00 - Alternates.	BID AMOUNT.
ALTERNATE # 1: ADD \$	
ALTERNATE # 2: ADD \$	
ALTERNATE # 3: ADD \$	
ALTERNATE # 4: (DEDUCT) \$	
ALTERNATE # 5: ADD \$	
ALTERNATE # 6: ADD \$	
ALTERNATE # 7: ADD \$	
ALTERNATE # 8: ADD \$	
ALIERNATE # 6: ADD \$	-
ALTERNATE # 9: ADD \$ END OF SECTION 00 43 23	
END OF SECTION 00 43 23	

# **SECTION 00 43 25** SUBSTITUTION REQUEST FORM DURING PROCUREMENT

# CSI Form 1.5C

# **SUBSTITUTION REQUEST** (During the Bid Period)

Project:	Substitution Request Number:	
	From:	
To:	Date:	
	A/E Project Number:	
Re:	Contract For:	
Specification Title:		
Section: Page:	Article/Paragraph:	
Proposed Substitution: Address: Trade Name:	Phone: Model No.:	
Attached data includes product description, specification of the request; applicable portions of the data are clear	tions, drawings, photographs, and performance and test data adequately identified.	e for evaluation
	to the Contract Documents that the proposed substitution will requi	
• Proposed substitution does not affect dimension	t on other trades and will not affect or delay progress schedule.	caused by the
Submitted by:		
Signed by:		
Firm:		
Address:		
Telephone:		
A/E's REVIEW AND ACTION		
	lance with Specification Section 01 25 00 Substitution Procedures. in accordance with Specification Section 01 25 00 Substitution Procedured materials.	lures.
Signed by:	Date:	
Supporting Data Attached:	Product Data Samples Tests Reports	

# SECTION 01 23 00 ALTERNATES

#### **PART 1 GENERAL**

#### 1.01 SECTION INCLUDES

- A. Description of Alternates.
- B. Procedures for pricing Alternates.

#### 1.02 RELATED REQUIREMENTS

A. Document 00 43 23 - Alternates Form: List of Alternates as supplement to Bid Form.

#### 1.03 ACCEPTANCE OF ALTERNATES

- A. Alternates quoted on Bid Forms will be reviewed and accepted or rejected at Owner's option. Accepted Alternates will be identified in the Owner-Contractor Agreement.
- B. Coordinate related work and modify surrounding work to integrate the Work of each Alternate.

# 1.04 SCHEDULE OF ALTERNATES

- A. Alternate No. 1 Supply and install surface mounted mechanically assisted mobile shelving system:
  - 1. Alternate Item: Section 10 56 26 Mobile Storage Shelving and 10 51 13 Metal Lockers (Evidence Lockers) and Drawing number A-201 Room 122 Evidence Room including n/a.
- B. Alternate No. 2 Supply and install special use lockers:
  - Alternate Item: Section 10 51 13 Metal Lockers First Responder Duty Lockers, Evidence Lockers (not part of mobile storage system) and Weapons Lockers and Drawing number A-203 including A-500 drawings.
- C. Alternate No. 3 Deduct cost to supply and install resilient base:
  - 1. Base Bid Item: Section 09 65 00 Resilient Flooring and Drawing number A-700; A-701 including Finish Schedule.
- D. Alternate No. 4 Deduct cost to supply and install window shades:
  - 1. Base Bid Item: Section 12 24 00 Window Shades and Drawing number A-201; A-202; A-800 including Elevation drawings.
- E. Alternate No. 5 Add cost to change roofing to white EPDM roofing in lieu of black:
  - 1. Base Bid Item: Section 07 53 23 Ethylene Propylene Diene Monomer Roofing and Drawing number A-206 including Roof detail drawings.
- F. Alternate No. 6 Add cost to supply and install blast mitigating windows film.:
  - 1. Alternate Item: Section 08 87 23 Safety and Security Films and Drawing number A-300; A-301 including Window and Storefront Schedules.
- G. Alternate No. 7 Add cost to modify existing Booking Room bench:
  - 1. Alternate Item: Section 05 50 00 Metal Fabrications and Drawing number A-507 including TBD.
- H. Alternate No. 8 Supply and install Emergency Responder Communication Enhancement System (ERCES):
  - Base Bid Item: Section 28 31 13 ERCES Pre-testing and Drawing number all including n/a
    - a. NOTE: Pre-testing, as described in Section 28 31 13, shall be by owner.
  - 2. Alternate Item: Section 28 31 13 Emergency Responder Communication Enhancement System and Drawing number all including n/a.
- I. Alternate No. 9 GC to submit an alternate to run all branch wiring in MC cable and all plenum rated low voltage & fire alarm wiring above the walls without conduit. Conduit to be used within walls:

END OF SECTION 01 23 00

# SECTION 32 35 00 SCREENING DEVICES

#### **PART 1 GENERAL**

#### 1.01 SECTION INCLUDES

- A. Wood sound barrier screening devices.
- B. Concrete footings.

#### 1.02 REFERENCE STANDARDS

- A. ACI PRC-304 Guide for Measuring, Mixing, Transporting, and Placing Concrete; 2000 (Reapproved 2009).
- B. ACI SPEC-301 Specifications for Concrete Construction; 2020.
- C. APA 303 Siding Manufacturing Specifications (Form B840); 2019.
- D. ASTM A153/A153M Standard Specification for Zinc Coating (Hot-Dip) on Iron and Steel Hardware: 2023.
- E. ASTM C39/C39M Standard Test Method for Compressive Strength of Cylindrical Concrete Specimens; 2023.
- F. ASTM C173/C173M Standard Test Method for Air Content of Freshly Mixed Concrete by the Volumetric Method; 2023.
- G. ASTM E90 Standard Test Method for Laboratory Measurement of Airborne Sound Transmission Loss of Building Partitions and Elements; 2023.
- H. ASTM E413 Classification for Rating Sound Insulation; 2022.
- AWPA U1 Use Category System: User Specification for Treated Wood; 2024.

#### 1.03 SUBMITTALS

- A. See Section 01 30 00 Administrative Requirements for submittal procedures.
- B. Product Data: Provide data on posts, panels, accessories, fittings, and hardware.
- C. Shop Drawings: Indicate plan layout, post foundation dimensions, hardware anchorage, and spacing and schedule of components.
- D. Manufacturer's Instructions: Indicate design requirements and installation procedure.

# 1.04 QUALITY ASSURANCE

### 1.05 FIELD CONDITIONS

A. Material Unloading and Storage - Contractor shall provide suitable unloading equipment and storage space for Sound Barrier Materials. Sound Barrier Materials shall be kept off the ground and shall be protected from mud, splattering, staining, vandalism, or physical damage.

#### **PART 2 PRODUCTS**

# 2.01 MATERIALS

- A. Wood Sound Barrier Screening Devices:
  - 1. Products:
    - a. Hoover Treated Wood Products, Inc; PLYWALL® SOUND BARRIER: www.plywall.
    - b. Substitutions: See Section 01 60 00 Product Requirements.
  - 2. Preservative (Pressure Treatment): AWPA U1, Use Category UC3B, Commodity Specification A, using waterborne preservative, at 0.25 pcf retention (, at 4.0 kg/cu m retention).
  - 3. Sound Barrier Panels Panels shall be fabricated as "PLYWALL®" panels as manufactured by Hoover Treated Wood Products, Inc. Panel design shall have been tested in accordance with ASTM E90 and ASTM E413 and shall result in a Sound Transmission Class (STC) of 31 or better.

- 4. Panels shall consist of a structurally sound frame of 2" by 6" (51mm by 153mm) Southern Yellow Pine lumber No. 1, surfaced four sides, covered on both panel faces by shiplap-jointed, APA 303 specialty siding, Exterior Grade, Premium (6- SW), Southern Pine, exposure durability classification Exterior, Texture 1-11, 5-ply, 19/32" (15mm) thick, grooves 8" (200mm) o.c. All wood used in panel construction shall be pressure preservative treated with MCA preservative to a minimum net retention of 0.15pcf (2.40kg/m3) or CCA preservative to a minimum net retention of 0.40pcf (6.41kg/m3) in accordance with American Wood Protection Association (AWPA) standards U1 and T1. All plywood siding and 2" (50mm) (nominal) lumber shall be kiln dried after treatment to a moisture content of 19% or less. All panel sections shall be fabricated prior to shipment. All panels shall have two nylon lifting webs, securely attached along the top.
- 5. Support Posts Posts shall be Power Preserved Glulam® Fb 1.8E 2400-V5-M1 Balanced-No- Camber as manufactured by Anthony Forest Products Company. Minimum net retention of preservative shall be 0.31pcf (4.97kg/m3) of MCA or 0.60pcf (9.61kg/m3) of CCA in accordance with AWPA standards U1 and T1. Posts shall be bundled so that each layer is separated by wood spacers to allow air drying after treatment. The length of the post may vary from Hoover's standard chart due to foundation and wind load requirements. Posts will be supplied with one extra foot in length to compensate for depth variances.
- Cleats Vertical cleats for attaching panels to posts shall be Southern Yellow Pine lumber No. 1, pre- drilled every 12" (304.8mm) for attaching. Minimum net retention of preservative shall be 0.15pcf (2.40kg/m3) of MCA or 0.40pcf (6.41kg/m3) of CCA in accordance with AWPA standards U1 and T1.
- 7. Fasteners All nails, spikes (or lag bolts, if applicable) shall be hot dip galvanized zinc coated per ASTM A153/A153M or stainless steel.
- 8. Sealant A clear sealant or solid color stain to be factory applied to the wall to include posts, cleats, and panels.

#### B. Concrete Footings:

- Normal Weight Concrete:
  - a. Compressive Strength: 3,000 psi (20.7 MPa) when tested in accordance with ASTM C39/C39M at 28 days.
  - b. Fly Ash Content: Maximum 15 percent of cementitious materials by weight.
  - Calcined Pozzolan Content: Maximum 10 percent of cementitious materials by weight.
  - d. Silica Fume Content: Maximum 5 percent of cementitious materials by weight.
  - e. Water-Cement Ratio: Maximum 40 percent by weight.
  - f. Total Air Content: 4 percent, determined in accordance with ASTM C173/C173M.
  - g. Maximum Slump: 3 inches (7.5 cm).
  - h. Maximum Aggregate Size: 5/8 inch (1.6 cm).

#### **PART 3 EXECUTION**

# 3.01 INSTALLATION

- A. Concrete Footings:
  - Excavation:
    - a. Excavate to accommodate new screening devices and construction operations.
    - Excavate to specified elevations.
    - c. Excavate to dimensions required to safely install, adjust, and remove bracing or supports necessary for installation of work.
    - d. Post holes shall be augered to the required diameter and depth, which shall be determined by the owner's engineer (Hoover provides standard recommendations based on assumed soil properties). Spacing shall allow the post to be centered within the hole and allow the post to be installed to the center-to-center-required measurement which is dependent on the post size and panel width. Posts may shrink slightly after erection. The contractor shall take all measures and precautions

necessary to prevent collapse of the hole sides prior to backfilling and compaction. Since post sizes may vary within a single project, actual post width shall be checked at delivery. Actual panel width shall also be verified at delivery.

#### 2. Concrete:

- a. Comply with requirements of ACI SPEC-301.
- b. Place concrete in accordance with ACI PRC-304.

### B. Wood Sound Barrier Screening Devices:

 Posts shall be plumb and in precise position to accept panels and shall be braced in such a manner as to remain plumb and in the required lateral position during backfilling. Post spacing shall allow clear spans between posts equal to the panel width plus a maximum 1.25" (32mm) tolerance overall. In no case shall the erection tolerance between posts exceed 1.25" (32mm).

#### Backfill:

- a. Concrete backfill shall extend a minimum of 3" above finish grade and slope away from the post on all sides.
- 3. Attachment of Rear Cleats: Prior to setting panels, the rear cleats shall be fully attached to each post to support the Sound Barrier panels during placement. Cleats shall be placed at an elevation that will insure support of the panel over the entire height. The rear edge of the cleat shall be placed such that the panel end's center-line is aligned with the presented post face's center-line. The cleats shall be attached with properly sized hot dip galvanized zinc coated (or stainless steel) spikes or lag bolts as shown. Note: Contractor may attach rear cleats prior to setting posts, but post embedment depth tolerances become critical since the cleats cannot be adjusted.
- 4. Setting Panels: Sound Barrier panels shall be lifted by the provided lift straps and seated firmly against the prefixed rear cleats in a manner which maintains panel plumb and level and equally divides the construction gap to each side (center panel between post do not place panel all the way to one side against the post). The panel will then be secured by attaching the front cleats to the posts along the unsecured panel face. Cleat nails shall never be driven into the panel. Note: Front cleats shall be firmly and securely fixed to the post at both ends before releasing lifting straps.
- 5. Panel Bottom Embedment:
  - Bottom of panels shall be backfilled with crushed stone to prevent th passage of sound and to provide drainage.
- 6. Field trimming of top posts: After panels have been set and caps attached, the post tops may be trimmed for aesthetics.
- 7. Panel caps: After removal of the nylon lifting straps, the panel caps shall be trimmed in the field and attached with provided stainless steel timber tamers placed every 12" (305mm).
- 8. **DISPOSAL OF TREATED WOOD SCRAPS** Do not burn scraps. Dispose of scraps as ordinary trash. Land-filling is acceptable for MCA-treated and CCA-treated wood.

# 3.02 TOLERANCES

- A. Maximum Variation from Plumb and Level: 1/4 inch (1 cm).
- B. Maximum Offset from True Alignment: 1/4 inch (1 cm).

#### 3.03 FIELD QUALITY CONTROL

- A. See Section 01 40 00 Quality Requirements for additional requirements.
- B. Inspect for plumb, level, and alignment installation.


#### 3.04 PROTECTION


- A. Protect installed screening device from subsequent construction operations.
- B. Touch up, repair, or replace damaged products.


### **END OF SECTION 32 35 00**


	SHEET LIST TABLE	<b>-</b>	100%		REV	(1510N	N HIS	TORY				CURRENT REVISION			
SHT.	SHEET TITLE	DRAWING DATE	CONSTRUCTION DOCUMENT	04/17/25	MM/DD/YY	MMDDMY	MM/DD/YY	WW/DD/W	MMDDMY	Rev. #	DATE	DESCRIPTION	ISSUED (Y/N)		
ARCHITE	CTURAL														
A-00 I	TITLE SHEET	02/24/25	100%										YES		
A-002	DRAWING LIST	02/24/25	100%	•						Α	04/17/25	ADDENDUM 2	YES		
A-003	CODE SHEET	02/24/25	100%										YE5		
A-004	BUILDING DIAGRAMS	02/24/25	100%	<u> </u>									YES		
A-005	FIRST FLOOR LIFE SAFETY PLAN	02/24/25	100%	•						A	04/17/25	ADDENDUM 2	YES		
A-006	SECOND FLOOR LIFE SAFETY PLAN	02/24/25	100%										YES		
A-007	LIFE SAFETY SECTION	02/24/25	100%	<u> </u>									YES		
A-008	LIFE SAFETY SECTION	02/24/25	100%	-	$\vdash$								YES		
A-009	ACCESSIBLE TYPICAL DETAILS	02/24/25	100%	-								ADDENDUM	YES		
A-010	STAGING PLAN	04/17/25	100%	<del>                                     </del>	$\vdash$						0.411.5105	ADDENDUM 2	YES		
A-100-ED	EXISTING/DEMOLITION BENCH PLAN	02/24/25	100%	•						Α	04/17/25	ADDENDUM 2	YES		
A-200	TYPICAL WALL TYPES	02/24/25	100%	+'							04117105	ADDENDUM	YES		
A-201	FIRST FLOOR PLAN	02/24/25	100%	•						Α	04/17/25	ADDENDUM 2	YES		
A-202	SECOND FLOOR PLAN ENLARGED MEN'S , WOMEN'S TOILET ,	02/24/25	100%										YES		
A-203	LOCKER ROOM & BOOKING	02/24/25		+							0.4117105	ADDENDUM	YES		
A-204	FIRST FLOOR RCP	02/24/25	100%	•						Α	04/17/25	ADDENDUM 2	YES		
A-205	SECOND FLOOR RCP	02/24/25	100%	-									YES		
A-206	ROOF PLAN	02/24/25	100%	<del>                                     </del>									YES		
A-300 A-301	NORTH \$ SOUTH EXTERIOR ELEVATIONS  WEST \$ EAST EXTERIOR ELEVATIONS	02/24/25	100%	-									YES VES		
A-301 A-400	BUILDING SECTIONS	02/24/25	100%	-									YES VES		
				-									YES		
A-401	BUILDING SECTIONS	02/24/25	100%	-									YES		
A-402 A-403	BUILDING SECTIONS SOUTH WALL SECTION & DETAILS	02/24/25	100%	-									YES		
A-403	SOUTH WALL SECTION & DETAILS  EAST WALL SECTION @ SILL AND HEADER			-									YES		
A-404	DETAILS  EAST WALL STOREFRONT SECTION \$	02/24/25	100%	-									YES		
A-405	DETAILS	02/24/25	100%	-									YE5		
A-406	EAST WALL SECTION AND DETAILS	02/24/25	100%	<u> </u>									YES		
A-407	WEST WALL ELEVATION & SECTION	02/24/25	100%	<u> </u>									YES		
A-408	NORTH WALL SECTION # DETAILS	02/24/25	100%	<u> </u>									YES		
A-409	VESTIBULE SECTION & DETAILS	02/24/25	100%	-									YE5		
A-410	WALL SECTION AND DETAILS @ PYLON	02/24/25	100%	<u> </u>									YE5		
A-411	STAIR PLAN AND SECTIONS	02/24/25	100%	<u> </u>									YE5		
A-412	STAIR DETAILS	02/24/25	100%	<u> </u>									YE5		
A-413	ROOF STAIR PLAN AND SECTION  WOMEN'S TOILET #118, LOCKER #119 \$	02/24/25	100%	<u> </u>									YES		
A-500	TRANSFER TOILET 138 INT. ELEVATION	02/24/25	100%	<u> </u>									YES		
A-501	MEN'S TOILET #115 INTERIOR ELEVATIONS TOILET #133, TOILET #134 \$ JANITOR'S		100%										YES		
A-502	CLO. #117 INT. ELEV.	02/24/25	100%	<u> </u>									YES		
A-503	MEN'S LOCKER # 1 1 6 INTERIOR ELEVATION	02/24/25	100%	<u> </u>									YES		
A-504	BREAK ROOM INTERIOR ELEVATION	02/24/25	100%	•						Α	04/17/25	ADDENDUM 2	YES		
A-505	LOBBY INTERIOR ELEVATION	02/24/25	100%	<u> </u>									YES		
A-506	LOBBY INTERIOR ELEVATION  EVIDENCE PROCESSING # BOOKING INT.	02/24/25	100%	<u> </u>									YE5		
A-507	ELEV.	02/24/25	100%	<u> </u>		<u> </u>							YE5		
A-508	LOW PARTTION INTERIOR ELEVATIONS	02/24/25	100%	<u> </u>									YES		
A-509	VESTIBULE INTERIOR ELEVATION	02/24/25	100%	<u> </u>									YES		
A-510	TRAINING ROOM INTERIOR ELEVATIONS	02/24/25	100%	ļ!									YES		
A-511	NEW BENCH PLAN & ELEVATIONS	02/24/25	100%	<u> </u>									YES		
A-600	FIRE RATED DETAILS	02/24/25	100%	<u> </u>									YES		
A-601	CONDUIT DETAILS	02/24/25	100%	<u> </u>									YES		
A-602	MOISTURE BARRIER DETAILS	02/24/25	100%	<u> </u>									YES		
A-603	METAL FRAMING DETAILS	02/24/25	100%	<u> </u>									YES		
A-604	MASONRY DETAILS	02/24/25	100%	<u> </u>									YES		
A-605	TILE SCHLUTER DETAILS	02/24/25	100%	-									YES		
A-606	MILLWORK DETAILS	02/24/25	100%	<u> </u>									YES		
A-607	DOOR DETAILS	02/24/25	100%	<u> </u>									YES		
A-608	WINDOW DETAILS	02/24/25	100%	-									YE5		
A-609	EPDM ROOF DETAILS	02/24/25	100%										YES		
A-610	EPDM ROOF DETAILS	02/24/25	100%	<u> </u>									YES		
A-611	EPDM ROOF DETAILS	02/24/25	100%	<u> </u>									YES		
A-612	ROOFING DETAILS	02/24/25	100%	-									YES		
A-613	ACM DETAILS	02/24/25	100%	-									YES		
A-614	ACM DETAILS	02/24/25	100%	-									YES		
A-615	ACM DETAILS	02/24/25	100%	-									YES		
A-616	MULLION MATE DETAILS	02/24/25	100%	-									YES		
A-617	CURTAIN WALL DETAILS	02/24/25	100%	<u> </u>									YES		
A-618	TOILET PARTITION DETAILS	02/24/25	100%	<u> </u>									YES		
A-619	CANOPY DETAILS	02/24/25	100%	<u> </u>									YES		
A-620	COMMERCIAL SITE DETAILS	02/24/25	100%	-									YES		
A-621	DOOR ¢ WINDOW FLASHING SEQUENCE	02/24/25	100%	<u> </u>									YES		
A-622	CEILING DETAILS	02/24/25	100%	<u> </u>									YE5		
A-623	WALL TRANSITION DETAIL \$ STOREFRONT DETAILS	02/24/25	100%	<u> </u>		<u> </u>							YES		
A-624	TYPICAL STAIR DETAILS	02/24/25	100%	<u> </u>									YES		
A-625	DRAIN-N-DRY LATH DETAILS	02/24/25	100%	<u> </u>		<u> </u>							YES		
	DOOR DETAILS	02/24/25	100%	<u> </u>		<u> </u>							YES		
A-626			i .	1 '	, 1	, ,			ı l		04417405	ADDENDUM O	1		
A-626 A-700	FIRST FLOOR FINISH PLAN	02/24/25	100%	•						Α	04/17/25	ADDENDUM 2	YES		


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				040 MM WM	N N N N N N N N N N N N N N N N N N N	Σ								0 MMM	\\\\\\\\\\\\\\\\\\\\\\\\\\\\\\\\\\\\\\	\\\\\\\\\\\\\\\\\\\\\\\\\\\\\\\\\\\\\\				
A-001	C T U R A L TITLE SHEET	02/24/25	100%						YES	A-703	FIRST FLOOR PAINT PLAN	02/24/25	100%	•			Α (	04/17/25	ADDENDUM 2	YES
A-002	DRAWING LIST	02/24/25	100%	•		A	04/17/25	ADDENDUM 2	YES	A-704	SECOND FLOOR PAINT PLAN	02/24/25	100%							YES
A-003	CODE SHEET	02/24/25	100%						YE5	A-800 A-801	DOORS # WINDOW SCHEDULE  STOREFRONT SCHEDULE	02/24/25	100%							YES YES
A-004	BUILDING DIAGRAMS	02/24/25	100%						YES	A-802	STOREFRONT SCHEDULE	02/24/25	100%							YES YES
A-005	FIRST FLOOR LIFE SAFETY PLAN	02/24/25	100%	•		A	04/17/25	ADDENDUM 2	YE5	A-803	STOREFRONT SCHEDULE	02/24/25	100%							YES
A-006	SECOND FLOOR LIFE SAFETY PLAN	02/24/25	100%						YES	A-804	STOREFRONT SCHEDULE	02/24/25	100%							YES
A-007	LIFE SAFETY SECTION	02/24/25	100%						YES	A-805	STOREFRONT SCHEDULE	02/24/25	100%							YES
A-008 A-009	LIFE SAFETY SECTION  ACCESSIBLE TYPICAL DETAILS	02/24/25	100%						YES VEG	A-900	FIRST FLOOR FURNITURE PLAN	02/24/25	100%	•			Α (	04/17/25	ADDENDUM 2	YES
A-010	STAGING PLAN	04/17/25	100%					ADDENDUM 2	YES YES	A-901	SECOND FLOOR FURNITURE PLAN	02/24/25	100%							YES
A-100-ED	EXISTING/DEMOLITION BENCH PLAN	02/24/25	100%	•		A	04/17/25	ADDENDUM 2	YES	A-902	INTERIOR SIGN SCHEDULE	02/24/25	100%	•			Α (	04/17/25	ADDENDUM 2	YES
A-200	TYPICAL WALL TYPES	02/24/25	100%						YES	A-903	FIRST FLOOR IT-AV PLAN	02/24/25	100%	•				04/17/25	ADDENDUM 2	YE5
A-201	FIRST FLOOR PLAN	02/24/25	100%	•		А	04/17/25	ADDENDUM 2	YES	A-904	SECOND FLOOR IT-AV PLAN	02/24/25	100%	•			A (	04/17/25	ADDENDUM 2	YES YES
A-202	SECOND FLOOR PLAN	02/24/25	100%						YES	A-905 A-906	EXTERIOR RENDERING  INTERIOR RENDERING	02/24/25	100%							YES YES
A-203	ENLARGED MEN'S , WOMEN'S TOILET , LOCKER ROOM & BOOKING	02/24/25	100%						YES	A-907	INTERIOR RENDERING	02/24/25	100%							YES
A-204	FIRST FLOOR RCP	02/24/25	100%	•		A	04/17/25	ADDENDUM 2	YES			3,7,4,2	1							
A-205	SECOND FLOOR RCP	02/24/25	100%						YE5	~										
A-206	ROOF PLAN	02/24/25	100%						YES	CIVIL	EXISTING CONDITIONS AND REMOVAL PLAN	01/14/25	100%	•			A 0-	4/17/25	ADDENDUM 2	YES
A-300	NORTH & SOUTH EXTERIOR ELEVATIONS	02/24/25	100%						YES	2	SITE PLAN	01/14/25	100%	•				4/17/25	ADDENDUM 2	YES
A-301	WEST \$ EAST EXTERIOR ELEVATIONS	02/24/25	100%						YES	3	GRADING AND UTILITY PLAN	01/14/25	100%	•				4/17/25	ADDENDUM 2	YES
A-400	BUILDING SECTIONS	02/24/25	100%						YES	4	EROSION AND SEDIMENT CONTROL PLAN	01/14/25	100%	•			A 0-	4/17/25	ADDENDUM 2	YES
A-401 A-402	BUILDING SECTIONS  BUILDING SECTIONS	02/24/25	100%						YES	5	CONSTRUCTION DETAILS I	01/14/25	100%							YES
A-403	SOUTH WALL SECTION # DETAILS	02/24/25	100%						YES	6	CONSTRUCTIONS DETAILS 2	01/14/25	100%							YES
A-404	EAST WALL SECTION @ SILL AND HEADER		100%							B-401	RETAINING WALL PLAN	01/14/25	100%							YES
A-405	DETAILS  EAST WALL STOREFRONT SECTION \$	02/24/25	100%						YES YES	B-402	SEGEMENTAL RETAINING WALL - SPECIFICATIONS AND NOTES	01/14/25	100%							YES
\-406	DETAILS  EAST WALL SECTION AND DETAILS	02/24/25	100%						YES	STRUCT	URAL									
-407	WEST WALL ELEVATION & SECTION	02/24/25	100%						YES	5-001	NOTES	02/24/25	100%							YES
N-408	NORTH WALL SECTION & DETAILS	02/24/25	100%						YES	5-002	NOTES	02/24/25	100%							YES
A-409	VESTIBULE SECTION & DETAILS	02/24/25	100%						YES	5-003	SPECIAL INSPECTIONS	02/24/25	100%							YES
A-410	WALL SECTION AND DETAILS @ PYLON	02/24/25	100%						YES	5-100	FOUNDATION	02/24/25	100%							YES
A-411	STAIR PLAN AND SECTIONS	02/24/25	100%						YES	5-101	LOW ROOF FRAMING	02/24/25	100%							YES
A-412	STAIR DETAILS	02/24/25	100%						YES	5-102	HIGH ROOF PLAN	02/24/25	100%							YES
A-413	ROOF STAIR PLAN AND SECTION	02/24/25	100%						YES	5-200 5-201	FOUNDATION DETAILS FOUNDATION/FRAMING DETAILS	02/24/25	100%							YES YES
A-500	WOMEN'S TOILET #118, LOCKER #119 \$ TRANSFER TOILET 138 INT. ELEVATION	02/24/25	100%						YES	5-300	SECTIONS AND DETAILS	02/24/25	100%							YES
A-501	MEN'S TOILET #115 INTERIOR ELEVATIONS		100%						YE5	5-301	SECTION AND DETAILS	02/24/25	100%							YES
A-502	TOILET #133, TOILET #134 ¢ JANITOR'S CLO. #117 INT. ELEV.	02/24/25	100%						YES	5-302	SECTIONS AND DETAILS	02/24/25	100%							YES
	MEN'S LOCKER # 1 1 G INTERIOR ELEVATION		100%						YES	5-303	SECTIONS AND DETAILS	02/24/25	100%							YES
A-504	BREAK ROOM INTERIOR ELEVATION	02/24/25	100%	•		A	04/17/25	ADDENDUM 2	YES	MECHAN	II C A I									
A-505	LOBBY INTERIOR ELEVATION	02/24/25	100%						YES	H-001	HVAC GENERAL NOTES, SYSTEMS & ABBREVIATIONS	02/24/25	100%							YES
A-506 A-507	LOBBY INTERIOR ELEVATION  EVIDENCE PROCESSING & BOOKING INT.	02/24/25	100%						YES	H-101	FIRST FLOOR PLAN - HVAC	02/24/25	100%							YES
A-507 A-508	ELEV.  LOW PARTTION INTERIOR ELEVATIONS	02/24/25	100%						YES	H-102	SECOND FLOOR \$ ROOF PLAN - HVAC	02/24/25	100%							YES
\-509	VESTIBULE INTERIOR ELEVATION	02/24/25	100%						YES YES	H-501	HVAC DETAILS	02/24/25	100%							YES
A-510	TRAINING ROOM INTERIOR ELEVATIONS	02/24/25	100%						YES	H-701	HVAC SCHEDULES	02/24/25	100%							YES
N-511	NEW BENCH PLAN ¢ ELEVATIONS	02/24/25	100%						YES	ELECTR	CAL									
<b>\-600</b>	FIRE RATED DETAILS	02/24/25	100%						YES	E-001	ELECTRICAL LEGEND # ABBREVIATIONS	02/24/25	100%	•			A 0-	4/17/25	ADDENDUM 2	YES
-601	CONDUIT DETAILS	02/24/25	100%						YES	E-002	ELECTRICAL SITE PLAN	02/24/25	100%							YES
-602	MOISTURE BARRIER DETAILS	02/24/25	100%						YES	E-101	FIRST FLOOR PLAN - POWER \$ SYSTEMS	02/24/25	100%							YES
-603	METAL FRAMING DETAILS	02/24/25	100%						YES	E-102	SECOND FLOOR PLAN - POWER & SYSTEMS		100%							YE:
-604	MASONRY DETAILS	02/24/25	100%						YES	E-201	FIRST FLOOR PLAN - LIGHTING	02/24/25	100%							YE:
-605	TILE SCHLUTER DETAILS	02/24/25	100%						YES	E-202	SECOND FLOOR PLAN - LIGHTING	02/24/25	100%	•			A 0-		ADDENDUM 2	YES
-606	MILLWORK DETAILS	02/24/25	100%						YES	E-601	ELECTRICAL ONELINE DIAGRAM	02/24/25	100%	•			A 0-	4/17/25	ADDENDUM 2	YES
607	DOOR DETAILS	02/24/25	100%						YES	E-701 E-702	ELECTRICAL SCHEDULES & DETAILS  ELECTRICAL DETAILS	02/24/25	100%							YE:
608	WINDOW DETAILS	02/24/25	100%						YE5			04/E <del>4</del> /E3	1 00 70							res
609	EPDM ROOF DETAILS	02/24/25	100%						YE5	P L U M B I		02/24/25	1,000							
610	EPDM ROOF DETAILS	02/24/25	100%						YES	P-001	GENERAL NOTES \$ SYMBOLS LIST  PLUMBING SITE PLAN	02/24/25	100%							YE:
S11 S12	EPDM ROOF DETAILS  ROOFING DETAILS	02/24/25	100%						YES	P-100	UNDERSLAB PLAN - PLUMBING	02/24/25	100%							YE:
612	ACM DETAILS	02/24/25	100%						YES	P-1015	FIRST FLOOR PLAN - PLUMBING DWV	02/24/25	100%							YES
613	ACM DETAILS  ACM DETAILS	02/24/25	100%						YES YES	P-101W	FIRST FLOOR PLAN - PLUMBING	02/24/25	100%							YES
-615	ACM DETAILS	02/24/25	100%						YES	P-102	SECOND FLOOR - PLUMBING	02/24/25	100%							YES
-616	MULLION MATE DETAILS	02/24/25	100%						YES	P-103	ROOF PLAN - PLUMBING	02/24/25	100%							YE
-617	CURTAIN WALL DETAILS	02/24/25	100%						YES	P-501	DETAILS	02/24/25	100%							YE
-618	TOILET PARTITION DETAILS	02/24/25	100%						YES	P-502	DETAILS	02/24/25	100%							YES
-619	CANOPY DETAILS	02/24/25	100%						YES	P-503	DETAILS	02/24/25	100%							YES
	COMMERCIAL SITE DETAILS	02/24/25	100%						YES	P-504	DETAILS	02/24/25	100%							YES
520				1 1 1	1 1				1		1	1		1 1						1

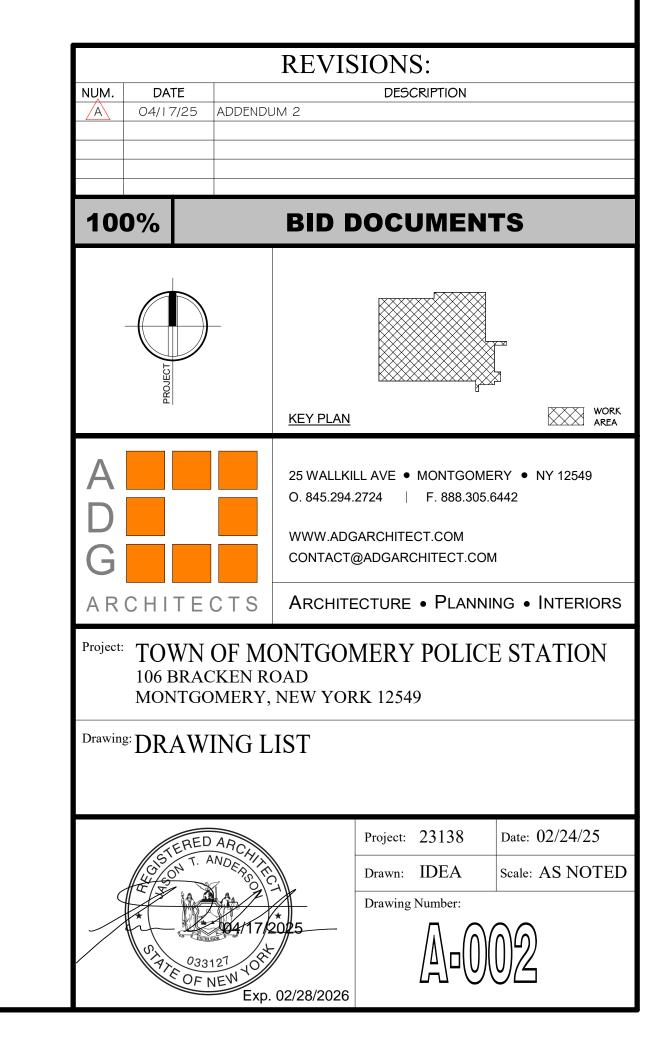


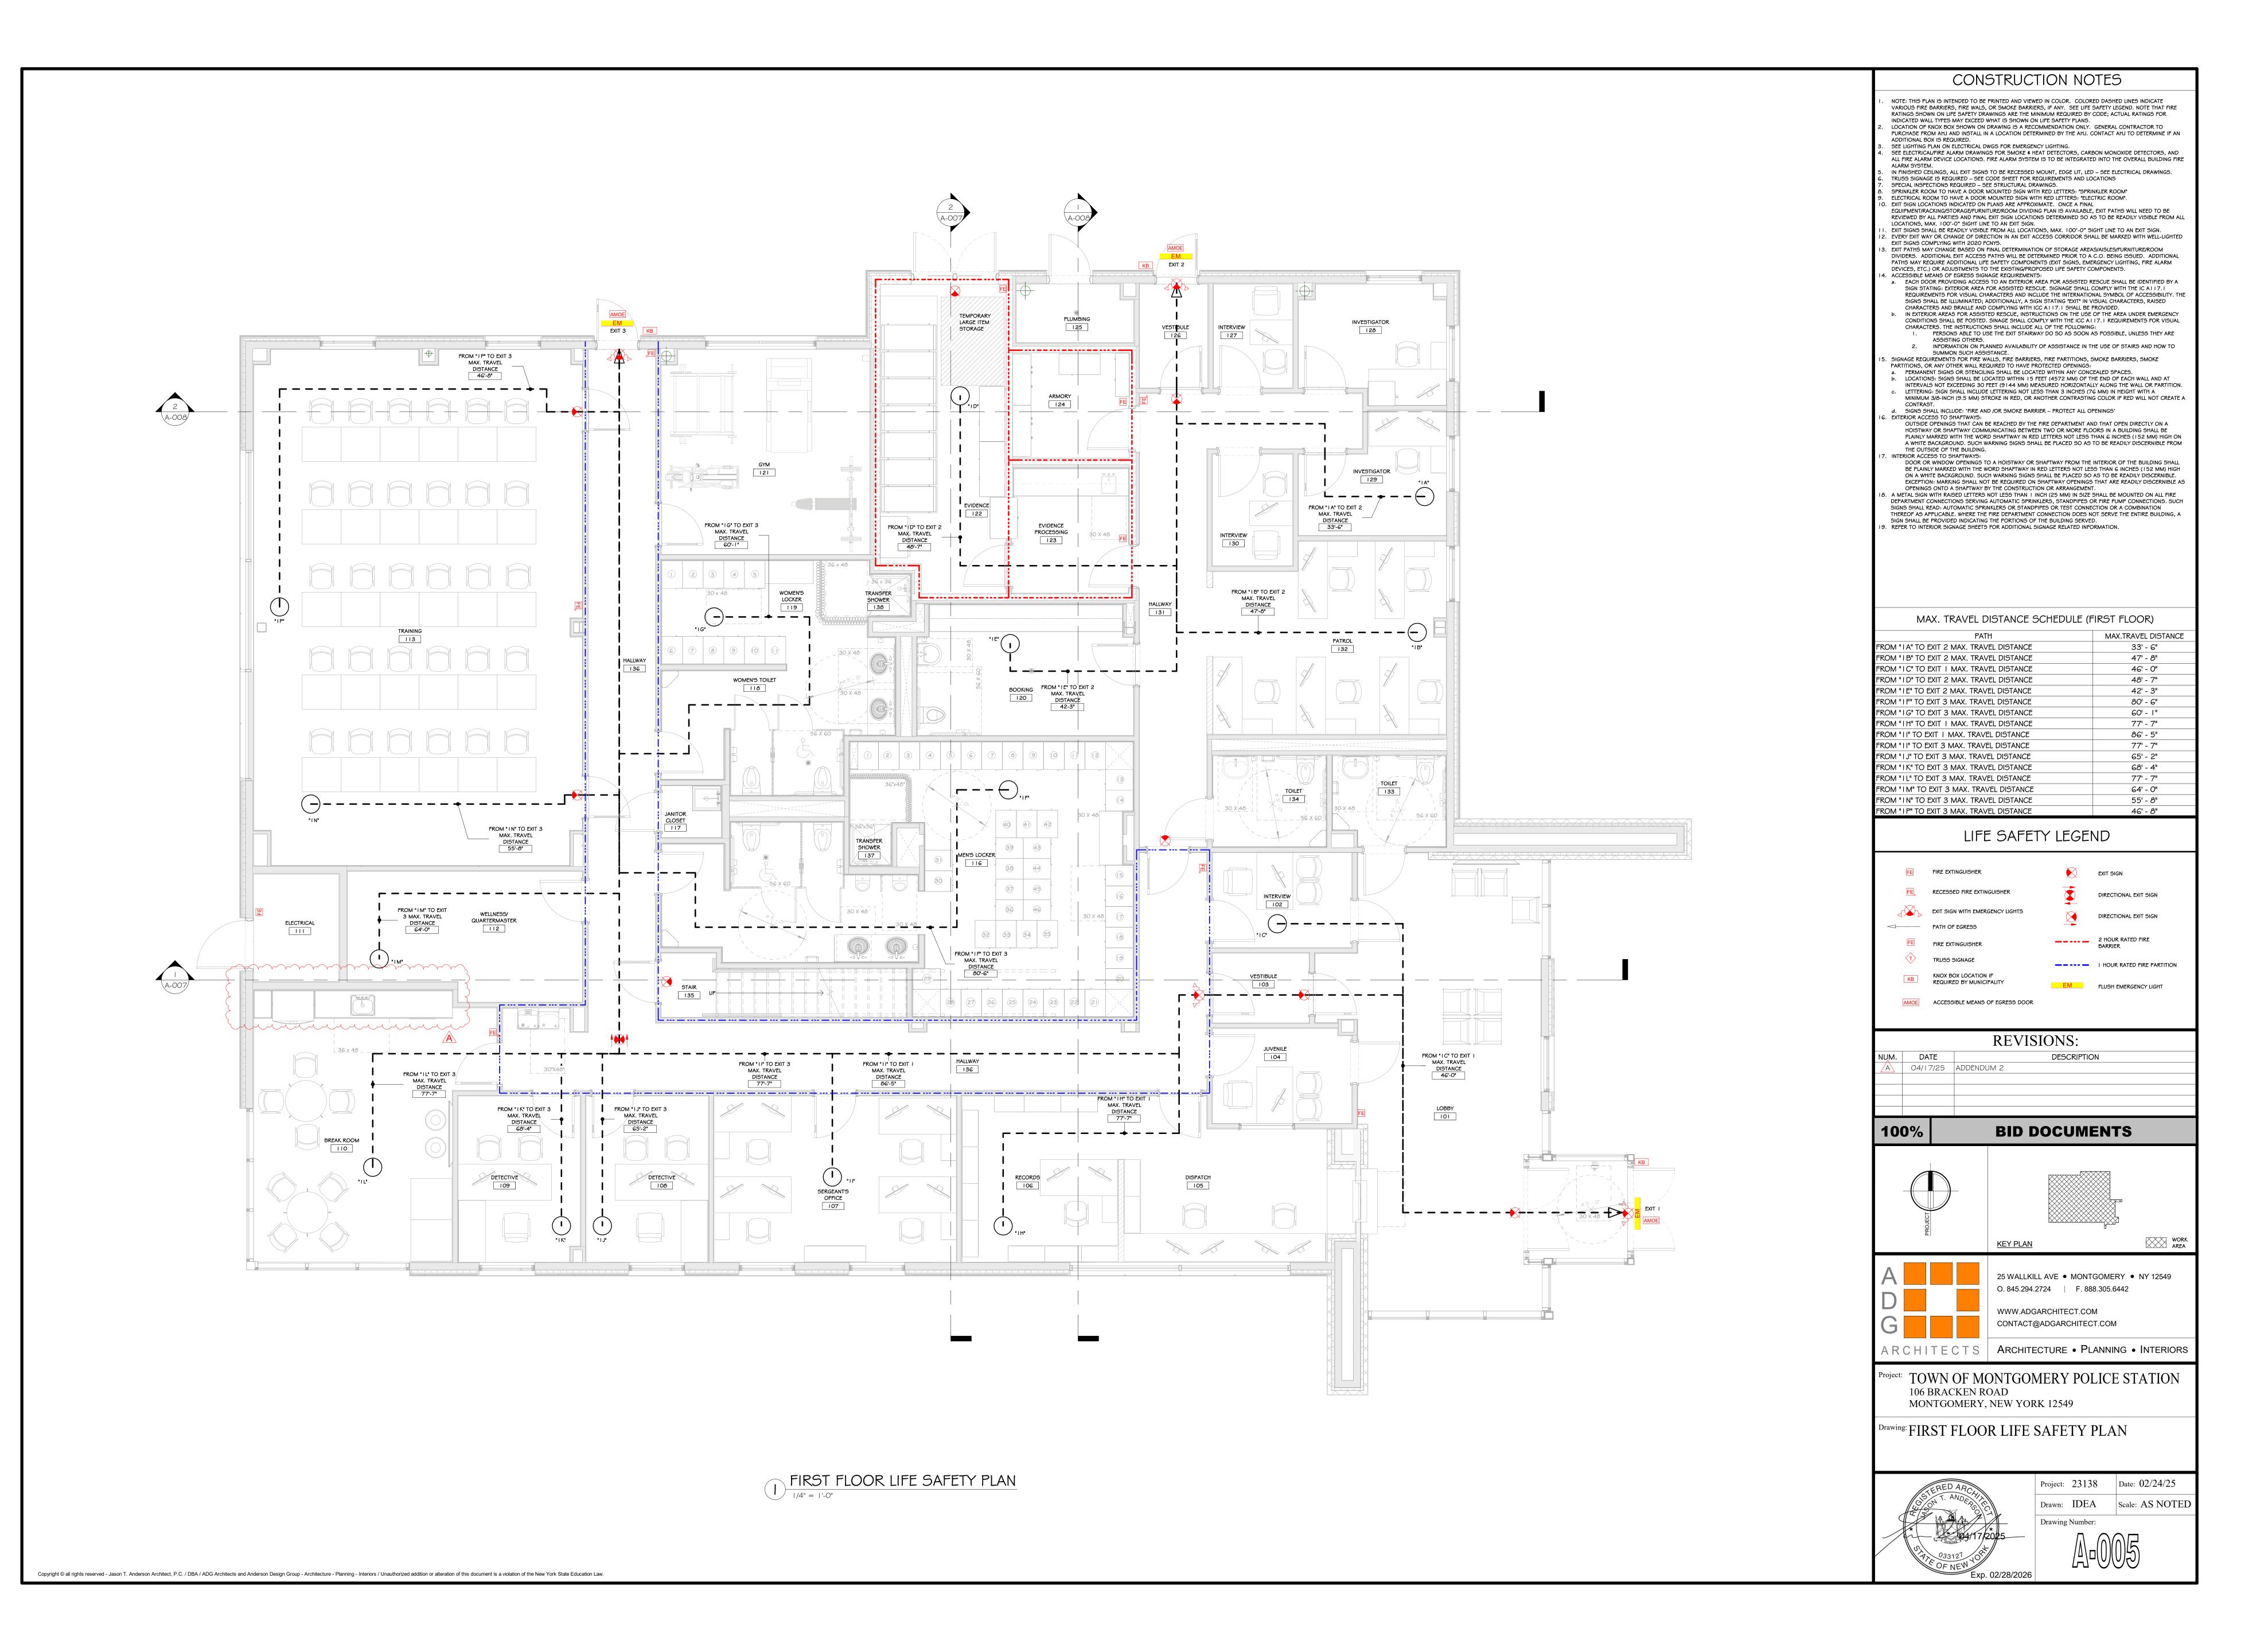

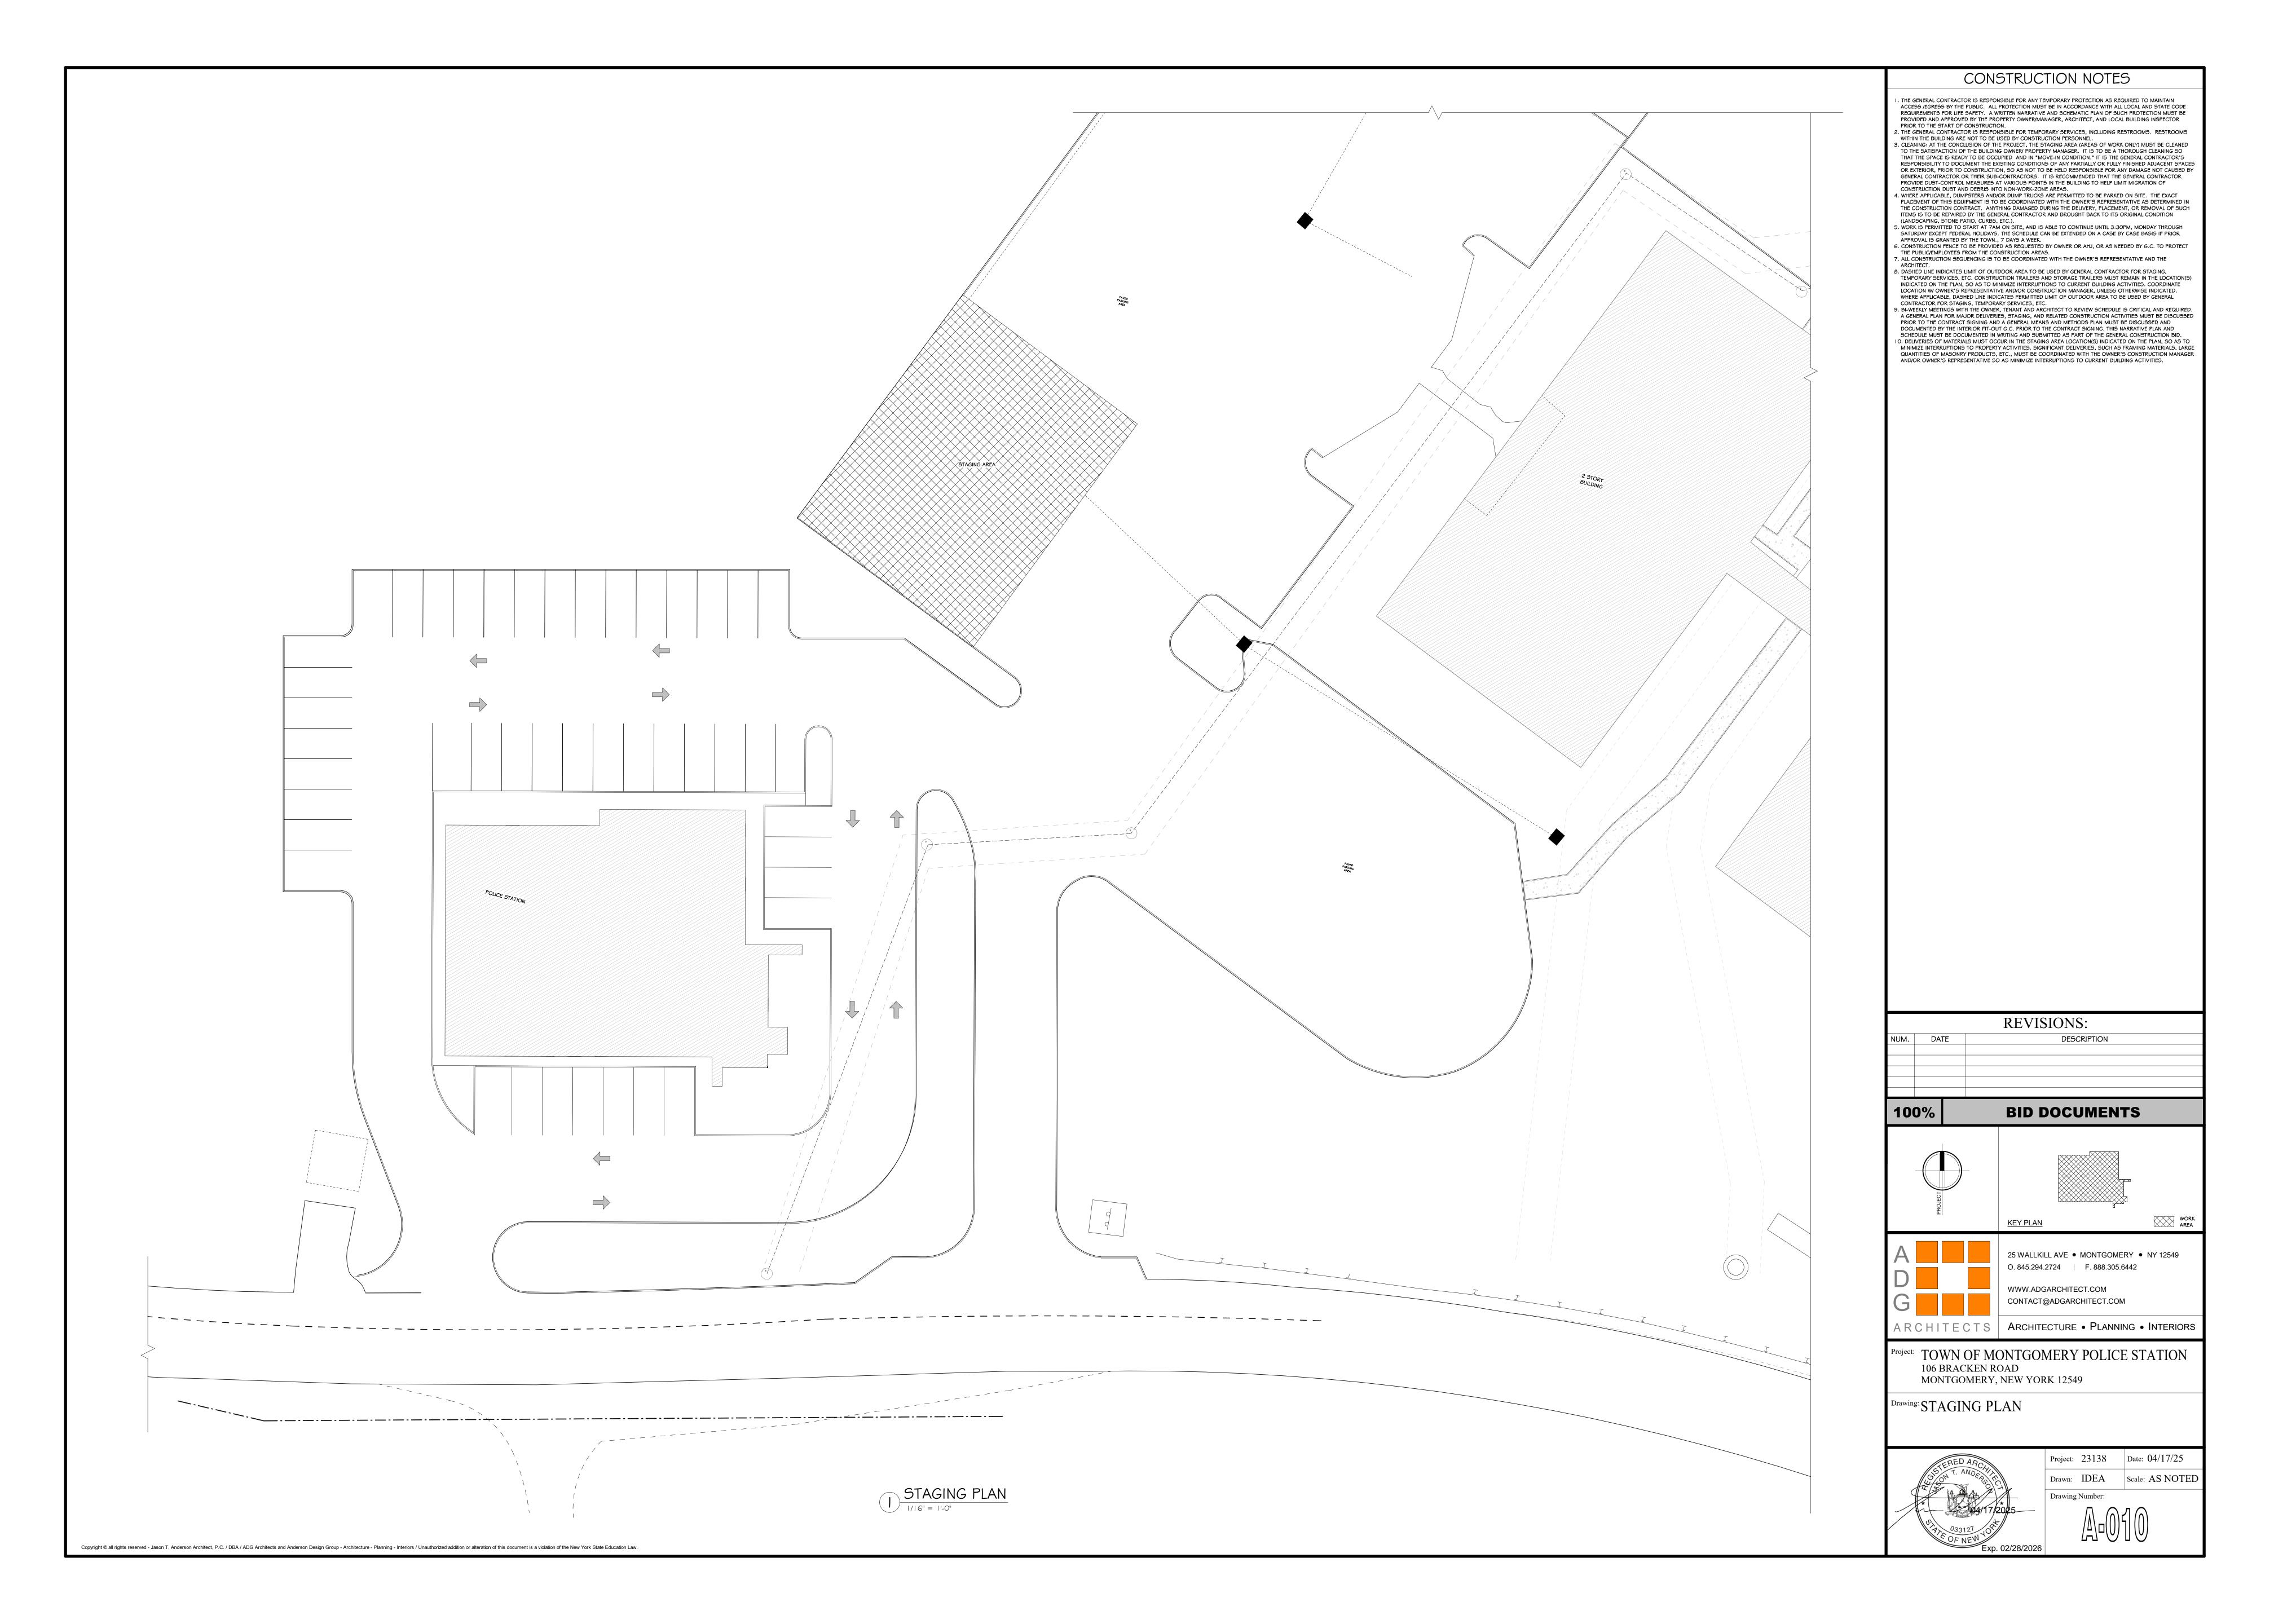


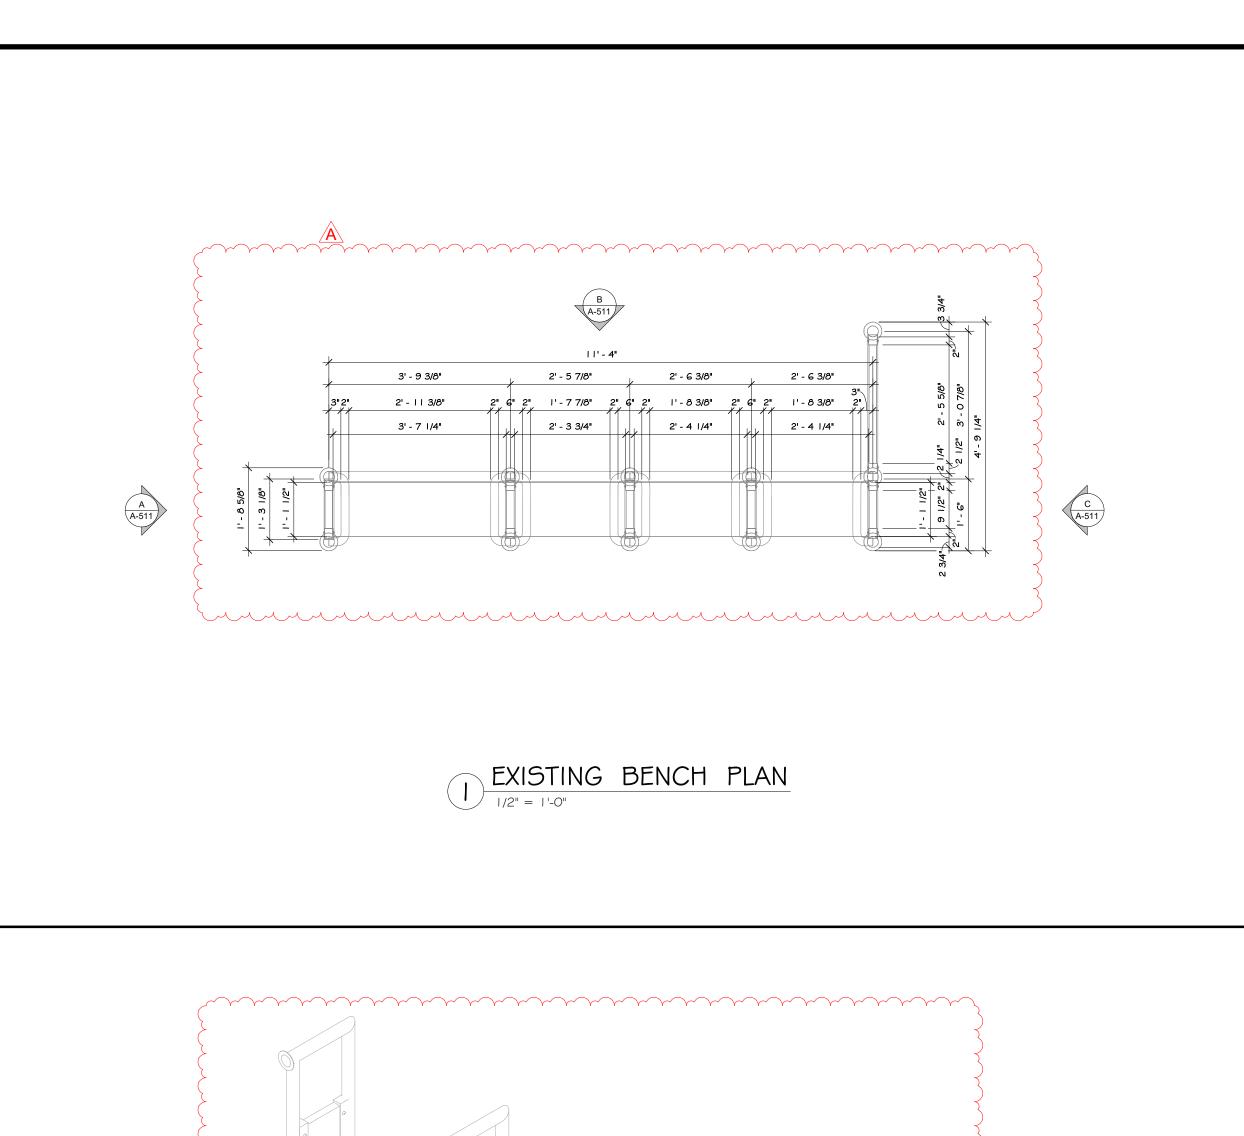

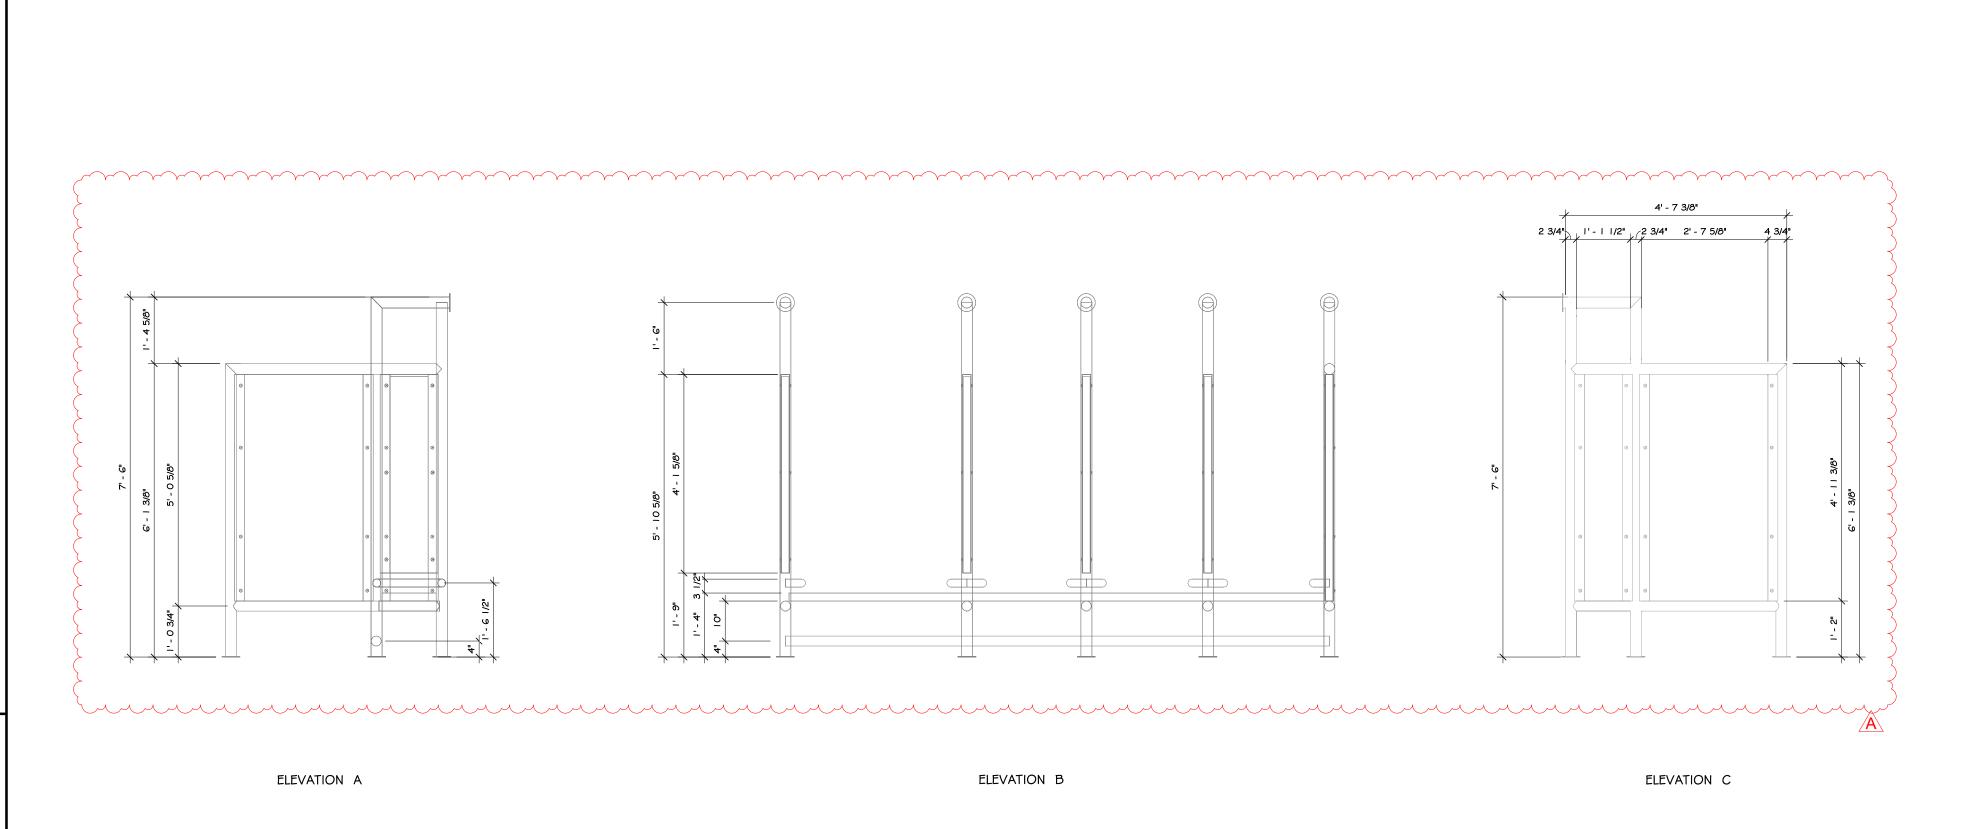


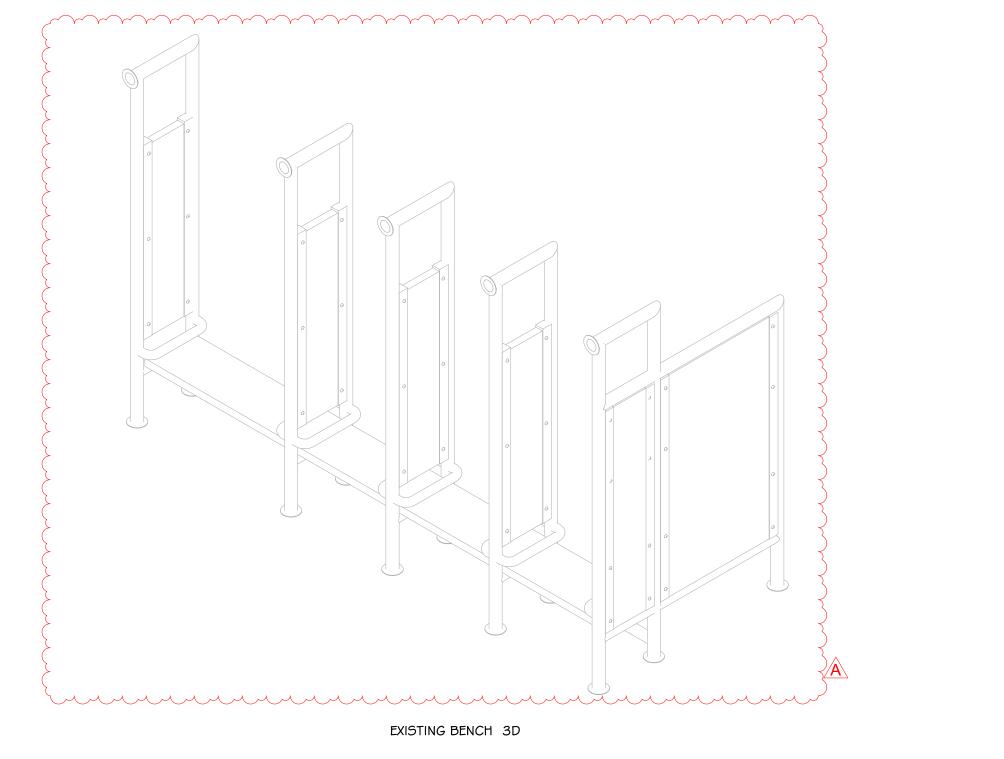




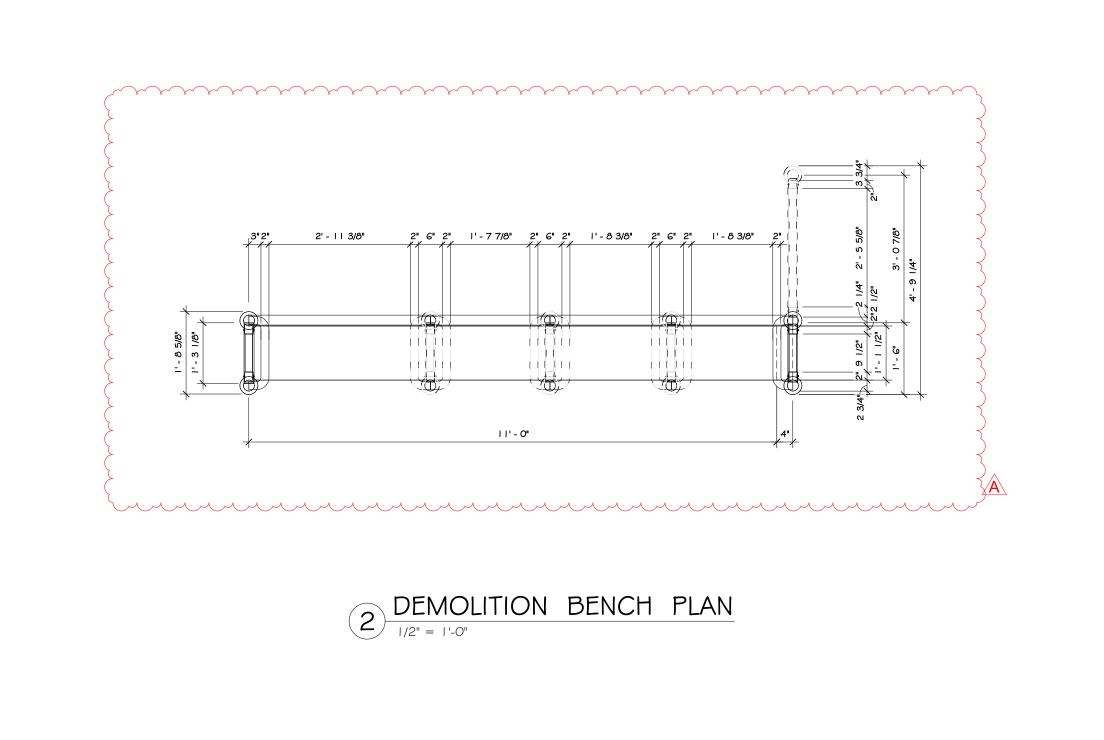

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CONSTRUCTION NOTES

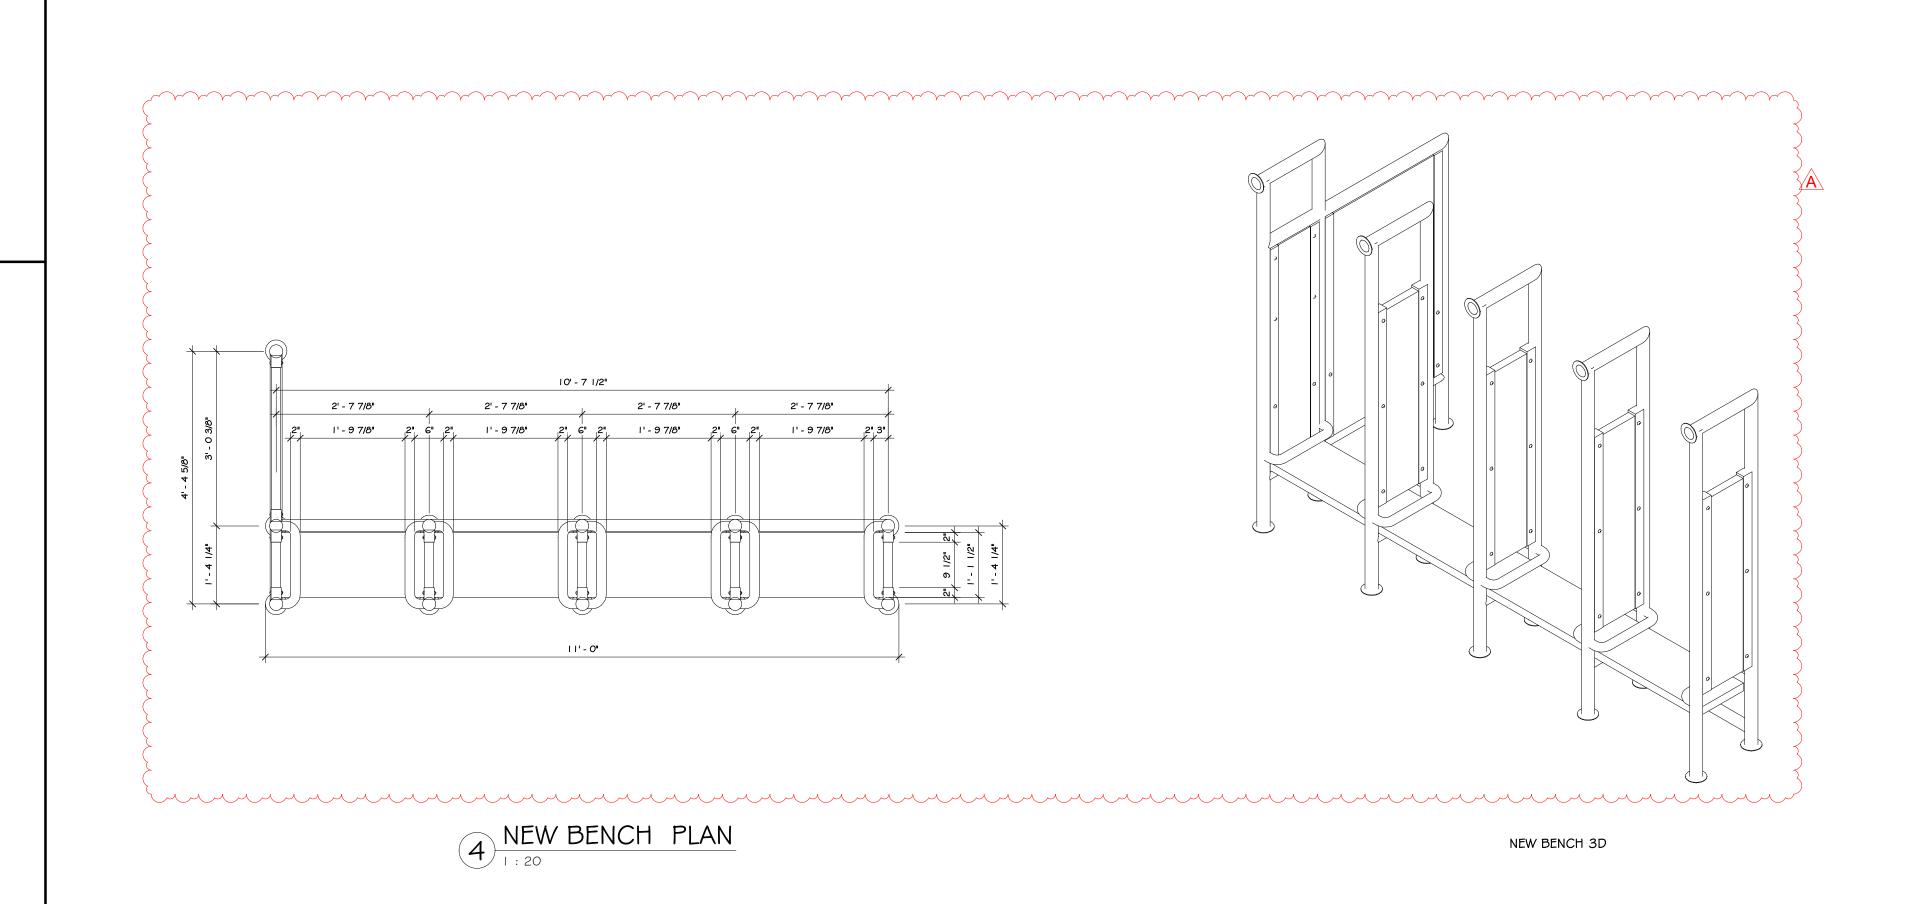REFER TO TYPICAL ACCESSIBILITY REQUIREMENT SHEET IN CONJUNCTION WITH THIS SHEET, FOR MOUNTING

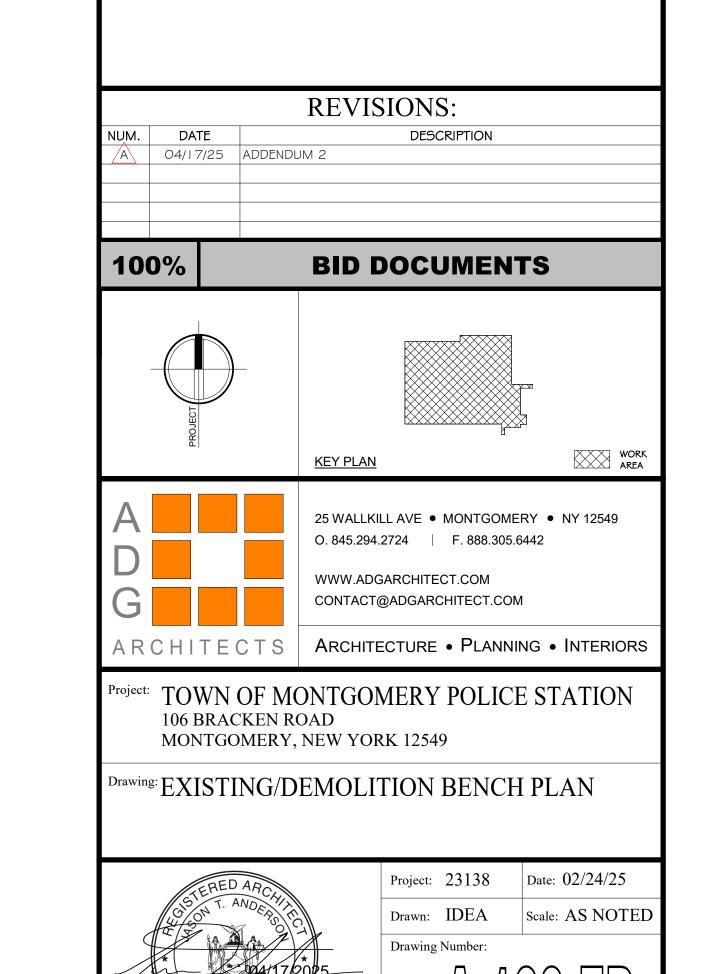TERMINATION POINTS (TOP OF TILE), ETC. ARE TO RECEIVE SCHLUTER EDGE TRIM.

GYP. BOARD TO BE PAINTED WALL W/ COLORS AS PER PAINT PLAN. SEE PAINT PLAN

MICROWAVES, OVENS, RANGES, ETC, PURCHASED BY OWNER, INSTALLED BY G.C.

ETC. COORDINATE LOCATION OF OWNER SUPPLIED EQUIPMENT WITH OWNER.

VENDING MACHINE ARE BY OWNER'S VENDOR. SEE PLAN FOR QUANTITY

OFFICES, CONFERENCE ROOMS, BREAK ROOM, TRAINING AREAS, CAFÉ, ETC.

13. BELOW COUNTER MICROWAVE SHELVES TO ACCOMMODATE A 24" MIN MICROWAVE.

. TV SIZE \$ LOCATIONS TO BE CONFIRMED W/OWNER.

PLUMBING DRAWINGS FOR DETAILS AND SPECIFICATIONS.

SCRIBED FILLER PANELS AS REQUIRED AT WALLS/ CEILINGS.

REPLACEMENT OF SOAP AND ACCESS TO PLUMBING.

INSTALL BLOCKING BEHIND ALL WALL MOUNTED FIXTURES, MIRRORS, GRAB BARS, AND TOILET PARTITIONS, AS TILE TO CONTINUE AROUND ENTIRE ROOM. ALL INSIDE CORNERS, OUTSIDE CORNERS, EXPOSED EDGES AT

PROVIDE FLAT METAL PLATE BLOCKING FOR FLAT SCREEN TV, GRAB BARS, TOILET PARTITIONS, INTERIOR SIGNAGE,

WALL MOUNTED MILLWORK: GC TO PROVIDE FLAT METAL PLATE BLOCKING FOR COUNTER SUPPORT. EXPOSED CMU TO HAVE BLOCK FILL PAINT AT ALL LOCATIONS.STEL COLUMNS TO BE CLEANED, PRIMED & PAINTED. SEE PAINT PLAN & SPECS.APPLIANCES, INCLUDING REFRIGERATOR W/ ICE MAKER, DISHWASHERS,


10. WALL MOUNTED BRACKETS TO BE PROVIDED BY OWNER'S IT/AV CONSULTANT FOR ALL AV EQUIPMENT (TV, SCREENS, PROJECTORS, ETC.) W/POWER & DATA. SEE SPECIFICATIONS FOR VARYING MOUNTING HEIGHTS AT

. DUAL HEIGHT ACCESSIBLE DRINKING FOUNTAIN IS TO BE PROVIDED WITH FILTERED WATER BOTTLE DISPENSER. SEI


12. WOOD APRONS AND/OR SLOPING WOOD PANEL ACCESSIBILITY SCREENS ARE TO BE REMOVABLE TO ALLOW FOR

14. INTERIOR ELEVATIONS ARE FOR SCHEMATIC CABINET LAYOUT. CONTRACTOR TO VERIFY ALL DIMENSIONS. PROVIDE

HEIGHTS AND DIMENSIONS.

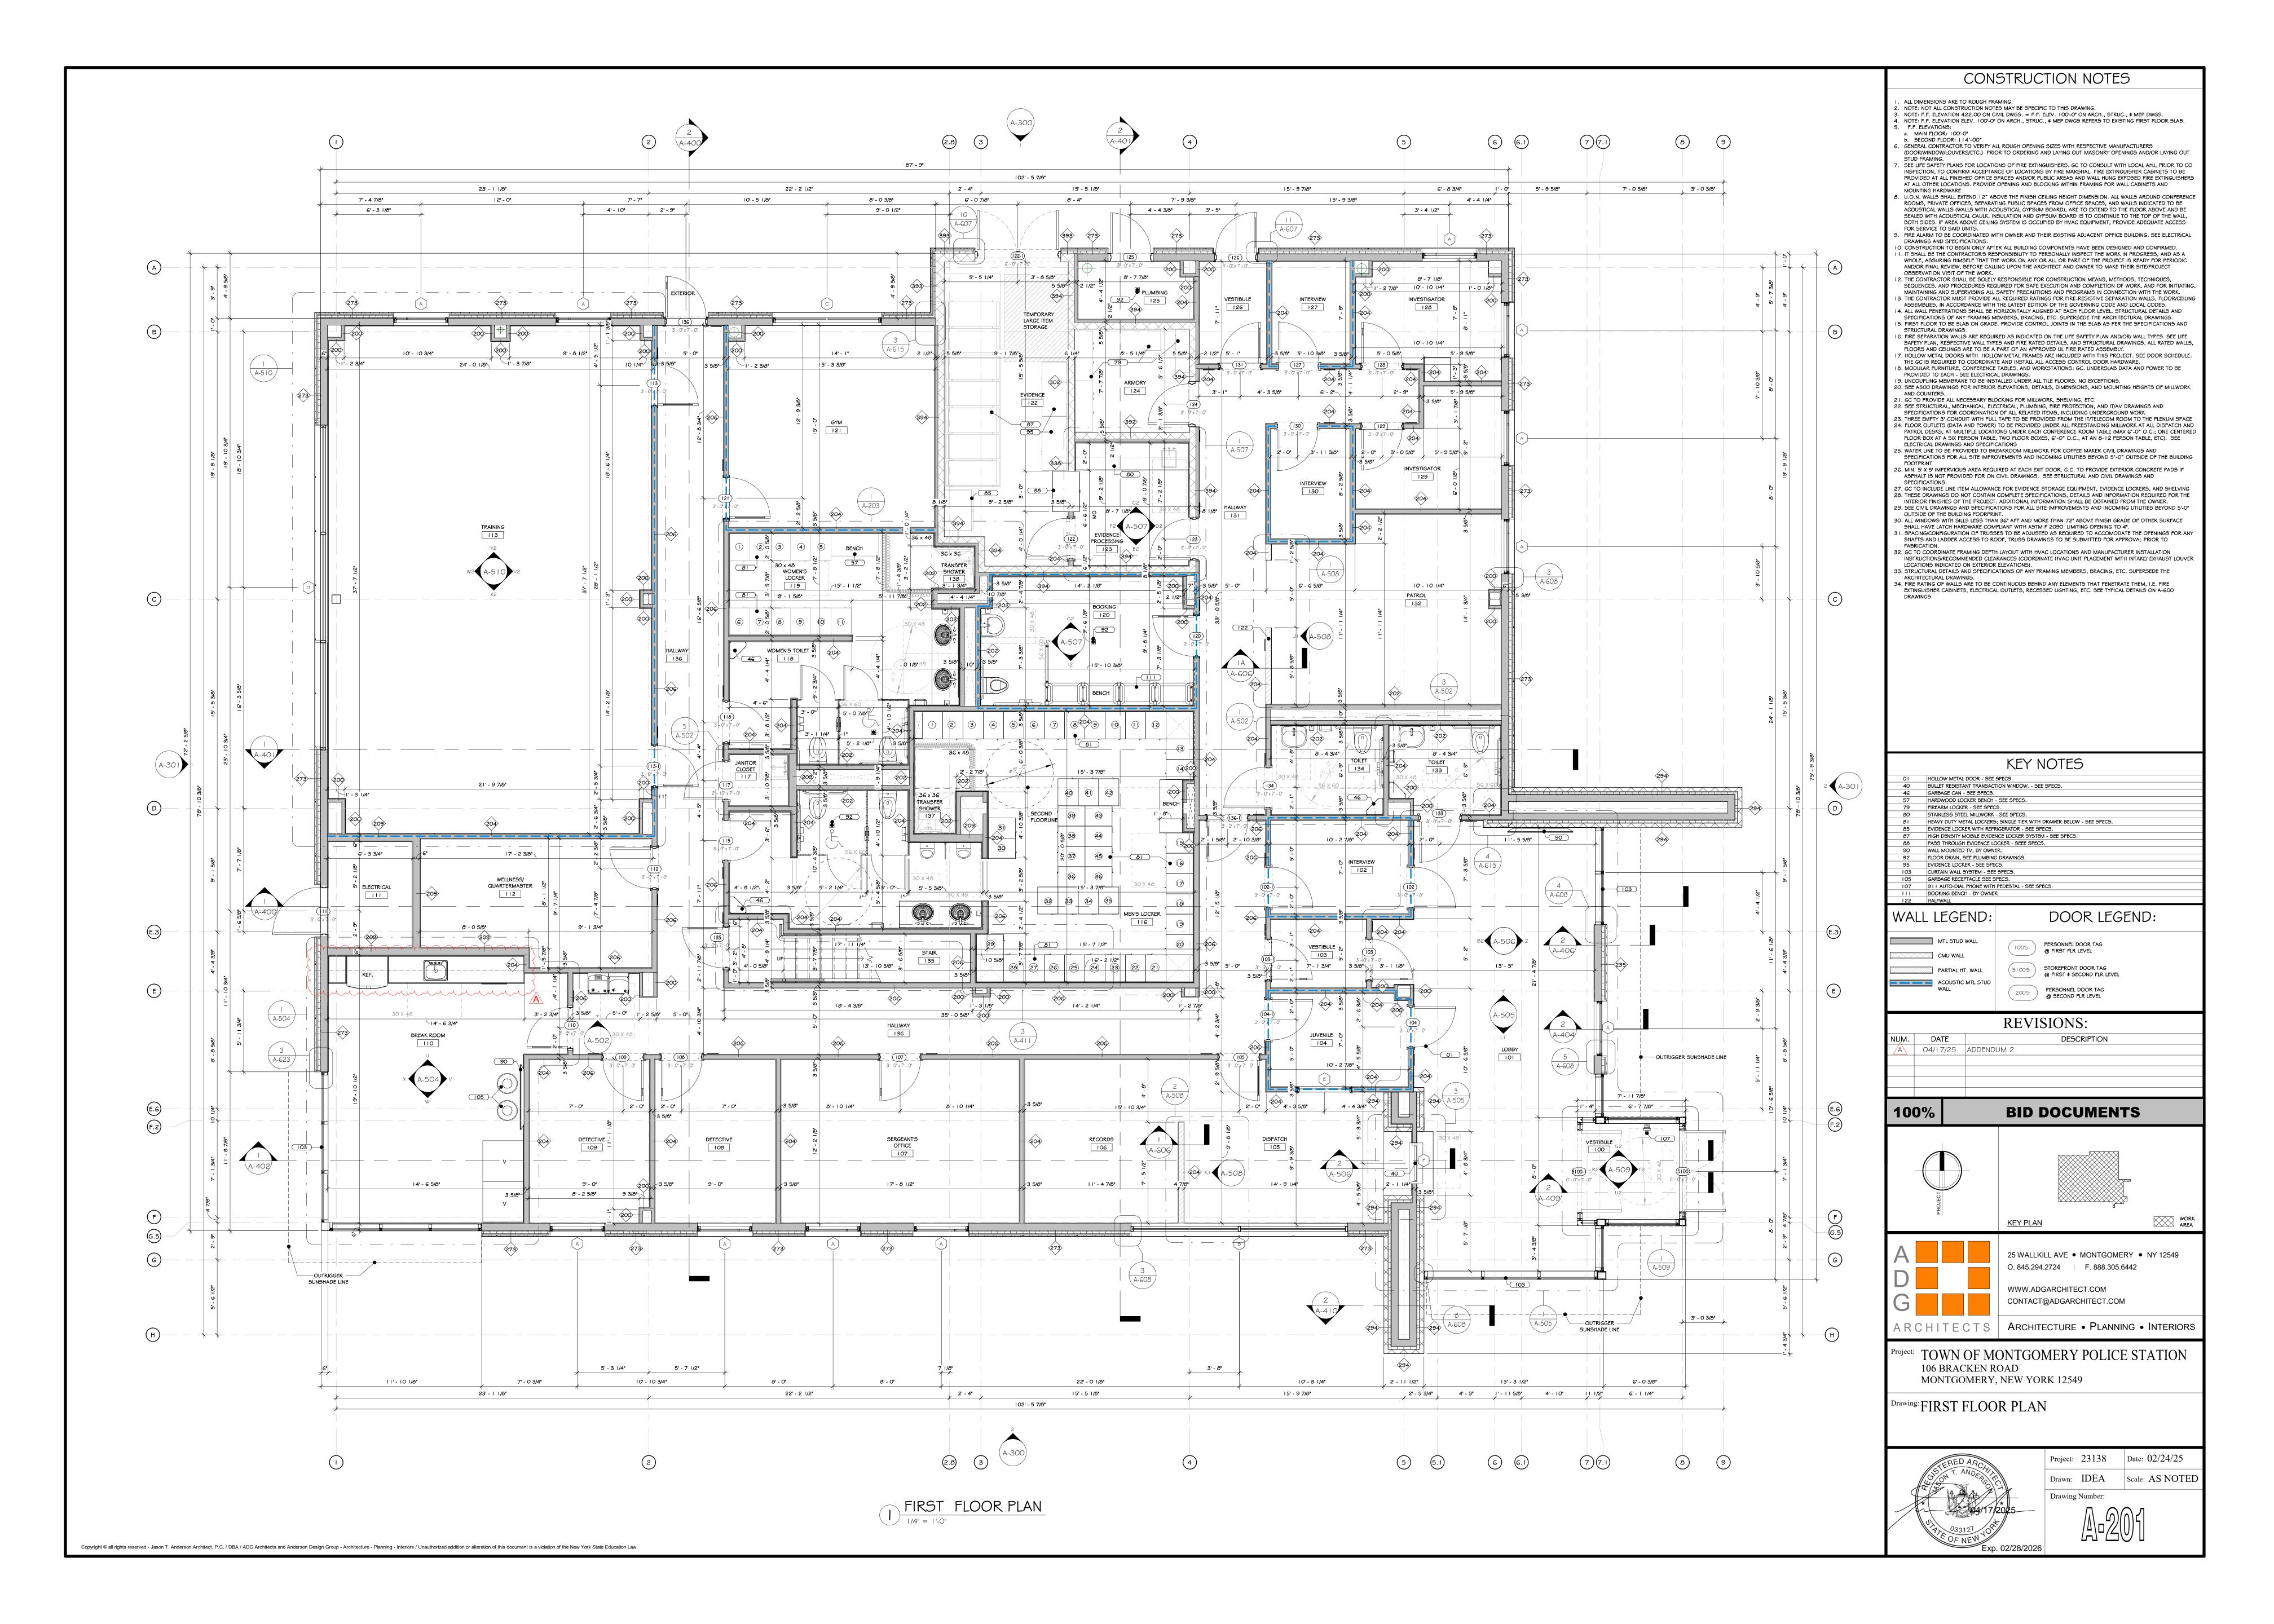



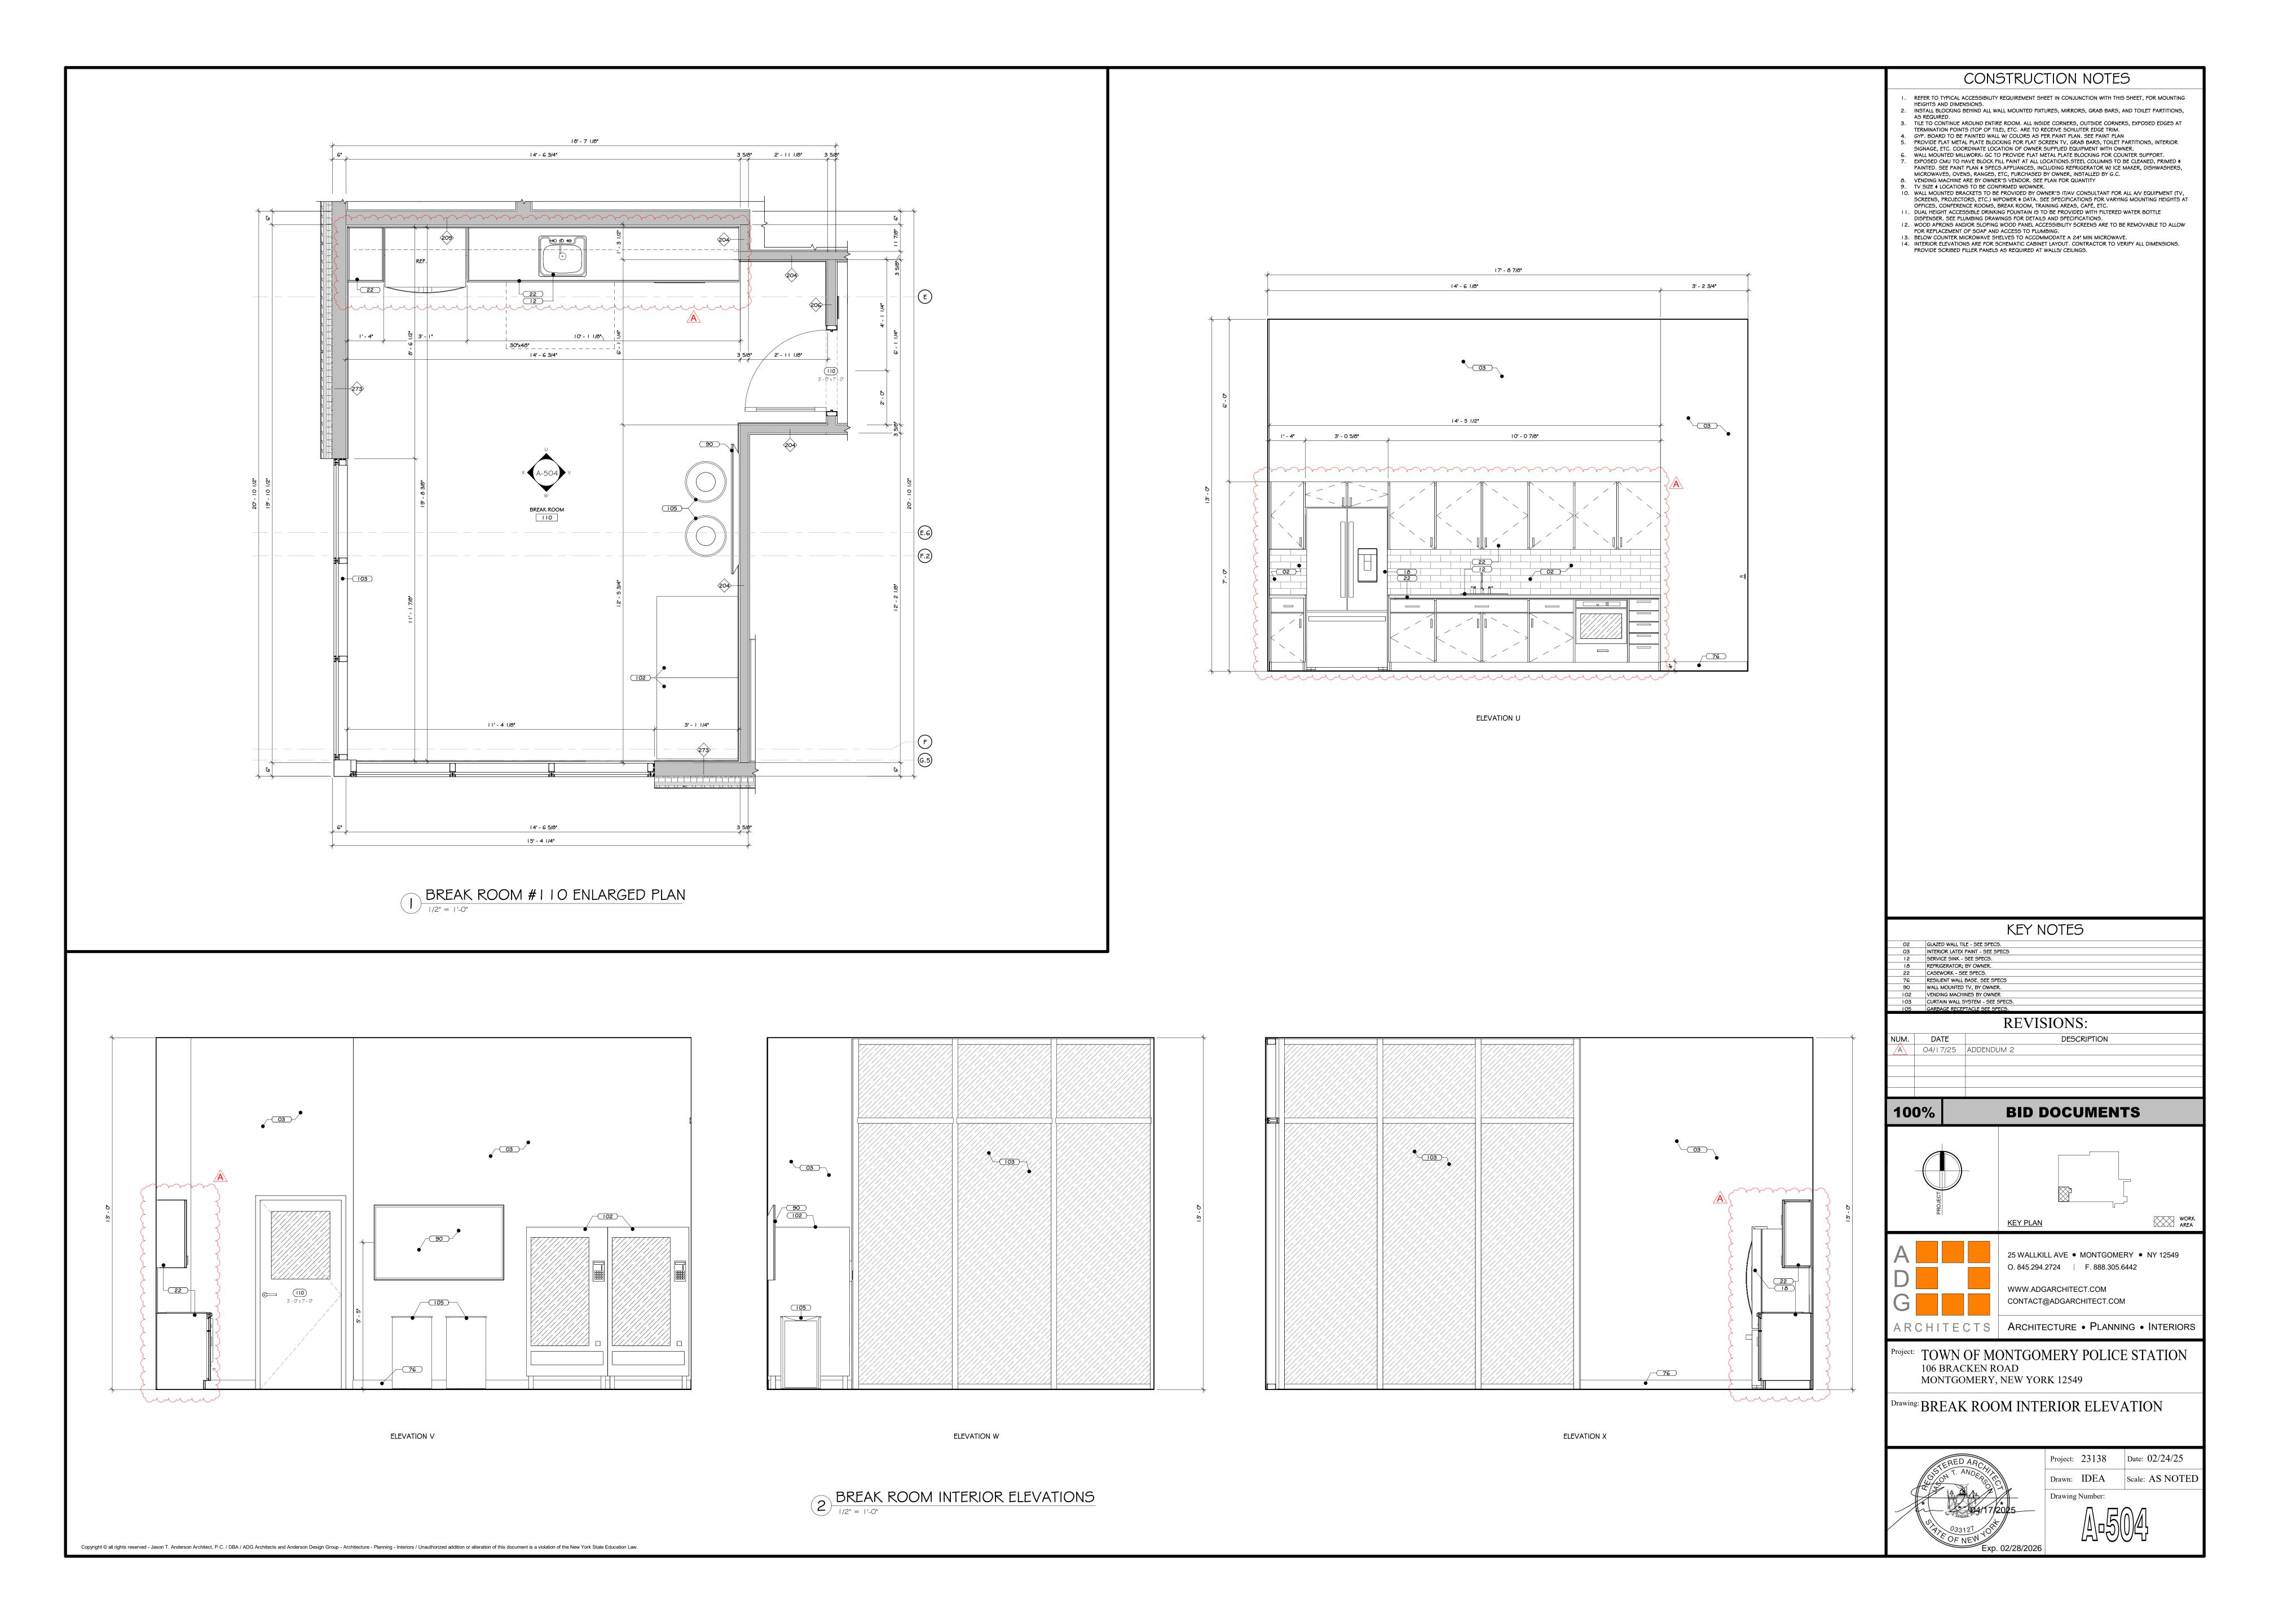



			FINISH SCHEDULE												
		ROOM NAME	FLOO	R	WALLS	C	EILING	DO	OORS	CASE	WORK	MISC.	NOTES		
	ROOM #		FLOOR	BASE		TYPE	FINISH	DOOR	FRAME	CABINETRY	COUNTERTOP				
	100	Vestibule	FL-7			GYP. BD.									
												ACT-2/AWP-1			
-	101	Lobby	FL-1/FL-2	B-1	P-1/W-4/W-5	GYP. BD.			P-4				Notes: 1, 2		
-	102	Interview	FL-1	B-2	P-1	GYP. BD.	ACT-1	WD-1	P-4						
	103	Vestibule	FL-1	B-2	P-2	GYP. BD.	ACT-1		P-4						
_	104	Juvenile	FL-1	B-2	P-1	GYP. BD.	ACT-1	WD-1	P-4						
-	105		FL-1	B-2	P-1/P-3	GYP. BD.	ACT-1	WD-1	P-4	PLAM-2	SS-1	WT-1	Notosi 1		
-	106	Dispatch Records	FL-1	B-2	P-1	GYP. BD.	ACT-1	WD-1	P-4	1 2 2	33 1	WT-1	Notes: 1		
-	100	Sergeant's		+	_	0	1.0								
	107	Office	FL-1	B-2	P-1	GYP. BD.	ACT-1	WD-1	P-4			WT-1	Notes: 1		
	108	Detective	FL-1	B-2	P-1	GYP. BD.	ACT-1	WD-1	P-4			WT-1			
	109	Detective	FL-1	B-2	P-1	GYP. BD.	ACT-1	WD-1	P-4			WT-1			
	110	Break Room	FL-2	B-2	P-1/P-3	GYP. BD.	ACT-1	WD-1	P-4	PLAM-2	SS-1	WT-1	Notes: 1, 3		
	111	Electrical	FL-4	B-2	P-2			Paint	P-4						
	112	Wellness/Quart	FL-1	B-2	P-2	ACT	ACT-1	Paint	P-4						
_	112	ermaster		B-2	P-2/P-3	ACT	ACT-1	WD-1	P-4 P-4			WT-1	N1-1		
-	113	Training	FL-5/FL-6	υ-2	W-1	ACT	ACT-1	WD-1	P-4 P-4			TP-1	Notes: 1, 2		
	115 116	Men's Toilet	FL-3		W-1	ACT	ACT-1	AAD-T	P-4 P-4			11 4			
Ŏ ⊢	117	Men's Locker	FL-3	B-1	P-2	ACT	ACT-1	WD-1	P-4 P-4						
	11/	Janitor Closet	1		1 4	7.01	/.С. 1	AAD-T	-						
1ST	118	Women's Toilet	FL-3		W-1	ACT	ACT-1	WD-1	P-4	PLAM-1	SS-2	TP-1			
		Women's													
-	119	Locker	FL-3		W-1	ACT	ACT-1		P-4	PLAM-1	SS-2				
-	120	Booking	FL-2	B-2	P-1	ACT	ACT-1	Paint	P-4	Stainless	Stainless				
-	121	Gym	FL-8	B-2		ACT	ACT-1	WD-1	P-4	0-0-0-0-	A				
-	122	Evidence	FL-4	B-2	P-2			Paint	P-4				Notes: 1		
	123	Evidence Processing	FL-4	B-2	P-2			Paint	P-4	Stainless	Stainless				
	124	Armory	FL-4	B-2				Paint	P-4						
-	125	Plumbing	FL-4	B-2	P-2			Paint	P-4						
-	126	Vestibule	FL-7	B-2	P-2	ACT	ACT-1	Paint	P-4						
-	127	Interview	FL-1	B-2	P-1	ACT	ACT-1	Paint	P-4			WT-1			
-	128	Investigator	FL-1	B-2	P-1	ACT	ACT-1	Paint	P-4			WT-1			
-	129	Investigator	FL-1	B-2	P-1	ACT	ACT-1	Paint	P-4			WT-1			
_	130	Interview	FL-1	B-2	P-1	ACT	ACT-1	Paint	P-4						
_	131	Hallway	FL-1	B-2	P-1	ACT	ACT-1	Paint	P-4						
	132	Patrol	FL-1	B-2	P-1	ACT	ACT-1	Paint	P-4			WT-1			
-	133	Toilet			W-1	ACT	ACT-1	Paint	P-4						
	134	Toilet			W-1	ACT	ACT-1	Paint	P-4						
-	135	Stair		B-2	P-2	ACT	ACT-1	WD-1	P-4						
	136	Hallway	FL-1	B-2	P-1	ACT	ACT-1		P-4						
	127	Transfer			W-1	ACT	ACT-1		P-4						
	137 138	Shower Transfer Shower			W-1	ACT	ACT-1		P-4 P-4						
	130	i i alistet silower			AA-T	1	ACI-I								
	200	Stair	FL-10	B-2	P-2	ACT	ACT-1		P-4						
-	201	Records	FL-1	B-2		ACT	ACT-1	WD-1	P-4			WT-1	Notes: 1		
_	202	Chief's Office	FL-6	B-2	P-2	ACT	ACT-1	WD-1	P-4			WT-1			
-	203	Lieutenant	FL-6	B-2		ACT	ACT-1	WD-1	P-4			WT-1	Notes: 1		
	204	Conference	FL-6	B-1		ACT	ACT-1	WD-1	P-4			WT-1	INULES, I		
0	205	Storage	FL-1			ACT	ACT-1	WD-1	P-4						
O L	206	IT Room	FL-9	B-2		ACT	ACT-1	WD-1	P-4						
	207	Mechanical	FL-4	B-2				Paint	P-4						
	207	Hallway	FL-1	B-2		ACT	ACT-1	WD-1	P-4						
7		⊢⊓dIIWdV	ı ·	ı	ı · -	1	1	1	1.	1			1		
7	200	,													

# FINISH SCHEDULE NOTES

1. ALL EXPOSED STEEL TO BE PAINTED SW #7068 GRIZZLE GRAY.

2. REFER TO FINISH PLANS FOR FLOORING INSTALLATION PATTERN. 3. PROVIDE BACK SPLASH/ SIDE SPLASH AND APPLY CONTINUOUS SEALANT IN ALL LOCATIONS WHERE COUNTERTOP ABUTS

4. REFER TO REFLECTED CEILING PLANS FOR CEILING TYPES AND HEIGHTS.

FINISH SCHEDULE LEGEND FL-1 LUXURY VINYL TILE SPECIFICATION SECTION 09 65 00 MANUFACTURER/ DISTRIBUTOR MILLIKEN THE MAGIC HOUR DIMENSIONS 19.7" X 19.7" (50 cm X 50 cm) COLOR ATMOSPHERE AMS68 LENS FL-2 LUXURY VINYL TILE SECTION 09 65 00 SPECIFICATION MANUFACTURER/ DISTRIBUTOR MILLIKEN THE MAGIC HOUR DIMENSIONS 19.7" X 19.7" (50 cm X 50 cm) ATMOSPHERE AMS217 FILTER FL-3 24" X 24" PORCELAIN TILE SPECIFICATION SECTION 09 30 00 MANUFACTURER/ DISTRIBUTOR PORCELANOSA NEWPORT STYLE DIMENSIONS COLOR NEWPORT DARK GRAY GROUT LATTICRETE #45 RAVEN FL-4 SEALED CONCRETE SPECIFICATION SECTION 03 35 11 MANUFACTURER/ DISTRIBUTOR PPG 2550 WB URETHANE STYLE FINISH STEEL TROWEL FINISH FL-5 CARPET TILE SPECIFICATION SECTION 09 68 13 MANUFACTURER/ DISTRIBUTOR MILLIKEN STYLE COUNTERCULTURE 19.7" X 19.7" (50 cm X 50 cm) DIMENSIONS PHENOM PHN13-265 FIGMENT COLOR **CARPET TILE** SECTION 09 68 13 SPECIFICATION MANUFACTURER/ DISTRIBUTOR MILLIKEN STYLE COUNTERCULTURE 19.7" X 19.7" (50 cm X 50 cm) DIMENSIONS PHENOM PHN13-27 ATYPICAL COLOR FL-7 WALK OFF MAT SPECIFICATION SECTION 09 68 13 MANUFACTURER/ DISTRIBUTOR MILLIKEN OBEX CUTX / FIBER 19.7" X 19.7" (50 cm X 50 cm) DIMENSIONS COLOR FRX118 - 119 DARK GREY FL-8 RUBBER FLOORING SECTION 09 65 66 SPECIFICATION MANUFACTURER/ DISTRIBUTOR STYLE TUFLEX SPARTUS 27" X 27" DIMENSIONS COLOR 913 CHARCOAL FL-9 ANTI-STATIC VCT FLOOR TILES SPECIFICATION SECTION 09 65 00 MANUFACTURER/ DISTRIBUTOR STATIC WORX AMERIWORX ESD SOLID VINYL TILE DIMENSIONS 12"X12" ROX GRAY DOLOMITE COLOR FL-10 RUBBER STAIR TREAD SECTION 09 65 00 SPECIFICATION MANUFACTURER/ DISTRIBUTOR ROPPE STYLE SYMMETRY #S100 BLACK

 $\frac{1}{1}$ B-1 RUBBER WALL BASE SPECIFICATION SECTION 09 65 00 MANUFACTURER/ DISTRIBUTOR JOHNSONITE STYLE Mandalay DIMENSIONS COLOR 40 BLACK RUBBER WALL BASE SECTION 09 65 00 SPECIFICATION MANUFACTURER/ DISTRIBUTOR JOHNSONITE STYLE Mandalay DIMENSIONS COLOR 01 SNOW WHITE P-1 PAINT SECTION 09 90 00 SPECIFICATION MANUFACTURER/ DISTRIBUTOR SHERWIN WILLIAMS COLOR SW 6134 NETSUKE EGGSHELL P-2 PAINT SECTION 09 90 00 SPECIFICATION MANUFACTURER/ DISTRIBUTOR SHERWIN WILLIAMS COLOR SW 7012 CREAMY FINISH EGGSHELL P-3 PAINT SPECIFICATION SECTION 09 90 00 MANUFACTURER/ DISTRIBUTOR SHERWIN WILLIAMS COLOR SW 7670 GRAY SHINGLE EGGSHELL PAINT SPECIFICATION SECTION 09 90 00 MANUFACTURER/ DISTRIBUTOR SHERWIN WILLIAMS SW 7068 GRIZZLE GRAY COLOR FINISH SEMI -GLOSS W-1 GLAZED CERAMIC WALL TILE SPECIFICATION SECTION 09 30 00 MANUFACTURER/ DISTRIBUTOR DALTILE STYLE LINEAR DIMENSIONS 4" X 12" COLOR ARCTIC WHITE 0190 INSTALLATION SUBWAY GROUT LATICRETE 78 STERLING SILVER W-2 ACM -1 SECTION 07 42 13.23 MANUFACTURER/ DISTRIBUTOR ALUCOBOND PLUS STYLE THE CLASSIC COLLECTION COLOR AZURE BLUE W-3 ALUM-1 SECTION 07 42 13 SPECIFICATION MANUFACTURER/ LONGBOARD DISTRIBUTOR ARCHITECTURAL PRODUCTS STYLE TONGUE & GROOVE CLADDING DIMENSIONS DARK CHERRY COLOR W-4 CMU VENEER-1 SPECIFICATION SECTION 04 73 00 ECHELON MASONRY / SPEC MANUFACTURER/ DISTRIBUTOR STYLE CORDOVA STONE 4"X24" DIMENSIONS COLOR MIDNIGHT CHISEL MORTAR SM770 SABLE W-5 CMU VENEER-2 SPECIFICATION SECTION 04 73 00 ECHELON MASONRY / SPEC MANUFACTURER/ DISTRIBUTOR STYLE CORDOVA STONE DIMENSIONS 8"X24" **GRANITE CHISEL** 


MORTAR

SM770 SABLE

ACT-1 ACOUSTIC CEILING TILE SPECIFICATION SECTION 09 51 00 MANUFACTURER/ DISTRIBUTOR ARMSTRONG ULTIMA BEVELED TEGULAR DIMENSIONS 24" X 24" COLOR WHITE SUSPENSION PRELUDE XL 9/16" 四 ACT-2 ACOUSTICAL VERTICAL PANEL SECTION 09 84 30 SPECIFICATION MANUFACTURER/ DISTRIBUTOR ARMSTRONG SOUNDSCAPES STYLE DIMENSIONS 10.5"X46"X2" COLOR OCEAN SUSPENSION CABLE SUSPENSION

		3031 LINSION	CADLE 3031 LINSION
	PLAM-1	HIGH PRESSURE LA	MINATE
			SECTION 06 41 00
		MANUFACTURER/ DISTRIBUTOR	WILSONART
		COLOR	PARTICO TEAK 8210K-28
		FINISH	GLOSS LINE FINISH
		GRAIN DIRECTION	
		GRAIN DIRECTION	VERTICAL
	PLAM-2	HIGH PRESSURE LA	MINATE
		SPECIFICATION	SECTION 06 41 00
		MANUFACTURER/	
			WILSONART
		COLOR	FIELD ELM 7999K-12
		FINISH	SOFTGRAIN FINISH
CASEWORK		GRAIN DIRECTION	VERTICAL
> >	SS-1	SOLID SURFACE CO	UNTERTOP
7		SPECIFICATION	SECTION 12 36 00
5		MANUFACTURER/	
		DISTRIBUTOR	CAMBRIA
		TYPE	QUARTZ
		COLOR	NEWPORT MATE
		FINISH	MATTE
		EDGE	EASED
	SS-2	SOLID SURFACE CO	UNTERTOP
		SPECIFICATION	SECTION 12 36 00
		SPECIFICATION  MANUFACTURER/	SECTION 12 36 00
		MANUFACTURER/ DISTRIBUTOR	SECTION 12 36 00 CORIAN
		MANUFACTURER/	
		MANUFACTURER/ DISTRIBUTOR	CORIAN
		MANUFACTURER/ DISTRIBUTOR TYPE	CORIAN QUARTZ

	WT-1	WINDOW TREATM	ENT									
		SPECIFICATION MANUFACTURER/	SECTION 12 24 00									
		DISTRIBUTOR	DRAPER, INC.									
		STYLE	DOUBLE ROLLER SHADE: LIGHT FILTERING AND BLACKOUT									
		COLOR	TBD									
	AWP-1	ACOUSTIC WALL PA	IC WALL PANEL									
		SPECIFICATION MANUFACTURER/	SECTION 09 84 30									
		DISTRIBUTOR	ARKTURA									
		PRODUCT	SOFT SCREEN									
ci		STYLE	SLANT									
MISC.		COLOR	HEATHER GRAY									
	TP-1	TOILET PARTITION										
		SPECIFICATION MANUFACTURER/	SECTION 10 21 13.17									
		DISTRIBUTOR	ASI GLOBAL PARTITION									
		TYPE	PHENOLIC TOILET PARTITION									
		STYLE	ALPACO CLASSIC									
		COLOR	#3020 GRAPHITE GRAFIX									
	WD-1	WOOD DOOR VENI	EER									
		SPECIFICATION MANUFACTURER/	SECTION 08 14 16									
		DISTRIBUTOR	LAMBTON DOORS									
		STYLE	SLICED WHITE BIRCH									
		COLOR	PLS INDONESIAN TEAK									

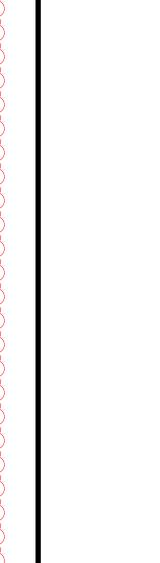


**REVISIONS:** DESCRIPTION A 04/17/25 ADDENDUM 2 **BID DOCUMENTS KEY PLAN** 25 WALLKILL AVE • MONTGOMERY • NY 12549 O. 845.294.2724 F. 888.305.6442 WWW.ADGARCHITECT.COM CONTACT@ADGARCHITECT.COM ARCHITECTS | ARCHITECTURE • PLANNING • INTERIORS

CONSTRUCTION NOTES

Project: TOWN OF MONTGOMERY POLICE STATION 106 BRACKEN ROAD MONTGOMERY, NEW YORK 12549

Drawing: FINISH SCHEDULE

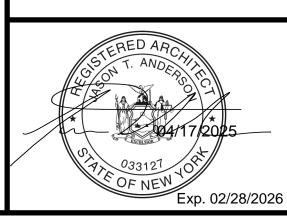



Project: 23138 Date: 02/14/25 Drawn: IDEA Scale: AS NOTED Drawing Number:


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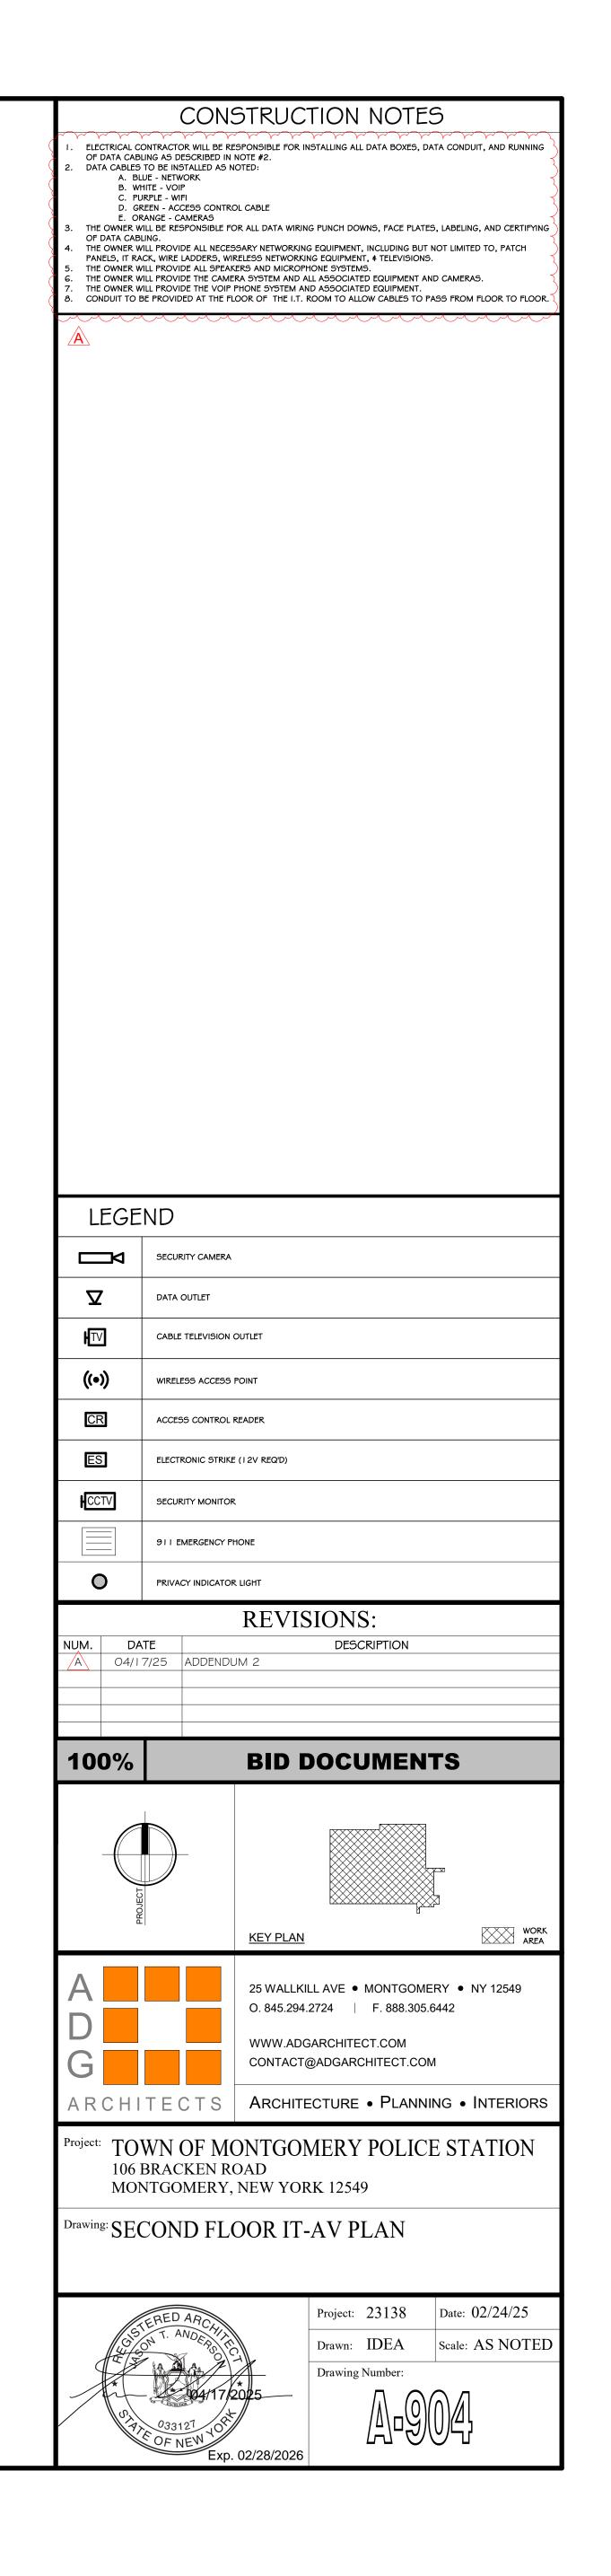







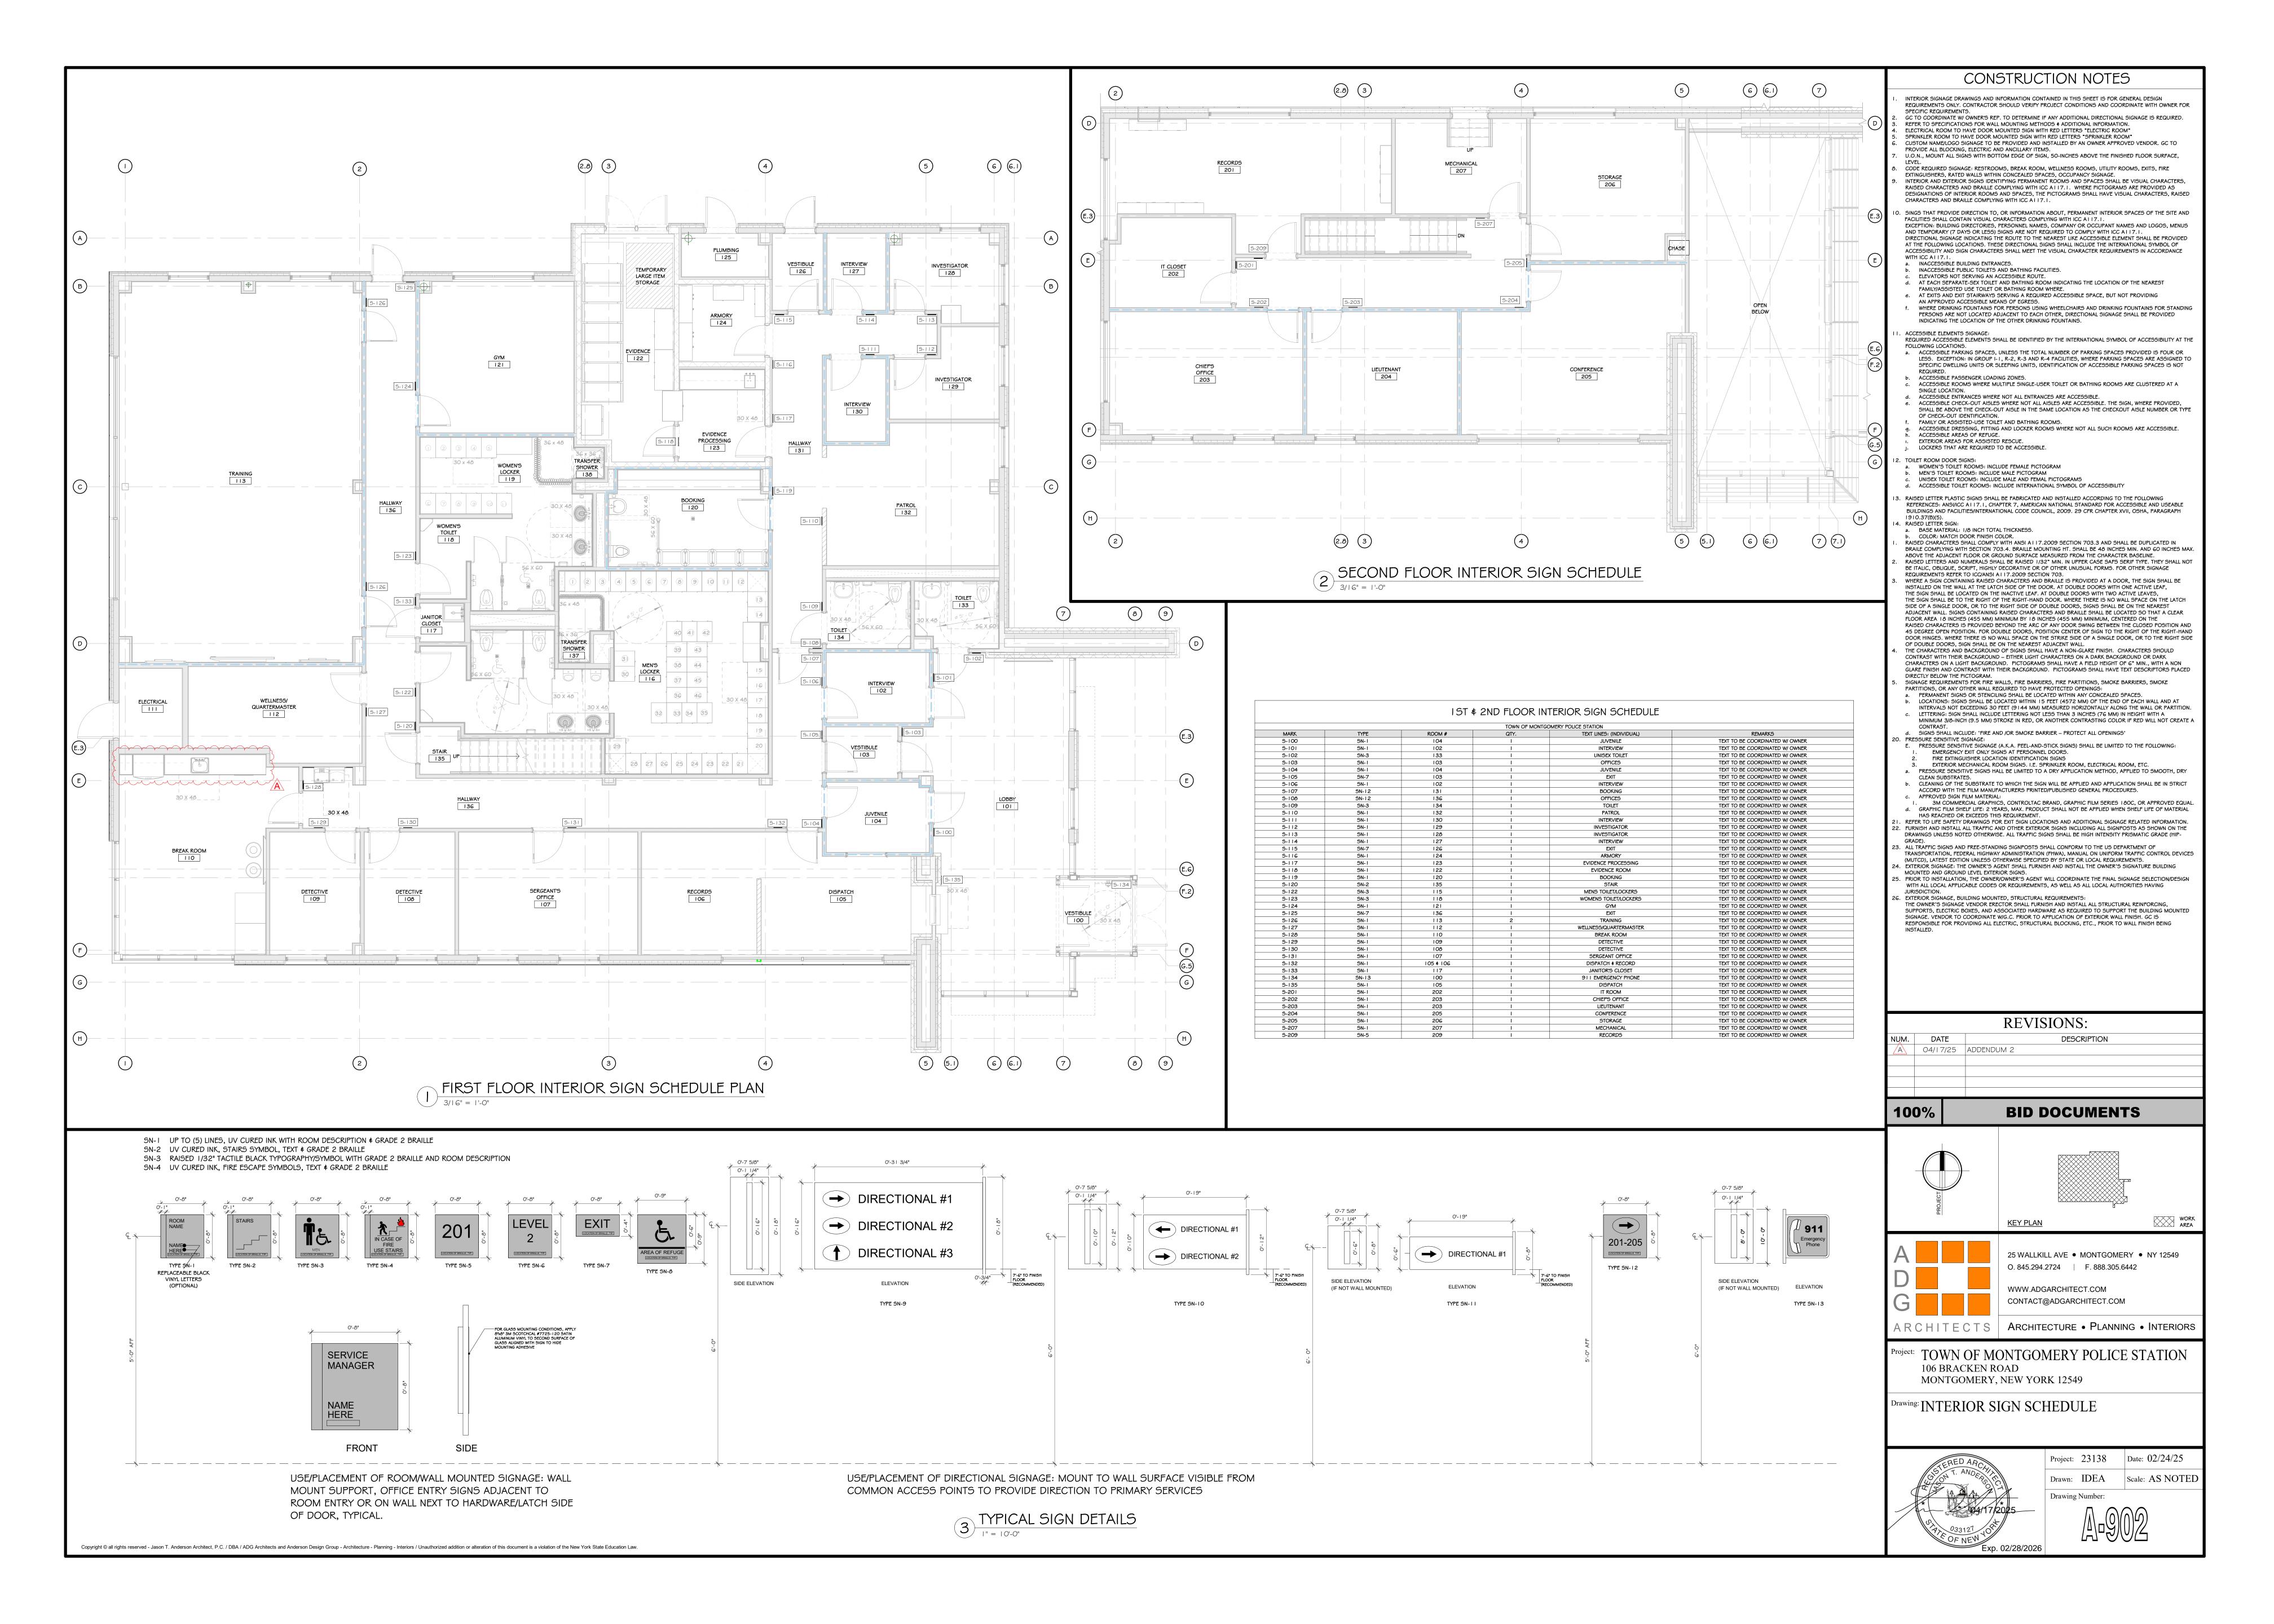

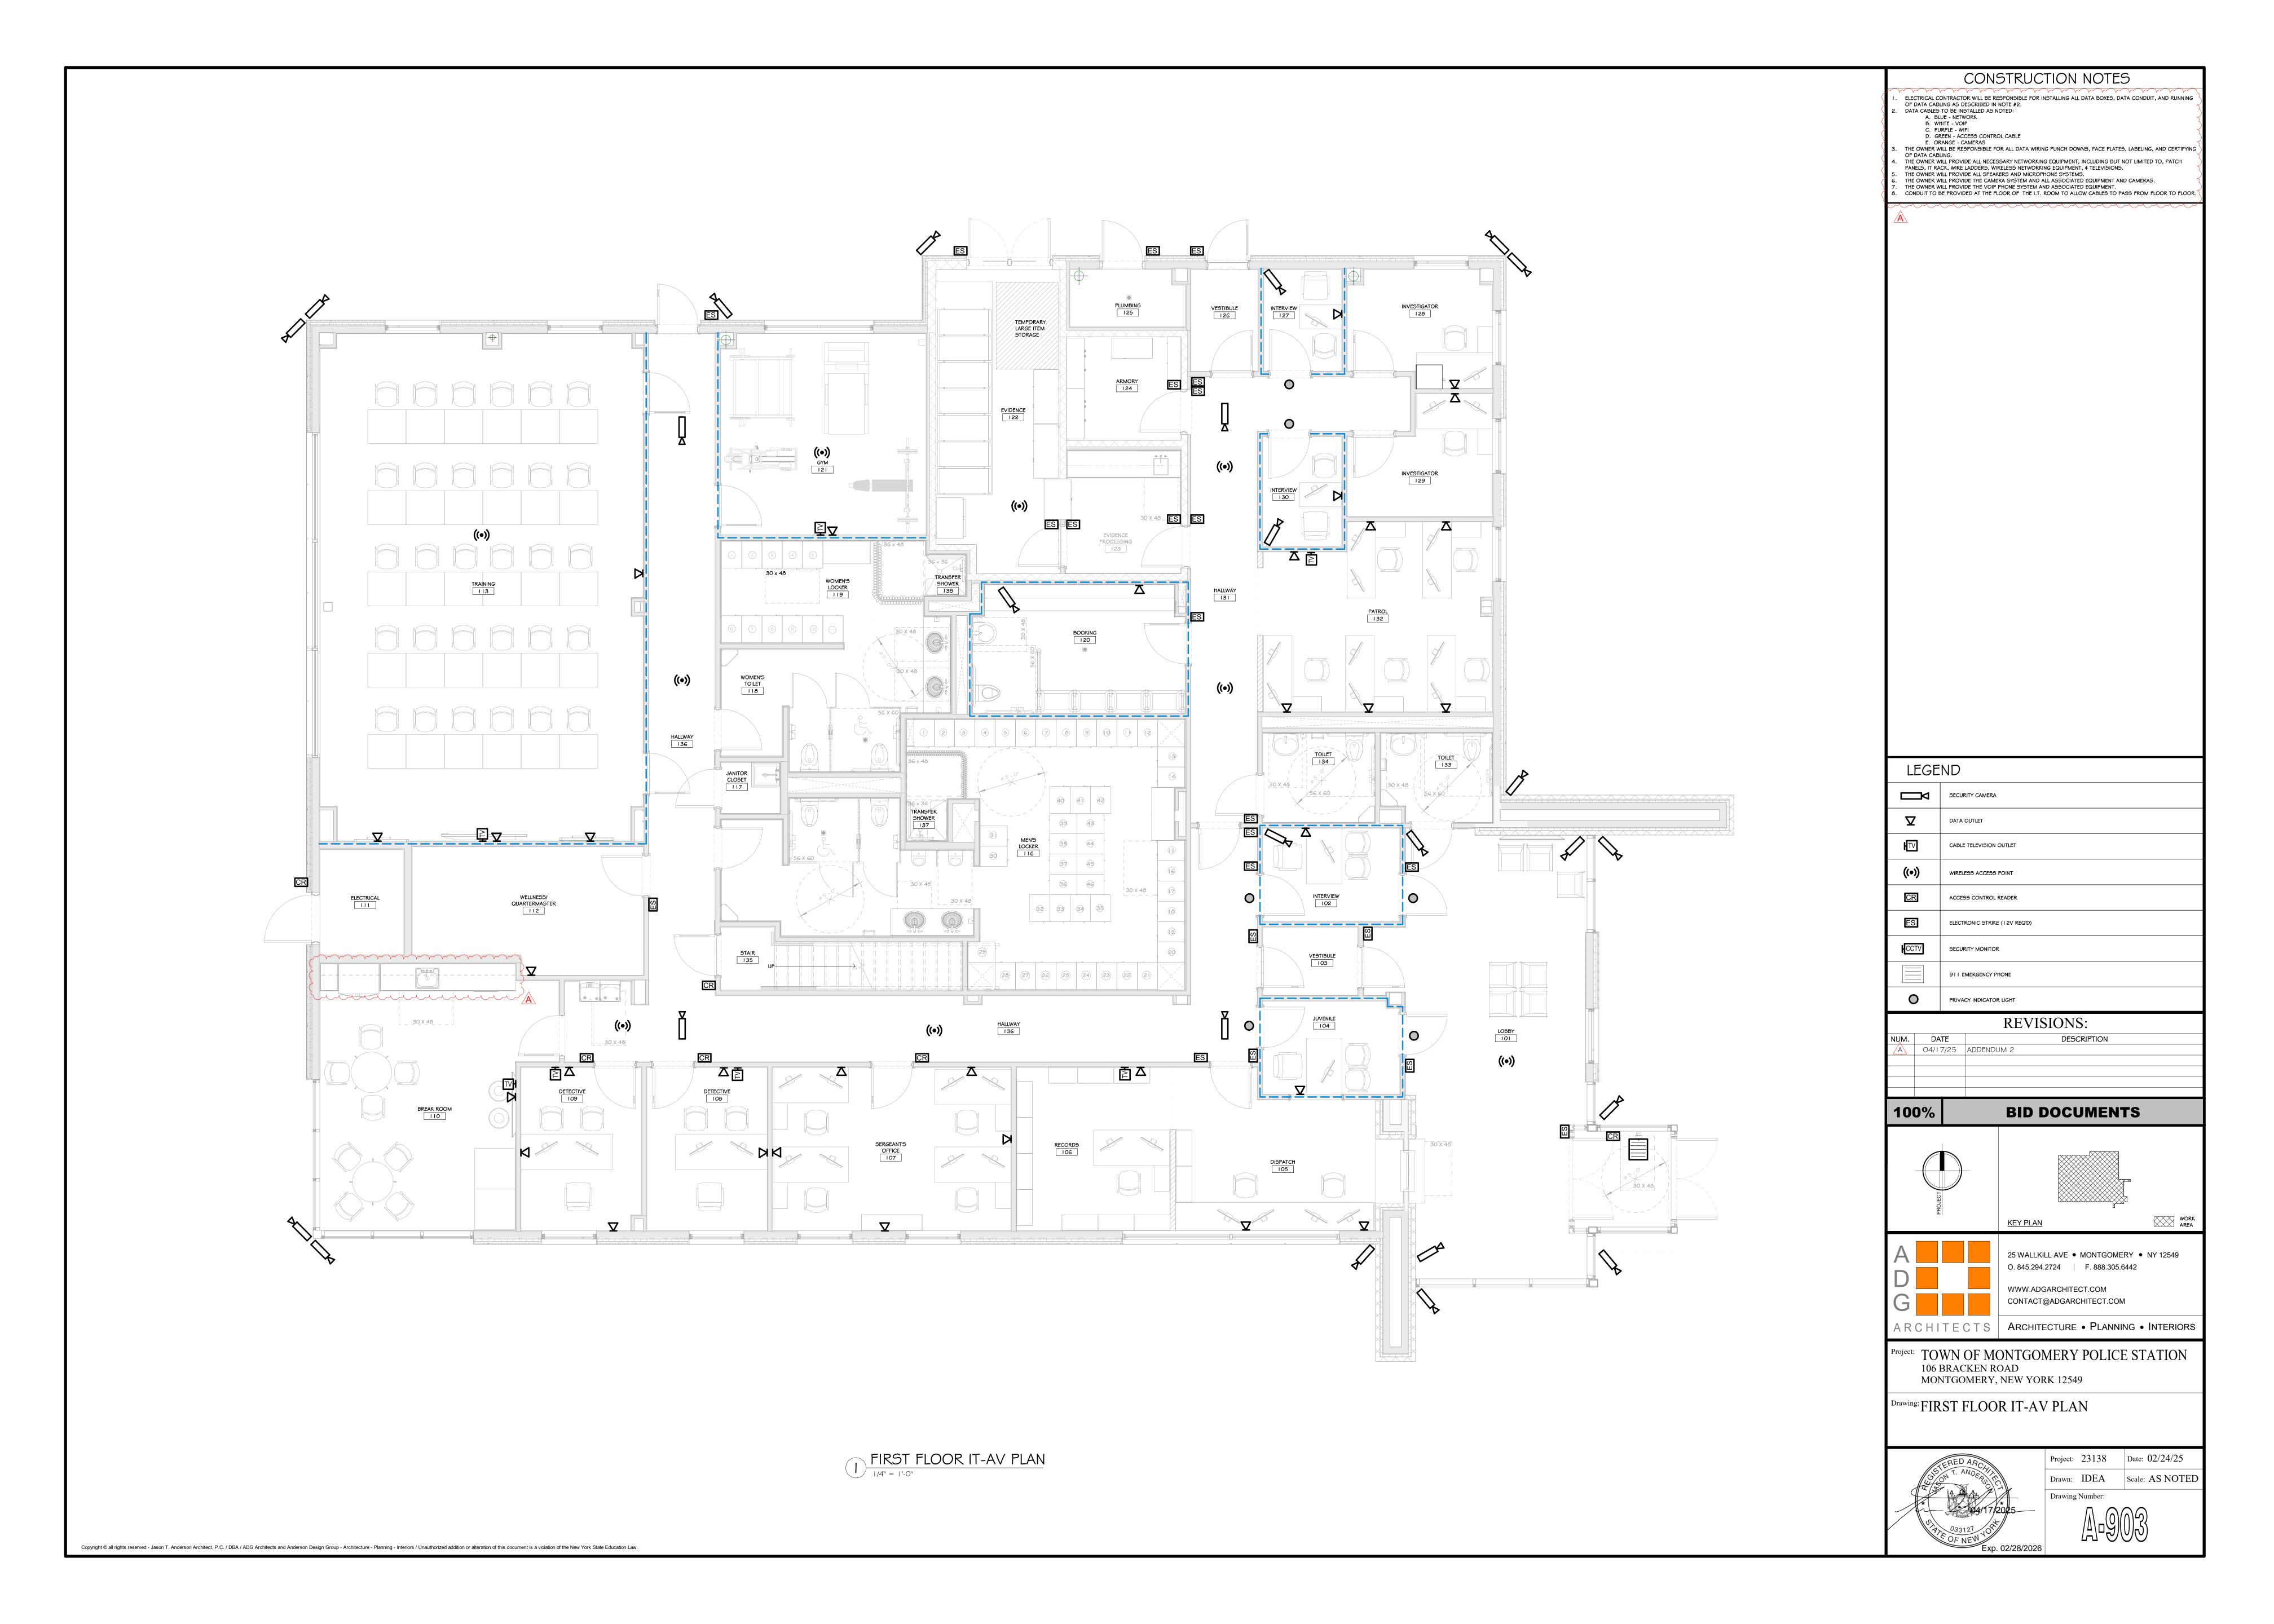SECOND FLOOR IT-AV PLAN

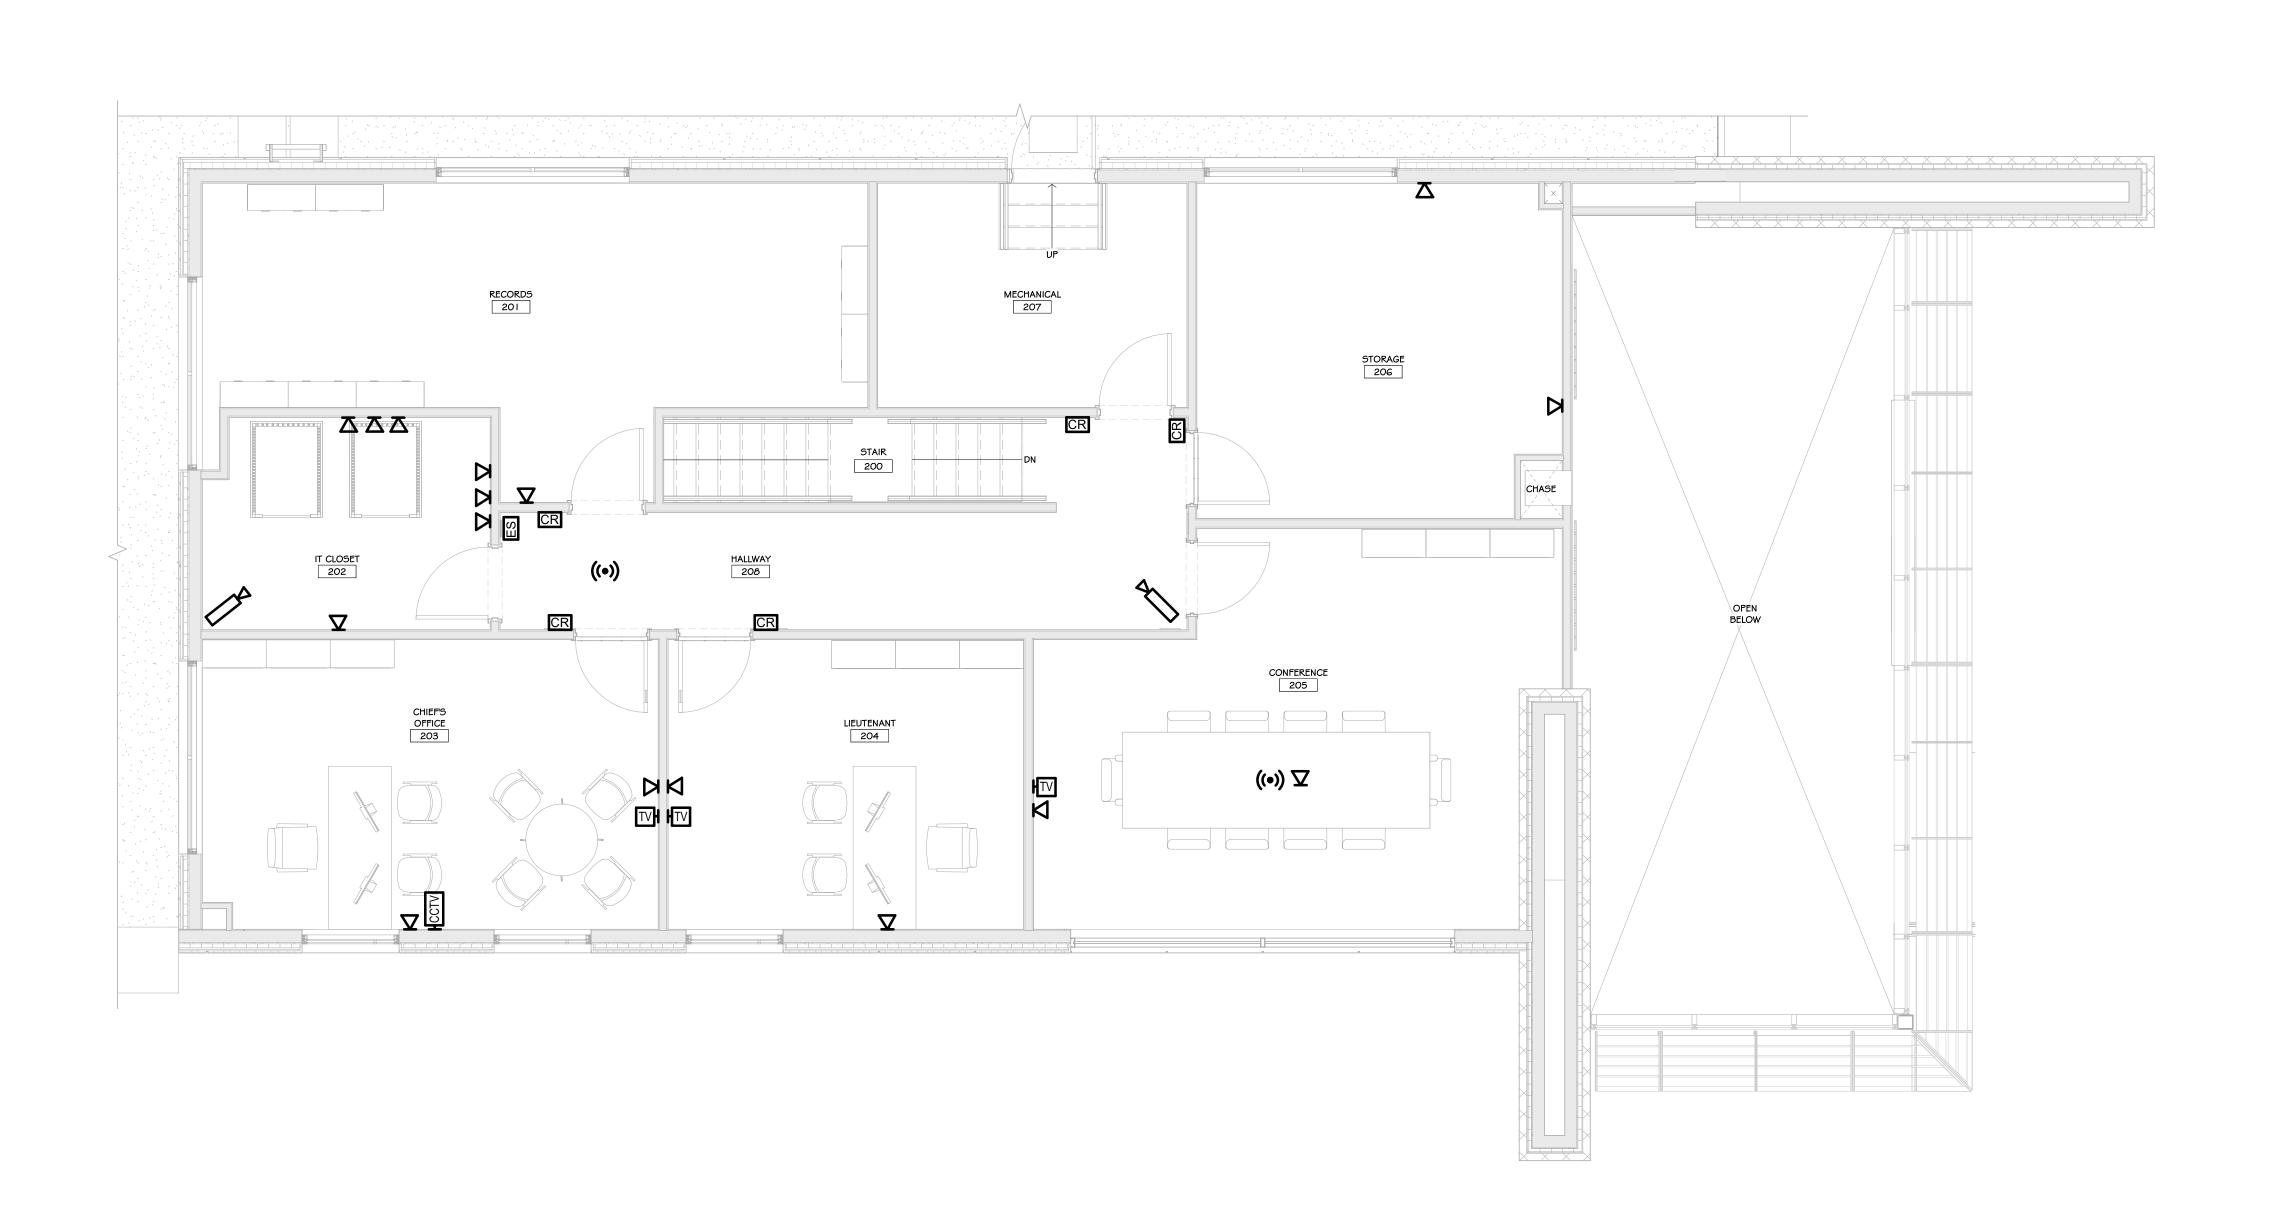

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LOCATION PLAN 1 INCH = 2000 FEET
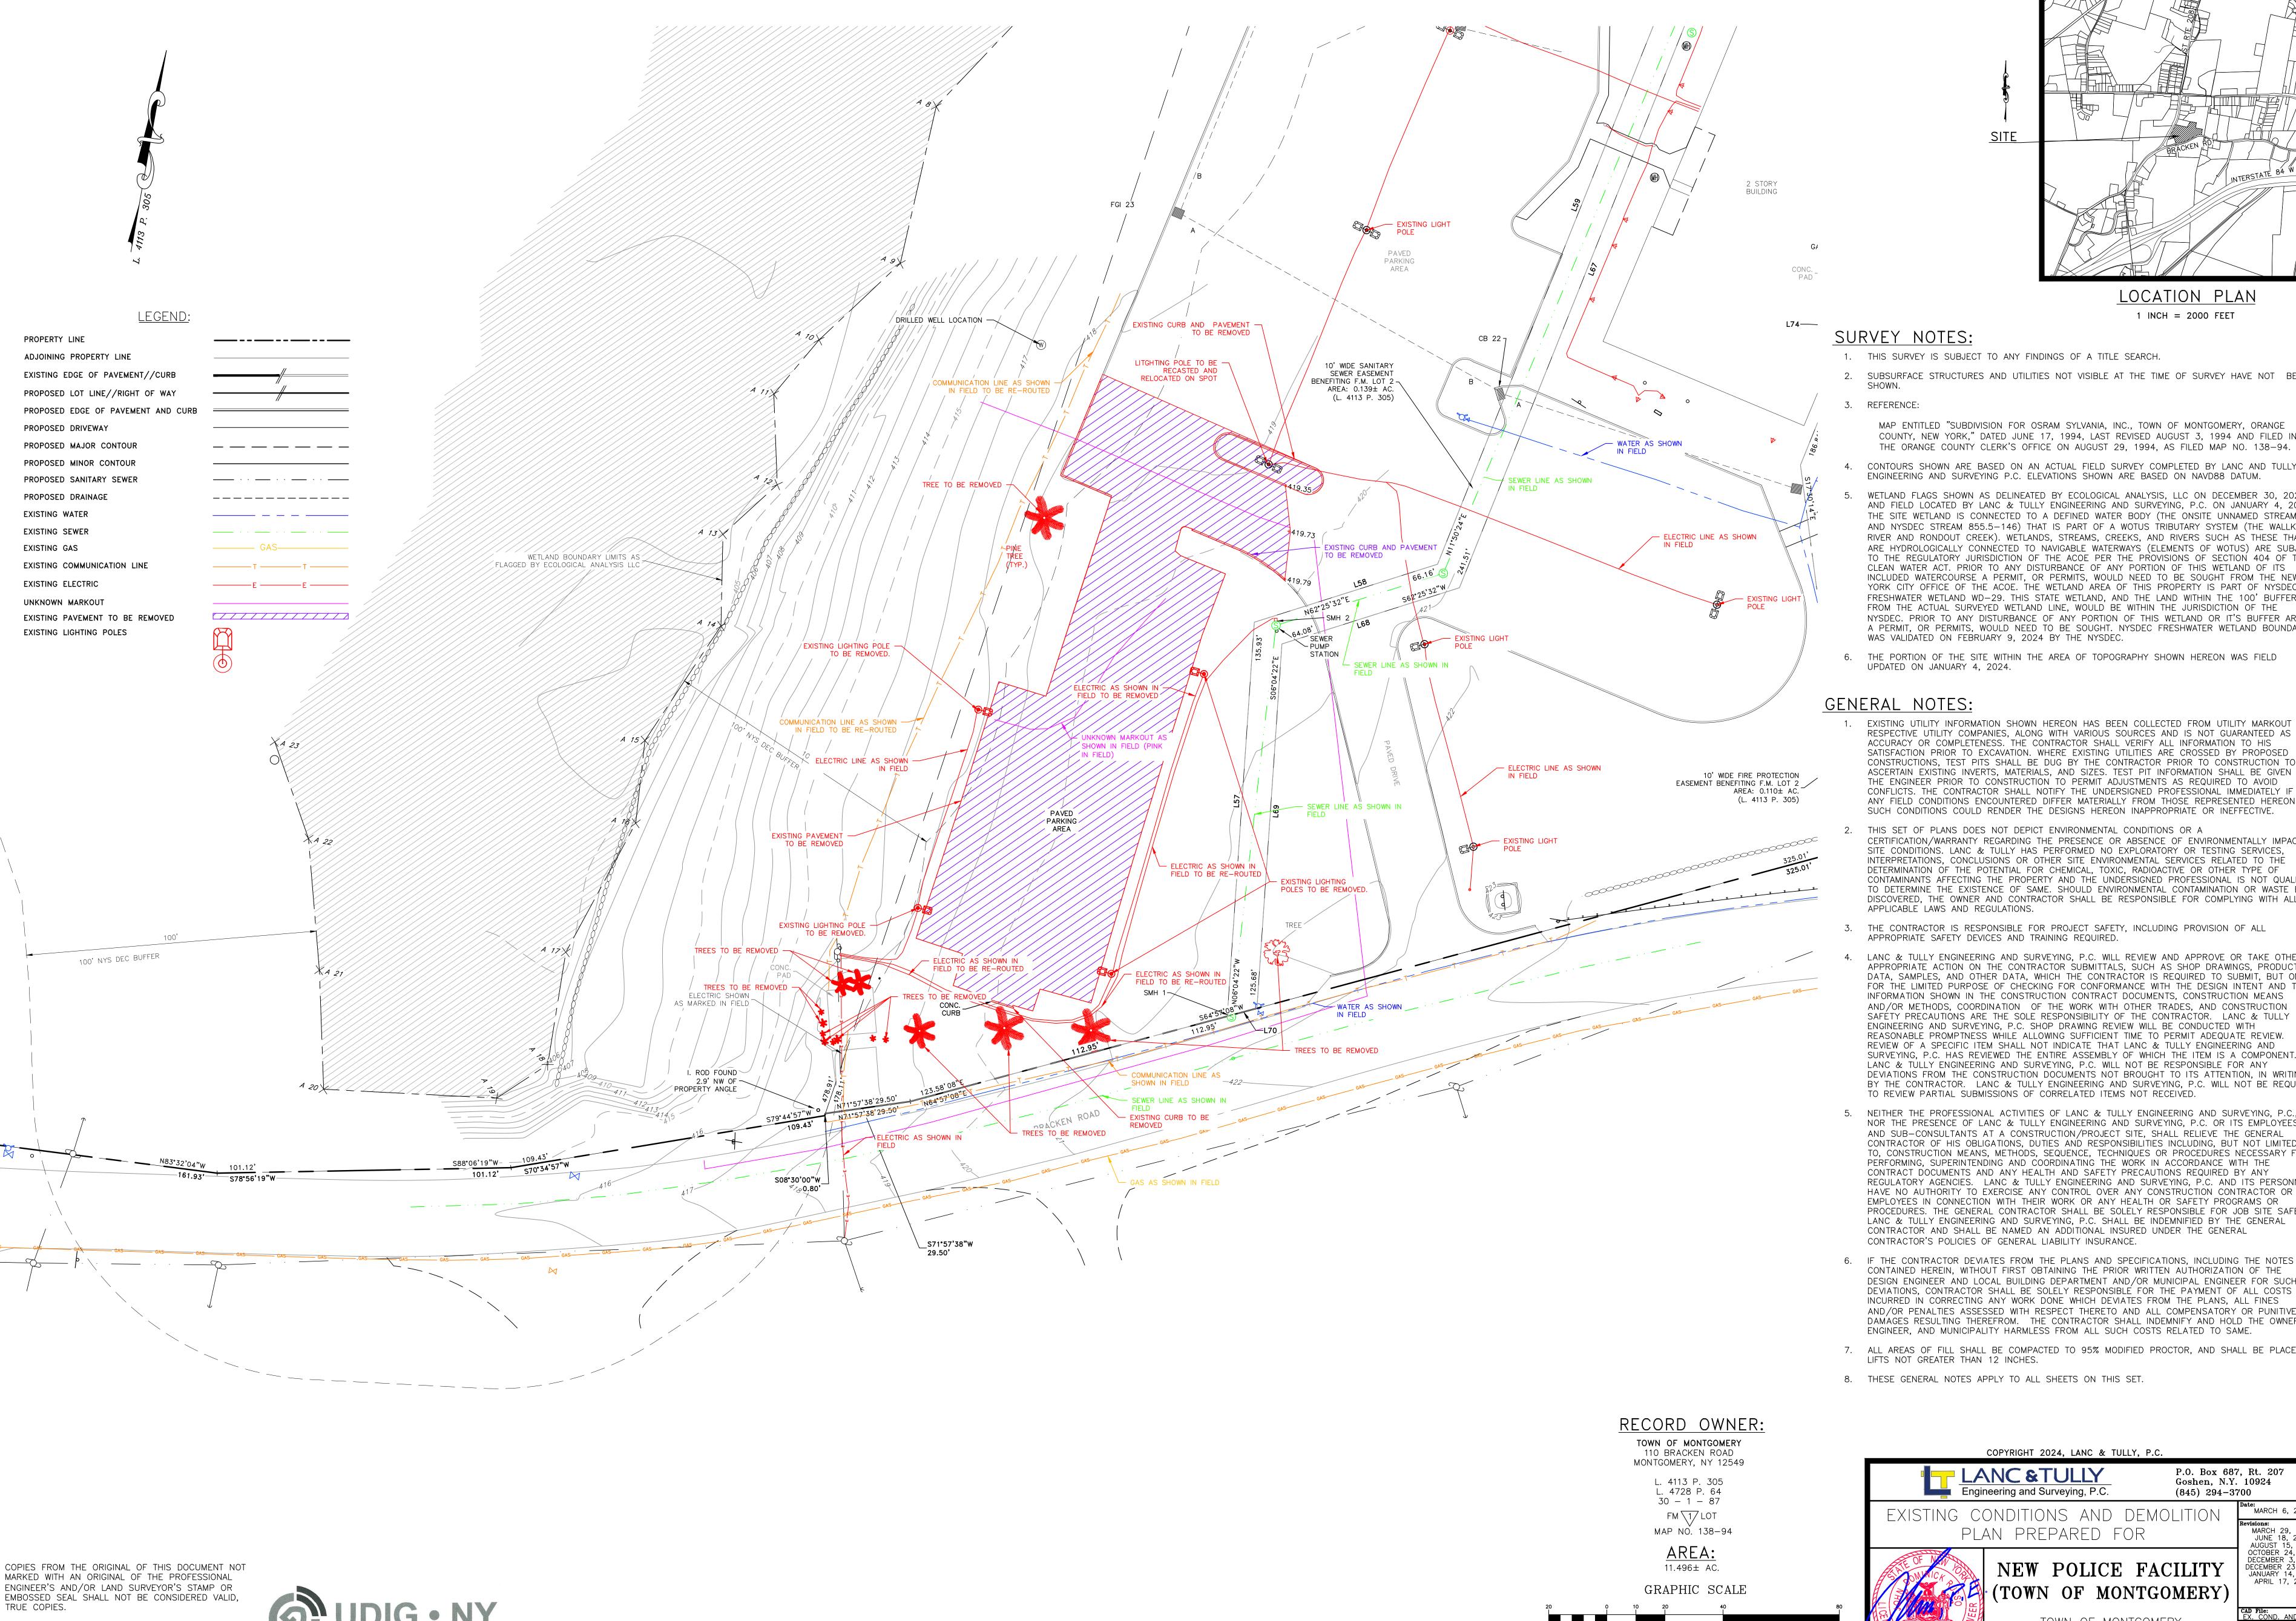
# SURVEY NOTES:


- 1. THIS SURVEY IS SUBJECT TO ANY FINDINGS OF A TITLE SEARCH.
- 2. SUBSURFACE STRUCTURES AND UTILITIES NOT VISIBLE AT THE TIME OF SURVEY HAVE NOT BEEN
- 3. REFERENCE:
  - MAP ENTITLED "SUBDIVISION FOR OSRAM SYLVANIA, INC., TOWN OF MONTGOMERY, ORANGE COUNTY, NEW YORK," DATED JUNE 17, 1994, LAST REVISED AUGUST 3, 1994 AND FILED IN THE ORANGE COUNTY CLERK'S OFFICE ON AUGUST 29, 1994, AS FILED MAP NO. 138-94.
- CONTOURS SHOWN ARE BASED ON AN ACTUAL FIELD SURVEY COMPLETED BY LANC AND TULLY ENGINEERING AND SURVEYING P.C. ELEVATIONS SHOWN ARE BASED ON NAVD88 DATUM.
- WETLAND FLAGS SHOWN AS DELINEATED BY ECOLOGICAL ANALYSIS, LLC ON DECEMBER 30, 2023 AND FIELD LOCATED BY LANC & TULLY ENGINEERING AND SURVEYING, P.C. ON JANUARY 4, 2024. THE SITE WETLAND IS CONNECTED TO A DEFINED WATER BODY (THE ONSITE UNNAMED STREAM AND NYSDEC STREAM 855.5-146) THAT IS PART OF A WOTUS TRIBUTARY SYSTEM (THE WALLKILL RIVER AND RONDOUT CREEK). WETLANDS, STREAMS, CREEKS, AND RIVERS SUCH AS THESE THAT ARE HYDROLOGICALLY CONNECTED TO NAVIGABLE WATERWAYS (ELEMENTS OF WOTUS) ARE SUBJECT TO THE REGULATORY JURISDICTION OF THE ACOE PER THE PROVISIONS OF SECTION 404 OF THE CLEAN WATER ACT. PRIOR TO ANY DISTURBANCE OF ANY PORTION OF THIS WETLAND OF ITS INCLUDED WATERCOURSE A PERMIT, OR PERMITS, WOULD NEED TO BE SOUGHT FROM THE NEW YORK CITY OFFICE OF THE ACOE. THE WETLAND AREA OF THIS PROPERTY IS PART OF NYSDEC FRESHWATER WETLAND WD-29. THIS STATE WETLAND, AND THE LAND WITHIN THE 100' BUFFER FROM THE ACTUAL SURVEYED WETLAND LINE, WOULD BE WITHIN THE JURISDICTION OF THE NYSDEC. PRIOR TO ANY DISTURBANCE OF ANY PORTION OF THIS WETLAND OR IT'S BUFFER AREAS, A PERMIT, OR PERMITS, WOULD NEED TO BE SOUGHT. NYSDEC FRESHWATER WETLAND BOUNDARY WAS VALIDATED ON FEBRUARY 9, 2024 BY THE NYSDEC.
- 6. THE PORTION OF THE SITE WITHIN THE AREA OF TOPOGRAPHY SHOWN HEREON WAS FIELD UPDATED ON JANUARY 4, 2024.

# **GENERAL NOTES:**


- 1. EXISTING UTILITY INFORMATION SHOWN HEREON HAS BEEN COLLECTED FROM UTILITY MARKOUT BY RESPECTIVE UTILITY COMPANIES, ALONG WITH VARIOUS SOURCES AND IS NOT GUARANTEED AS TO ACCURACY OR COMPLETENESS. THE CONTRACTOR SHALL VERIFY ALL INFORMATION TO HIS SATISFACTION PRIOR TO EXCAVATION. WHERE EXISTING UTILITIES ARE CROSSED BY PROPOSED CONSTRUCTIONS, TEST PITS SHALL BE DUG BY THE CONTRACTOR PRIOR TO CONSTRUCTION TO ASCERTAIN EXISTING INVERTS, MATERIALS, AND SIZES. TEST PIT INFORMATION SHALL BE GIVEN TO THE ENGINEER PRIOR TO CONSTRUCTION TO PERMIT ADJUSTMENTS AS REQUIRED TO AVOID CONFLICTS. THE CONTRACTOR SHALL NOTIFY THE UNDERSIGNED PROFESSIONAL IMMEDIATELY IF ANY FIELD CONDITIONS ENCOUNTERED DIFFER MATERIALLY FROM THOSE REPRESENTED HEREON. SUCH CONDITIONS COULD RENDER THE DESIGNS HEREON INAPPROPRIATE OR INEFFECTIVE.
- THIS SET OF PLANS DOES NOT DEPICT ENVIRONMENTAL CONDITIONS OR A CERTIFICATION/WARRANTY REGARDING THE PRESENCE OR ABSENCE OF ENVIRONMENTALLY IMPACTED SITE CONDITIONS. LANC & TULLY HAS PERFORMED NO EXPLORATORY OR TESTING SERVICES, INTERPRETATIONS, CONCLUSIONS OR OTHER SITE ENVIRONMENTAL SERVICES RELATED TO THE DETERMINATION OF THE POTENTIAL FOR CHEMICAL, TOXIC, RADIOACTIVE OR OTHER TYPE OF CONTAMINANTS AFFECTING THE PROPERTY AND THE UNDERSIGNED PROFESSIONAL IS NOT QUALIFIED TO DETERMINE THE EXISTENCE OF SAME. SHOULD ENVIRONMENTAL CONTAMINATION OR WASTE BE DISCOVERED, THE OWNER AND CONTRACTOR SHALL BE RESPONSIBLE FOR COMPLYING WITH ALL APPLICABLE LAWS AND REGULATIONS.
- 3. THE CONTRACTOR IS RESPONSIBLE FOR PROJECT SAFETY, INCLUDING PROVISION OF ALL APPROPRIATE SAFETY DEVICES AND TRAINING REQUIRED.
- LANC & TULLY ENGINEERING AND SURVEYING, P.C. WILL REVIEW AND APPROVE OR TAKE OTHER APPROPRIATE ACTION ON THE CONTRACTOR SUBMITTALS, SUCH AS SHOP DRAWINGS, PRODUCT DATA, SAMPLES, AND OTHER DATA, WHICH THE CONTRACTOR IS REQUIRED TO SUBMIT, BUT ONLY FOR THE LIMITED PURPOSE OF CHECKING FOR CONFORMANCE WITH THE DESIGN INTENT AND THE INFORMATION SHOWN IN THE CONSTRUCTION CONTRACT DOCUMENTS, CONSTRUCTION MEANS AND/OR METHODS, COORDINATION OF THE WORK WITH OTHER TRADES, AND CONSTRUCTION SAFETY PRECAUTIONS ARE THE SOLE RESPONSIBILITY OF THE CONTRACTOR. LANC & TULLY ENGINEERING AND SURVEYING, P.C. SHOP DRAWING REVIEW WILL BE CONDUCTED WITH REASONABLE PROMPTNESS WHILE ALLOWING SUFFICIENT TIME TO PERMIT ADEQUATE REVIEW. REVIEW OF A SPECIFIC ITEM SHALL NOT INDICATE THAT LANC & TULLY ENGINEERING AND SURVEYING, P.C. HAS REVIEWED THE ENTIRE ASSEMBLY OF WHICH THE ITEM IS A COMPONENT. LANC & TULLY ENGINEERING AND SURVEYING, P.C. WILL NOT BE RESPONSIBLE FOR ANY DEVIATIONS FROM THE CONSTRUCTION DOCUMENTS NOT BROUGHT TO ITS ATTENTION, IN WRITING BY THE CONTRACTOR. LANC & TULLY ENGINEERING AND SURVEYING, P.C. WILL NOT BE REQUIRED TO REVIEW PARTIAL SUBMISSIONS OF CORRELATED ITEMS NOT RECEIVED.
- NEITHER THE PROFESSIONAL ACTIVITIES OF LANC & TULLY ENGINEERING AND SURVEYING, P.C., NOR THE PRESENCE OF LANC & TULLY ENGINEERING AND SURVEYING, P.C. OR ITS EMPLOYEES AND SUB-CONSULTANTS AT A CONSTRUCTION/PROJECT SITE, SHALL RELIEVE THE GENERAL CONTRACTOR OF HIS OBLIGATIONS, DUTIES AND RESPONSIBILITIES INCLUDING, BUT NOT LIMITED TO, CONSTRUCTION MEANS, METHODS, SEQUENCE, TECHNIQUES OR PROCEDURES NECESSARY FOR PERFORMING, SUPERINTENDING AND COORDINATING THE WORK IN ACCORDANCE WITH THE CONTRACT DOCUMENTS AND ANY HEALTH AND SAFETY PRECAUTIONS REQUIRED BY ANY REGULATORY AGENCIES. LANC & TULLY ENGINEERING AND SURVEYING, P.C. AND ITS PERSONNEL HAVE NO AUTHORITY TO EXERCISE ANY CONTROL OVER ANY CONSTRUCTION CONTRACTOR OR ITS EMPLOYEES IN CONNECTION WITH THEIR WORK OR ANY HEALTH OR SAFETY PROGRAMS OR PROCEDURES. THE GENERAL CONTRACTOR SHALL BE SOLELY RESPONSIBLE FOR JOB SITE SAFETY, LANC & TULLY ENGINEERING AND SURVEYING, P.C. SHALL BE INDEMNIFIED BY THE GENERAL CONTRACTOR AND SHALL BE NAMED AN ADDITIONAL INSURED UNDER THE GENERAL CONTRACTOR'S POLICIES OF GENERAL LIABILITY INSURANCE.
- CONTAINED HEREIN, WITHOUT FIRST OBTAINING THE PRIOR WRITTEN AUTHORIZATION OF THE DESIGN ENGINEER AND LOCAL BUILDING DEPARTMENT AND/OR MUNICIPAL ENGINEER FOR SUCH DEVIATIONS, CONTRACTOR SHALL BE SOLELY RESPONSIBLE FOR THE PAYMENT OF ALL COSTS INCURRED IN CORRECTING ANY WORK DONE WHICH DEVIATES FROM THE PLANS, ALL FINES AND/OR PENALTIES ASSESSED WITH RESPECT THERETO AND ALL COMPENSATORY OR PUNITIVE DAMAGES RESULTING THEREFROM. THE CONTRACTOR SHALL INDEMNIFY AND HOLD THE OWNER, ENGINEER, AND MUNICIPALITY HARMLESS FROM ALL SUCH COSTS RELATED TO SAME.
- 7. ALL AREAS OF FILL SHALL BE COMPACTED TO 95% MODIFIED PROCTOR, AND SHALL BE PLACED I LIFTS NOT GREATER THAN 12 INCHES.
- 8. THESE GENERAL NOTES APPLY TO ALL SHEETS ON THIS SET.


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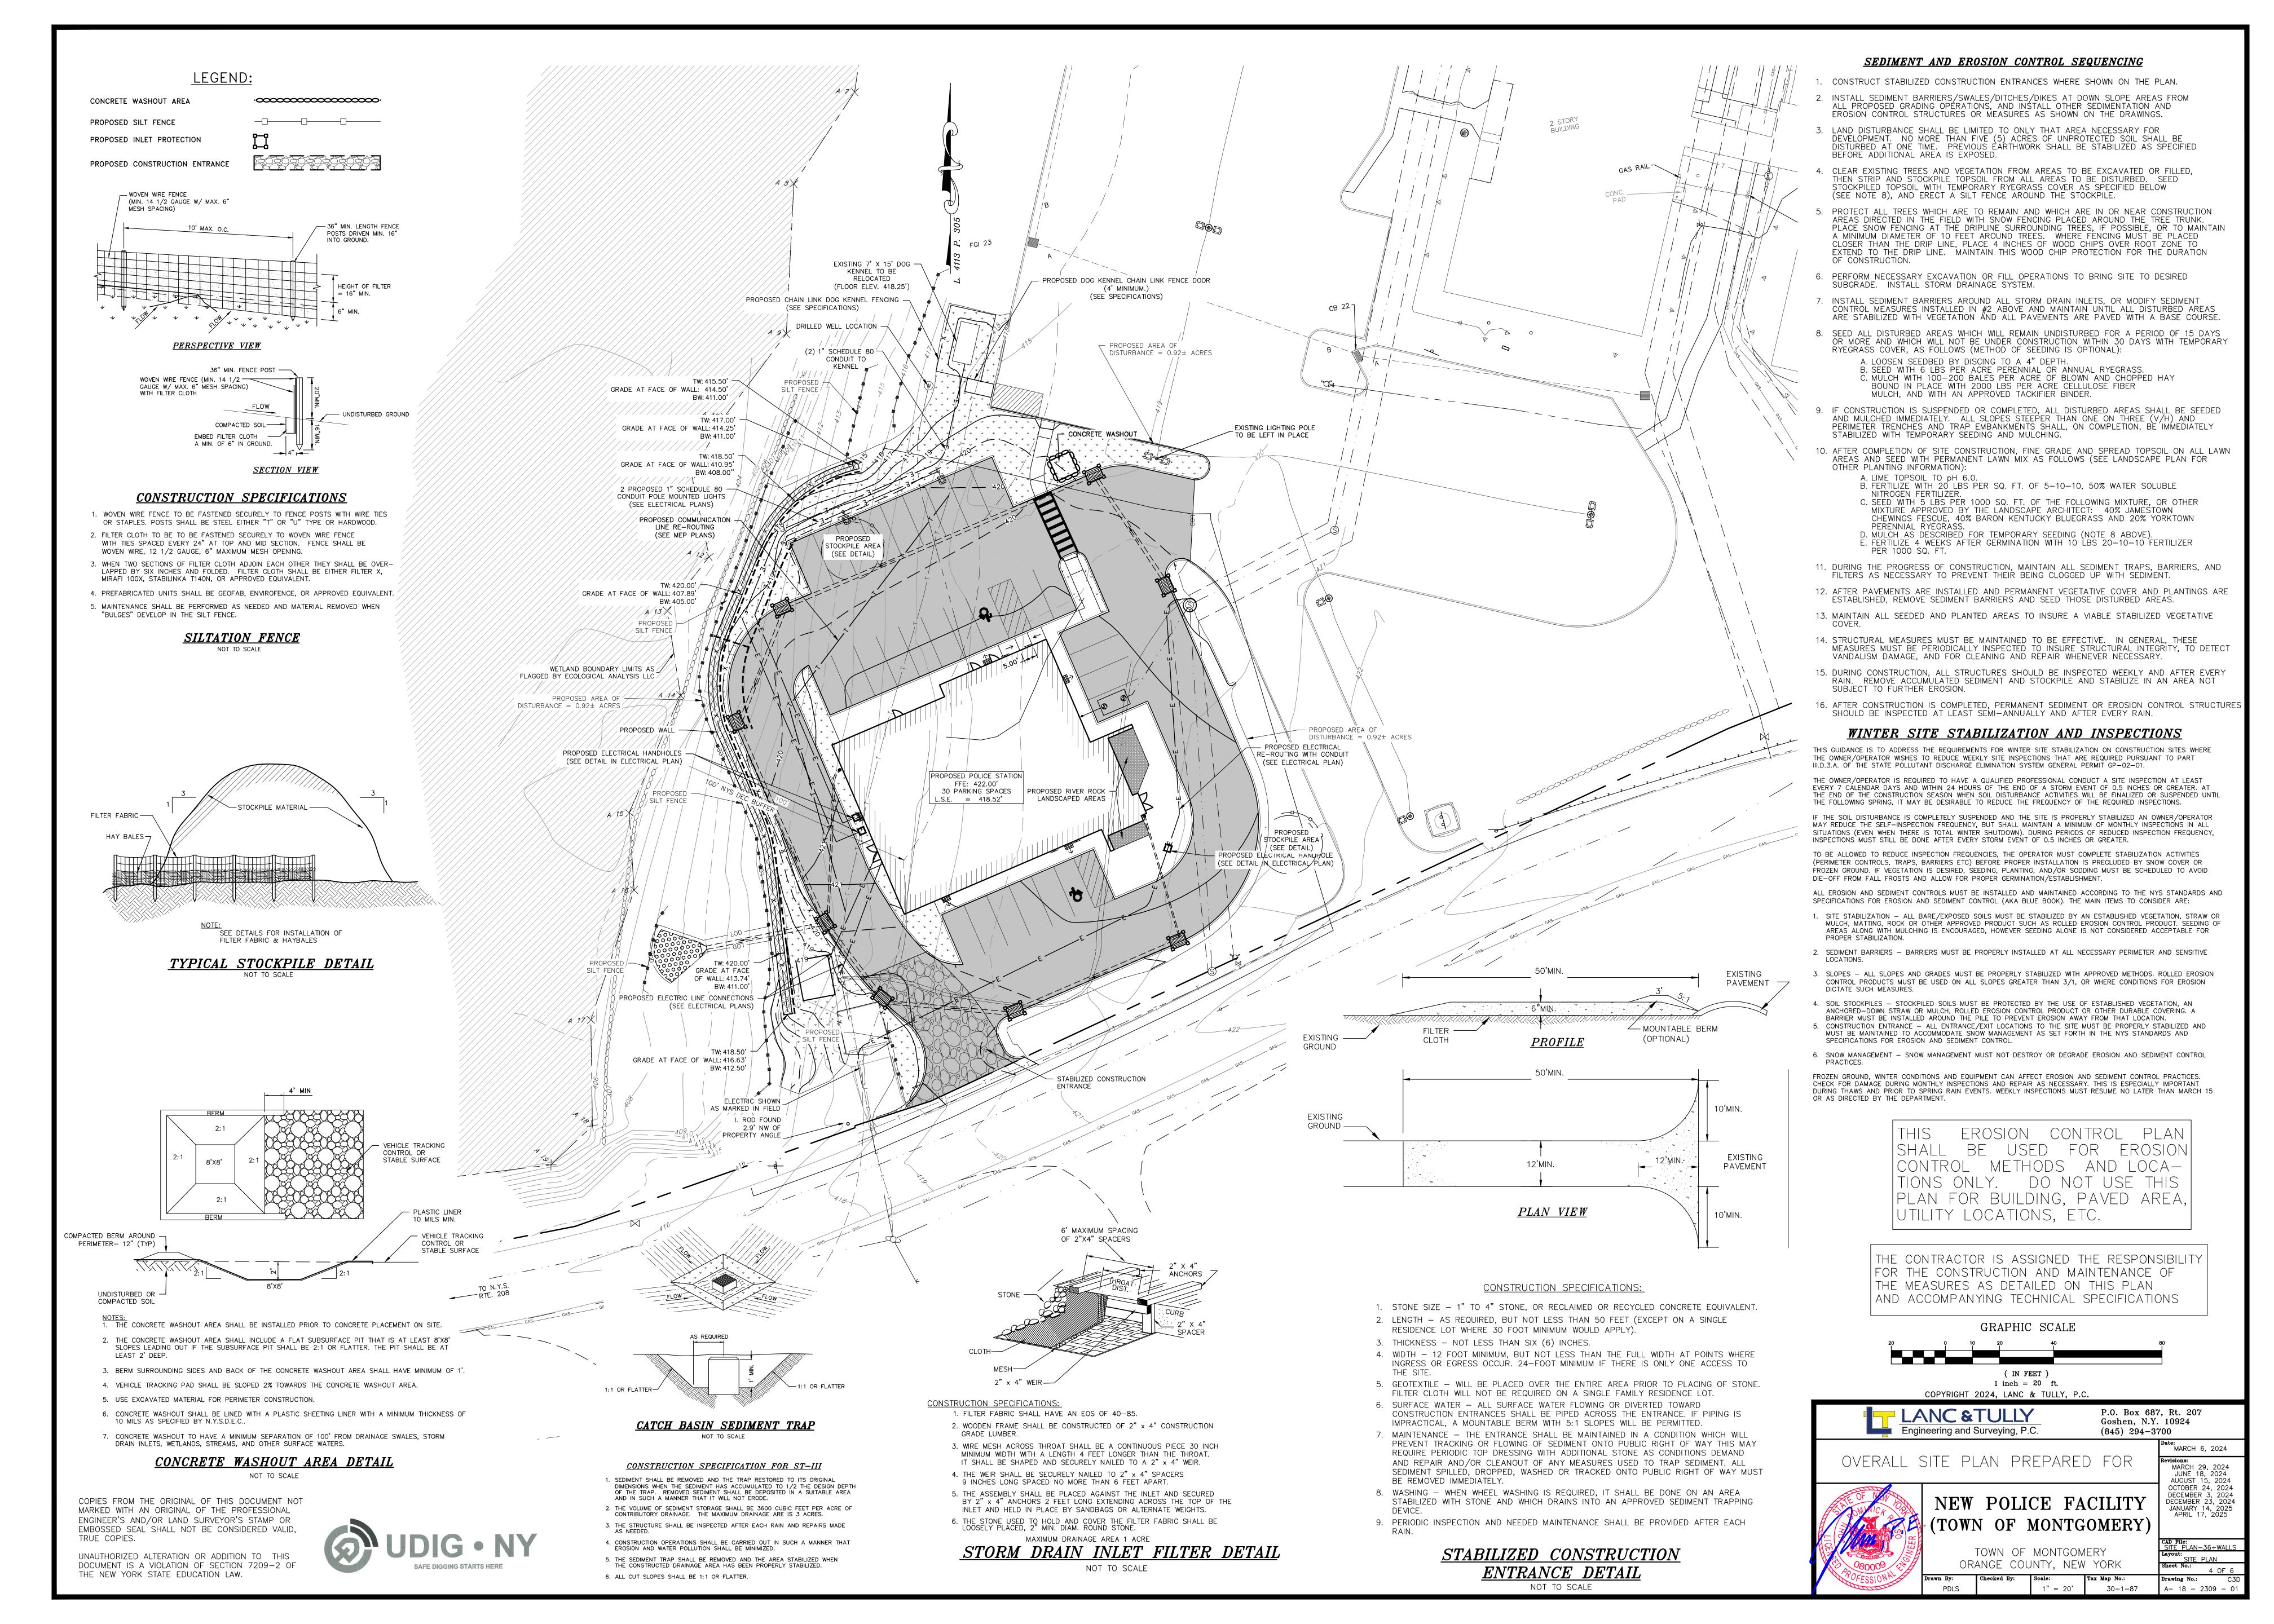
1 inch = 20 ft.

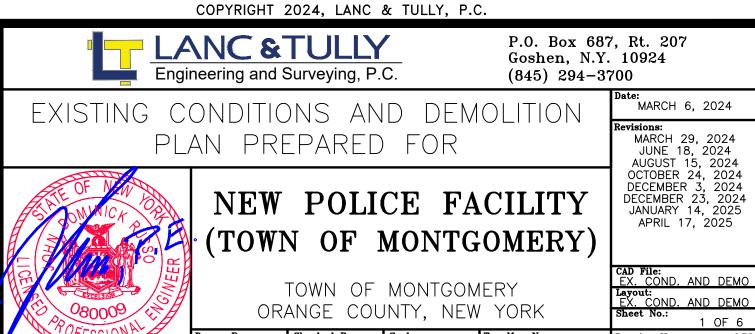

A- 18 - 2309 -



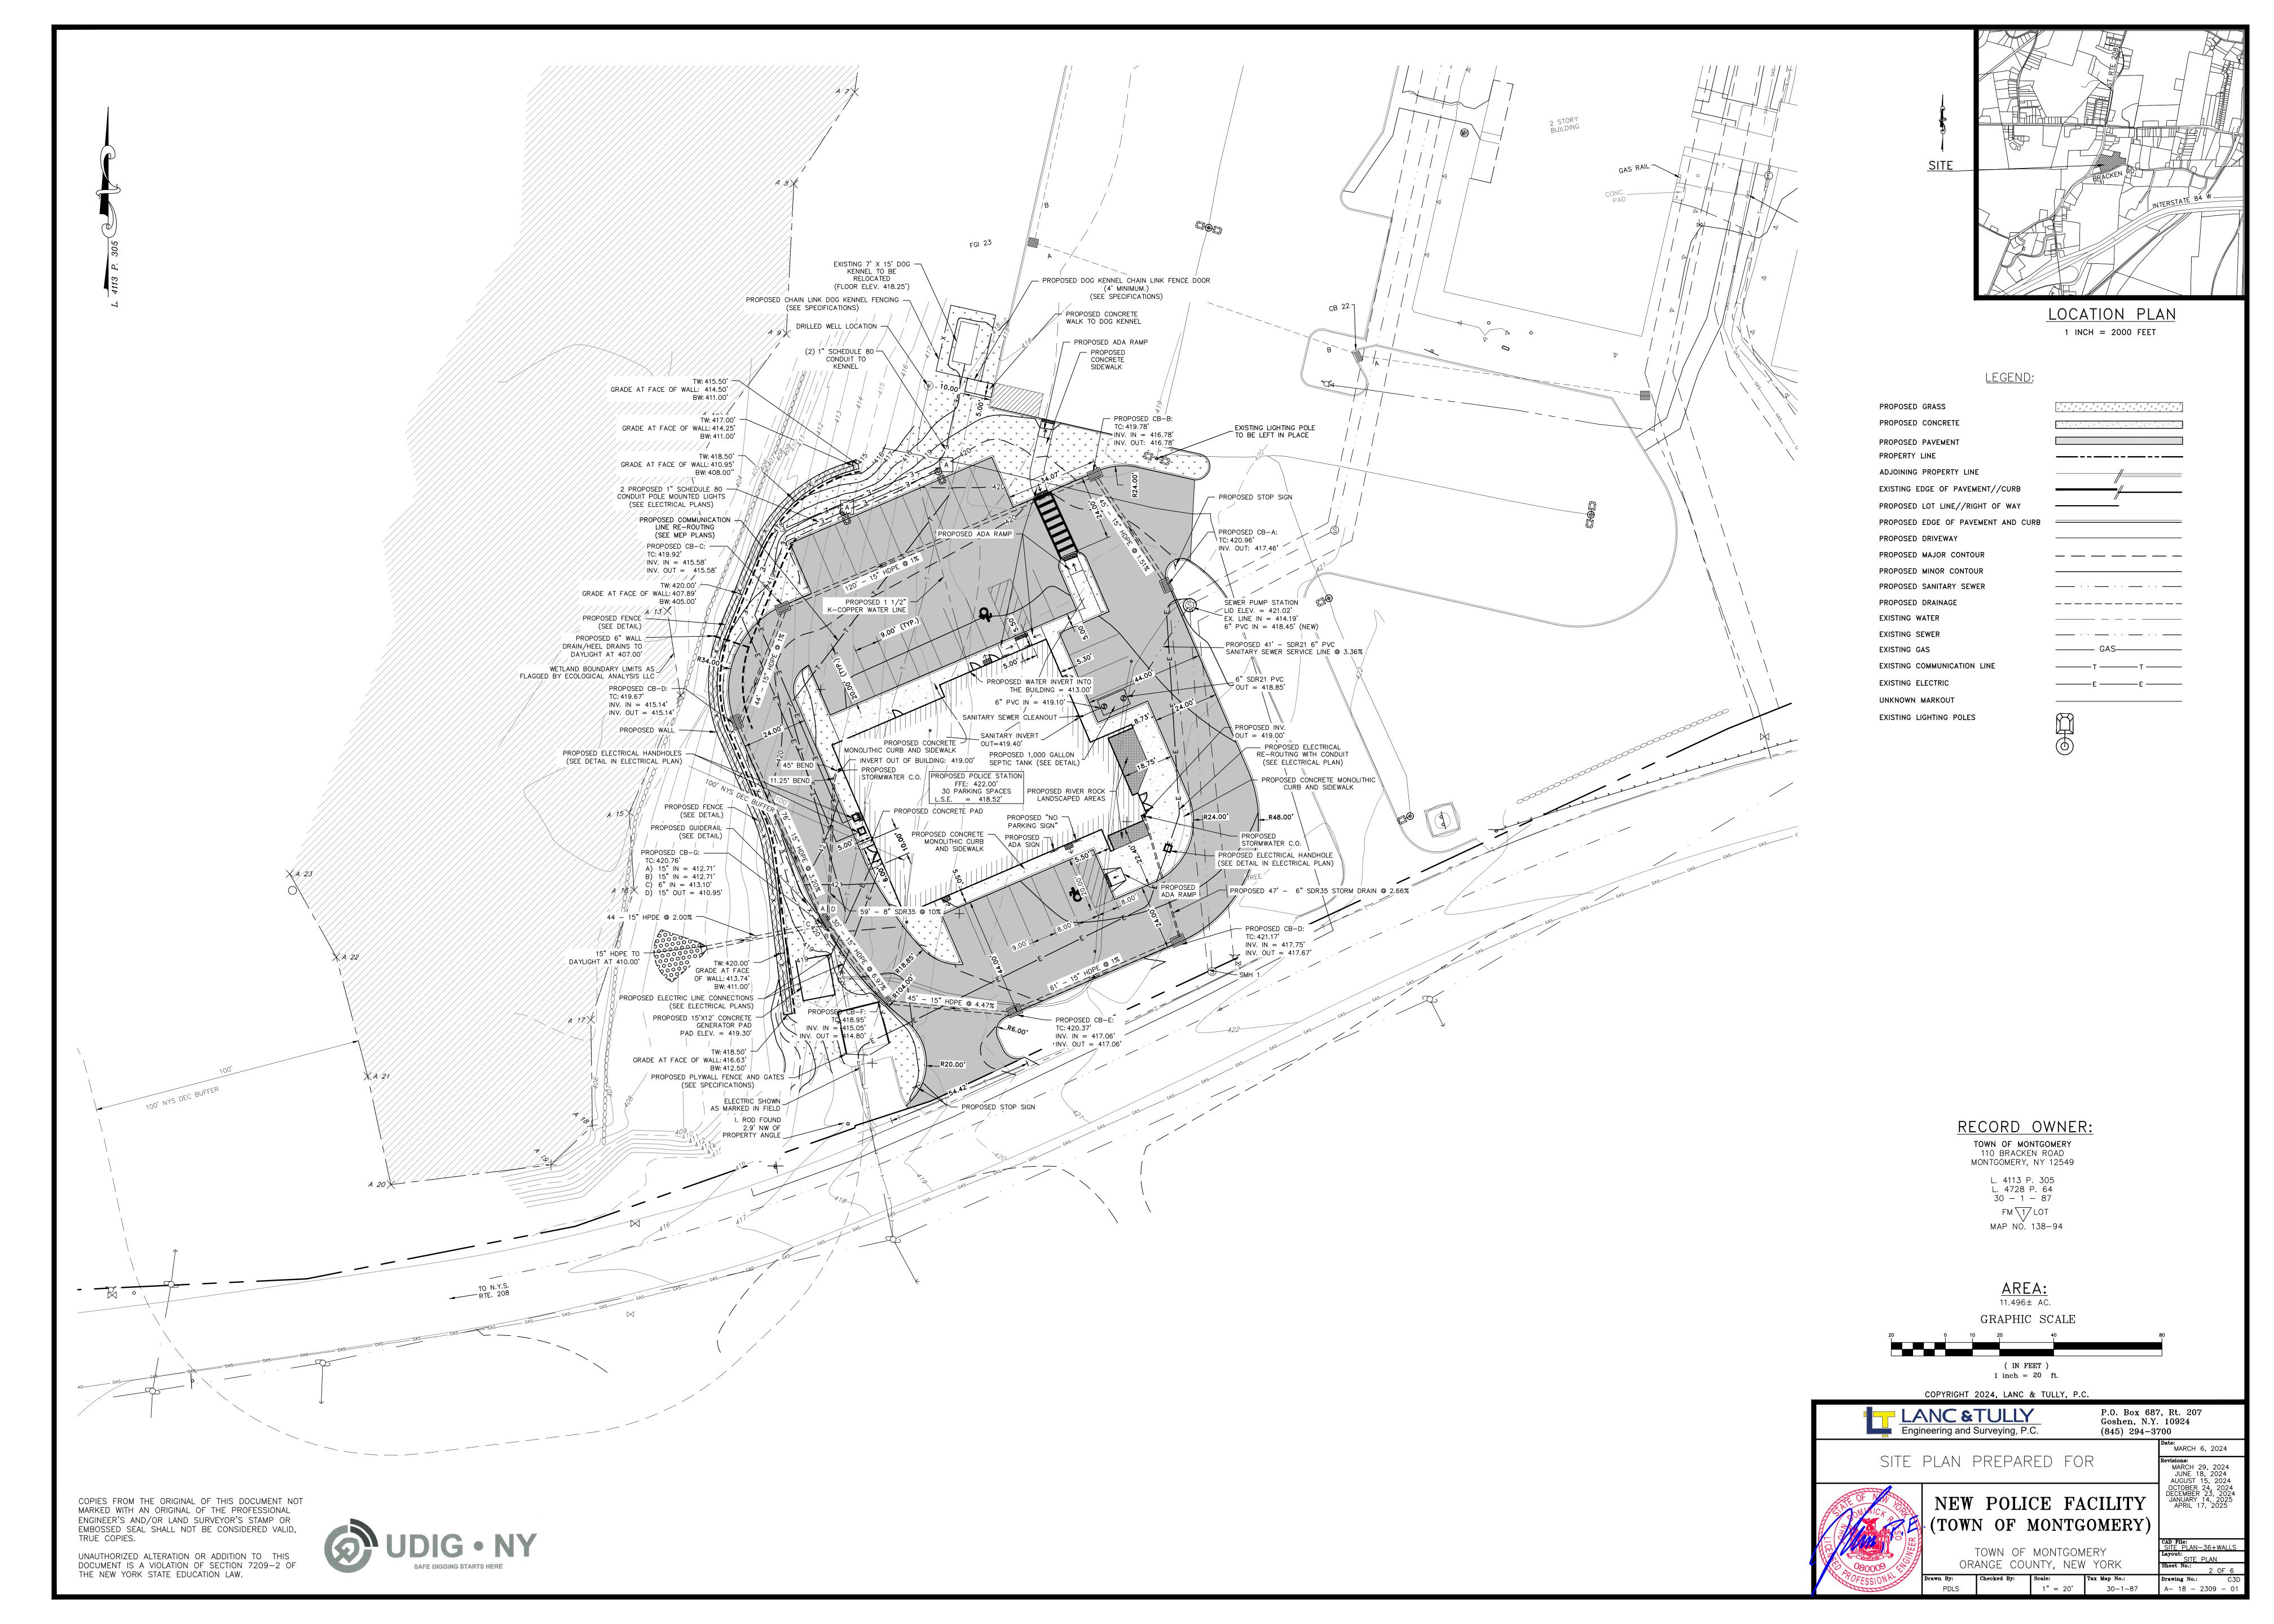

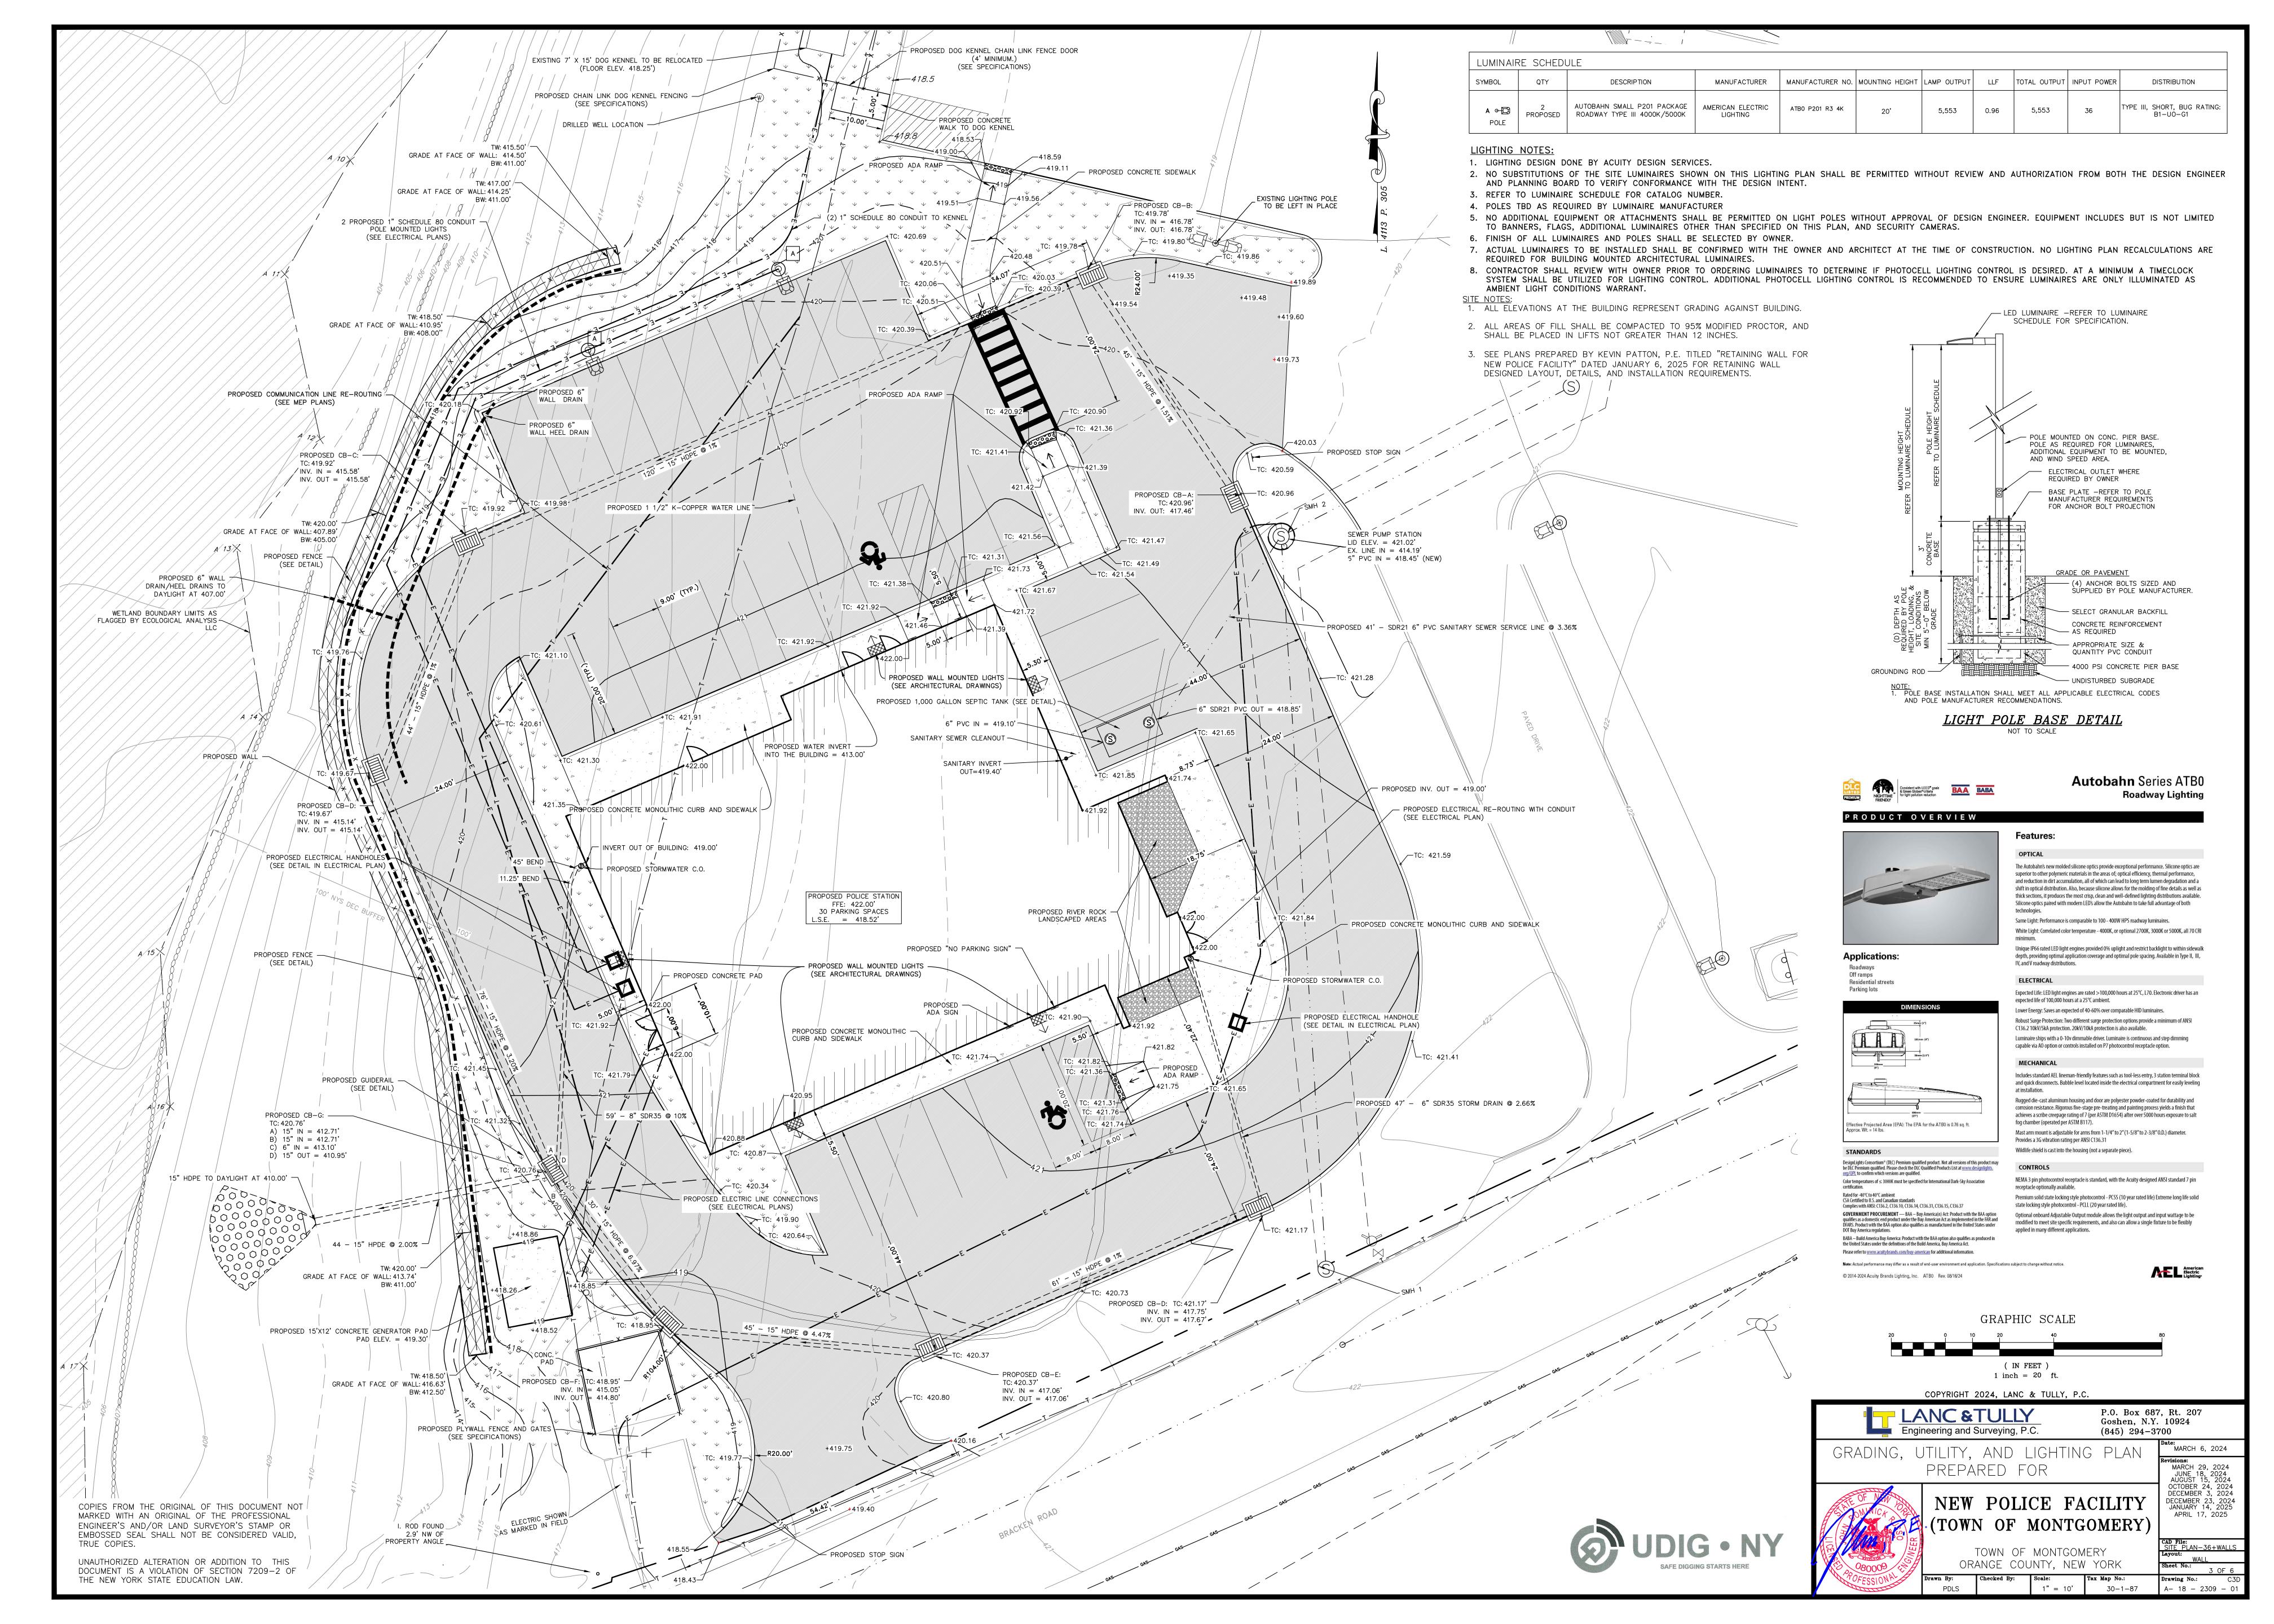

# **GENERAL NOTES**

- (APPLY TO ALL DRAWINGS): PROVIDE ALL LABOR, MATERIALS, EQUIPMENT AND SERVICES TO PERFORM ALL OPERATIONS REQUIRED FOR THE COMPLETE INSTALLATION AND RELATED WORK AS SHOWN ON THE DRAWINGS AND AS SPECIFIED HEREIN. ELECTRIC EQUIPMENT SHALL BE INSTALLED IN A NEAT AND WORKMANLIKE MANNER.
- B. PROVIDE ALL ELECTRICAL EQUIPMENT CONNECTIONS.
- . PROVIDE ALL REQUIRED SUPPORTS AND ACCESSORIES.

5. AUTHORITY HAVING JURISDICTION (AHJ)


6. SERVING UTILITY COMPANIES


- PROVIDE ALL WORK IN COMPLIANCE WITH THE NATIONAL ELECTRICAL CODE (NEC) AND THE LATEST EDITION OF THE: 1. BUILDING CODE OF NEW YORK STATE 2. ENERGY CONSERVATION CONSTRUCTION CODE OF NEW YORK STATE 3. OSHA REQUIREMENTS 4. LOCAL MUNICIPAL ORDINANCES AND CODES
- PROVIDE ELECTRICAL INSPECTION CERTIFICATE FROM INSPECTION AGENCY RECOGNIZED AS ACCEPTABLE FROM THE AHJ.
- . ALL RECEPTACLES INDICATED AS GFI TYPE MUST BE A GFI RECEPTACLE. CONNECTING NORMAL RECEPTACLES DOWNSTREAM OF ONE GFI RECEPTACLE IS NOT ACCEPTABLE PROVIDE TEMPORARY ELECTRICAL SERVICE IN SIZES TO ACCOMMODATE CONSTRUCTION WHERE REQUIRED.
- EREPAIR OR REPLACE ALL DEFECTS IN MATERIAL OR WORKMANSHIP WITHIN ONE YEAR OF CONSTRUCTION CLOSE OUT DATE AT NO ADDITIONAL COST TO
- PERFORM ALL OPERATIONS REQUIRED FOR A COMPLETE SYSTEM TEST. PRIOR TO CLOSE OUT DATE SUBMIT ALL SATISFACTORY SYSTEM TEST RESULTS FOR RECORD.
- 1. ALL ITEMS OF EQUIPMENT AND MATERIALS PROVIDED SHALL BE SUBMITTED FOR ENGINEERING REVIEW. 2. SUBMIT A MINIMUM OF THREE COPIES OF SHOP DRAWINGS/PRODUCT DATA INFORMATION.
- CONTRACTOR IS HERE BY CAUTIONED THAT ELECTRIC POWER CHARACTERISTICS (VOLTAGE, PHASE, HORSEPOWER, AMPERAGE, ETC.) OF EQUIPMENT IS BASED ON AVAILABLE INFORMATION AT THE TIME OF PROJECT DESIGN. CONTRACTOR MUST VERIFY CHARACTERISTICS FOR EACH PIECE OF NEW EQUIPMENT PRIOR TO ORDERING ELECTRICAL EQUIPMENT. INDICATE VERIFICATION ON SUBMITTALS.
- LOCATIONS INDICATED FOR LIGHTING FIXTURES ARE APPROXIMATE. LOCATE FIXTURES AS REQUIRED TO AVOID INTERFERENCE WITH BUILDING STEEL, PIPING, DUCTWORK, CONDUIT, DIFFUSERS, GRILLES, SPEAKERS, SMOKE DETECTORS, ETC. FIELD COORDINATE EXACT LOCATIONS AS NEAR AS POSSIBLE TO THE LOCATION INDICATED. VERIFY COMPLIANCE WITH NEC ARTICLE 410.16 FOR INSTALLATION OF LIGHT FIXTURES IN CLOTHES CLOSETS, PRIOR TO ROUGH-IN. REFER TO ARCHITECTURAL REFLECTED CEILING PLANS.
- . EXACT LOCATIONS OF CEILING MOUNTED SMOKE DETECTORS, EXIT SIGNS, ETC. SHALL BE COORDINATED WITH OTHER CEILING MOUNTED EQUIPMENT TO AVOID CONFLICT. LOCATE DEVICES AS NEAR AS POSSIBLE TO THE LOCATION INDICATED. FIRE ALARM SMOKE AND HEAT DETECTORS SHALL BE LOCATED 3'-0 MINIMUM FROM HVAC DIFFUSERS, REGISTERS, GRILLES, ETC. SMOKE DETECTORS AT SMOKE DOORS MUST BE INSTALLED WITHIN 5'-0 OF THE DOORS (REFER TO NFPA 72).
- N. ALL NEW CIRCUITING SHALL BE CONCEALED (EXCEPT IN UNFINISHED SPACES). PROVIDE ALL CUTTING AND PATCHING AS REQUIRED.
- . CONTRACTOR SHALL REVIEW ALL TRADES' CONTRACT DOCUMENTS TO DETERMINE SPECIFIC MOUNTING LOCATIONS FOR ELECTRICAL EQUIPMENT. COORDINATE EXACT MOUNTING LOCATIONS WITH THE ARCHITECT AND OTHER CONTRACTORS. REFER TO ARCHITECTURAL PLANS FOR CASEWORK LAYOUT, ELEVATIONS, ETC. COORDINATE WITH LOCATIONS OF ELECTRICAL DEVICES AND OUTLETS
- EXACT LOCATION OF MECHANICAL AND PLUMBING EQUIPMENT THAT REQUIRE ELECTRICAL CONNECTIONS ARE SHOWN ON THE MECHANICAL AND PLUMBING
- . PROVIDE CONDUIT/WIRING (CIRCUITING) AND REQUIRED CONNECTIONS TO ALL DEVICES/ EQUIPMENT. CONNECT TO CIRCUIT(S) AS INDICATED.
- COORDINATE ALL WORK WITH OTHER TRADES; REFER TO ARCHITECTURAL DRAWINGS FOR COORDINATING LOCATIONS.
- RE-INSTALL REMOVED SYSTEM DEVICES REMOVED AS A RESULT IN WALL. PARTITION OR CEILING REPLACEMENT WORK. PROVIDE POWER AND COMMUNICATION WALL AND PARTITION MOUNTED DEVICES AND RECONNECT TO EXISTING SYSTEMS. CLEAN EXISTING CEILING MOUNTED DEVICES. EXTEND EXISTING SYSTEM CIRCUITS AS REQUIRED FOR REINSTALLATION. COORDINATE WITH EXISTING SYSTEM MANUFACTURER.
- SLEEVE AND SEAL ALL WALL AND FLOOR PENETRATIONS. PROVIDE APPROPRIATE FIRE STOPPING FOR ALL PENETRATIONS.
- SHARED NEUTRAL SHALL NOT BE ALLOWED ON ANY BRANCH CIRCUITS. MAINTAIN SERVICE CLEARANCES OF ALL EQUIPMENT. ADVISE OTHER TRADES OF SERVICE CLEARANCES AND ENSURE NO SERVICES OR TRADES RUN THROUGH SERVICE AREA.
- . ALL WIRING INDICATED ON PLANS IS TO BE COPPER WIRING UNLESS OTHERWISE NOTED.
- /. REFER TO ONE-LINE DIAGRAM. RATINGS TO MATCH THE RATING OF THE WALL/CEILING. UTILIZE FIRE RATED PUDDY PADS IN THESE LOCATIONS.
- REFER TO ARCHITECTURAL DRAWINGS FOR MOUNTING OF RECEPTACLES IN AND NEAR ALL MILLWORK AND CABINETRY.
- THE CONTRACTOR MUST FOLLOW FEDERAL AND STATE ELECTRICAL SAFETY PRACTICE INCLUDING LOCK OUT TAG OUT (LOTO). THE CONTRACTOR MUST AFFIX THEIR COMPANY'S INDIVIDUAL LOTO LOCKS AND TAGS TO CONTROL HAZARDOUS ENERGIES AND TO PREVENT INJURIES.
- PROVIDE SURFACE MOUNTED BOXES AND SURFACE METAL RACEWAY FOR ALL DEVICES INDICATED TO BE INSTALLED ON EXISTING WALLS, UNLESS OTHERWISE NOTED; COLOR TO MATCH EXISTING WALL.


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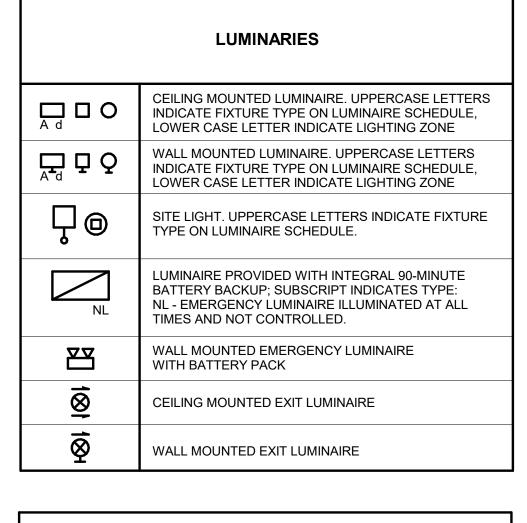
AA. PROVIDE RECESSED BOXES AND RACEWAYS FOR ALL DEVICES INDICATED TO BE INSTALLED ON NEW WALLS, UNLESS OTHERWISE NOTED.

	ABBREVIATIONS
ABBREV.	DESCRIPTION
А	AMPERE
AC	MOUNTED ABOVE COUNTER HEIGHT
AFF	ABOVE FINISHED FLOOR
AFG	ABOVE FINISHED GRADE
AIC	AMPERE INTERRUPTING CURRENT
AL	ALUMINUM
ASD	ADJUSTABLE SPEED DRIVE
ATS	AUTOMATIC TRANSFER SWITCH
AV	AUDIO VISUAL
AWG	AMERICAN WIRE GAUGE
С	CONDUIT
CU	COPPER
EC	ELECTRICAL CONTRACTOR/TRADE
FACP	FIRE ALARM CONTROL PANEL
G	GROUND
GC	GENERAL CONTRACTOR/TRADE
GEN	GENERATOR
GFCI/GFI	GROUND FAULT CIRCUIT INTERRUPTER
НН	HAND HOLE
HP	HORSE POWER
HVAC	HEATING, VENTILATION & AIR CONDITIONING CONTRACTOR/TRADE
JB	JUNCTION BOX
KV	KILOVOLT
KVA	KILOVOLT AMPERES
KW	KILOWATT
LED	LIGHT EMITTING DIODE
MCB	MAIN CIRCUIT BREAKER
MLO	MAIN LUG ONLY
MTS	MANUAL TRANSFER SWITCH
NA	NOT APPLICABLE
NC	NORMALLY CLOSED
NEC	NATIONAL ELECTRIC CODE
NIC	NOT IN CONTRACT
NL	NIGHT LIGHT
NTS	NOT TO SCALE
Р	POLE
SMR	SURFACE METAL RACEWAY
SPEC	SPECIFICATION
TYP	TYPICAL
UC	MOUNTED UNDER COUNTER HEIGHT
UL	UNDERWRITER'S LABORATORY
V	VOLT
W	WIRE/WATT
WP	WEATHERPROOF



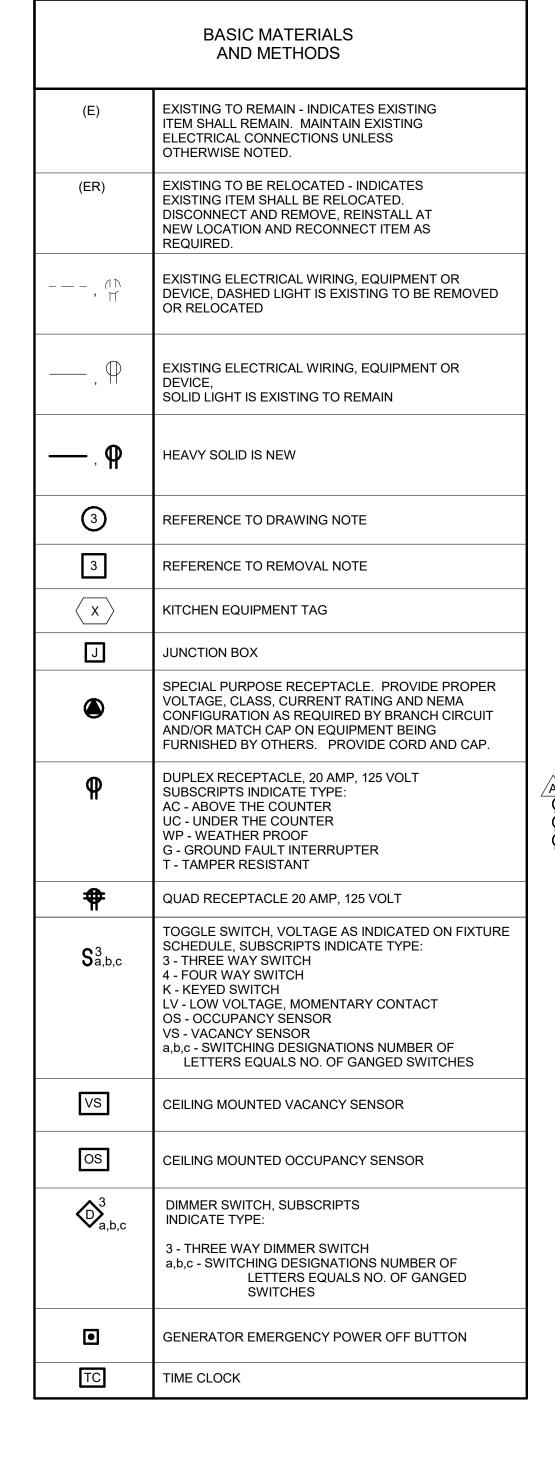

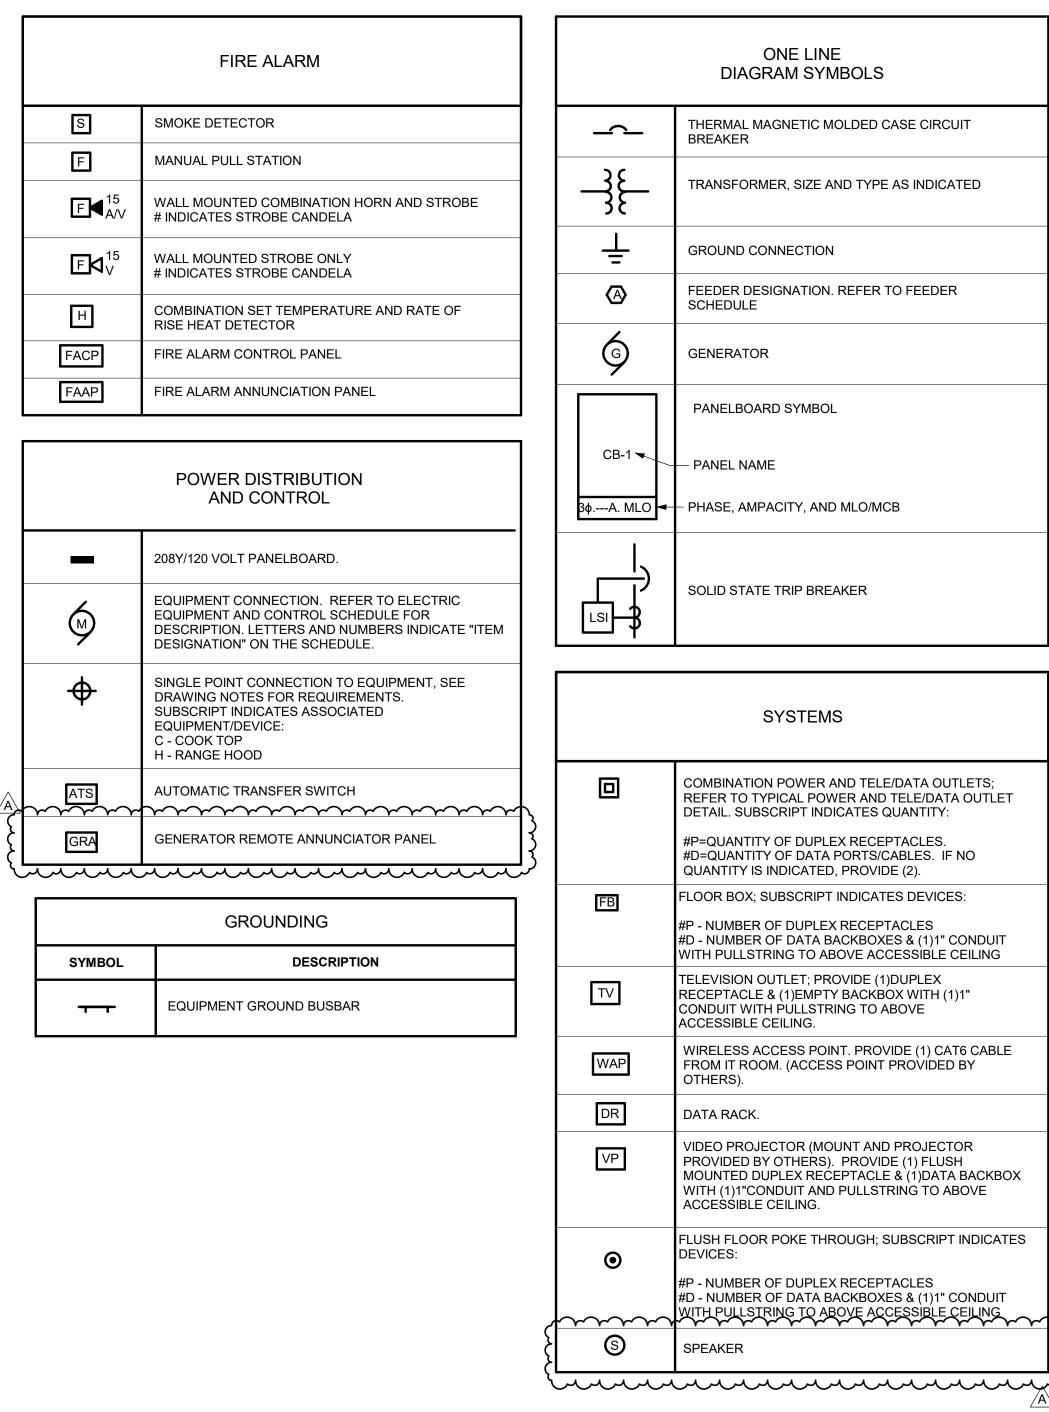

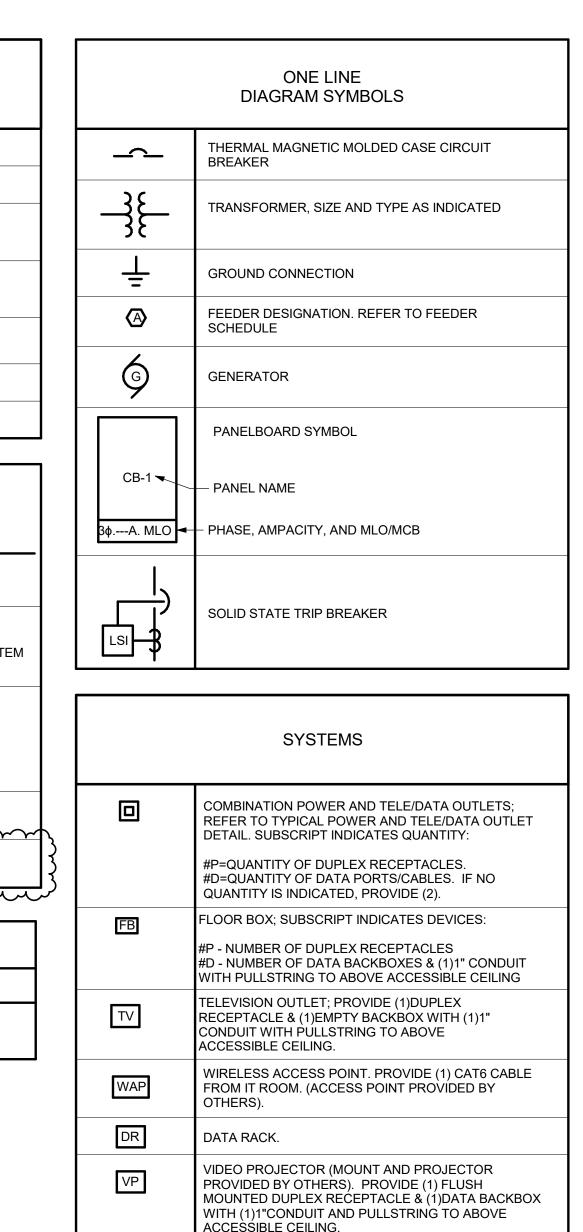

**GENERAL FIRE ALARM NOTES** (APPLY TO ALL DRAWINGS): THE CONTRACTOR SHALL PROVIDE A COMPLETE TEST OF THE EXISTING SYSTEM PRIOR TO MAKING MODIFICATIONS TO ASSESS THE CONDITION AND CAPABILITY OF DEVICES AND CIRCUITS TO BE REUSED. WHERE POSSIBLE, THE CONTRACTOR SHALL HAVE THE OPTION TO REUSE EXISTING DEVICES, BOXES AND WIRING.

IN GENERAL, EXISTING INITIATION AND NOTIFICATION APPLIANCE CIRCUITS SHALL BE RETAINED AND EXTENDED TO THE NEW CONTROL PANEL FOR DEVICES IN AREAS UNAFFECTED BY THE SCOPE OF WORK. NEW DEVICES SHALL BE TIED INTO EXISTING CIRCUITS, OR NEW CIRCUITS SHALL BE PROVIDED AS REQUIRED TO PROVIDE A COMPLETE SYSTEM AS INDICATED.

ALL WIRING SHALL BE COPPER, INSTALLED IN A DEDICATED/SEGREGATED EMT CONDUIT SYSTEM AND SHALL CONFORM TO THE NEC AND TO NFPA-72, NATIONAL FIRE ALARM CODE. INSTALL IN ACCORDANCE WITH THE MANUFACTURER'S RECOMMENDATIONS.

THE COMPLETE FIRE ALARM SYSTEM SHALL BE FULLY TESTED AFTER THE WORK IS COMPLETE. TESTING SHALL INCLUDE ALL DEVICES. CONTROL PANEL, ANNUNCIATOR PANEL, OTHER PANELS, FEATURES AND FUNCTIONS. TESTING SHALL BE WITNESSED BY THE OWNER'S REPRESENTATIVE AND BE IN ACCORDANCE WITH THE NFPA. PROVIDE A TESTING REPORT TO THE AHJ AND THE ENGINEER AS A SUBMITTAL. REFER TO SPECIFICATION SECTION 283103.



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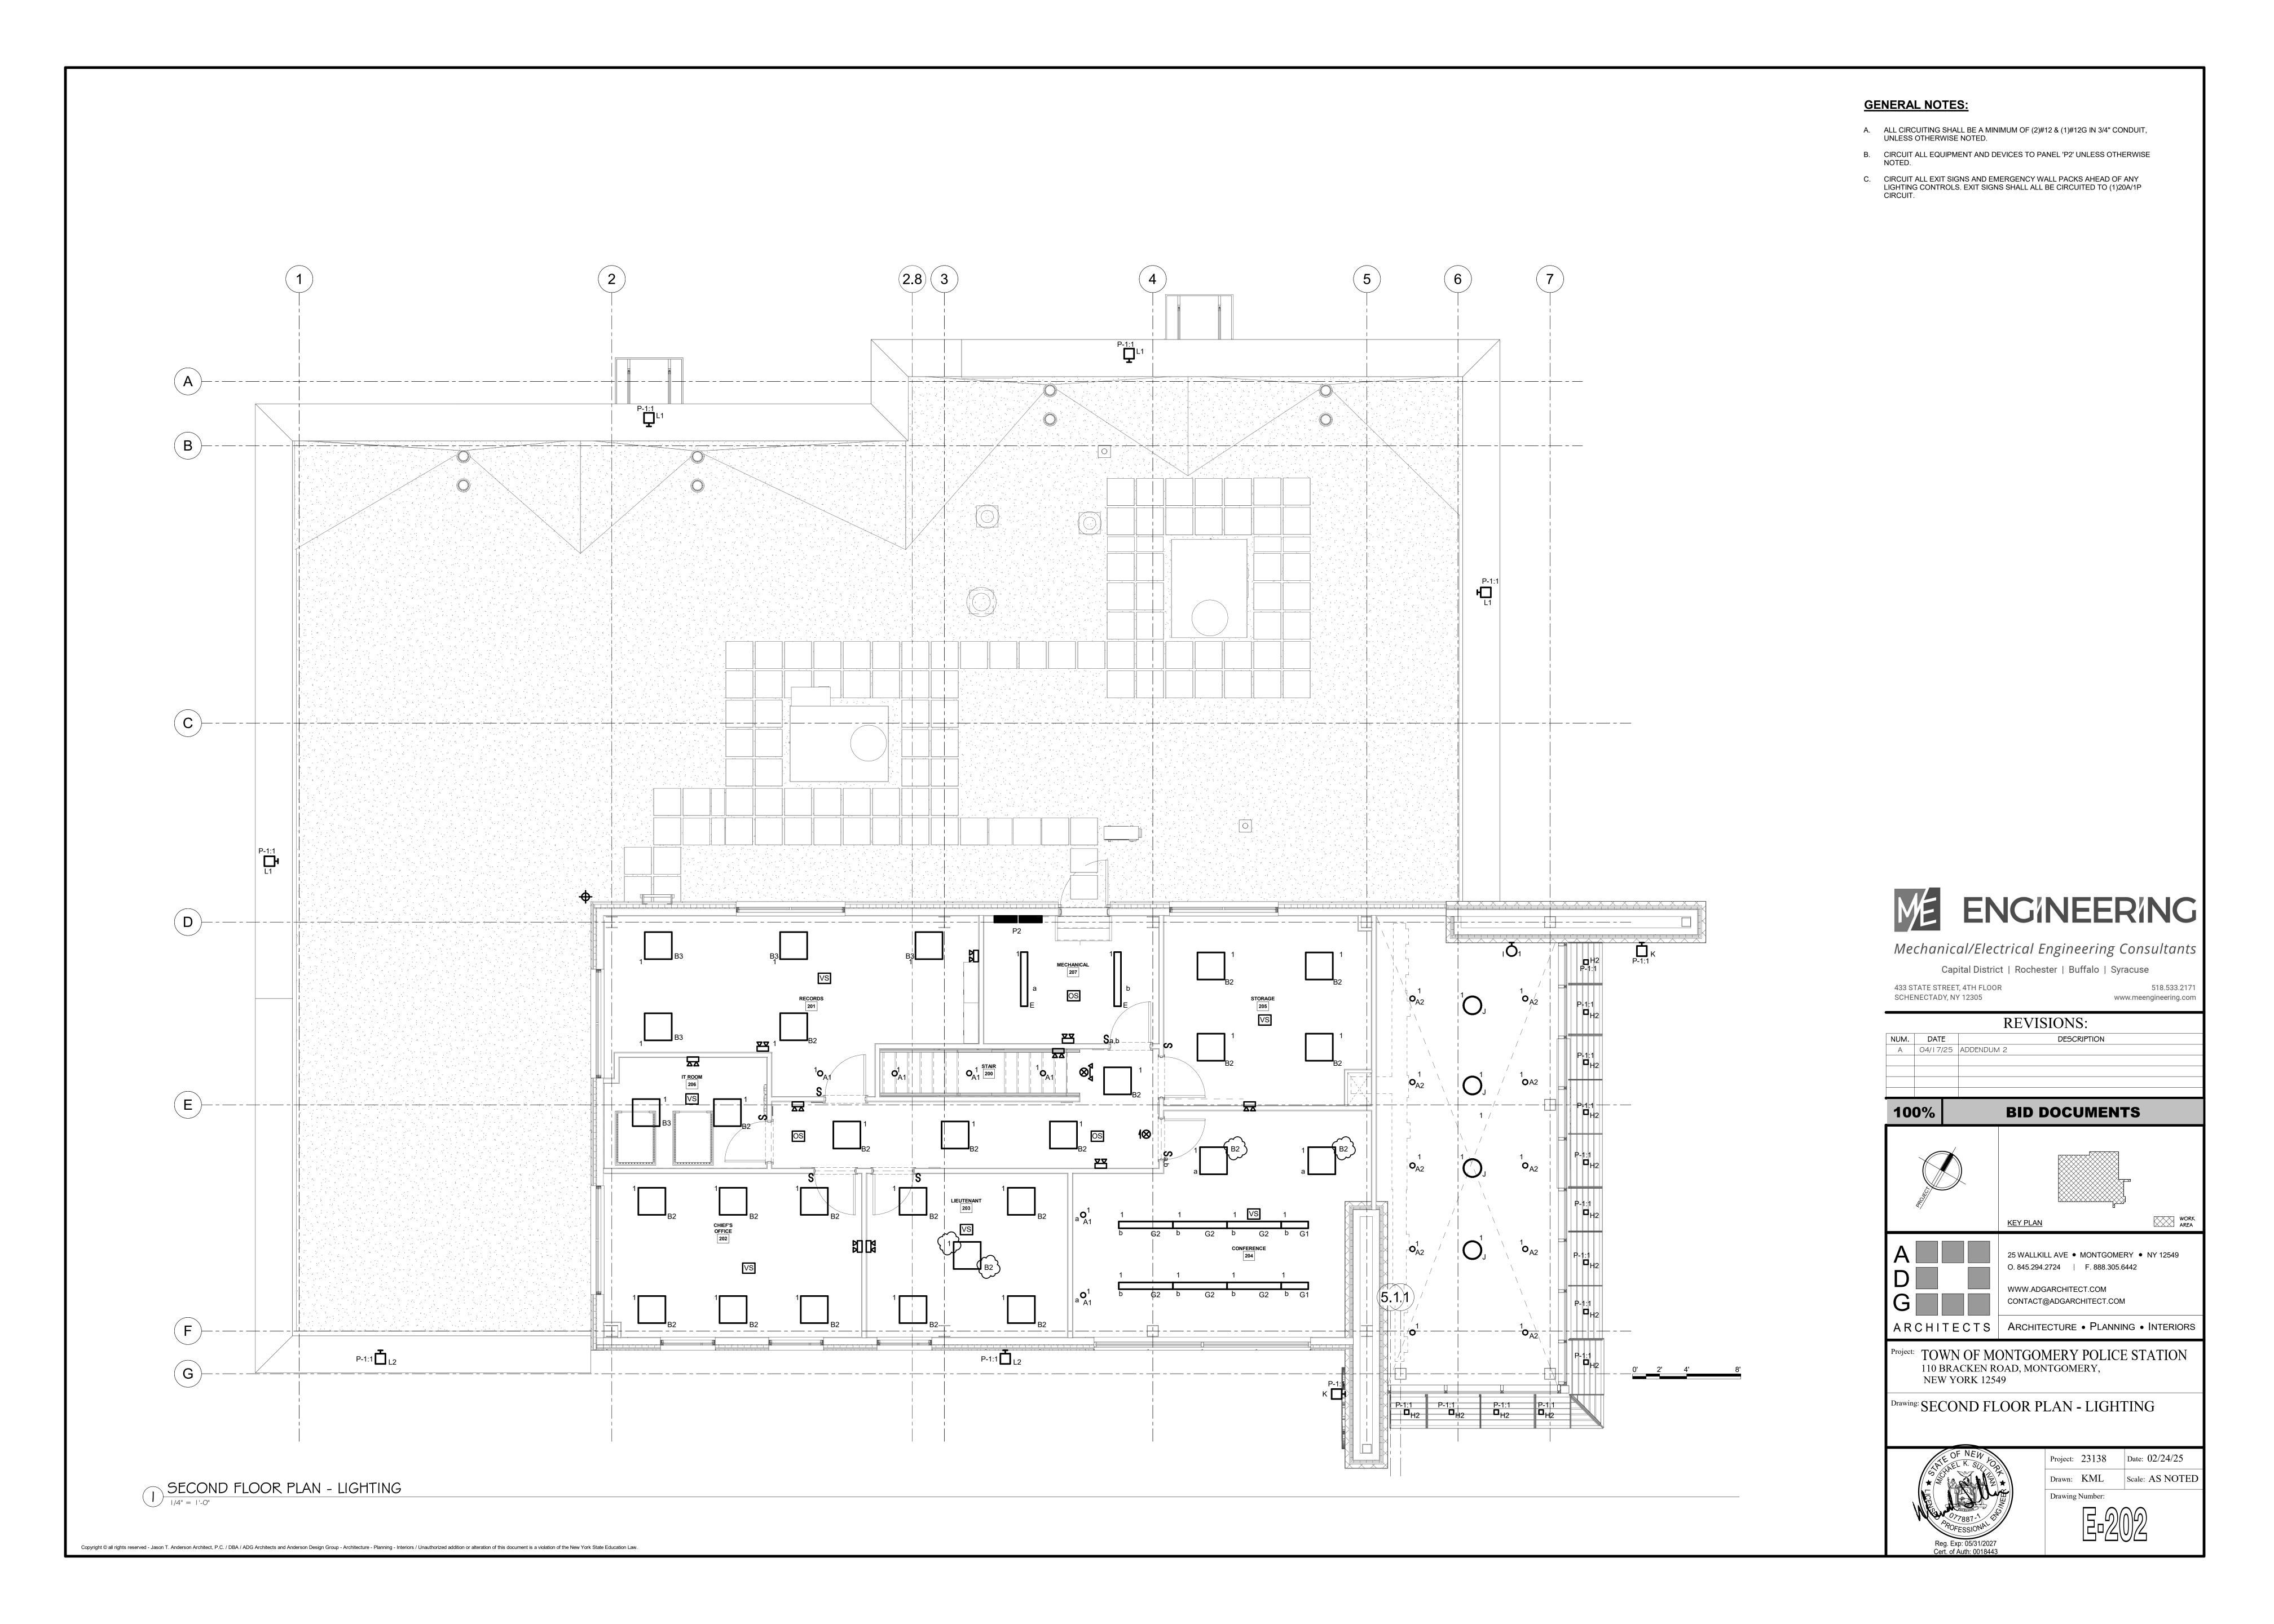
Project: TOWN OF MONTGOMERY POLICE STATION 110 BRACKEN ROAD, MONTGOMERY.

brawing: ELECTRICAL LEGEND & **ABBREVIATIONS** 



NEW YORK 12549

Project: 23138 Date: 02/24/25 Drawn: KML Scale: AS NOTEI Drawing Number:



ELECTRIC EQUIPMENT AND CONTROL SCHEDULE  AU AT UNIT IU INTEGRAL WITH UNIT  B ASD WITH BYPASS M MULTIPLE MOTOR ASD  ECB ENCLOSED CIRCUIT BREAKER NF NON-FUSED  F FUSED R ASD WITH REDUNDANT ASD  HOA HAND-OFF-AUTO WITH RELAY RE REMOTE											A. B. C.	A. REFER TO SPECIFICATIONS FOR EQUIPMENT REQUIREMENTS  B. PROVIDE CONTROLLER SIZED PER HP/AMPS.  C. LOCATIONS/QUANTITIES OF FIRE ALARM DUCT DETECTORS ARE SHOWN ON PLANS																			
		EQUIPMENT						POW	ER SOURCE,	PROTECT	TION & WIRII	NG			MO <sup>-</sup>	TOR CO	ONTROLLE	ER				DISCON	NECTING	G MEAN	S		CONNE	ECTIONS	<u>,                                    </u>		EQUIPMENT
ITEM ID	NAME	ROOM LOCATION	HP	KW	AMPERAGE	PHASE	VOLTAGE	SOURCE	OCPD RATING	E	IG FROM SO EQUIPMENT CONTROLLE ONNECTING	VIA ER /	ANUAL OTOR STARTER	AGNETIC OTOR STARTER	OMBINATION AGNETIC STARTER ND SAFETY SWITCH	DJUSTABLE SPEED RIVE	ACKAGED CONTROL NIT	EMA ENCLOSURE TYPE	EMA STARTER SIZE	OCATION	AFETY SWITCH	AFETY SWITCH MPERE RATING	USE/CB MPERE RATING	EMA ENCLOSURE TYPE	OCATION	IRE ALARM SHUTDOWN	RE ALARM UCT DETECTOR(S)	OTORIZED DAMPER	NE VOLTAGE EMPERATURE CONTROL	REFERENCE NOTES	ITEM ID
RTU-1	ROOFTOP HANDLING UNIT	ROOF	1	1	60.7	2	208	P-2	80A/3P	3#3	1#8	1-1/4"C	ΣΣ	ΣΣ	U≥∢	ΨO	X □ □ □	Z	Z	IU	S	ა ∢	ū∢	Z	I IU	4 📛		Σ		/ <del> </del>	RTU-1
RTU-2	ROOFTOF HANDLING UNIT	ROOF		1	132.2	3	208	P-2	175A/3P	3#2/0	1#6	2"C					X			IU	<b>I</b>				IU	X	X	1	$\vdash$	1 💳	RTU-2
VAV-1-1	AIR TERMINAL UNIT	EVIDENCE 123			8.4	1	208	P-1	15A/2P	2#12	1#12	3/4"C					Х			IU					IU						VAV-1-1
VAV-1-2	AIR TERMINAL UNIT	EVIDENCE 123			8.4	1	208	P-1	15A/2P	2#12	1#12	3/4"C					Х			IU					IU						VAV-1-2
VAV-1-3	AIR TERMINAL UNIT	CORRIDOR			10.8	1	208	P-1	15A/2P	2#12	1#12	3/4"C					Х			IU					IU						VAV-1-3
VAV-1-4	AIR TERMINAL UNIT	CORRIDOR			6.0	1	208	P-1	15A/2P	2#12	1#12	3/4"C					Х			IU					IU	1	'	/	4	4	VAV-1-4
VAV-1-5	AIR TERMINAL UNIT	CORRIDOR			8.4	1	208	P-1	15A/2P	2#12	1#12	3/4"C					X			IU					IU	4		<b></b>	$\longleftarrow$	<b> </b>	VAV-1-5
VAV-2-1 VAV-2-2	AIR TERMINAL UNIT AIR TERMINAL UNIT	CORRIDOR 103 CORRIDOR			45.1 4.8	3	208 208	P-2 P-1	50A/3P 15A/2P	3#6 2#12	1#10 1#12	3/4"C 3/4"C					X			IU IU					IU	1 -			$\longleftarrow$	<b> </b>	VAV-2-1 VAV-2-2
VAV-2-3	AIR TERMINAL UNIT	CORRIDOR			13.2	1	208	P-1	15A/2P	2#12	1#12	3/4 C					X			IU					IU	1 -		+	+	<b> </b>	VAV-2-2 VAV-2-3
VAV-2-4	AIR TERMINAL UNIT	CORRIDOR			10.8	1	208	P-1	15A/2P	2#12	1#12	3/4"C					X			IU					IU	1			$\vdash$		VAV-2-4
VAV-2-5	AIR TERMINAL UNIT	CORRIDOR			10.8	1	208	P-1	15A/2P	2#12	1#12	3/4"C					Х			IU					IU						VAV-2-5
VAV-2-6	AIR TERMINAL UNIT	BREAK ROOM 110			36.1	1	208	P-1	40A/2P	2#8	1#10	3/4"C					Х			IU					IU						VAV-2-6
VAV-2-7	AIR TERMINAL UNIT	QUARTERMASTER 112			12.0	1	208	P-1	15A/2P	2#12	1#12	3/4"C					Х			IU					IU	1				4	VAV-2-7
VAV-2-8	AIR TERMINAL UNIT	QUARTERMASTER 112			34.7	3	208	P-1	35A/3P	2#8	1#10	3/4"C		<u> </u>			X			IU					IU	<b>↓</b>			$\longleftarrow$	4	VAV-2-8
VAV-2-9	AIR TERMINAL UNIT	GYM 2-9			13.2	1	208	P-1	15A/2P	2#12	1#12	3/4"C		<u> </u>			X			IU					IU	<b> </b>		/	1	<b> </b>	VAV-2-9
VAV-2-10 VAV-2-11	AIR TERMINAL UNIT AIR TERMINAL UNIT	MECHANICAL 207 CORRIDOR			16.8 13.2	1	208	P-2 P-2	20A/2P 15A/2P	2#12 2#12	1#12 1#12	3/4"C 3/4"C					X			IU IU					IU	1 -			+	<b> </b>	VAV-2-10 VAV-2-11
VAV-2-11 VAV-2-12	AIR TERMINAL UNIT	LIEUTENANT 204			8.4	1	208 208	P-2	15A/2P 15A/2P	2#12	1#12	3/4 °C					X			IU					IU	1		+	$\vdash$	1	VAV-2-11 VAV-2-12
VAV-2-13	AIR TERMINAL UNIT	CORRIDOR			22.8	1	208	P-2	25A/2P	2#10	1#10	3/4"C					X			IU					IU	1			$\vdash$		VAV-2-13
VAV-2-14	AIR TERMINAL UNIT	MENS LOCKER 116			15.6	1	208	P-1	20A/2P	2#12	1#12	3/4"C					Х			IU					IU						VAV-2-14
VAV-2-15	AIR TERMINAL UNIT	MENS LOCKER 116			9.6	1	208	P-1	15A/2P	2#12	1#12	3/4"C					Х			IU					IU						VAV-2-15
CUH-100	CABINET UNIT HEATER	VESTIBULE 100		4	19.2	1	208	P-1	30A/2P	2#10	1#10	3/4"C					Х			IU					IU	<b> </b>		$ldsymbol{\perp}$	igspace	<b>I</b>	CUH-100
CUH-126	CABINET UNIT HEATER	CORRIDOR		4	19.2	1	208	P-1	30A/2P	2#10	1#10	3/4"C		<u> </u>		1	X			IU	<u> </u>			<u> </u>	IU	1	<b>—</b>	<b> </b>	$\longmapsto$	<b> </b>	CUH-126
UH-111	UNIT HEATER UNIT HEATER	ELECTRICAL 111 PLUMBING 125		5	24.0	1	208	P-1	35A/2P	2#8	1#10	3/4"C 3/4"C		1	-	1	X			IU	-	1		1	IU	1	<b>-</b>	+	$\longmapsto$	<b> </b>	UH-111
UH-125 EF-1	EXHAUST FAN	ROOF	1/4	3	24.0	3	208 208	P-2 P-2	35A/2P 15A/3P	2#8 3#12	1#10 1#12	3/4"C 3/4"C		1		Y	X			IU IU		1	-		AU	1 -	<del>                                     </del>	+	igodot	-	UH-125 EF-1
EF-122	EXHAUST FAN	ROOF	1/7		1.3	1	120	P-2	15A/3P	2#12	1#12	3/4 C		<b>†</b>		<b>-^</b> -	X			IU					IU	1 -	<b> </b>	1	$\vdash \vdash \vdash$		EF-122
EF-124	EXHAUST FAN	ROOF		1	1.3	1	120	P-2	15A/1P	2#12	1#12	3/4"C					X			IU			<b> </b>	t	IU	1		+	$\vdash$		EF-124
AC-01	AIR CONDITIONING UNIT	IT CLOSET 202		1	1.0	1	208	ACCU-01	-	2#12	1#12	3/4"C					Х			IU					IU	1					AC-01
ACCU-01	AIR CONDITIONING UNIT	ROOF			19.0	1	208	P-2	20A/2P	2#12	1#12	3/4"C					Х			IU					IU						ACCU-01
TMV-1	THERMOSTATIC MIXING VALVE	MECHANICAL 207			5.0	1	120	P-2	20A/1P	2#12	1#12	3/4"C					Х			IU					AU	<b> </b>	<b>_</b>	$ldsymbol{\perp}$	igspace	1	TMV-1
RP-1	RECIRC PUMP	MECHANICAL 207			1.8	1	120	P-2	20A/1P	2#12	1#12	3/4"C		<b>_</b>			X			IU	NIT.	20		4	AU	1	<b>-</b>	<b></b> /	$\longleftarrow$		RP-1
WH-1	WATER HEATER ULTRAVIOLET FILTER	MECHANICAL 207		5.5	26.4	1	208	P-2	35A/2P	2#8	1#10	3/4"C 3/4"C					X			IU	NF	30		1	AU	1	<b></b> '	<b> </b>	igoplus	1	WH-1
UV-1 UV-2	ULTRAVIOLET FILTER ULTRAVIOLET FILTER	PLUMBING 125 PLUMBING 125		0.23	1.9 1.9	1	120 120	P-2 P-2	20A/1P 20A/1P	2#12 2#12	1#12 1#12	3/4"C 3/4"C		-			X			IU IU		-	-		AU	1 -	<b> </b>	1	$\vdash$	1	UV-1 UV-2
WP-1	WELL PUMP	PLUMBING 125	10	0.23	30.8	3	208	P-2 P-2	70A/3P	3#8	1#12	3/4 C					X			IU	NF	60	1	1	AU	1 -	<b>—</b>	+-	igodot	<b>/</b>	WP-1
DWBP-1	DOMESTIC WATER PUMP	PLUMBING 125	2	1	13.2	1	208	P-2	20A/2P	2#12	1#12	3/4"C		1			X			IU	NF	30	1	1	AU		<b>†</b>	1 1	$\vdash$	1 -	DWBP-1
PS-1	PRESSURE SWITCH	PLUMBING 125	_	1	1.0	1	120	P-2	20A/1P	2#12	1#12	3/4"C					$\frac{1}{x}$			IU	1				AU	1	<b>†</b>		$\vdash$	1	PS-1

**ABBREVIATIONS** 


**GENERAL NOTES** 

REFERENCE NOTES

1 PLUG SERVES AS DISCONNECTING MEANS.

SAFETY DISCONNECT FURNISHED BY MC AND INSTALLED BY EC.



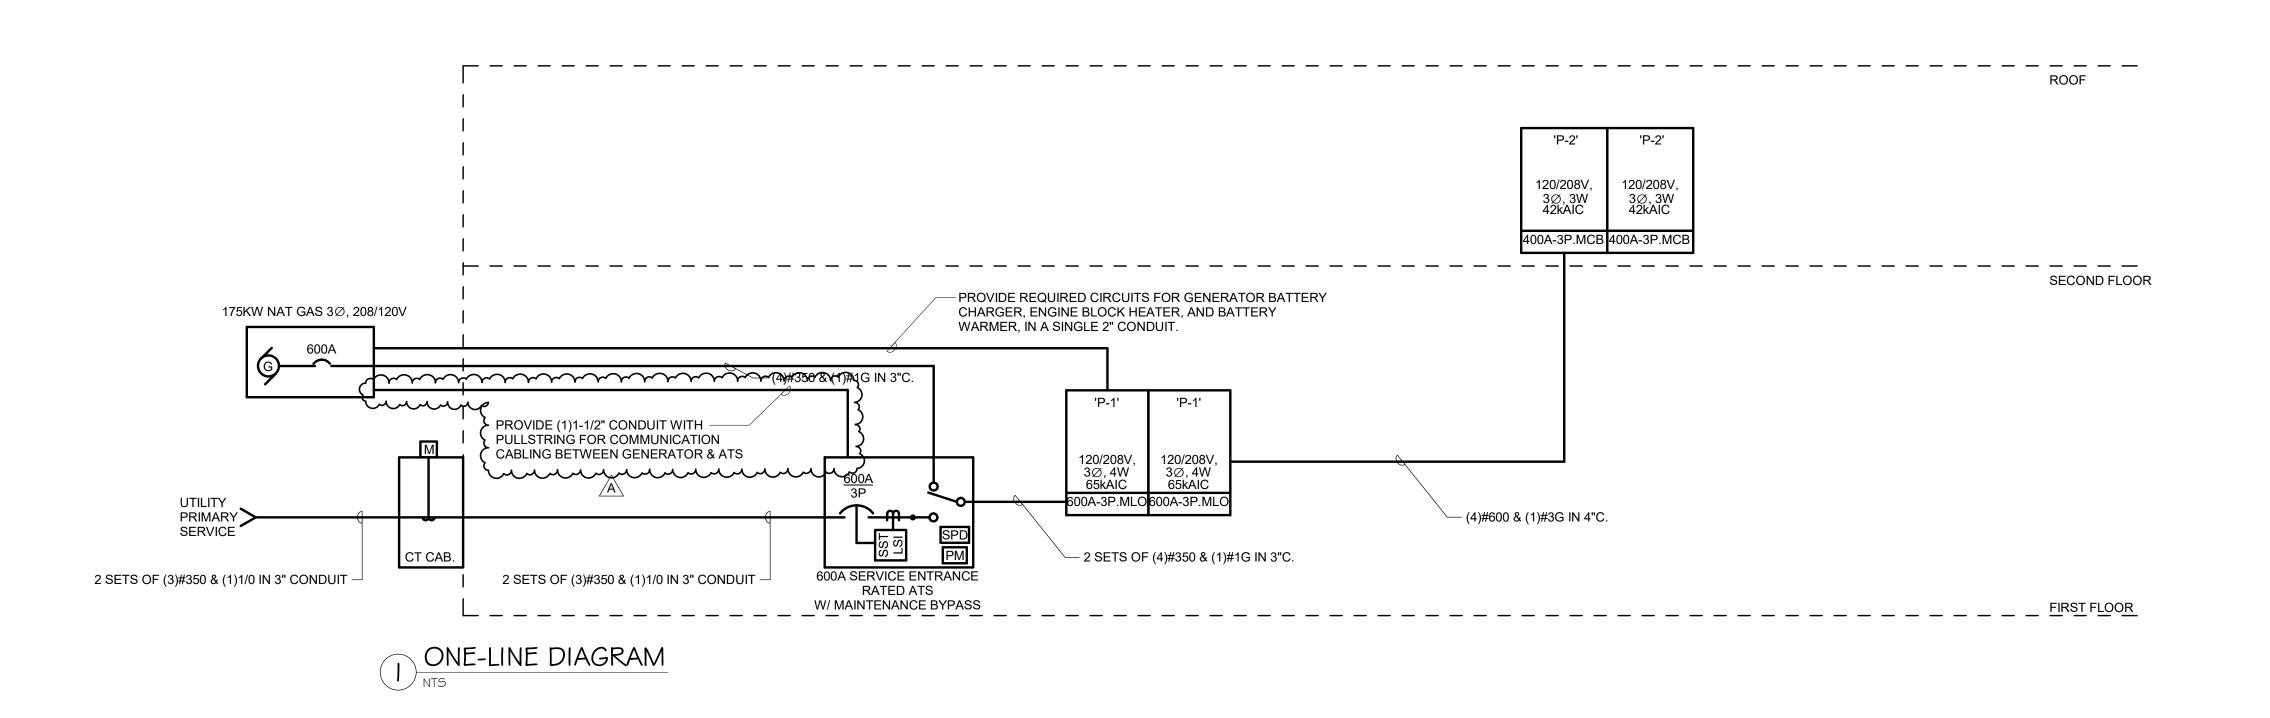



Mechanical/Electrical Engineering Consultants

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	REVISIONS:									
NUM.	DATE	DESCRIPTION								
Α	04/17/25	ADDENDUM 2								


**BID DOCUMENTS** 

	KEY PLAN	WOF ARE
A	25 WALLKILL AVE • MONTGOMERY •	NY 12549



Project: TOWN OF MONTGOMERY POLICE STATION
110 BRACKEN ROAD, MONTGOMERY,
NEW YORK 12549

Drawing: ELECTRICAL ONELINE DIAGRAM

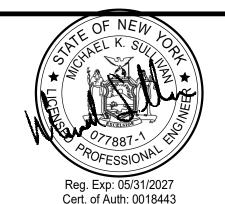

Project:	23138	Date: 02/24/25
Drawn:	KML	Scale: AS NOTED
Drawing Number:		

