


WESTCHESTER COUNTY

CONTRACT No. 20-502 LOW RISE BUILDING RENOVATIONS **AND HVAC IMPROVEMENTS - PHASE II** 110 DR. MARTIN LUTHER KING JR. BOULEVARD WHITE PLAINS, NEW YORK

WESTCHESTER COUNTY, NEW YORK **DEPARTMENT OF PUBLIC WORKS AND TRANSPORTATION**

RECOMMENDED FOR CONSTRUCTION	1-16-24 DATE	RECOMMENDED FOR CONSTRUCTION DATE	APPROVED FOR CONSTRUCTION
ADAM KAPLINSKI, R.A.		GAYLE KATZMAN, P.E.	HUGH J. GREECHAN, JR., P.E.
PRINCIPAL ARCHITECT DEPARTMENT OF PUBLIC WORKS AND TRANSPORTATION		FIRST DEPUTY COMMISSIONER DEPARTMENT OF PUBLIC WORKS AND TRANSPORTATION	DEPARTMENT OF PUBLIC WORKS AN TRANSPORTATION

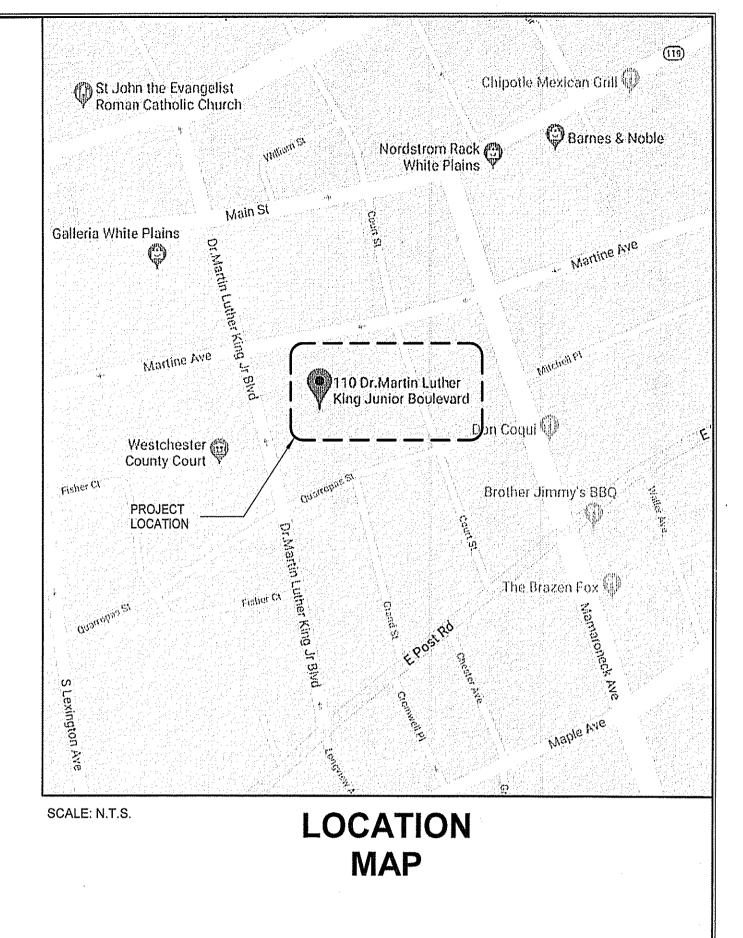

ASBESTOS NOTE:

IF ANY SUSPECT ASBESTOS CONTAINING MA ASDESTOS WARNING TAPE AND AN ADATEMENT PLAN SHALL DE SUBMITTED TO THE OWNER & ARCHITECT.

ALL WOOD TO BE FIRE TREATED

BALANCING REPORT TO BE REQUIRED PRIOR TO PROJECT CLOSE-OUT

	CONSULTANT SEAL	CONSULTANT	CONSULTANT INFORMATION Graf & Lewent Architects LLP 90-30 161st Street, Jamaica, NY 11432					
					P: 718	3-651-6200 F: 718-	-251-6989	
	REVISION NUMBER	DATE	MADE BY			REVIS	SION	
		r - CHANGE r - NO CHAI	S AS NOTED		AVVIN	G CERTIFICATION		
	NAME: SIGNATURE: TITLE:					DATE:		
1/16/24 DATE	DEP		STCHESTER OF PUBLIC		CONTRACT SHEET NUMBER NUMBER 20-502 T-001			
۱D	DIVISION OF ENGINEERING LOW RISE BUILDING RENOVATIONS AND HVAC IMPROVEMENTS - PHASE II 110 DR. MARTIN LUTHER KING, JR. BOULEVARD WHITE PLAINS, NEW YORK TITLE SHEET						SHEET NO. 1 OF 133 SCALE: 12" = 1'-0" DATE: 01-19-2024 Issue Date DPW FILE NO. REV 52-11-T-1813-0 NO.	
			1111				52-11-T-1813-0 NO.	

DRAWING LIST:

ARCHITECTURE

No	SHEET No	SHEET NAME	DPW FILE No
1	T-001	TITLE SHEET	52-11-T-1813-0
2	T-002	DRAWING LIST	52-11-G-1814-0
3	G-001	CODE ANALYSIS	52-11-G-1815-0
4	G-002	EGRESS AND FIRE RATING PLAN	52-11-G-1816-0
5	G-003	PHASING PLAN - PHASE I & II	52-11-G-1817-0
6	G-004	1ST FLOOR NORTH WING - TEMPORARY TAX OFFICE	52-11-G-1818-0
7	DM-001	PARTIAL DEMOLITION PLAN - 1ST FLOOR CENTRAL WING	52-11-G-1819-0
8	DM-002	PARTIAL DEMOLITION PLAN - 1ST FLOOR NORTH WING	52-11-G-1820-0
9	DM-003	PARTIAL DEMOLITION PLAN - 2ND FLOOR CENTRAL WING	52-11-G-1821-0
10	DM-004	PARTIAL DEMOLITION PLAN - 2ND FLOOR NORTH WING	52-11-G-1822-0
11	DM-005	PARTIAL DEMOLITION CEILING PLAN -	52-11-G-1823-0
		1ST FLOOR CENTRAL WING	
12	DM-006	PARTIAL DEMOLITION REFLECTED CEILING PLAN -	52-11-G-1824-0
		1ST FLOOR NORTH WING	
13	DM-007	PARTIAL DEMOLITION REFLECTED CEILING PLAN -	52-11-G-1825-0
		2ND FLOOR CENTRAL WING	
14	DM-008	PARTIAL DEMOLITION REFLECTED CEILING PLAN -	52-11-G-1826-0
		2ND FLOOR NORTH WING	
15	DM-009	DETAIL DEMOLITION PLANS - RESTROOMS	52-11-G-1827-0
16	A-101	CONSTRUCTION PLAN - 1ST FLOOR CENTRAL WING	52-11-A-1828-0
17	A-102	CONSTRUCTION PLAN - 1ST FLOOR NORTH WING	52-11-A-1829-0
18	A-103	CONSTRUCTION PLAN - 2ND FLOOR CENTRAL WING	52-11-A-1830-0
19	A-104	CONSTRUCTION PLAN - 2ND FLOOR NORTH WING	52-11-A-1831-0
	A-105	REFLECTED CEILING PLAN - 1ST FLOOR CENTRAL WING	52-11-A-1832-0
21	A-106	REFLECTED CEILING PLAN - 1ST FLOOR NORTH WING REFLECTED CEILING PLAN - 2ND FLOOR CENTRAL WING	52-11-A-1833-0 52-11-A-1834-0
22 23	A-107 A-108	REFLECTED CEILING PLAN - 2ND FLOOR CENTRAL WING REFLECTED CEILING PLAN - 2ND FLOOR NORTH WING	52-11-A-1835-0
	A-108 A-109	REFLECTED CEILING PLAN - GARAGE LEVEL B2 - CENTRAL WING	
	A-110	REFLECTED CEILING PLAN - GARAGE LEVEL B2 - OCITICAL WING	52-11-A-1837-0
	A-111	FINISH PLAN - 1ST FLOOR CENTRAL WING	52-11-A-1838-0
27	A-112	FINISH PLAN - 1ST FLOOR NORTH WING	52-11-A-1839-0
28	A-113	FINISH PLAN - 2ND FLOOR CENTRAL WING	52-11-A-1840-0
29	A-114	FINISH PLAN - 2ND FLOOR NORTH WING	52-11-A-1841-0
30	A-120	PLUMBING PLAN & FIXTURE SCHEDULE	52-11-A-1842-0
31	A-121	POWER & COMMUNICATION PLAN - RESTROOMS	52-11-A-1843-0
32	A-130	PARTIAL B3 PLAN - ELEVATOR MACHINE RMS - 110 MLK BLVD	52-11-A-1844-0
33	A-131	PARTIAL ROOF PLAN - ELEVATOR HOISTWAY - 110 MLK BLVD	52-11-A-1845-0
34	A-132	PARTIAL EXTERIOR ELEVATION - 110 MLK BLVD	52-11-A-1846-0
35	A-133	PARTIAL 1ST FLOOR PLAN - JUDGE ELEVATOR - 111 MLK BLVD	52-11-A-1847-0
36	A-134	ROOF PLAN - ELEVATOR MACHINE ROOM - 111 MLK BLVD	52-11-A-1848-0
37	A-135	PARTIAL ELEVATIONS & SECTIONS - 111 MLK BLVD	52-11-A-1849-0
38	A-136	EXISTING BASEMENT PLAN - ELEVATOR - 143 GRAND STREET	52-11-A-1850-0
39	A-137	PARTIAL 3RD FLOOR & LOW ROOF PALN - 143 GRAND STREET	52-11-A-1851-0
		ELEVATOR #09 & #10 CAB PLANS & ELEVATIONS - 110 MLK BLVD	52-11-A-1852-0
41	A-141	JUDGE ELEVATOR CAB PLANS & ELEVATIONS - 111 MLK BLVD	52-11-A-1853-0
42	A-142	BOARD OF ELECTION ELEVATOR CAB PLANS & ELEVATIONS -143 GRAND STREET	52-11-A-1854-0
43	A-201	INTERIOR ELEVATIONS - 1ST FLOOR - CENTRAL WING	52-11-A-1855-0
44	A-202	INTERIOR ELEVATIONS - 1ST FLOOR - NORTH WING	52-11-A-1856-0
45	A-203	INTERIOR ELEVATIONS - 2ND FLOOR - CENTRAL WING	52-11-A-1857-0
46	A-204	INTERIOR ELEVATIONS - 2ND FLOOR - NORTH WING	52-11-A-1858-0
47	A-205	INTERIOR ELEVATIONS - 1ST FLOOR - RESTROOMS	52-11-A-1859-0
48	A-206	INTERIOR ELEVATIONS - 2ND FLOOR - RESTROOMS	52-11-A-1860-0
49	A-300	DETAILS	52-11-A-1861-0
50	A-301	CEILING DETAILS	52-11-A-1862-0
51	A-302	FIRESTOPPING DETAILS	52-11-A-1863-0
52 52	A-303	SIGN SCHEDULE & DETAILS	52-11-A-1864-0
53	A-304	LIGHT FIXTURE & FINISH SCHEDULES	52-11-A-1865-0

FIRE PROTECTION

No SHEET No	SHEET NAME	DPW FILE No
1 SP-010	SYMBOLS, ABBREVIATIONS, NOTES, SCHEDULES AND DETAILS	52-11-SP-1866-0
2 SP-030	COMBINATION SPRINKLER/STANDPIPE RISER DIAGRAM	52-11-SP-1867-0
3 SP-102	SPRINKLER PLAN - 1ST FLOOR CENTRAL WING	52-11-SP-1868-0
4 SP-103	SPRINKLER PLAN - 1ST FLOOR NORTH WING	52-11-SP-1869-0
5 SP-104	SPRINKLER PLAN - 2ND FLOOR CENTRAL WING	52-11-SP-1870-0
6 SP-105	SPRINKLER PLAN - 2ND FLOOR NORTH WING	52-11-SP-1871-0

PLUMBING

No	SHEET No	SHEET NAME	DPW FILE No	No	SHEET No	SHEET NAME	DPW FILE No
1	P-010	SYMBOLS, ABBREVIATIONS AND SCHEDULES	52-11-P-1872-0	1	E-010	SYMBOLS, ABBREVIATIONS, SCHEDULES AND NOTES	52-11-E-1915-0
2	P-020	DETAILS	52-11-P-1873-0	2	E-020	DETAILS	52-11-E-1916-0
3	P-030	SANITARY RISER DIAGRAMS	52-11-P-1874-0	3	E-030	PANEL SCHEDULE AND RISER DIAGRAM	52-11-E-1917-0
4	P-031	DOMESTIC WATER RISER DIAGRAMS	52-11-P-1875-0	4	E-098	ELECTRICAL PLAN - BOILER ROOM	52-11-E-1918-0
5	P-103	PLUMBING PLAN - 1ST FLOOR NORTH WING	52-11-P-1876-0	5	E-099	ELECTRICAL PLAN - CHILLER PLANT	52-11-E-1919-0
6	P-104	PLUMBING PLAN - 2ND FLOOR CENTRAL WING	52-11-P-1877-0	6	E-102	ELECTRICAL PLAN - 1ST FLOOR CENTRAL WING	52-11-E-1920-0
7	P-105	PLUMBING PLAN - 2ND FLOOR NORTH WING	52-11-P-1878-0	7	E-103	ELECTRICAL PLAN - 1ST FLOOR NORTH WING	52-11-E-1921-0
8	P-130	PARTIAL BASEMENT PLUMBING PLAN - 110 MLK BLVD	52-11-P-1879-0	8	E-104	ELECTRICAL PLAN - 2ND FLOOR CENTRAL WING	52-11-E-1922-0
9	P-133	PARTIAL 1ST FLOOR PLUMBING PLAN - 111 MLK BLVD	52-11-P-1880-0	9	E-105	ELECTRICAL PLAN - 2ND FLOOR NORTH WING	52-11-E-1923-0
10	P-137	PARTIAL BASEMNT PLUMBING PLAN - 143 GRAND ST	52-11-P-1881-0	10	E-106	ELECTRICAL PLAN - ROOF	52-11-E-1924-0
				11	E-130	ELECTRICAL PLAN - BASEMENT L3 ELEVATOR - 110 MLK BLVD	52-11-E-1925-0
				12	E-133	ELECTRICAL PLAN - COURT HOUSE JUDGE'S ELEVATOR	52-11-E-1926-0
						- 111 MLK BLVD	
				13	E-135	ELECTRICAL PLAN - COURT HOUSE ROOF - 111 MLK BLVD	52-11-E-1927-0
Er	IERGY COM	PLIANCE		14	E-137	ELECTRICAL PLAN - 143 GRAND STREET BASEMENT	52-11-E-1928-0
				15	E-138	ELECTRICAL PLAN - 143 GRAND ST 3RD FLOOR & LOW ROOF	52-11-E-1929-0
No	SHEET No	SHEET NAME	DPW FILE No	16	E-202	ELECTRICAL LIGHTING PLAN - 1ST FLOOR CENTRAL WING	52-11-E-1930-0
			DIWINEENO	17	E-203	ELECTRICAL LIGHTING PLAN - 1ST FLOOR NORTH WING	52-11-E-1931-0
1	EN-010	ENERGY COMPLIANCE	52-11-EN-1882-0	18	E-204	ELECTRICAL LIGHTING PLAN - 2ND FLOOR CENTRAL WING	52-11-E-1932-0
2	EN-011	ENERGY COMPLIANCE	52-11-EN-1883-0	19	E-205	ELECTRICAL LIGHTING PLAN - 2ND FLOOR NORTH WING	52-11-E-1933-0
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No	SHEET No	SHEET NAME	DPW FILE No
1	EN-010	ENERGY COMPLIANCE	52-11-EN-1882-0
2	EN-011	ENERGY COMPLIANCE	52-11-EN-1883-0
3	EN-012	ENERGY COMPLIANCE	52-11-EN-1884-0

MECHANICAL

No	SHEET No	SHEET NAME	DPW FILE No	No	SHEET No	SHEET	NAME	DPW FILE No
1 2 3 4 5 6 7 8 9 10	M-010 M-011 M-020 M-021 M-039 M-042 M-043 M-043 M-045 M-045 M-052	SYMBOLS, ABBREVIATIONS, SCHEDULES, AND NOTES SCHEDULES DETAILS DETAILS CHILLER ROOM MECHANICAL DEMOLITION PLAN 1ST FLOOR CENTRAL WING MECHANICAL DEMOLITION PLAN 1ST FLOOR NORTH WING MECHANICAL DEMOLITION PLAN 2ND FLOOR CENTRAL WING MECHANICAL DEMOLITION PLAN 1ST FLOOR NORTH WING MECHANICAL DEMOLITION PLAN	52-11-M-1885-0 52-11-M-1886-0 52-11-M-1887-0 52-11-M-1888-0 52-11-M-1889-0 52-11-M-1890-0 52-11-M-1891-0 52-11-M-1892-0 52-11-M-1893-0 52-11-M-1894-0	1 2 3 4 5 6 7 8 9	FA-010 FA-102 FA-104 FA-105 FA-130 FA-131 FA-135 FA-137 FA-138	FIRE ALARM PLAN - 1ST FL FIRE ALARM PLAN - 2ND FL FIRE ALARM PLAN - 2ND FL FIRE ALARM PLAN - BASEN FIRE ALARM PLAN - ROOF FIRE ALARM PLAN - COUR FIRE ALARM PLAN - 143 GF	LOOR CENTRAL WING LOOR NORTH WING MENT L3 CENTRAL WING ELEVATOR PLAN - 110 MLK BLVD T HOUSE ROOF PLAN - 111 MLK BLVD	52-11-FA-1934-0 52-11-FA-1935-0 52-11-FA-1936-0 52-11-FA-1937-0 52-11-FA-1938-0 52-11-FA-1939-0 52-11-FA-1940-0 52-11-FA-1941-0 52-11-FA-1942-0
11	M-053	DEMOLITION PLAN 1ST FLOOR NORTH WING MECHANICAL PIPING DEMOLITION PLAN	52-11-M-1895-0	AS	BESTOS AB	ATEMENT/ENVIRONME	NTAL	
12	M-054	2ND FLOOR CENTRAL WING MECHANICAL PIPING DEMOLITION PLAN	52-11-M-1896-0	No	SHEET No	SHEET	NAME	DPW FILE No
13	M-055	2ND FLOOR NORTH WING MECHANICAL PIPING DEMOLITION PLAN	52-11-M-1897-0	1	AA-001 AA-002	WORK PROCEDURES, ABATEMENT SCHEDULE & DETAIL 52-11-AB-194 FIRST FLOOR ASBESTOS ABATEMENT PLAN 52-11-AB-194		
14	M-098	BOILER ROOM MECHANICAL PLAN	52-11-M-1898-0	3	AA-003	SECOND FLOOR ASBESTC		52-11-AB-1945-0
15	M-099	CHILLER ROOM MECHANICAL PLAN	52-11-M-1899-0	0	AA-000			52-11-AD-15 4 5-0
16	M-101	2ND SUBGRADE GARAGE MECHANICAL PLAN	52-11-M-1900-0					
17	M-102	1ST FLOOR CENTRAL WING MECHANICAL PLAN	52-11-M-1901-0					
18	M-103	1ST FLOOR NORTH WING MECHANICAL PLAN	52-11-M-1902-0					
19	M-104	2ND FLOOR CENTRAL WING MECHANICAL PLAN	52-11-M-1903-0					
20	M-105	2ND FLOOR NORTH WING MECHANICAL PLAN	52-11-M-1904-0					
21	M-106	3RD FLOOR & ROOF MECHANICAL PART PLAN	52-11-M-1905-0					
22	M-130	PARTIAL BASEMENT MECHANICAL PLAN - 110 MLK BLVD	52-11-M-1906-0					
23	M-131	PARTIAL ROOF MECHANICAL PLAN - ELEVATOR HOISTWAY - 110 MLK BLVD	52-11-M-1907-0			CONSULTANT SEAL	CONSULTANT INFORMATION	
24	M-134	ROOF MECHANICAL PLAN - ELEVATOR MACHINE ROOM - 111 MLK BLVD	52-11-M-1908-0			CONSULTAINT SEAL		
25	M-136	BASEMENT MECHANICAL PLAN - ELEVATOR - 143 GRAND ST	52-11-M-1909-0				Graf & Lewent	
26	M-137	3RD FLOOR & ROOF MECHANICAL PLAN - 143 GRAND ST	52-11-M-1910-0				Architects LLP	
27	M-202	1ST FLOOR CENTRAL WING MECHANICAL PIPING PLAN	52-11-M-1911-0			XXXXXXXXXXXXXXXXXXXXXXXXXXXXXXXXXXXXXXX		
28	M-203	1ST FLOOR NORTH WING MECHANICAL PIPING PLAN	52-11-M-1912-0			14610	90-30 161st Street, Jamaica, NY	
29	M-204	2ND FLOOR CENTRAL WING MECHANICAL PIPING PLAN	52-11-M-1913-0			SE NEW T	P: 718-651-6200 F: 718-251-	-0909
30	M-205	2ND FLOOR NORTH WING MECHANICAL PIPING PLAN	52-11-M-1914-0					

ELECTRICAL

FIRE ALARM

Graf & Lewent Architects LLP 90-30 161st Street, Jamaica, NY 11432 P: 718-651-6200 F: 718-251-6989				
REVISION NUMBER DATE MADE BY APP'D BY REVISION				
RECORD DRAWING CERTIFICATION				
AS BUILT - CHANGES AS NOTED AS BUILT - NO CHANGES				
CONTRACTOR CONTRACTOR	CONTRACTOR			
NAME: NAME:	NAME:			
SIGNATURE:				
TITLE:				
WESTCHESTER COUNTY, NEW YORK	MBER			
DEPARTMENT OF PUBLIC WORKS AND TRANSPORTATION 20-502 T-0	02			
DIVISION OF ENGINEERING SHEET NO. 2 OF 133				
LOW RISE BUILDING RENOVATIONS AND HVAC IMPROVEMENTS - PHASE II 110 DR. MARTIN LUTHER KING, JR. BOULEVARD WHITE PLAINS, NEW YORK DPW FILE NO.	sue Date			
DRAWING LIST 52-11-G-1814				

2020 EXISTING BUILDING CODE OF NEW YORK STATE - ANALYSIS CHAPTER 3 PROVISIONS FOR ALL COMPLIANCE METHODS **SECTION 301 ADMINISTRATION** 301.1 GENERAL 301.1.2 WORK AREA COMPLIANCE METHOD REPAIRS, ALTERATIONS, ADDITIONS, CHANGES IN OCCUPANCY AND RELOCATED BUILDINGS COMPLYING WITH THE APPLICABLE REQUIREMENTS OF CHAPTERS 5 THROUGH 13 OF THIS CODE SHALL BE CONSIDERED IN COMPLIANCE WITH THE PROVISIONS OF THIS CODE. SECTION 305 ACCESSIBILITY FOR EXISTING BUILDINGS 305.1 SCOPE THE PROVISIONS OF SECTIONS 305.1 THROUGH 305.9 APPLY TO MAINTENANCE, CHANGE OF OCCUPANCY,

ADDITIONS AND ALTERATIONS TO EXISTING BUILDINGS, INCLUDING THOSE IDENTIFIES AS HISTORIC BUILDINGS.

NO CHANGE TO USE, EGRESS AND OCCUPANCY PROJECT INCLUDES PROVIDING NEW FLOOR, WALL, AND CEILING FINISHES AND REPLACING PLUMBING FIXTURES AND ACCESSORIES AND LIGHTING FIXTURES.

305.7 ALTERATIONS AFFECTING AN AREA CONTAINING A PRIMARY FUNCTION WHERE AN ALTERATION AFFECTS THE ACCESSIBILITY TO, OR CONTAINS AN AREA OF PRIMARY

FUNCTIONS, THE ROUTE TO THE PRIMARY FUNCTION AREA SHALL BE ACCESSIBLE. THE ACCESSIBLE ROUTE TO THE PRIMARY FUNCTION AREA SHALL INCLUDE TOILET FACILITIES AND DRINKING FOUNTAINS SERVING THE AREA OF PRIMARY FUNCTION.

NO CHANGE TO PRIMARY FUNCTIONS.

CHAPTER 6: CLASSIFICATION OF WORK

SECTION 601 GENERAL

601.2 WORK AREA

LOW RISE BUILDING PARTIAL 1ST & 2ND FLOOR RENOVATION WORK AREA 1ST FLOOR = 12,130 S.F.

WORK AREA 2ND FLOOR = 13,650 S.F. **SECTION 602 ALTERATION - LEVEL 1**

603.1 SCOP

LEVEL 1 ALTERATIONS INCLUDE THE REMOVAL AND REPLACEMENT OR THE COVERING OF EXISTING MATERIALS, ELEMENTS, EQUIPMENT, OR FIXTURES USING NEW MATERIALS, ELEMENTS, EQUIPMENT, OR FIXTURES THAT SERVE THE SAME PURPOSE.

PROJECT INCLUDES REPLACING CEILING, WALL, AND FLOOR FINISHES, PLUMBING FIXTURES, AND LIGHTING FIXTURES. ALTERATION LEVEL 1 APPLIES

SECTION 603 ALTERATION - LEVEL 2

LEVEL 2 ALTERATIONS INCLUDE THE RECONFIGURATION OF SPACE, THE ADDITION OR ELIMINATION OF ANY DOOR OR WINDOW THE RECONFIGURATION OR EXTENSION OF ANY SYSTEM, OR THE INSTALLATION OF ANY ADDITIONAL EQUIPMENT

PROJECT INCLUDES INSTALLING NEW VAV BOXES AND PROVIDING A SPRINKLER SYSTEM. NO CHANGE TO WALL LAYOUT, DOORS OR WINDOWS. ALTERATION LEVEL 2 APPLIES

ALTERATION LEVEL 3 DO NOT APPLY

CHAPTER 7: ALTERATIONS - LEVEL 1

SECTION 701 GENERAL

701.1 SCOPE

LEVEL 1 ALTERATION AS DESCRIBED IN SECTION 602 SHALL COMPLY WITH THE REQUIREMENTS OF THIS CHAPTER.

SECTION 702 BUILDING ELEMENTS AND MATERIALS

702.1 INTERIOR FINISHES

NEWLY INSTALLED INTERIOR WALL AND CEILING FINISHES SHALL COMPLY WITH CHAPTER 8 OF THE BUILDING CODE OF NEW YORK STATE.

PROJECT INCLUDES PROVIDING NEW CEILING FINISHES OF ENTIRE FIRST AND SECOND FLOOR AND PORTION OF WALL FINISHES AS PER THE CONSTRUCTION DOCUMENTS AND SHALL COMPLY WITH CHAPTER 8.

702.2 INTERIOR FLOOR FINISH

NEW INTERIOR FLOOR FINISH, INCLUDING NEW CARPETING USED AS AN INTERIOR FLOOR FINISH MATERIAL, SHALL COMPLY WITH SECTION 804 OF THE BUILDING CODE OF NEW YORK STATE.

PROJECT INCLUDES PROVIDING NEW FLOOR FINISHES AS PER THE CONSTRUCTION DOCUMENTS AND SHALL COMPLY WITH SECTION 804.

SECTION 703 FIRE PROTECTION

703.1 GENERAL

ALTERATIONS SHALL BE DONE IN A MANNER THAT MAINTAINS THE LEVEL OF FIRE PROTECTION PROVIDED. PROJECT INCLUDES NEW AUTOMATIC SPRINKLER SYSTEM INSTALLATION.

SECTION 704 MEANS OF EGRESS

704.1 GENERAL

ALTERATION SHALL BE DONE IN A MANNER THAT MAINTAINS THE LEVEL OF PROTECTION PROVIDED FOR THE MEANS OF EGRESS.

NO CHANGE TO USE, EGRESS AND OCCUPANCY.

[NY] SECTION 708 PLUMBING 708.1 WATER CLOSET REPLACEMENT

WHEN ANY WATER CLOSET IS REPLACED. THE REPLACEMENT WATER CLOSET SHALL COMPLY WITH SECTION 604.4 OF THE PLUMBING CODE OF NEW YORK STATE.

PROJECT INCLUDES REPLACING WATER CLOSETS AND SHALL COMPLY WITH SECTION 604.4.

CHAPTER 8: ALTERATIONS - LEVEL 2

SECTION 801 GENERAL

801.1 SCOPE

LEVEL 2 ALTERATIONS AS DESCRIBED IN SECTION 603 SHALL COMPLY WITH THE REQUIREMENTS OF THIS CHAPTER.

801.2 ALTERATION LEVEL 1 COMPLIANCE

IN ADDITION TO THE REQUIREMENTS OF THIS CHAPTER, ALL WORK SHALL COMPLY WITH THE REQUIREMENTS OF CHAPTER 7.

801.3 COMPLIANCE

NEW CONSTRUCTION ELEMENTS, COMPONENTS, SYSTEMS, AND SPACES SHALL COMPLY WITH THE REQUIREMENTS OF THE BUILDING CODE OF NEW YORK STATE.

EXCEPTIONS: 4. THE MINIMUM CEILING HEIGHT OF THE NEWLY CREATED HABITABLE AND OCCUPIABLE SPACES AND CORRIDORS SHALL BE 7 FEET. ACTUAL MINIMUM CEILING HEIGHT IS 8 FEET - COMPLIES

SECTION 802 BUILDING ELEMENTS AND MATERIALS

802.1 SCOPE

THE REQUIREMENTS OF THIS SECTION ARE LIMITED TO WORK AREAS IN WHICH LEVEL 2 ALTERATIONS ARE BEING PERFORMED AND SHALL APPLY BEYOND THE WORK AREA WHERE SPECIFIED.

802.2 VERTICAL OPENINGS

EXISTING VERTICAL OPENINGS SHALL COMPLY WITH THE PROVISIONS OF SECTIONS 802.2.1.

802.2.1 EXISTING VERTICAL OPENINGS EXISTING INTERIOR VERTICAL OPENINGS CONNECTING TWO OR MORE FLOORS SHALL BE ENCLOSED WITH APPROVED ASSEMBLIES HAVING A FIRE-RESISTANCE RATING OF NOT LESS THAN 1 HOUR WITH APPROVED OPENING PROTECTIVES.

NEW ELEVATION SMOKE VENTS MAINTAIN 1 HOUR FIRE RESISTANCE.

802.4 INTERIOR FINISH

COMPLY WITH THE REQUIREMENTS OF THE BUILDING CODE OF NEW YORK STATE.

NEW INTERIOR FINISH OF FLOORS, WALLS AND CEILING WILL BE INSTALLED AS PER THE CONSTRUCTION DOCUMENTS AND IN COMPLIANCE WITH NYS BUILDING CODE.

SECTION 803 FIRE PROTECTION

803.1 SCOPE THE REQUIREMENTS OF THIS SECTION SHALL BE LIMITED TO WORK ARES IN WHICH LEVEL 2 ALTERATIONS ARE BEING PERFORMED, AND WHERE SPECIFIED THEY SHALL APPLY THROUGHOUT THE FLOOR ON WHICH THE WORK ARES ARE LOCATED OR OTHERWISE BEYOND THE WORK AREA.

803.2 AUTOMATIC SPRINKLER SYSTEMS

AUTOMATIC SPRINKLER SYSTEMS SHALL BE PROVIDED IN ACCORDANCE WITH THE REQUIREMENTS OF SECTIONS 803.2.1 THROUGH 803.2.4. INSTALLATION REQUIREMENTS SHALL BE IN ACCORDANCE WITH THE BUILDING CODE OF NEW YORK STATE.

803.2.2 GROUP E IN BUILDING IN OCCUPANCY GROUP 'B', WORK AREAS THAT HAVE EXITS OR CORRIDORS SHARED BY MORE THAN ONE TENANT OR THAT HAVE EXITS OR CORRIDORS SERVING AN OCCUPANT LOAD GREATER THAN 30 SHALL BE PROVIDED WITH AUTOMATIC SPRINKLER PROTECTIONS WHERE BOTH OF THE FOLLOWING CONDITIONS OCCUR:

1. THE WORK AREA IS REQUIRED TO BE PROVIDED WITH AUTOMATIC SPRINKLER PROTECTION IN ACCORDANCE WITH THE BUILDING CODE OF NEW YORK STATE AS APPLICABLE TO NEW CONSTRUCTION.

2. THE WORK AREA EXCEEDS 50% OF THE FLOOR AREA PROJECT INCLUDES NEW AUTOMATIC SPRINKLER SYSTEM THROUGHOUT THE ENTIRE FIRST AND

SECOND FLOOR.

803.4 FIRE ALARM AND DETECTION AN APPROVED FIRE ALARM SYSTEM SHALL BE INSTALLED IN ACCORDANCE WITH SECTIONS 803.4.1 THROUGH 803.4.3. WHERE AUTOMATIC SPRINKLER PROTECTION IS PROVIDED IN ACCORDANCE WITH SECTION 803.2 AND IS CONNECTED TO THE BUILDING FIRE ALARM SYSTEM, AUTOMATIC HEAT DETECTION SHALL NOTE BE REQUIRED.

AN APPROVED AUTOMATIC FIRE DETECTION SYSTEM SHALL BE INSTALLED IN ACCORDANCE WITH THE PROVISIONS OF THIS CODE AND NFPA 72. DEVICES, COMBINATIONS OF DEVICES, APPLIANCES, AND EQUIPMENT SHALL BE APPROVED. THE AUTOMATIC FIRE DETECTORS SHALL BE SMOKE DETECTORS, EXCEPT THAT AN APPROVED ALTERNATIVE TYPE OF DETECTOR SHALL BE INSTALLED IN SPACES SUCH AS BOILER ROOMS, WHERE PRODUCTS OF COMBUSTION ARE PRESENT DURING NORMAL OPERATION IN SUFFICIENT QUANTITY TO ACTUATE A SMOKE DETECTOR.

EXISTING FIRE ALARM SYSTEM PROVIDED.

SECTION 805 MEANS OF EGRESS

805.1 SCOPE

THE REQUIREMENTS OF THIS SECTION SHALL BE LIMITED TO WORK AREAS THAT INCLUDE EXITS OR CORRIDORS SHARED BY MORE THAN ONE TENANT WITHIN THE WORK AREA IN WHICH LEVEL 2 ALTERATIONS ARE BEING PERFORMED, AND WHERE SPECIFIED THEY SHALL APPLY THROUGHOUT THE FLOOR ON WHICH THE WORK ARES ARE LOCATED OR OTHERWISE BEYOND THE WORK AREA.

OR ELIMINATION OF ANY DOOR OR WINDOW.

SECTION 807 ELECTRICAL

807.3.

807.1 NEW INSTALLATIONS NEWLY INSTALLED ELECTRICAL EQUIPMENT AND WIRING RELATING TO WORK DONE IN ANY WORK AREA SHALL COMPLY WITH ALL APPLICABLE REQUIREMENTS OF NFPA 70 ESCEPT AS PROVIDED FOR IN SECTION

NEW ELECTRICAL WORK COMPLIES WITH SECTION 807.3.

SECTION 808 MECHANICAL

808.2 ALTERED EXISTING SYSTEMS

IN MECHANICALLY VENTILATED SPACES, EXISTING MECHANICAL VENTILATION SYSTEMS THAT ARE ALTERED, RECONFIGURED, OR EXTENDED SHALL PROVIDE NOT LESS THAN 5 CUBIC FEET PER MINUTE (CFM) (0.0024 M3/S) PER PERSON OF OUTDOOR AIR AND NOT LESS THAN 15 CFM (0.0071 M3/S) OF VENTILATION AIR PER PERSON; OR NOT LESS THAN THE AMOUNT OF VENTILATION AIR DETERMINED BY THE INDOOR AIR QUALITY PROCEDURE OF ASHRAE 62.1.

NEW MECHANICAL WORK COMPLIES WITH ASHRAE 62.1.

SECTION 809 PLUMBING

809.1 MINIMUM FIXTURES WHERE THE OCCUPANT LOAD OF THE STORY IS INCREASED BY MORE THAN 20 PERCENT, PLUMBING FIXTURES FOR THE STORY SHALL BE PROVIDED IN QUANTITIES SPECIFIED IN THE PLUMBING CODE OF NEW YORK STATE BASED ON THE INCREASED OCCUPANT LOAD.

NO CHANGE IN OCCUPANT LOAD. PROJECT INCLUDES REPLACING PLUMBING FIXTURES. PLUMBING FIXTURES HAVE BEEN PROVIDED AS PER THE REQUIREMENTS OF THE NEW YORK STATE PLUMBING CODE. SEE CALCULATIONS AND TOTAL NUMBER OF FIXTURES ON THIS SHEET.

SECTION 810 ENERGY CONSERVATION

810.1 MINIMUM REQUIREMENTS

LEVEL 2 ALTERATIONS OT EXISTING BUILDINGS OR STRUCTURES ARE PERMITTED WITHOUT REQUIRING THE ENTIRE BUILDING OR STRUCTURE TO COMPLY WITH THE ENERGY REQUIREMENTS OF THE ENERGY CONSERVATION CONSTRUCTION CODE OF NEW YORK STATE OR RESIDENTIAL CODE OF NEW YORK STATE. THE ALTERATIONS SHALL CONFORM TO THE ENERGY REQUIREMENTS OF THE ENERGY CONSERVATION CONSTRUCTION CODE OF NEW YORK STATE OR RESIDENTIAL CODE OF NEW YORK STATE AS THEY RELATE TO NEW CONSTRUCTION ONLY.

NEW INSULATION AT GARAGE CEILING COMPLIES WITH ASHRAE 90.1.2016 FOR NON RESIDENTIAL MASS FLOORS.

THE INTERIOR FINISH OF WALLS AND CEILINGS IN EXITS AND CORRIDORS IN ANY WORK AREA SHALL

NEW SPRINKLER SYSTEM IS PROVIDED IN ACCORDANCE WITH SECTIONS 803.2.1 THROUGH 803.2.4.

NOT APPLICABLE - PROJECT DOES NOT INCLUDE THE RECONFIGURATION OF SPACE, THE ADDITION

2020 BUILDING CODE OF NEW YORK STATE - ANALYSIS

CHAPTER 3 USE AND OCCUPANCY CLASSIFICATION

304.1 BUSINESS GROUP B: CIVIC ADMINISTRATION - WESTCHESTER COUNTY CLERK OFFICES

CHAPTER 10: MEANS OF EGRESS

SECTION 1003 GENERAL MEANS OF EGRESS

1003.2 CEILING HEIGHT

THE MEANS OF EGRESS SHALL HAVE A CEILING HEIGHT OF NOT LESS THAN 7 FEET 6 INCHES ABOVE THE FINISHED FLOOR.

ACTUAL MINIMUM CEILING HEIGHT: 8 FEET - COMPLIES

1003.3.1 HEADROOM

PROTRUDING OBJECTS ARE PERMITTED TO EXTEND BELOW THE MINIMUM CEILING HEIGHT REQUIRED BY SECTION 1003.2 WHERE A MINIMUM HEADROOM OF 80 INCHES (2032 MM) IS PROVIDED OVER ANY WALKING SURFACE, INCLUDING WALKS, CORRIDORS, AISLES AND PASSAGEWAYS. NOT MORE THAN 50 PERCENT OF THE CEILING AREA OF A MEANS OF EGRESS SHALL BE REDUCED IN HEIGHT BY PROTRUDING OBJECTS.

ACTUAL LIGHT FIXTURE MIN. HEIGHT = 8 FEET - COMPLIES

1003.3.3 HORIZONTAL PROJECTIONS

OBJECTS WITH LEADING EDGES MORE THAN 27 INCHES (685 MM) AND NOT MORE THAN 80 INCHES (2030 MM) ABOVE THE FLOOR SHALL NOT PROJECT HORIZONTALLY MORE THAN 4 INCHES (102 MM) INTO THE CIRCULATION PATH.

1004.1.2 AREAS WITHOUT FIXED SEATING THE NUMBER OF OCCUPANTS SHALL BE COMPUTED AT THE RATE OF ONE OCCUPANT PER UNIT OF AREA AS PRESCRIBED IN TABLE 1004.5.

- BUSINESS 150SF GROSS 1ST FLOOR 12,780 SF ÷ 150 = 85.2 PEOPLE TOTAL OCCUPANCY = 86 NO CHANGE IN USE EGRESS & OCCUPANCY
- BUSINESS 150SF GROSS 2ST FLOOR 14,600 SF ÷ 150 = 97.3 PEOPLE TOTAL OCCUPANCY = 98 NO CHANGE IN USE EGRESS & OCCUPANCY

1005.3.2 OTHER EGRESS COMPONENTS THE CAPACITY, IN INCHES, OF MEANS OF EGRESS COMPONENTS OTHER THAN STAIRWAYS SHALL BE CALCULATED BY MULTIPLYING THE OCCUPANT LOAD SERVED BY SUCH COMPONENT BY A MEANS OF EGRESS CAPACITY FACTOR OF 0.3 INCHES PER OCCUPANT.

SEE DIAGRAM 1 & 2 / G-002

1005.5 DISTRIBUTION OF MINIMUM WIDTH AND REQUIRED CAPACITY

WHERE MORE THAN ONE EXIT, OR ACCESS TO MORE THAN ONE EXIT, IS REQUIRED, THE MEANS OF EGRESS SHALL BE CONFIGURED SUCH THAT THE LOSS OF ANY ONE EXIT, OR ACCESS TO ONE EXIT, SHALL NOT REDUCE THE AVAILABLE CAPACITY OR WIDTH TO LESS THAN 50 PERCENT OF THE REQUIRED CAPACITY OR WIDTH.

FOUR EXISTING EXITS DISTRIBUTED PROPORTIONALLY ALONG THE FLOOR = 25% EACH - COMPLIES

1006.2.1 EGRESS BASED ON OCCUPANT LOAD AND COMMON PATH OF EGRESS TRAVEL DISTANCE TWO EXITS OR EXIT ACCESS DOORWAYS FROM ANY SPACE SHALL BE PROVIDED WHERE THE DESIGN OCCUPANT

LOAD OR THE COMMON PATH OF EGRESS TRAVEL DISTANCE EXCEEDS THE VALUES LISTED IN TABLE 1006.2.1.

TABLE 106.2.1 SPACES WITH ONE EXIT OR EXIT ACCESS DOORWAY B - MAX. OCCUPANCY WITH ONE EXIT = 49

ACTUAL MAX. OCCUPANCY WITH ONE EXIT = 10 - COMPLIES MAX. COMMON TRAVEL DISTANCE = 100' IN BUILDINGS EQUIPPED THROUGHOUT WITH AN AUTOMATIC SPRINKLER SYSTEM

THE VALUES OF TABLE 1006.2.1 ARE NOT EXCEEDED. SEE DIAGRAM 1 / G-002

1009.1 ACCESSIBLE MEANS OF EGRESS PER EXCEPTION 1: ACCESSIBLE MEANS OF EGRESS ARE NOT REQUIRED TO BE PROVIDED IN EXISTING BUILDINGS.

1010.1.1 SIZE OF DOORS

THE REQUIRED CAPACITY OF EACH DOOR OPENING SHALL BE SUFFICIENT FOR THE OCCUPANT LOAD THEREOF AND SHALL PROVIDE A MINIMUM CLEAR WIDTH OF 32 INCHES (813 MM), CLEAR OPENINGS OF DOORWAYS WITH SWINGING DOORS SHALL BE MEASURED BETWEEN THE FACE OF THE DOOR AND THE STOP, WITH THE DOOR OPEN 90 DEGREES 1.57 RAD). WHERE THIS SECTION REQUIRES A MINIMUM CLEAR WIDTH OF 32 INCHES (813 MM) AND A DOOR OPENING INCLUDES TWO DOOR LEAVES WITHOUT A MULLION, ONE LEAF SHALL PROVIDE A CLEAR OPENING WIDTH OF 32 INCHES (813 MM).

SEE DIAGRAM 1 & 2 / G-002

SECTION 1013 - EXIT SIGNS

1013.1 WHERE REQUIRED

EXITS AND EXIT ACCESS DOORS SHALL BE MARKED BY AN APPROVED EXIT SIGN READILY VISIBLE FROM ANY DIRECTION OF EGRESS TRAVEL. THE PATH OF EGRESS TRAVEL TO EXITS AND WITHIN EXITS SHALL BE MARKED BY READILY VISIBLE EXIT SIGNS TO CLEARLY INDICATE THE DIRECTION OF EGRESS TRAVEL IN CASES WHERE THE EXIT OR THE PATH OF EGRESS TRAVEL IS NOT IMMEDIATELY VISIBLE TO THE OCCUPANTS. INTERVENING MEANS OF EGRESS DOORS WITHIN EXITS SHALL BE MARKED BY EXIT SIGNS. EXIT SIGN PLACEMENT SHALL BE SUCH THAT NO POINT IN AN EXIT ACCESS CORRIDOR OR EXIT PASSAGEWAY IS MORE THAN 100 FEET (30 480 MM) OR THE LISTED VIEWING DISTANCE FOR THE SIGN. WHICHEVER IS LESS. FROM THE NEAREST VISIBLE EXIT SIGN.

1017 TRAVEL DISTANCE

TABLE 1017.2 EXIT ACCESS TRAVEL DISTANCE WITH SPRINKLER SYSTEM = 300' ACTUAL FARTHEST TRAVEL = 206' - COMPLIES SEE DIAGRAM 1 / G-002

1020 CORRIDORS

1020.1 CONSTRUCTION CORRIDORS SHALL BE FIRE-RESISTANCE RATED IN ACCORDANCE WITH TABLE 1020.1.

TABLE 1020.1

FOR 'B' OCCUPANCY WITH OCCUPANT LOAD GREATER THAN 30, WITH SPRINKLER SYSTEM: 0 HOUR FIRE RATING IS REQUIRED. SEE DIAGRAM 1 / G-002

1020.2 WIDTH AND CAPACITY THE REQUIRED CAPACITY OF CORRIDORS SHALL BE DETERMINED AS SPECIFIED IN SECTION 1005.1 BUT THE MINIMUM SHALL NOT BE LESS THAN TABLE 1020.2

TABLE 1020.2

OCCUPANCY GROUP B : 44 INCHES ACTUAL MINIMUM WIDTH IS 54"

SEE DIAGRAM 1 / G-002

SECTION 29 PLUMBING SYSTEMS (PER TABLE 2902.1)

1ST FLOOR REQUIRED PLUBMING FIXTURES

WATER CLOSET 1 PER 25 FOR THE FIRST 50 1 PER 50 FOR THE REMAINDER MALE REQUIRED: 2 = (25+18=43) MALE PROVIDED: 2 FEMALE REQUIRED: 2 = (25+18=43) FEMALE PROVIDED: 2

 LAVATORIES 1 PER 40 FOR THE FIRST 80 1 PER 80 FOR THE REMAINDER MALE REQUIRED: 2 = (40+3=43) MALE PROVIDED: 2 FEMALE REQUIRED: 2 = (40+3=43)FEMALE PROVIDED: 2

2ND FLOOR REQUIRED PLUBMING FIXTURES


 WATER CLOSET 1 PER 25 FOR THE FIRST 50 1 PER 50 FOR THE REMAINDER MALE REQUIRED: 2 = (25+24=49) MALE PROVIDED: 2 FEMALE REQUIRED: 2 = (25+24=49)FEMALE PROVIDED: 3

 LAVATORIES 1 PER 40 FOR THE FIRST 80 1 PER 80 FOR THE REMAINDER MALE REQUIRED: 2 = (40+3=43)MALE PROVIDED: 3 FEMALE REQUIRED: 2 = (40+3=43)FEMALE PROVIDED: 2

 PROVIDED UNISEX RESTROOMS = 3 **PROVIDED WATER CLOSET: 3 PROVIDED LAVATORIES: 3**

	WATER O	CLOSETS	LAVATORIES		
LOCATION	REQUIRED	PROVIDED	REQUIRED	PROVIDED	
1ST FL MALE	2	2	2	2	
1ST FL FEMALE	2	2	2	2	
2ND FL MALE	2	2	2	3	
2ND FL FEMALE	2	3	2	2	
2ND FL UNISEX		3		3	

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LOW RISE BUILDING RENOVATIONS AND HVAC IMPR 110 DR. MARTIN LUTHER KING, JR. BOU WHITE PLAINS, NEW YORK				JR. BOU		SCALE: DATE: 01-19-2024	Issue Date	
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[F]TABLE 906.3(1) FIRE EXTINGUISHERS FOR CLASS A FIRE HAZARDS LIGHT (LOW) HAZARD OCCUPANCY MINIMUM RATED SINGLE EXTINGUISHER 2-AC

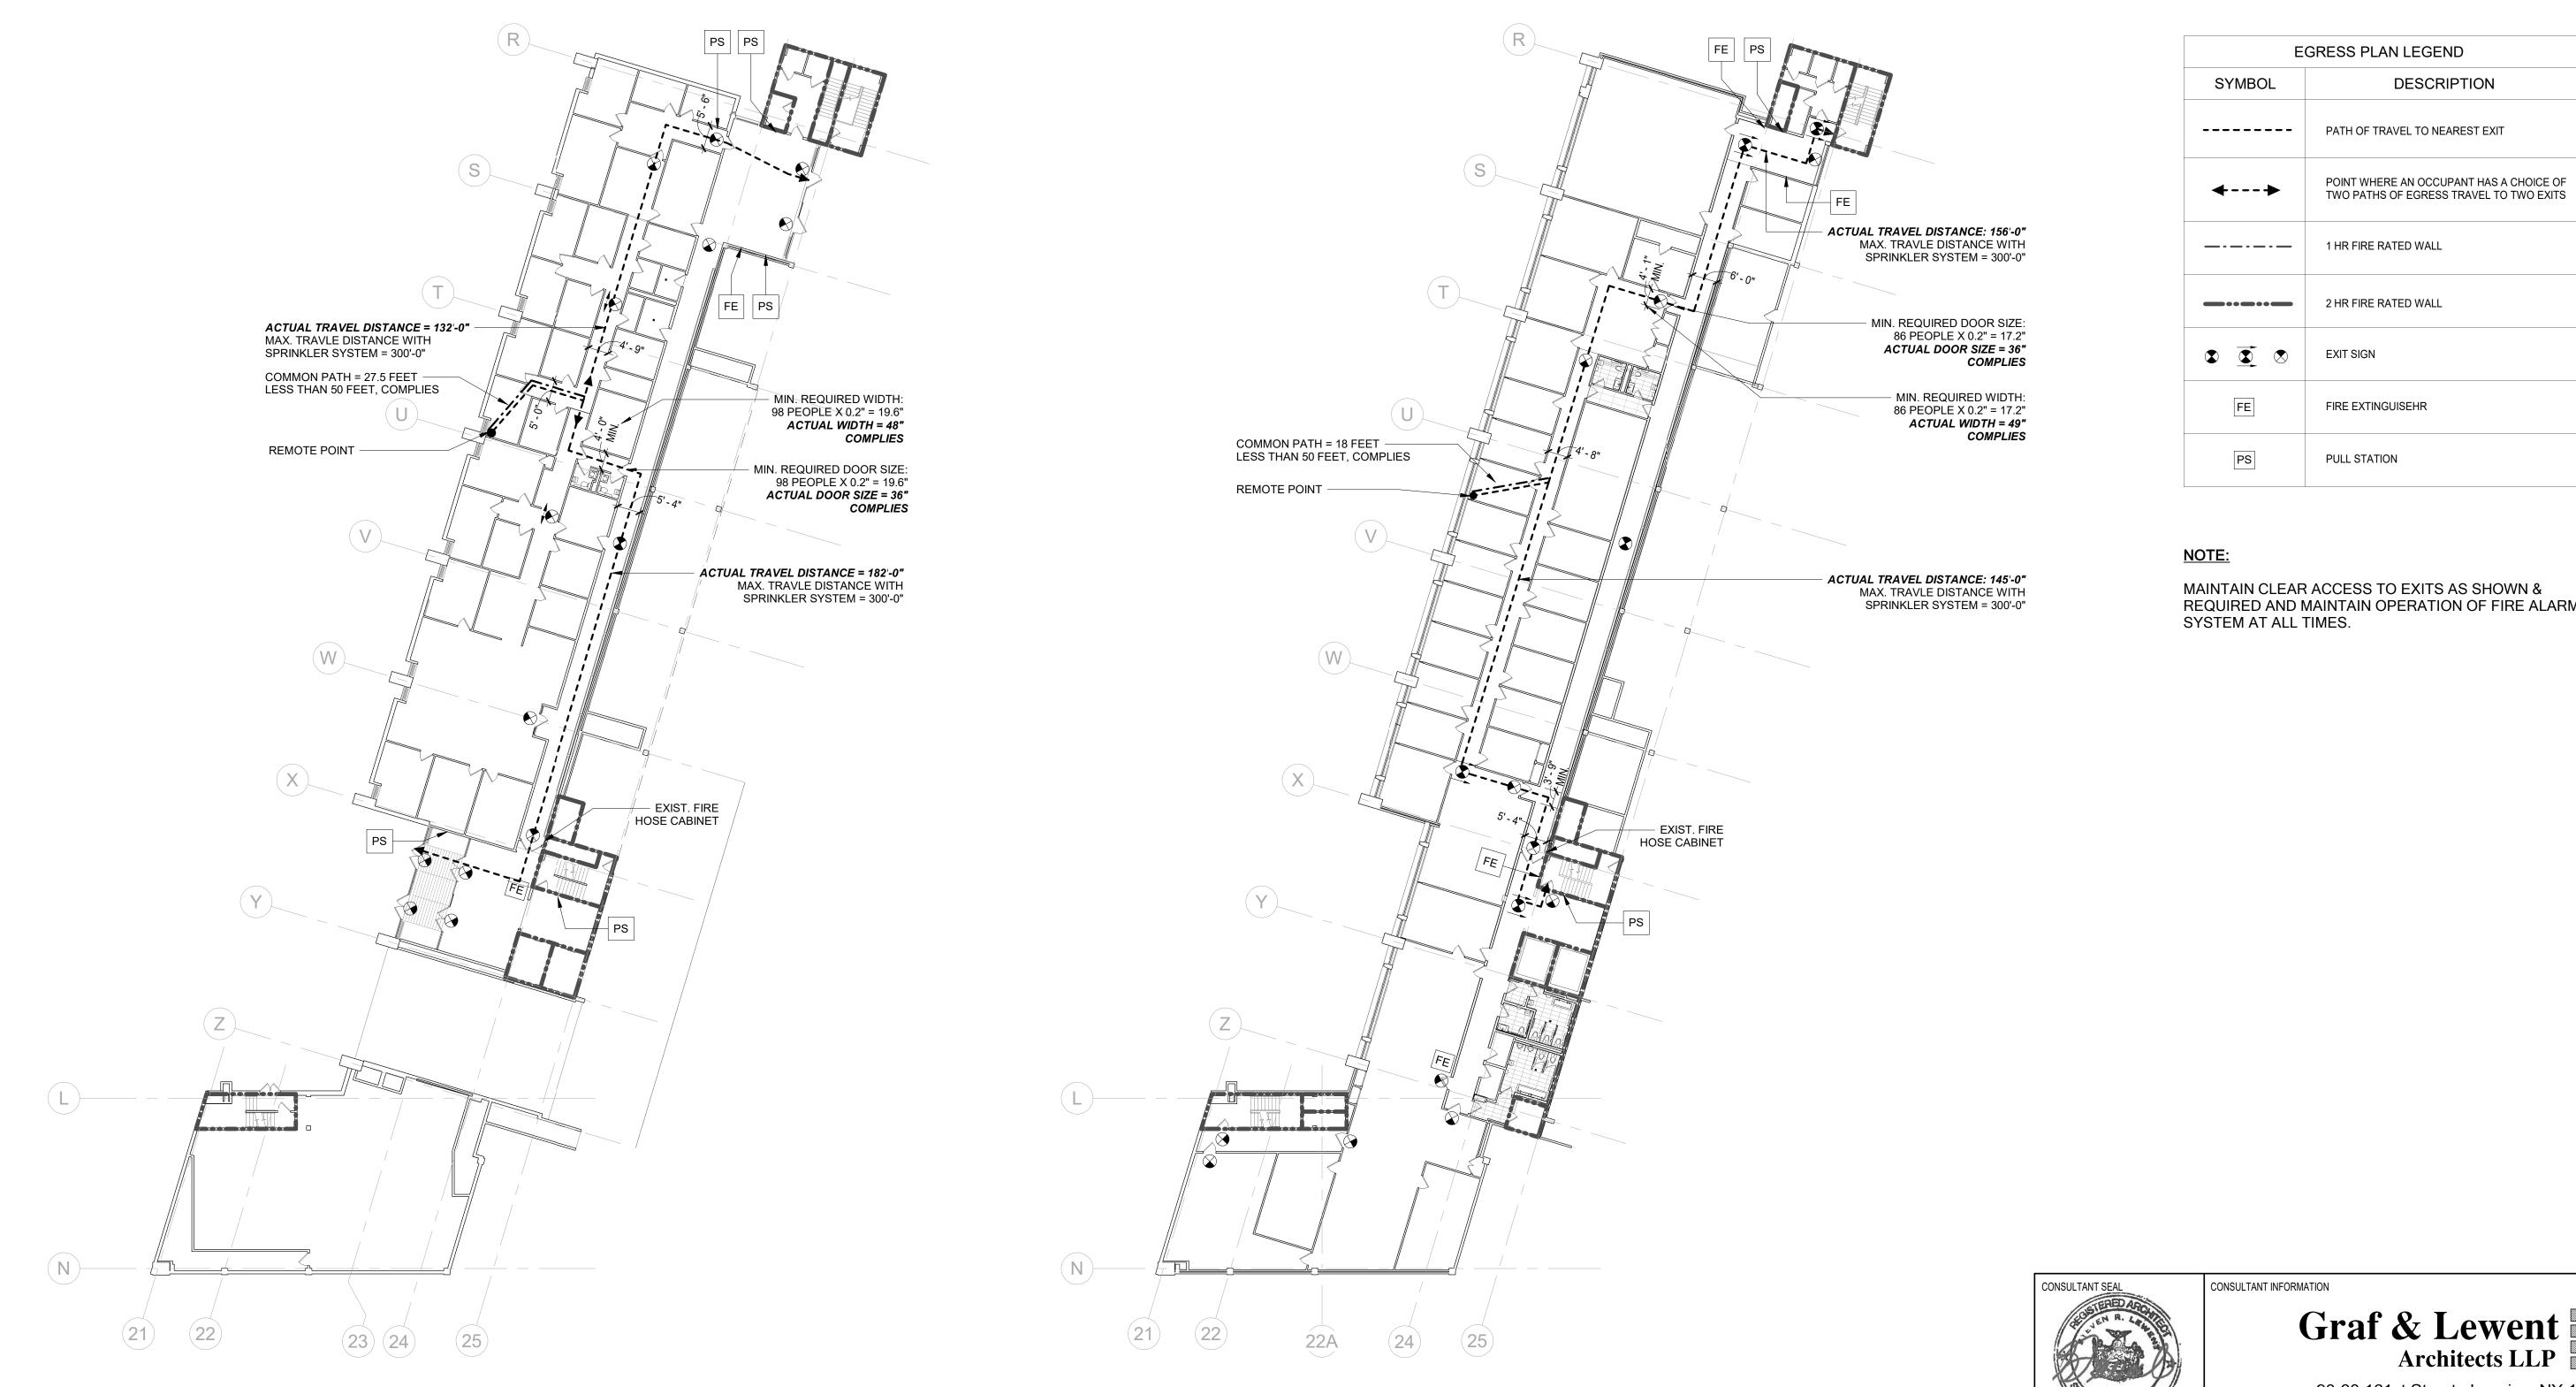MAXIMUM FLOOR AREA PER UNIT OF A 3,000 SQUARE FEET MAXIMUM FLOOR AREA FOR EXTINGUISHER 11,250 SQUARE FEET MAXIMUM DISTANCE OF TRAVEL TO EXTINGUISHER 75 FEET




2 EGRESS & FIRE RATING PLAN - 2ND FLOOR 1" = 20'-0"



REQUIRED AND MAINTAIN OPERATION OF FIRE ALARM

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AFTER RESTORE TAX ASSESSOR OFFICE EXIST. WALL PATCH & REPAIR AFTER TEMP. PARTITION REMOVAL

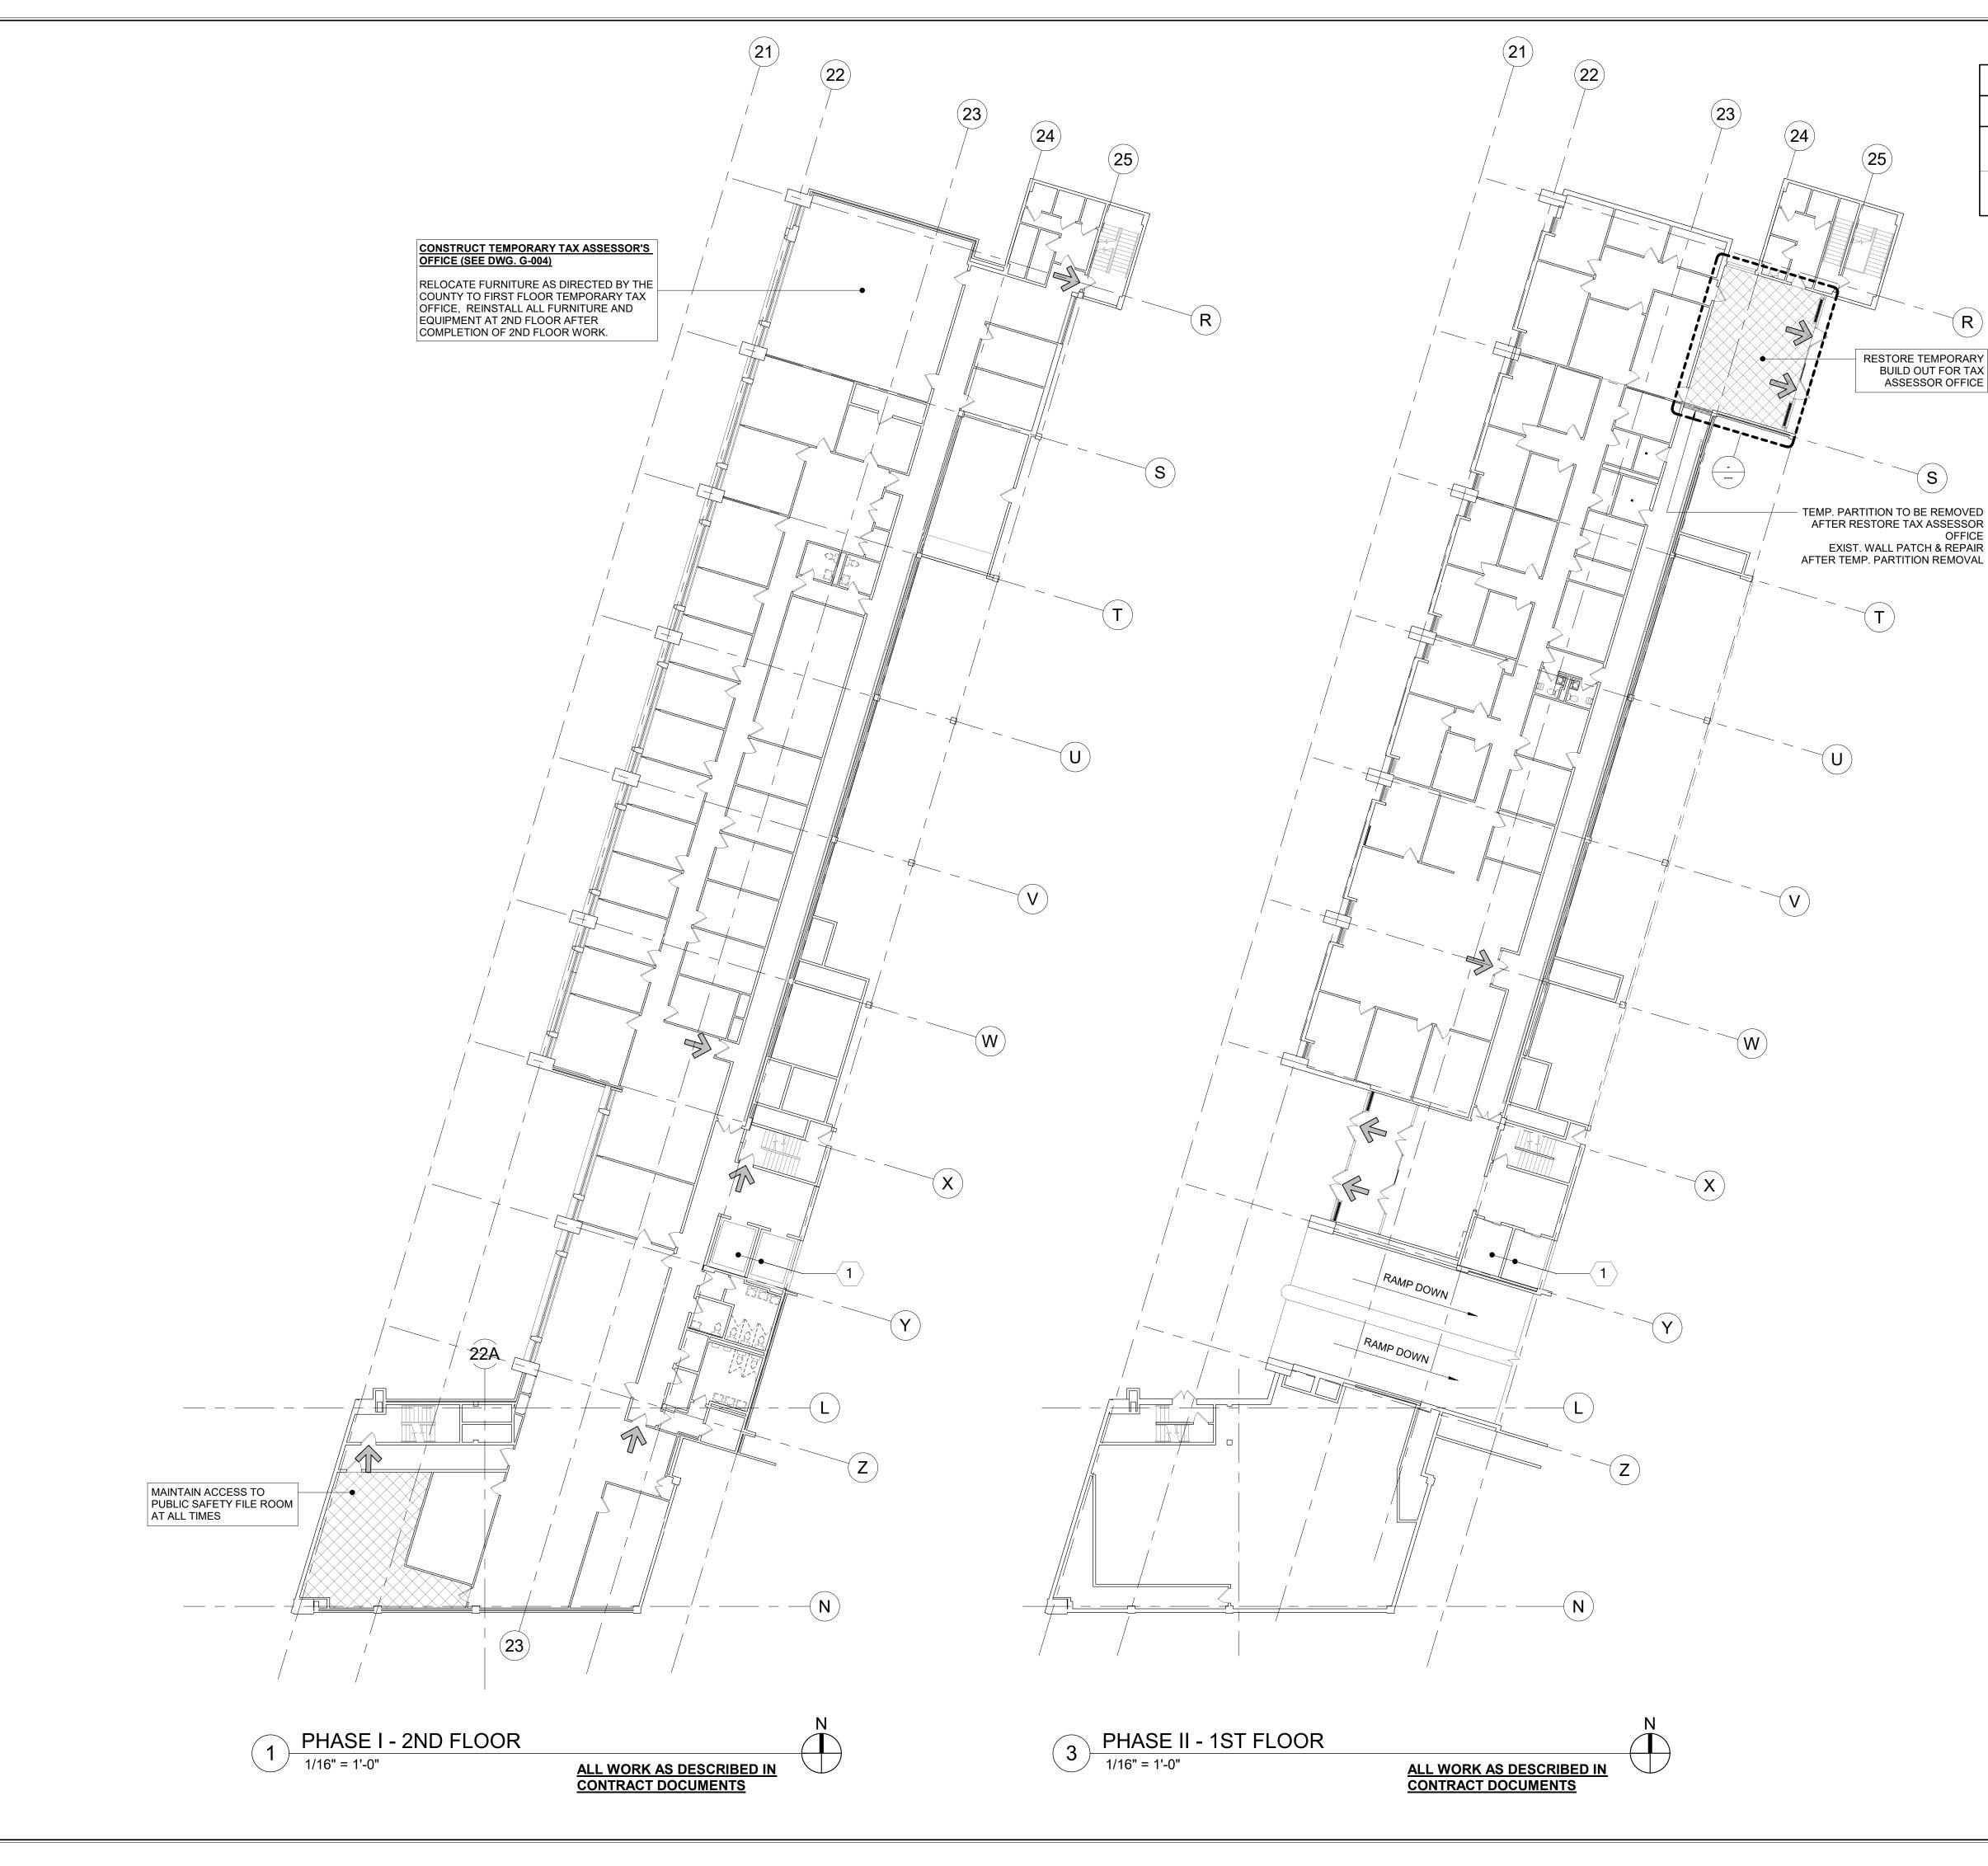GENERAL NOTES:

PHASING PLAN LEGEND

RENOVATION

EXIT

SYMBOL

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DESCRIPTION

TEMPORARY PARTITION FOR EGRESS DURING CORRIDOR

- 1. THE CONTRACTOR PRIOR TO START OF ANY FIELD WORK, SHALL PREPARE LOGISTICS PLAN SHOWING THE FOLLOWING:
 - * DUST MITIGATION
 - PROCEDURE FOR NEGATIVE AIR AND * HEPA FANS WITH EXTERIOR EXHAUST IN ORDER PREVENT CONTAMINATION OF ADJACENT WORK AREA.
 - * INGRESS AND EGRESS PATHS FOR CONSTRUCTION DEBRIS, WORKERS AND MATERIALS.
 - NOISE PLAN IN ORDER TO AVOID * DISRUPTION TO ADJACENT OCCUPIED AREAS.
 - CONSTRUCTION WALLS, DOORS AND * STICKY MATS AT CONSTRUCTION ENTRANCES.
 - TEMPORARY SIGNAGE TO DIRECT * TRAFFIC AND EGRESS.
- 2. EGRESS PATH TO EXISTING EXITS TO BE MAINTAINED DURING CONSTRUCTION.
- ABATEMENT OF ASBESTOS CONTAINING 3. FLOORING MATERIAL MUST BE PERFORMED IN ADVANCE OF CONSTRUCTION OF AFFECTED AREAS IN EACH PHASE.
- RETOUCH ALL REMAINING DAMAGED WORK 4. RESULTING FROM PHASING OF CONSTRUCTION IN ENTIRE FLOOR.
- 5. CONTRACTOR SHALL ASSUME A 2-WEEK INTERVAL BETWEEN PHASES TO RELOCATE STAFF AND EQUIPMENT.
- ALL ELEVATOR RENOVATIONS IN 110 MLK, 6 111 MLK, AND 143 GRAND STREET TO OCCUR CONCURRENTLY WITH PHASE I.
- SWING SPACE TO BE LOCATED IN 7. BASEMENT, 85 COURT STREET. PROVIDE & MAINTAIN 4 PORTABLE AIR PURIFIERS FOR SWING SPACE DURING THE ENTIRE PROJECT.
- MAINTAIN ALL HVAC SERVICES TO THE 8 OCCUPIED SECTIONS.
- ALL WORK REQUIRED IN GARAGE TO BE 9. SCHEDULED WITH THE COUNTY.
- 10. WORK SHOWN ON ENGINEERING DRAWINGS TO BE COORDINATED WITH THIS PHASING PLAN.

PHASING PLAN KEY NOTES:

ONE ELEVATOR TO REMAIN IN OPERATION AT ALL TIMES.

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CONSTRUCTION PLAN - 1ST FLOOR - TEMPORARY TAX OFFICE 1 1/4" = 1'-0"

CONSTRUCTION PLAN LEGEND SYMBOL DESCRIPTION DESCRIPTION SYMBOL - TEMPORARY LOW PARTITION I EXISTING COLUMNS TO REMAIN (WITH OR WITHOUT STEEL PROFILE) PARTITION TYPE: SEE DETAIL ON 3/G-004 EXISTING PARTITIONS / WALLS TEMPORARY DOOR AND FRAME - DOOR TYPE INDICATION EXISTING DOOR & DOOR FRAME TO WOOD DOOR: 3'-0"W x 6'-8"H, FACTORY FINISH WITH HOLLOW METAL FRAMES REMAIN SHALL RECEIVE PAINT FINISH WHERE FACING AREA OF WORK EXCEPT NATURAL WOOD DOOR PAINT FINISH. HARDWARE: F104 (OFFICE) LOCK SET, 3 BUTT HINGES, FLÒOR STÓP AND - EXISTING STOREFRONT STSTEM (VIF) WITHOUT HOLD OPEN CLOSER. EXISTING WALL (VIF) NOTE: DOOR SHALL BE OPENABLE - EXISTING RADIATOR (VIF) FROM OCCUPIED SIDE AT ALL TIMES.

GENERAL NOTES:

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- 1. THIS WORK TO BE PERFORMED AT THE START OF PHASE I.
- 2. ALL WORK ON FLOORS BELOW OR ABOVE AND IN ADJACENT AREAS THAT ARE DISTURBED OR DAMAGED DUE TO WORK RELATED TO THIS PROJECT SHALL BE REPAIRED TO MATCH PREVIOUS UNDAMAGED CONDITIONS.

POWER & COMMUNICATIONS PLAN - 1ST FLOOR - TEMPORARY TAX OFFIC (2) 1/4" = 1'-0"


NOTE: NO CHANGE TO EXISTING CEILING DURING THIS PHA

S	FURNITURE SCHEDULE - TEMPOR										
	TYPE MARK	COUNT	DESCRIPTION								
	C1-E	2	TASK CHAIR WITH ARMS								
ND	C2-E	1	TASK CHAIR WITH NO ARMS								
	S1-E	5	28" x 18" FILE CABINET								
	S2-E	8	30" x 16" STORAGE CABINET								
	S3-E	2	40" x 20" STORAGE CABINET								
	TB-E	1	60" x 36" TABLE								
	WKST-E	2	72" x 60" MODULAR WORK STATION								

NOTE: ALL FURNITURES ARE EXISTING.

POWER & COMMUNICATIONS PLAN LEGEND								
SYMBOL	DESCRIPTION							
ш⊕	EXISTING WALL MOUNTED QUAD OUTLET							
E	EXISTING WALL MOUNTED DATA AND COMMUNICATIONS OUTLET							
	WALL MOUNTED DUPLEX OUTLET							
	WALL MOUNTED DATA AND COMMUNICATIONS OUTLET							

(24)				
	(25)			
G1046				
G1045				
	STAIR #1	77		
	SG-1 (G1044)			
		/		
ELEC/TEL/JAN. CLOSET				
G-01 (G1042)				
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S. F.				
				CEILING +/- 10'-6"
			METAL STUD WIT	ГН БҮР.
			BD. ENCLOS CEILING WHERE	
			1 LAYER GYPSUM	
			PARTITION CA	
			TAPE & SPACKLE S BOTH SIDE OF PAR	
S33H S33H			DOUBLE 3 5/8"	' METAL
O)			STUD HEAD F	
	LHT IGHT		1 LAYER GYPSUM	
	2-0" LOW PARTITION HEIGHT		ON BOTH SIDE	S (TYP.)
			3 5/8" METAL ST 16" O.C. SPACINO	
	M PA		1 LAYER GYPSUM	
	C 		ON BOTH SIDE	
	Ň		METAL R	
			FASTEN TO EXT	
			4" VINYL BAS	
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	1ST FLOOR NORTH WING			DPW FILE NO. REV 52-11-G-1818-0

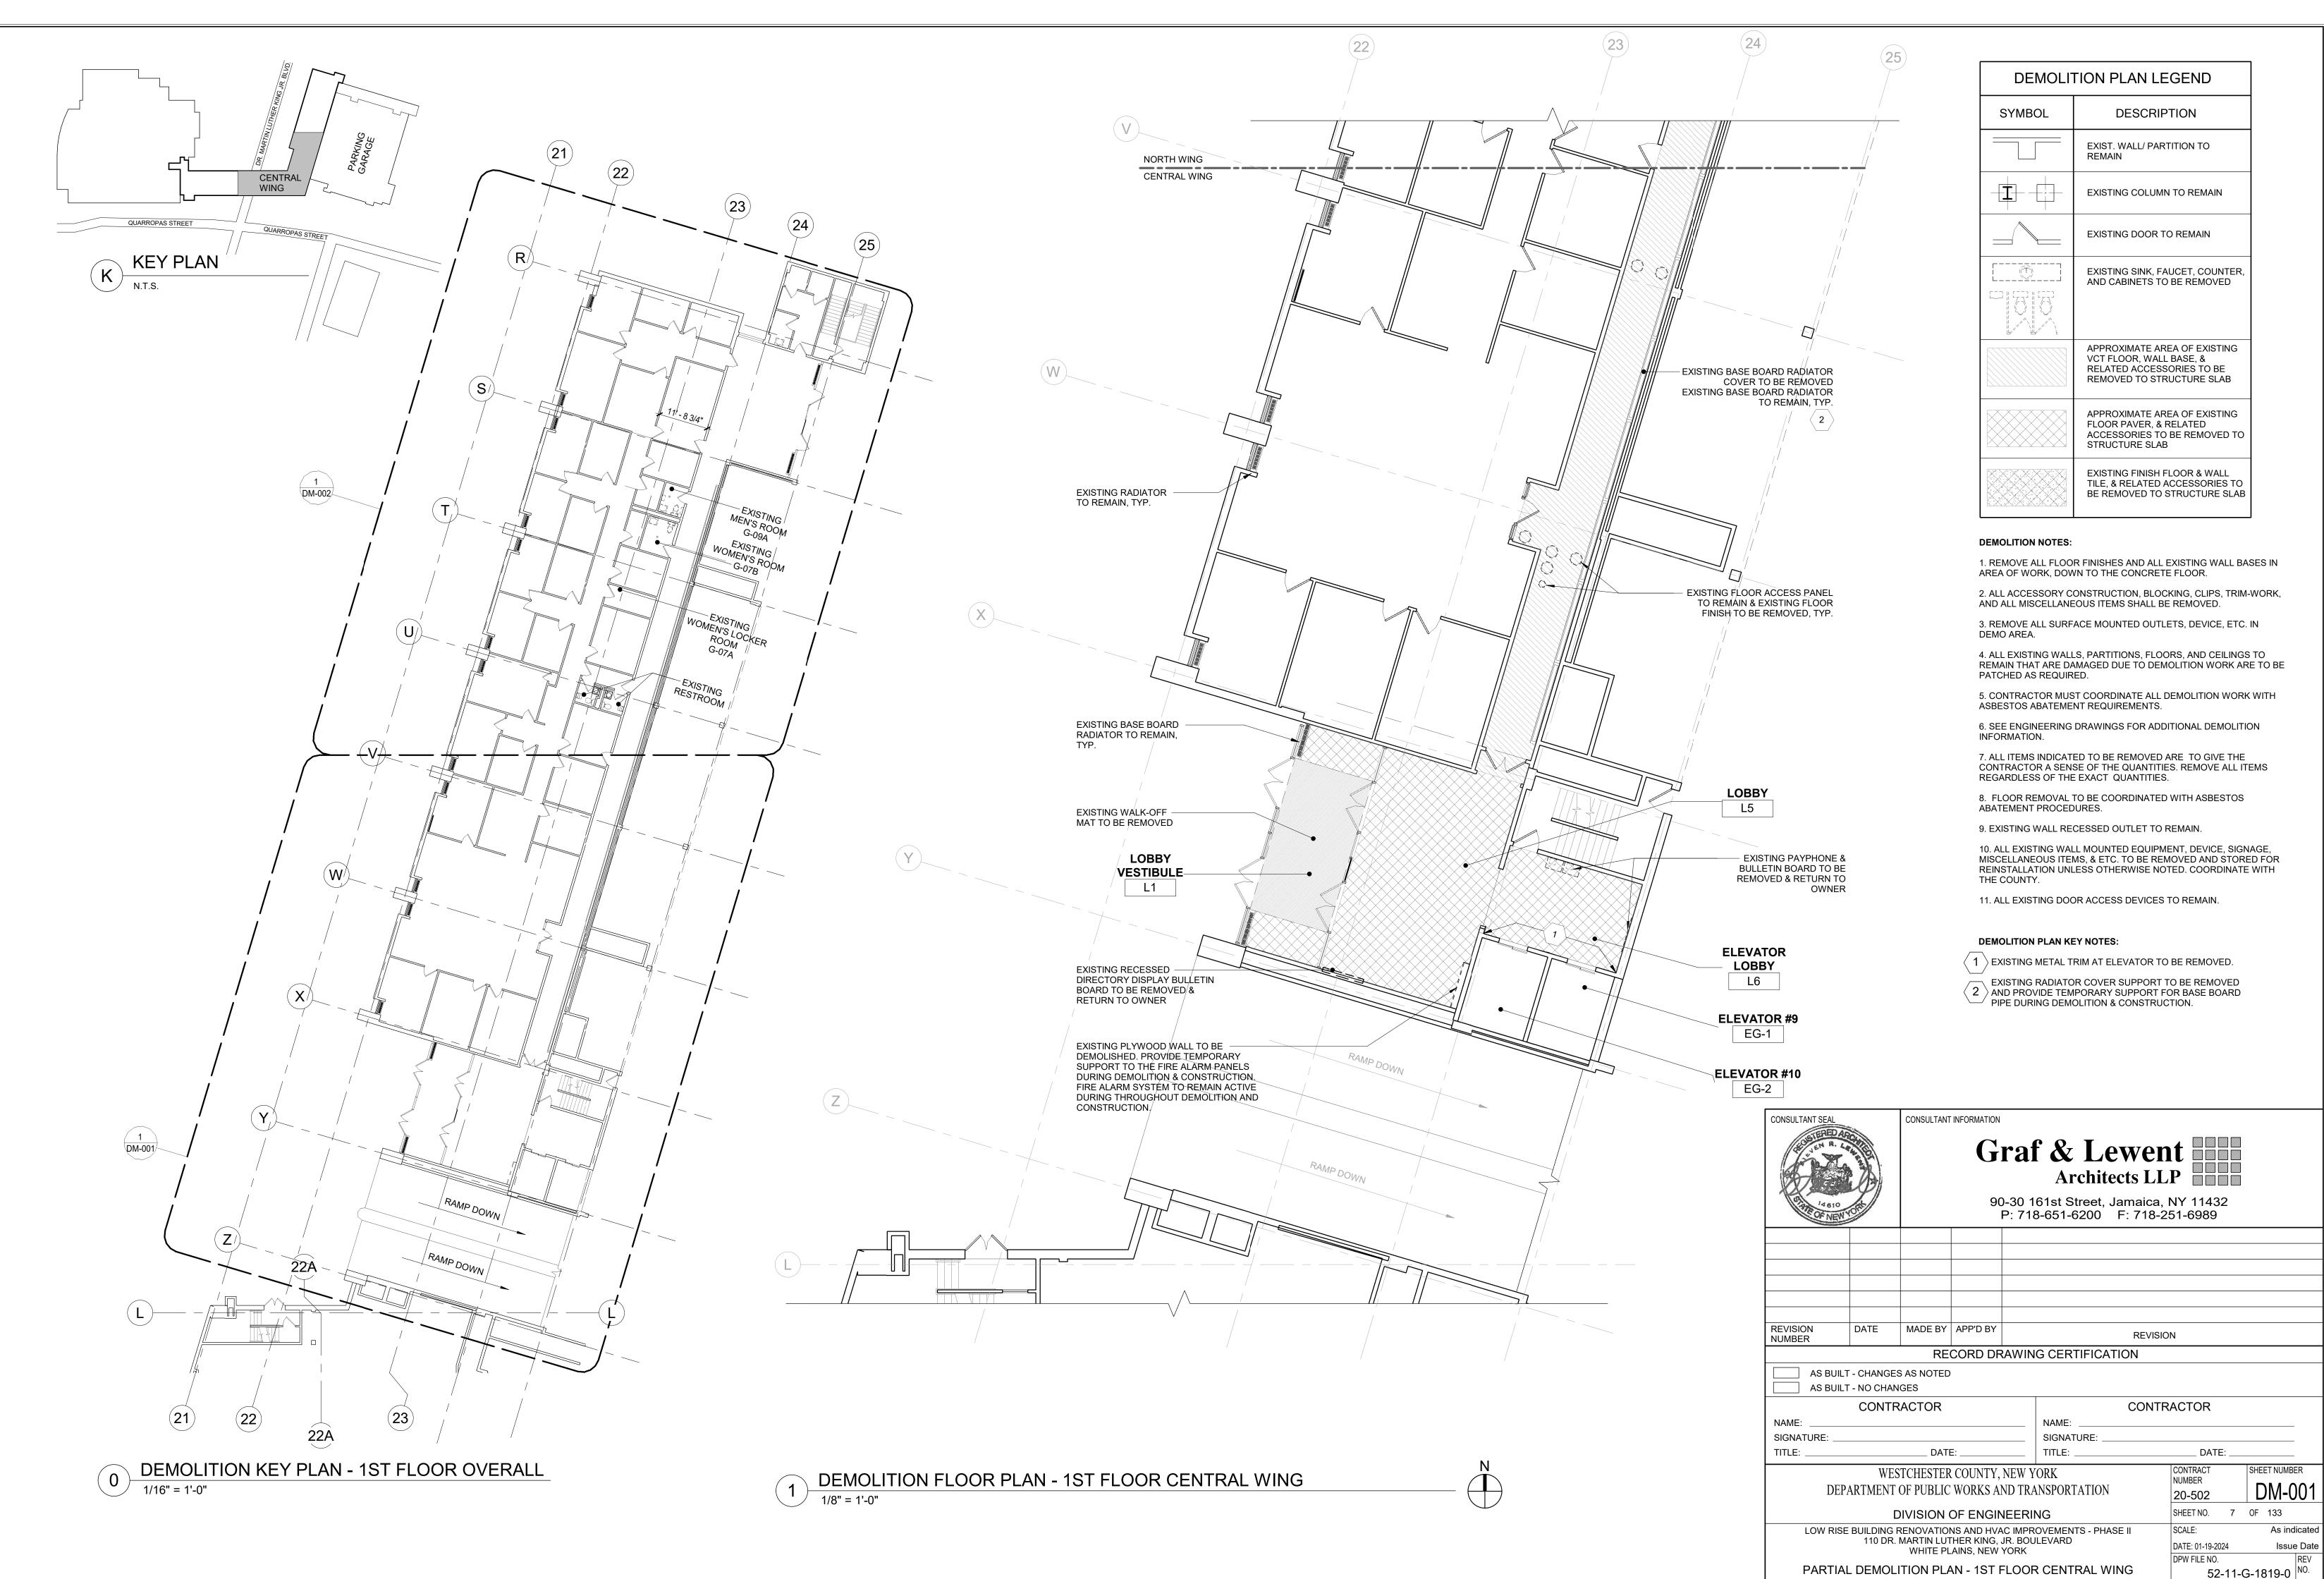


QUARROPAS STREET QUARROPAS STREF KEY PLAN KEY PLAN

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STAIR #1

SG-1 TO REMAIN

PANEL TO REMAIN & EXISTING FLOOR FINISH

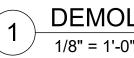TO REMAIN

DEMOLITION PLAN LEGEND DESCRIPTION SYMBOL EXIST. WALL/ PARTITION TO REMAIN **__**___ EXISTING COLUMN TO REMAIN EXISTING DOOR TO REMAIN EXISTING SINK, FAUCET, COUNTER, AND CABINETS TO BE REMOVED L______ APPROXIMATE AREA OF EXISTING VCT FLOOR, WALL BASE, & RELATED ACCESSORIES TO BE REMOVED TO STRUCTURE SLAB $\langle X X \rangle$ APPROXIMATE AREA OF EXISTING FLOOR PAVER, & RELATED ACCESSORIES TO BE REMOVED TO STRUCTURE SLAB EXISTING FINISH FLOOR & WALL TILE, & RELATED ACCESSORIES TO BE REMOVED TO STRUCTURE SLAB

DEMOLITION NOTES:

1. REMOVE ALL FLOOR FINISHES AND ALL EXISTING WALL BASES IN AREA OF WORK, DOWN TO THE CONCRETE FLOOR.

2. ALL ACCESSORY CONSTRUCTION, BLOCKING, CLIPS, TRIM-WORK, AND ALL MISCELLANEOUS ITEMS SHALL BE REMOVED.

3. REMOVE ALL SURFACE MOUNTED OUTLETS, DEVICE, ETC. IN DEMO AREA.

4. ALL EXISTING WALLS, PARTITIONS, FLOORS, AND CEILINGS TO REMAIN THAT ARE DAMAGED DUE TO DEMOLITION WORK ARE TO BE PATCHED AS REQUIRED.

5. CONTRACTOR MUST COORDINATE ALL DEMOLITION WORK WITH ASBESTOS ABATEMENT REQUIREMENTS.

6. SEE ENGINEERING DRAWINGS FOR ADDITIONAL DEMOLITION INFORMATION.

7. ALL ITEMS INDICATED TO BE REMOVED ARE TO GIVE THE CONTRACTOR A SENSE OF THE QUANTITIES. REMOVE ALL ITEMS REGARDLESS OF THE EXACT QUANTITIES.

8. FLOOR REMOVAL TO BE COORDINATED WITH ASBESTOS ABATEMENT PROCEDURES.

9. EXISTING WALL RECESSED OUTLET TO REMAIN.

10. ALL EXISTING WALL MOUNTED EQUIPMENT, DEVICE, SIGNAGE, MISCELLANEOUS ITEMS, & ETC. TO BE REMOVED AND STORED FOR REINSTALLATION UNLESS OTHERWISE NOTED. COORDINATE WITH THE COUNTY.


11. ALL EXISTING DOOR ACCESS DEVICES TO REMAIN.

DEMOLITION PLAN KEY NOTES:

C EXISTING RADIATOR COVER SUPPORT TO BE REMOVED $\langle 1 \rangle$ and provide temporary support for base board └──∕ PIPE DURING FINISH FLOOR DEMOLITION.

2 PROTECT EXISTING PLUMBING FIXTURES, ACCESSORIES, & ETC. DURING DEMOLITION.

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LOW RISE BUILDING RENOVATIONS AND HVAC IMPRO 110 DR. MARTIN LUTHER KING, JR. BOUL WHITE PLAINS, NEW YORK							SCALE: DATE: 01-19-2024	1/8" = 1'-0" Issue Date
PARTIA	L DEMOI	LITION PL	.AN - 1ST	FLOO	R NORTH WING		DPW FILE NO. 52-11-	G-1820-0

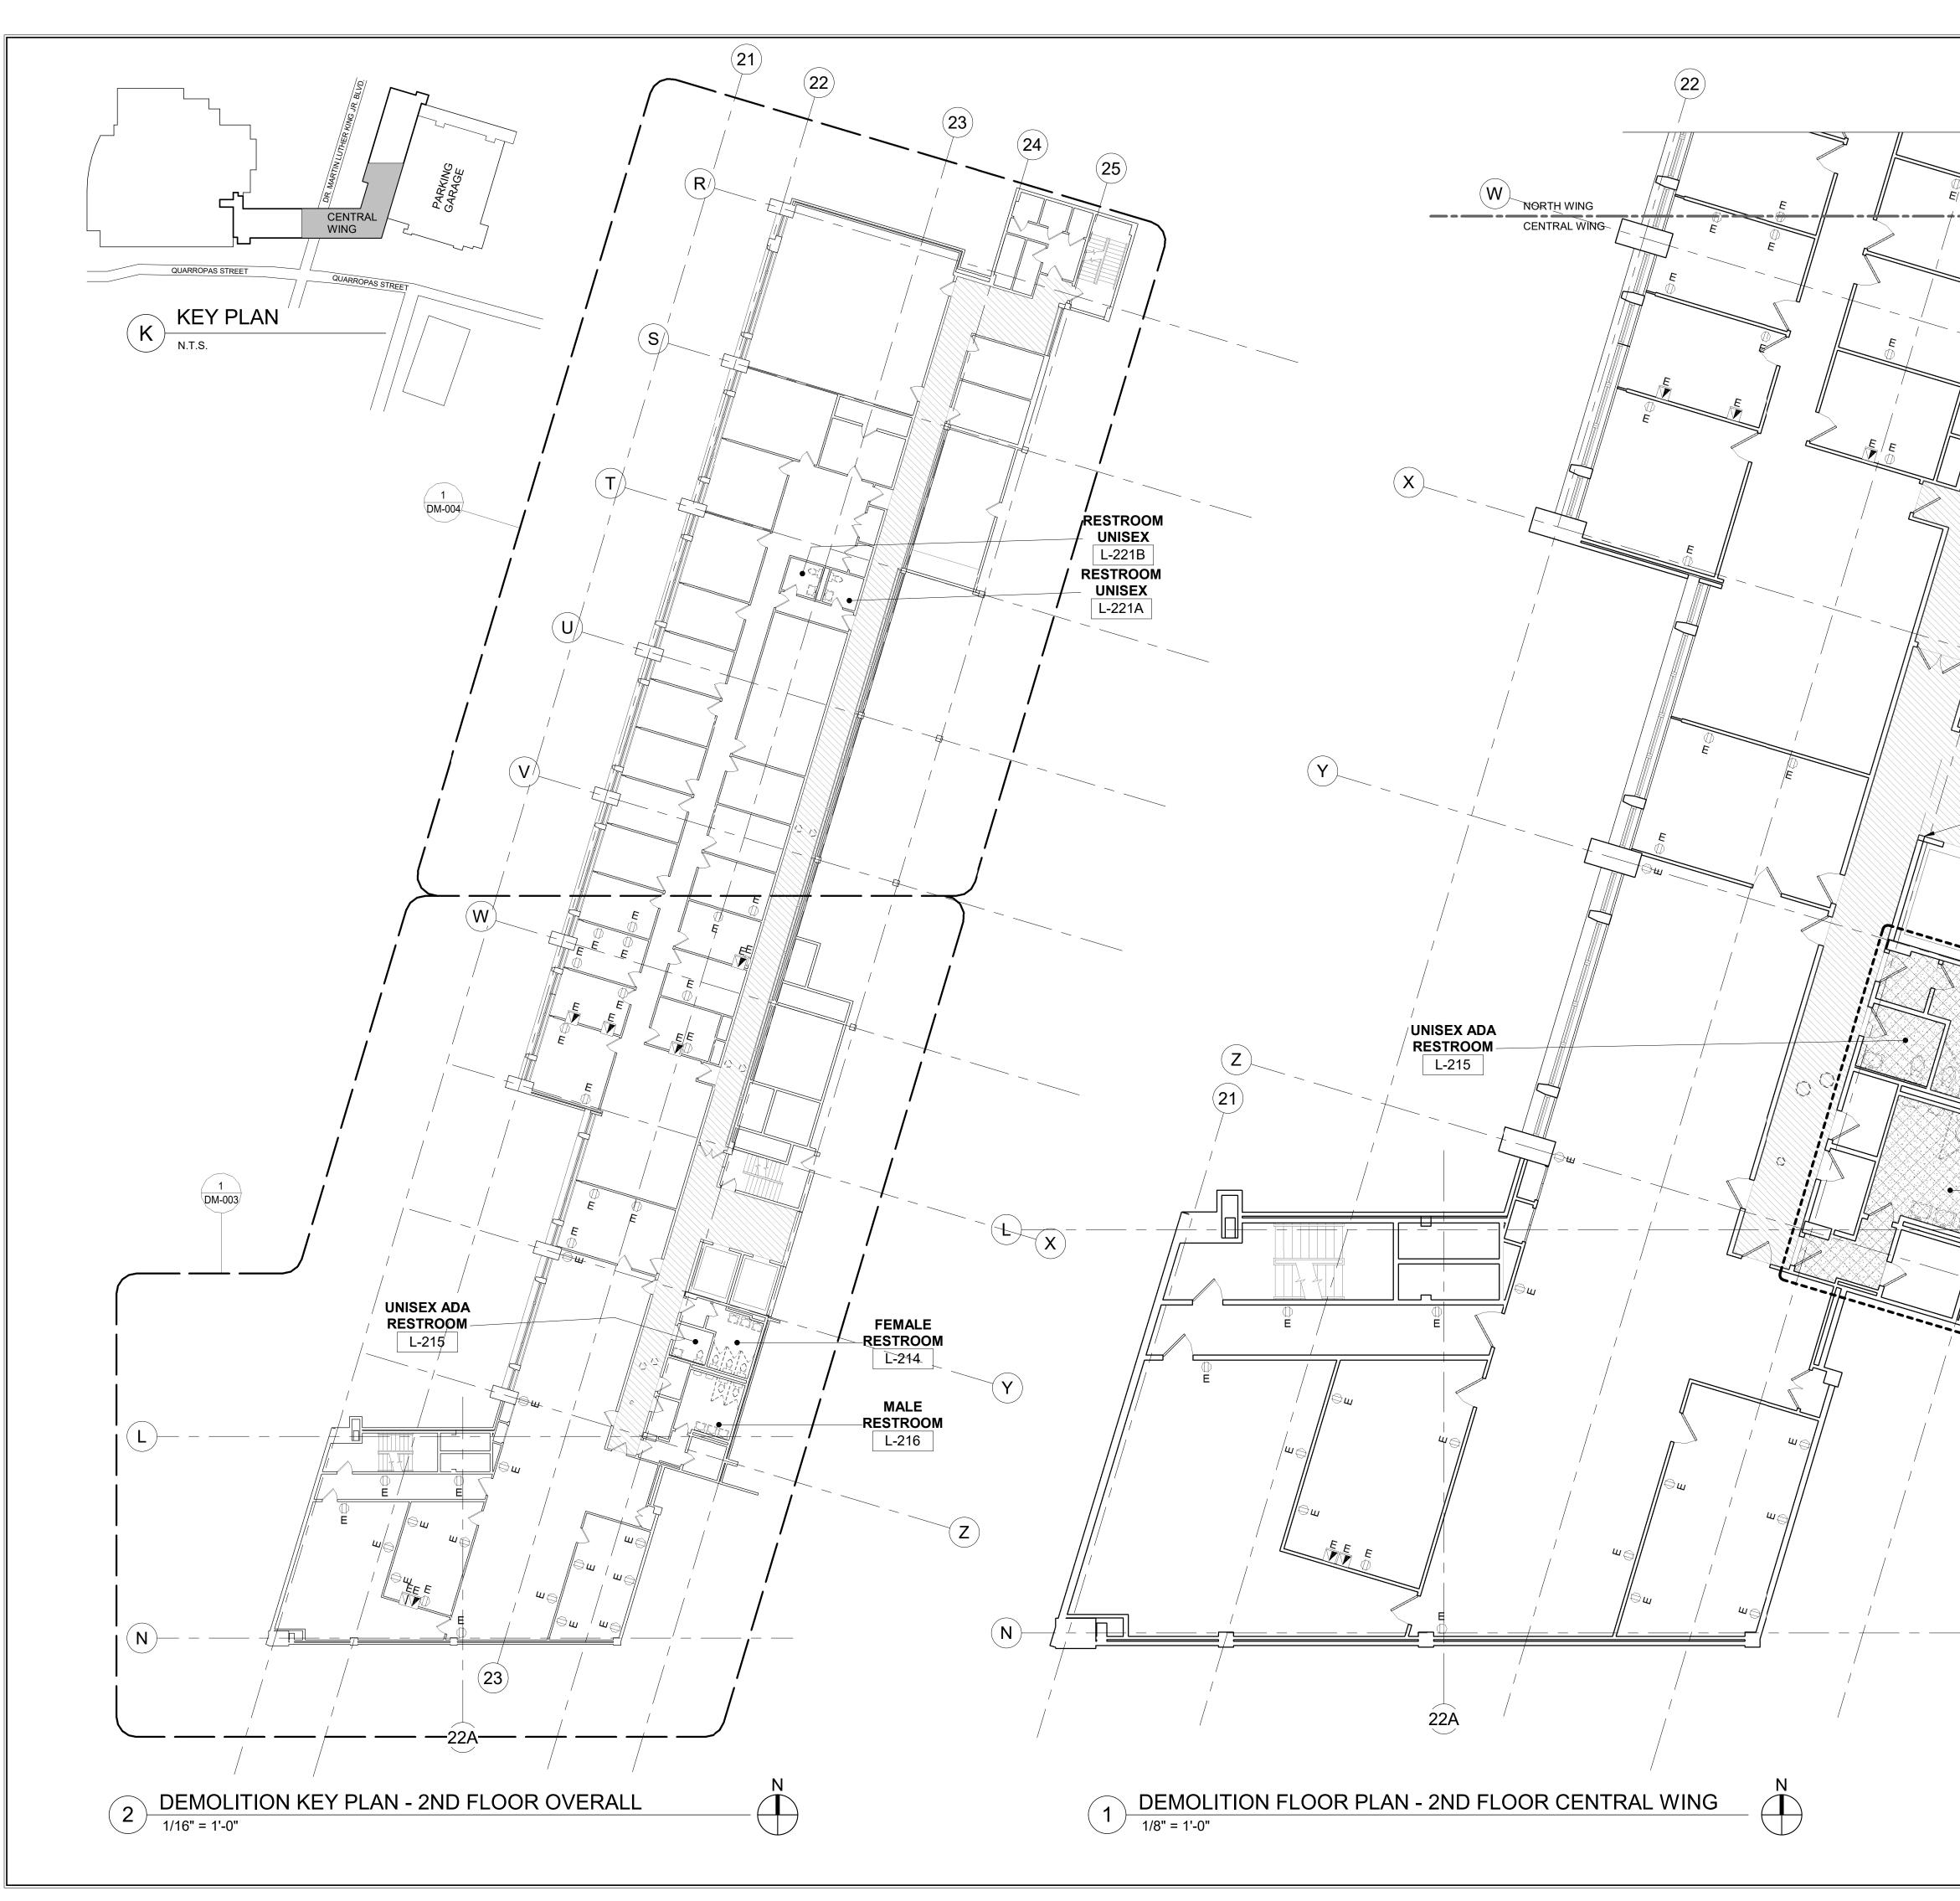

(24) (25) (23) _____ EXISTING BASE BOARD RADIATOR COVER TO BE REMOVED EXISTING BASE BOARD RADIATOR TO REMAIN, TYP. **⟨ 2 ⟩** - EXISTING FLOOR ACCESS PANEL TO **REMAIN & EXISTING** FLOOR FINISH TO BE REMOVED, TYP. **DEMOLITION NOTES:** DEMO AREA. PATCHED AS REQUIRED. INFORMATION. -----ABATEMENT PROCEDURES. FEMALE RESTROOM THE COUNTY. L-214 DEMOLITION PLAN KEY NOTES: DM-009 MALE -RESTROOM L-216 ••••• _____

DEMOLITION PLAN LEGEND							
SYMBOL	DESCRIPTION						
	EXIST. WALL/ PARTITION TO REMAIN						
	EXISTING COLUMN TO REMAIN						
	EXISTING DOOR TO REMAIN						
	EXISTING SINK, FAUCET, COUNTER, AND CABINETS TO BE REMOVED						
	APPROXIMATE AREA OF EXISTING VCT FLOOR, WALL BASE, & RELATED ACCESSORIES TO BE REMOVED TO STRUCTURE SLAB						
	APPROXIMATE AREA OF EXISTING FLOOR PAVER, & RELATED ACCESSORIES TO BE REMOVED TO STRUCTURE SLAB						
	EXISTING FINISH FLOOR & WALL TILE, & RELATED ACCESSORIES TO BE REMOVED TO STRUCTURE SLAB						

1. REMOVE ALL FLOOR FINISHES AND ALL EXISTING WALL BASES IN AREA OF WORK, DOWN TO THE CONCRETE FLOOR.

2. ALL ACCESSORY CONSTRUCTION, BLOCKING, CLIPS, TRIM-WORK, AND ALL MISCELLANEOUS ITEMS SHALL BE REMOVED.

3. REMOVE ALL SURFACE MOUNTED OUTLETS, DEVICE, ETC. IN

4. ALL EXISTING WALLS, PARTITIONS, FLOORS, AND CEILINGS TO REMAIN THAT ARE DAMAGED DUE TO DEMOLITION WORK ARE TO BE

5. CONTRACTOR MUST COORDINATE ALL DEMOLITION WORK WITH ASBESTOS ABATEMENT REQUIREMENTS.

6. SEE ENGINEERING DRAWINGS FOR ADDITIONAL DEMOLITION

7. ALL ITEMS INDICATED TO BE REMOVED ARE TO GIVE THE CONTRACTOR A SENSE OF THE QUANTITIES. REMOVE ALL ITEMS REGARDLESS OF THE EXACT QUANTITIES.

8. FLOOR REMOVAL TO BE COORDINATED WITH ASBESTOS

9. EXISTING WALL RECESSED OUTLET TO REMAIN.

10. ALL EXISTING WALL MOUNTED EQUIPMENT, DEVICE, SIGNAGE, MISCELLANEOUS ITEMS, & ETC. TO BE REMOVED AND STORED FOR REINSTALLATION UNLESS OTHERWISE NOTED. COORDINATE WITH


11. ALL EXISTING DOOR ACCESS DEVICES TO REMAIN.


 $\langle 1 \rangle$ EXISTING METAL TRIM AT ELEVATOR TO BE REMOVED.

EXISTING RADIATOR COVER SUPPORT TO BE REMOVED AND PROVIDE TEMPORARY SUPPORT FOR BASE BOARD PIPE DURING FINISH FLOOR DEMOLITION.

CONSULTANT SEAL	CONSULTANT INFORMATION							
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REVISION NUMBER	DATE	MADE BY	APP'D BY		RE	VISION		
		RE	CORD DF	AWIN	G CERTIFICATION			
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	CONTR	RACTOR			CONTRACTOR			
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DEPARTMENT OF PUBLIC WORKS AND TRA					NSPORTATION	20-502	DM-003	
DIVISION OF ENGINEERI					NG	SHEET NO. 9	OF 133	
LOW RISE BUILDING RENOVATIONS AND HVAC IMPR						SCALE:	As indicated	
110 DR. MARTIN LUTHER KING, JR. BOU WHITE PLAINS, NEW YORK					LEVARU	DATE: 01-19-2024	Issue Date	
PARTIAL DEMOLITION PLAN - 2ND FLOOI					R CENTRAL WING	DPW FILE NO. 52-11-0	G-1821-0	

QUARROPAS STREET QUARROPAS STRE K KEY PLAN

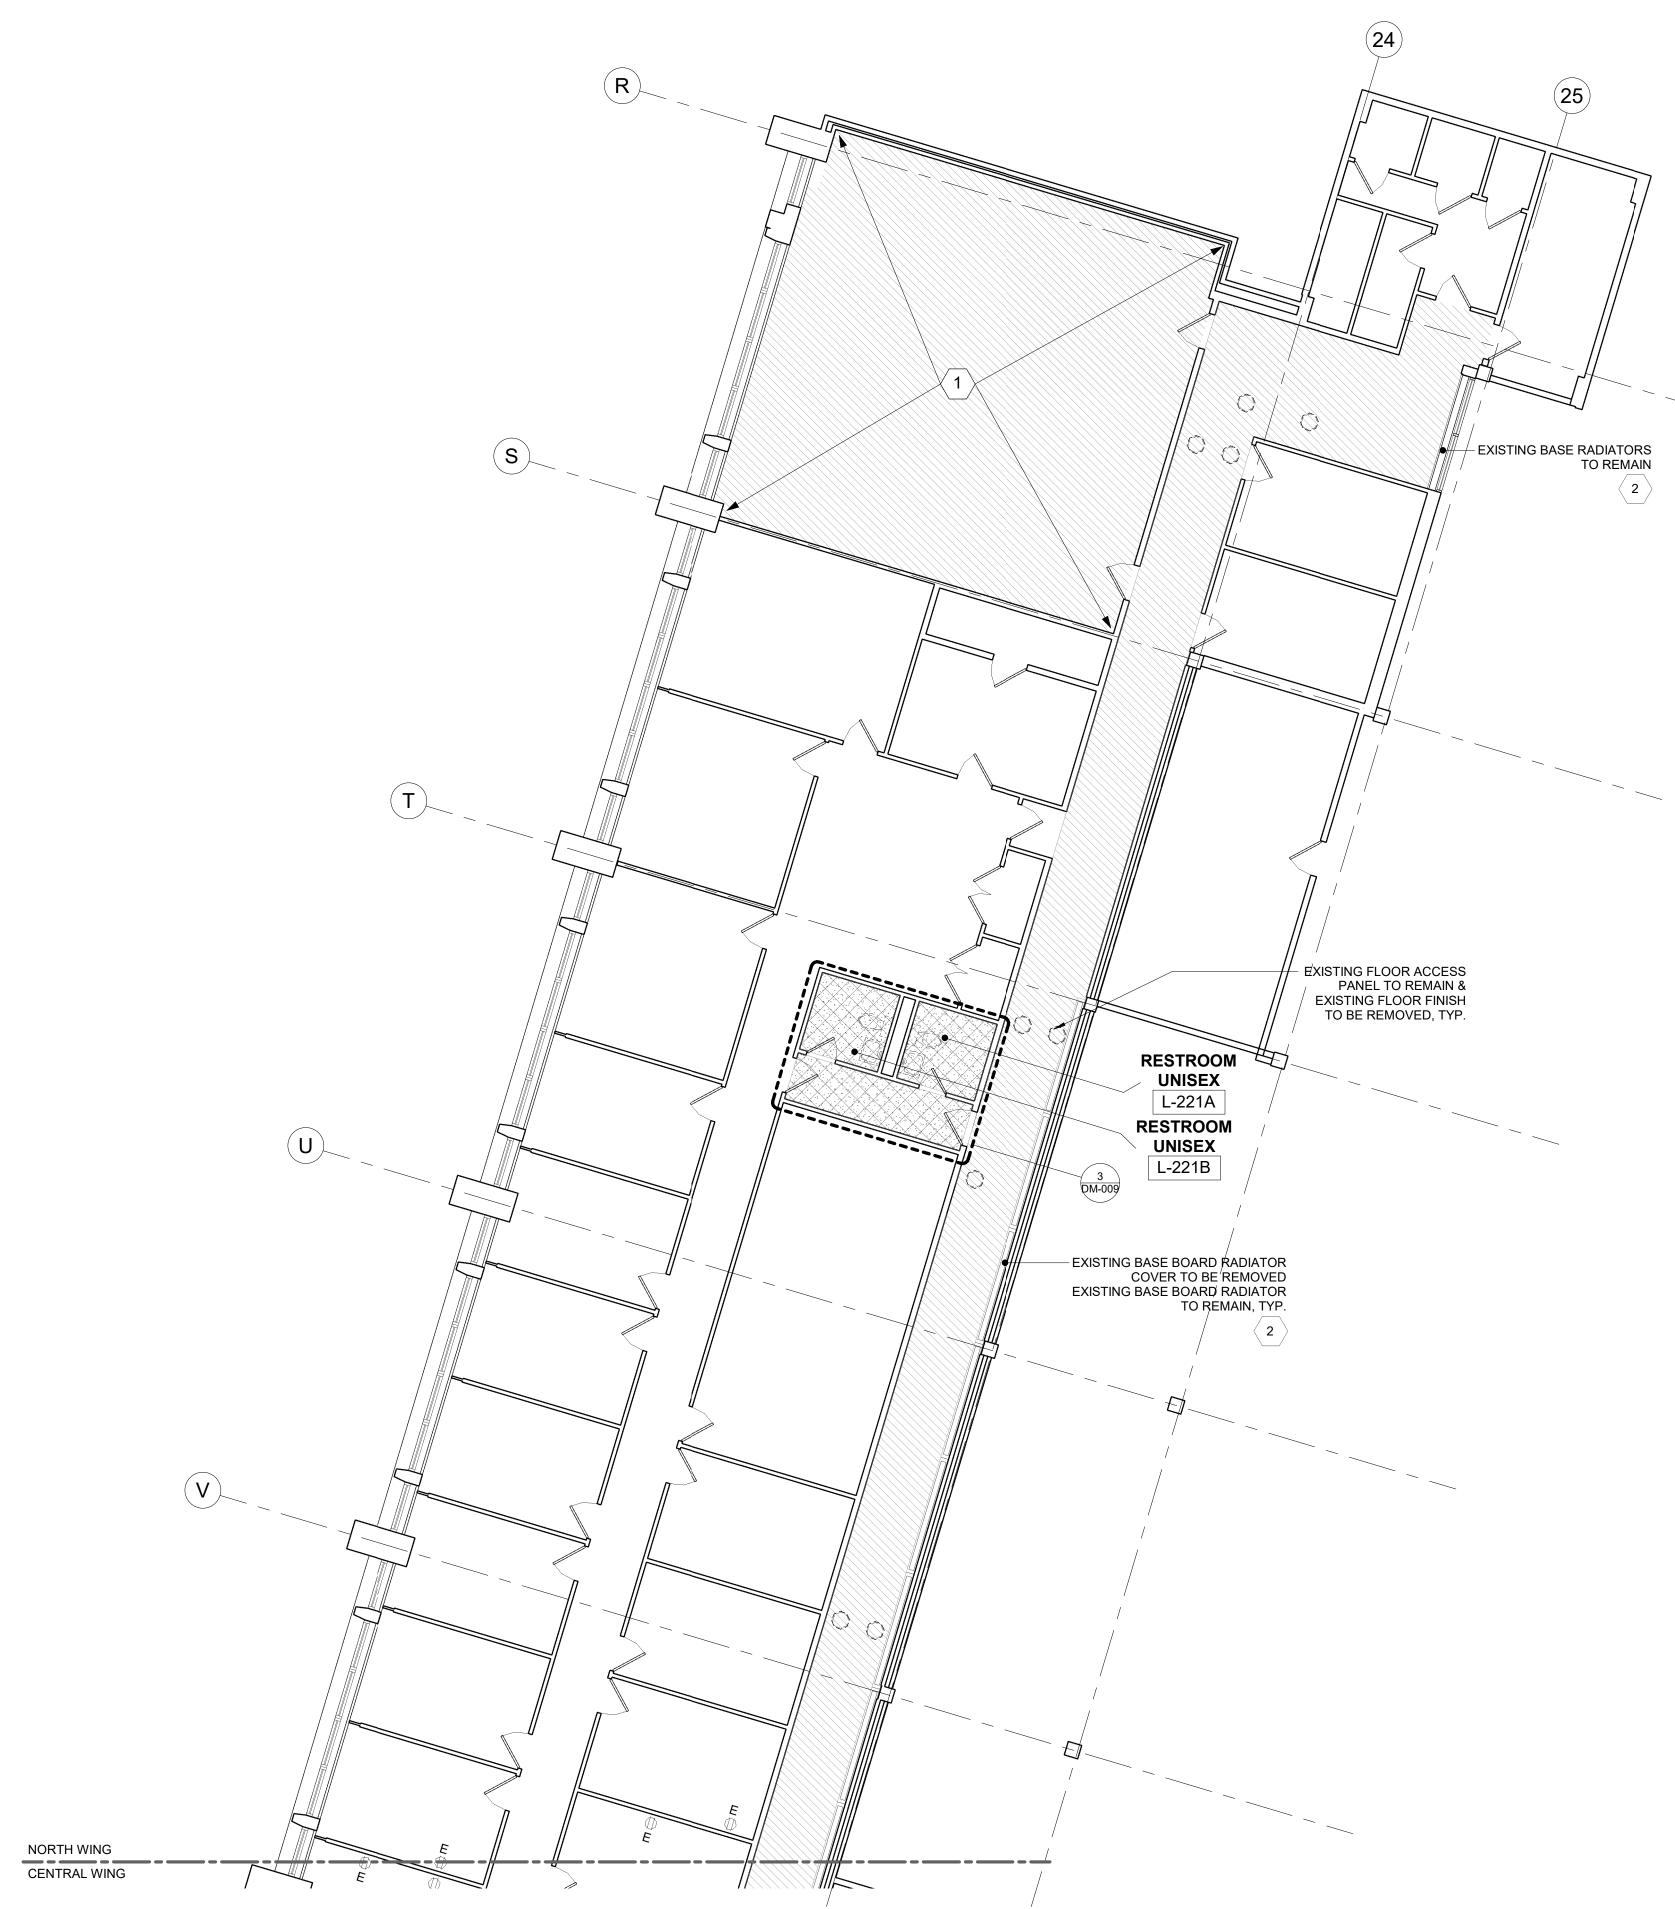

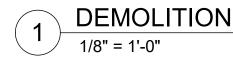

DEMOLITION FLOOR PLAN - 2ND FLOOR NORTH WING



DEMOLITION PLAN LEGEND							
SYMBOL	DESCRIPTION						
	EXIST. WALL/ PARTITION TO REMAIN						
	EXISTING COLUMN TO REMAIN						
	EXISTING DOOR TO REMAIN						
	EXISTING SINK, FAUCET, COUNTER, AND CABINETS TO BE REMOVED						
	APPROXIMATE AREA OF EXISTING VCT FLOOR, WALL BASE, & RELATED ACCESSORIES TO BE REMOVED TO STRUCTURE SLAB						
	APPROXIMATE AREA OF EXISTING FLOOR PAVER, & RELATED ACCESSORIES TO BE REMOVED TO STRUCTURE SLAB						
	EXISTING FINISH FLOOR & WALL TILE, & RELATED ACCESSORIES TO BE REMOVED TO STRUCTURE SLAB						

DEMOLITION NOTES:

1. REMOVE ALL FLOOR FINISHES AND ALL EXISTING WALL BASES IN AREA OF WORK, DOWN TO THE CONCRETE FLOOR.

2. ALL ACCESSORY CONSTRUCTION, BLOCKING, CLIPS, TRIM-WORK, AND ALL MISCELLANEOUS ITEMS SHALL BE REMOVED.

3. REMOVE ALL SURFACE MOUNTED OUTLETS, DEVICE, ETC. IN DEMO AREA.

4. ALL EXISTING WALLS, PARTITIONS, FLOORS, AND CEILINGS TO REMAIN THAT ARE DAMAGED DUE TO DEMOLITION WORK ARE TO BE PATCHED AS REQUIRED.

5. CONTRACTOR MUST COORDINATE ALL DEMOLITION WORK WITH ASBESTOS ABATEMENT REQUIREMENTS.

6. SEE ENGINEERING DRAWINGS FOR ADDITIONAL DEMOLITION INFORMATION.

7. ALL ITEMS INDICATED TO BE REMOVED ARE TO GIVE THE CONTRACTOR A SENSE OF THE QUANTITIES. REMOVE ALL ITEMS REGARDLESS OF THE EXACT QUANTITIES.

8. FLOOR REMOVAL TO BE COORDINATED WITH ASBESTOS ABATEMENT PROCEDURES.

9. EXISTING WALL RECESSED OUTLET TO REMAIN.

10. ALL EXISTING WALL MOUNTED EQUIPMENT, DEVICE, SIGNAGE, MISCELLANEOUS ITEMS, & ETC. TO BE REMOVED AND STORED FOR REINSTALLATION UNLESS OTHERWISE NOTED. COORDINATE WITH THE COUNTY.

11. ALL EXISTING DOOR ACCESS DEVICES TO REMAIN.

DEMOLITION PLAN KEY NOTES:

EXISTING FURNITURE, FILE CABINET, & ETC. TO BE REMOVED PRIOR TO DEMOLITION. COORDINATE WITH THE COUNTY.

2 EXISTING RADIATOR COVER SUPPORT TO BE REMOVED AND PROVIDE TEMPORARY SUPPORT FOR BASE BOARD PIPE DURING DEMOLITION.

CONSULTANT SEAL	CONSULTANT INFORMATION								
THE OF NEW	Graf & Lewent Architects LLP 90-30 161st Street, Jamaica, NY 11432 P: 718-651-6200 F: 718-251-6989								
REVISION NUMBER	DATE	MADE BY	APP'D BY		REVIS	SION			
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	WES	TCHESTER	COUNTY,	NEW Y	ORK	CONTRACT NUMBER	SHEET NUMBER		
DEP	ARTMENT	OF PUBLIC	WORKS AN	ND TRA	NSPORTATION	20-502	DM-004		
							OF 133		
						SCALE:	1/8" = 1'-0"		
LOW RISE BUILDING RENOVATIONS AND HVAC IMPRO 110 DR. MARTIN LUTHER KING, JR. BOU						DATE: 01-19-2024			
WHITE PLAINS, NEW YORK						DATE: 01-19-2024 DPW FILE NO.	REV		
PARTIA	AL DEMOL	LITION PL	.AN - 2ND	R NORTH WING		G-1822-0			




SYMBOL	DESCRIPTION
	EXIST. WALL/ PARTITION TO REMAIN
	EXISTING COLUMN TO REMAIN
	EXISTING 2X2 ACOUSTICAL CEILING TILES AND GRIDS TO BE REMOVED
	EXISTING 2X4 ACOUSTICAL CEILING TILES AND GRIDS TO BE REMOVED
- + + - - +	EXISTING ACOUSTICAL CEILING TILES AND GRIDS TO BE REMOVED
	AREA OF EXISTING GYPSUM BOARD CEILING CONSTRUCTION TO BE REMOVED
	EXISTING LIGHT FIXTURE TO BE REMOVED & STORED FOR REINSTALLATION
R R R R	EXISTING DIFFUSER & RETURN REGISTER TO BE REMOVED
R R-O- IIR	EXISTING LIGHT FIXTURES TO BE REMOVED
© R	EXISTING CEILING MOUNTED EXIT SIGNS TO BE REMOVED
SDE	EXISTING SMOKE DETECTOR TO REMAIN
Ĕ	EXISTING WALL MOUNTED EXIT SIGN TO REMAIN
⊗ E	EXISTING CEILING MOUNTED EXIT SIGN TO REMAIN
₫ R ⊗ R	EXISTING EXIT SIGN TO BE REMOVED

AND SECURE FOR REINSTALLATION OF WAPS AFTER CEILING INSTALL.

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LOW RISE BUILDING RENOVATIONS AND HVAC IMPR 110 DR. MARTIN LUTHER KING, JR. BOU							SCALE: DATE: 01-19-2024	As indicated Issue Date
WHITE PLAINS, NEW YORK							DATE: 01-19-2024 DPW FILE NO.	REV
PARTIAL DEMO CEILING PLAN - 1ST FLOO					R CENTRAL WING			-G-1823-0

QUARROPAS STREET K KEY PLAN

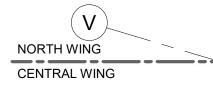





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CEILING DEMOLITION PLAN LEGEND							
SYMBOL	DESCRIPTION						
	EXIST. WALL/ PARTITION TO REMAIN						
	EXISTING COLUMN TO REMAIN						
	EXISTING 2X2 ACOUSTICAL CEILING TILES AND GRIDS TO BE REMOVED						
	EXISTING 2X4 ACOUSTICAL CEILING TILES AND GRIDS TO BE REMOVED						
	EXISTING ACOUSTICAL CEILING TILES AND GRIDS TO BE REMOVED						
	AREA OF EXISTING GYPSUM BOARD CEILING CONSTRUCTION TO BE REMOVED						
E E E	EXISTING LIGHT FIXTURE TO BE REMOVED & STORED FOR REINSTALLATION						
R R R R R	EXISTING DIFFUSER & RETURN REGISTER TO BE REMOVED						
R R-∲- □R	EXISTING LIGHT FIXTURES TO BE REMOVED						
© R	EXISTING CEILING MOUNTED EXIT SIGNS TO BE REMOVED						
SDE	EXISTING SMOKE DETECTOR TO REMAIN						
ĕ₽	EXISTING WALL MOUNTED EXIT SIGN TO REMAIN						
⊗ E	EXISTING CEILING MOUNTED EXIT SIGN TO REMAIN						
₫ R ⊗ R	EXISTING EXIT SIGN TO BE REMOVED						


GENERAL NOTE:

1. ALL EXISTING CEILING MOUNTED WIFI DEVICE TO BE REMOVED BY THE COUNTY. GC TO COIL EXISTING WIRING AND SECURE FOR REINSTALLATION OF WAPS AFTER CEILING INSTALL.

DEMOLITION CEILING PLAN KEY NOTES:


1 EXISTING RECESSED LIGHT FIXTURE TO BE REMOVED. MODIFY AND PREPARE EXISTING GYPSUM BOARD CEILING TO RECEIVE NEW LIGHT FIXTURE.


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WESTCHESTER COUNTY, NEW Y DEPARTMENT OF PUBLIC WORKS AND TRA						NUMBER 20-502	DM-006
DIVISION OF ENGINEERING						SHEET NO. 12	OF 133
LOW RISE BUILDING RENOVATIONS AND HVAC IMPROVEMENTS - PHAS						SCALE:	1/8" = 1'-0"
110 DR. MARTIN LUTHER KING, JR. BOULEVARD WHITE PLAINS, NEW YORK						DATE: 01-19-2024 DPW FILE NO.	Issue Date
PART	TIAL DEM	O CEILIN	G - 1ST F	LOOR	NORTH WING		G-1824-0

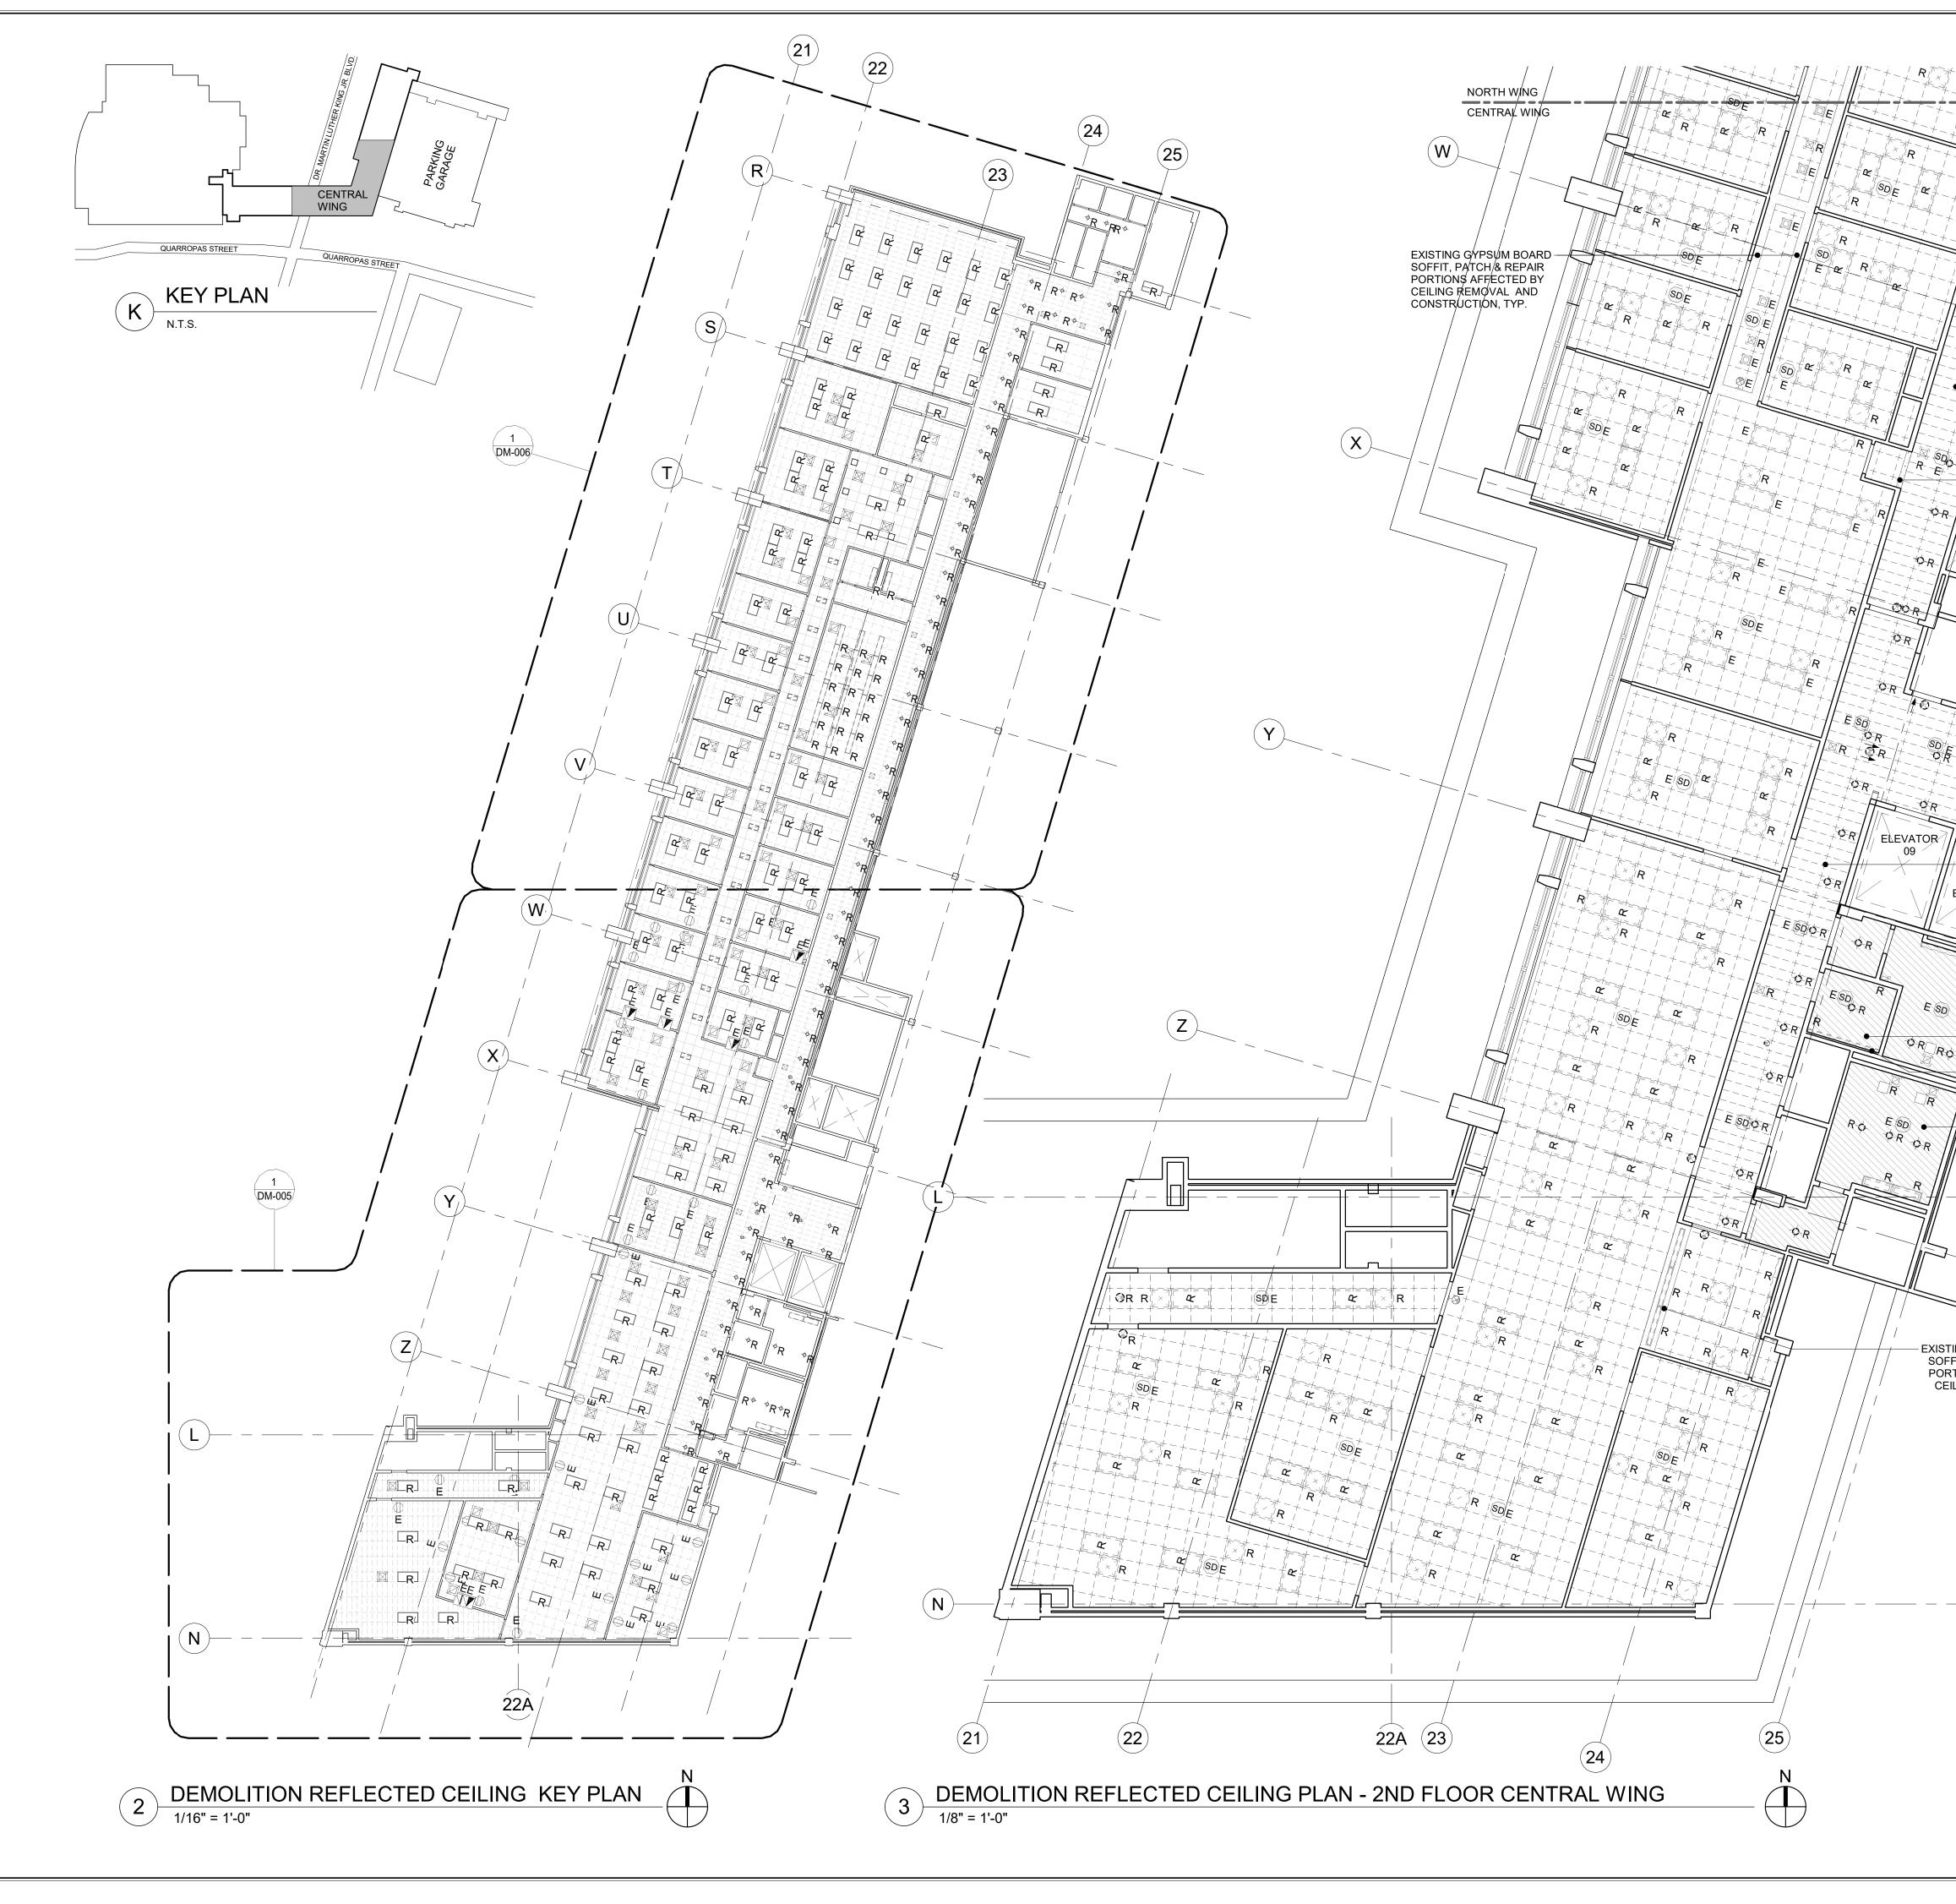

		•	CEILING	DEMOLITION LEGEND	I PLAN
		SY	MBOL	DESCRIP	TION
				EXIST. WALL/ PART REMAIN	TITION TO
		-1		EXISTING COLUMN	I TO REMAIN
				EXISTING 2X2 ACO CEILING TILES AND REMOVED	
• • • • • •	NAY			EXISTING 2X4 ACO CEILING TILES ANE REMOVED	
	EXISTING GYPSUM BOARD			EXISTING ACOUST TILES AND GRIDS REMOVED	
R	SOFFIT, PATCH & REPAIR PORTIONS AFFECTED BY CEILING REMOVAL AND CONSTRUCTION			AREA OF EXISTING BOARD CEILING CO TO BE REMOVED	
		۲ ۱ ۱ ۲		EXISTING LIGHT FI REMOVED & STOR REINSTALLATION	
	/ / 7	ເລັ ເຊັ ເຊີ ເຊີ		EXISTING DIFFUSE REGISTER TO BE F	
		R] R-¢- □R	EXISTING LIGHT FI REMOVED	XTURES TO BE
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	EVATOR LOBBY (212)		€	EXISTING WALL MO TO REMAIN	DUNTED EXIT SIGN
CENTRAL	WING HALLWAY		⊗E	EXISTING CEILING TO REMAIN	MOUNTED EXIT SIGN
		्	R 🕲 R	EXISTING EXIT SIG	N TO BE REMOVED
UNISEX RESTROOM ADA (L-214) EXIST. RECESSED LIGHT FIXTURE TO BE REMOVED WOMEN'S RESTROOM (L-216)					
7					
	CONSULTANT SEAL CO	NSULTANT INFORMATION			
STING GYPSUM BOARD FFIT, PATCH & REPAIR PRTIONS AFFECTED BY EILING REMOVAL AND CONSTRUCTION	REAL PROPERTY OF NEW YORK	90-3	Ar 0 161st St	Lewen chitects LL reet, Jamaica, I 200 F: 718-29	P
	REVISION DATE M/ NUMBER	ADE BY APP'D BY			Ν
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	CONTRAC	TOR		CONTR	
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	WESTCI	HESTER COUNTY, NE PUBLIC WORKS AND	W YORK		CONTRACT SHEET NUMBER 20-502 DM-007
	LOW RISE BUILDING REN	SION OF ENGINEE OVATIONS AND HVAC IN RTIN LUTHER KING, JR. I	MPROVEMENT	S - PHASE II	SHEET NO. 13 OF 133 SCALE: As indicate
	W	PLAN - 2ND FLOOR	RK	WING	DATE: 01-19-2024 Issue Dat DPW FILE NO. 52-11-G-1825-0 NO.

QUARROPAS STREET K KEY PLAN

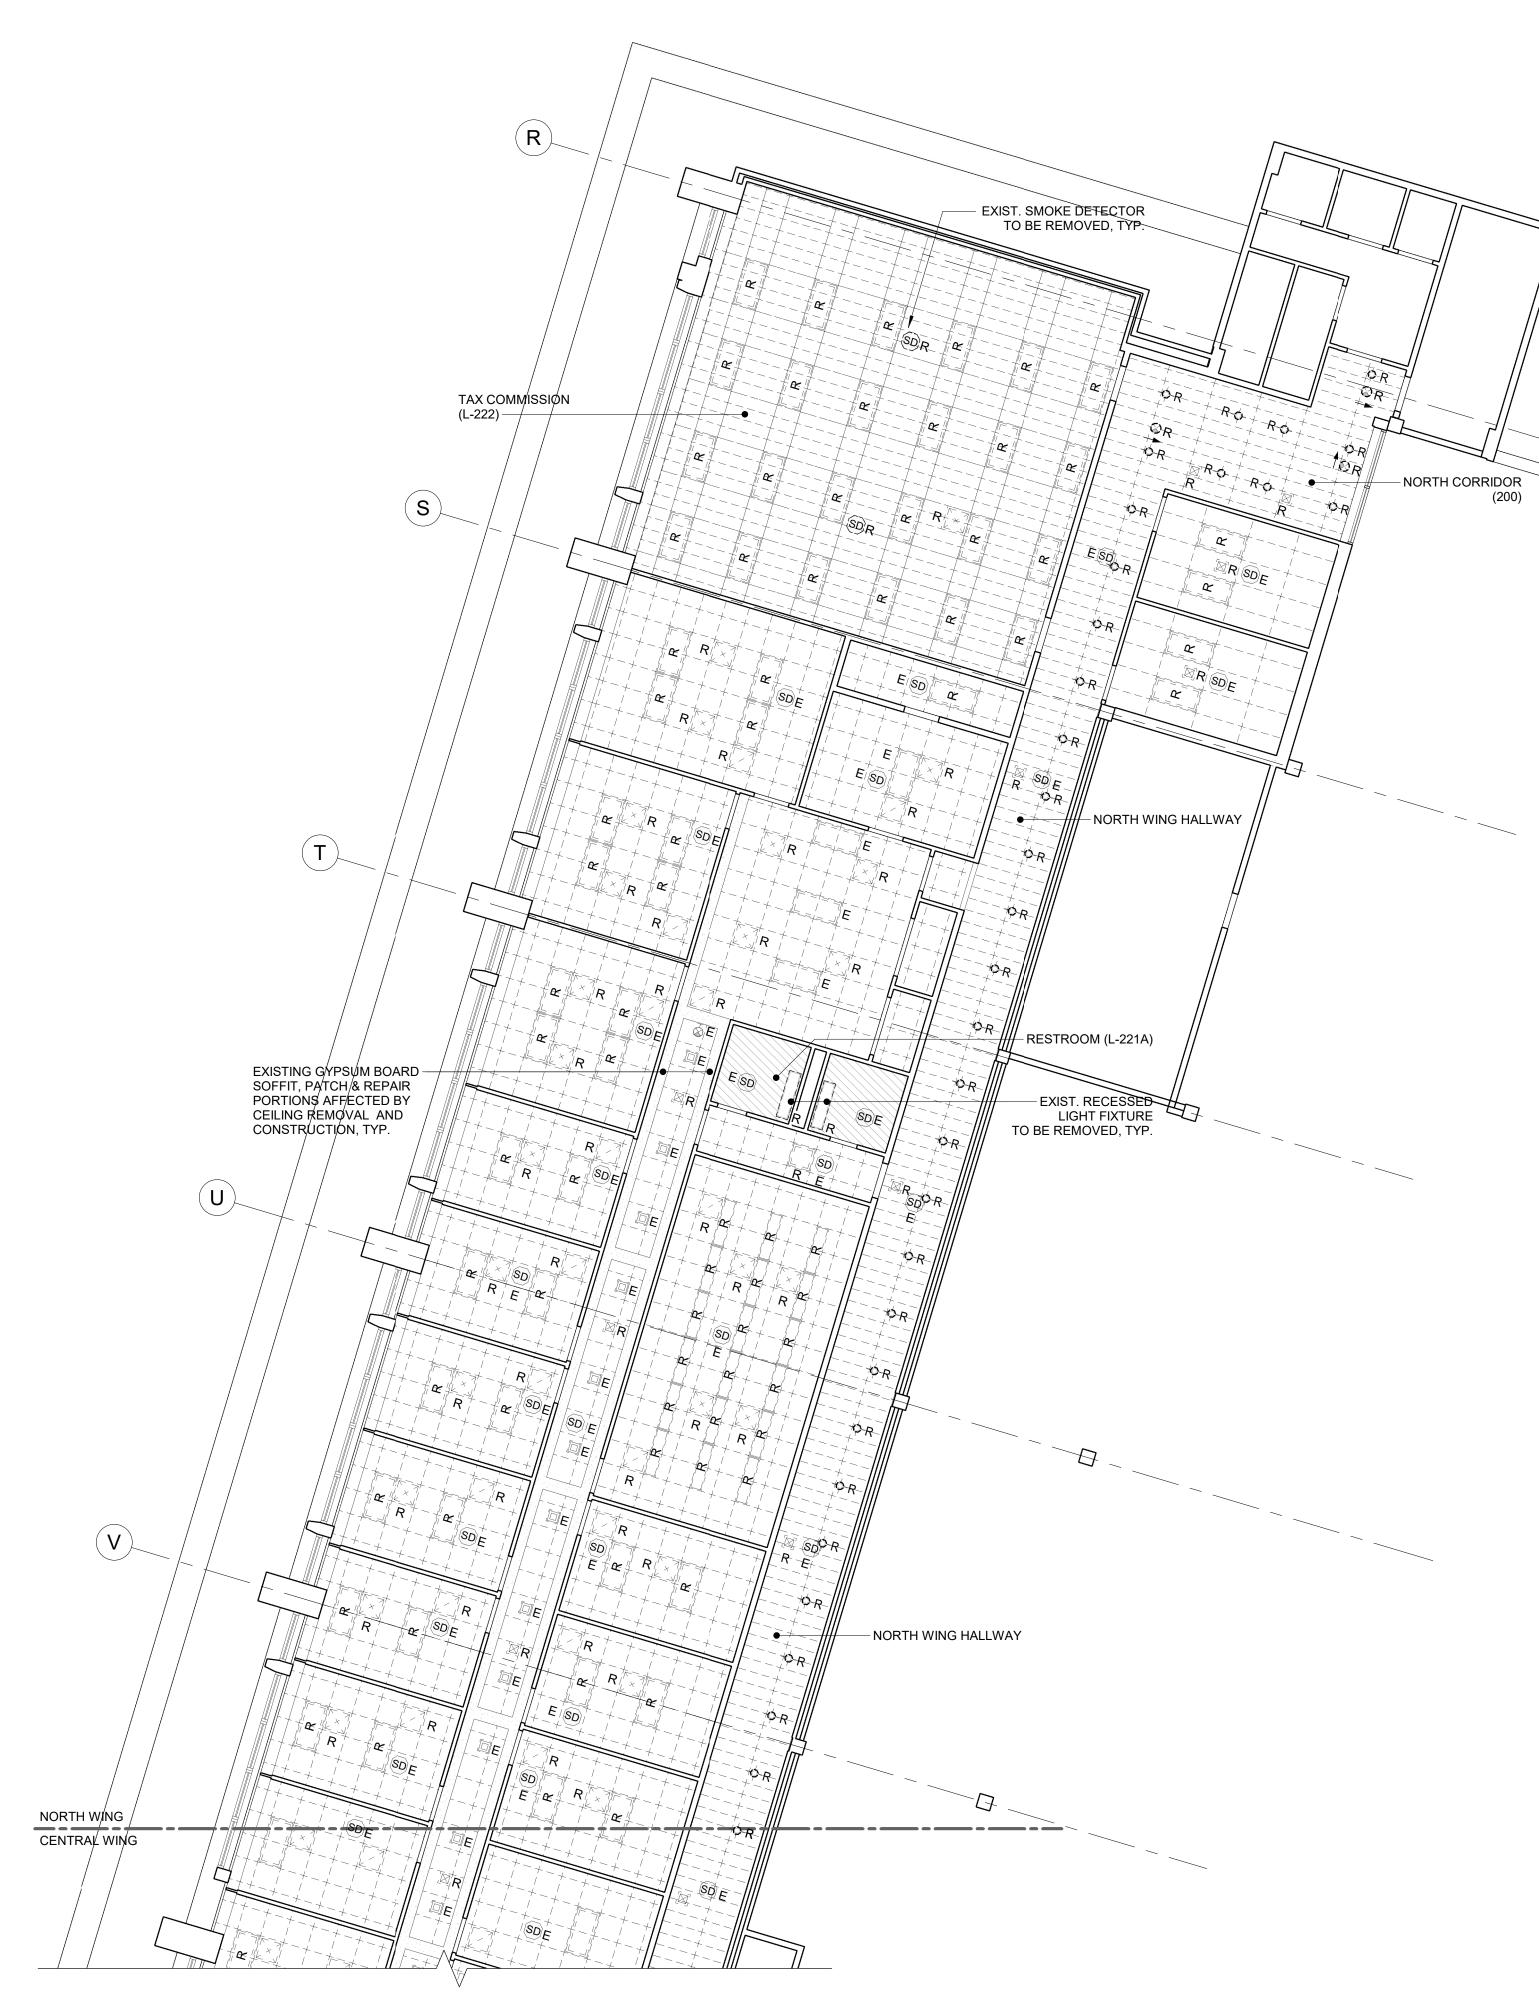

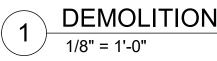

1 DEMOLITION REFLECTED CEILING PLAN - 2ND FLOOR NORTH WING 1/8" = 1'-0"




CEILING DEMOLITION PLAN LEGEND							
SYMBOL	DESCRIPTION						
	EXIST. WALL/ PARTITION TO REMAIN						
	EXISTING COLUMN TO REMAIN						
	EXISTING 2X2 ACOUSTICAL CEILING TILES AND GRIDS TO BE REMOVED						
	EXISTING 2X4 ACOUSTICAL CEILING TILES AND GRIDS TO BE REMOVED						
	EXISTING ACOUSTICAL CEILING TILES AND GRIDS TO BE REMOVED						
	AREA OF EXISTING GYPSUM BOARD CEILING CONSTRUCTION TO BE REMOVED						
۲ ۲ ۵ ل الـ ۵ E E E	EXISTING LIGHT FIXTURE TO BE REMOVED & STORED FOR REINSTALLATION						
R R R R R	EXISTING DIFFUSER & RETURN REGISTER TO BE REMOVED						
R R-∲- □R	EXISTING LIGHT FIXTURES TO BE REMOVED						
	EXISTING CEILING MOUNTED EXIT SIGNS TO BE REMOVED						
SDE	EXISTING SMOKE DETECTOR TO REMAIN						
€ €	EXISTING WALL MOUNTED EXIT SIGN TO REMAIN						
⊗ E	EXISTING CEILING MOUNTED EXIT SIGN TO REMAIN						
<u>@</u> R ⊗R	EXISTING EXIT SIGN TO BE REMOVED						


GENERAL NOTE:

1. ALL EXISTING CEILING MOUNTED WIFI DEVICE TO BE REMOVED BY THE COUNTY. GC TO COIL EXISTING WIRING AND SECURE FOR REINSTALLATION OF WAPS AFTER CEILING INSTALL.

CONSULTANT SEAL		CONSULTANT	90)-30 1	NY 11432		
OF NEW					8-651-6200 F: 718-2	.51-0909	
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			COUNTY,			CONTRACT NUMBER	SHEET NUMBER
DEPARTMENT OF PUBLIC WORKS AND TRA					ANSPORTATION	20-502	DM-008
					NG	SHEET NO. 14	OF 133
LOW RISE BUILDING RENOVATIONS AND HVAC IMPR					SCALE:	1/8" = 1'-0"	
110 DR. MARTIN LUTHER KING, JR. BOU WHITE PLAINS, NEW YORK					ILEVARD	DATE: 01-19-2024	
DEN				IORTH WING	DPW FILE NO. 52-11-0	G-1826-0	

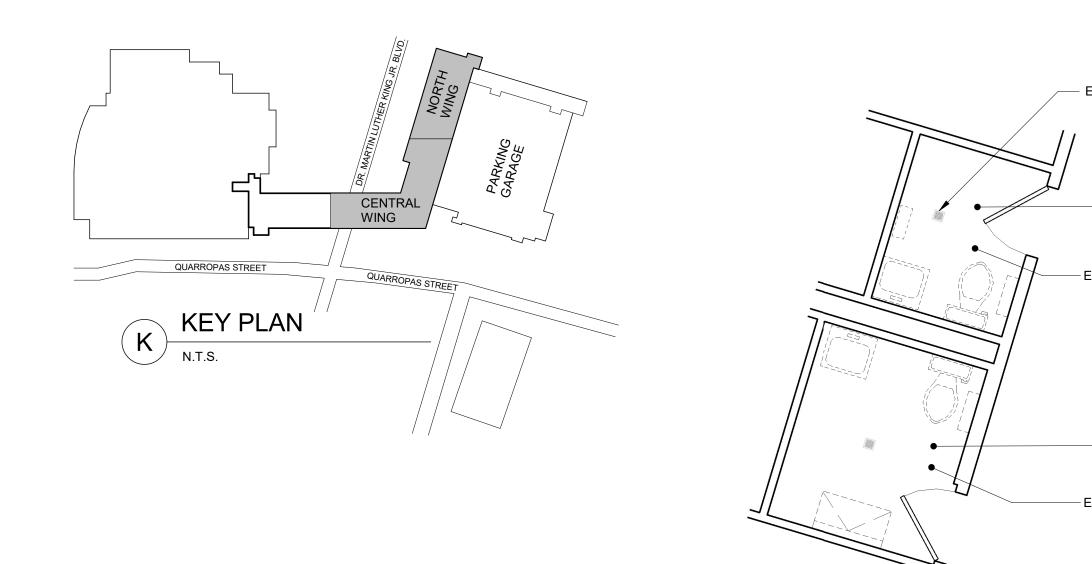

DETAIL DEMOLITION PLAN - 1ST FL - MEN'S AND WOMEN'S RESTROOMS 1/4" = 1'-0" (1)

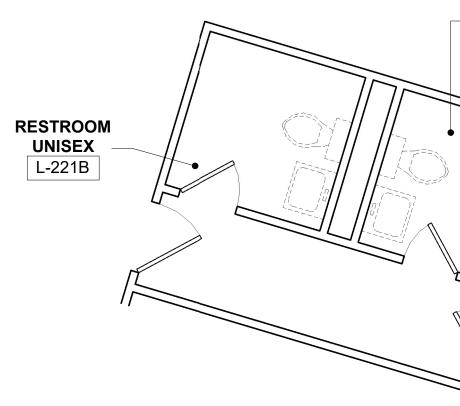



EXISTING FLOOR DRAIN TO REMAIN, TYP.


MEN'S RESTROOM G-09A

- EXISTING FINISH FLOOR TO BE REMOVED

WOMEN'S RESTROOMS G-07B

- EXISTING FINISH FLOOR TO BE REMOVED

RESTROOM UNISEX L-221A

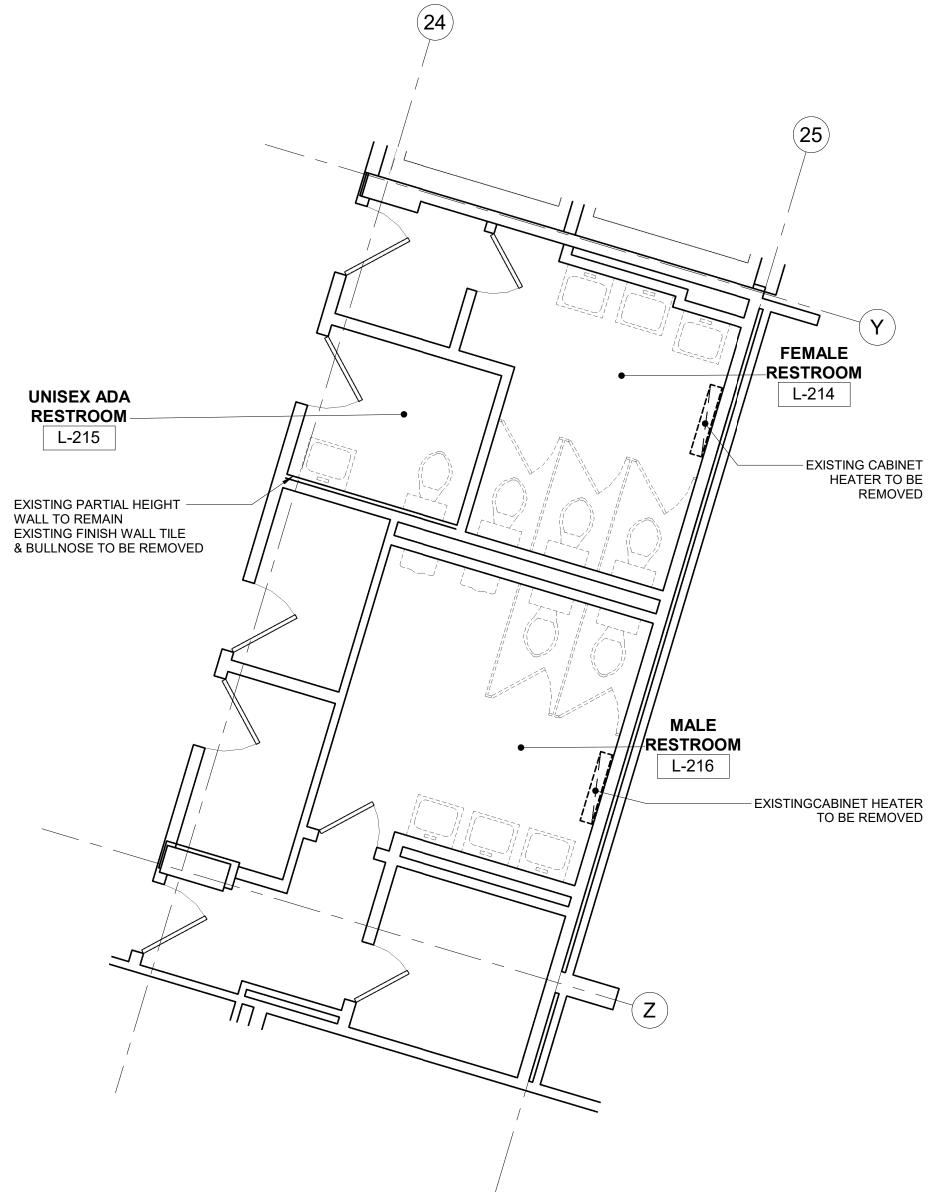

DEMOLITION FLOOR PLAN - 2ND FLOOR CENTRAL WING - PUBLIC RESTROOMS 2 1/4" = 1'-0"

Z)

DEMOLITION PLAN LEGEND						
SYMBOL	DESCRIPTION					
	EXIST. WALL/ PARTITION TO REMAIN					
	EXISTING COLUMN TO REMAIN					
	EXISTING DOOR TO REMAIN					
	EXISTING SINK, FAUCET, COUNTER, AND CABINETS TO BE REMOVED					

DEMOLITION NOTES:

1. REMOVE ALL FLOOR FINISHES AND ALL EXISTING WALL BASES IN AREA OF WORK, DOWN TO THE CONCRETE FLOOR.

2. ALL ACCESSORY CONSTRUCTION, BLOCKING, CLIPS, TRIM-WORK, AND ALL MISCELLANEOUS ITEMS SHALL BE REMOVED.

3. REMOVE ALL SURFACE MOUNTED OUTLETS, DEVICE, ETC. IN DEMO AREA.

4. ALL EXISTING WALLS, PARTITIONS, FLOORS, AND CEILINGS TO REMAIN THAT ARE DAMAGED DUE TO DEMOLITION WORK ARE TO BE REPAIRED & PATCHED AS REQUIRED. SEE GENERAL NOTE NO. 1 ON CONSTRUCTION PLANS.


5. CONTRACTOR MUST COORDINATE ALL DEMOLITION WORK WITH ASBESTOS ABATEMENT REQUIREMENTS.

6. SEE ENGINEERING DRAWINGS FOR ADDITIONAL DEMOLITION INFORMATION.


7. ALL ITEMS INDICATED TO BE REMOVED ARE TO GIVE THE CONTRACTOR A SENSE OF THE QUANTITIES. REMOVE ALL ITEMS REGARDLESS OF THE EXACT QUANTITIES.

8. FLOOR REMOVAL TO BE COORDINATED WITH ASBESTOS ABATEMENT PROCEDURES.

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NUMBER	REVISION NUMBER DATE MADE BY APP'D BY REVISION RECORD DRAWING CERTIFICATION AS BUILT - CHANGES AS NOTED AS BUILT - NO CHANGES						
CONTRACTOR NAME:					NAME:		
WESTCHESTER COUNTY, NEW Y DEPARTMENT OF PUBLIC WORKS AND TRA DIVISION OF ENGINEERII LOW RISE BUILDING RENOVATIONS AND HVAC IMPR 110 DR. MARTIN LUTHER KING, JR. BOU					NSPORTATION NG ovements - phase 11	CONTRACT NUMBER 20-502 SHEET NO. 15 SCALE: DATE: 01-19-2024	SHEET NUMBER DM-009 OF 133 As indicated Issue Date
	WHITE PLAINS, NEW YORK DETAIL DEMOLITION PLAN - RES					DPW FILE NO.	G-1827-0

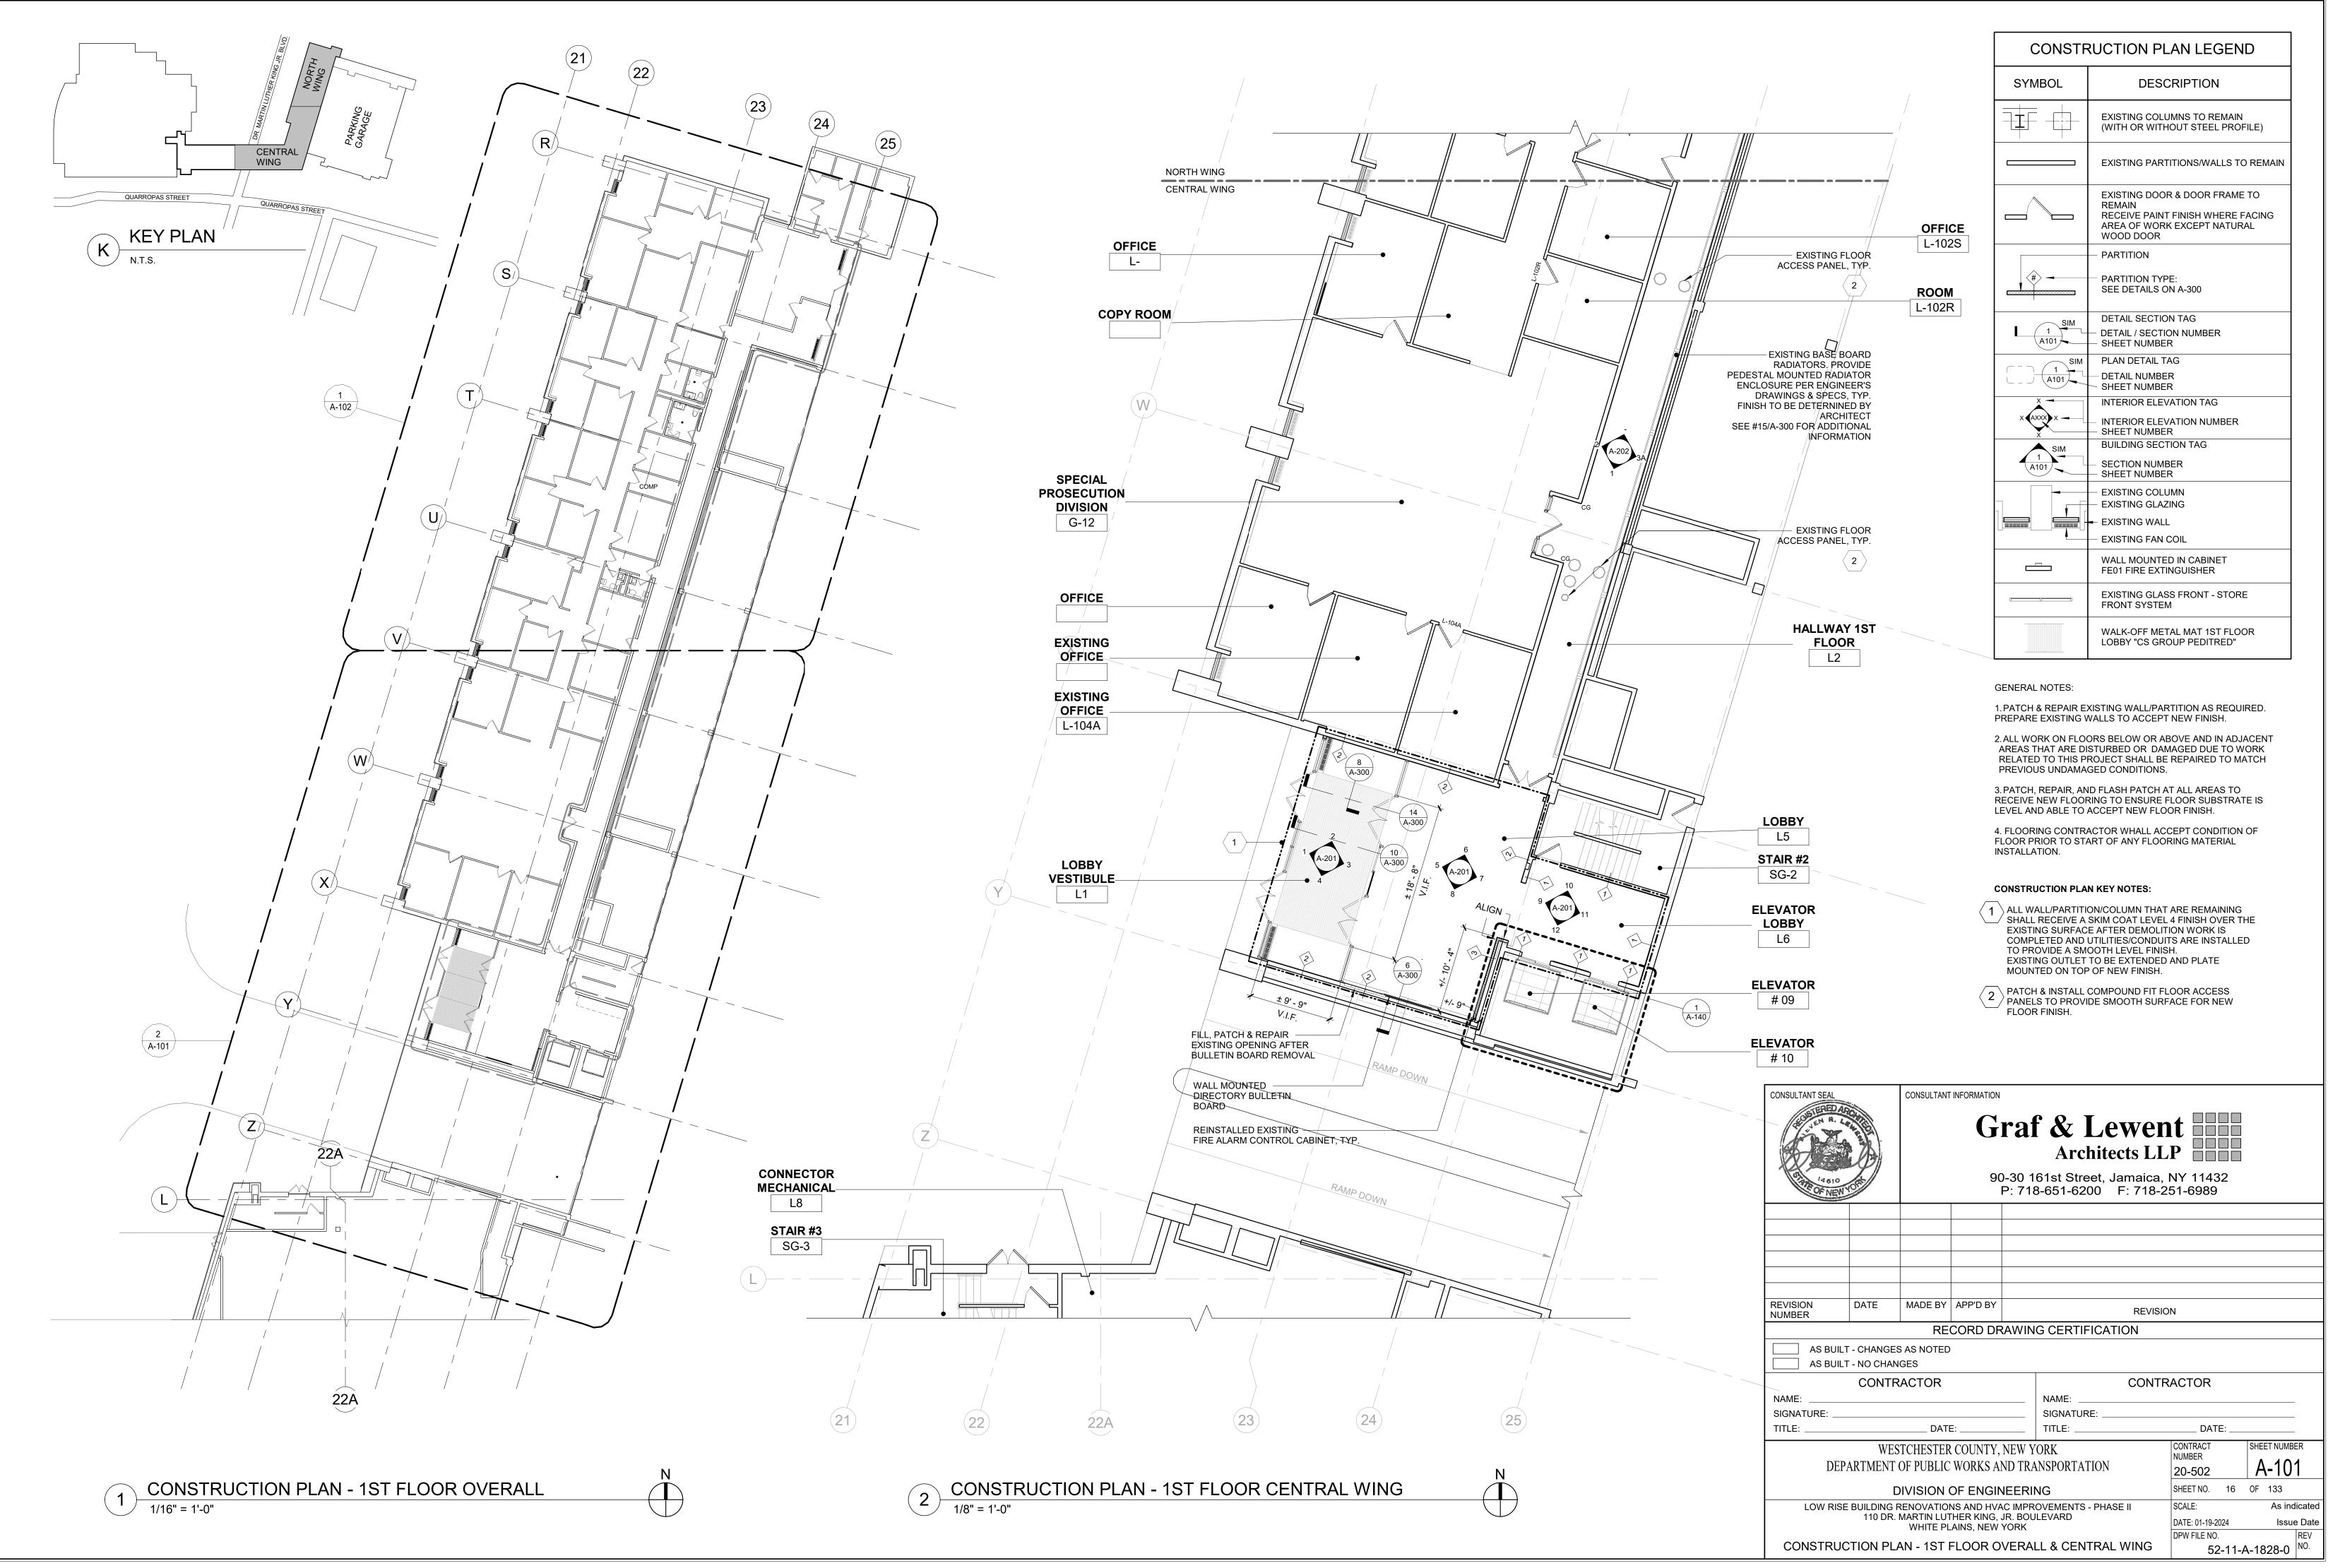


QUARROPAS STREET QUARROPAS STREE KEY PLAN KEY PLAN

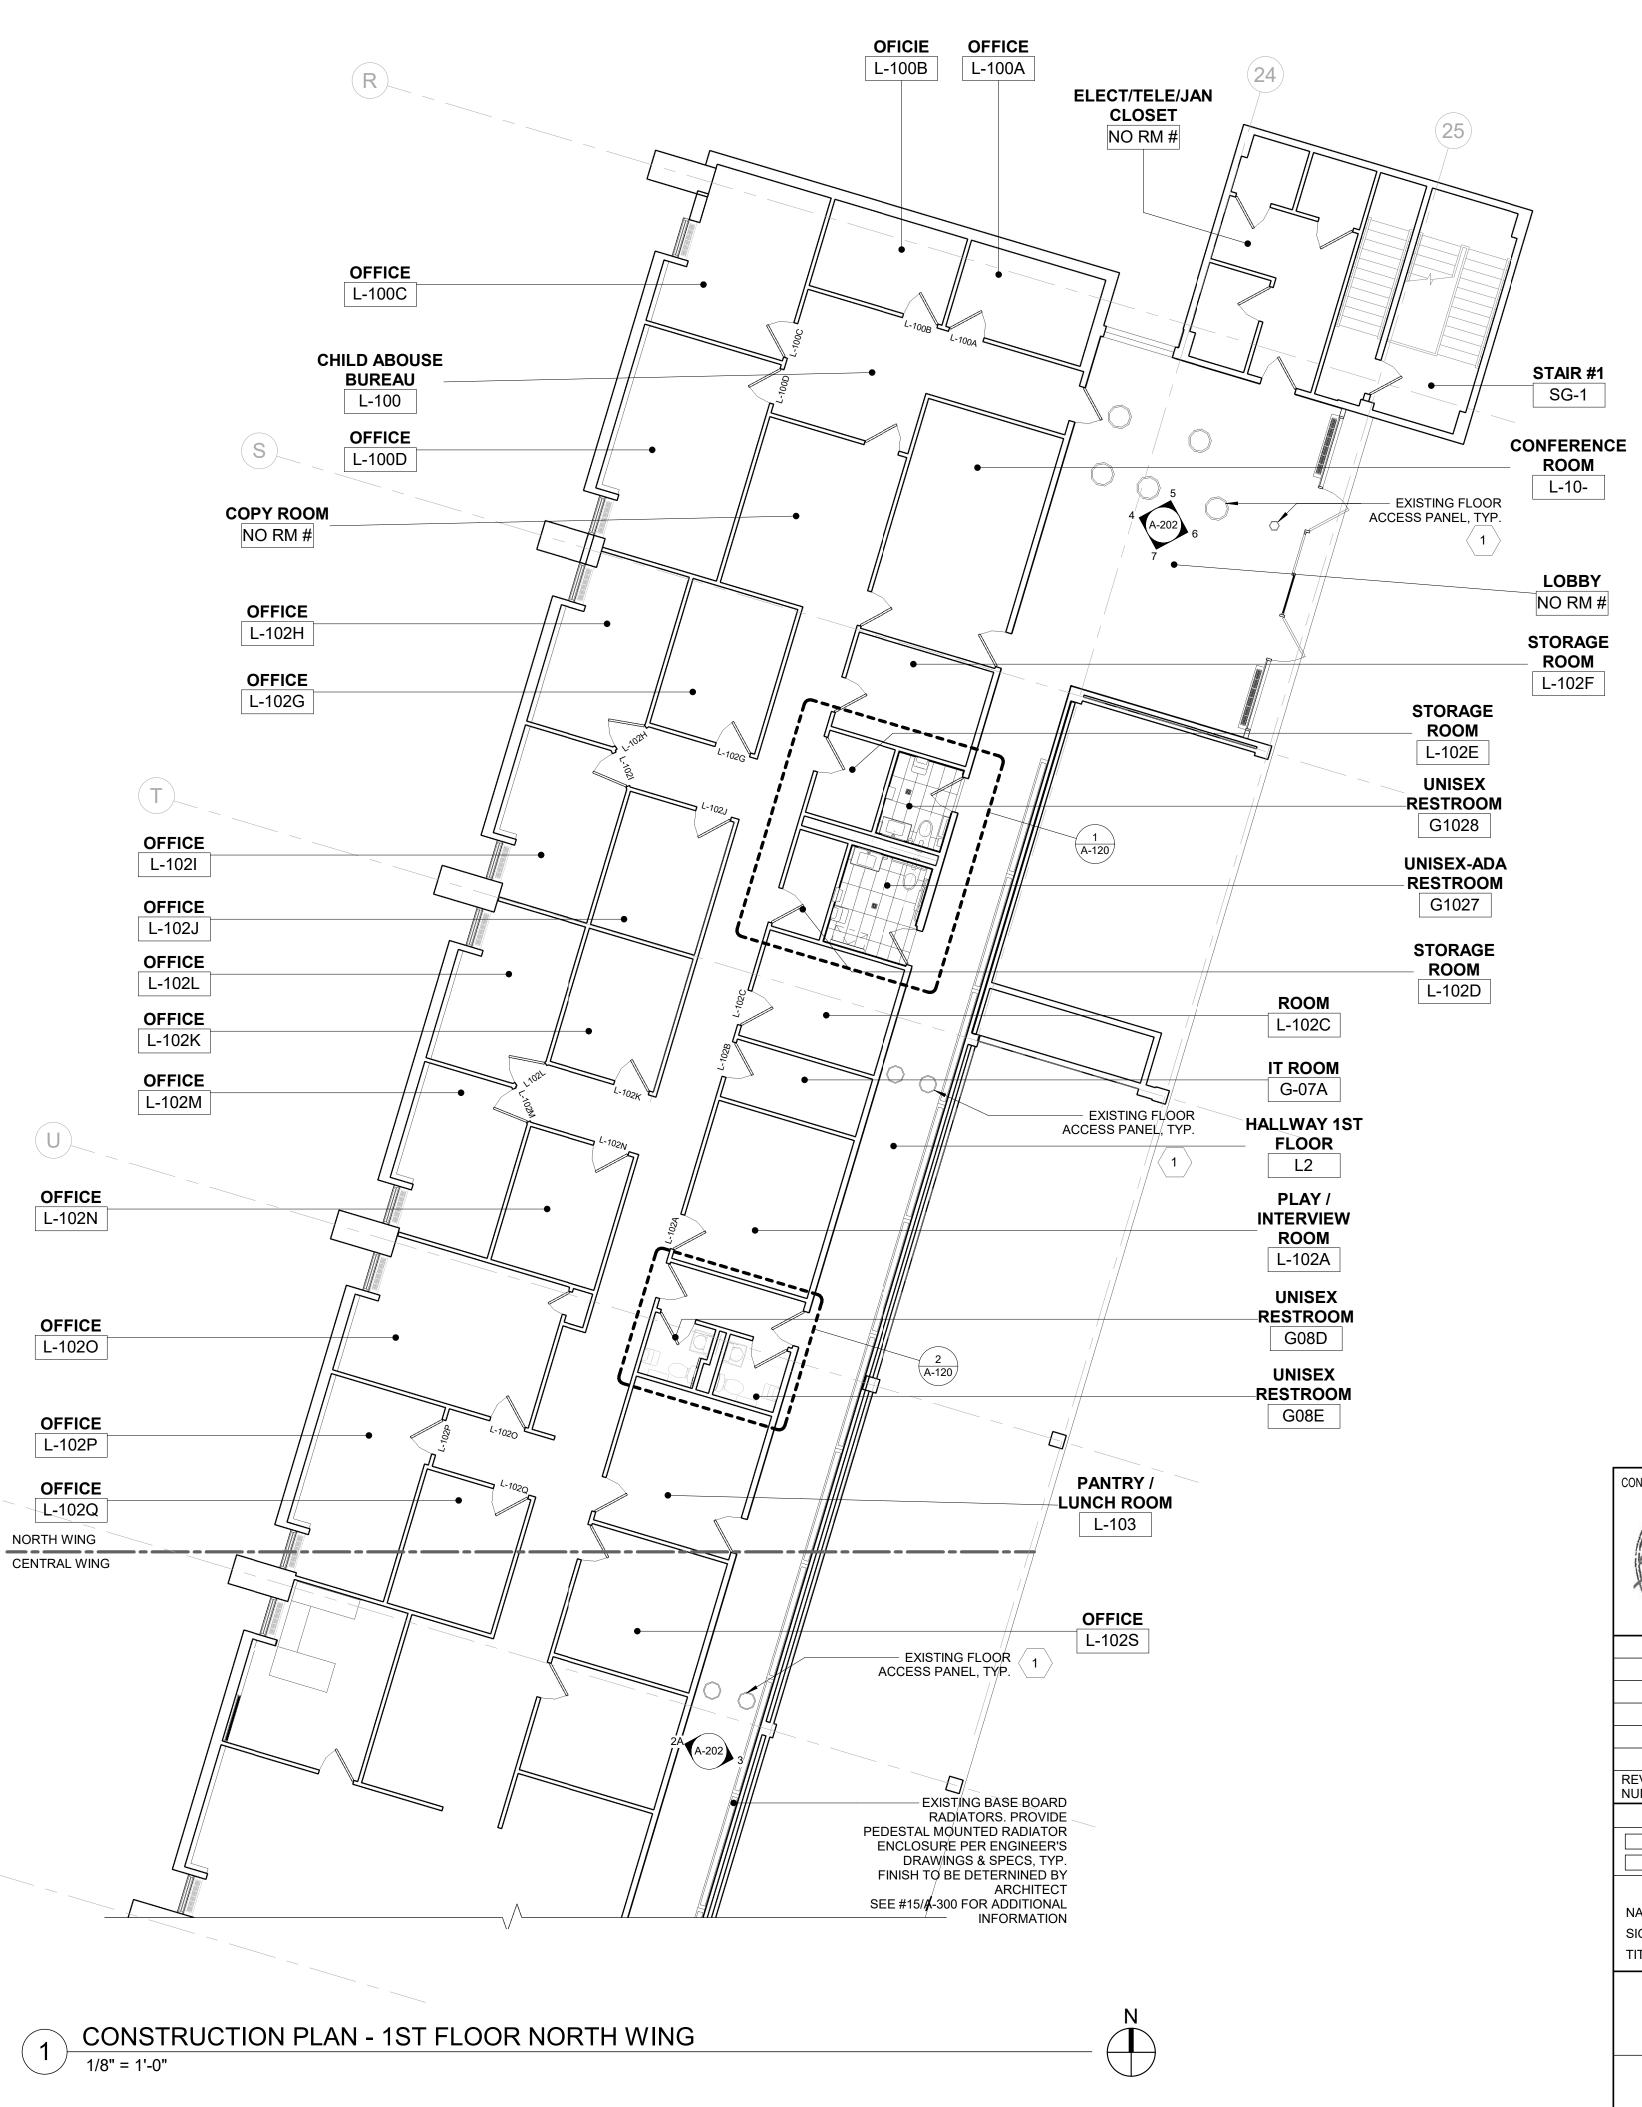

W _____

(V)

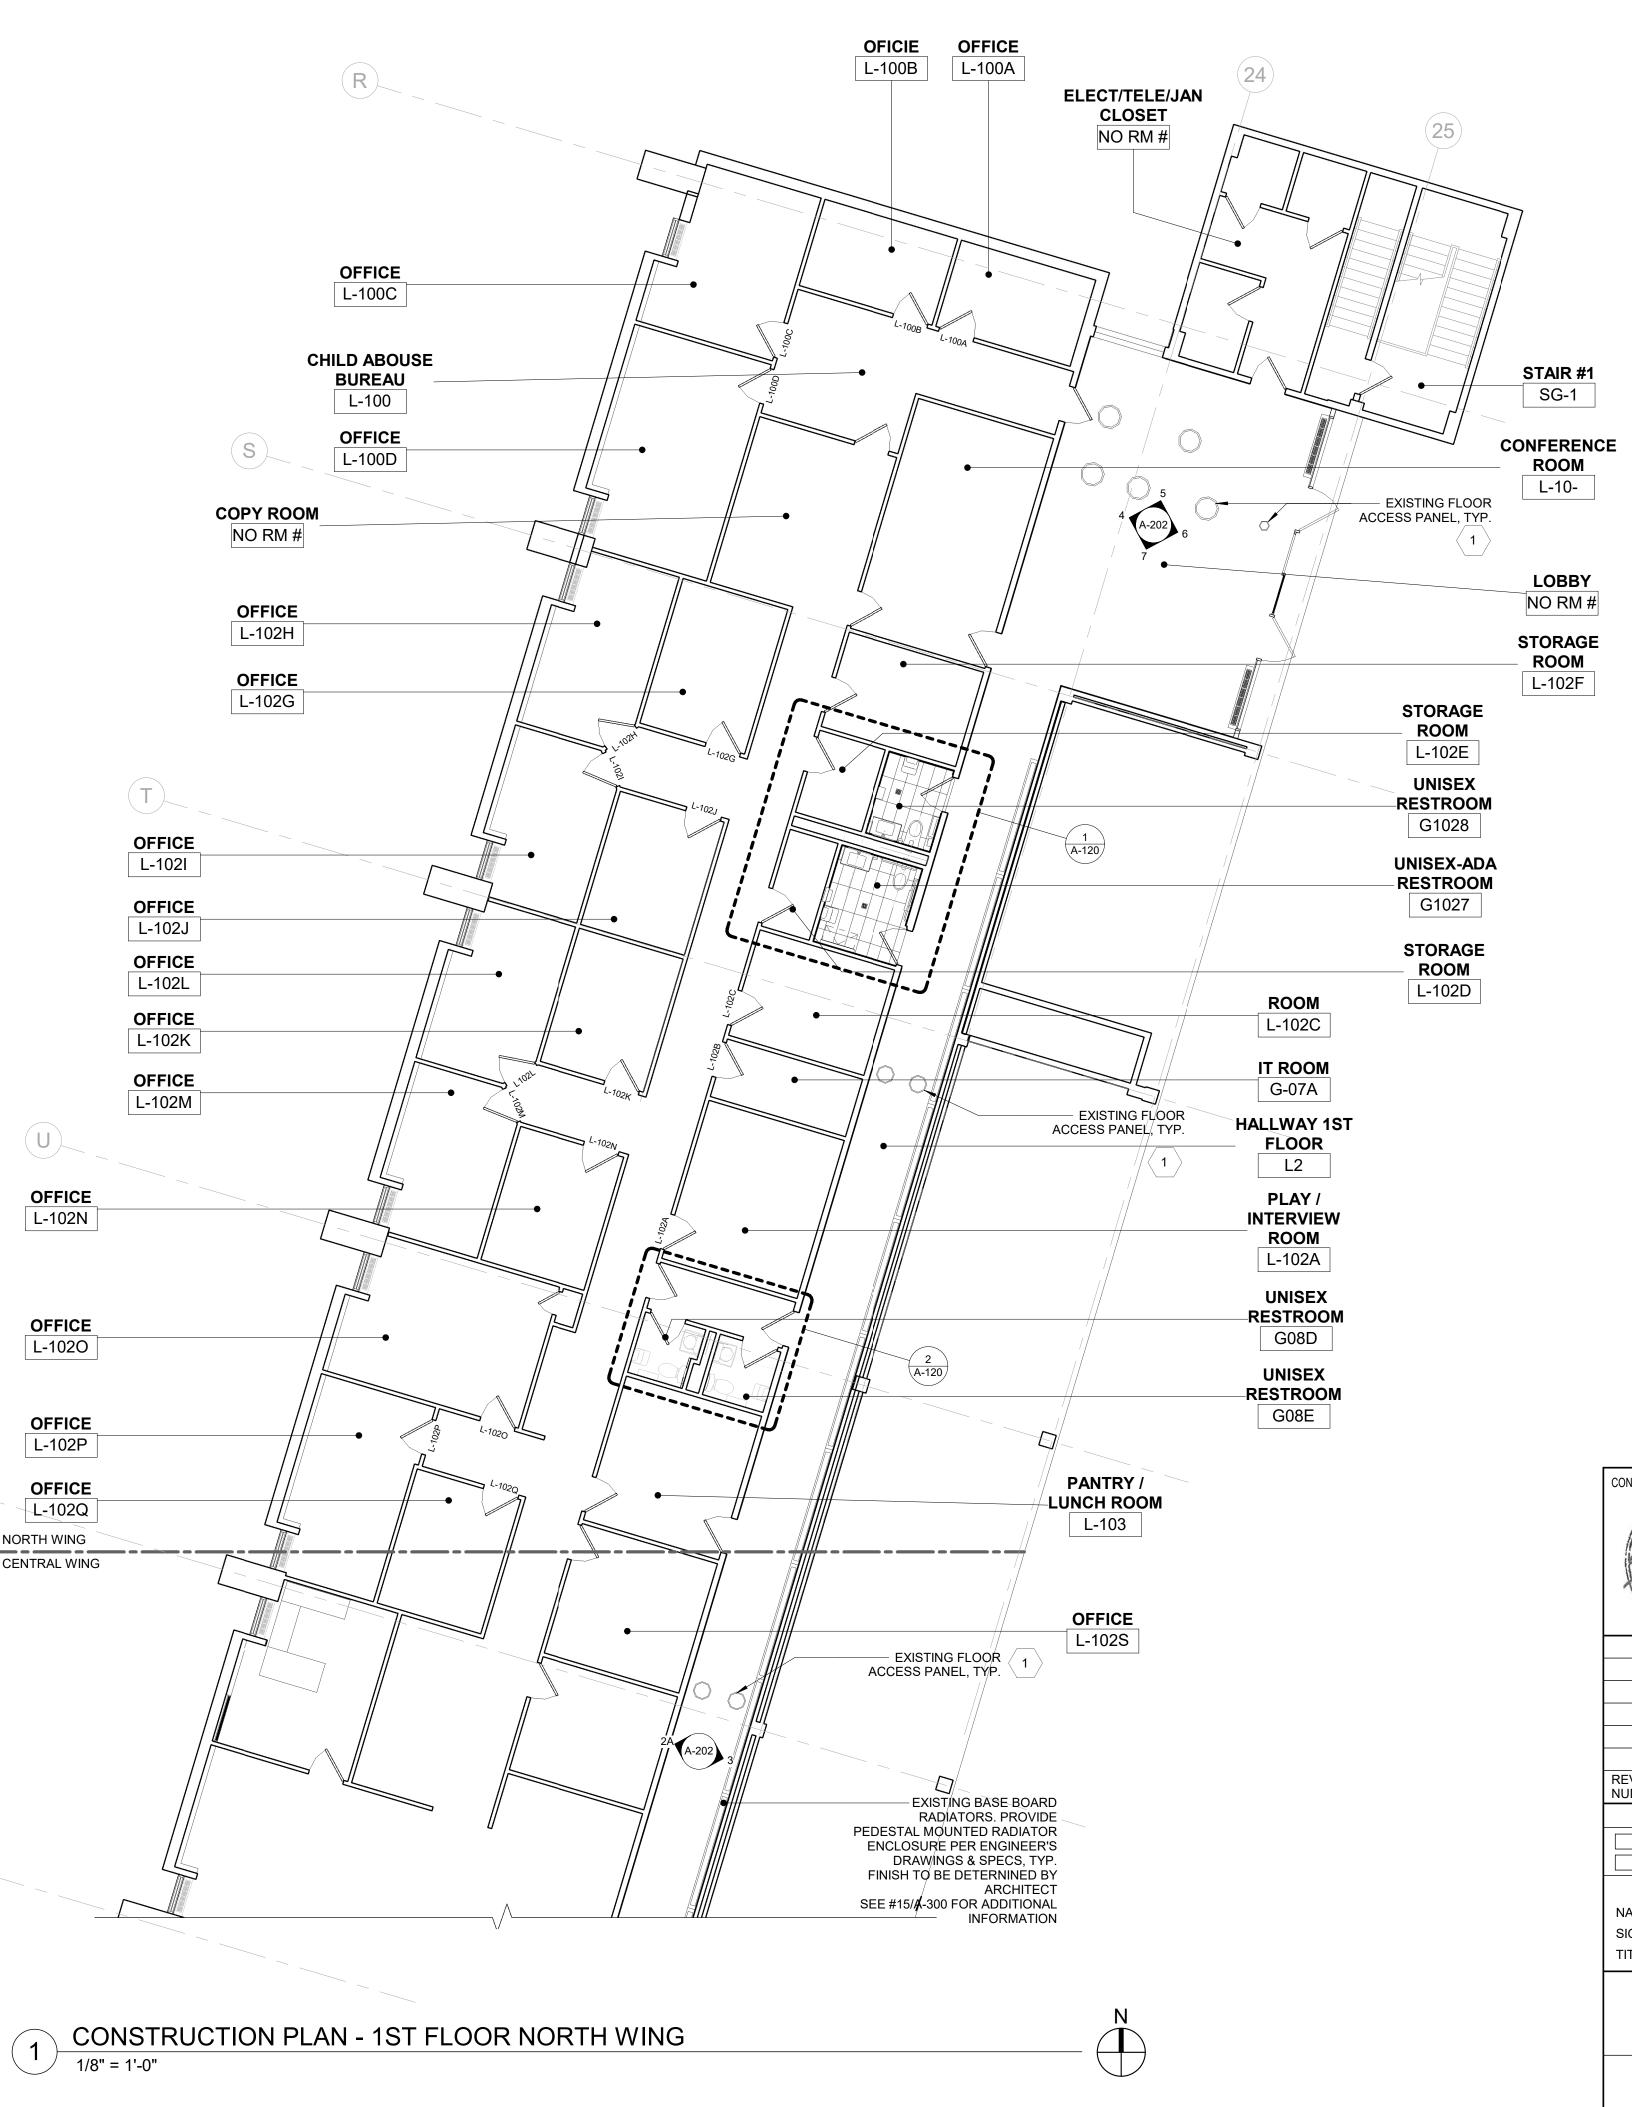

CONSTRUCTION PLAN LEGEND DESCRIPTION SYMBOL EXISTING COLUMNS TO REMAIN (WITH OR WITHOUT STEEL PROFILE) -1-EXISTING PARTITIONS/WALLS TO REMAIN EXISTING DOOR & DOOR FRAME TO REMAIN RECEIVE PAINT FINISH WHERE FACING AREA OF WORK EXCEPT NATURAL WOOD DOOR - PARTITION | ⟨#⟩ ------ PARTITION TYPE: SEE DETAILS ON A-300 DETAIL SECTION TAG 1 SIM - DETAIL / SECTION NUMBER A101 - SHEET NUMBER PLAN DETAIL TAG SIM 1 +----– DETAIL NUMBER A101 - SHEET NUMBER INTERIOR ELEVATION TAG х — X AXXX X -- INTERIOR ELEVATION NUMBER - SHEET NUMBER BUILDING SECTION TAG 1 A101 SECTION NUMBER SHEET NUMBER -- EXISTING COLUMN - EXISTING GLAZING - EXISTING FAN COIL WALL MOUNTED IN CABINET FE01 FIRE EXTINGUISHER EXISTING GLASS FRONT - STORE 1 FRONT SYSTEM WALK-OFF METAL MAT 1ST FLOOR LOBBY "CS GROUP PEDITRED"

GENERAL NOTES:

1. PATCH & REPAIR EXISTING WALL/PARTITION AS REQUIRED. PREPARE EXISTING WALLS TO ACCEPT NEW FINISH.

2. ALL WORK ON FLOORS BELOW OR ABOVE AND IN ADJACENT AREAS THAT ARE DISTURBED OR DAMAGED DUE TO WORK RELATED TO THIS PROJECT SHALL BE REPAIRED TO MATCH PREVIOUS UNDAMAGED CONDITIONS.


3. PATCH, REPAIR, AND FLASH PATCH AT ALL AREAS TO RECEIVE NEW FLOORING TO ENSURE FLOOR SUBSTRATE IS LEVEL AND ABLE TO ACCEPT NEW FLOOR FINISH.

4. FLOORING CONTRACTOR WHALL ACCEPT CONDITION OF FLOOR PRIOR TO START OF ANY FLOORING MATERIAL INSTALLATION.

CONSTRUCTION PLAN KEY NOTES:

 $\langle 1 \rangle$ PATCH & INSTALL COMPOUND FIT FLOOR ACCESS PANELS TO PROVIDE SMOOTH SURFACE FOR NEW FLOOR FINISH.

CONSULTANT SEAL CONSULTANT INFORMATION	
Architects LLP 90-30 161st Street, Jamaica, NY 11432 P: 718-651-6200 F: 718-251-6989	
REVISION NUMBER DATE MADE BY APP'D BY	
RECORD DRAWING CERTIFICATION	
AS BUILT - CHANGES AS NOTED AS BUILT - NO CHANGES	
CONTRACTOR CONTRACTOR	
NAME: NAME:	
SIGNATURE:	
TITLE: DATE: DATE: DATE:	
WESTCHESTER COUNTY, NEW YORK	T NUMBER
DEPARTMENT OF PUBLIC WORKS AND TRANSPORTATION	-102
DIVISION OF ENGINEERING SHEET NO. 17 OF 1	133
LOW RISE BUILDING RENOVATIONS AND HVAC IMPROVEMENTS - PHASE II SCALE:	1/8" = 1'-0"
110 DR. MARTIN LUTHER KING, JR. BOULEVARD WHITE PLAINS, NEW YORK	Issue Date
CONSTRUCTION PLAN - 1ST FLOOR - NORTH WING 52-11-A-182	29-0 REV NO.

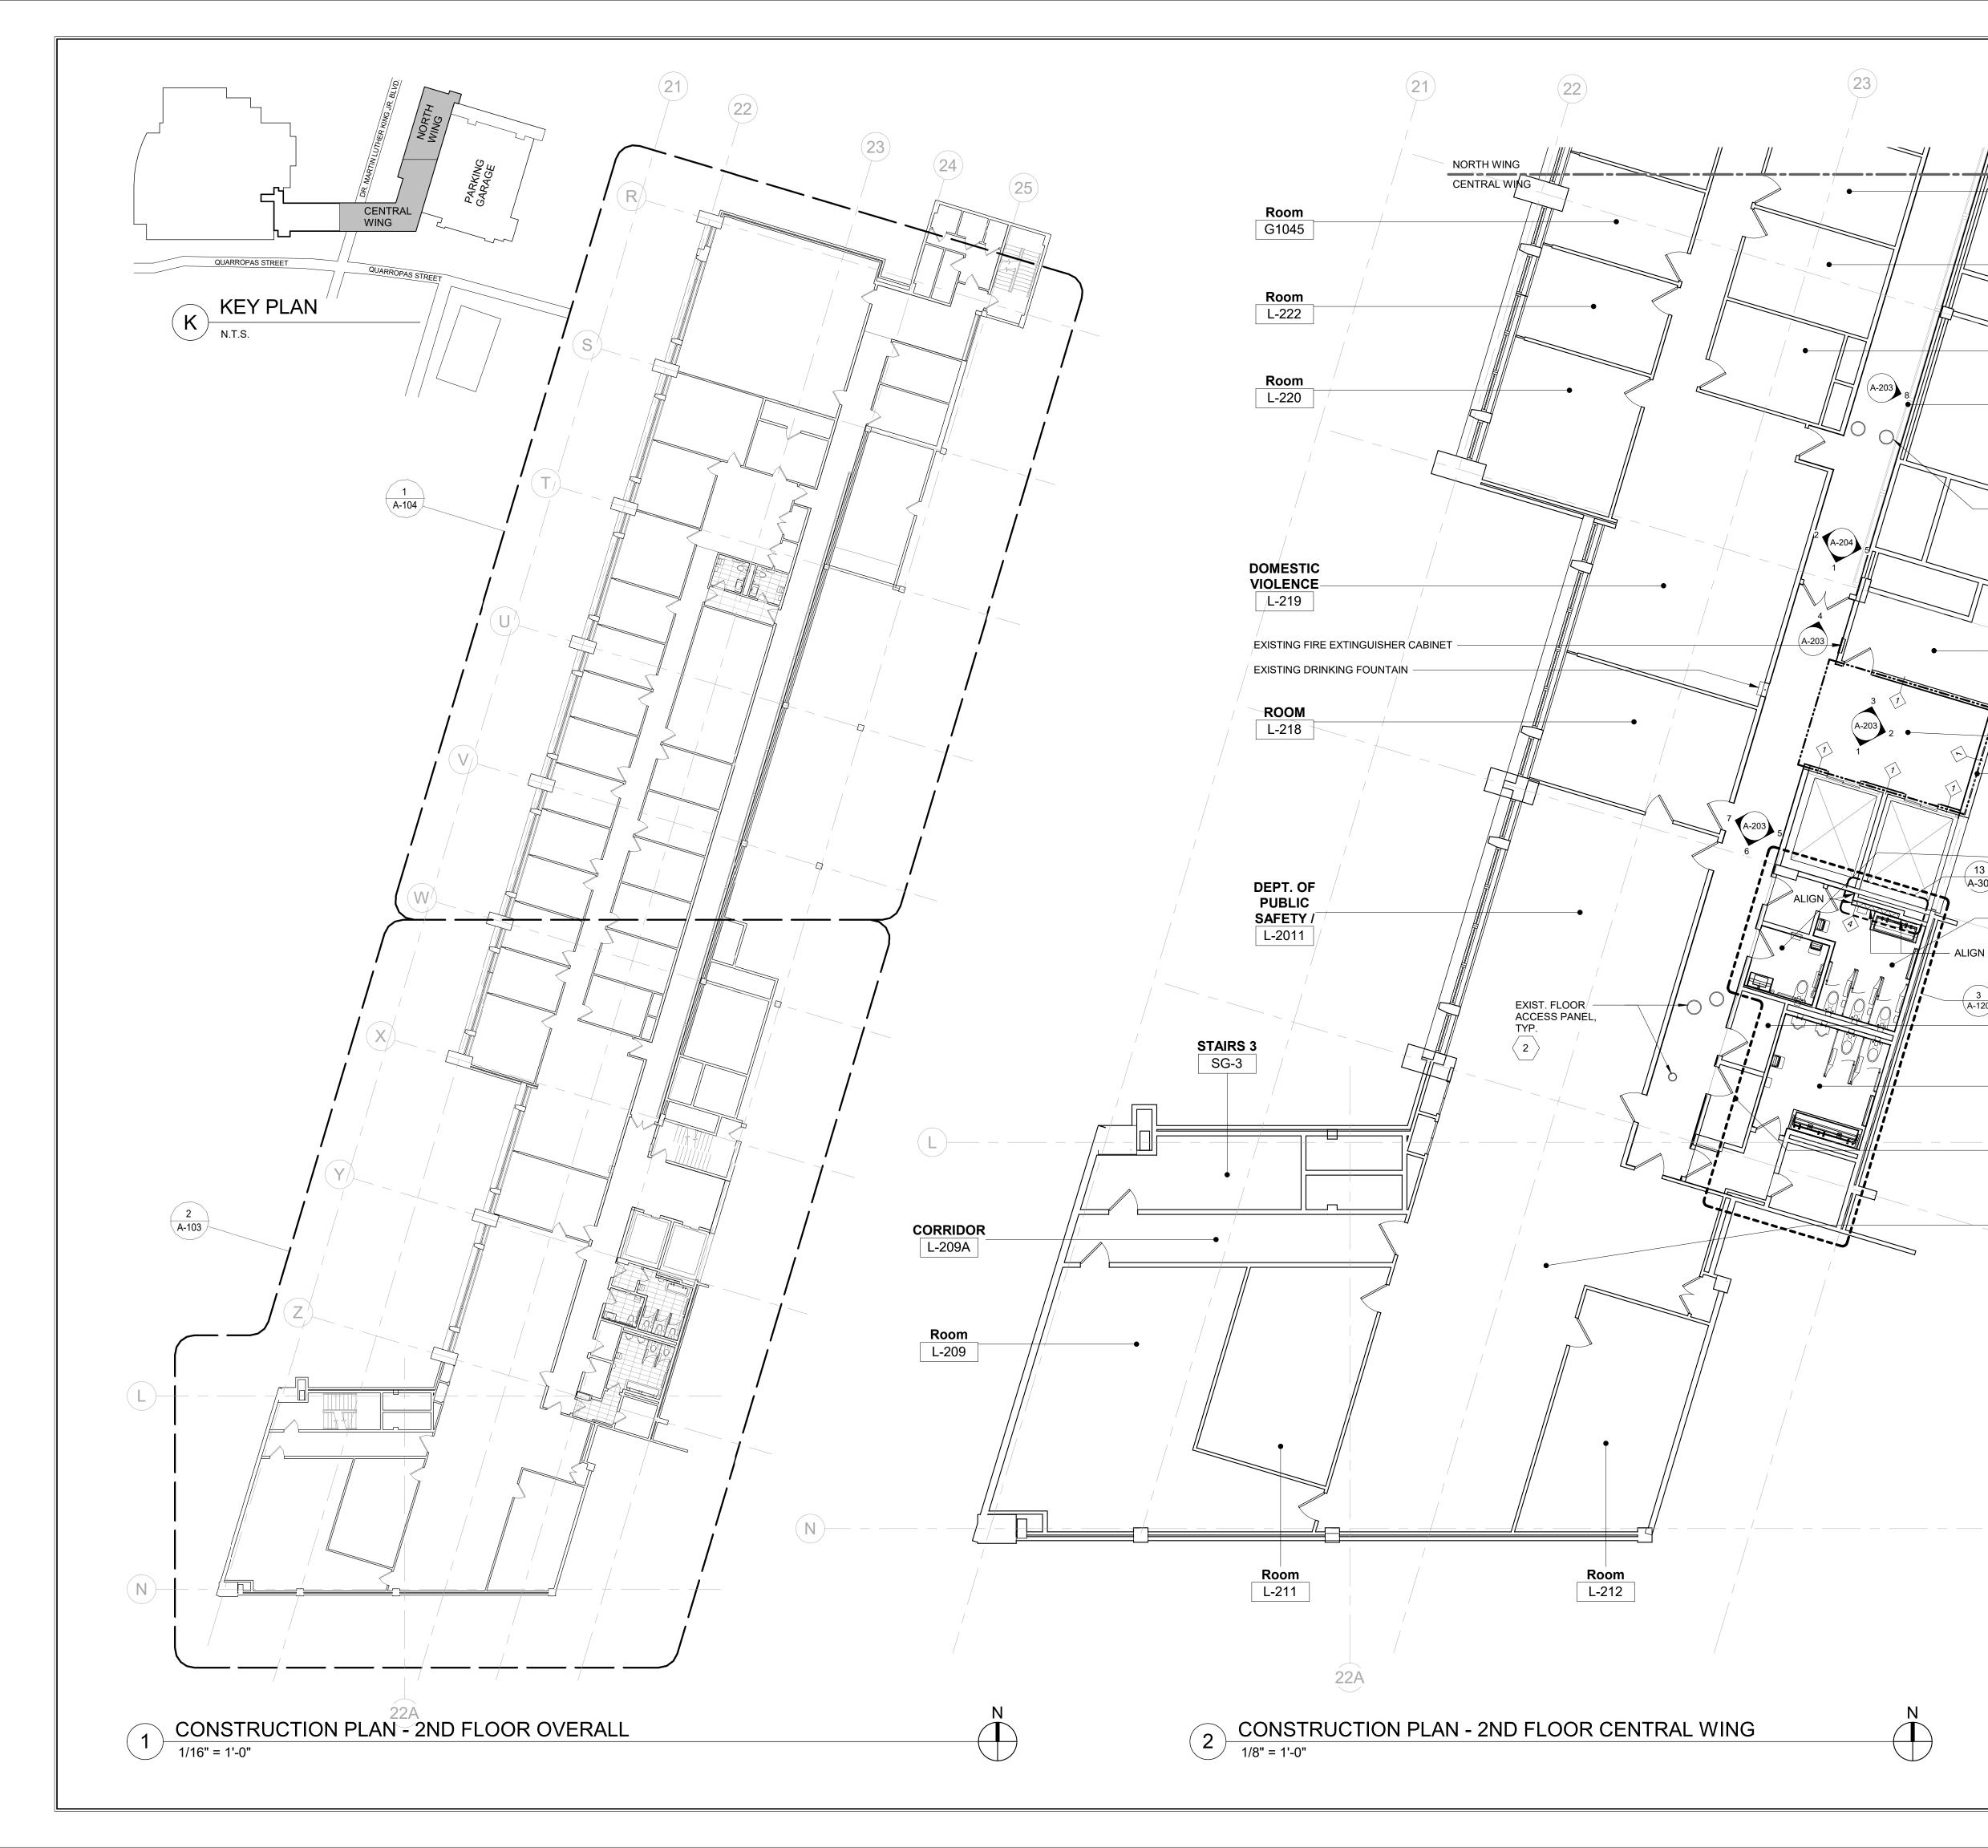

CONSTRUCTION PLAN LEGEND DESCRIPTION SYMBOL -----Room ŢŢ EXISTING COLUMNS TO REMAIN L-225 (WITH OR WITHOUT STEEL PROFILE) (25) EXISTING PARTITIONS/WALLS TO REMAIN Room G1044 EXISTING DOOR & DOOR FRAME TO REMAIN RECEIVE PAINT FINISH WHERE FACING AREA OF WORK EXCEPT NATURAL WOOD DOOR Room - PARTITION L-221 PARTITION TYPE: SEE DETAILS ON A-300 EXISTING BASE BOARD RADIATORS. (W)PROVID∉ PEDESTAL MOUNTED RADIATOR DETAIL SECTION TAG 1 SIM ENCLOSURE PER ENGINEER'S DRAWINGS - DETAIL / SECTION NUMBER & SPECS, TYP. A101 - SHEET NUMBER FINISH TO BE DETERNINED BY ARCHITECT SEE #15/A-300 FOR ADDITIONAL PLAN DETAIL TAG SIM INFORMATION $\overline{}$ 1 🕌 – DETAIL NUMBER A101 SHEET NUMBER - EXISTING FLOOR ACCESS х — INTERIOR ELEVATION TAG PANEL, TYP. x AXXX X ----INTERIOR ELEVATION NUMBER 2 - SHEET NUMBER BUILDING SECTION TAG 1 A101 SECTION NUMBER - SHEET NUMBER - EXISTING COLUMN -- EXISTING GLAZING **STAIRS 2** EXISTING WALL SG-2 - EXISTING FAN COIL WALL MOUNTED IN CABINET FE01 FIRE EXTINGUISHER 2ND FLOOR **EXISTING GLASS FRONT - STORE** - ELEVATOR 1 FRONT SYSTEM L-212 WALK-OFF METAL MAT 1ST FLOOR LOBBY "CS GROUP PEDITRED" GENERAL NOTES: UNISEX ADA RESTROOM 1. PATCH & REPAIR EXISTING WALL/PARTITION AS REQUIRED. PREPARE EXISTING WALLS TO ACCEPT NEW FINISH. L-215 \A-300 2. ALL WORK ON FLOORS BELOW OR ABOVE AND IN ADJACENT WOMEN'S AREAS THAT ARE DISTURBED OR DAMAGED DUE TO WORK RESTROOM RELATED TO THIS PROJECT SHALL BE REPAIRED TO MATCH L-214 PREVIOUS UNDAMAGED CONDITIONS. 3. PATCH, REPAIR, AND FLASH PATCH AT ALL AREAS TO RECEIVE NEW FLOORING TO ENSURE FLOOR SUBSTRATE IS Y LEVEL AND ABLE TO ACCEPT NEW FLOOR FINISH. (3) (A-120) 4. FLOORING CONTRACTOR WHALL ACCEPT CONDITION OF TELECOM FLOOR PRIOR TO START OF ANY FLOORING MATERIAL INSTALLATION. L-216A CONSTRUCTION PLAN KEY NOTES: MEN'S $^{\prime}$ 1 $^{\circ}$ ALL WALL/PARTITION/COLUMN THAT ARE REMAINING SHALL RECEIVE A SKIM COAT LEVEL 4 FINISH OVER THE RESTROOM EXISTING SURFACE AFTER DEMOLITION WORK IS L-216 COMPLETE AND UTILITIES/CONDUITS ARE INSTALLED TO PROVIDE A SMOOTH LEVEL FINISH. ELECTRIC EXISTING OUTLET TO BE EXTENDED AND PLATE

DEPT. OF PUBLIC SAFETY /

L-216B

L-211

90-30 1					f & Lev Architect 61st Street, Jan 3-651-6200 F:	i <mark>s LL</mark> naica,	P	
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WESTCHESTER COUNTY, NEW YORK DEPARTMENT OF PUBLIC WORKS AND TRANSPORTATION						CONTRACT NUMBER 20-502	SHEET NUMBER	
DIVISION OF ENGINEERING						SHEET NO. 18	OF 133	
LOW RISE BUILDING RENOVATIONS AND HVAC IMPROVEMENTS - PHASE II 110 DR. MARTIN LUTHER KING, JR. BOULEVARD WHITE PLAINS, NEW YORK					l	SCALE: DATE: 01-19-2024 DPW FILE NO.	As indicated Issue Date REV	
CONSTRUCTION PLAN - 2ND FLOOR OVERALL & CENTRAL WING					/ING	-	-A-1830-0	


MOUNTED ON TOP OF NEW FINISH.


FLOOR FINISH.

 $\begin{tabular}{|c|c|c|c|c|} \hline $PATCH & INSTALL COMPOUND FIT FLOOR ACCESS \\ PANELS TO PROVIDE SMOOTH SURFACE FOR NEW \end{tabular}$


QUARROPAS STREET QUARROPAS ST KEY PLAN

TAX

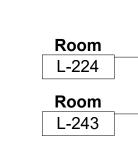

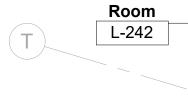

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CONSTRUCTION PLAN LEGEND							
SYMBOL	DESCRIPTION						
	EXISTING COLUMNS TO REMAIN (WITH OR WITHOUT STEEL PROFILE)						
	EXISTING PARTITIONS/WALLS TO REMAIN						
	EXISTING DOOR & DOOR FRAME TO REMAIN RECEIVE PAINT FINISH WHERE FACING AREA OF WORK EXCEPT NATURAL WOOD DOOR						
	 PARTITION PARTITION TYPE: SEE DETAILS ON A-300 						
1 A101	DETAIL SECTION TAG — DETAIL / SECTION NUMBER — SHEET NUMBER						
SIM A101	PLAN DETAIL TAG — DETAIL NUMBER — SHEET NUMBER						
	INTERIOR ELEVATION TAG — INTERIOR ELEVATION NUMBER — SHEET NUMBER						
1 A101	BUILDING SECTION TAG — SECTION NUMBER — SHEET NUMBER						
	- EXISTING COLUMN - EXISTING GLAZING - EXISTING WALL						
	EXISTING FAN COIL WALL MOUNTED IN CABINET FE01 FIRE EXTINGUISHER						
(EXISTING GLASS FRONT - STORE FRONT SYSTEM						
	WALK-OFF METAL MAT 1ST FLOOR LOBBY "CS GROUP PEDITRED"						

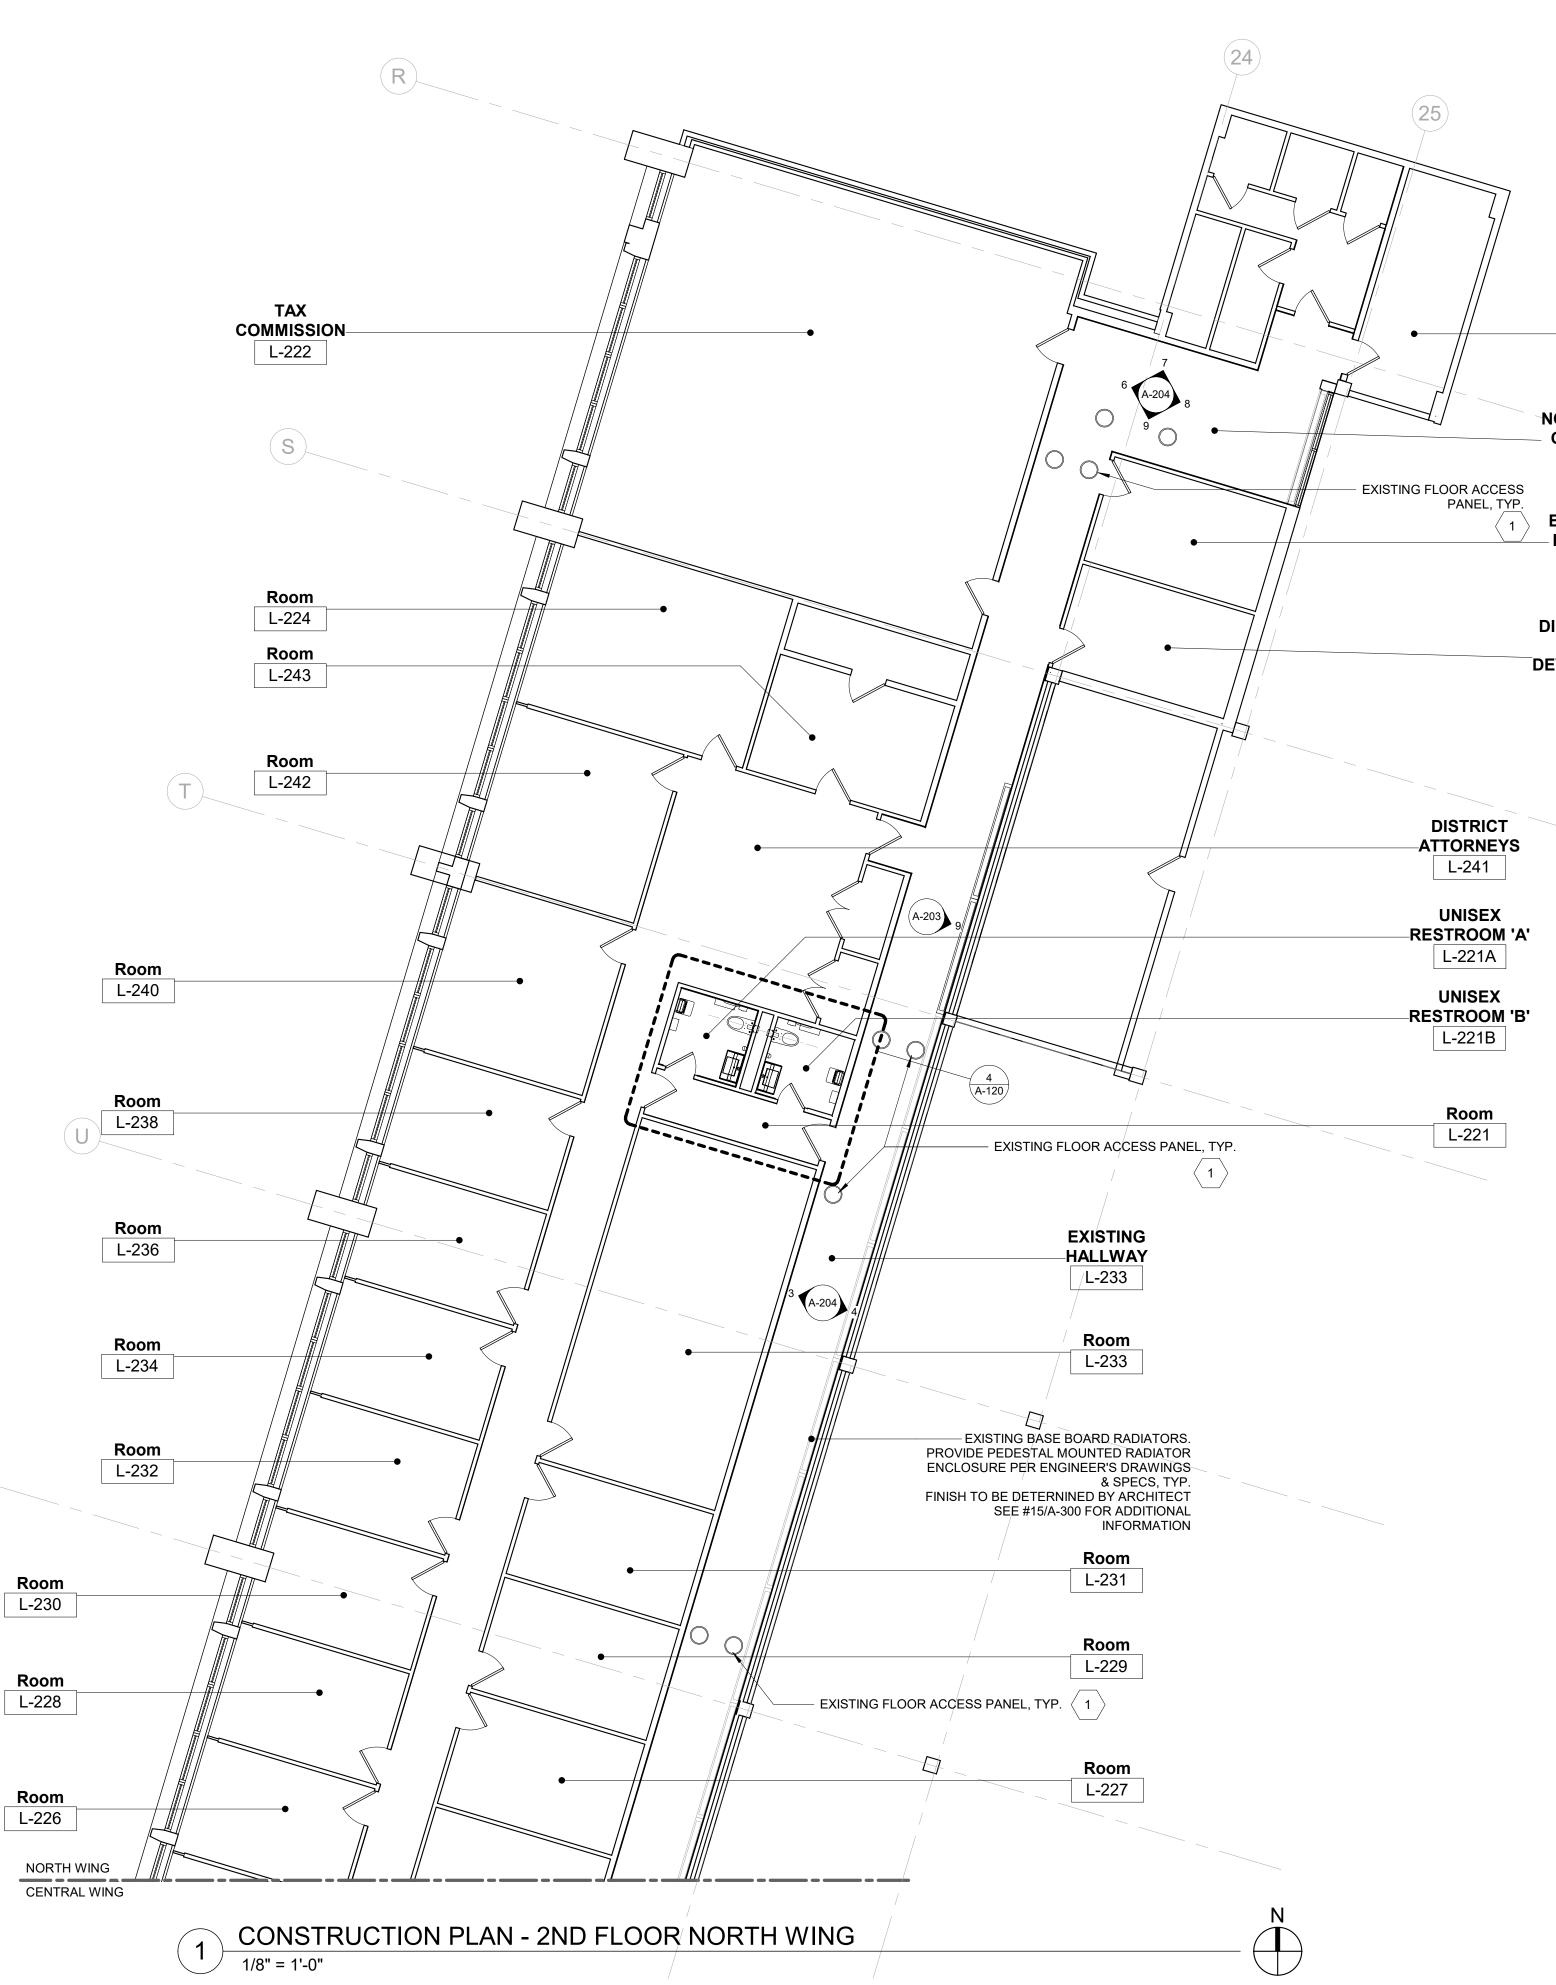GENERAL NOTES:

1. PATCH & REPAIR EXISTING WALL/PARTITION AS REQUIRED. PREPARE EXISTING WALLS TO ACCEPT NEW FINISH.

2. ALL WORK ON FLOORS BELOW OR ABOVE AND IN ADJACENT AREAS THAT ARE DISTURBED OR DAMAGED DUE TO WORK RELATED TO THIS PROJECT SHALL BE REPAIRED TO MATCH PREVIOUS UNDAMAGED CONDITIONS.

3. PATCH, REPAIR, AND FLASH PATCH AT ALL AREAS TO RECEIVE NEW FLOORING TO ENSURE FLOOR SUBSTRATE IS LEVEL AND ABLE TO ACCEPT NEW FLOOR FINISH.

4. FLOORING CONTRACTOR WHALL ACCEPT CONDITION OF FLOOR PRIOR TO START OF ANY FLOORING MATERIAL INSTALLATION.

CONSTRUCTION PLAN KEY NOTES:

1 PATCH & INSTALL COMPOUND FIT FLOOR ACCESS PANELS TO PROVIDE SMOOTH SURFACE FOR NEW FLOOR FINISH.

CONSULTANT SEAL CONSULTANT INFORMATION							
					Architects I		
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DIVISION OF ENGINEERING						SHEET NO. 19	OF 133
LOW RISE BUILDING RENOVATIONS AND HVAC IMPR				• • • • • • • • • • • • • • • • • • • •	SCALE:	1/8" = 1'-0"	
110 DR. MARTIN LUTHER KING, JR. BOU WHITE PLAINS, NEW YORK					LEVARD	DATE: 01-19-2024	
CONSTRUCTION PLAN - 2ND FLOOR - NO					NORTH WING	DPW FILE NO. 52-11-/	4-1831-0

STAIR 1 SG-1


NORTH WING CORRIDOR L-200

EXECUTIVE L-223

DIRECTOR OF PROJECT DEVELOPMENT L-224

PARA GARA CENTRAL WING QUARROPAS STREET QUARROPAS STRE K KEY PLAN



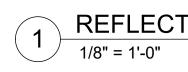

REFLECTED CEILING PLAN - 1ST FLOOR - CENTRAL WING 1/8" = 1'-0"



25

REFLECTI	/E CEILING PLAN LEGEND
SYMBOL	DESCRIPTION
	2'x2' ACOUSTICAL CEILING SYSTEM CEILING TYPE 1 (ACT-1)
	2'X4' ACOUSTICAL CEILING SYSTEM CEILING TYPE 2 (ACT-2) AT INNER HALLWAY
	GYPSUM BOARD CEILING AND SOFFITS
	EXISTING GYPSUM BOARD SOFFITS & FASCIA
F1 F1A	NEW LIGHT FIXTURES SEE LIGHT FIXTURE SCHEDULE ON A-304
□ F2 □ F3	
E E	EXISTING LIGHT FIXTURE TO BE REINSTALLED
	NEW DIFFUSER & RETURN REGISTER SEE ENGINEERING DRAWINGS LOCATION PER ENGINEERING DRAWINGS
DF	NEW LINEAR CEILING DIFFUSER
۲	NEW SPRINKLER HEAD SEE ENGINEERING DRAWINGS
(SD) E	EXISTING SMOKE DETECTOR
SD	NEW SMOKE DETECTOR
ES-1	NEW EXIT SIGN - CEILING MOUNTED SEE SCHEDULE ON A-30X — DIRECTIONAL ARROWS (TYP.)
€	EXISTING EXIT SIGN - WALL MOUNTED
⊗ E	EXISTING EXIT SIGN - CEILING MOUNTED

GENERAL NOTES:

1. ALL DEVICES SUCH AS SMOKE DETECTORS, OCCUPANCY SENSORS, CEILING MOUNTED CAMERA, MIC, SPEAKER, ETC. ARE TO BE LOCATED IN THE CENTER OF THE CEILING TILES

2. ALL SUSPENDED CEILINGS TO BE INSTALLED AT HEIGHT OF EXISTING FINISH CEILING.

3. ACOUSTICAL CEILING TILE GRID ALIGN WITH EXISTING DIFFUSER & RETURN GRILL.


4. PROVIDE FINISH AT EXISTING GYPSUM BOARD CEILING. PAINT TO MATCH EXISTING.

5. ALL LIGHT FIXTURES ARE TO BE LOCATED IN THE CENTER OF CEILING TILES.

CONSULTANT SEAL		CONSULTANT	90)-30 1	f & Lewe Architects L 61st Street, Jamaic 8-651-6200 F: 718	LP	
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	E BUILDING 110 DR	MARTIN LUT WHITE PL	NS AND HVA HER KING, AINS, NEW	AC IMPR JR. BOU YORK	OVEMENTS - PHASE II	SHEET NO. 20 SCALE: DATE: 01-19-2024 DPW FILE NO.	1/8" = 1'-0"

QUARROPAS STREET K KEY PLAN

L-102K

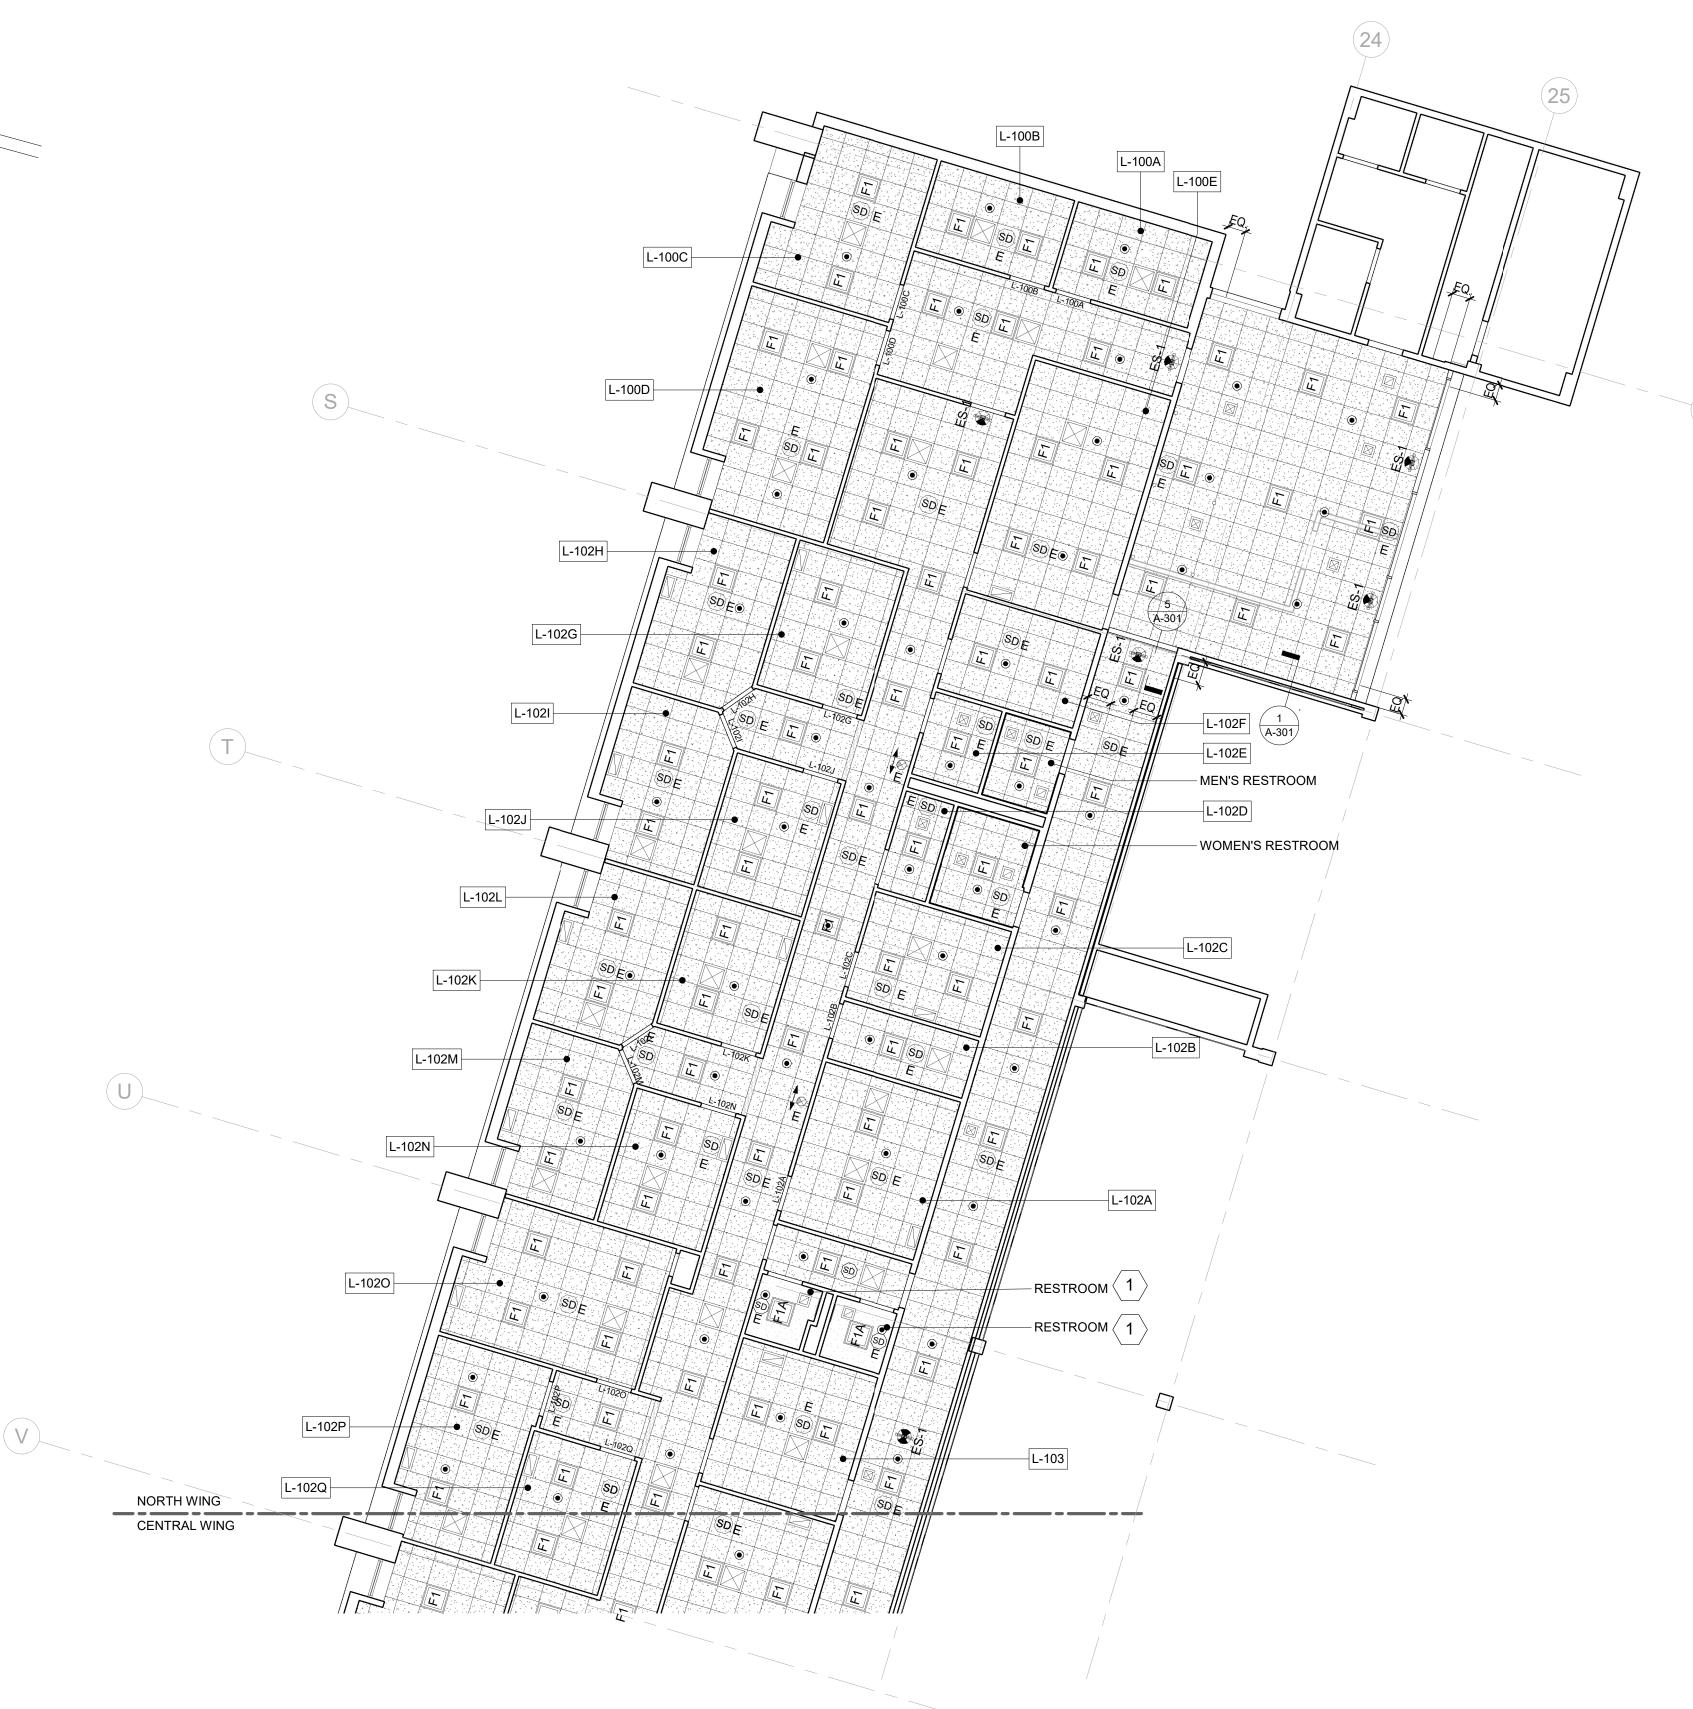



REFLECTED CEILING PLAN - 1ST FLOOR - NORTH WING



REFLECTI	/E CEILING PLAN LEGEND
SYMBOL	DESCRIPTION
	2'x2' ACOUSTICAL CEILING SYSTEM CEILING TYPE 1 (ACT-1)
	2'X4' ACOUSTICAL CEILING SYSTEM CEILING TYPE 2 (ACT-2) AT INNER HALLWAY
	GYPSUM BOARD CEILING AND SOFFITS
	EXISTING GYPSUM BOARD SOFFITS & FASCIA
F1 F1A F2 F3	NEW LIGHT FIXTURES SEE LIGHT FIXTURE SCHEDULE ON A-304
E E	EXISTING LIGHT FIXTURE TO BE REINSTALLED
	NEW DIFFUSER & RETURN REGISTER SEE ENGINEERING DRAWINGS LOCATION PER ENGINEERING DRAWINGS
DF	NEW LINEAR CEILING DIFFUSER
۲	NEW SPRINKLER HEAD SEE ENGINEERING DRAWINGS
SD E	EXISTING SMOKE DETECTOR
SD	NEW SMOKE DETECTOR
ES-1	NEW EXIT SIGN - CEILING MOUNTED SEE SCHEDULE ON A-30X — DIRECTIONAL ARROWS (TYP.)
€	EXISTING EXIT SIGN - WALL MOUNTED
⊗ E	EXISTING EXIT SIGN - CEILING MOUNTED

GENERAL NOTES:

1. ALL DEVICES SUCH AS SMOKE DETECTORS, OCCUPANCY SENSORS, CEILING MOUNTED CAMERA, MIC, SPEAKER, ETC. ARE TO BE LOCATED IN THE CENTER OF THE CEILING TILES

2. ALL SUSPENDED CEILINGS TO BE INSTALLED AT HEIGHT OF EXISTING FINISH CEILING.

3. ACOUSTICAL CEILING TILE GRID ALIGN WITH EXISTING DIFFUSER & RETURN GRILL.

4. PROVIDE FINISH AT EXISTING GYPSUM BOARD CEILING. PAINT TO MATCH EXISTING.

5. ALL LIGHT FIXTURES ARE TO BE LOCATED IN THE CENTER OF CEILING TILES.

REFLECTED CEILING PLAN KEY NOTES:

 1
 EXISTING GYPSUM BOARD CEILING TO BE REPAIRED AND REPAINT AFTER LIGHT FIXTURE REPLACEMENT.

CONSULTANT SEAL		CONSULTANT	90)-30 1	f & Lewe Architects I 61st Street, Jamaic 3-651-6200 F: 718	LLP	
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LOW RISE		MARTIN LUT	NS AND HVA THER KING, J AINS, NEW	JR. BOU	OVEMENTS - PHASE II LEVARD	SCALE: DATE: 01-19-2024	
REFLE	CTED CE				R - NORTH WING	DPW FILE NO. 52-11-	-A-1833-0

PARI GARA CENTRAL WING QUARROPAS STREET QUARROPAS ST' KEY PLAN

STAIR 3 (SG-3) ES-1 • • F1 CORRIDOR (L-209A) ES-1 (N)L-209





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REFLECTIV	VE CEILING PLAN LEGEND
SYMBOL	DESCRIPTION
	2'x2' ACOUSTICAL CEILING SYSTEM CEILING TYPE 1 (ACT-1)
	2'X4' ACOUSTICAL CEILING SYSTEM CEILING TYPE 2 (ACT-2) AT INNER HALLWAY
	GYPSUM BOARD CEILING AND SOFFITS
	EXISTING GYPSUM BOARD SOFFITS & FASCIA
F1 F1A F2 F3	NEW LIGHT FIXTURES SEE LIGHT FIXTURE SCHEDULE ON A-304
E E	EXISTING LIGHT FIXTURE TO BE REINSTALLED
	NEW DIFFUSER & RETURN REGISTER SEE ENGINEERING DRAWINGS LOCATION PER ENGINEERING DRAWINGS
DF	NEW LINEAR CEILING DIFFUSER
۲	NEW SPRINKLER HEAD SEE ENGINEERING DRAWINGS
SD E	EXISTING SMOKE DETECTOR
SD	NEW SMOKE DETECTOR
ES-1	NEW EXIT SIGN - CEILING MOUNTED SEE SCHEDULE ON A-30X — DIRECTIONAL ARROWS (TYP.)
, ↓ E E	EXISTING EXIT SIGN - WALL MOUNTED
⊗ E	EXISTING EXIT SIGN - CEILING MOUNTED

GENERAL NOTES:

(25)

1. ALL DEVICES SUCH AS SMOKE DETECTORS, OCCUPANCY SENSORS, CEILING MOUNTED CAMERA, MIC, SPEAKER, ETC. ARE TO BE LOCATED IN THE CENTER OF THE CEILING TILES

2. ALL SUSPENDED CEILINGS TO BE INSTALLED AT HEIGHT OF EXISTING FINISH CEILING.

3. ACOUSTICAL CEILING TILE GRID ALIGN WITH EXISTING DIFFUSER & RETURN GRILL.

4. PROVIDE FINISH AT EXISTING GYPSUM BOARD CEILING. PAINT TO MATCH EXISTING.

5. ALL LIGHT FIXTURES ARE TO BE LOCATED IN THE CENTER OF CEILING TILES.

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	110 DR.	MARTIN LUT WHITE PL	HER KING, AINS, NEW	JR. BOU YORK	OVEMENTS - PHASE II ILEVARD - CENTRAL WING	SCALE: DATE: 01-19-2024 DPW FILE NO. 52-11-	1/8" = 1'-0" Issue Date A-1834-0


QUARROPAS STREET K KEY PLAN

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EXISTING GYP. BD. DROP CÉILING PROVIDE NEW FINISH, TYP. W NORTH WING





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REFLECTIVE CEILING PLAN LEGEND						
SYMBOL	DESCRIPTION					
	2'x2' ACOUSTICAL CEILING SYSTEM CEILING TYPE 1 (ACT-1)					
	2'X4' ACOUSTICAL CEILING SYSTEM CEILING TYPE 2 (ACT-2) AT INNER HALLWAY					
	GYPSUM BOARD CEILING AND SOFFITS					
	EXISTING GYPSUM BOARD SOFFITS & FASCIA					
☐ F1 F1A □ F2	NEW LIGHT FIXTURES SEE LIGHT FIXTURE SCHEDULE ON A-304					
F 3						
E E	EXISTING LIGHT FIXTURE TO BE REINSTALLED					
	NEW DIFFUSER & RETURN REGISTER SEE ENGINEERING DRAWINGS LOCATION PER ENGINEERING DRAWINGS					
DF	NEW LINEAR CEILING DIFFUSER					
۲	NEW SPRINKLER HEAD SEE ENGINEERING DRAWINGS					
SD E	EXISTING SMOKE DETECTOR					
(SD)	NEW SMOKE DETECTOR					
ES-1	NEW EXIT SIGN - CEILING MOUNTED SEE SCHEDULE ON A-30X — DIRECTIONAL ARROWS (TYP.)					
Ĕ	EXISTING EXIT SIGN - WALL MOUNTED					
⊗ E	EXISTING EXIT SIGN - CEILING MOUNTED					

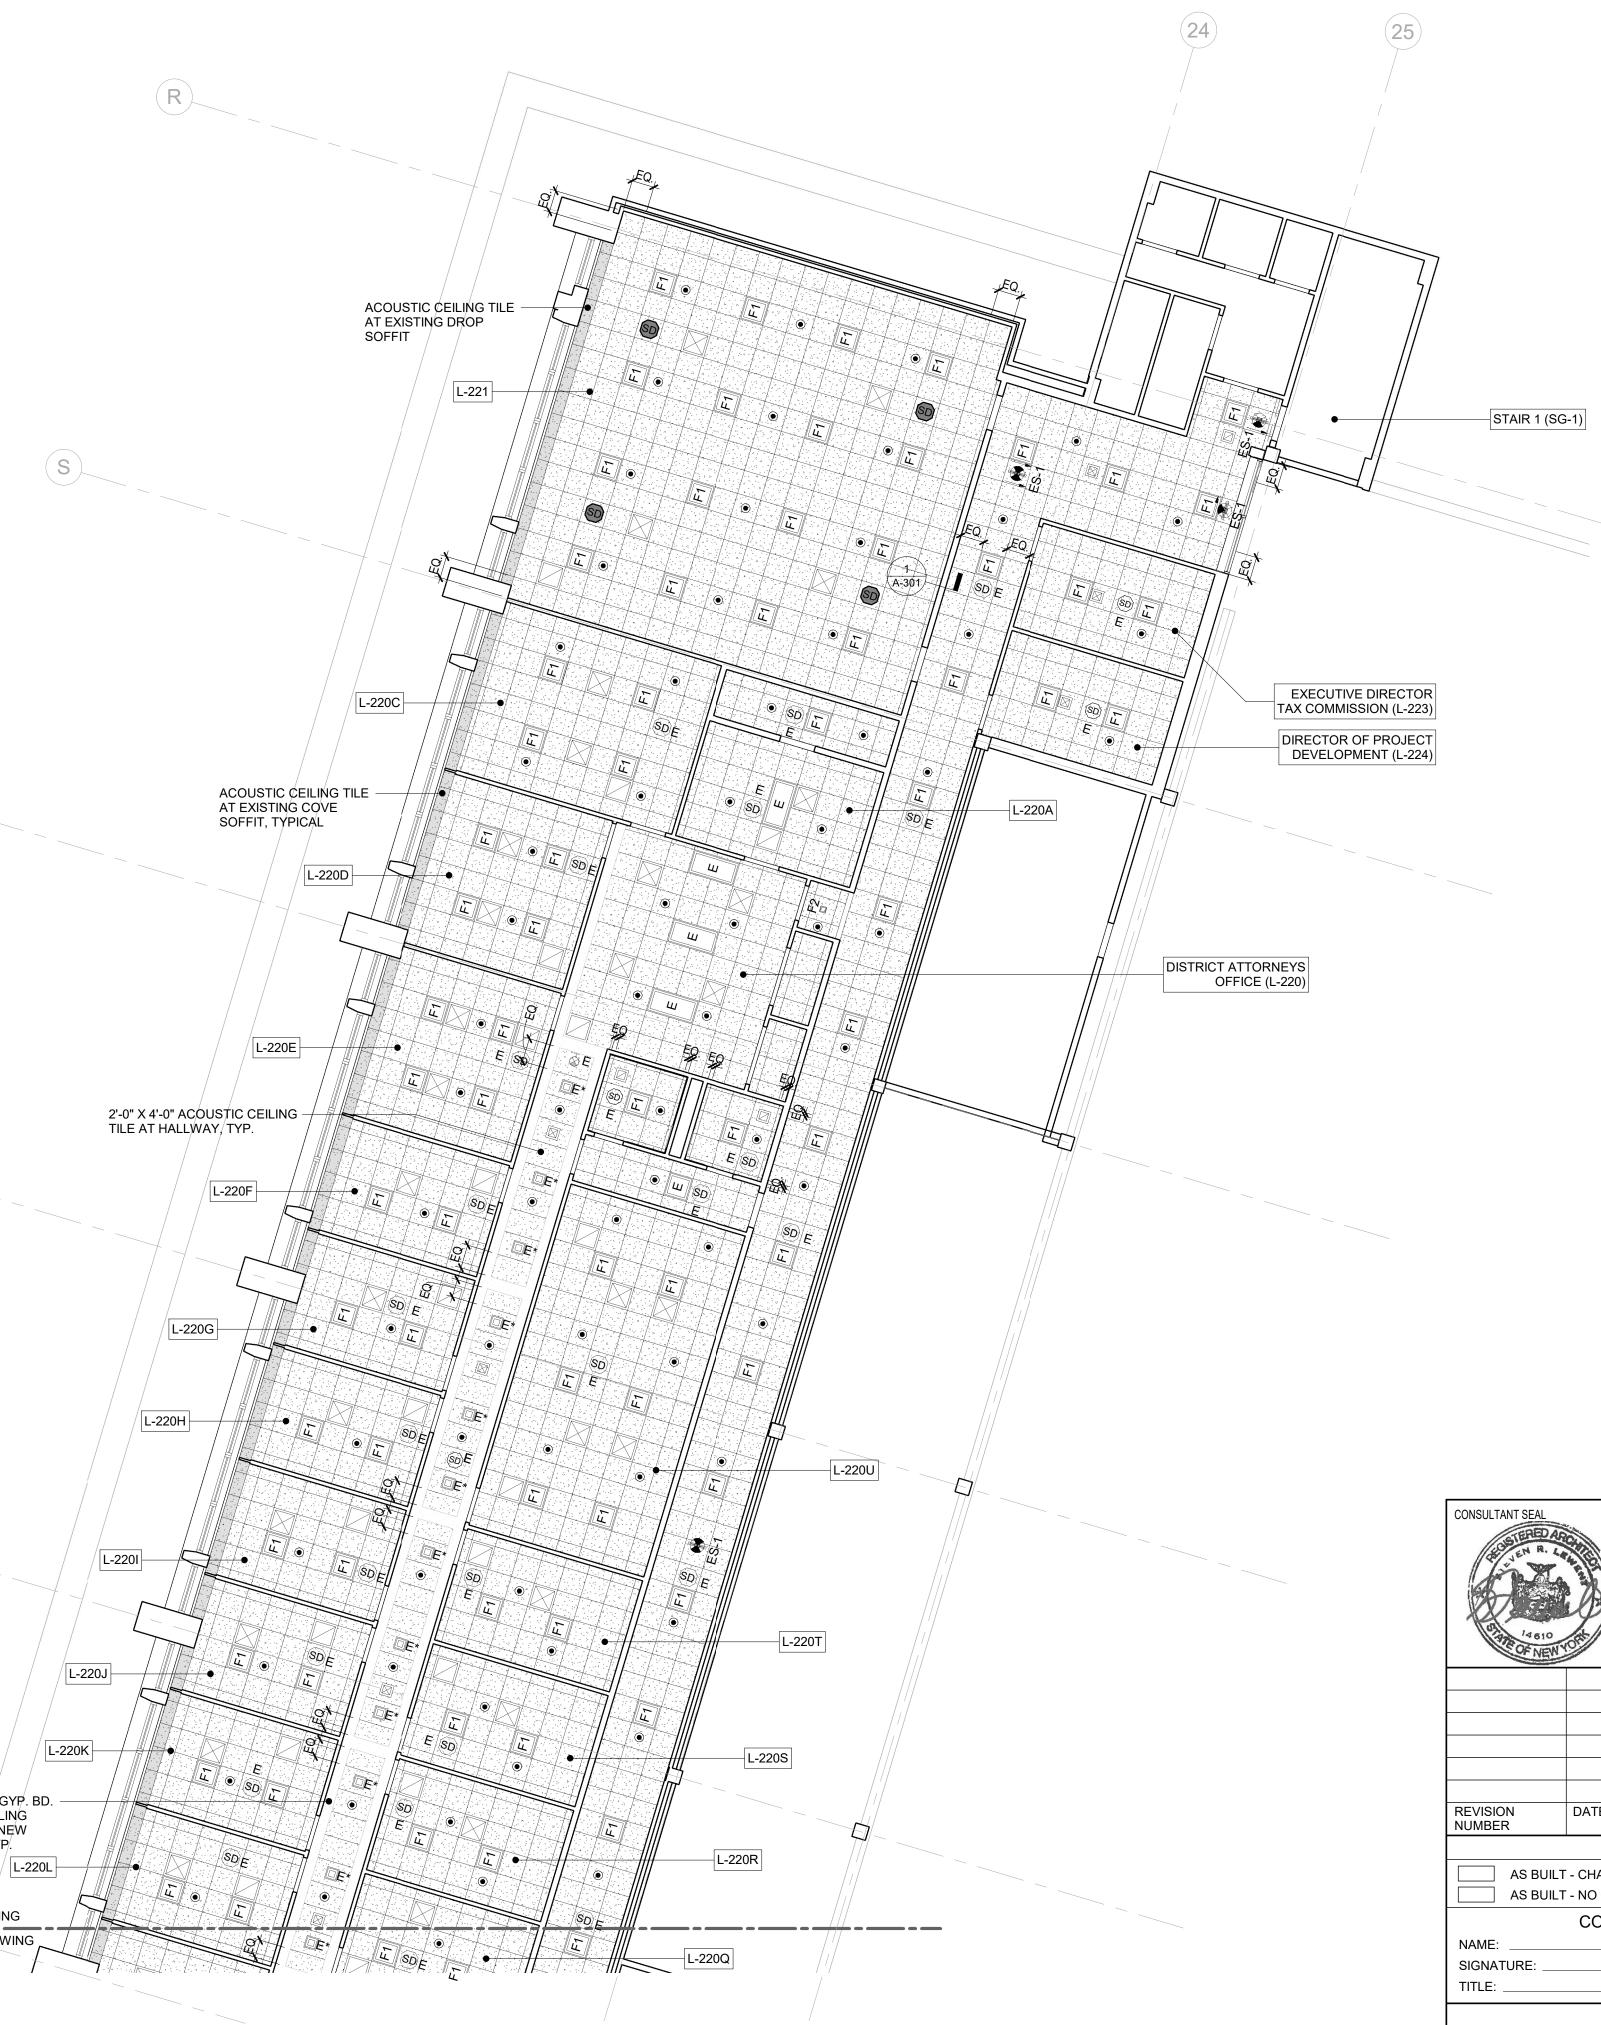GENERAL NOTES:

1. ALL DEVICES SUCH AS SMOKE DETECTORS, OCCUPANCY SENSORS, CEILING MOUNTED CAMERA, MIC, SPEAKER, ETC. ARE TO BE LOCATED IN THE CENTER OF THE CEILING TILES


2. ALL SUSPENDED CEILINGS TO BE INSTALLED AT HEIGHT OF EXISTING FINISH CEILING.

3. ACOUSTICAL CEILING TILE GRID ALIGN WITH EXISTING DIFFUSER & RETURN GRILL.

4. PROVIDE FINISH AT EXISTING GYPSUM BOARD CEILING. PAINT TO MATCH EXISTING.

5. ALL LIGHT FIXTURES ARE TO BE LOCATED IN THE CENTER OF CEILING TILES.


CONSULTANT SEAL		CONSULTANT	90)-30 1	f & Lewe Architects I 61st Street, Jamaic 8-651-6200 F: 718	LLP	
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	BUILDING F 110 DR.	RENOVATIOI MARTIN LUT WHITE PL	NS AND HVA THER KING, AINS, NEW	AC IMPR JR. BOU YORK	OVEMENTS - PHASE II	SCALE: DATE: 01-19-2024 DPW FILE NO.	1/8" = 1'-0"

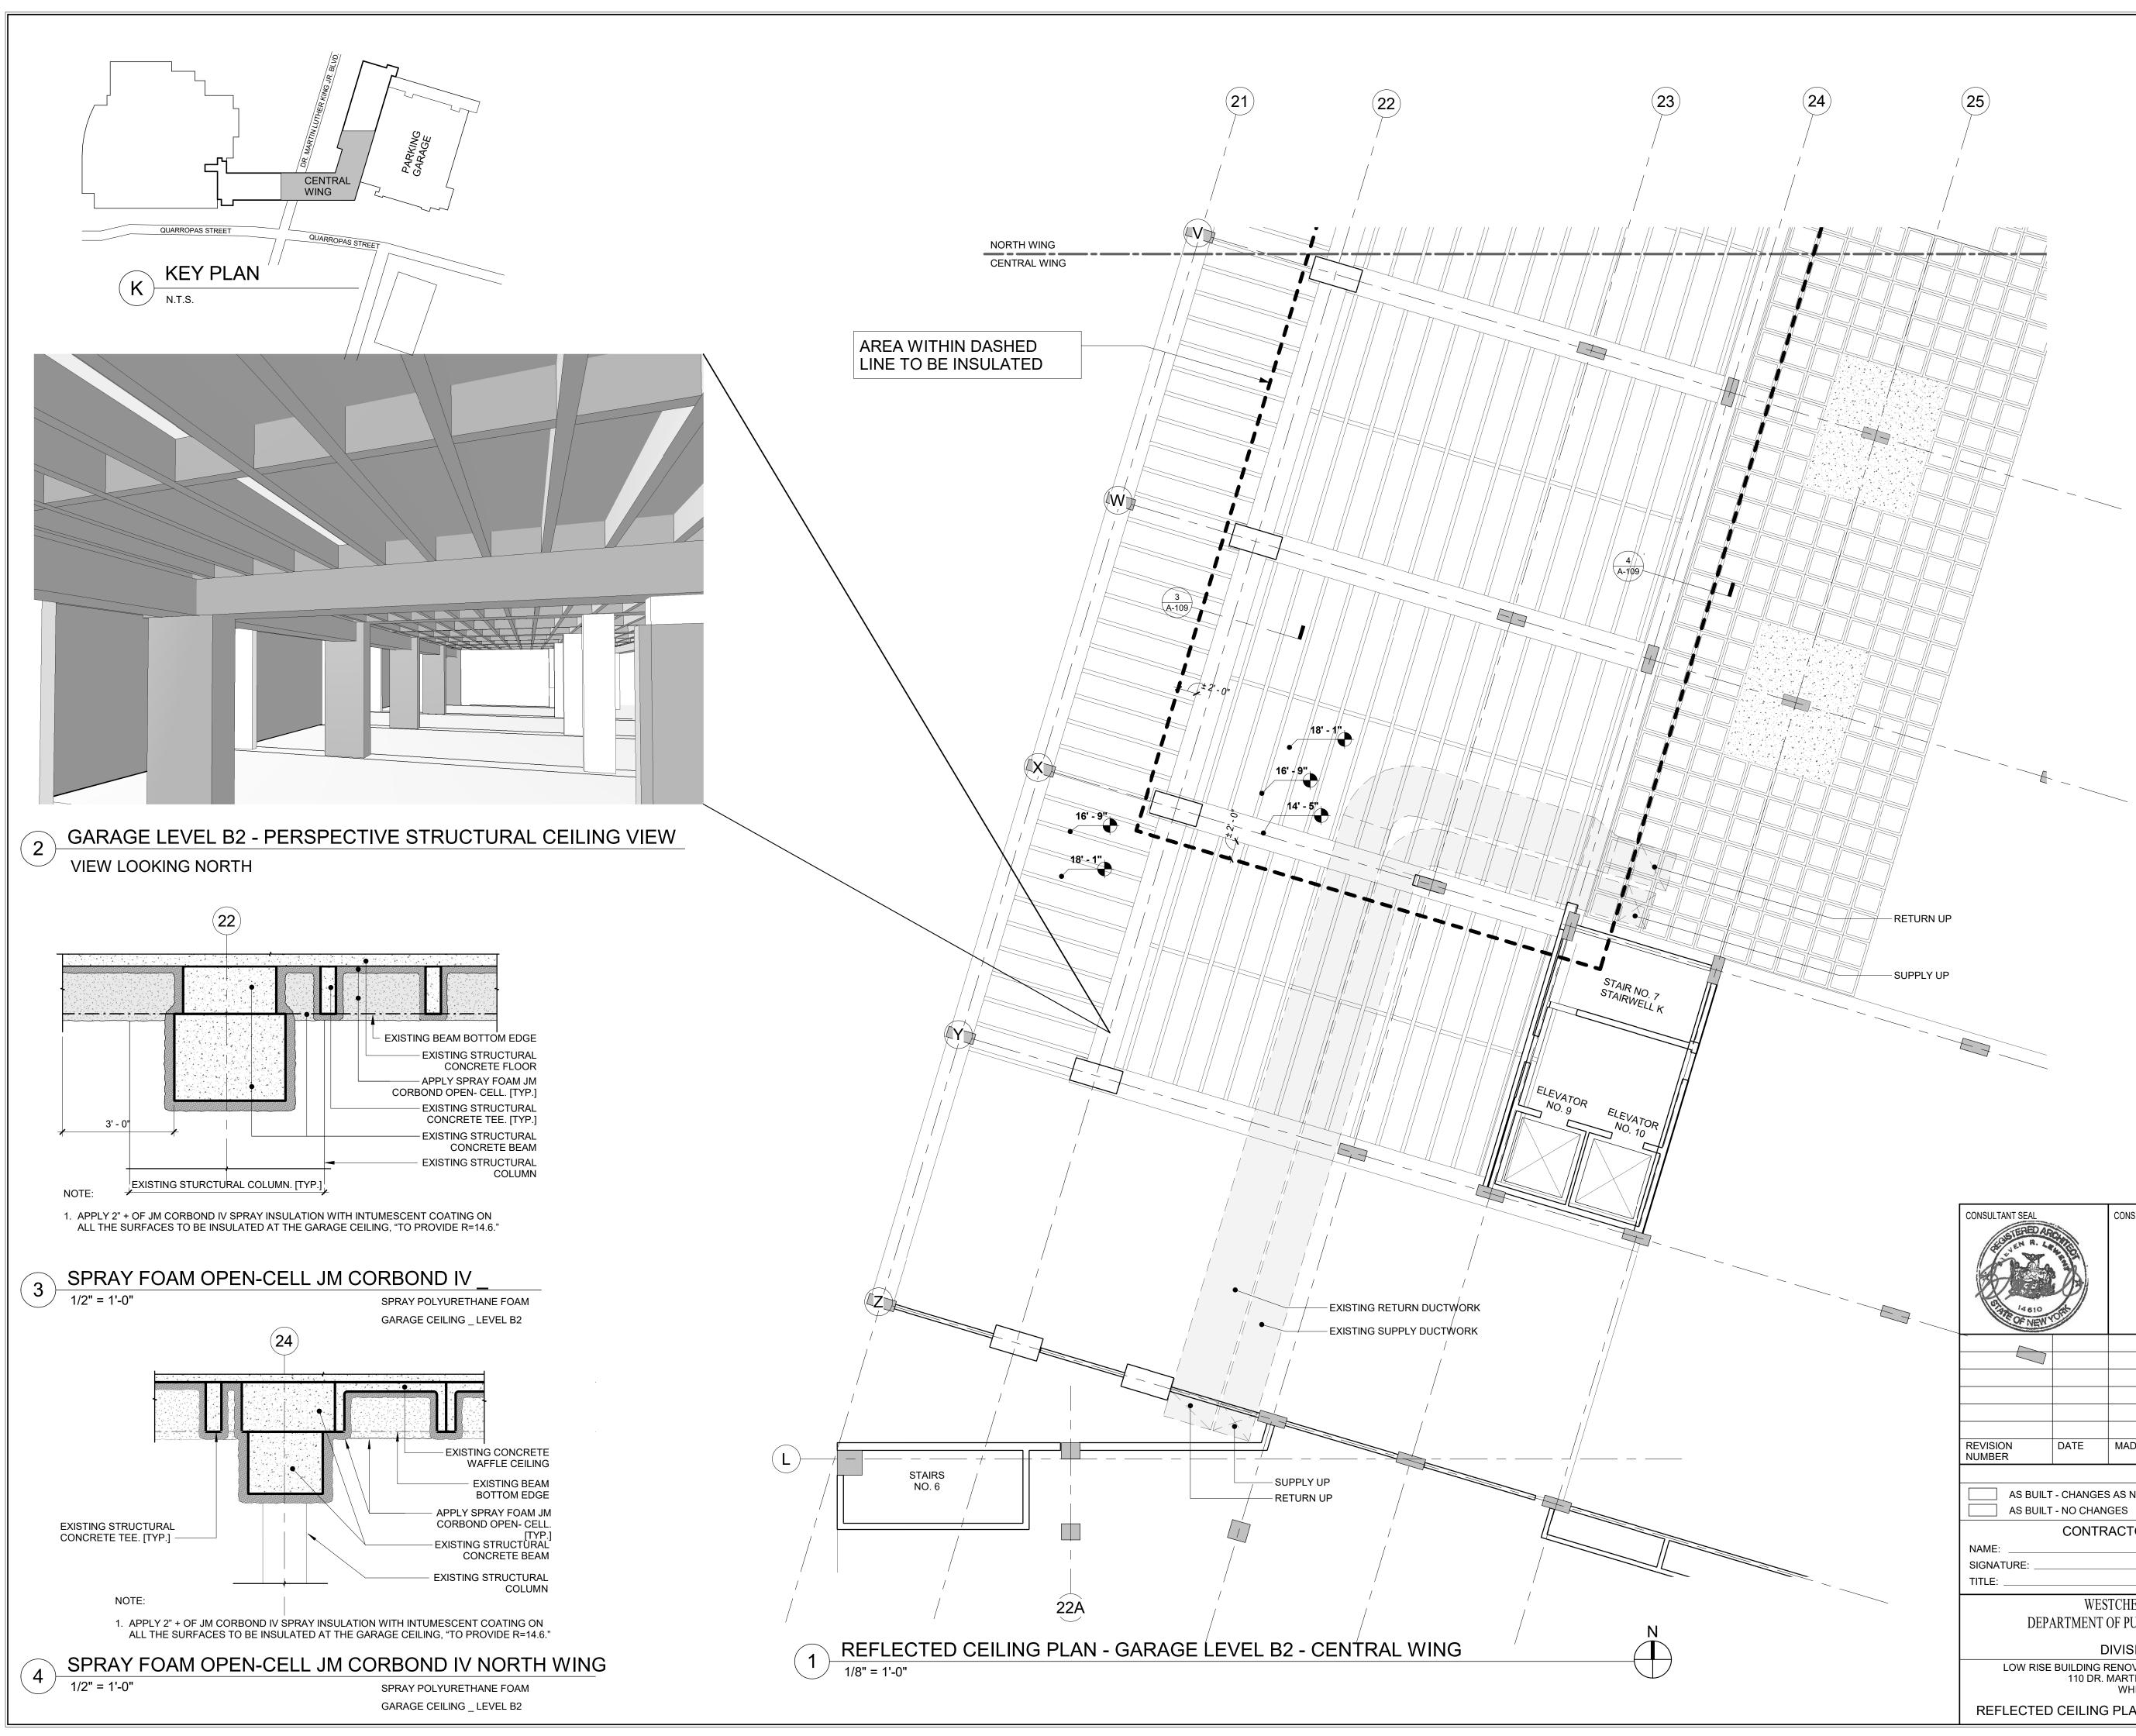


	VE CEILING PLAN LEGEND ARAGE LEVEL B2
SYMBOL	DESCRIPTION
	— EXISTING BEAM — EXISTING COLUMN
	— EXISTING BEAM
	- EXISTING COLUMN
	— EXISTING CONCRETE FILL — EXISTING COLUMN
	EXISTING STRUCTURAL CONCRETE TEE
	EXISTING STRUCTURAL CONCRETE WAFFLE CEILING
RETURN	EXISTING SUPPLY AND RETURN DUCT WORK. SEE MECH. DWG M-101 FOR INSULATION.

- 1. WITHIN AREA TO BE INSULATED, APPLY MANVILLE CORBOND IV IN THICKNESS REQUIRED TO PROVIDE R=14.6. APPLY MANVILLE FIRE SAFETY INTUMESCENT NO BURN OVER SPRAYED INSULATION. MAKE ACCOMMODATIONS FOR APPLICATION ABOVE AND AROUND EXISTING DUCTS, PIPES, ETC.
- 2. COORDINATE ALL WORK WITH PARKING GARAGE REHABILITATION PROJECT WHICH INCLUDES CONCRETE PATCHING & SPRINKLER REPLACEMENT. PROTECT ALL EXISTING HVAC, SPRINKLERS, LIGHT FIXTURES, ETC.
- 3. PRIOR TO INSULATION INSTALLATION, ENSURE THAT ALL COMPONENTS OF NEW SYSTEMS REQUIRED TO BE INSTALLED PRIOR TO INSULATION SPRAY ON ARE IN PLACE.

7	CONSULTANT SEAL		CONSULTANT	90)-30 1	& Lewe Architects L 61st Street, Jamaica 3-651-6200 F: 718	LP	
	REVISION	DATE	MADE BY	APP'D BY		REVIS	SION	
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	DEPA	ARTMENT	OF PUBLIC	COUNTY, WORKS AI	ND TRA	NSPORTATION	CONTRACT NUMBER 20-502 SHEET NO. 24	SHEET NUMBER A-109 OF 133
		BUILDING F 110 DR.	RENOVATION MARTIN LUT WHITE PL	NS AND HVA HER KING, AINS, NEW	AC IMPRO JR. BOU YORK	OVEMENTS - PHASE II	SCALE: DATE: 01-19-2024 DPW FILE NO. 52-11-	As indicated Issue Date REV A-1836-0

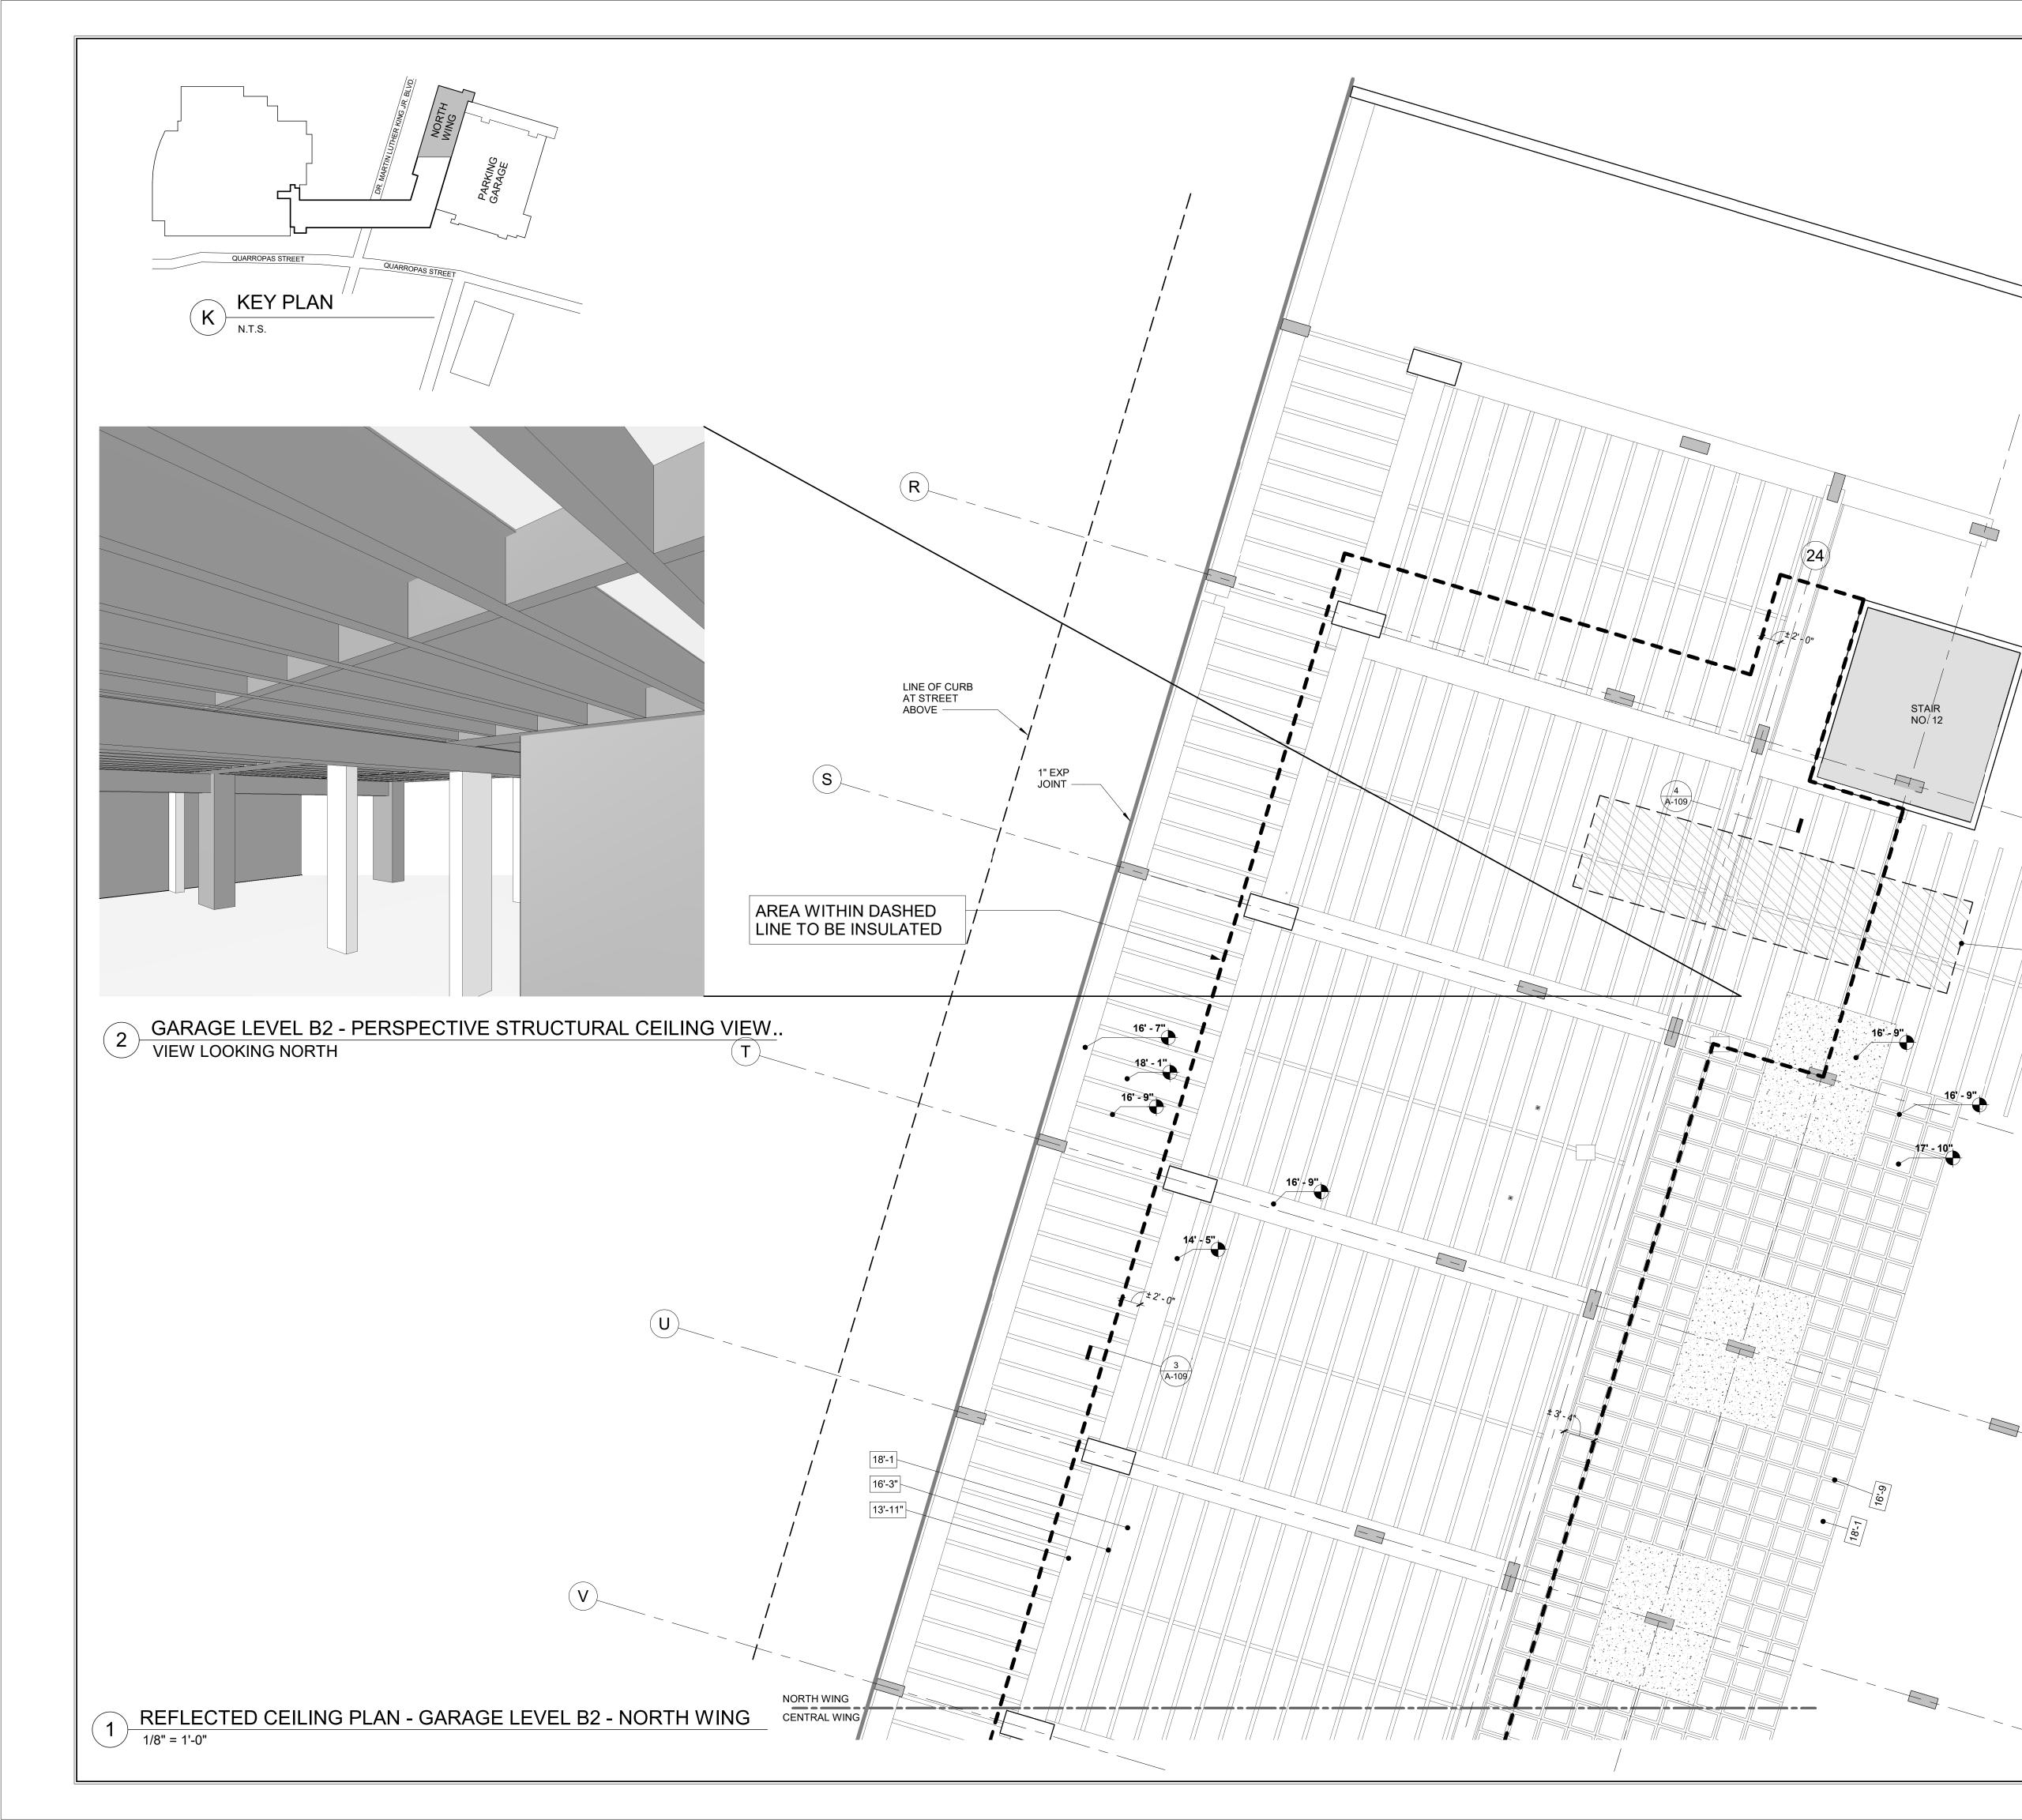

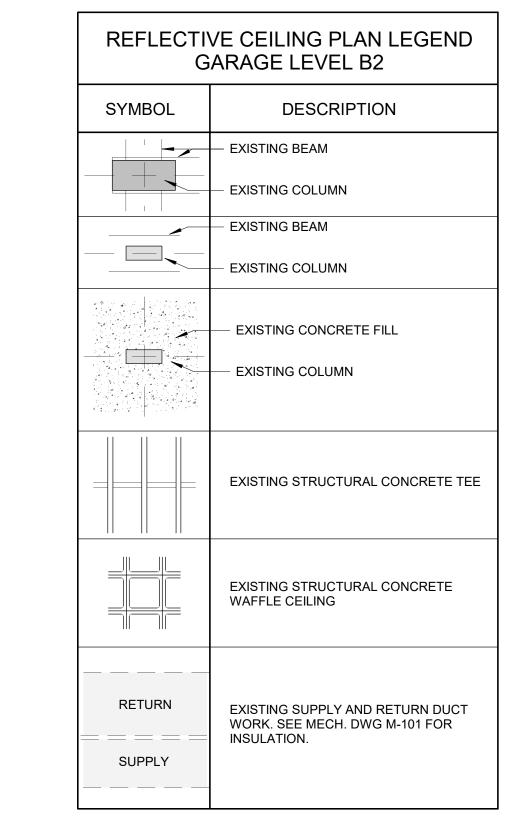

- 1. WITHIN AREA TO BE INSULATED, APPLY MANVILLE CORBOND IV IN THICKNESS REQUIRED TO PROVIDE R=14.6. APPLY MANVILLE FIRE SAFETY INTUMESCENT NO BURN OVER SPRAYED INSULATION. MAKE ACCOMMODATIONS FOR APPLICATION ABOVE AND AROUND EXISTING DUCTS, PIPES, ETC.
- 2. COORDINATE ALL WORK WITH PARKING GARAGE REHABILITATION PROJECT WHICH INCLUDES CONCRETE PATCHING & SPRINKLER REPLACEMENT. PROTECT ALL EXISTING HVAC, SPRINKLERS, LIGHT FIXTURES, ETC.
- 3. PRIOR TO INSULATION INSTALLATION, ENSURE THAT ALL COMPONENTS OF NEW SYSTEMS REQUIRED TO BE INSTALLED PRIOR TO INSULATION SPRAY ON ARE IN PLACE.

CONSULTANT SEAL			CONSULTANT	90)-30 1	f & Lewe Architects L 61st Street, Jamaica 3-651-6200 F: 718-	LP	
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	DIVISION OF ENGINEEF LOW RISE BUILDING RENOVATIONS AND HVAC IMF 110 DR. MARTIN LUTHER KING, JR. BO WHITE PLAINS, NEW YORK REFLECTED CEILING PLAN - GARAGE LEV					OVEMENTS - PHASE II LEVARD	SCALE: DATE: 01-19-2024 DPW FILE NO.	1/8" = 1'-0" Issue Date A-1837-0

EXISTING TRAILER

(25)

PARA GARA CENTRAL WING / QUARROPAS STREET QUARROPAS STREET K KEY PLAN





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FINISH PLAN LEGEND							
SYMBOL	DESCRIPTION						
P-	PAINT FINISH						
SS-	SOLID SURFACE PANELS						
CT-	CERAMIC WALL TILES						
SB-	STAINLESS STEEL WALL BASE						
CB-	COVE BASE						
VB-	VINYL BASE						
C->	CARPET FLOOR						
CT-	CERAMIC FLOOR TILE						
VT-	RESILIENT FLOOR TILES						
CR	CRASH RAIL						
CG	CORNER GUARD						

1. SEE A-304 FOR SCHEDULE OF FINISHES.

2. BASE **VB-1** IS TYPICAL TO ALL WALLS AND PARTITIONS, EXISTING AND NEW UNLESS OTHERWISE NOTED.


3. SEE REFLECTED CEILING PLANS AND ELEVATIONS FOR ADDITIONAL FINISH INFORMATION.


4. EXISTING FLOORING IN WORK AREAS TO BE REMOVED AND SUBSTRATE PREPARED FOR NEW FLOOR FINISH.

5. EXISTING DOOR & FRAME PAINT MATCH TO ADJACENT WALL PAINT.

CONSULTANT SEAL		CONSULTANT INFORMATION Graf & Lewel Architects LI 90-30 161st Street, Jamaica P: 718-651-6200 F: 718-					P		
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DIVISION OF ENGINEERING SHEET NO. 26 OF 133									
LOW RISE BUILDING RENOVATIONS AND HVAC IMPROVEMENTS - PHASE II					SE II	SCALE:	1/8" = 1'-0"		
110 DR. MARTIN LUTHER KING, JR. BOU						DATE: 01-19-2024	Issue Date		
FI	WHITE PLAINS, NEW YORK FINISH PLAN - 1ST FLOOR - CENTRAL WING					DPW FILE NO. 52-11-	-A-1838-0		



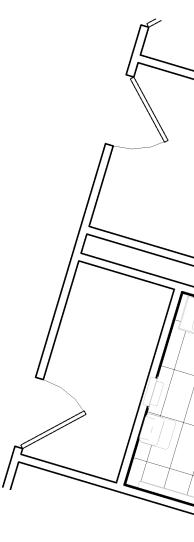

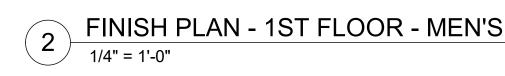

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					CT-	CERAMIC FL	OOR TILE	
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CB-1						CRASH RAIL		
CT-3	7				CG	CORNER GU		
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FINISH PLAN LEGEND

PAINT FINISH

COVE BASE

DESCRIPTION

SOLID SURFACE PANELS

CERAMIC WALL TILES

STAINLESS STEEL WALL BASE

SYMBOL

P-

 $\langle SS- \rangle$

 $\langle \text{CT-} \rangle$

SB-

(CB-)



FINISH PLAN LEGEND							
SYMBOL DESCRIPTION							
P-	PAINT FINISH						
 SS- 	SOLID SURFACE PANELS						
CT-	CERAMIC WALL TILES						
SB-	STAINLESS STEEL WALL BASE						
CB-	COVE BASE						
VB-	VINYL BASE						
C-	CARPET FLOOR						
СТ-	CERAMIC FLOOR TILE						
VT-	RESILIENT FLOOR TILES						
CR	CRASH RAIL						
CG	CORNER GUARD						

1. SEE A-304 FOR SCHEDULE OF FINISHES.


2. BASE **VB**-1 IS TYPICAL TO ALL WALLS AND PARTITIONS, EXISTING AND NEW UNLESS OTHERWISE NOTED.

3. SEE REFLECTED CEILING PLANS AND ELEVATIONS FOR ADDITIONAL FINISH INFORMATION.

4. EXISTING FLOORING IN WORK AREAS TO BE REMOVED AND SUBSTRATE PREPARED FOR NEW FLOOR FINISH.

5. EXISTING DOOR & FRAME PAINT MATCH TO ADJACENT WALL PAINT.

CONSULTANT SEAL CONSULTANT INFORMATION								
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LOW RISE BUILDING RENOVATIONS AND HVAC IMPR 110 DR. MARTIN LUTHER KING, JR. BOU WHITE PLAINS, NEW YORK				JR. BOU YORK	LEVARD	SCALE: DATE: 01-19-2024 DPW FILE NO.	REV	
FINISH PLAN - 2ND FLOOR - CENTRAL WING 52-11-A-1						A-1840-0		

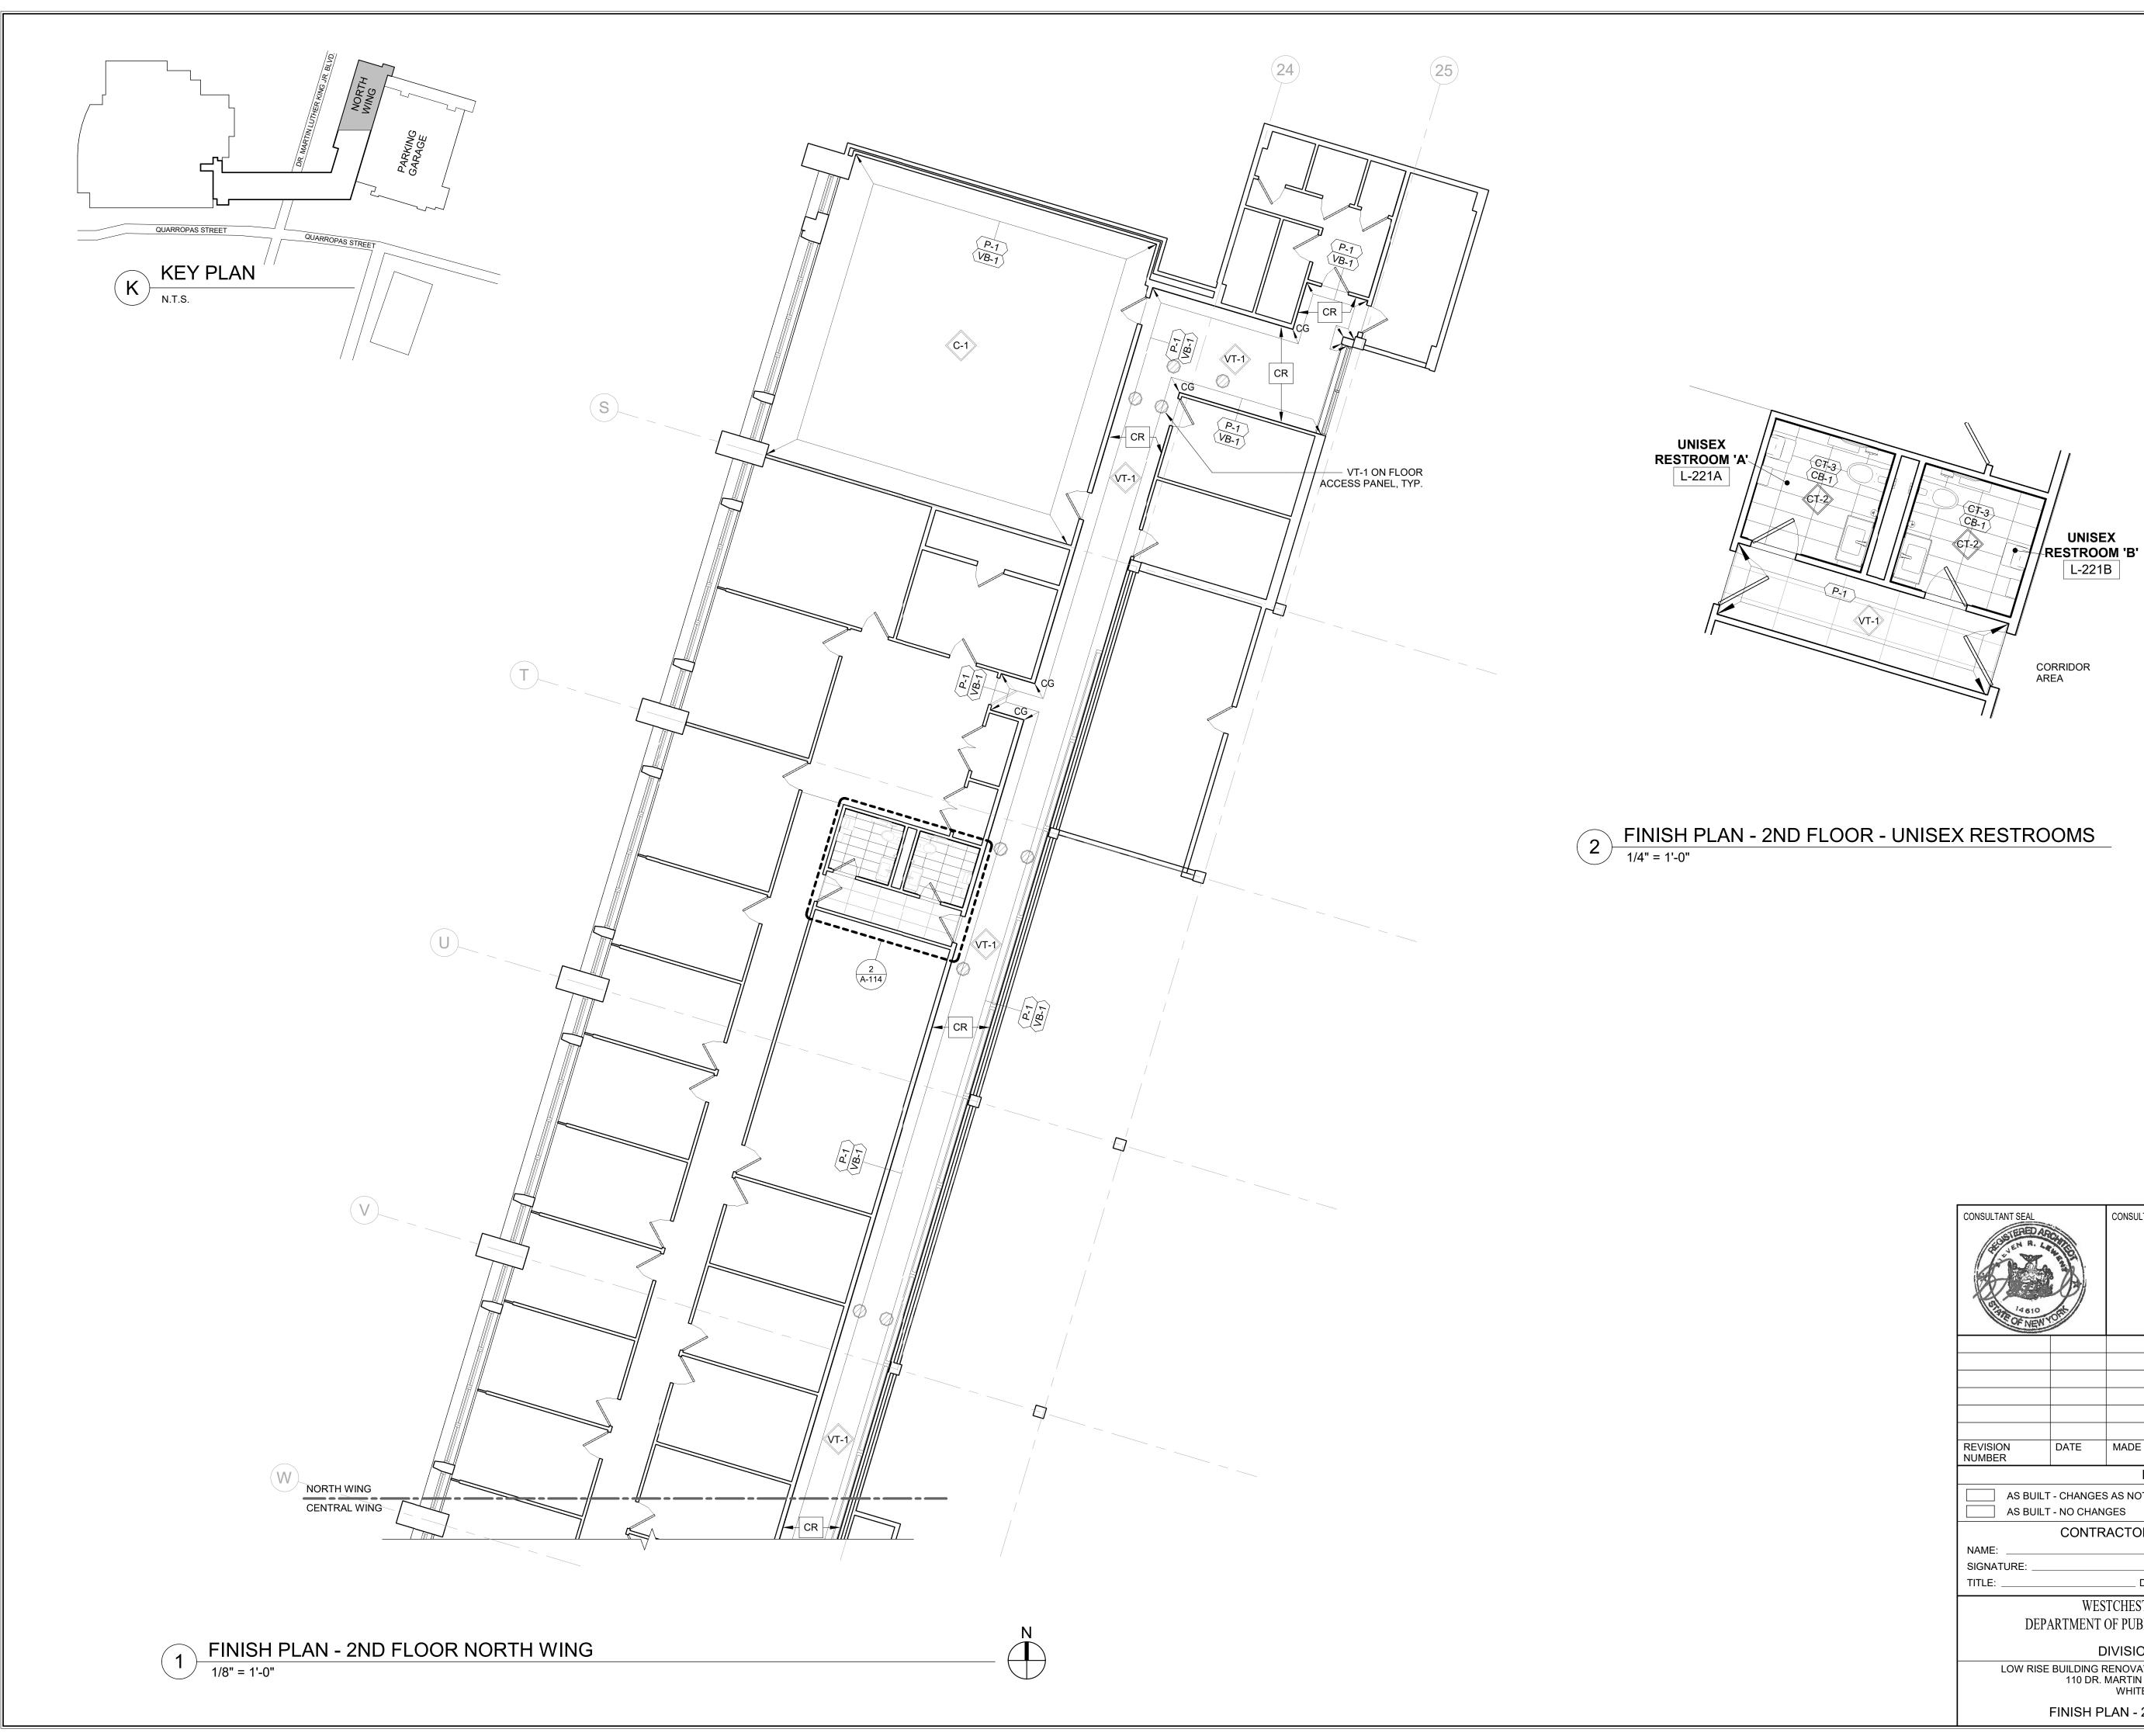

FINISH PLAN LEGEND SYMBOL DESCRIPTION P-PAINT FINISH $\langle SS- \rangle$ SOLID SURFACE PANELS CT-CERAMIC WALL TILES SB-STAINLESS STEEL WALL BASE (CB-COVE BASE **VB-**VINYL BASE C-> CARPET FLOOR Ст-CERAMIC FLOOR TILE VT-RESILIENT FLOOR TILES CR CRASH RAIL CG CORNER GUARD

NOTES:

1. SEE A-304 FOR SCHEDULE OF FINISHES.


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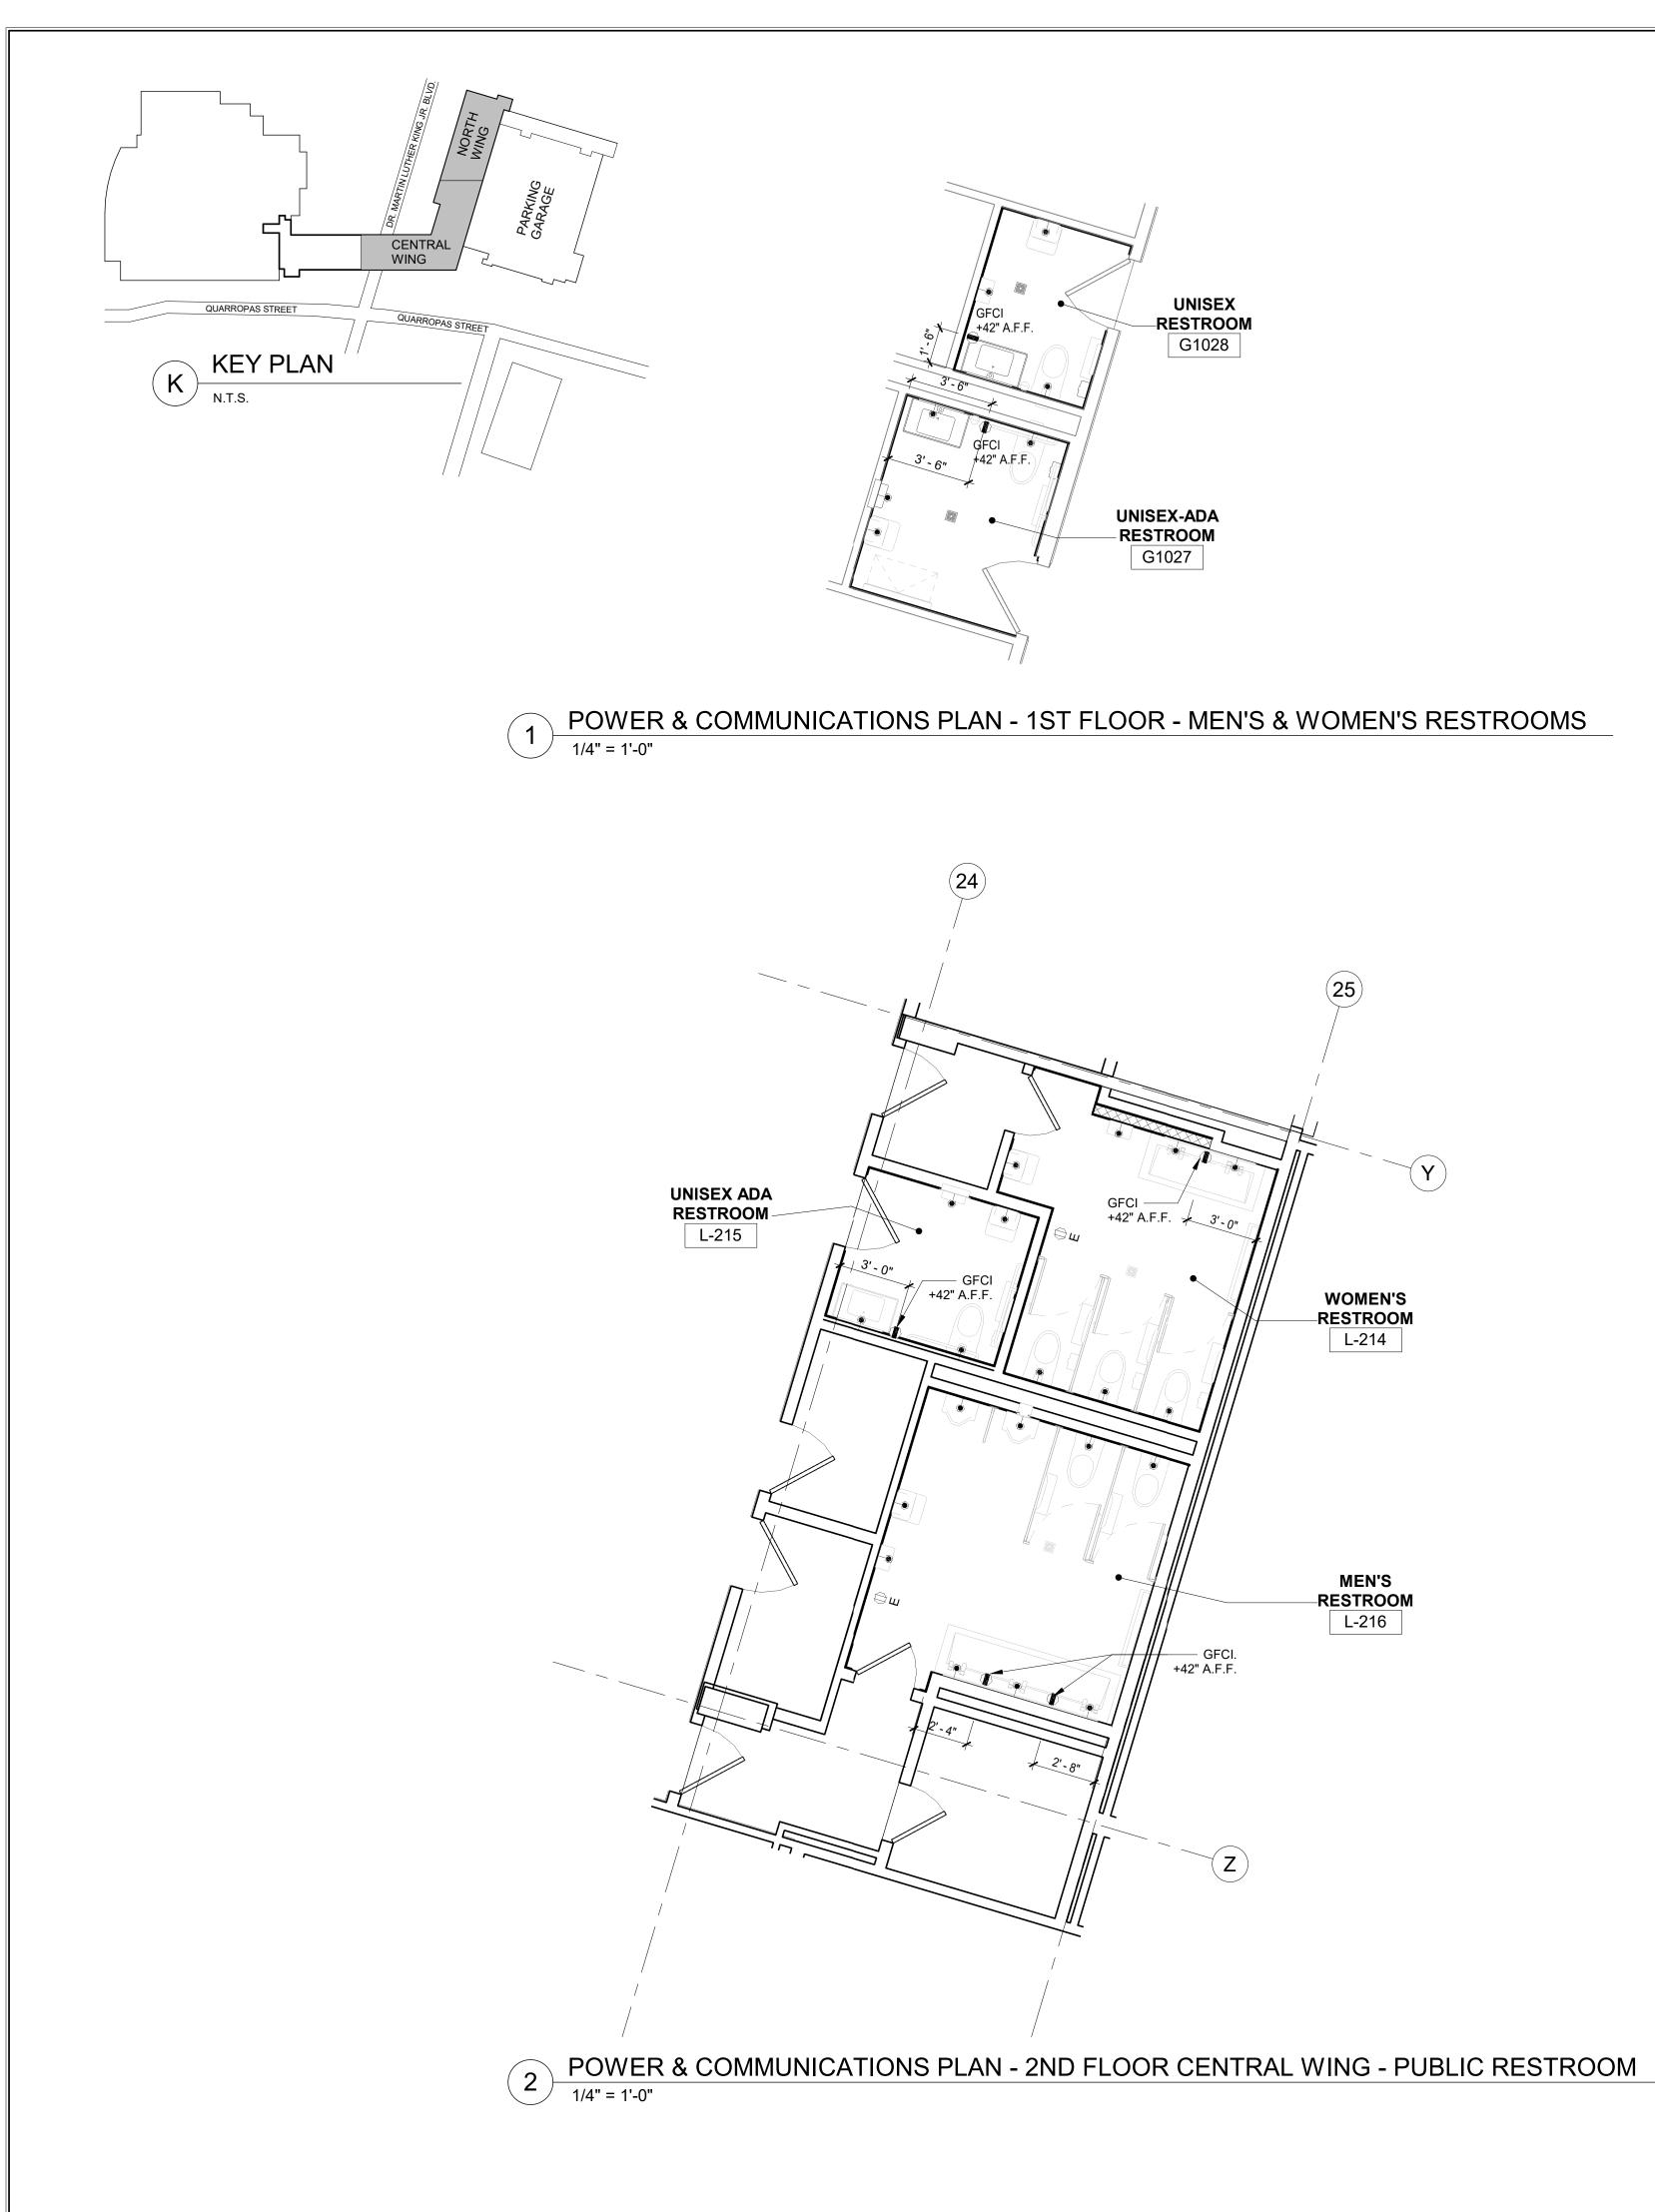
5. EXISTING DOOR & FRAME PAINT MATCH TO ADJACENT WALL PAINT.


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LOW RISE BUILDING RENOVATIONS AND HVAC IMPROVEMENTS - PHASE II						SCALE:	As indicated
WHITE PLAINS, NEW YORK					DATE: 01-19-2024		
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	PLUMBING FIXTU	JRES SCHEDULE	1
SYMBOL	DESCRIPTION	MANUFACTURER	MODEL #
(FA)	SENSOR RESTROOM FAUCET - HARD WIRED WITH BELOW DECK THERMOSTATIC MIXER 0.50 GPM	SLOAN	EFX-200.200.0010 # 3324250 POL. CHROME
	SENSOR UNISEX RESTROOM FAUCET 1.0 GPM WITH SIDE MIXER, 1 - AERATED SPRAY & PLUG - IN ADAPTOR	SLOAN	EAF-100 # 3335123
	LAVATORY - RESTROOM - 90" 3 - STATION TROUGH SINK, SS-3 CORIAN EVEREST, STRAIGHT EDGE AND ADA STAINLESS STEEL ENCLOSURE	SLOAN	DSG-84000 CORIAN SOLID SURFACE
(LV) ₂	LAVATORY - RESTROOM - 60" 2 - STATION TROUGH SINK, SS-3 CORIAN EVEREST, STRAIGHT EDGE AND ADA STAINLESS STEEL ENCLOSURE	SLOAN	DSG-84000 CORIAN SOLID SURFACE
	LAVATORY - RESTROOM - W:30" X D:18" SINGLE STATION, SS-3 CORIAN EVEREST, STRAIGHT EDGE AND ADA STAINLESS STEEL ENCLOSURE	SLOAN	ELC-81000 CORIAN SOLID SURFACE
	URINAL - REAR SPUD 0.125 - 1.0 GPF PROVIDE ADA HEIGHT WHERE INDICATED	SLOAN	SU-1019- "STG" (SLOAN TEC GLAZE) #1171019
WC ADA	WATER CLOSET - WALL MOUNT REAR SPUD 1.1 - 1.6 GPF – PROVIDE ADA HEIGHT WHRE INDICATED	SLOAN	ST-2469-STG # 2172469 - "STG" - SLOAN - TEC GLAZE?
(FS)	FLUSHOMETER SENSOR - WATER CLOSET CONCEALED 1.28 GPF	SLOAN	CX 8158-1.28-CP-OR # 3400301
	FLUSHOMETER SENSOR - URINAL CONCEALED 0.5 GPF	SLOAN	CX 8198-0.5-CP-OR # 3400302
(SD)	SENSOR SOAP DISPENSER - RESTROOMS HARD - WIRED - DECK MOUNTED	SLOAN	ESD-400-CP # 3346080
	SENSOR SOAP DISPENSER - RESTROOMS HARD - WIRED - WALL MOUNTED	GOJO	GOJO LTX-12
	AUTOMATIC HAND DRYER & — PROVIDE ADA RECESS KIT (BRUSHED NICKEL) WHERE INDICATED	SLOAN	XLERATOR - EHD 501-BN # 3366122 + ADA RECESS KIT # 3366139
	RESTROOM ACCES	SSORY SCHEDULI	Ξ
SYMBOL	DESCRIPTION	MANUFACTURER	MODEL #
GB	GRAB BAR - SIDE	BOBRICK	B-6806 42"
	GRAB BAR - REAR	BOBRICK	B-6806 36"
GB ₃	GRAB BAR - VERTICAL	BOBRICK	B-6806 18" VERTICAL
	BABY CHANGING STATION	KOALA KARE	KB-110-SSWM
	TOILET PAPER DISPENSER UNIT	KIMBERLY CLARK	09551
	PAPER TOWEL DISPENSER	GEORGIA PACIFIC ENMOTION	59462A
	MIRROR 6'-9" X4'-0"	BOBRICK	B-290 81"X48"
	MIRROR 4'-0" X4'-0"	BOBRICK	B-290 48"X48"
	MIRROR 2'-0" X4'-0"	BOBRICK	B-290 24"X48"
sc	SEAT COVER DISPENSER	BOBRICK	B-221
	WASTE RECEPTACLE - 21 GALLONS NO COVER	BOBRICK	B-2280
SN	SANITARY NAPKIN DISPOSAL BIN	BOBRICK	B-35139
PS	TOILET PARTITIONS	SCRANTON	ECLIPSE 62" HEIGHT

CONSULTANT SEAL		CONSULTANT	90	0-30 1	nt L P NY 11432 251-6989		
REVISION NUMBER DATE MADE BY APP'D BY REVISION RECORD DRAWING CERTIFICATION							
AS BUILT - NO CHANGES CONTRACTOR NAME: NAME					NAME:		
WESTCHESTER COUNTY, NEW YO DEPARTMENT OF PUBLIC WORKS AND TRA DIVISION OF ENGINEERIN LOW RISE BUILDING RENOVATIONS AND HVAC IMPRO					ANSPORTATION NG ovements - phase 11	CONTRACT NUMBER 20-502 SHEET NO. 30 SCALE:	SHEET NUMBER A-120 OF 133 As indicated
	110 DR. PLUMBI	DATE: 01-19-2024 DPW FILE NO. 52-11-	Issue Date A-1842-0				



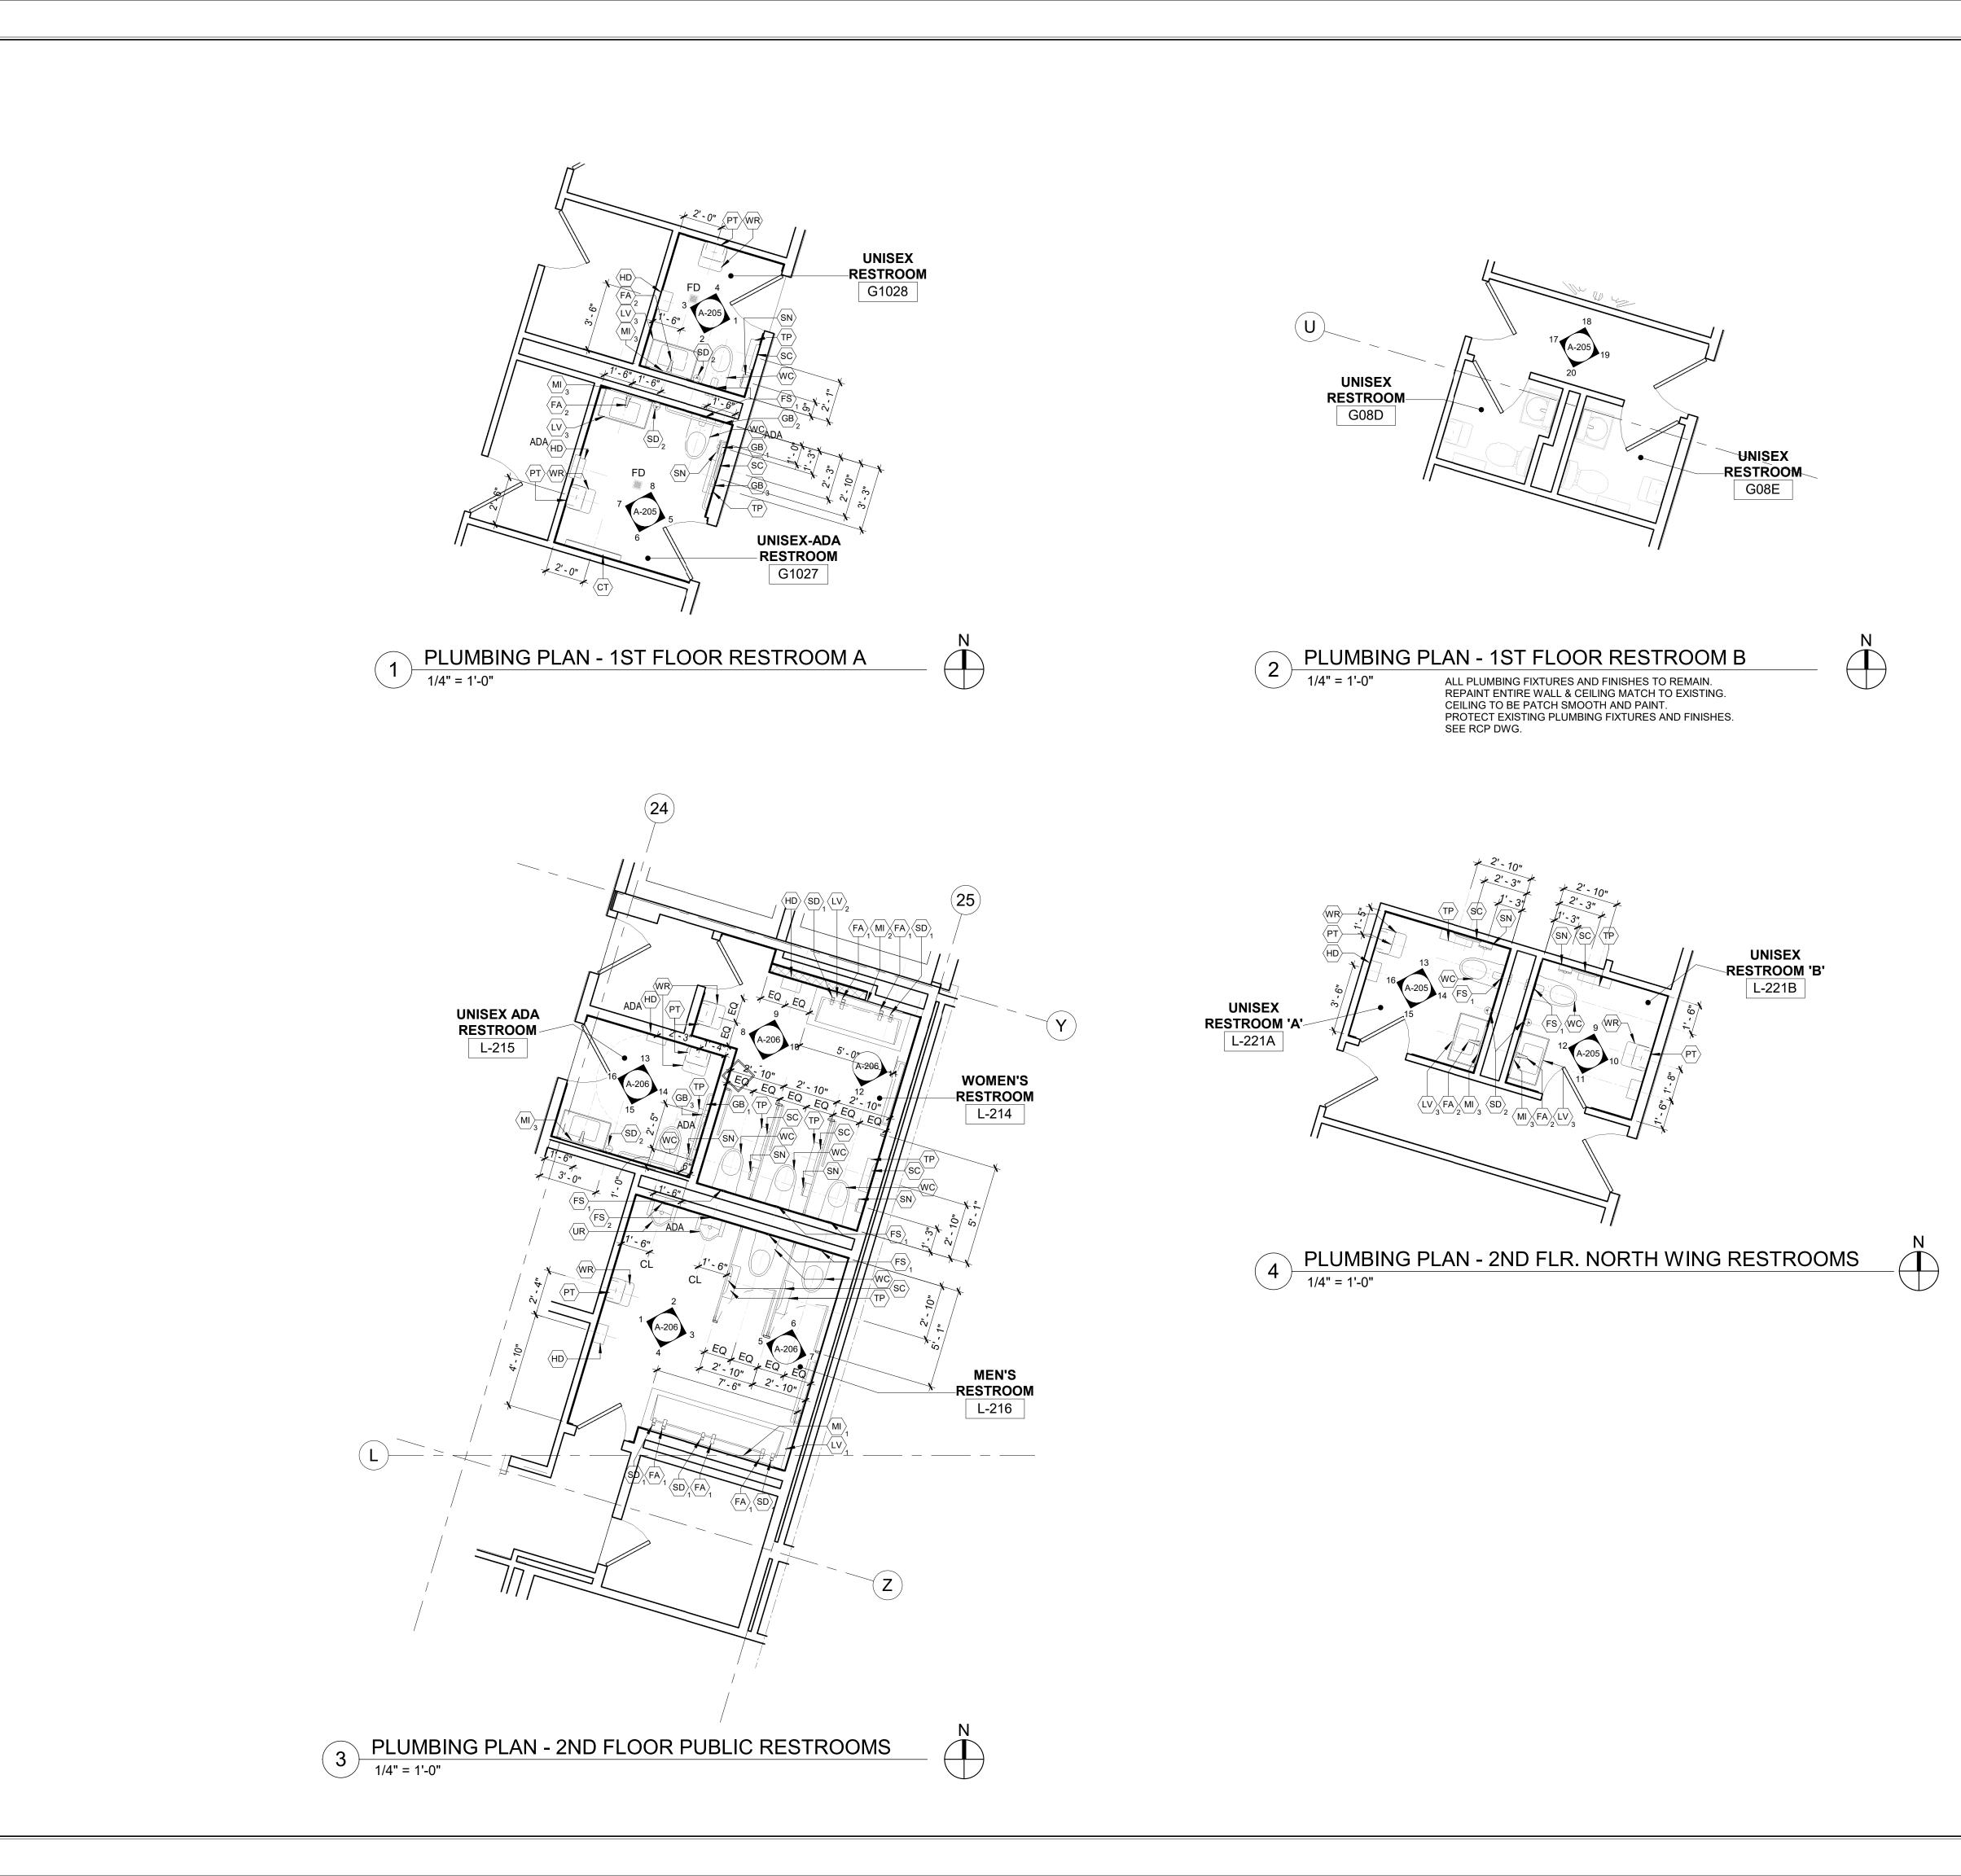

3 POWER & COMMUNICATIONS PLAN - 2ND FLOOR NORTH WING - RESTROOM 1/4" = 1'-0"

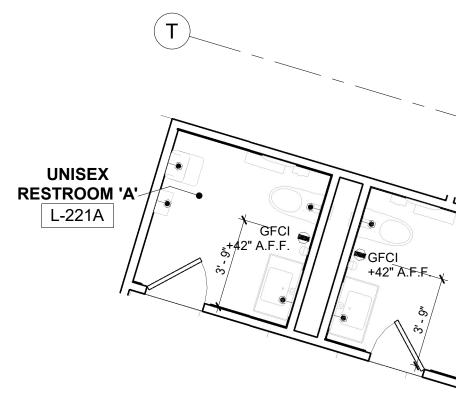
POWER PLAN LEGEND

SYMBOL	DESCRIPTION					
•	JUNCTION BOX					
GFCI	DUPLEX GFCI OUTLET					
E	EXISTING OUTLET TO REMAIN					
	DOUPLEX OUTLET					
	DATA COMMUNICATIONS OUTLET					


POWER PLAN NOTE:


1. ALL OUTLET TO BE RECESSED.

CONSULTANT SEAL		CONSULTANT	90	0-30 1	f & Lewe Architects L 61st Street, Jamaica 3-651-6200 F: 718-	LP	
	DATE T - CHANGES T - NO CHAN	RE S AS NOTED		RAWIN	REVIS G CERTIFICATION	SION	
					NAME: SIGNATURE:		
WESTCHESTER COUNTY, NEW Y DEPARTMENT OF PUBLIC WORKS AND TRA						CONTRACT NUMBER 20-502	SHEET NUMBER
LOW RISE	E BUILDING F 110 DR.	MARTIN LUT	NS AND HVA THER KING, AINS, NEW	AC IMPR JR. BOU YORK	OVEMENTS - PHASE II ILEVARD	SCALE: DATE: 01-19-2024 DPW FILE NO.	OF 133 As indicated Issue Date A-1843-0

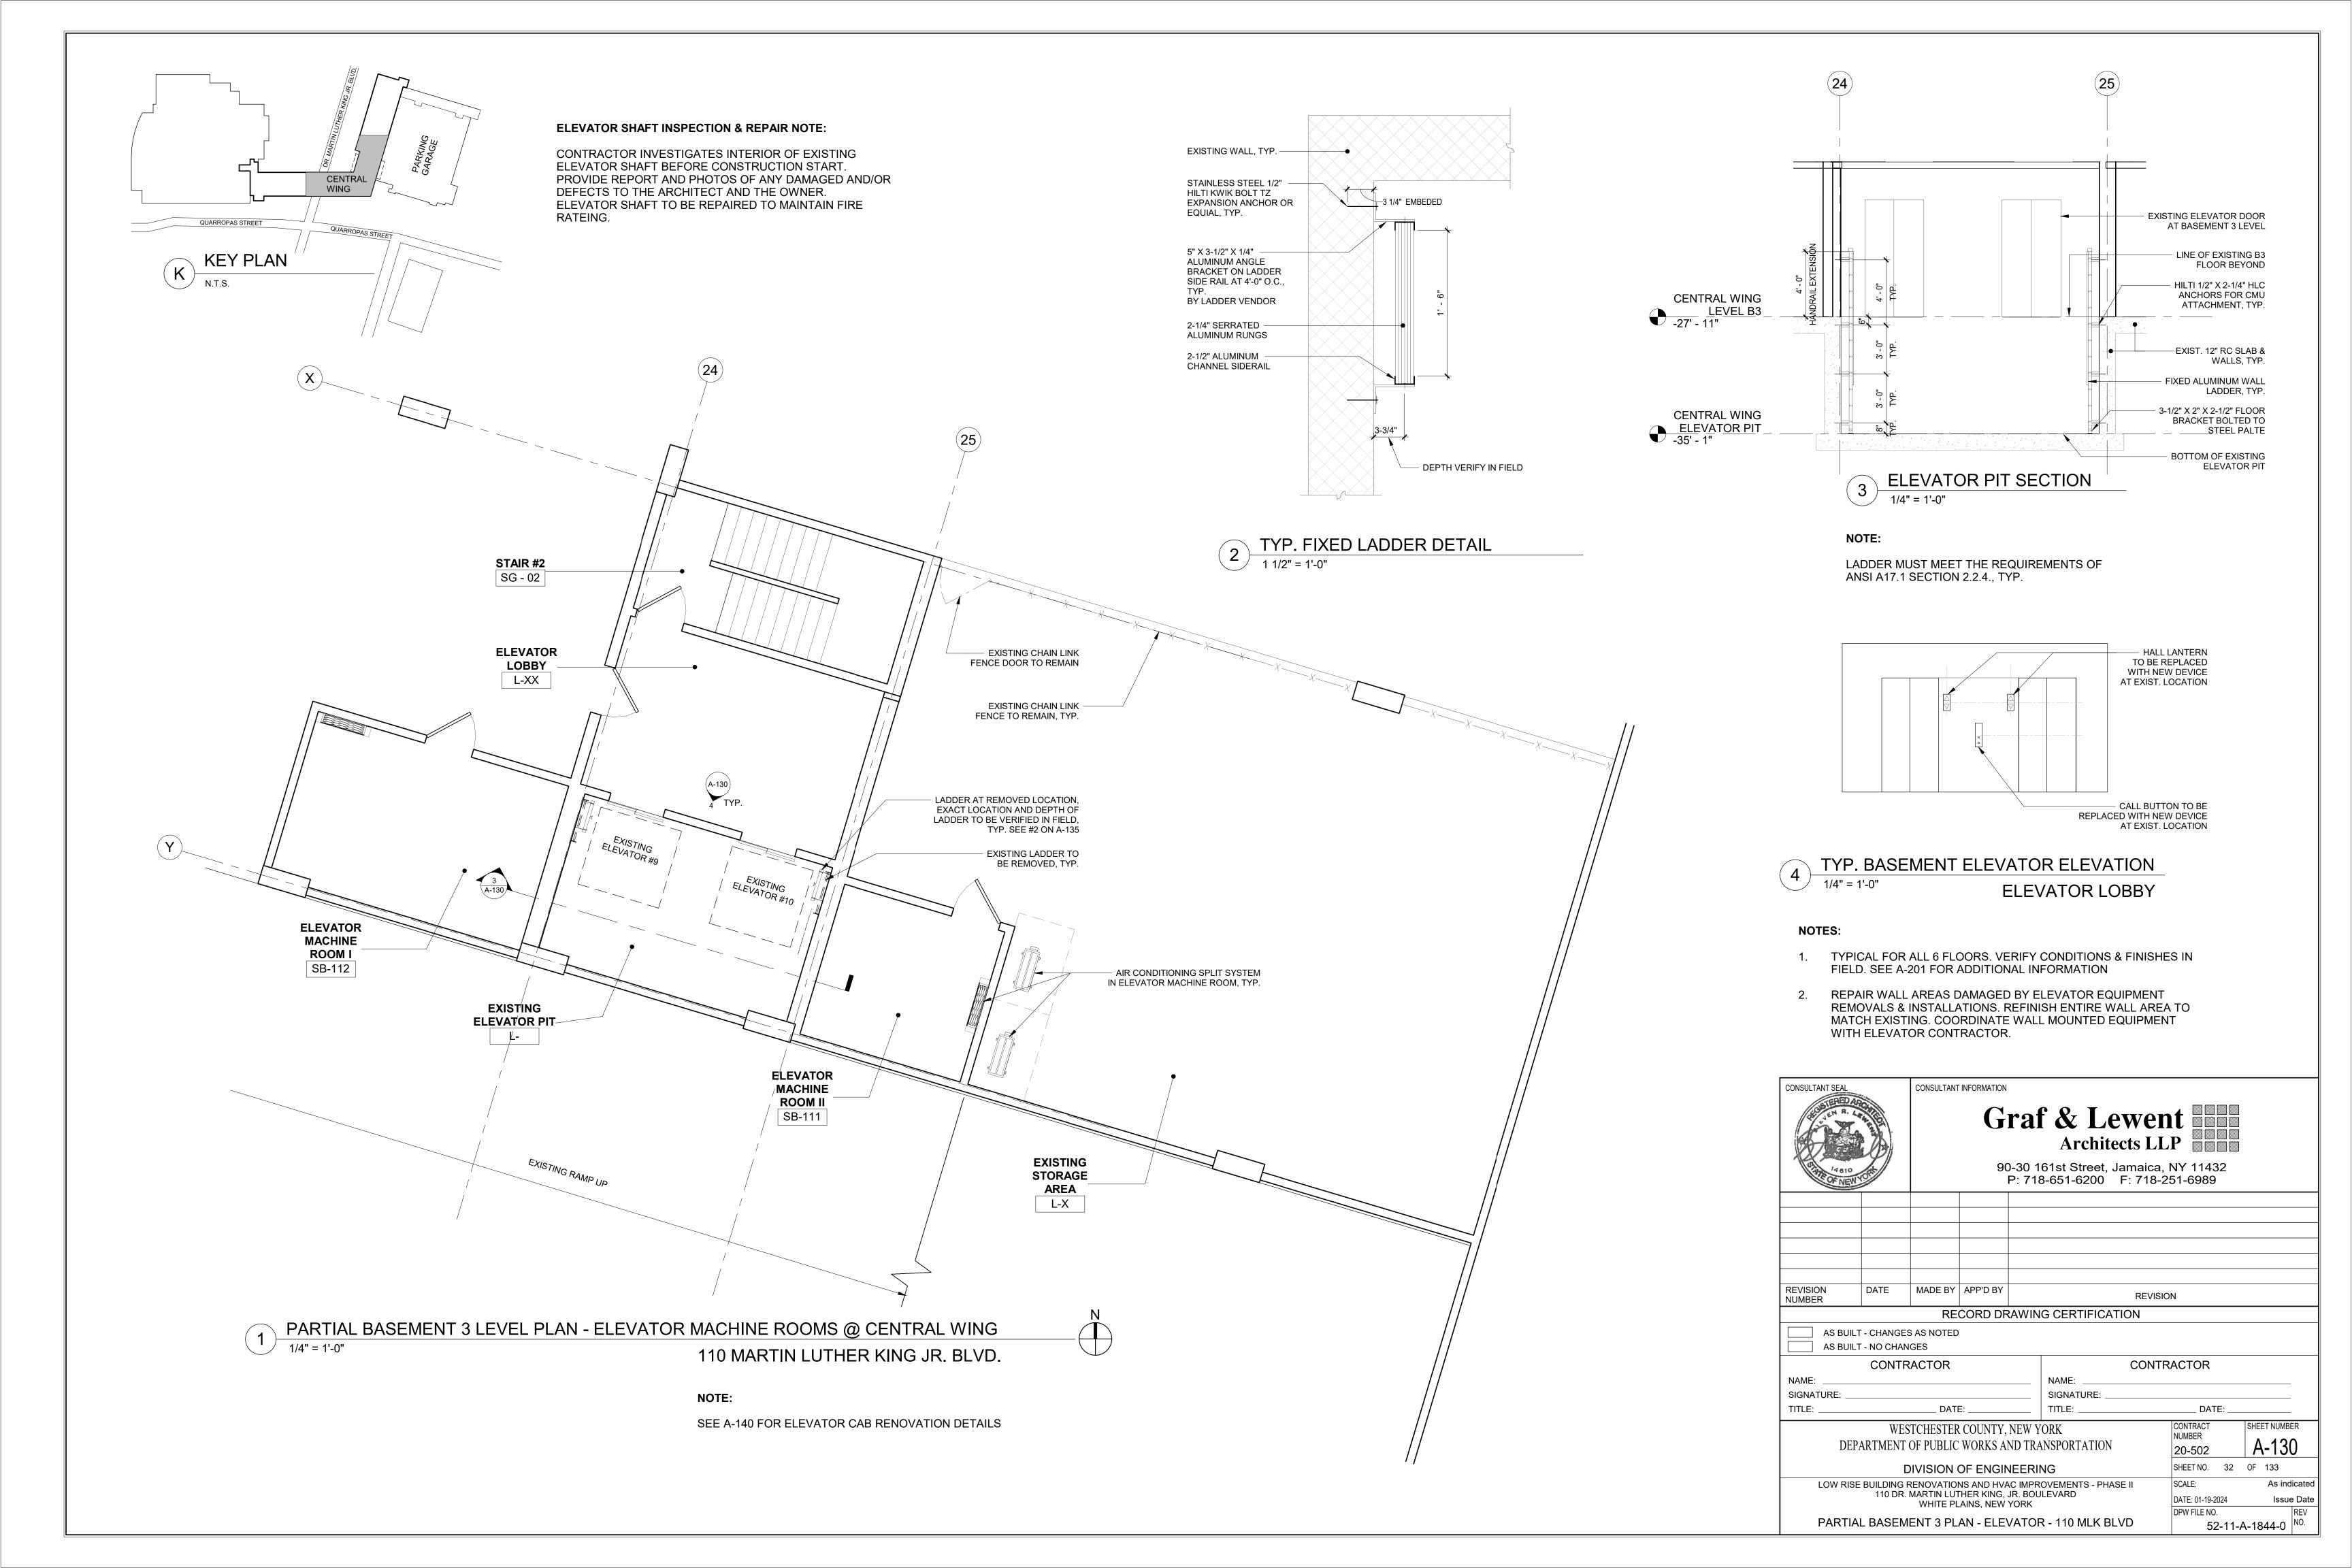


PAR CENTRAL WING QUARROPAS STREET QUARROPAS STREE K KEY PLAN WALL OF EXISTING COOLING TOWER, TYP. MOTORIZED FIRE DAMPER -SEE ENG. DRAWINGS FOR ADD. INFORMATION A-132 ELEVATOR SMOKE VENT -THRU EXISTING LOUVER SEE ELEVATION PROVIDE BIRD SCREEN AT DUCTWORK OPENING 2 (A-132) EXISTING -WALKING PAD, TYP. EXISTING STAIRS / %/ 1/4" = 1'-0"

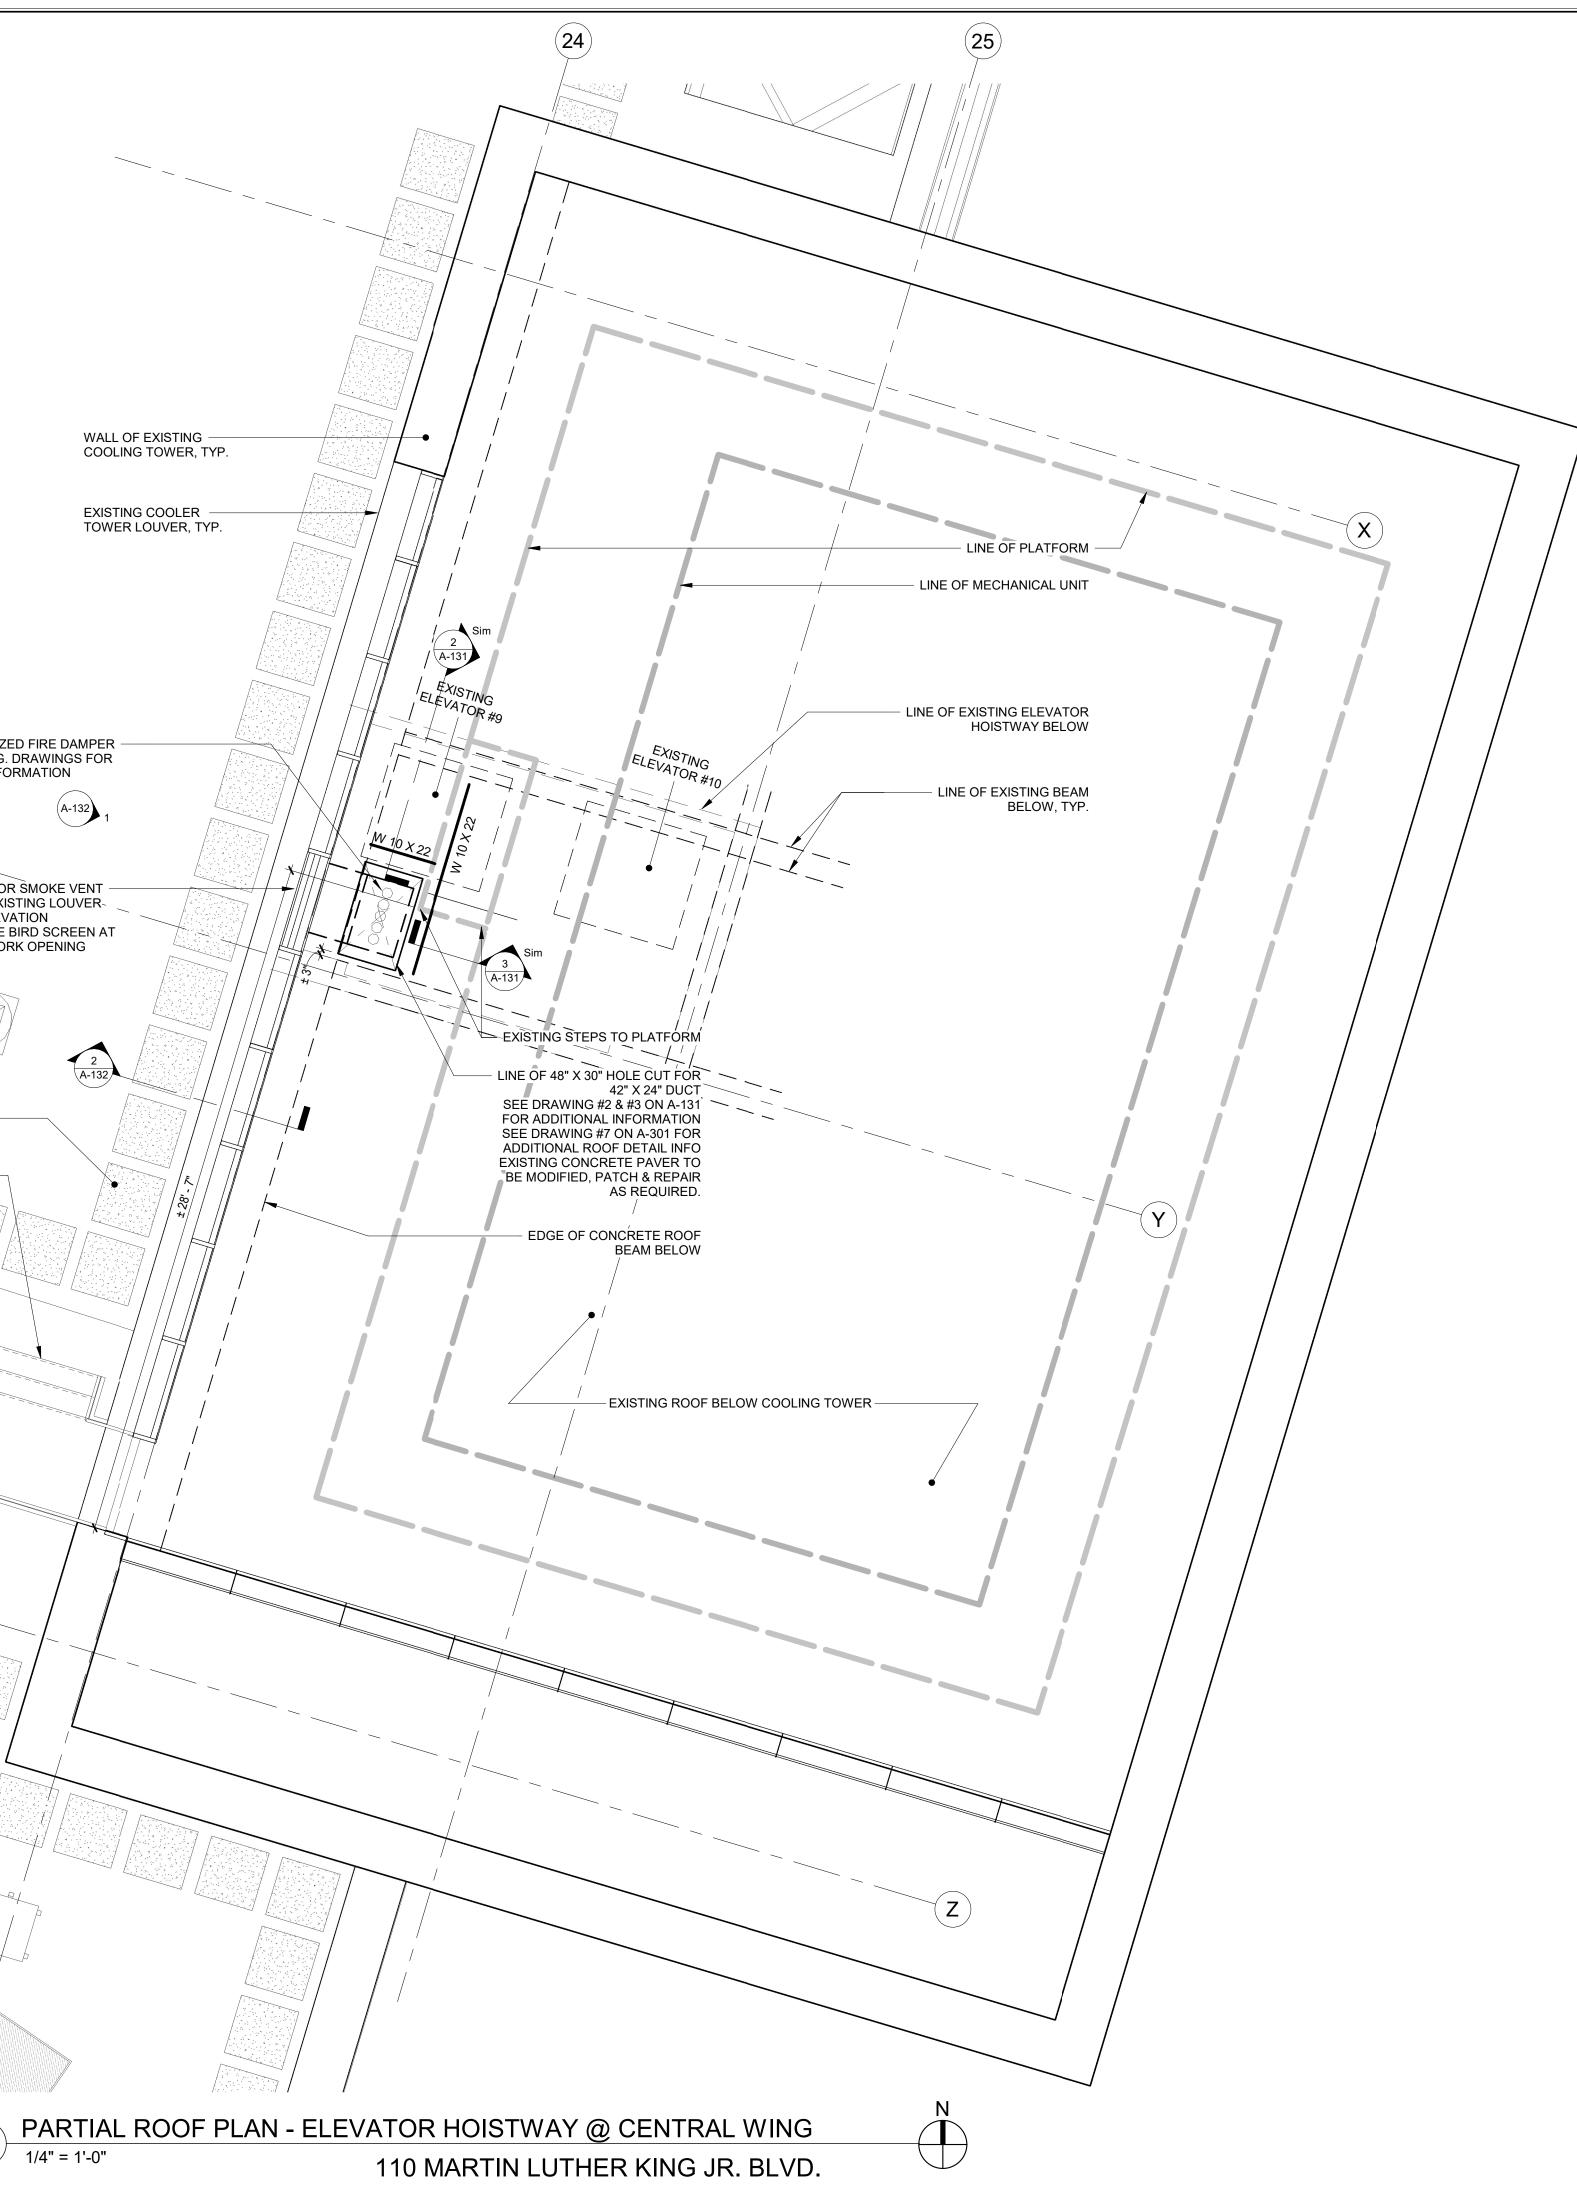

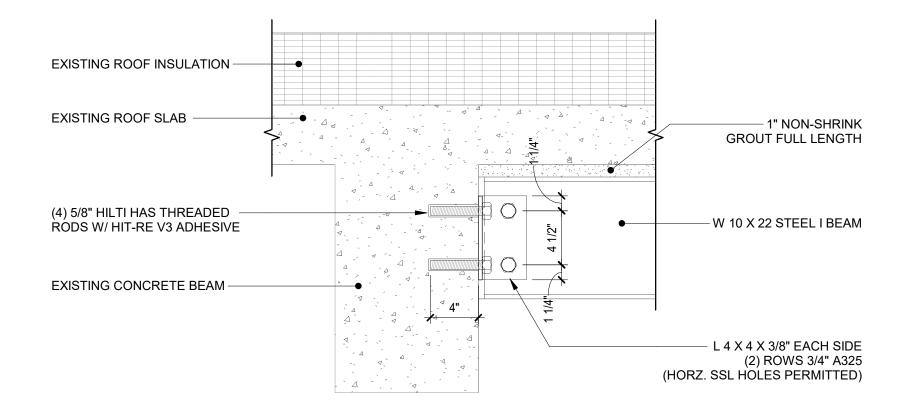

2 ROOF OPENING STRUCTURAL SUPPORT DETAIL 1 1 1/2" = 1'-0"

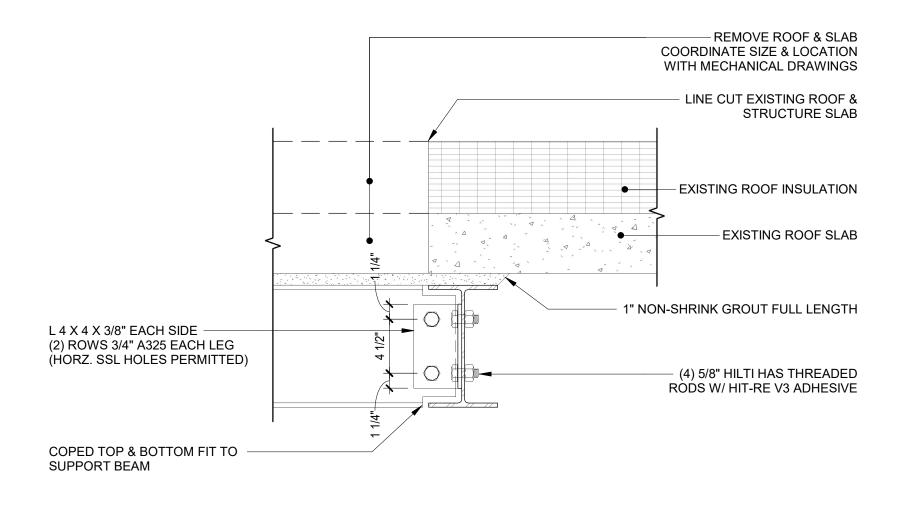

3 ROOF OPENING STRUCTURAL SUPPORT DETAIL 2 1 1/2" = 1'-0"

ROOF WARRANTY NOTE:

ROOF UNDER JM WARRANTY ALL ROOF WORK TO BE DONE BY JM AUTHORIZED CONTRACTOR AND REPORTED TO JM FOR WARRANTY PURPOSES.

CONSULTANT SEAL	A SOLUTION	CONSULTANT	90)-30 1	f & Lewe Architects L 61st Street, Jamaic 3-651-6200 F: 718	LP	
REVISION	DATE	MADE BY	APP'D BY		REV	ISION	
		RE	CORD DF	RAWIN	G CERTIFICATION		
	JILT - CHANGE						
	CONTF	RACTOR			CON	ITRACTOR	
NAME:					NAME:		
SIGNATURE: _					SIGNATURE:		
							SHEET NUMBER
WESTCHESTER COUNTY, NEW YORK DEPARTMENT OF PUBLIC WORKS AND TRANSPORTATION					NUMBER 20-502	A-131	
DIVISION OF ENGINEERING						SHEET NO. 33	OF 133
LOW RISE BUILDING RENOVATIONS AND HVAC IMPROVEMENTS - PHAS 110 DR. MARTIN LUTHER KING, JR. BOULEVARD WHITE PLAINS, NEW YORK						SCALE: DATE: 01-19-2024	
PARTIAL ROOF PLAN - ELEVATOR HOISTWAY - 110 MLK BLVD						DPW FILE NO. 52-11-	-A-1845-0

OUARROPAS STREET OUARROPAS STREET OUARROPAS STREET OUARROPAS STREET KEY PLAN N.T.S.	ARKING CARAGE	
	LINE OF EXISTING	

EXISTING COOLING TOWER WALL -

(1)


EXISTING LOUVER AT COOLING TOWER -

42" X 24" DUCT TO VENT SMOKE -FROM ELEVATOR SHAFT PROVIDE BIRD SCREEN -


FIRE DAMPER AT FIRE RATED — ELEVATOR SHAFT ENCLOSURE EXISTING ROOF TOP OF -ELEVATOR SHAFT

EXISTING CONCRETE BEAM -



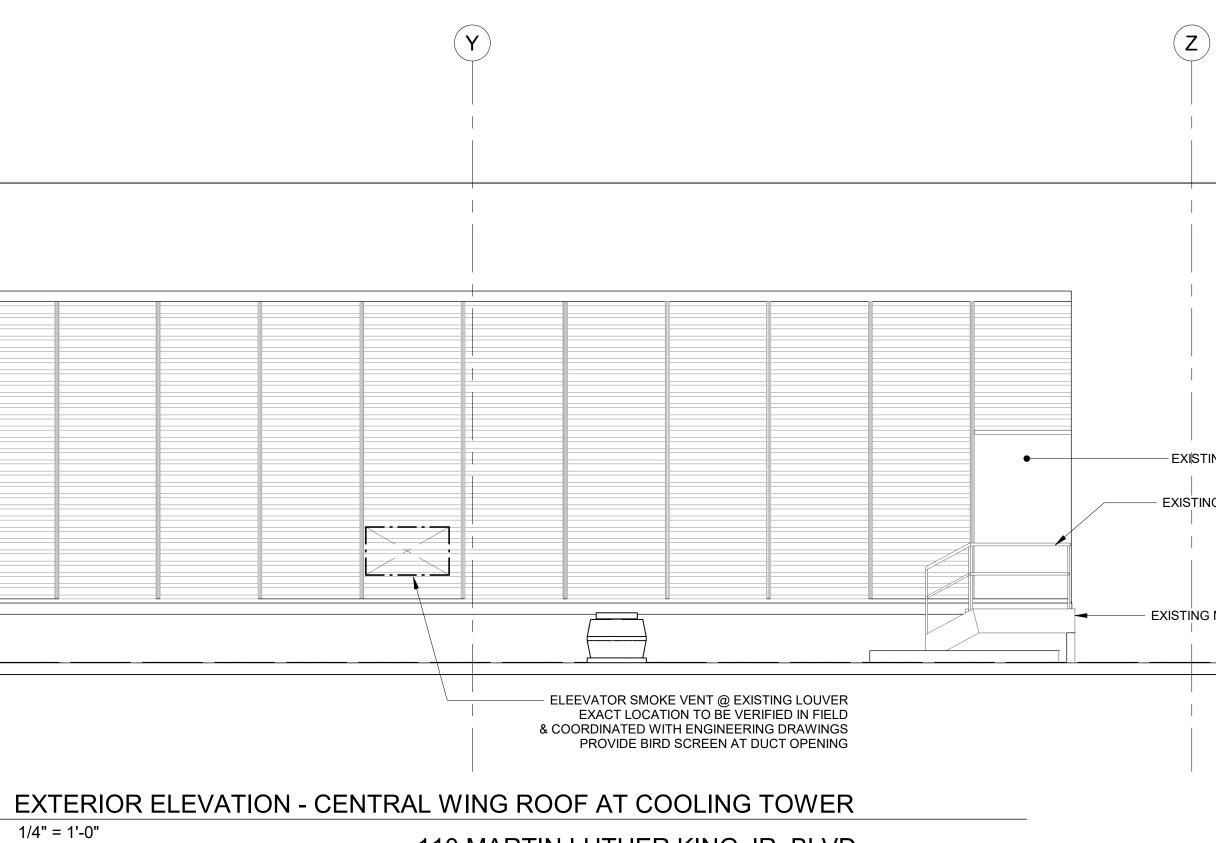

110 MARTIN LUTHER KING JR. BLVD.

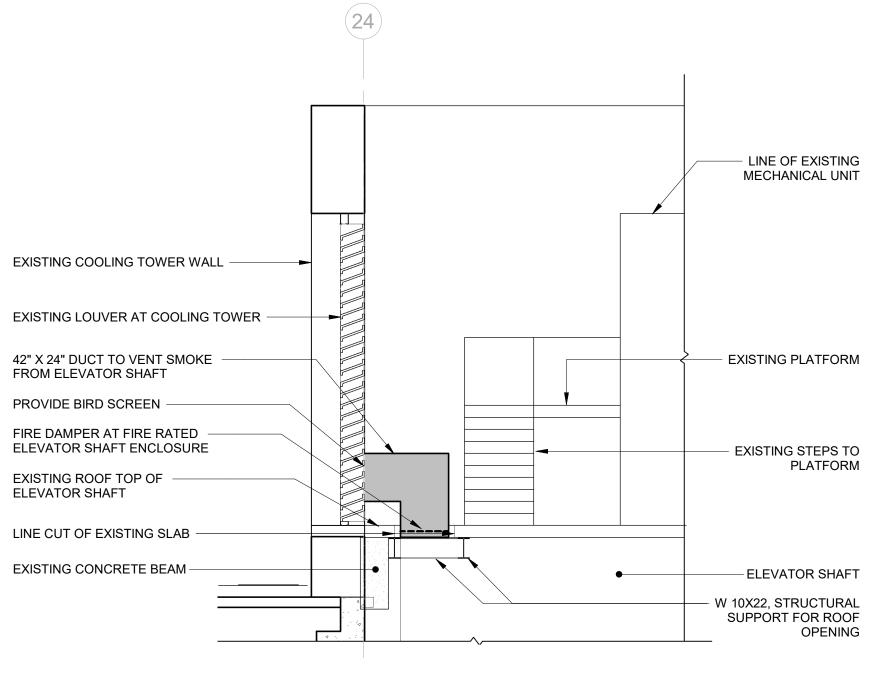


SECTION AT DUCTWORK PENETRATION 1/4" = 1'-0"


TING OPENING					
NG HAND RAIL					
G METAL STEP	/]			
			 CENTRAL V ROOF_L		\ \
			 4	0' - 0"	1

ROOF WARRANTY NOTE:

ROOF UNDER JM WARRANTY ALL ROOF WORK TO BE DONE BY JM AUTHORIZED CONTRACTOR AND REPORTED TO JM FOR WARRANTY PURPOSES.


CONSULTANT SEAL		CONSULTANT INFORMATION							
BIR HOF NEW	Graf & Lewent								
		_							
REVISION NUMBER	DATE	MADE BY	APP'D BY	REVISION					
RECORD DRAWING CERTIFICATION									
AS BUILT - CHANGES AS NOTED AS BUILT - NO CHANGES									
CONTRACTOR					CONTE	CONTRACTOR			
NAME:					NAME:				
SIGNATURE:				SIGNATURE:					
TITLE: TITLE:						DATE:			
WESTCHESTER COUNTY, NEW YORK						CONTRACT NUMBER	SHEET NUMBER		
DEPARTMENT OF PUBLIC WORKS AND TRA					NSPORTATION	20-502	A-132		
DIVISION OF ENGINEERING						SHEET NO. 34	OF 133		
LOW RISE BUILDING RENOVATIONS AND HVAC IMPROVEMENTS - PHASE II						SCALE:	1/4" = 1'-0"		
110 DR. MARTIN LUTHER KING, JR. BOU WHITE PLAINS, NEW YORK				LEVARD	DATE: 01-19-2024				
PARTIAL EXTERIOR ELEVATION @ CENTRAL WING - 110 MLK BLVD					DPW FILE NO. 52-11-	•A-1846-0			

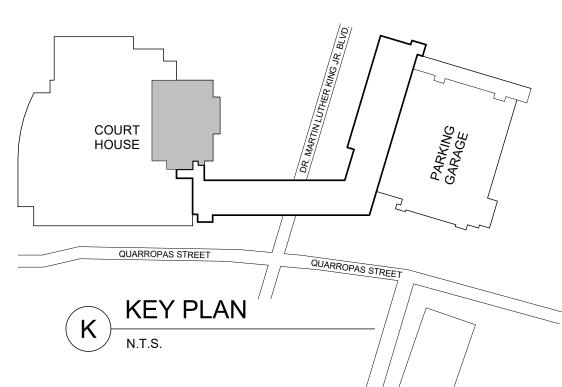

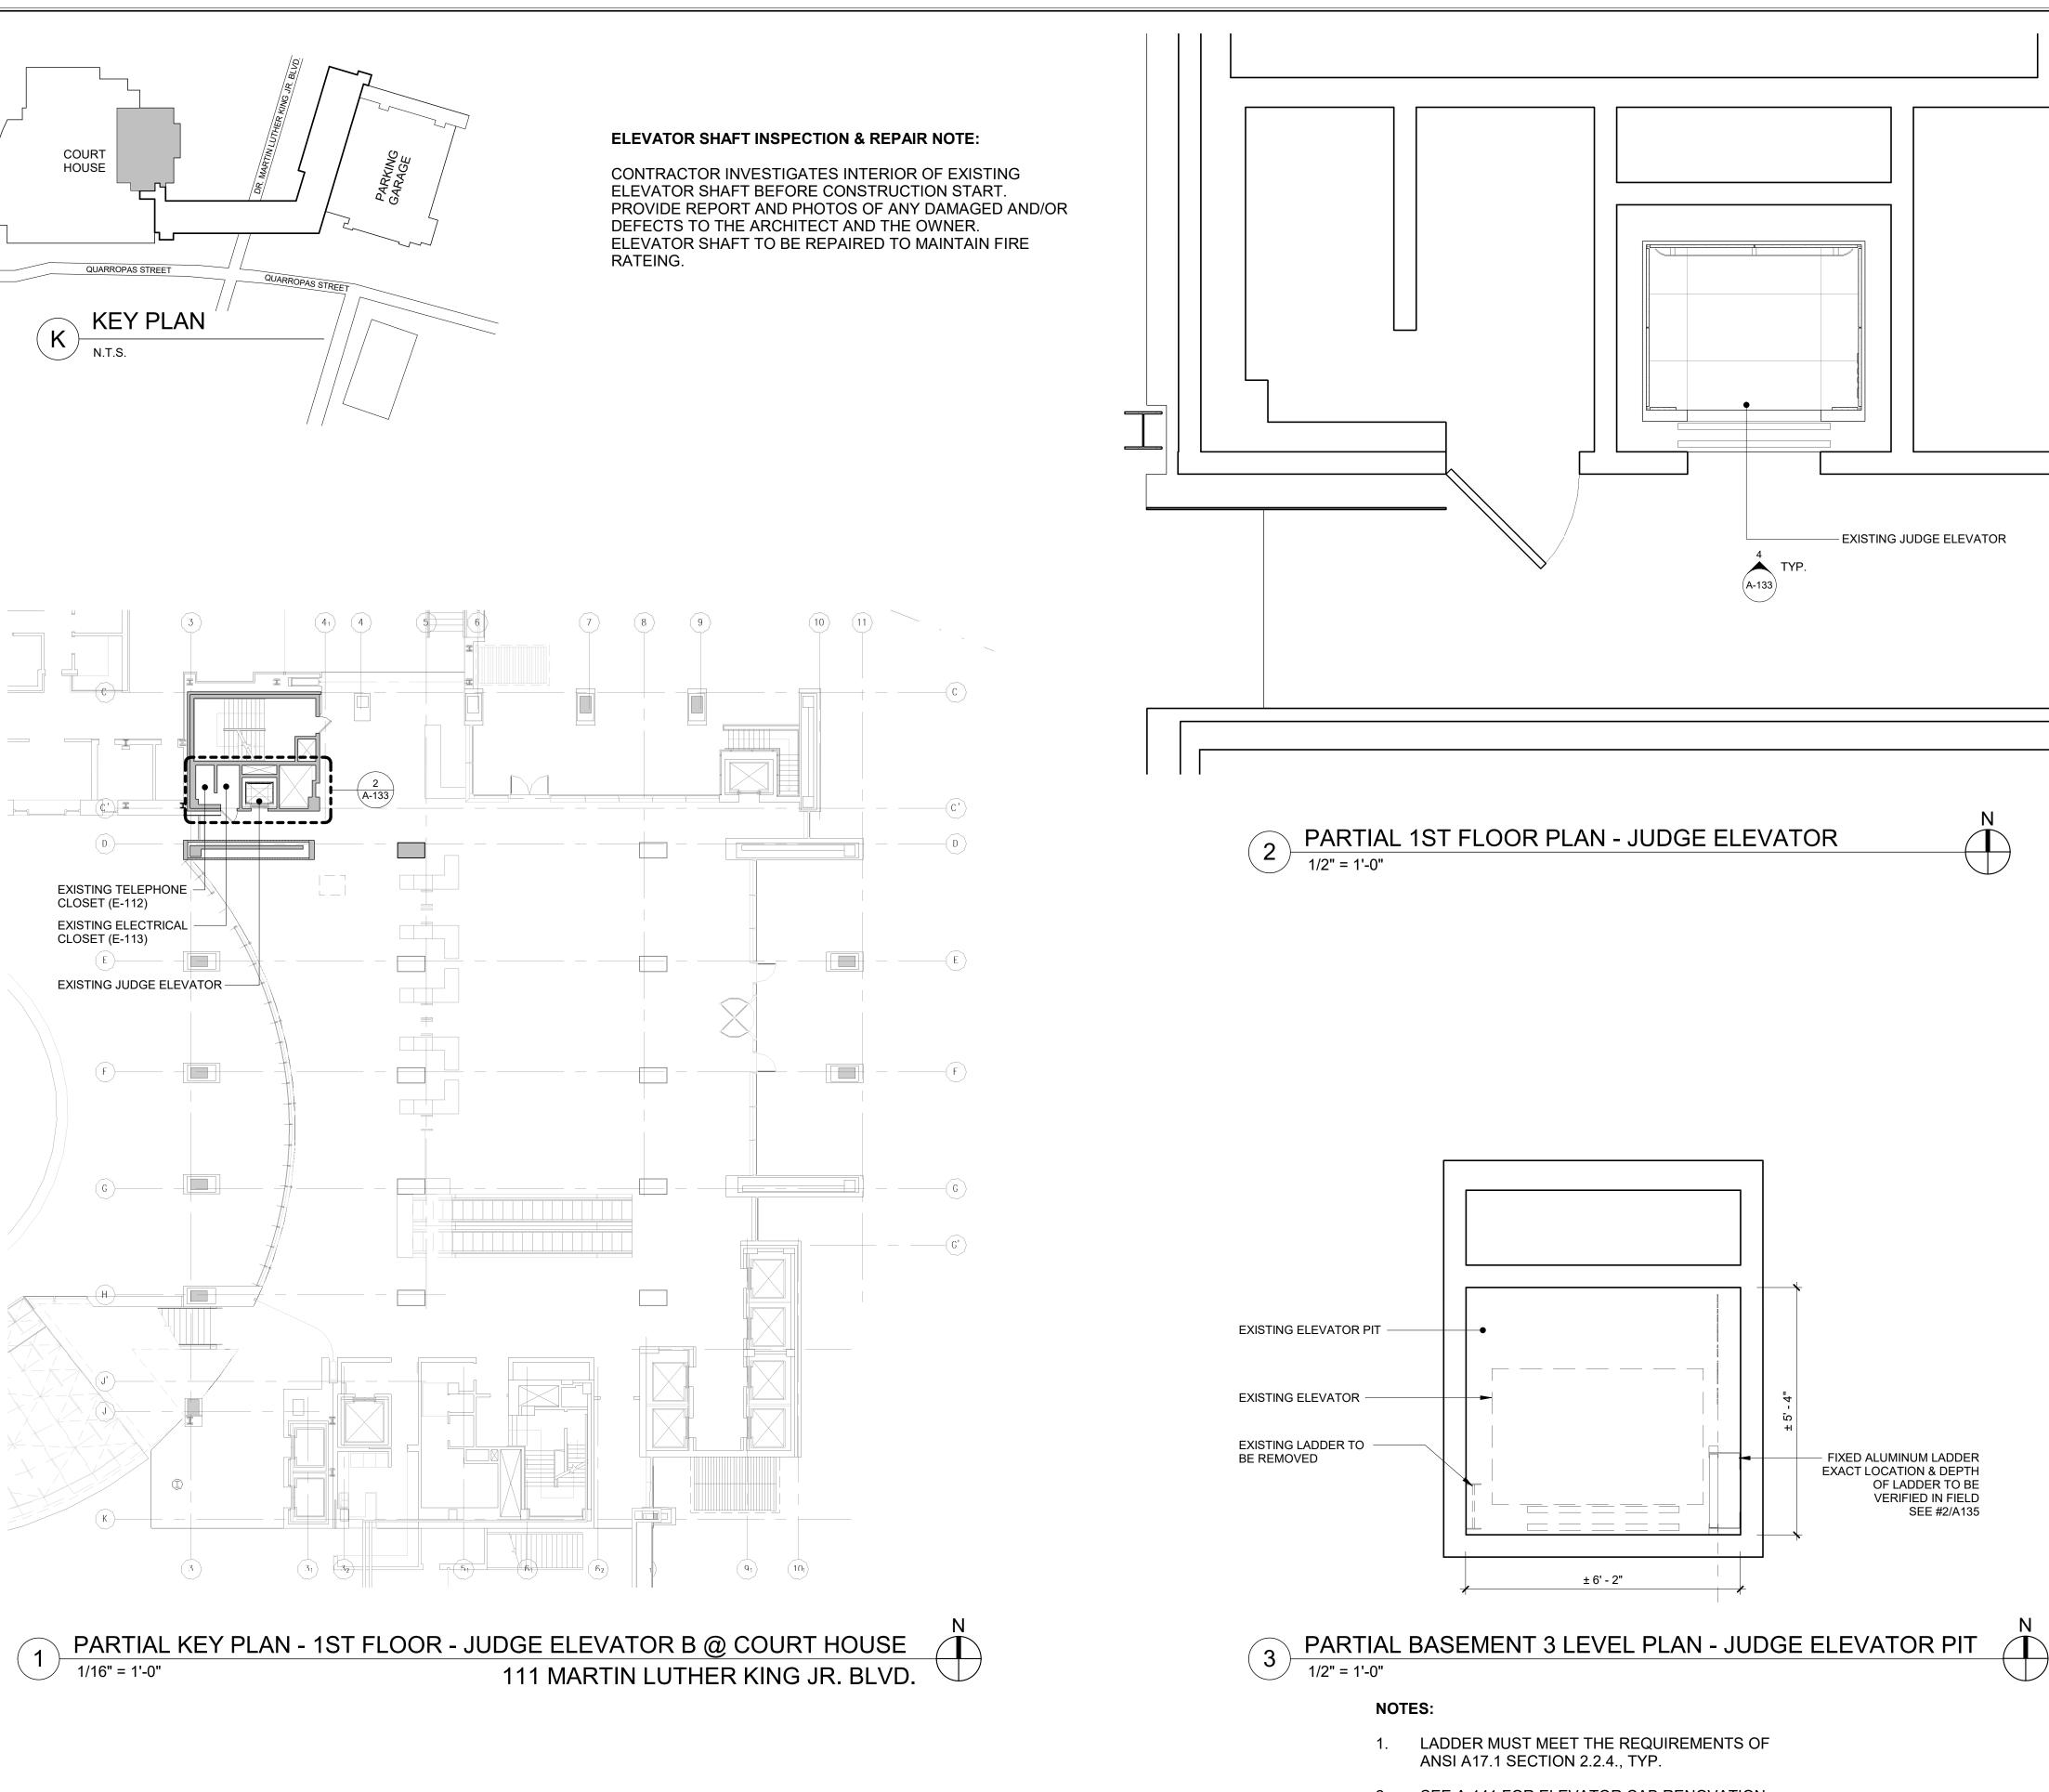


SEE A-141 FOR ELEVATOR CAB RENOVATION 2. DETAILS.


						- HALL LANTERN TO BE REPLACED WITH NEW DEVICE AT EXIST. LOCATION
				CL		CALL BUTTON TO BE REPLACED WITH NEW DEVICE AT EXIST. LOCATION
		↓)	P. ELEV = 1'-0"	ATOR WALL	ELEVATIO	<u>ON</u>
		NOTES				
			YPICAL FO	NR ALL 21 FLOORS. V N FIELD.	/ERIFY COND	IIIONS &
		С	OORDINA	LL AREA TO MATCH TE WALL MOUNTED CONTRACTOR.		WITH
CONSULTANT SEAL		CONSULTANT	INFORMATION			
CONSULTANT SEAL		CONSULTANT	Gr 90-	•af & Lev Architec 30 161st Street, Ja 5: 718-651-6200 F	ts LLP	1432
CONSULTANT SEAL	DATE		Gr 90-	Archited 30 161st Street, Ja	ets LLP	1432
CHARTER CONTROL OF NE	DATE	MADE BY	Gr 90- P	Archited 30 161st Street, Ja	ets LLP	1432
REVISION NUMBER AS BU		MADE BY REC	Gr 90- P	Archited 30 161st Street, Ja 2 718-651-6200 F	ets LLP	1432
REVISION NUMBER	IILT - CHANGE IILT - NO CHAN CONTF	MADE BY MADE BY REQ ES AS NOTED NGES RACTOR	Gr 90- P	Archited 30 161st Street, Ja 2 718-651-6200 F	REVISION	1432 289
REVISION NUMBER	IILT - CHANGE IILT - NO CHAN CONTF	MADE BY REC ES AS NOTED NGES RACTOR	Gr 90- P APP'D BY CORD DRA	Archited 30 161st Street, Jac 30 161st Street, Jac WING CERTIFICATI WING CERTIFICATI NAME: SIGNATURE:	REVISION	1432 289
REVISION NUMBER	UILT - CHANGE	MADE BY MADE BY REG S AS NOTED NGES RACTOR DATE	Gr 90-P P APP'D BY CORD DRA	Archited 30 161st Street, Jac 30 161st Street, Jac 30 161st Street, Jac WING CERTIFICATI AWING CERTIFICATI SIGNATURE: TITLE:	Ets LLP	DATE:
REVISION NUMBER	UILT - CHANGE UILT - NO CHAN CONTF CONTF WE EPARTMENT	MADE BY MADE BY REG SAS NOTED NGES RACTOR DATE STCHESTER OF PUBLIC	Gr 90-P P APP'D BY CORD DRA	Archited	Ets LLP	DATE:

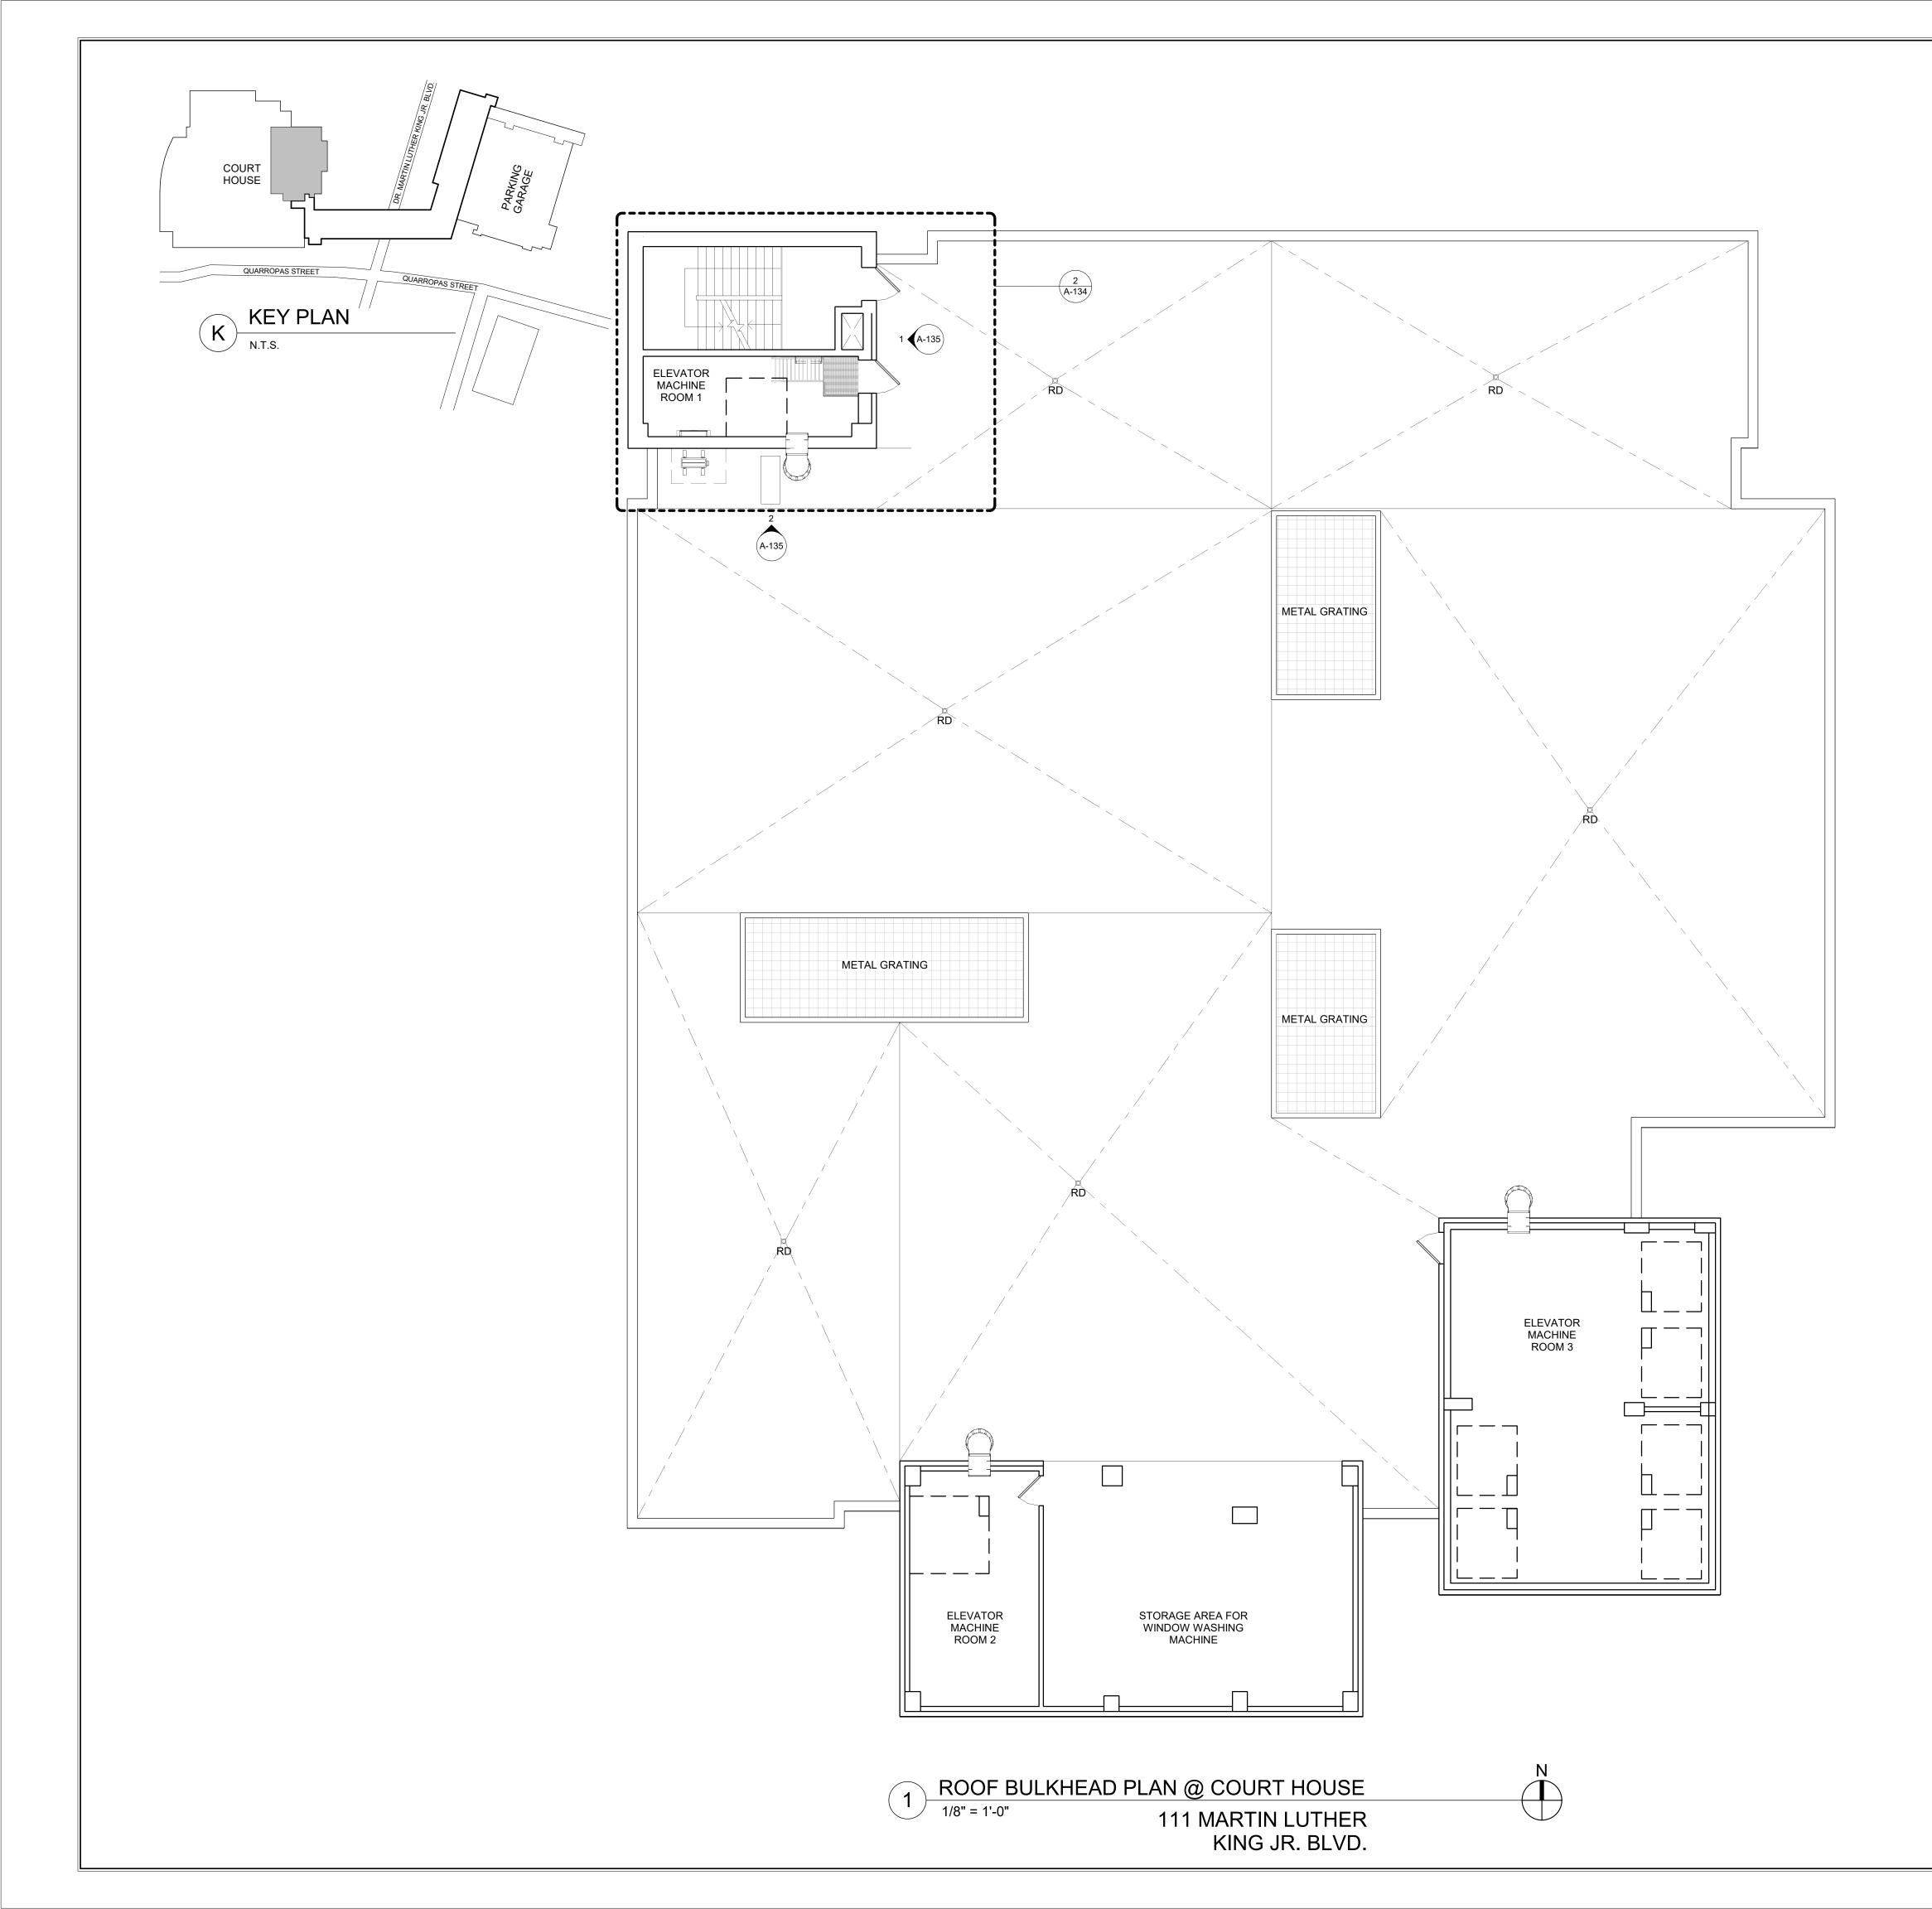

3 			
		ANCH EXISTIN MOD ELEVA ANCH PIT ELEVA SAW CUT 26" X 26" OP DUCTWORK DOWN INT (3) W 10 X RUNNING AIR CONDITION EXACT LOCATION FIELD & C ENGIN SEE #8/A-3	
	M WARRANTY RK TO BE DONE BY JM D TO JM FOR WARRAN		
AND A CONTRACT OF NEW YORK	90-30	f & Lewe Architects Ll 161st Street, Jamaica 18-651-6200 F: 718-	L P , NY 11432
REVISION DATE NUMBER	MADE BY APP'D BY RECORD DRAWI	REVIS NG CERTIFICATION	ION
AS BUILT - CHANGES AS BUILT - NO CHANG CONTRA NAME: SIGNATURE: TITLE:	GES ACTOR DATE:	NAME:	
DEPARTMENT (D LOW RISE BUILDING R	TCHESTER COUNTY, NEW DF PUBLIC WORKS AND TH IVISION OF ENGINEER ENOVATIONS AND HVAC IMP MARTIN LUTHER KING, JR. BC	ANSPORTATION AING ROVEMENTS - PHASE II DULEVARD	CONTRACT NUMBERSHEET NUMBER20-502A-134SHEET NO.36SCALE:As indicatedDATE: 01-19-2024Issue Date
	WHITE PLAINS, NEW YORK		DATE: 01-19-2024 Issue Date DPW FILE NO. 52-11-A-1848-0 NO.

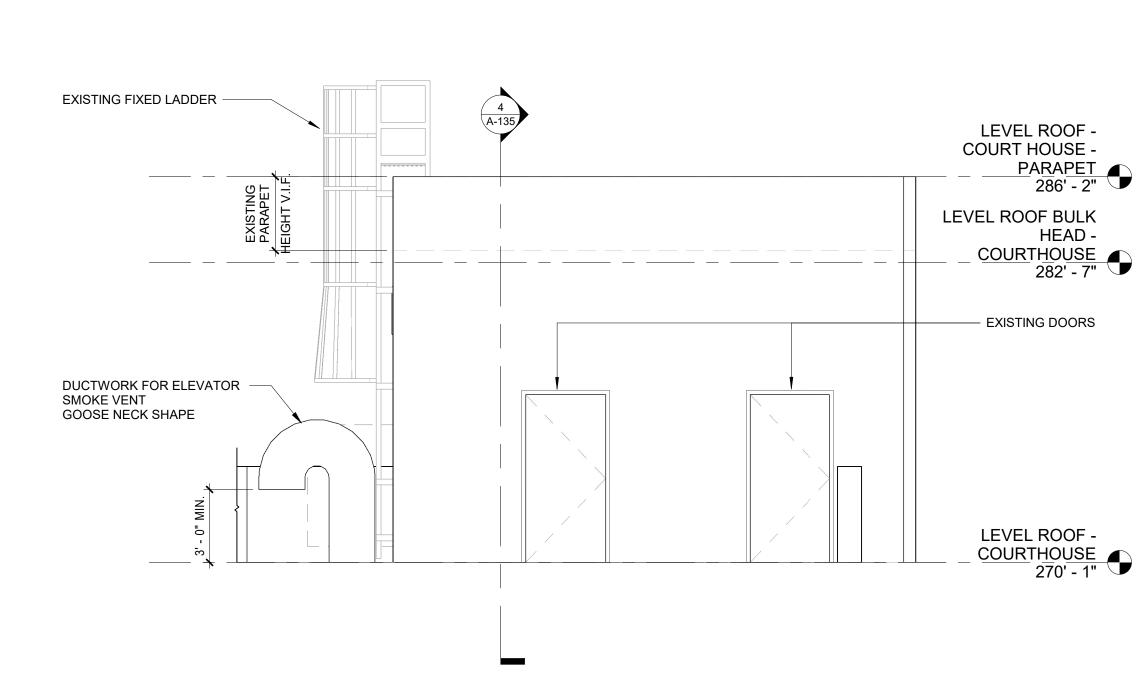




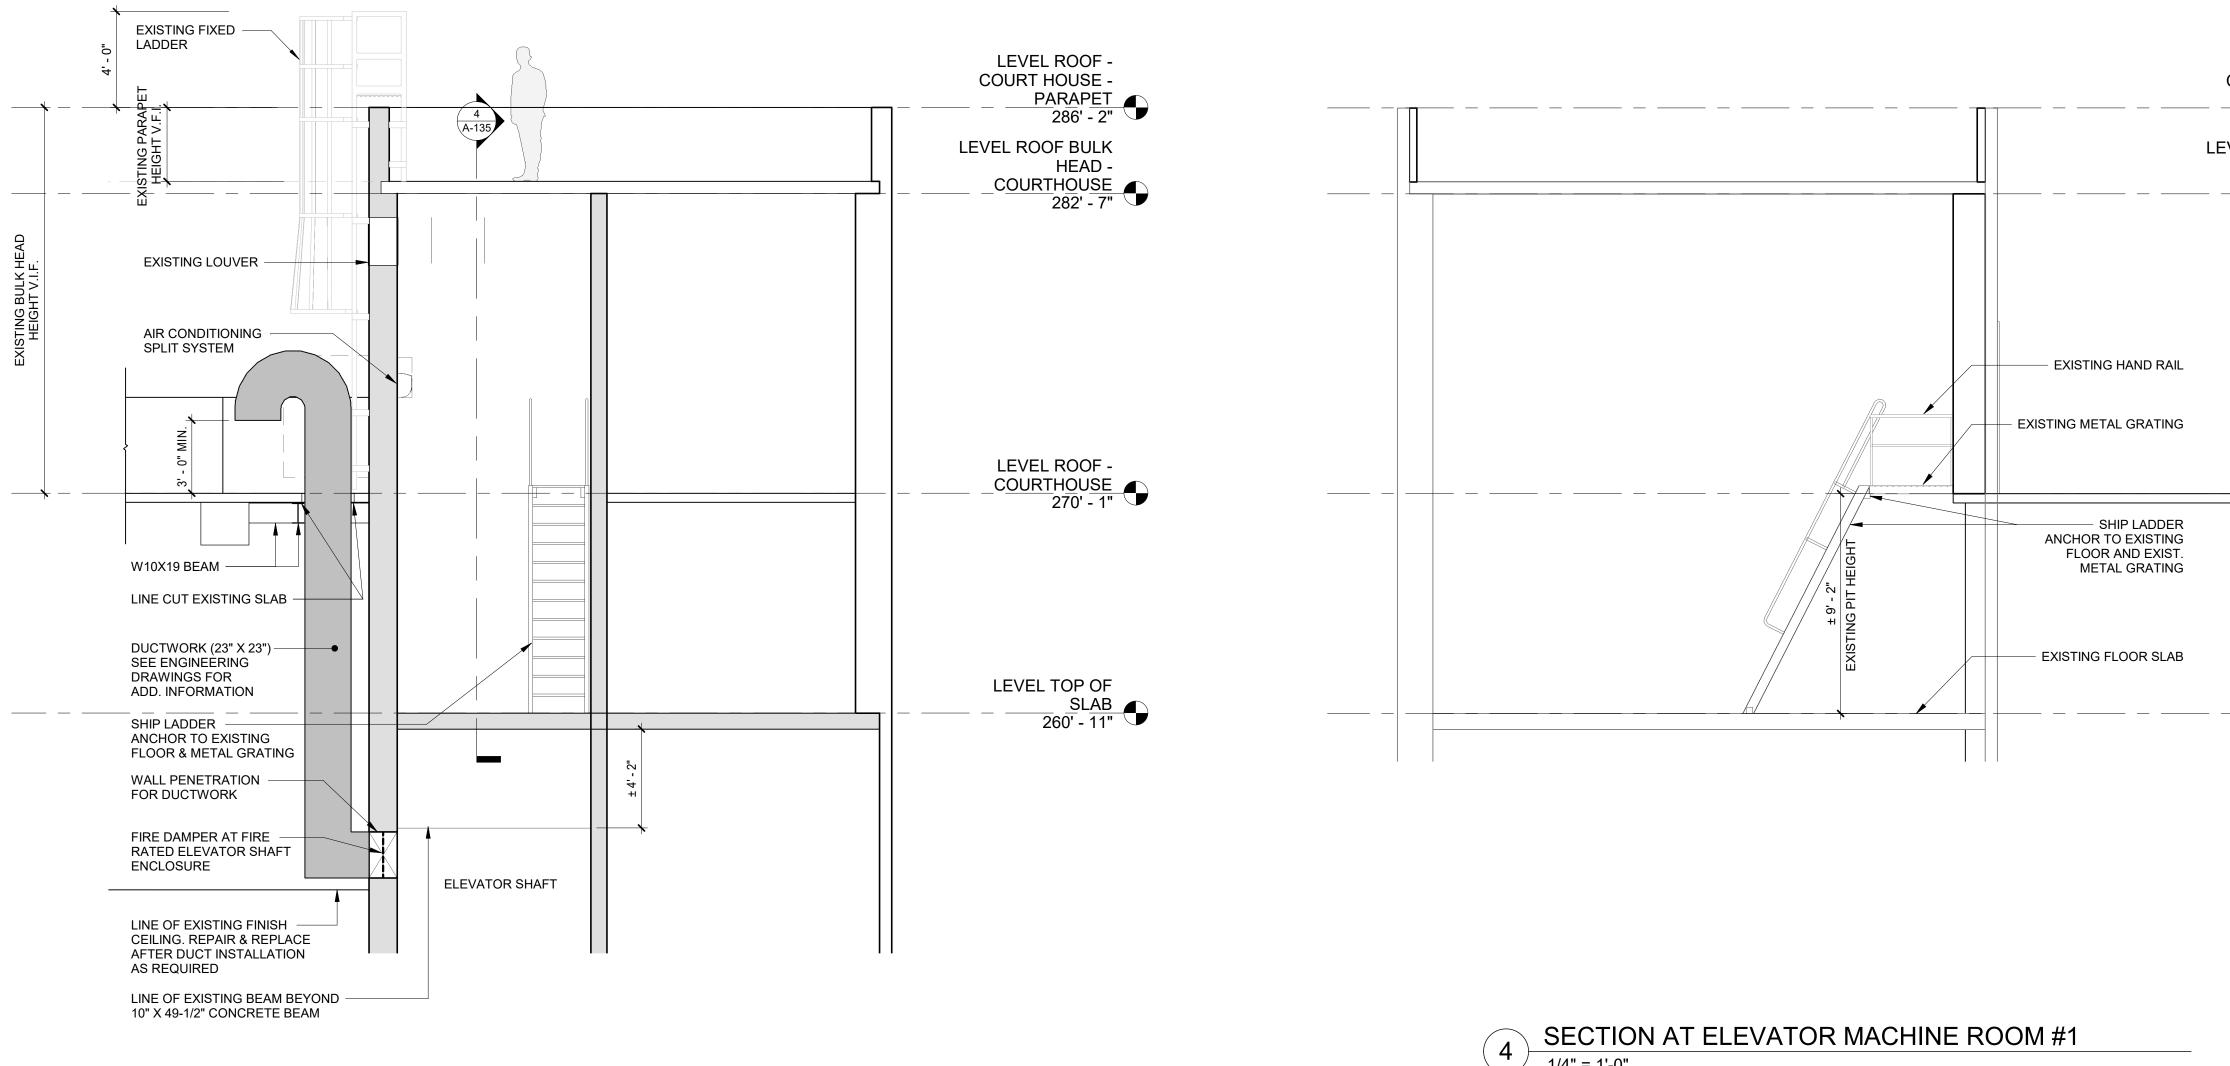

3 WEST SECTION - COURTHOUSE ROOF BULKHEAD - MACHINE ROOM #1



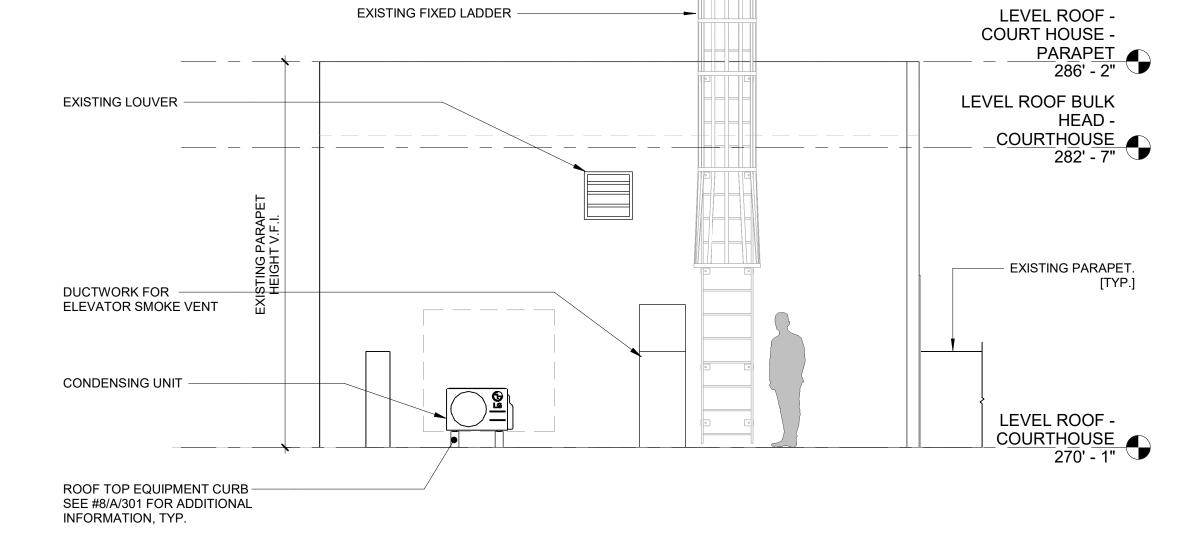

(2

NORTH ELEVATION - COURTHOUSE ROOF BULKHEAD - MACHINE ROOM #1 1/4" = 1'-0"

LEVEL ROOF -COURT HOUSE -PARAPET 286' - 2" LEVEL ROOF BULK HEAD -COURTHOUSE 282' - 7"


ROOF WARRANTY NOTE:

ROOF UNDER JM WARRANTY

ALL ROOF WORK TO BE DONE BY JM AUTHORIZED CONTRACTOR AND REPORTED TO JM FOR WARRANTY PURPOSES.


LEVEL ROOF - <u>COURTHOUSE</u> 270' - 1"
LEVEL TOP OF <u>SLAB</u>

CONSULTANT SEAL		CONSULTANT	INFORMATION					
REGISTERED VENTERI R. VENTERI R. VENTERI R.			90	0-30 1	f & Lewe Architects Ll 61st Street, Jamaica 3-651-6200 F: 718-	L P		
REVISION NUMBER	DATE	MADE BY	MADE BY APP'D BY REVISION					
		RE	CORD DF	RAWIN	G CERTIFICATION			
	ILT - CHANGE ILT - NO CHAN		•					
	CONTF	RACTOR			CONTRACTOR			
NAME:					NAME:			
SIGNATURE: _					SIGNATURE:			
TITLE:		DATI	E:		TITLE:	DATE:		
	WES	STCHESTER	COUNTY,	NEW Y	ORK	CONTRACT NUMBER	SHEET NUMBER	
DE	EPARTMENT	OF PUBLIC	WORKS A	ND TRA	NSPORTATION	20-502	A-135	
	Γ			NEERII	NG	SHEET NO. 37		
LOW RIS					OVEMENTS - PHASE II	SCALE:	1/4" = 1'-0"	
110 DR. MARTIN LUTHER KING, JR. BOU WHITE PLAINS, NEW YORK				ILEVARD	DATE: 01-19-2024	Issue Date		
						DPW FILE NO.	REV NO.	
PARTIAL EXTERIOR ELEVATIONS & SECTION					JNG - TTIVILK DLVD	52-11-	A-1849-0 ^{ℕ∪.}	

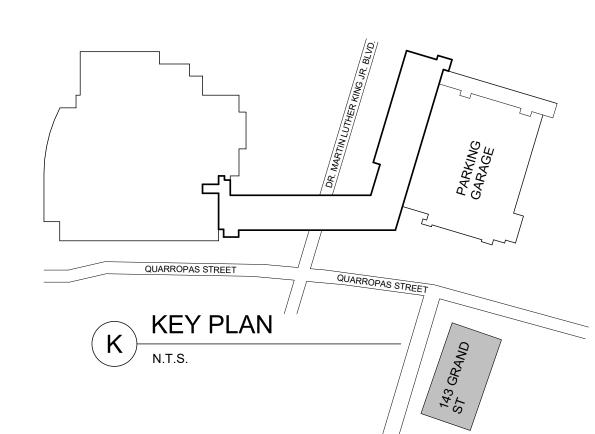







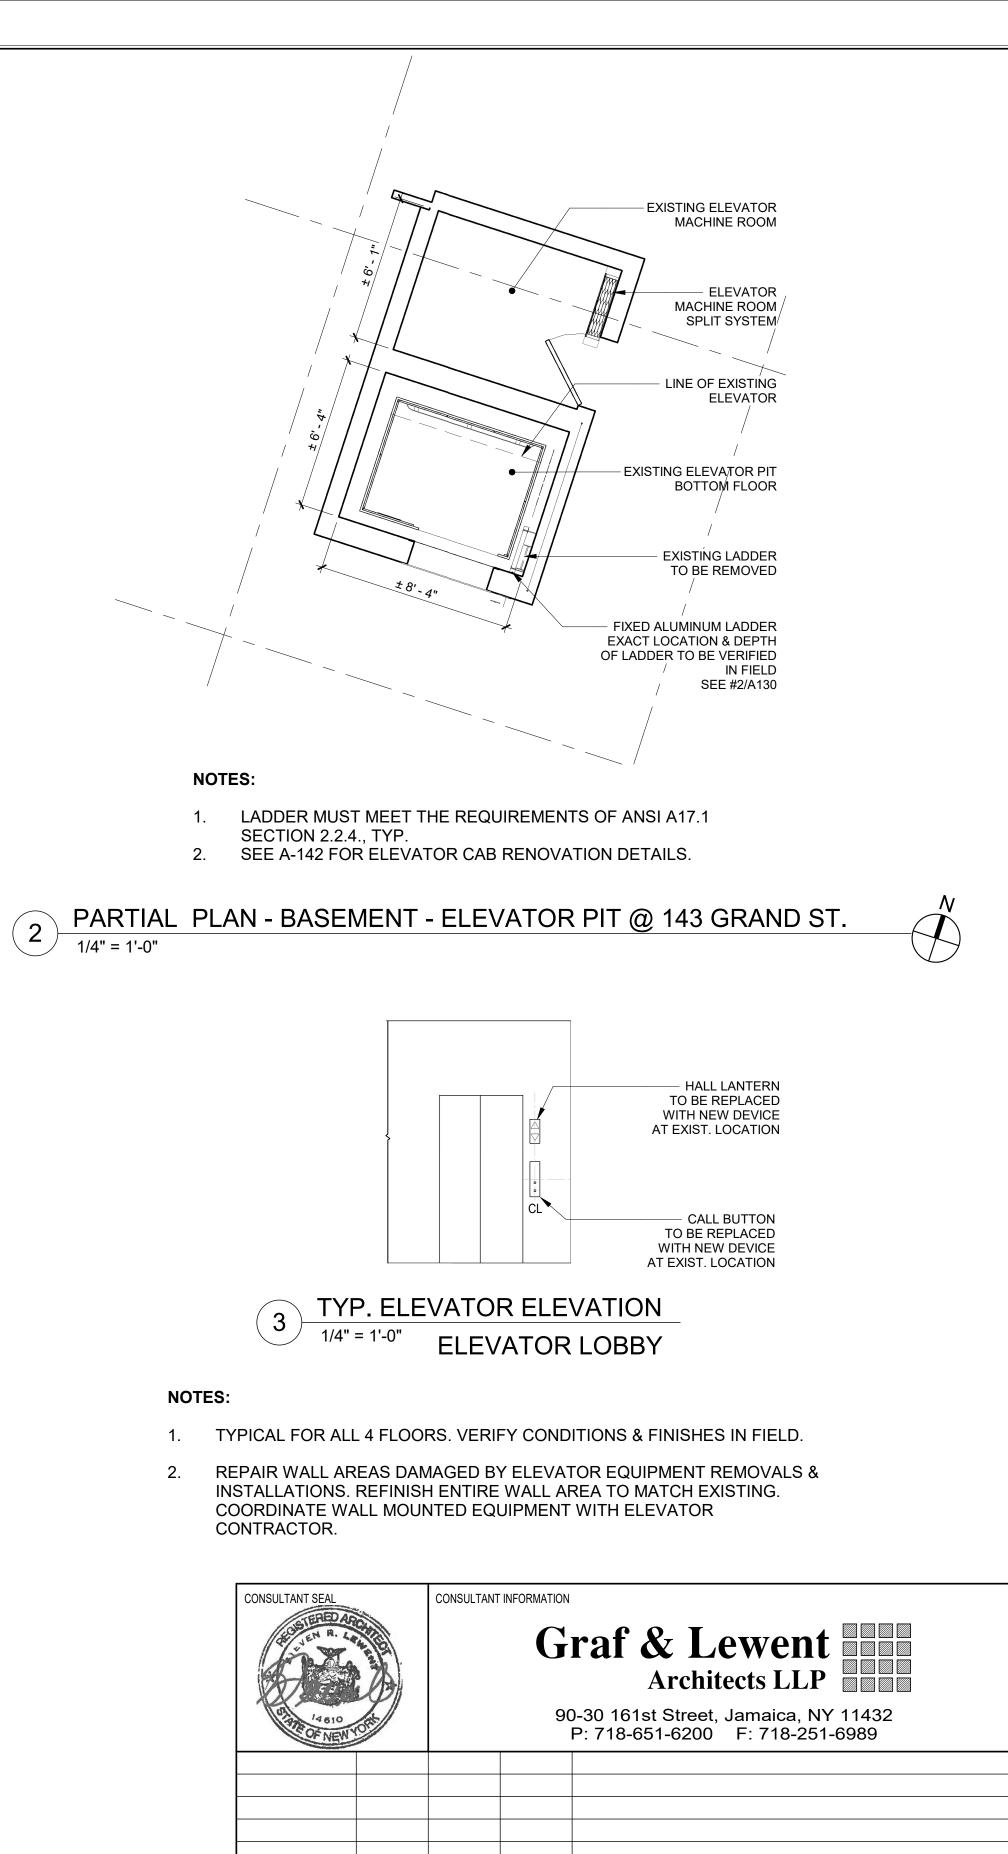

EVISION JMBER	DATE	MADE BY	APP'D BY	REVISION				
RECORD DRAWING CERTIFICATION								
AS BUILT	- CHANGES	S AS NOTED						


AS BUILT - CHANGES AS NOTED							
AS BUILT - NO CHANGES							
CONTRACTOR	CONTRACTOR						
NAME:	NAME:						
SIGNATURE:	SIGNATURE:						
TITLE: DATE:		DATE:					
WESTCHESTER COUNTY, NEW Y	CONTRACT	SHEET NUMBE	ĒR				
DEPARTMENT OF PUBLIC WORKS AND TRA		NUMBER 20-502	A-136	6			
DIVISION OF ENGINEERIN	NG	SHEET NO. 38	OF 133				
LOW RISE BUILDING RENOVATIONS AND HVAC IMPRO	-	SCALE:	As ind	icated			
110 DR. MARTIN LUTHER KING, JR. BOU WHITE PLAINS, NEW YORK	LEVARD	DATE: 01-19-2024	lssue	e Date			
		DPW FILE NO.		REV			
EXISTING BASEMENT PLAN - ELEVATOR - 1	43 GRAND STREET	52-11-A	\-1850-0	NO.			

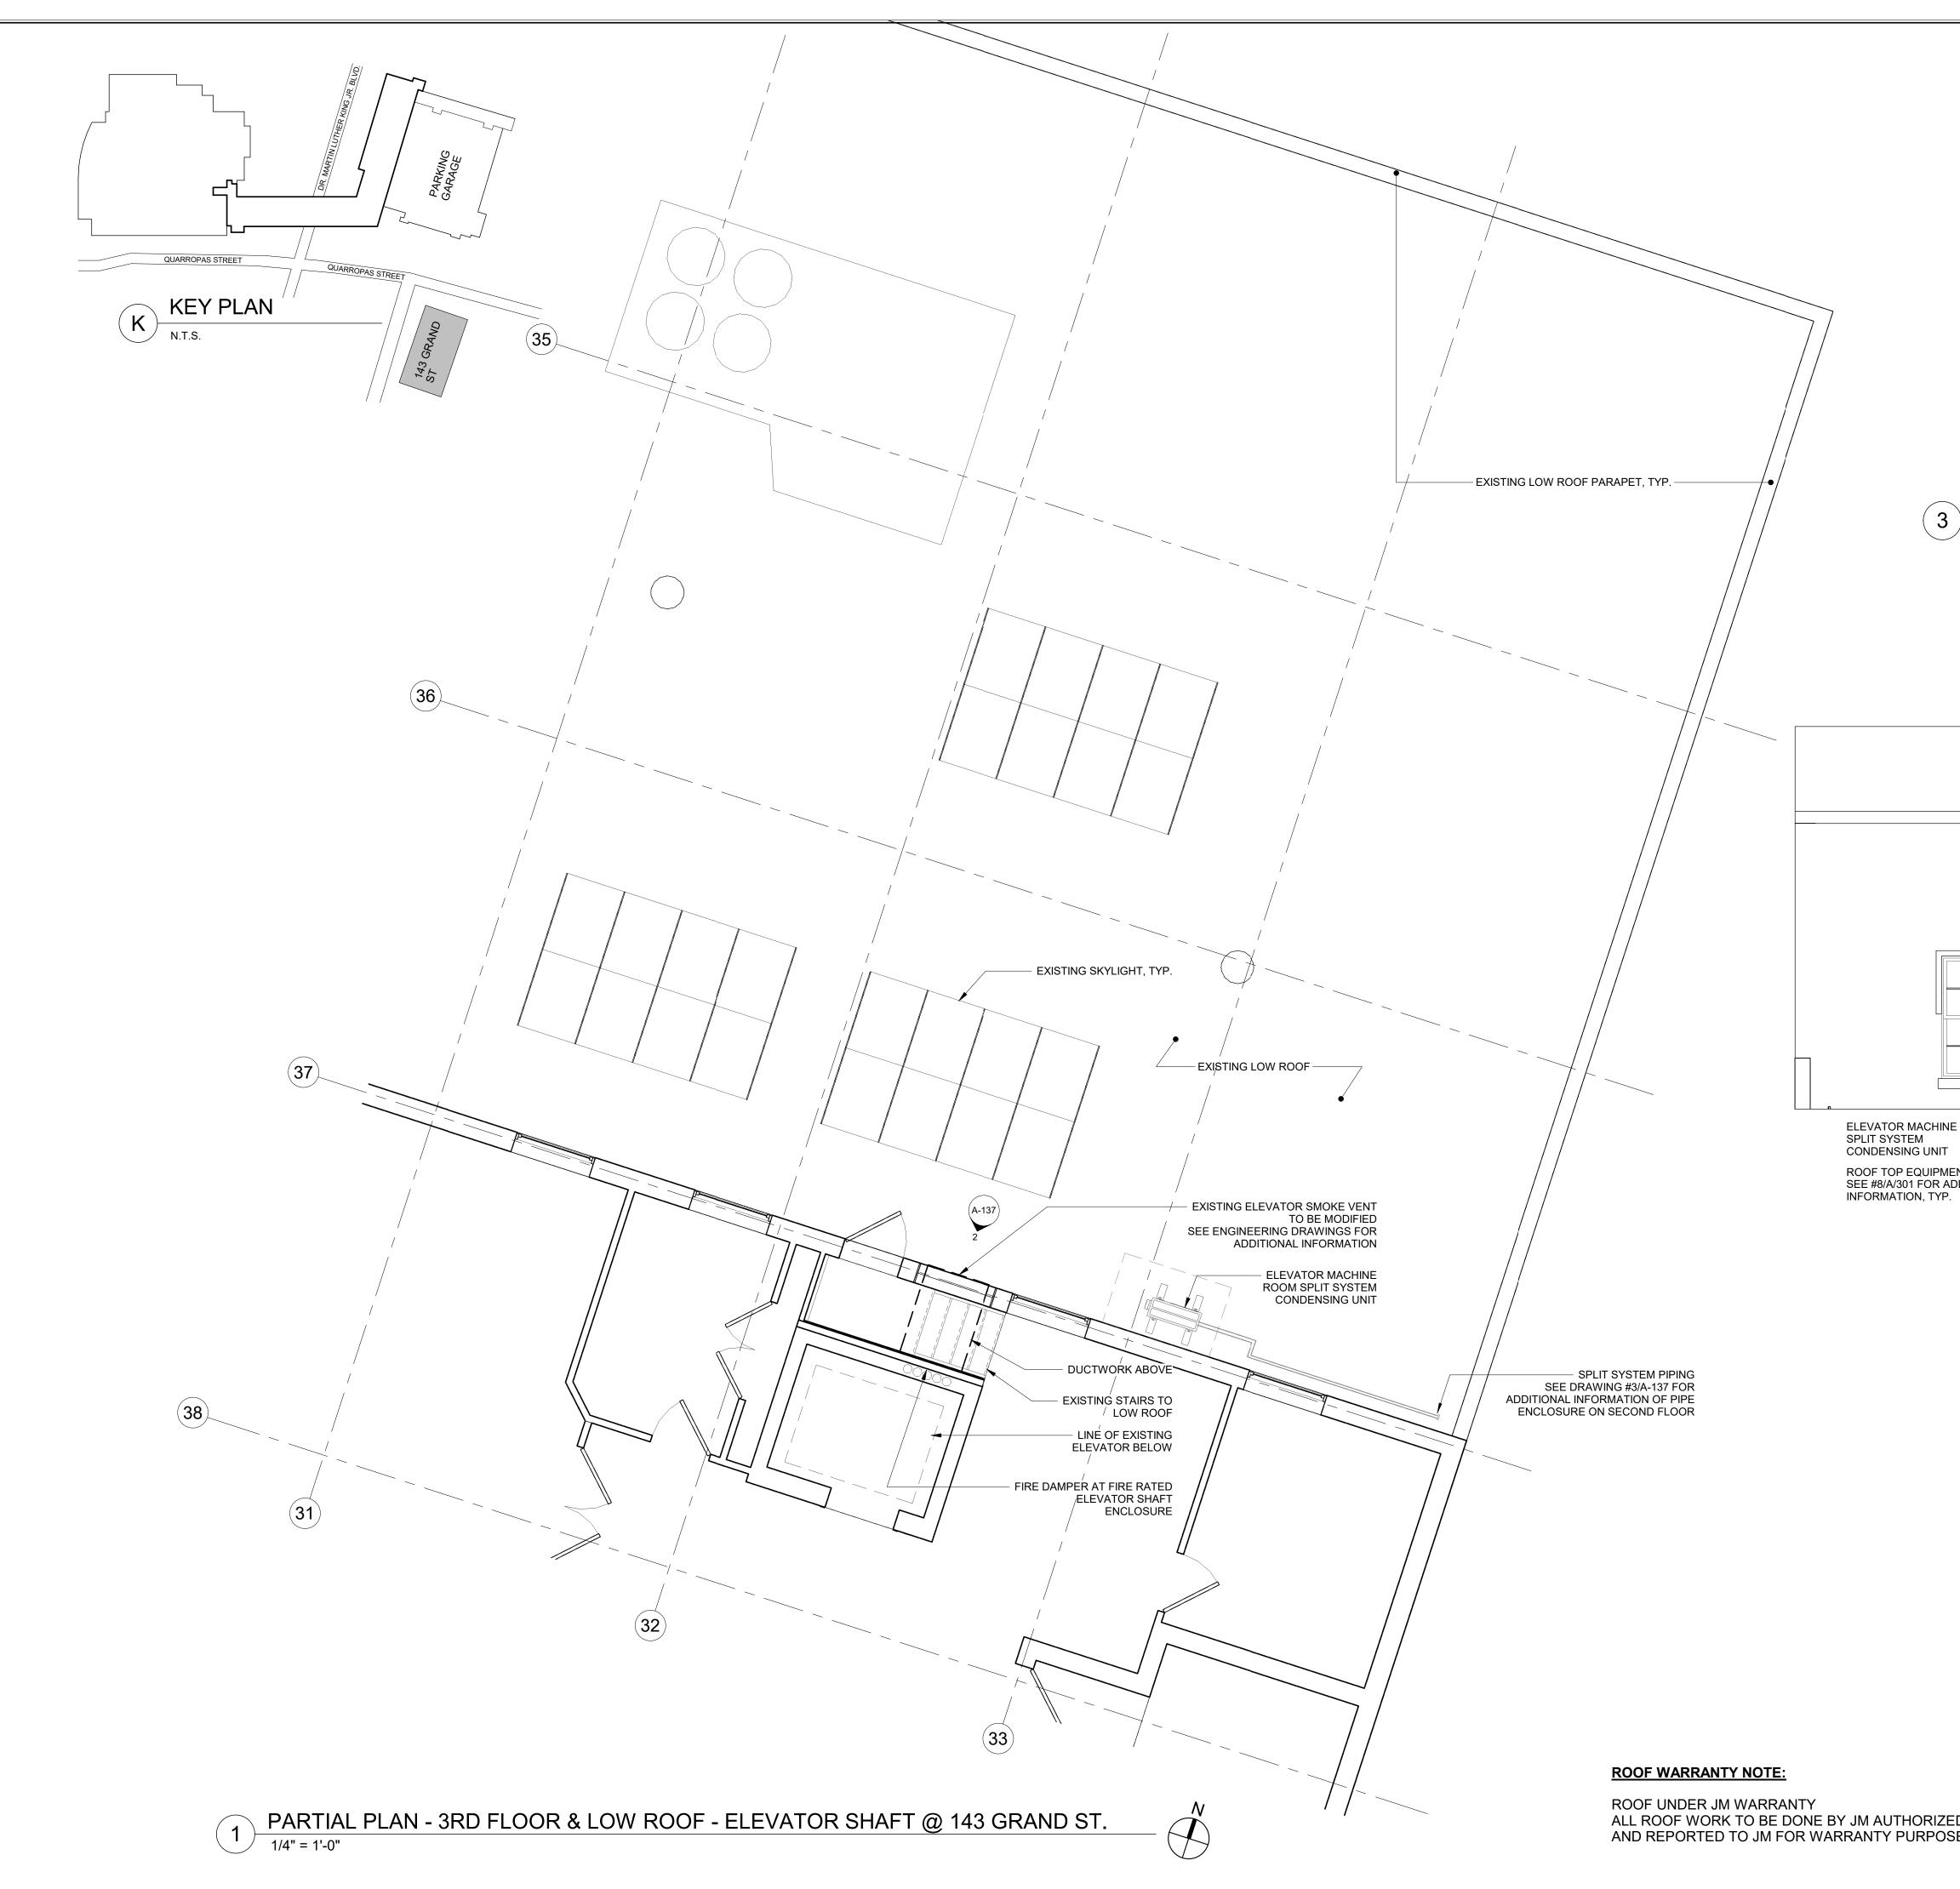


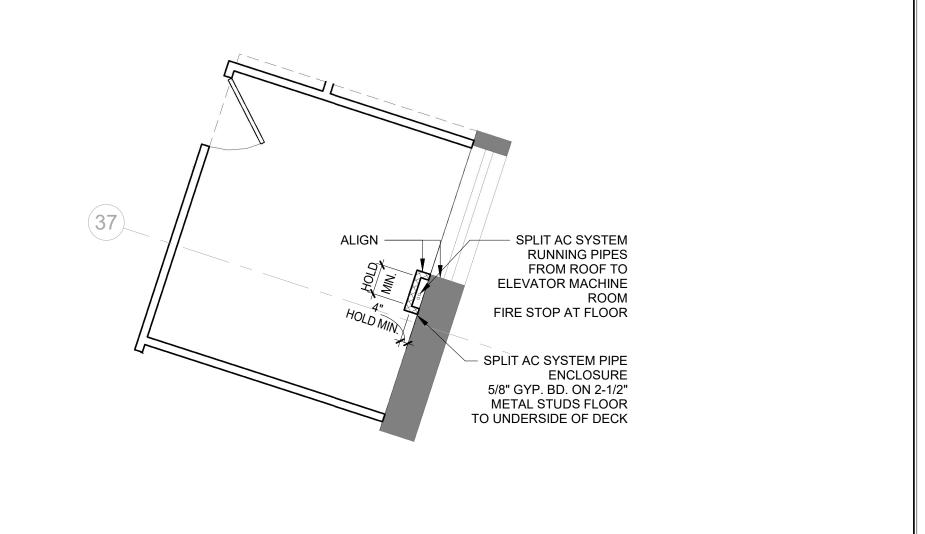



3 CONSTRUCTION PLAN - 2ND FL PIPE ENCLOSURE @ 143 GRAND ST. 1/4" = 1'-0"

	33			32	
ROOM NT CURB DDITIONAL PARTIAL 1/4" = 1'-0"					 EXISTING ELEVATOR SOMKE VENT TO REMAIN TO BE MODIFIED AS REQUIRED EXISTING ACCESS DOOR EXISTING OVERHUNG WINDOW, TYP.
	CONSULTANT SEAL	CONSULTANT INFO	Graf 90-30 16	Caracterization Architects LL 61st Street, Jamaica, 6-651-6200 F: 718-2	P
	REVISION DATE NUMBER		P'D BY RD DRAWING	REVISIO	N
D CONTRACTOR ES.	NAME:	ANGES RACTOR DATE: DATE: ESTCHESTER CO T OF PUBLIC WO DIVISION OF	UNTY, NEW YO ORKS AND TRA ENGINEERIN	NAME:	DATE:
		WHITE PLAINS	S, NEW YORK	GRAND STREET	DATE: 01-19-2024 Issue Date DPW FILE NO. REV 52-11-A-1851-0 NO.

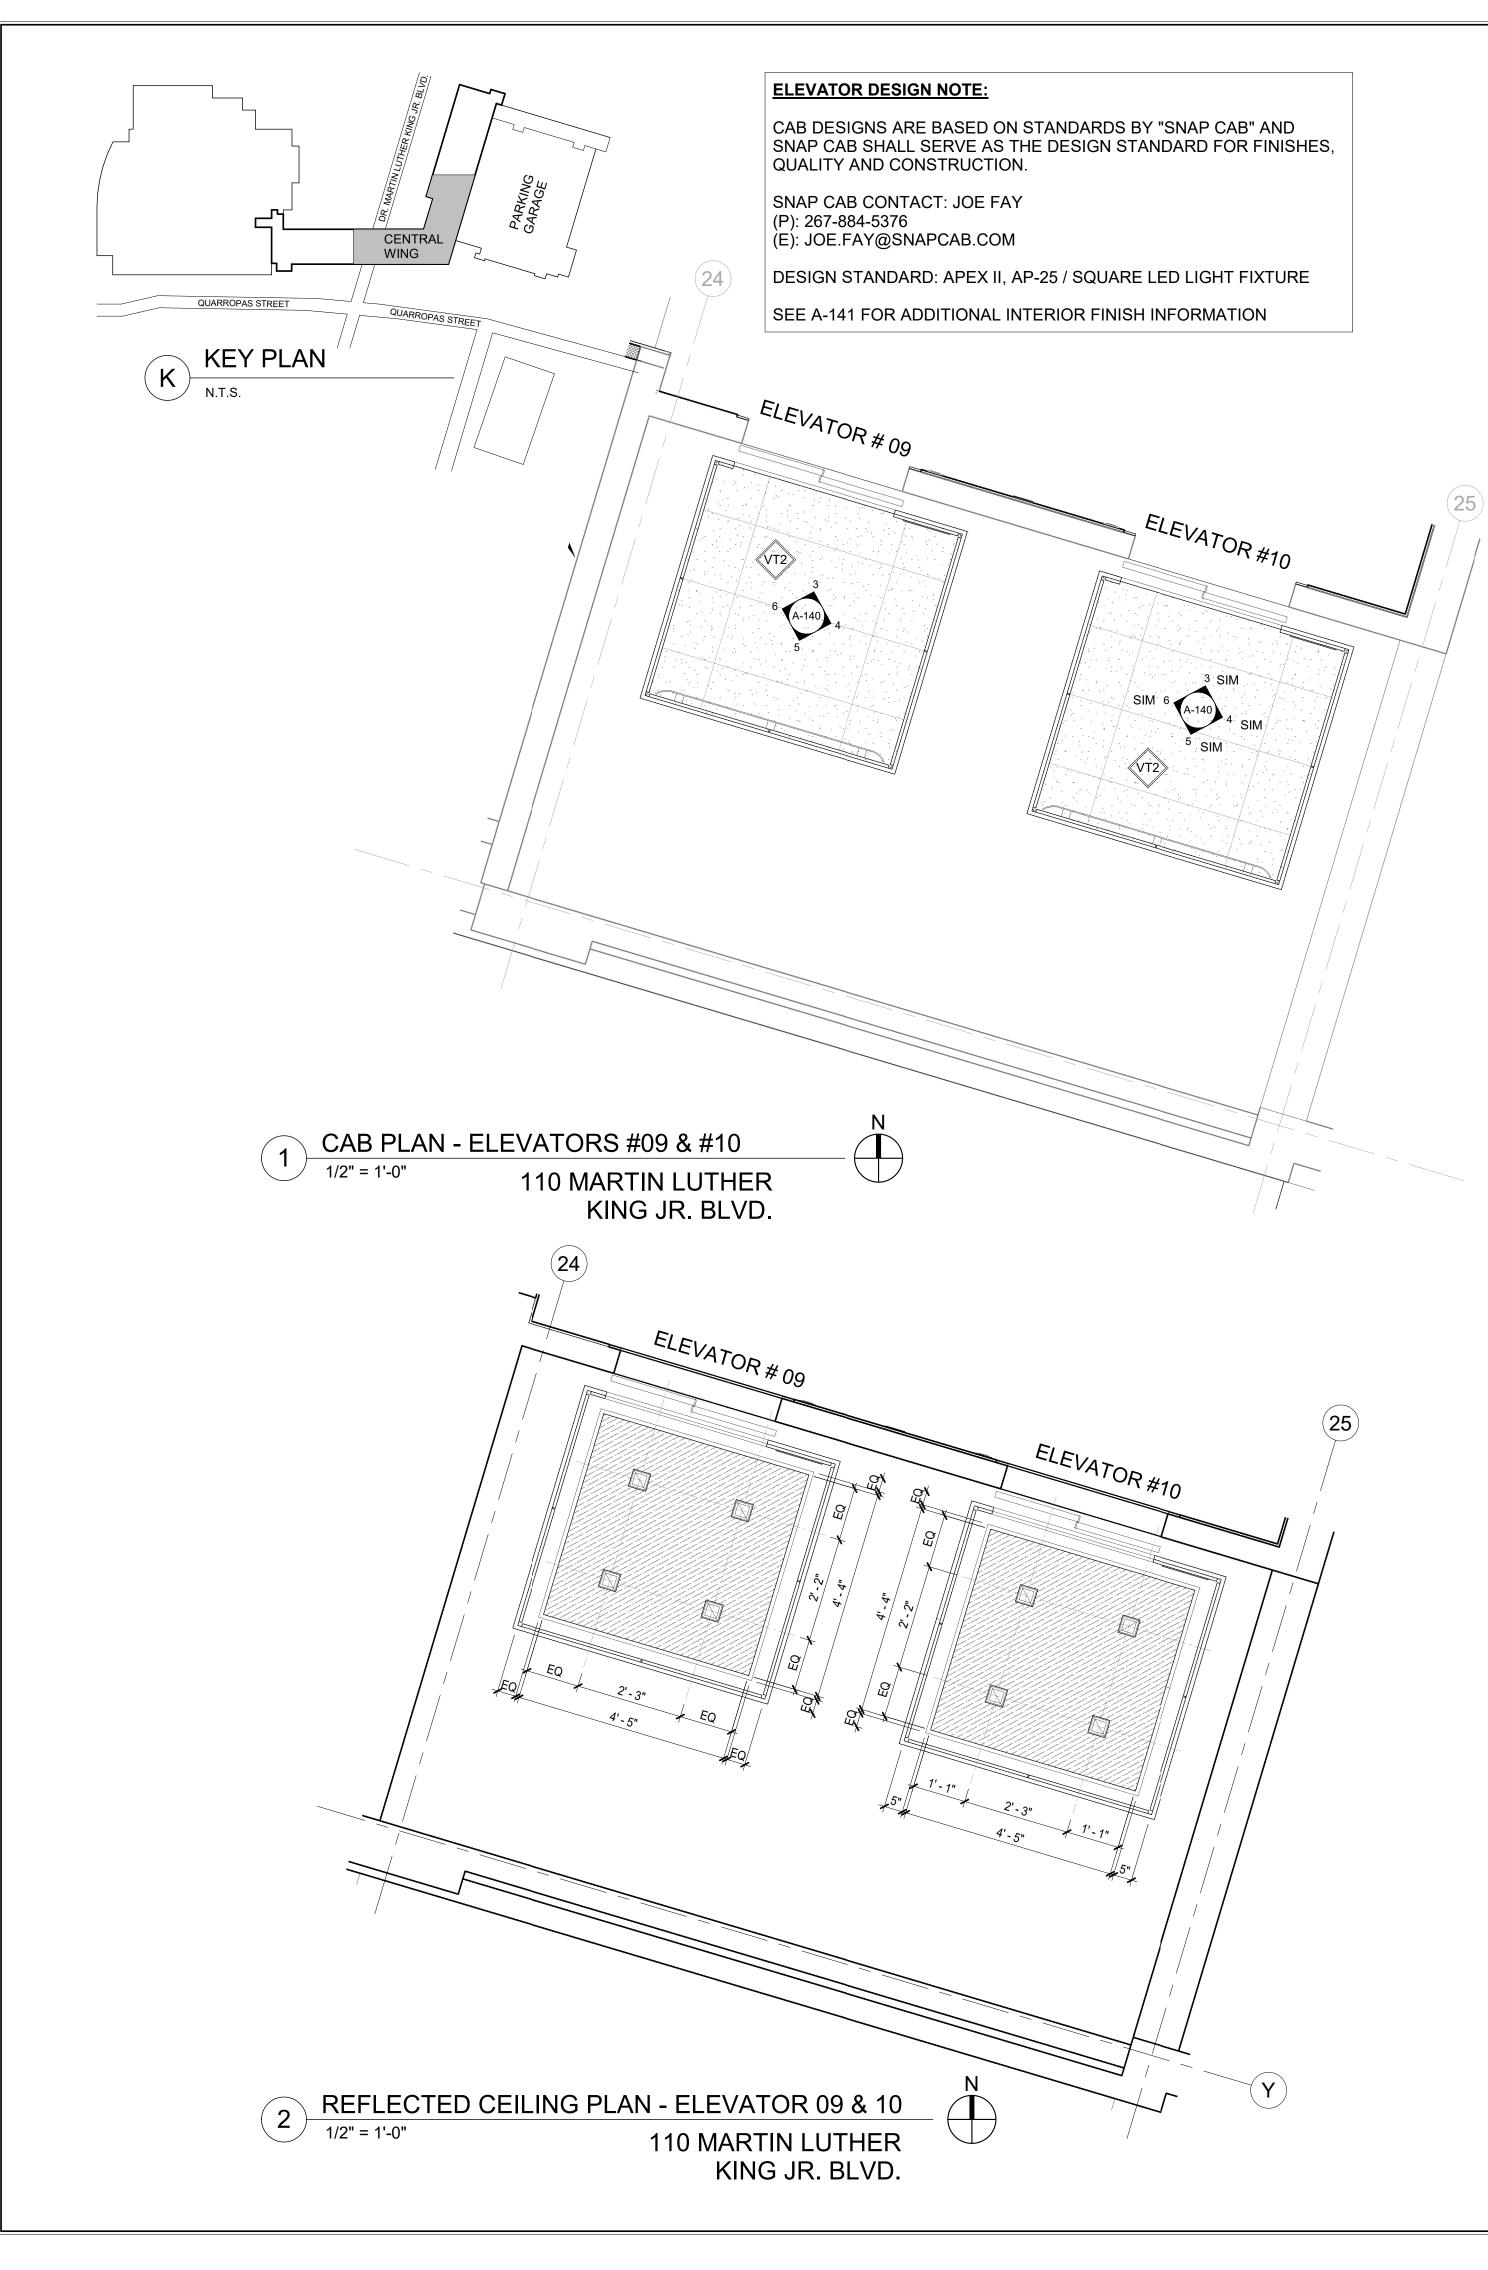

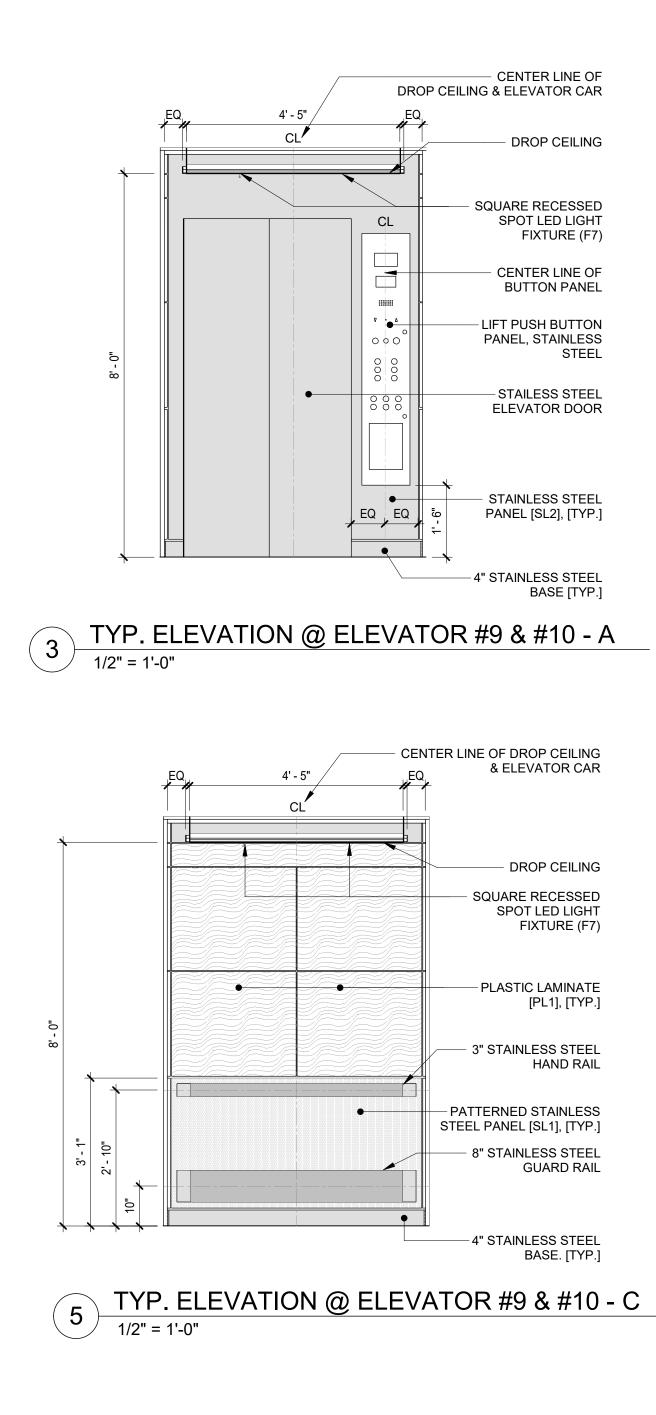

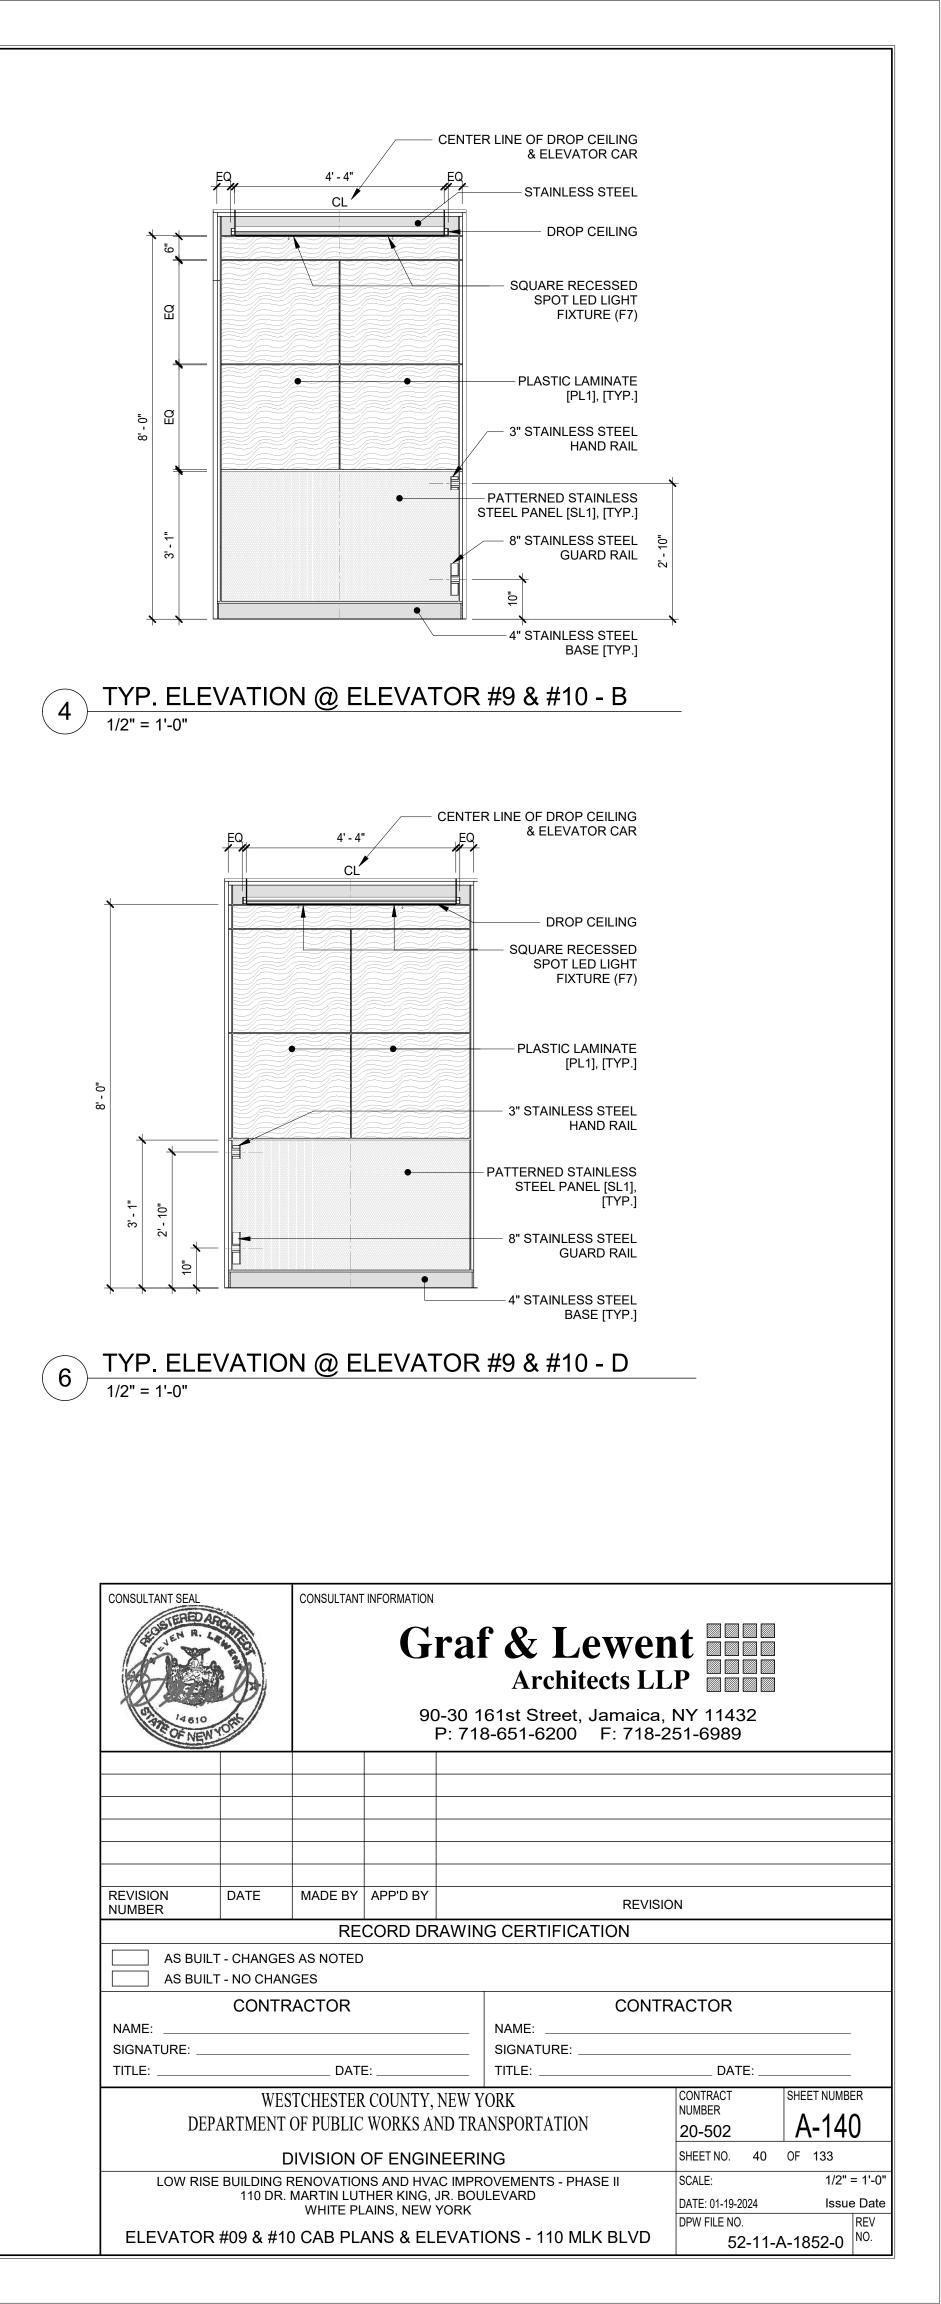

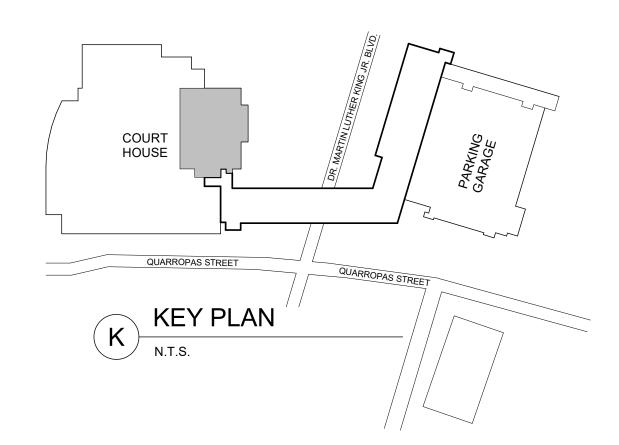

ELEVATOR DESIGN NOTE:


CAB DESIGNS ARE BASED ON STANDARDS BY "SNAP CAB" AND SNAP CAB SHALL SERVE AS THE DESIGN STANDARD FOR FINISHES, QUALITY AND CONSTRUCTION.

SNAP CAB CONTACT: JOE FAY (P): 267-884-5376


(E): JOE.FAY@SNAPCAB.COM

DESIGN STANDARD: HERITAGE II, HE-19 / SQUARE LED LIGHT FIXTURE

SEE A-141 FOR ADDITIONAL INTERIOR FINISH INFORMATION

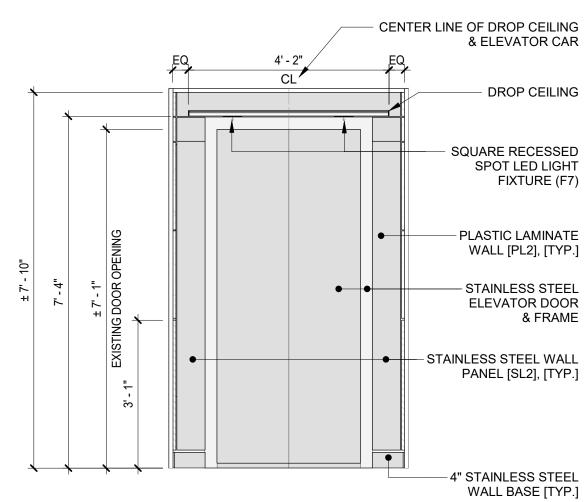



INTERIOR ELEVATION - JUDGE ELEVATOR - A 3 INTERIO 1/2" = 1'-0" COURT HOUSE

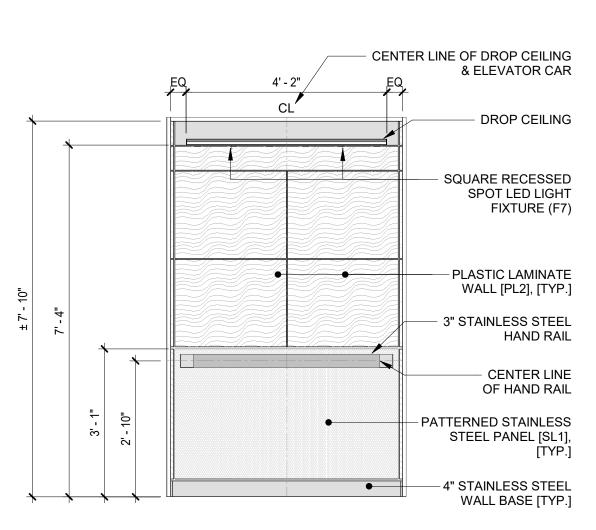




(1)

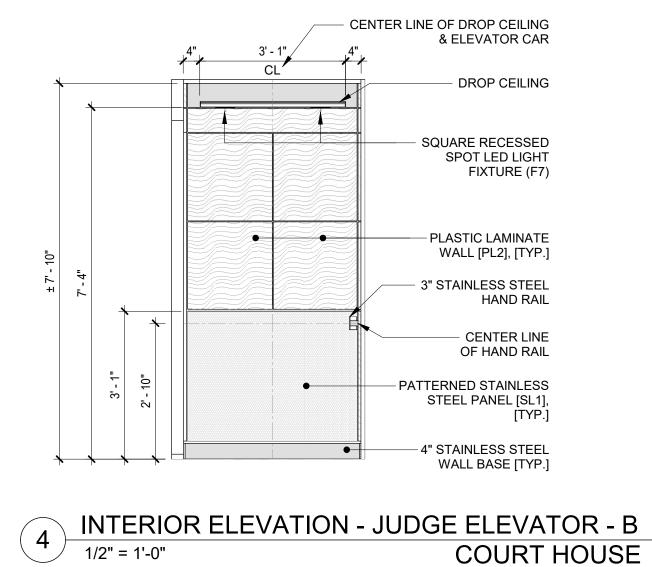

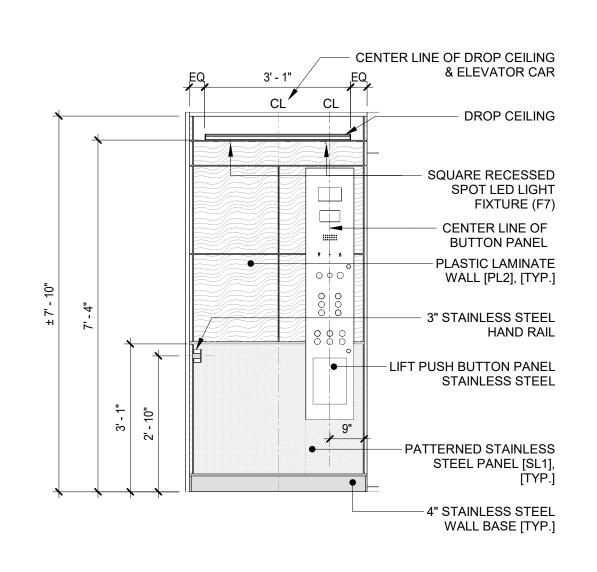

INTERIOR ELEVATION - JUDGE ELEVATOR - C COURT HOUSE



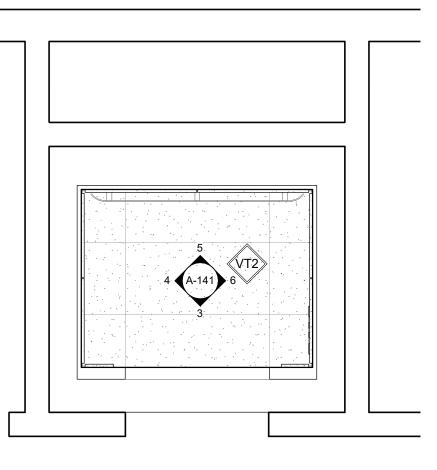


JUDGE ELEVATOR LOBBY



Ν CAB PLAN - COURT HOUSE - JUDGE ELEVATOR 111 MARTIN LUTHER KING JR. BLVD.

COURT HOUSE

6 INTERIOR ELEVATION - JUDGE ELEVATOR - D COURT HOUSE

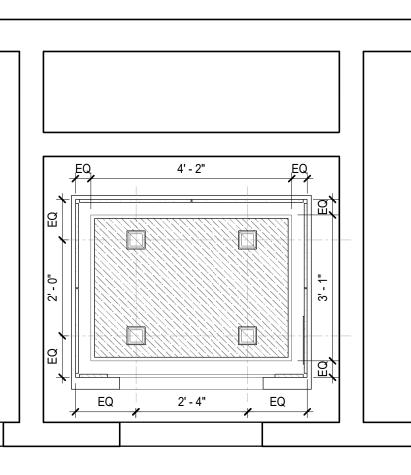


JUDGE ELEVATOR LOBBY

Ν 2 REFLECTED CEILING PLAN - COURT HOUSE - JUDGE ELEVATOR 1/2" = 1'-0" 111 MARTINI LITHED KING ID DIVID \bigcirc 111 MARTIN LUTHER KING JR. BLVD.

	SCHEDULE OF FINISHES - ELEVATOR CAB									
FINISH DESIGNATION	DESCRIPTION	MANUFACTURER	COLOR / MODEL NO.	NOTES						
PL-1	PLASTIC LAMINATE	WILSON ART	7919K-78 AMBER CHERRY	TOP FINISH WALL ELEVATOR #9 & 10 (110 MLK) AND BOARD OF ELECTION ELEVATOR (143 GRAND)						
PL-2	PLASTIC LAMINATE	WILSON ART	7925-38 MONTICELLO MAPLE	TOP FINISH WALL JUDGE'S ELEVATOR (111 MLK)						
SL-1	PATTERNED STAINLESS STEEL PANEL	RIGIDIZED METALS	5WL PATTERN	TYPICAL BOTTOM WALL ALL ELEVATORS						
SL-2	STAINLESS STEEL PANEL	-	#4 POLISHED STAINLESS STEEL	TYPICAL FRONT WALL FULL HEIGHT ALL ELEVATORS						
VT-2	RESILIENT FLOOR TILES	SHAW CONTRACT SURFACE	STYLE NUMBER: 0515V COLOR: CEMENT 15518	18" X 36" HEAVY DUTY TILE TYP. FINISH FLOOR ON ELEVATOR CAB						

CONSULTANT SEAL CONSULTANT INFORMATION								
Participant Participant		90)-30 1	f & Lewer Architects LI 61st Street, Jamaica, 3-651-6200 F: 718-2	LP			
REVISION NUMBER	DATE	MADE BY	APP'D BY		REVISI	ON		
	•	RE	CORD DR	AWIN	G CERTIFICATION			
	- CHANGES - NO CHAN							
	CONTR	ACTOR			CONTRACTOR			
NAME:					NAME:			
SIGNATURE:					SIGNATURE:			
		DATE	=:		TITLE:			
	WES	TCHESTER	COUNTY,	NEW Y	ORK	CONTRACT NUMBER	SHEET NUMBER	
DEP	ARTMENT	OF PUBLIC	WORKS AN	ND TRA	NSPORTATION	20-502	A-141	
DIVISION OF ENGINEERI				IEERII	NG	SHEET NO. 41	OF 133	
LOW RISE BUILDING RENOVATIONS AND HVAC IMPR						SCALE:	As indicated	
110 DR. MARTIN LUTHER KING, JR. BOU WHITE PLAINS, NEW YORK					LEVARD	DATE: 01-19-2024	Issue Date	
	EVATOR				NS - 111 MLK BLVD	DPW FILE NO.	REV NO.	
						52-11-/	A-1853-0 ^{NO.}	

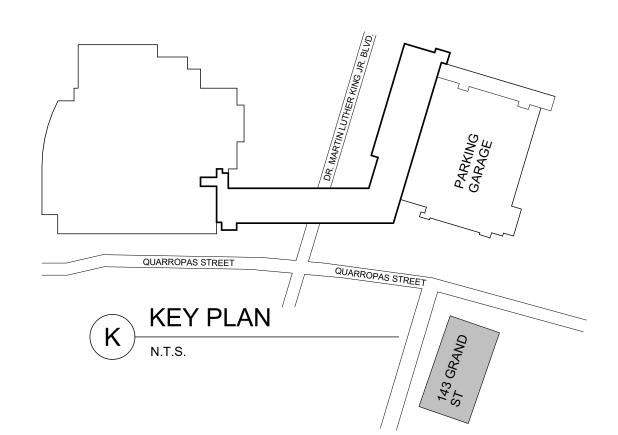

ELEVATOR DESIGN NOTE:

CAB DESIGNS ARE BASED ON STANDARDS BY "SNAP CAB" AND SNAP CAB SHALL SERVE AS THE DESIGN STANDARD FOR FINISHES, QUALITY AND CONSTRUCTION.


SNAP CAB CONTACT: JOE FAY (P): 267-884-5376 (E): JOE.FAY@SNAPCAB.COM

DESIGN STANDARD: APEX II, AP-25 / SQUARE LED LIGHT FIXTURE


SEE A-141 FOR ADDITIONAL INTERIOR FINISH INFORMATION

ELEVATOR OPERATION NOTE:

THE BUILDING CONTAINS SINGLE ELEVATOR. PERFORM ELEVATOR WORK IN TIMELY MANNER INCLUDING SATURDAY WORK TO COMPLETE ELEVATOR WORK IN SHORTEST TIME POSSIBLE NO WORK SHALL START UNTIL ALL EQUIPMENT AND MATERIAL IS AVAILABLE. CONTRACTOR SHALL SCHEDULE ALL WORK MINIMUM ONE WEEK IN ADVANCE.

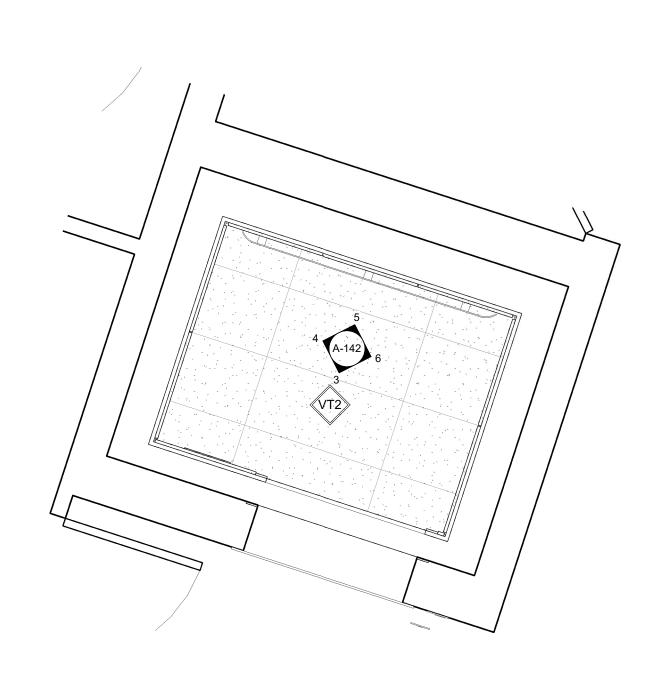




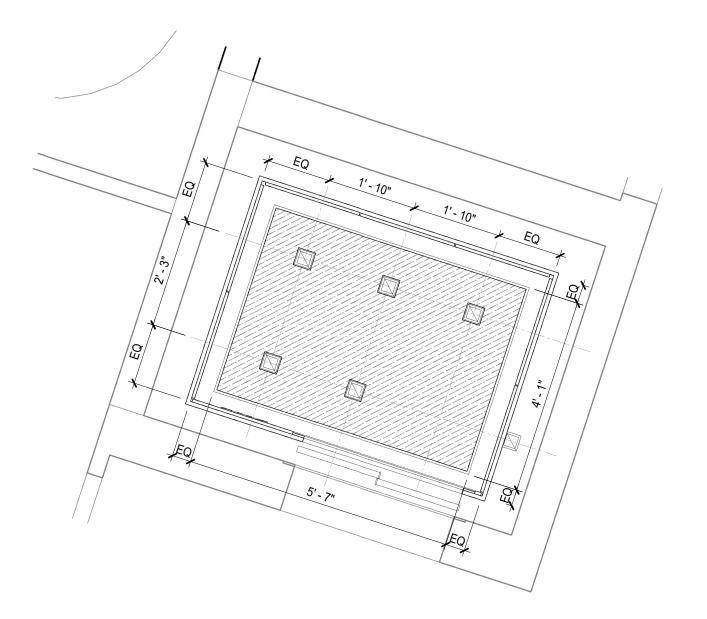




Ð 143 GRAND ST.


2 REFLECTED CEILING PLAN - ELEVATOR @ BOARD OF ELECTIONS. 1/2" = 1'-0" 143 GRAND ST.

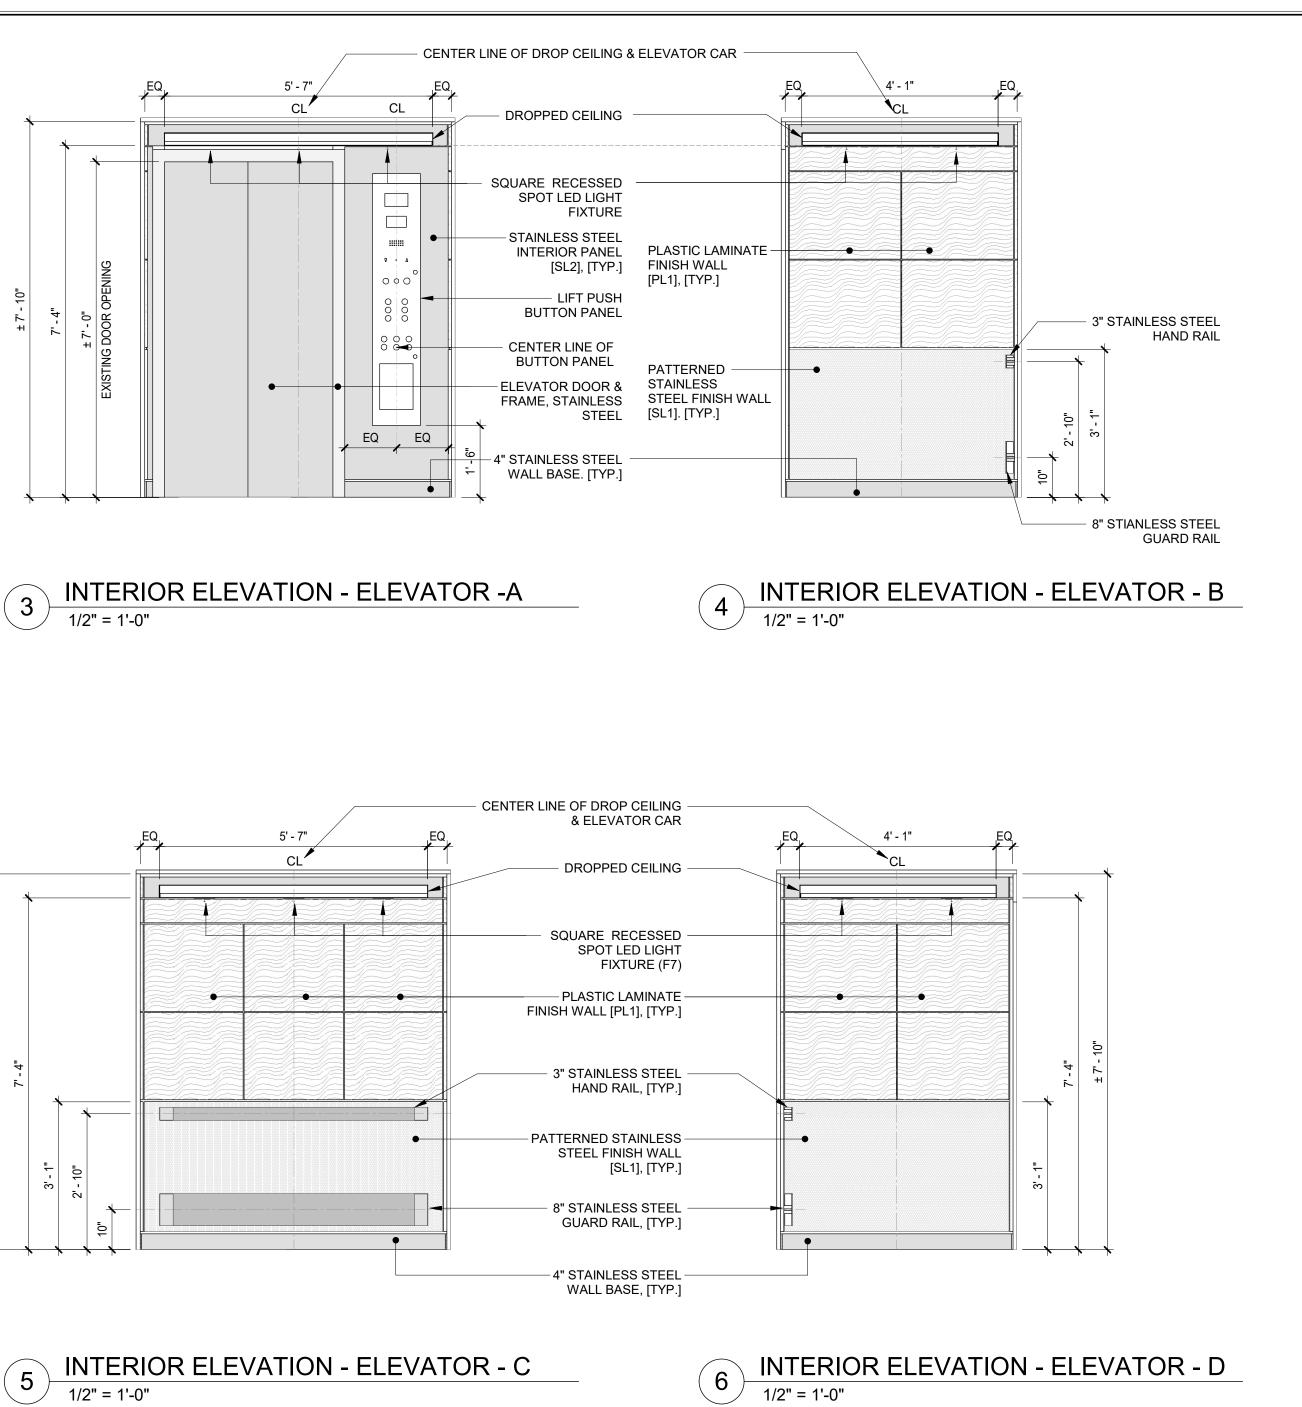

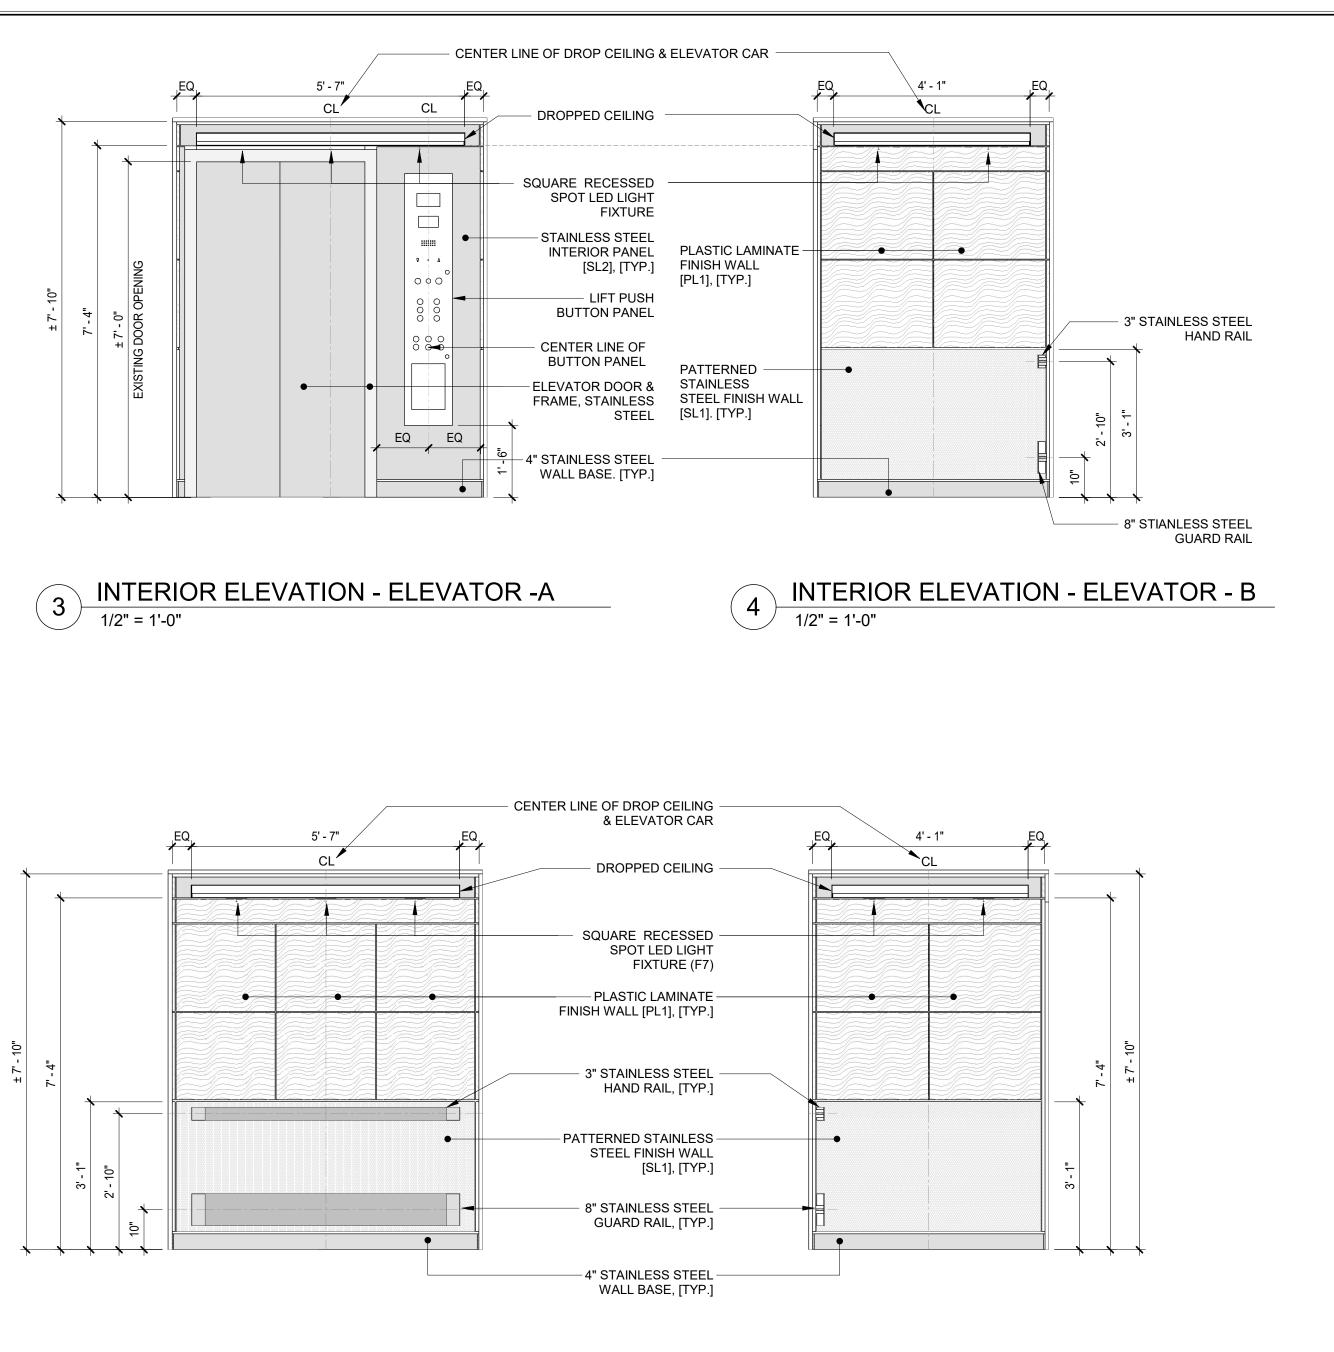




CONSULTANT SEAL		CONSULTANT	CONSULTANT INFORMATION Graf & Lewent Architects LLP 90-30 161st Street, Jamaica, NY 11432 P: 718-651-6200 F: 718-251-6989							
REVISION NUMBER	DATE	MADE BY	APP'D BY		RE	VISION	١			
		RE	CORD DF	AWIN	G CERTIFICATION					
	Γ - CHANGE Γ - NO CHAN	S AS NOTED IGES								
	CONTR	RACTOR			CONTRACTOR					
NAME:					NAME:					
SIGNATURE:										
DEP		STCHESTER OF PUBLIC			ORK INSPORTATION		CONTRACT NUMBER 20-502		SHEET NUMBER	
	C	DIVISION	OF ENGIN	IEERII	NG		SHEET NO.	42	OF 133	
LOW RISE BUILDING RENOVATIONS AND HVAC IMPROV 110 DR. MARTIN LUTHER KING, JR. BOULE WHITE PLAINS, NEW YORK							SCALE: DATE: 01-19-2024	1	1/2" = 1' Issue Da	ate
ELEVATOR CAB PALNS & ELEVATIONS - 143 GRAND STREET							DPW FILE NO. 52-2	11-A	-1854-0	

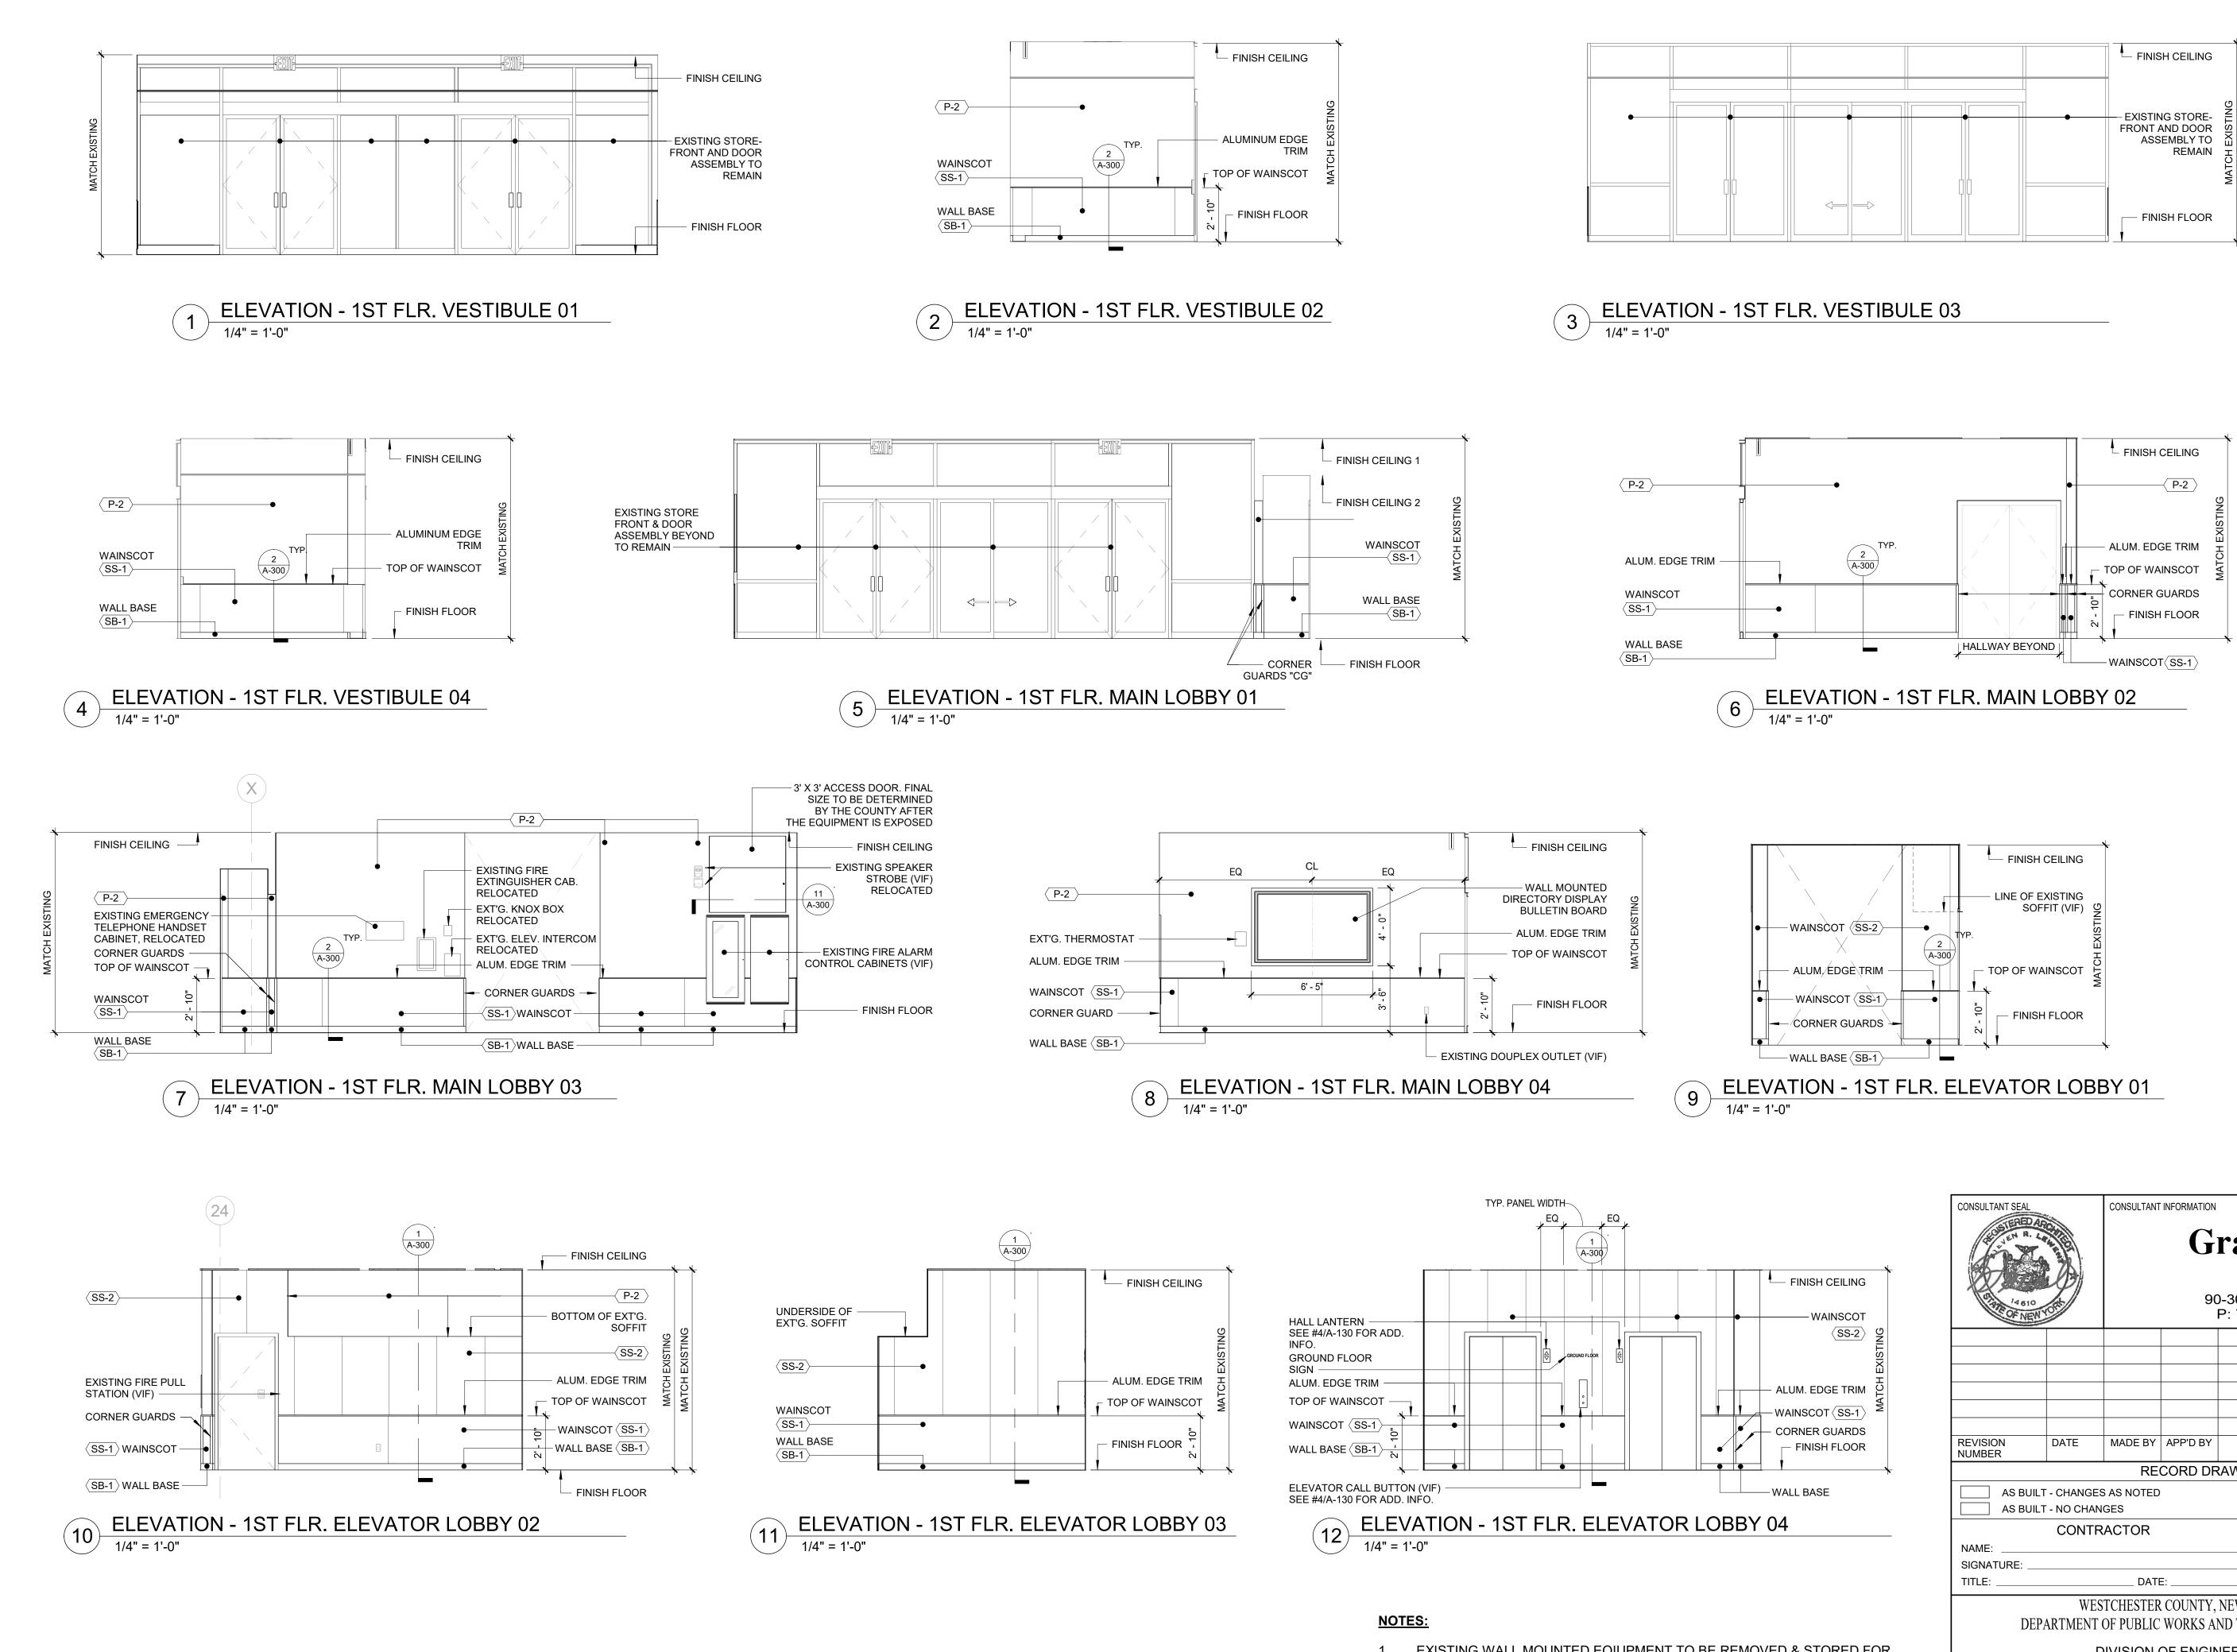


1. EXISTING WALL MOUNTED EQIUPMENT TO BE REMOVED REINSTALLATION, INSTALL AFTER WALL FINISH DONE

2. SEE A-304 FOR FINISH SCHEDULE.

	CONSULTANT SEAL	CONSULTANT INFORMATION							
- FINISH CEILING	REGISTERED ARC	Graf & Lewent Architects LLP 90-30 161st Street, Jamaica, NY 11432							
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	LOW RISE BUILDING			NS AND HVAC THER KING, JF		OVEMENTS - PHASE II LEVARD	SCALE:	1/4" = 1'-0"	
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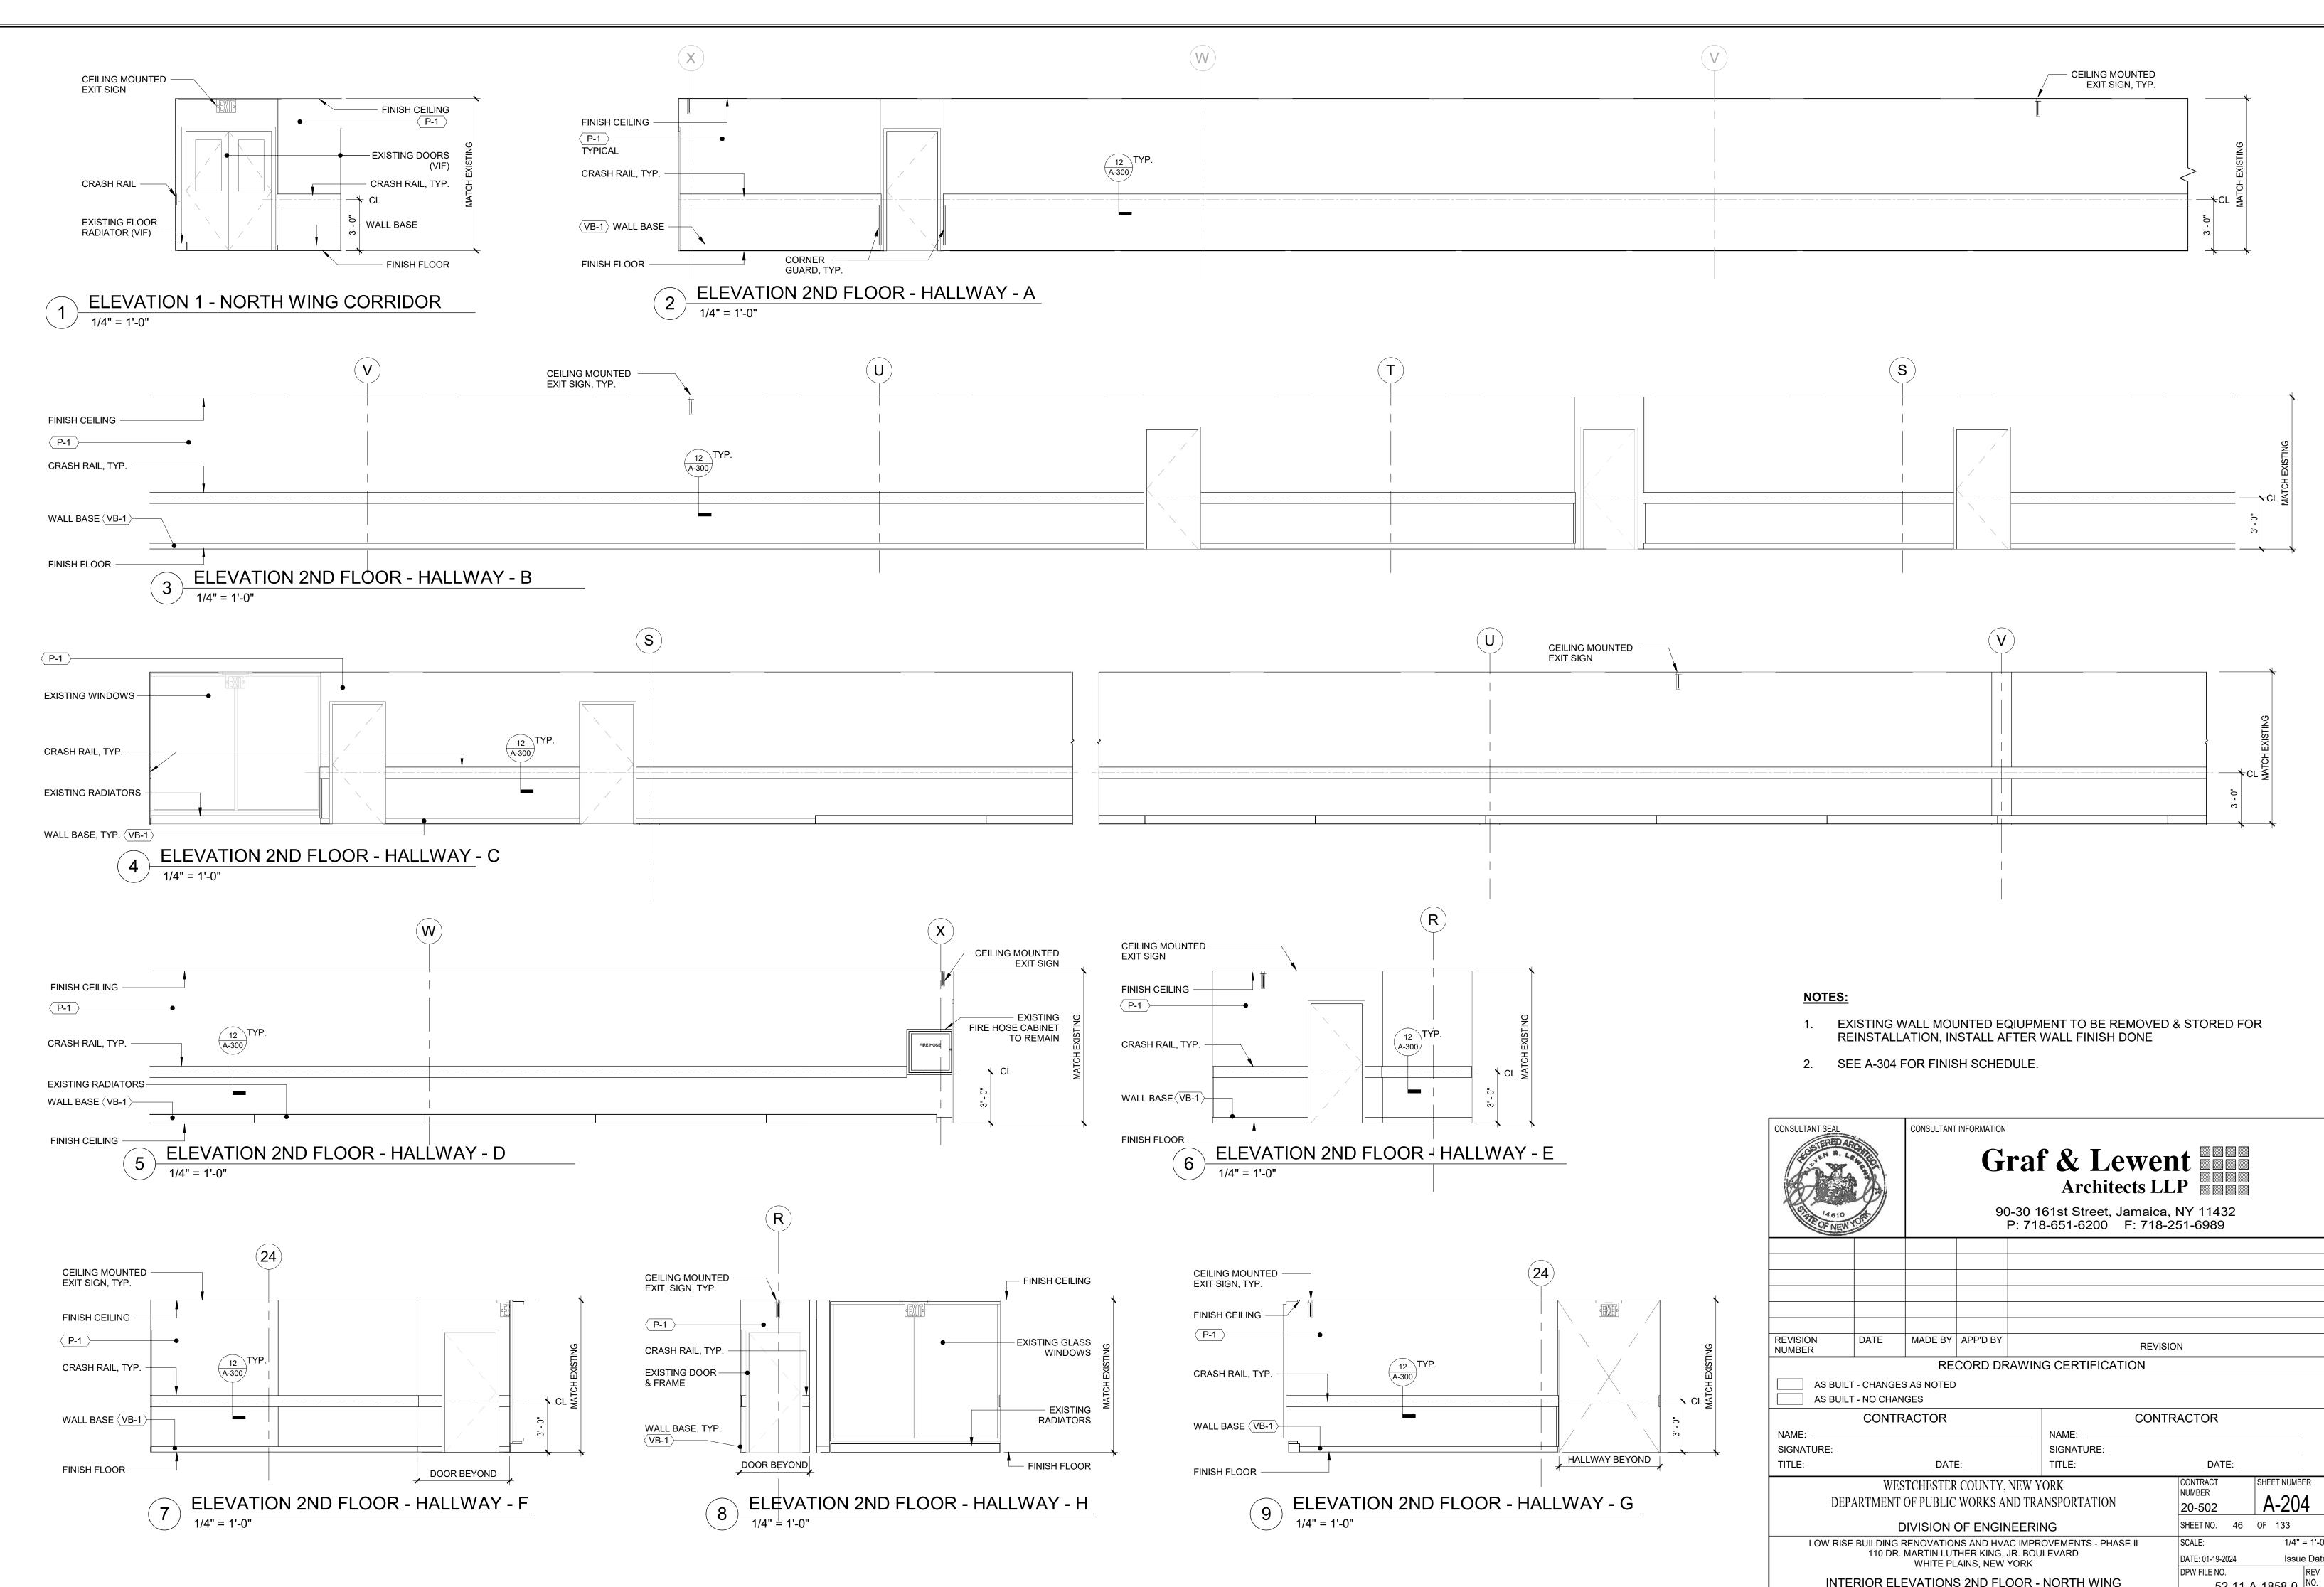


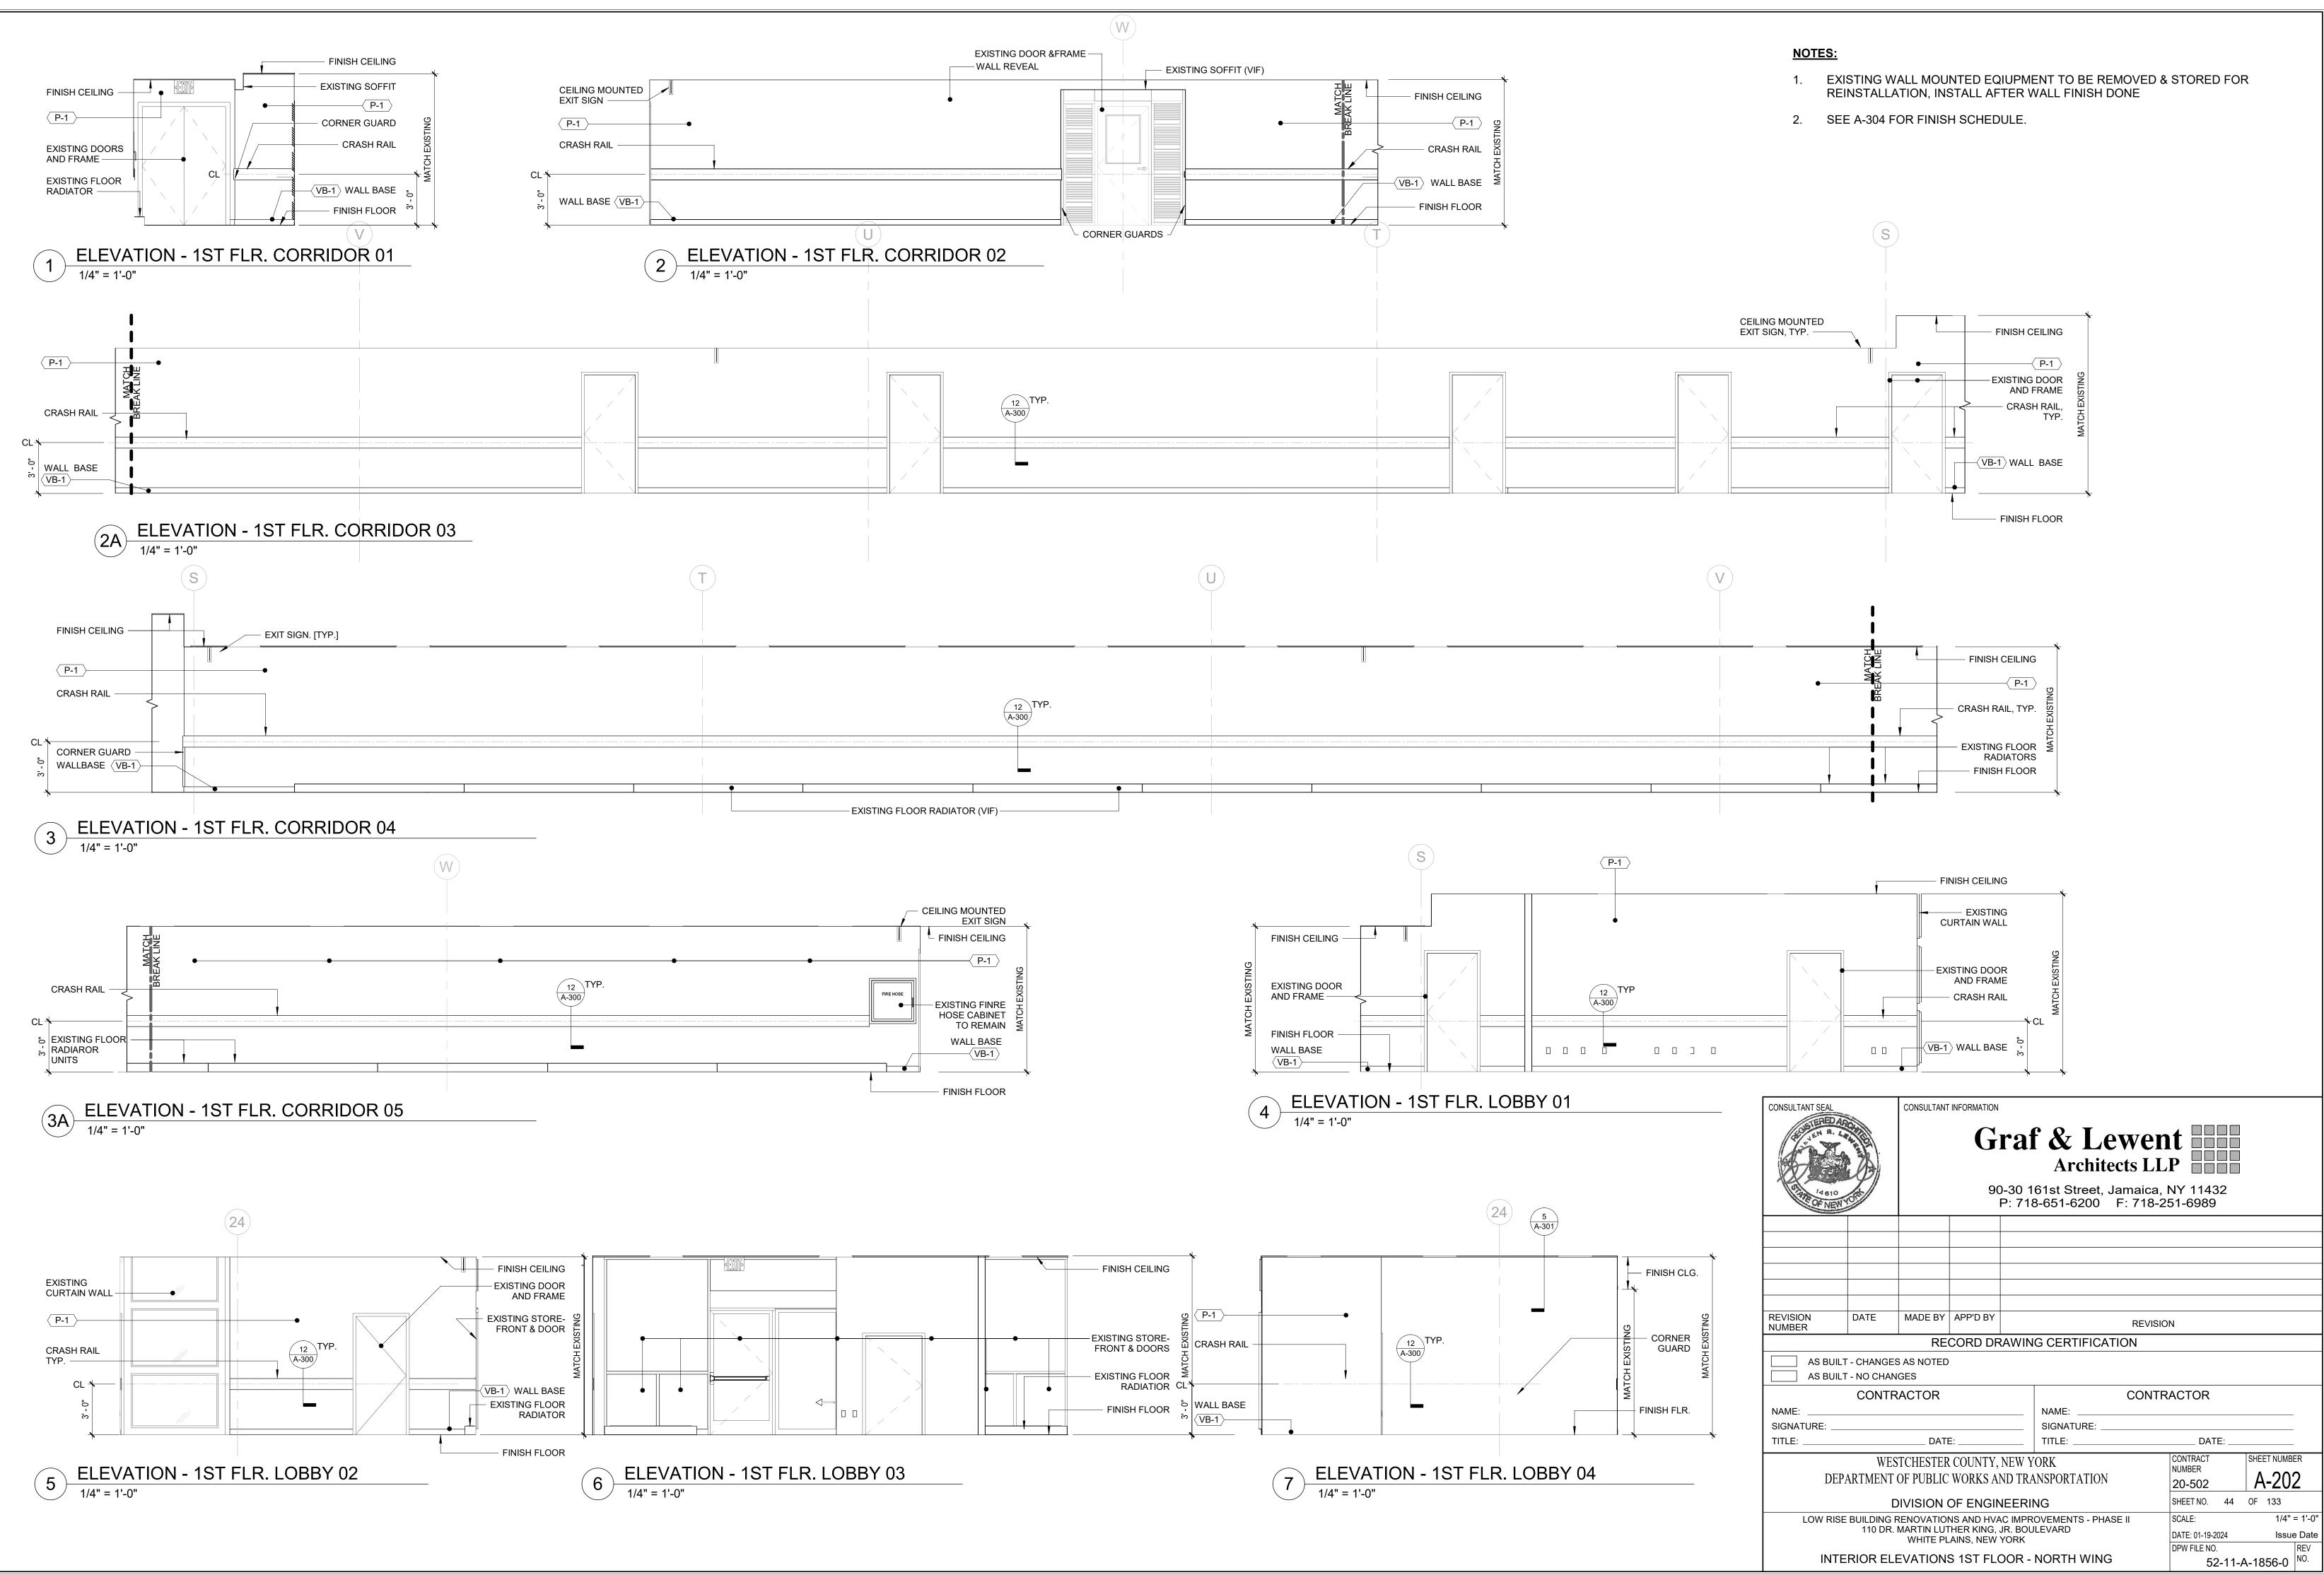

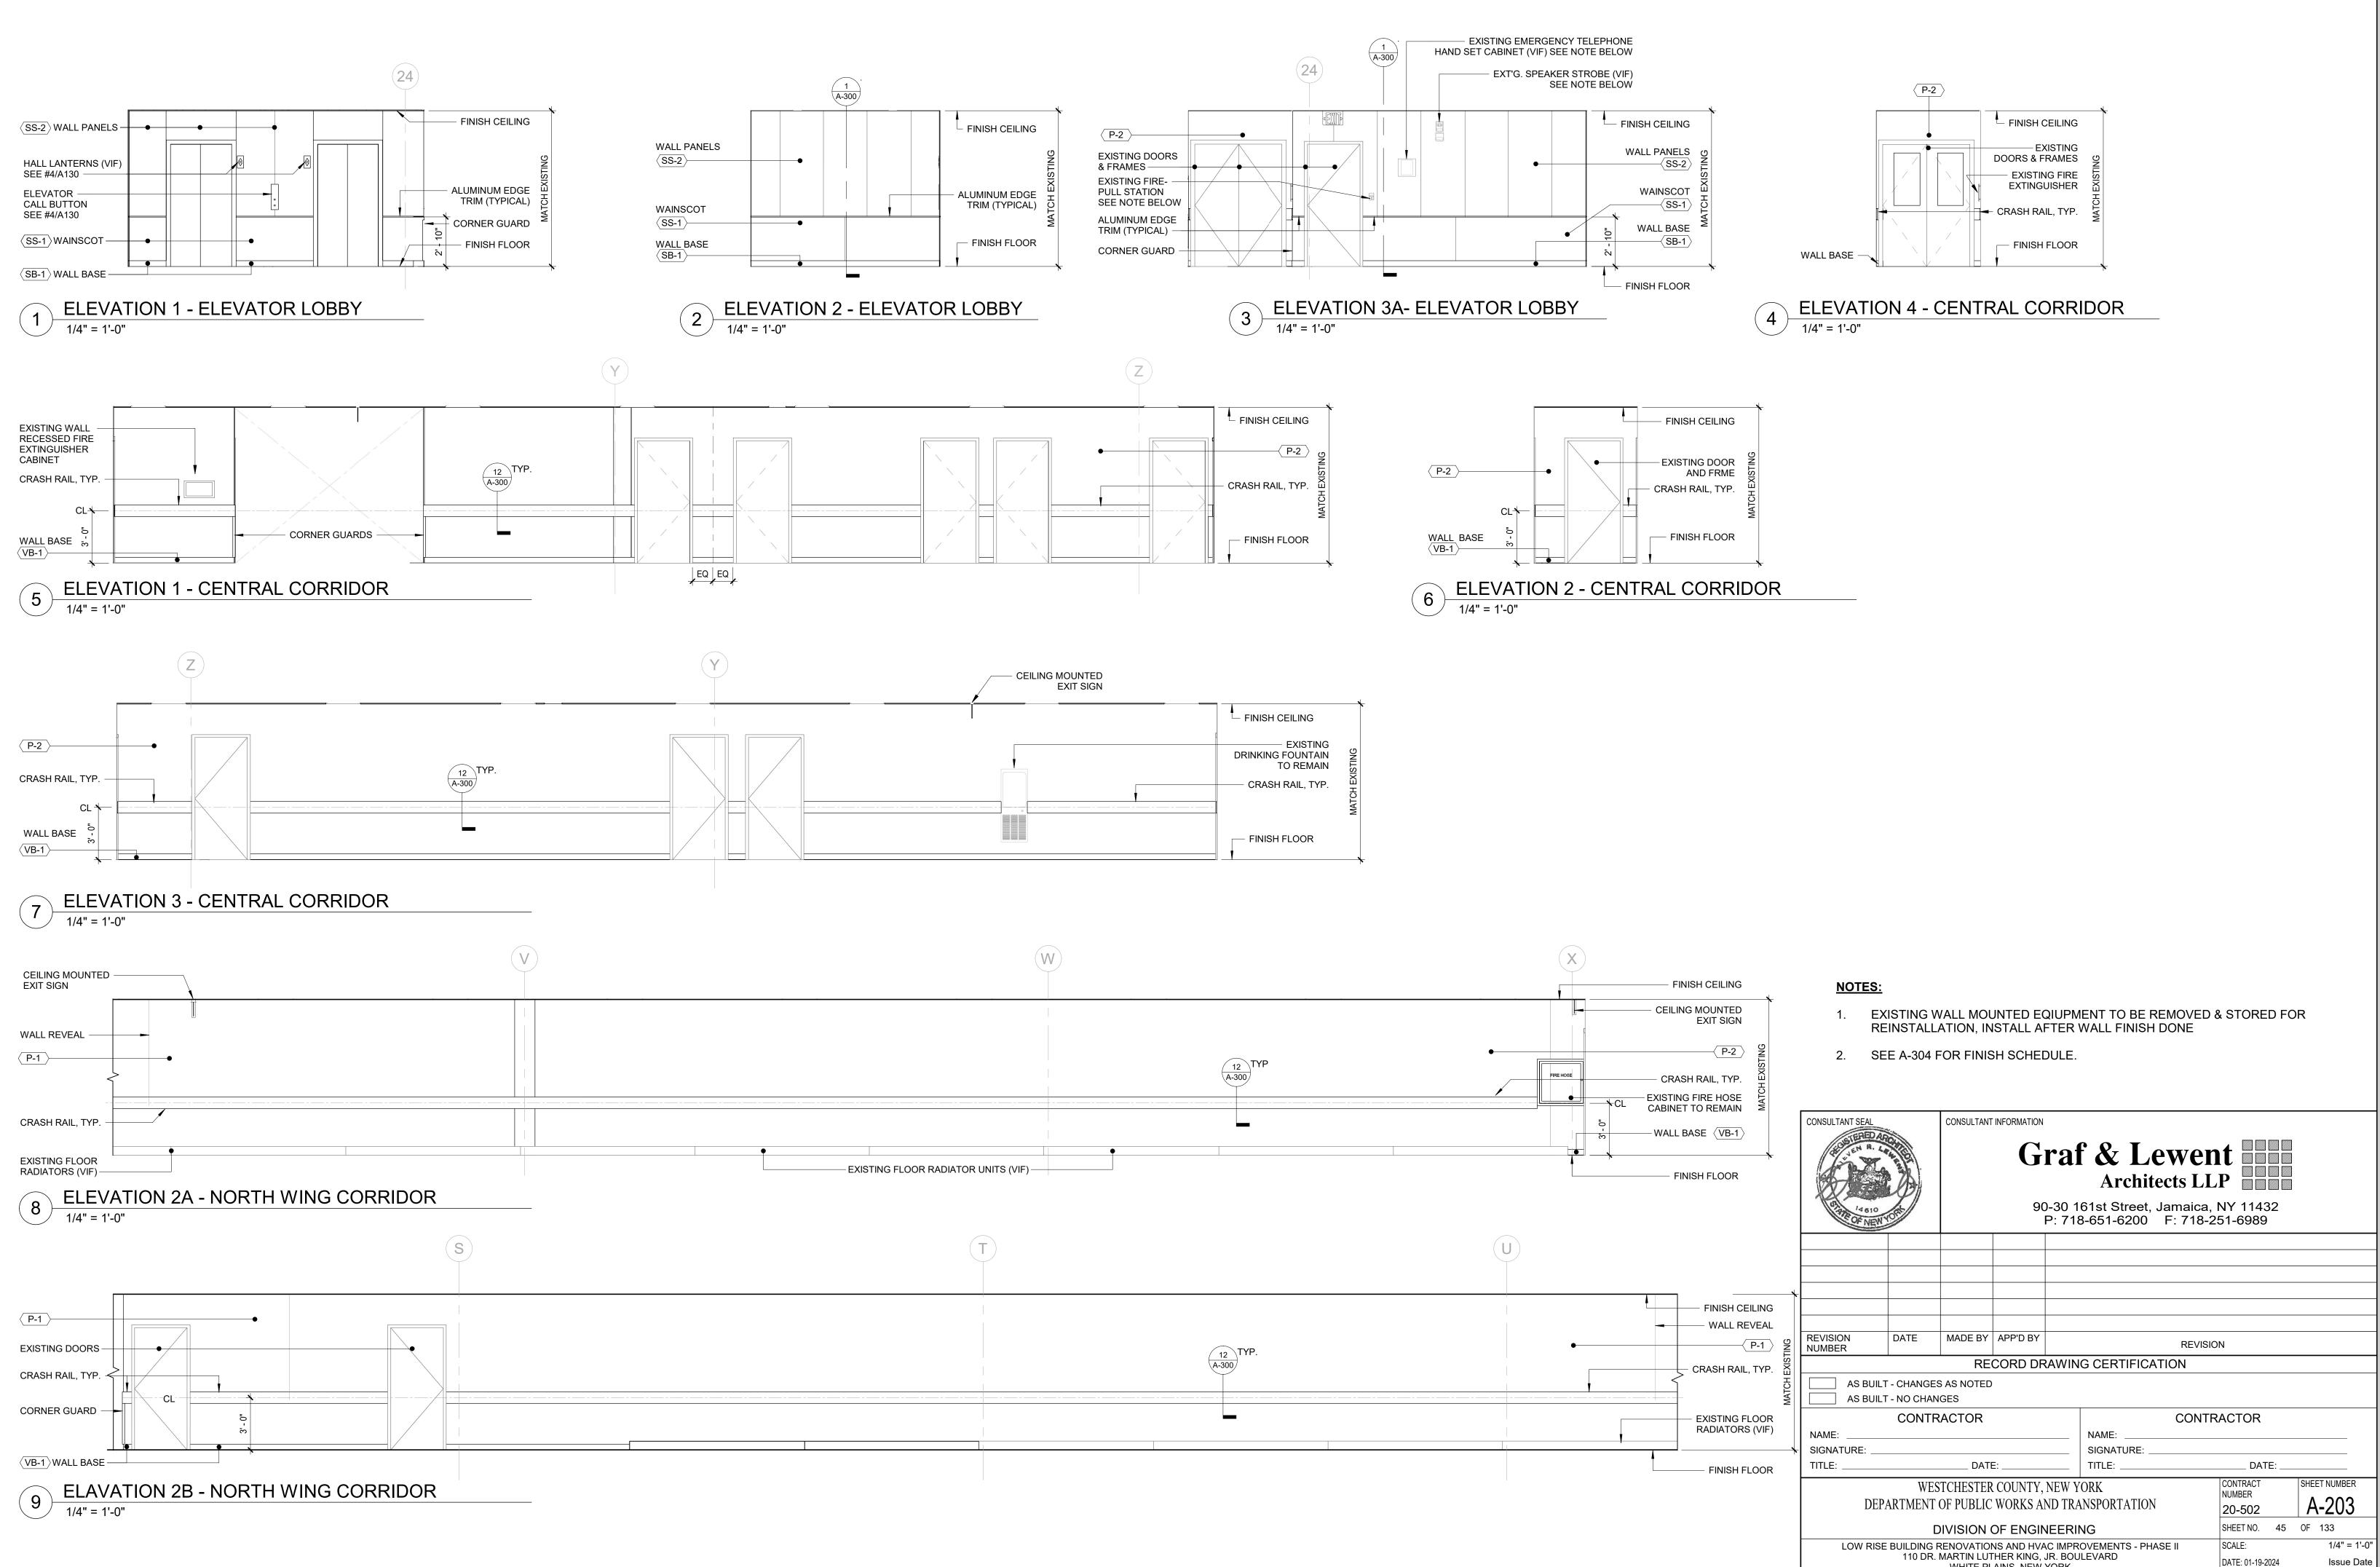DEPARTMENT OF PUBLIC WORKS AND TRANSPORTATION
DIVISION OF ENGINEERING
LOW RISE BUILDING RENOVATIONS AND HVAC IMPROVEMENTS - PHASE 110 DR. MARTIN LUTHER KING, JR. BOULEVARD WHITE PLAINS, NEW YORK
INTERIOR ELEVATIONS 2ND FLOOR - CENTRAL WING


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52-11-A-1857-0 NO.




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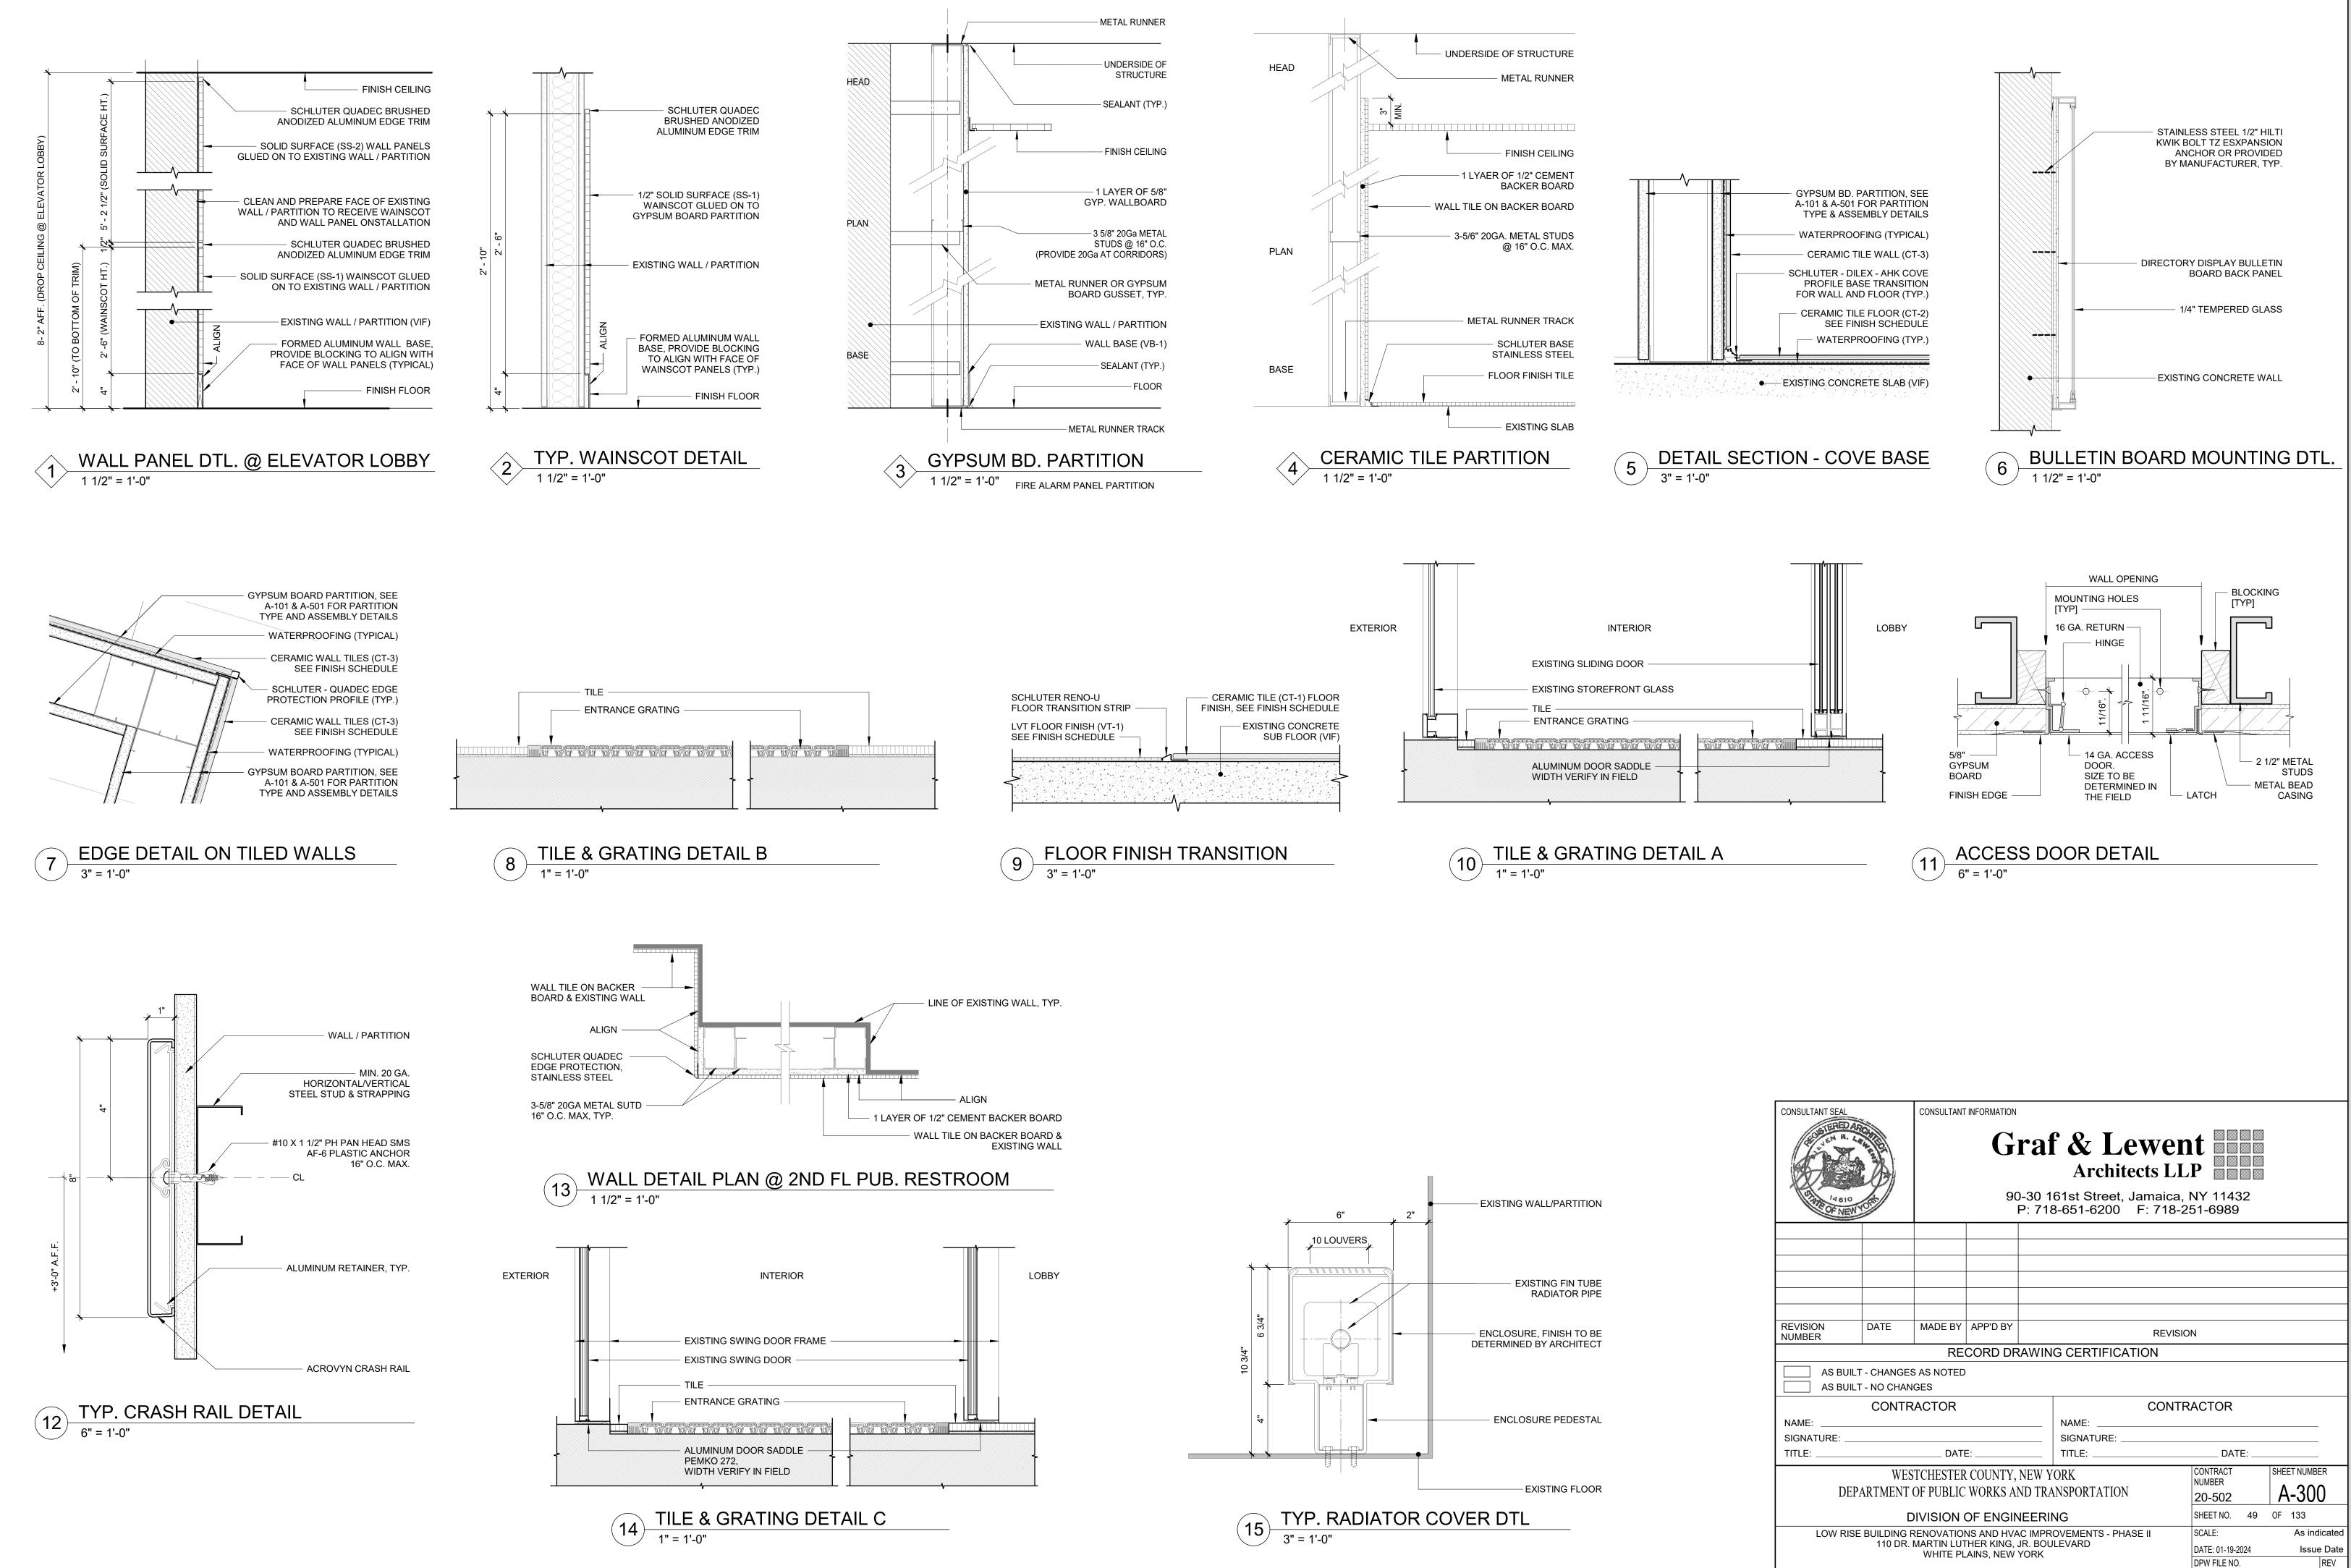
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	DIVISION OF ENGINEERIN	NG	SHEET NO. 46	OF 133	
LOV	W RISE BUILDING RENOVATIONS AND HVAC IMPRO 110 DR. MARTIN LUTHER KING, JR. BOU WHITE PLAINS, NEW YORK	SCALE: DATE: 01-19-2024 DPW FILE NO.	1/4" = Issue	-	
	INTERIOR ELEVATIONS 2ND FLOOR -	NORTH WING	52-11-A		NO.




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	STATE OF NEW					61st Street, Jamaica, 3-651-6200 F: 718-2	NY 11432		
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IEDOLE.	LOW RISE		MARTIN LUT		JR. BOU	OVEMENTS - PHASE II LEVARD	SCALE: DATE: 01-19-2024 DPW FILE NO.	Issue	= 1'-0" e Date REV
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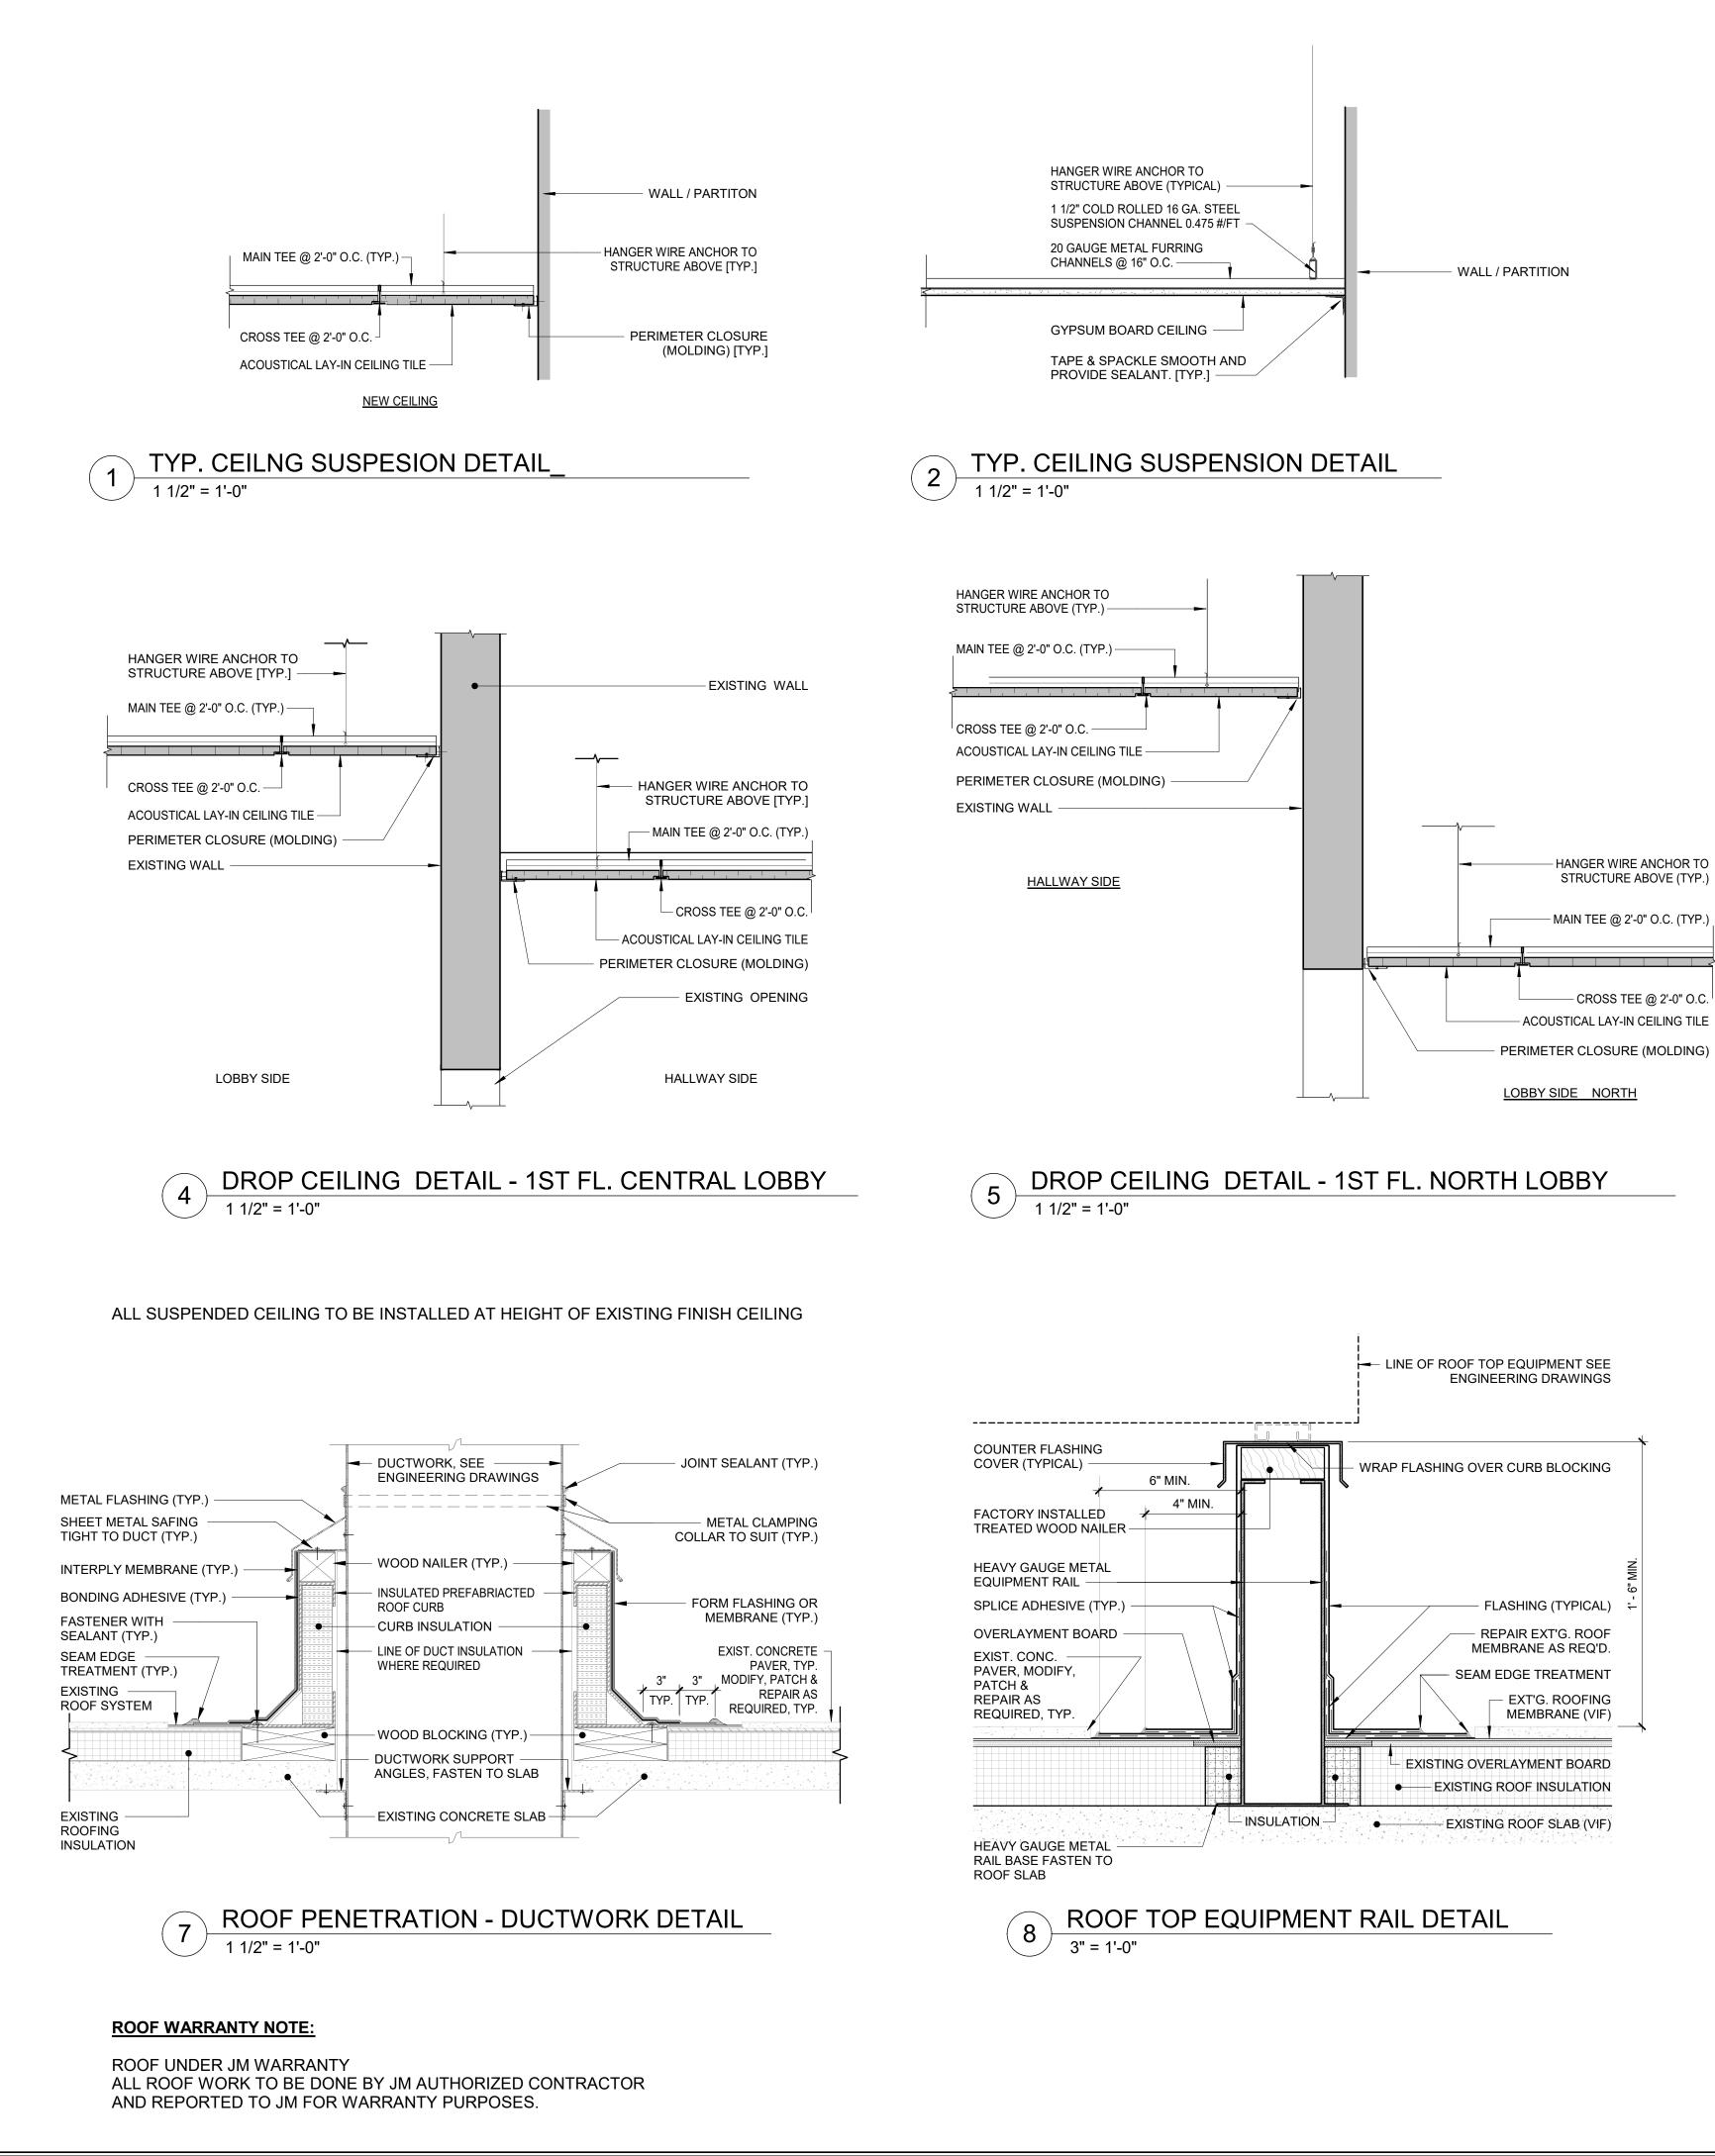
INTERIOR ELEVATIONS 2ND FLOOR - RESTROOMS

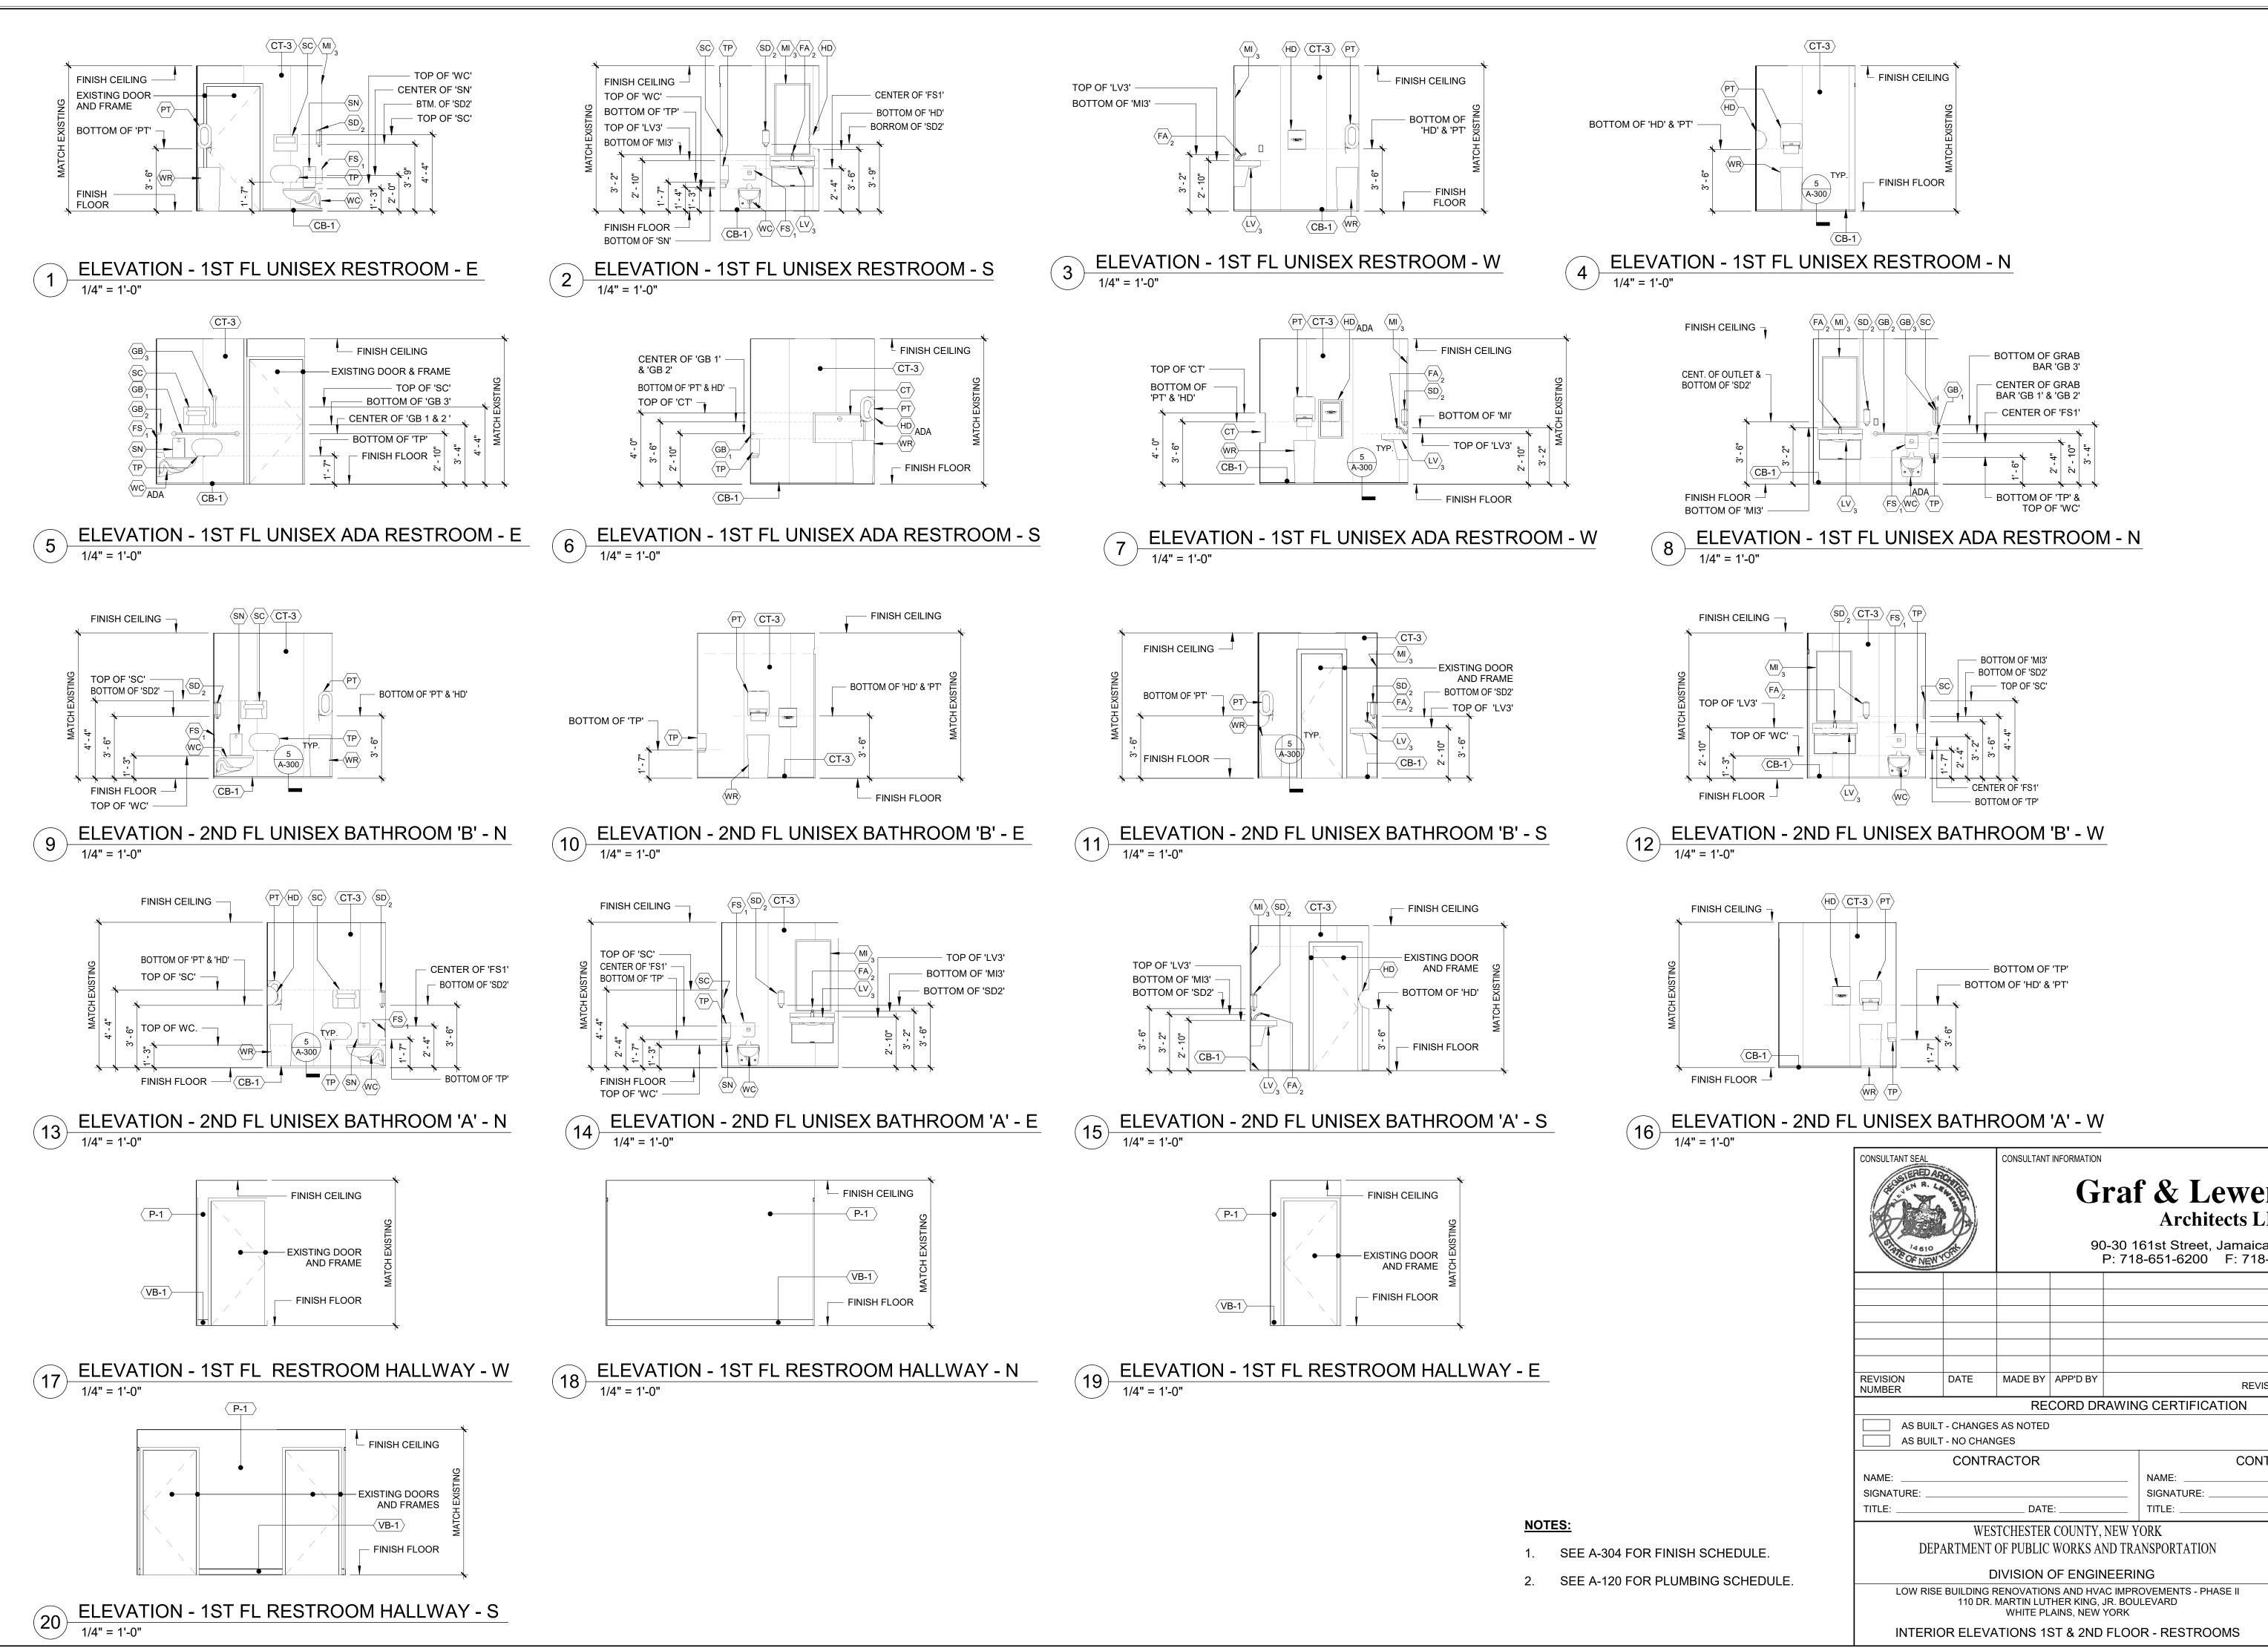

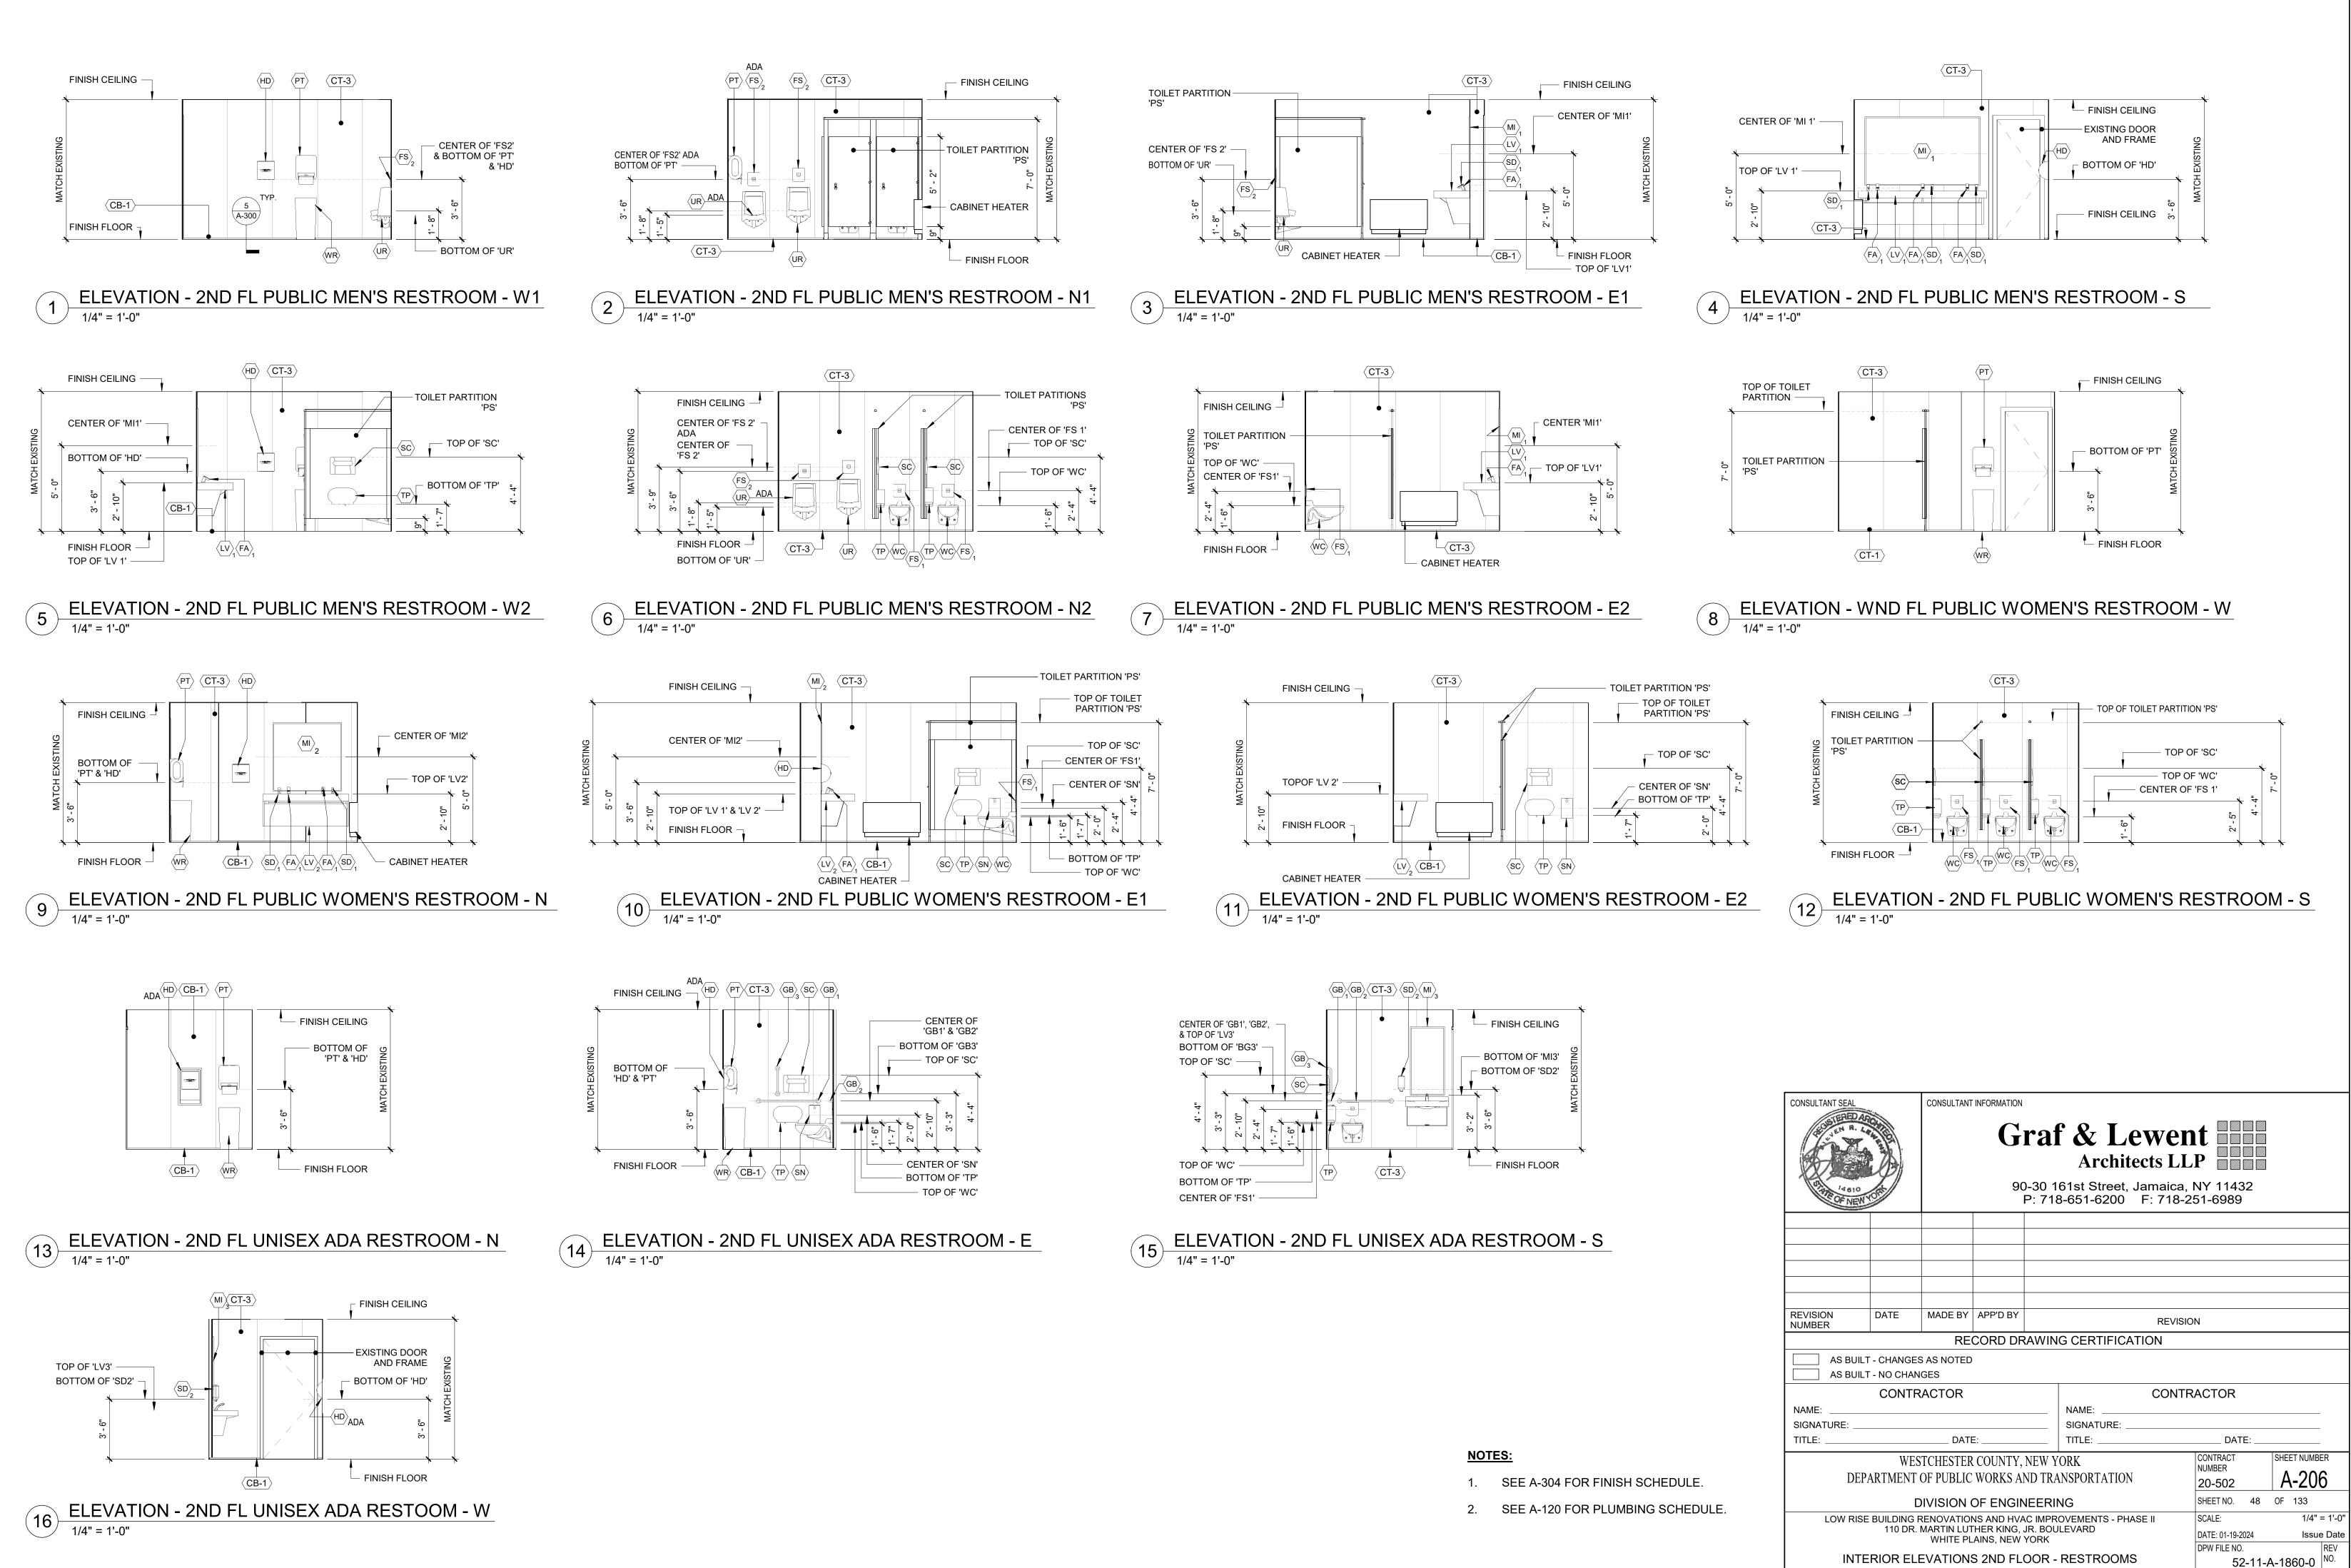


DETAILS

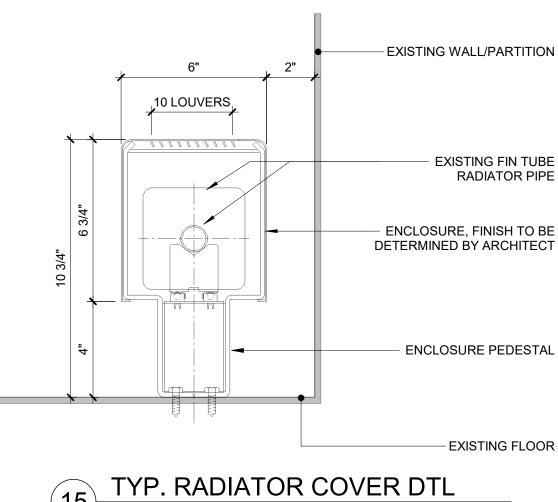52-11-A-1861-0 NO.



- GYPSUM BOARD WALL/ PARTITION SEE A-501 FOR ASSEMBLY DETAILS LINEAR DIFFUSER BOX PLENUM SEE ENGINEERING DRAWINGS - HANGER WIRE ANCHOR TO STRUCTURE ABOVE (TYPICAL) 1 1/2" COLD ROLLED 16 GA. STEEL SUSPENSION CHANNEL 0.475 #/FT ------ 20 GAUGE METAL FURRING CHANNELS @ 16" O.C. - GYPSUM BOARD CEILING PANEL - LINEAR AIR DIFFUSER, SEE ENGR. DRAWINGS -WOOD BLOCKING AS REQUIRED - TAPE AND SPACKLE SMOOTH LINE OF SOLID SURFACE PANEL (SS-2) WHERE REQUIRED 6 AIR DIFFUSER @ DROP CEILING 1 1/2" = 1'-0"

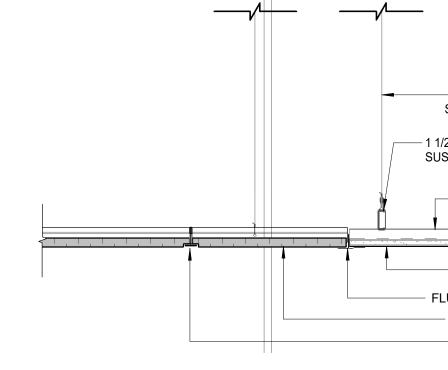



- HANGER WIRE ANCHOR TO STRUCTURE ABOVE (TYPICAL)


- 1 1/2" COLD ROLLED 16 GA. STEEL SUSPENSION CHANNEL 0.475 #/FT


> - 20 GAUGE METAL FURRING CHANNELS @ 16" O.C.

GYPSUM BOARD CEILING FLUSH TRANSITION MOLDING ACOUSTICAL TILE CEILING - CROSS TEE @ 24" O.C.

ACOUSTICAL TILE / GYP. BD. CEILNG DETAIL 1 1/2" = 1'-0"

CONSULTANT SEAL		CONSULTANT	90)-30 1	f & Lewe Architects I 61st Street, Jamaio 3-651-6200 F: 71	LLP		
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DIVISION OF ENGINEERING SHEET NO. 50 OF 133						OF 133		
LOW RISE					OVEMENTS - PHASE II	SCALE:	As indicated	
	110 DR. 1		HER KING, AINS, NEW		LEVAKU	DATE: 01-19-2024	Issue Date	
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	LOW RISE					OVEMENTS - PHASE II	SCALE:	1 1/2" = 1'-0"			
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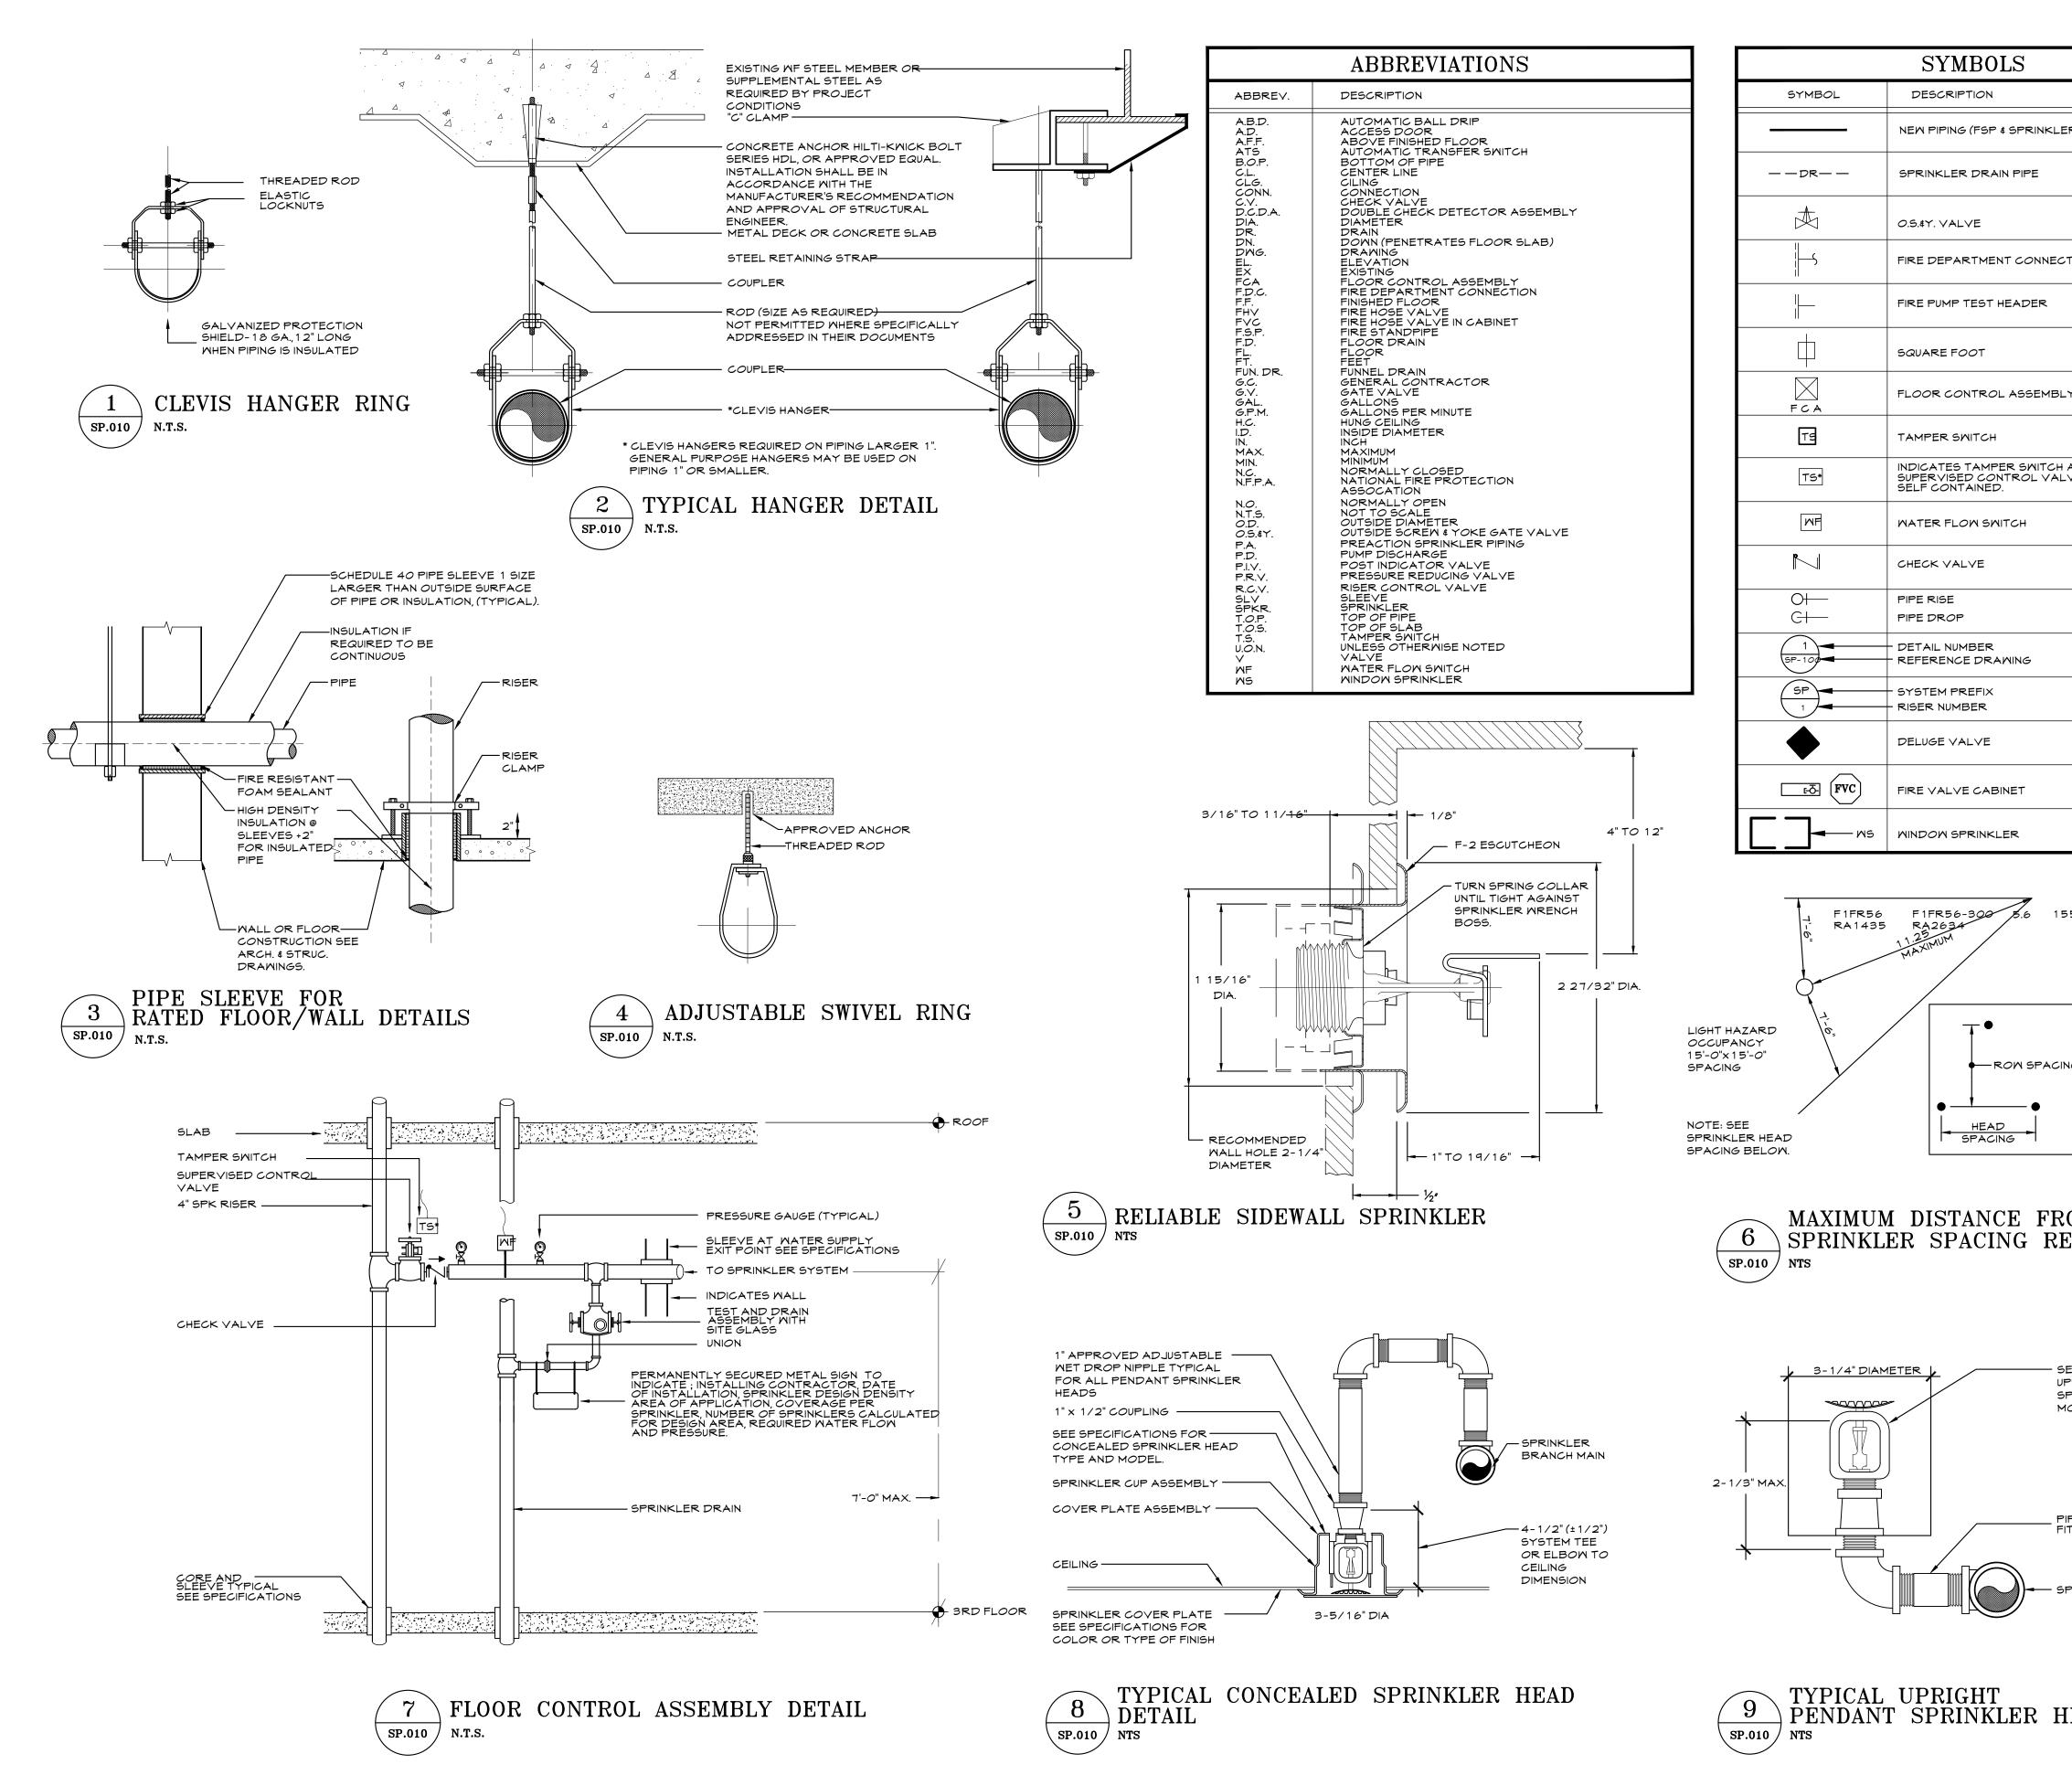
	LIGHT FIXTURE SCHEDULE									
TYPE	SYMBOL	DESCRIPTION	MANFR / SERIES	MODEL NO.	LAMPS	NOTES/ACCESSORIES				
F1 F1A		2' X 2' LED RECESSED TROFFER	EATON CORELITE BRIDGE	BRG-WS-4-L35-LD2-UNV-22-T1-STD	LED ENGINE PROVIDING APPROX. 3600 LUMENS AT 33.8W INCLUDED.	SEE ENGINEERING CIRCUITING FOR SWITCHING AND DIMMING DESIGN. PROVIDE GYPSUM BOARD RECESSED FLANGE FOR F1A FIXTURE.				
F2		6" SQUARE RECESSED WIDE BEAM LED DOWNLIGHT	COOPER PORTFOLIO LDSQ6B SERIES	LDSQ6B-30-DE010- EU6B-3050-90—35-6LB-SQ-0-LI	INCLUDED LED WITH 3000 LUMEN OUTPUT AT 27.6W.	SEE ENGINEERING CIRCUITING FOR SWITCHING AND DIMMING DESIGN.				
F3		6" X 4' LED RECESSED	ATLANTIC LIGHTING ZOOM	ZR-66SC-D-WA-LED1650-35K-4-FR- WH	LED 1650 LUMENS AT 13W	PROVIDE WIDE FLANGE TO FILL EXISTING OPENING				
ES-1	•	CEILING RECESSED MOUNTED EDGE LIT EXIT SIGN WITH EMERG. POWER	ATLITE MARATHON SERIES	TS-C-1/2*-8-RW-SA-**	INCLUDED LED	* SIDES AS SHOWN ON DRAWINGS ** ARROWS AS SHOWN ON DRAWINGS				

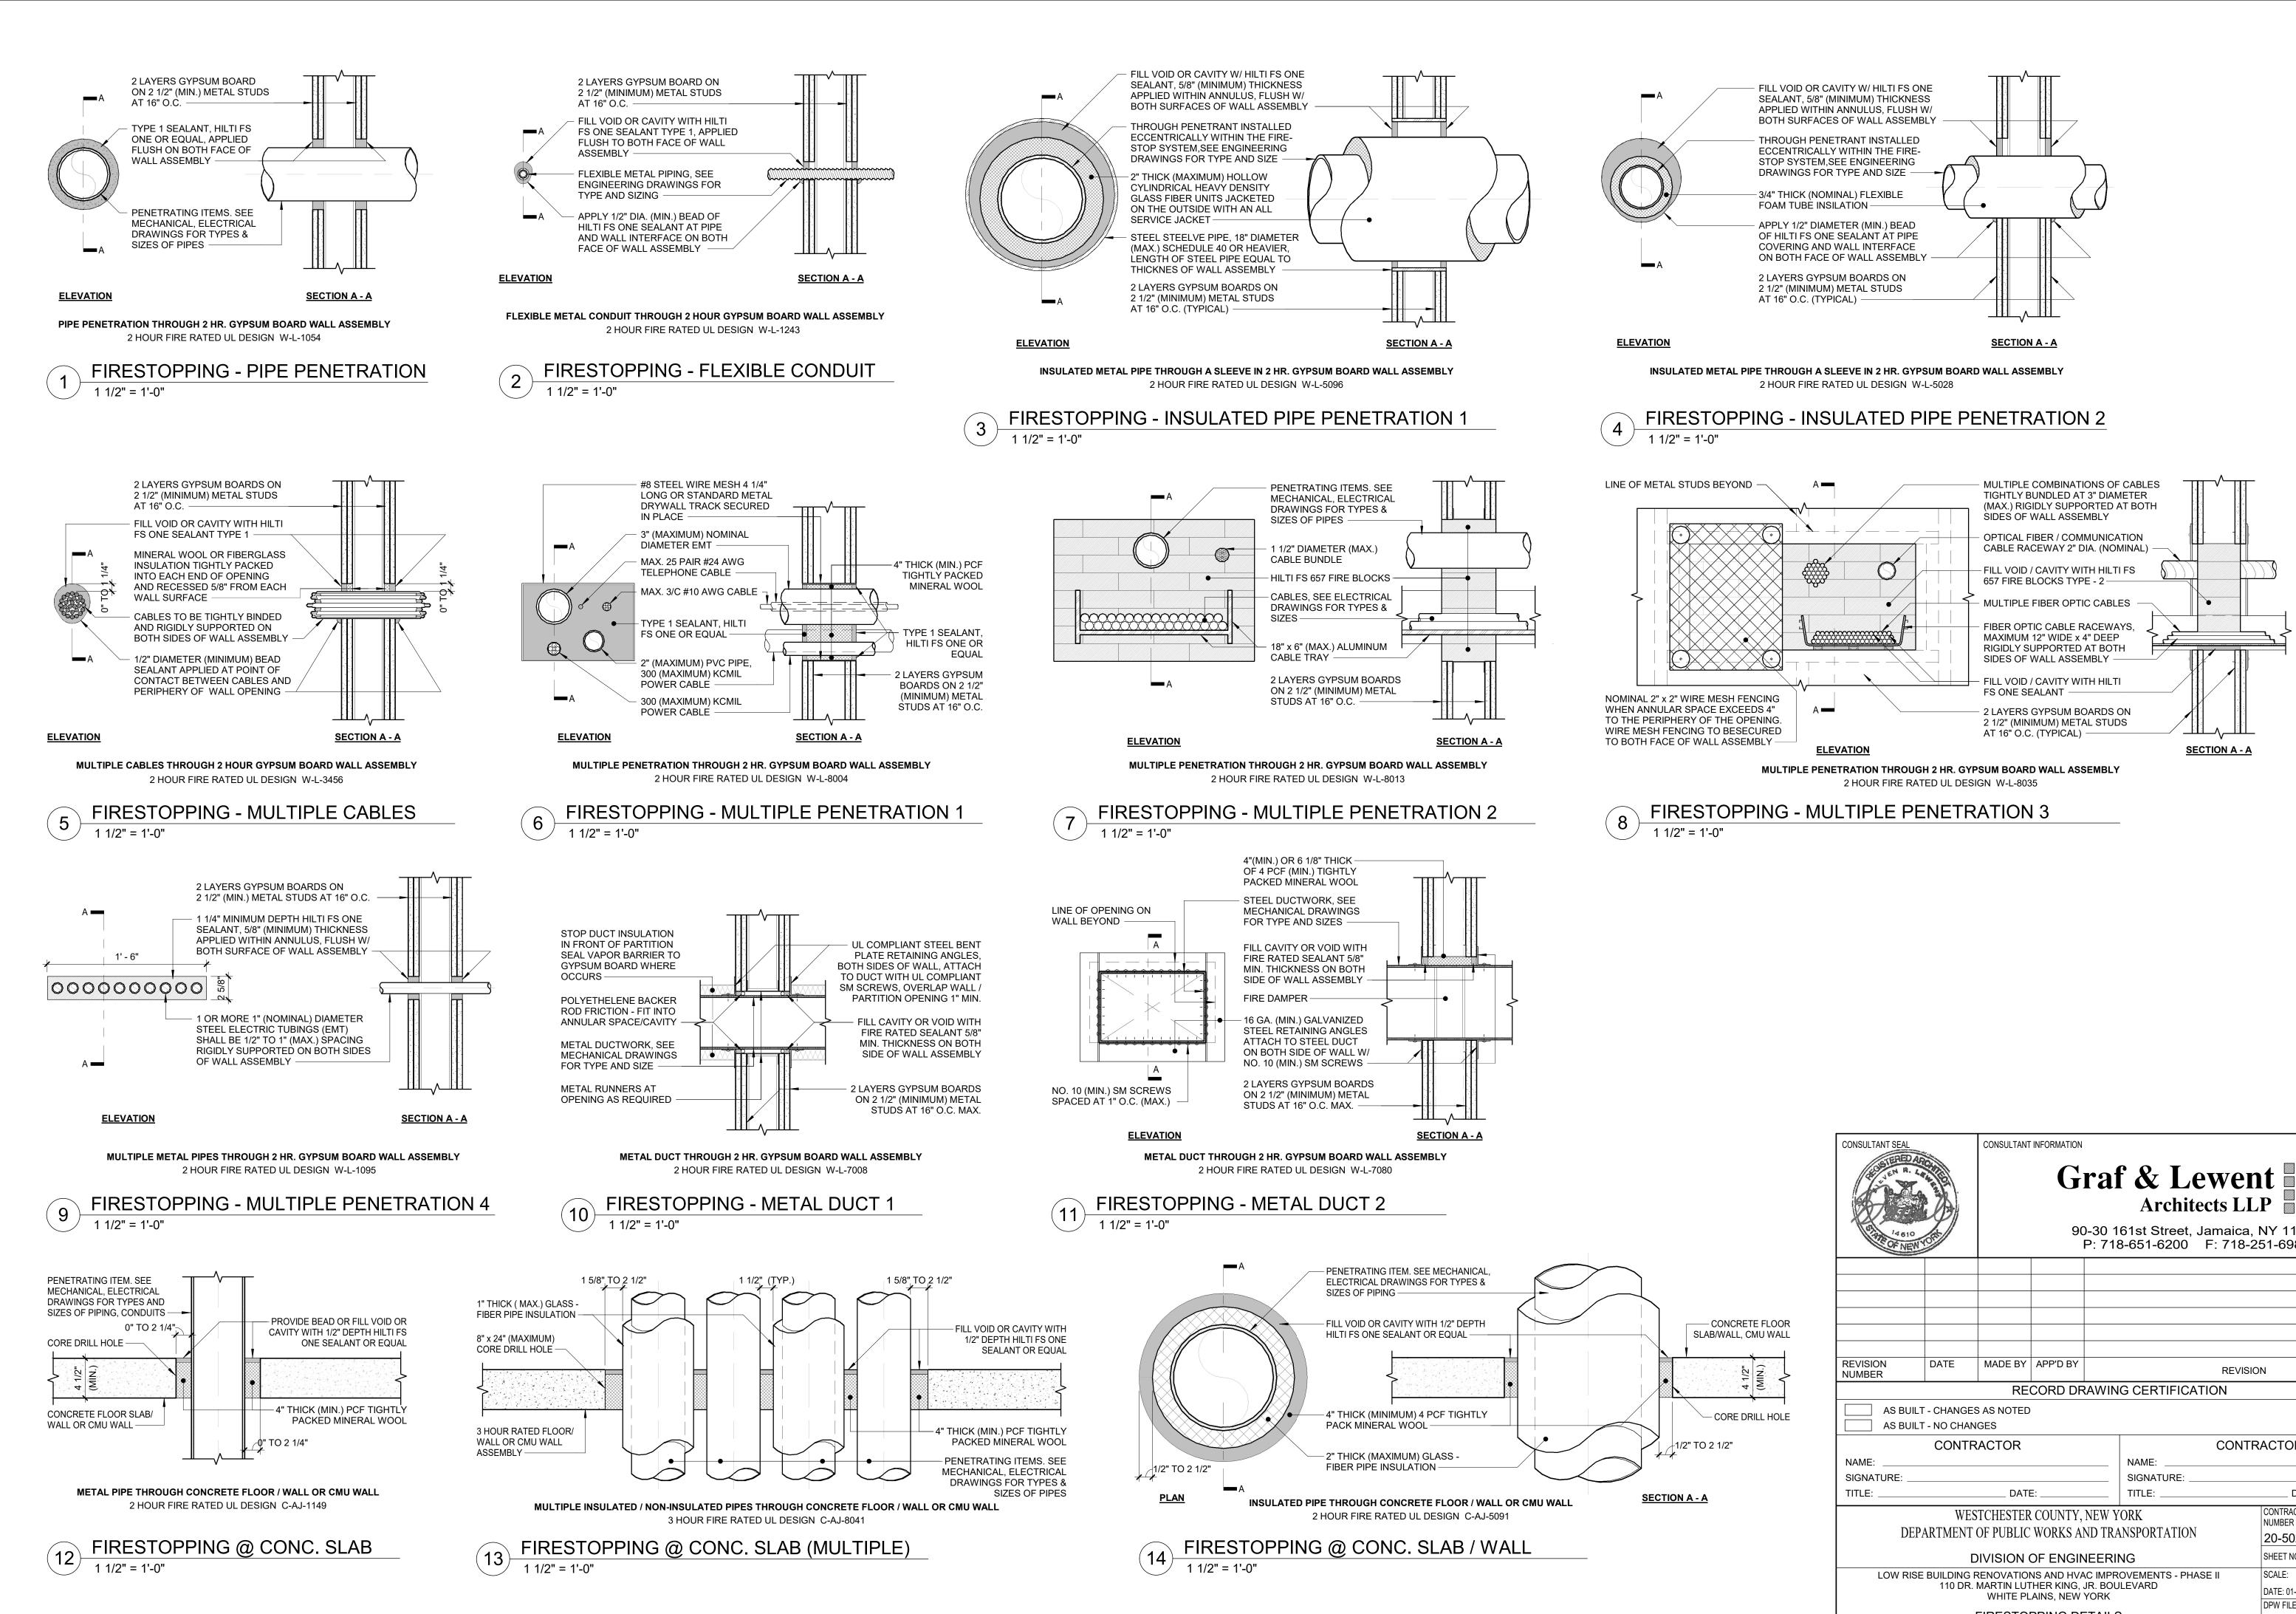NOTES:

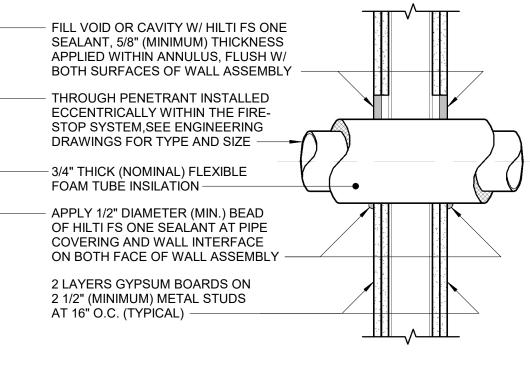ALL LED LAMPS TO BE 4000K, 80 MIN CRI, UNLESS NOTED OTHERWISE
 WHERE "EM" IS SHOWN ON ELECTRICAL ENGINEERING DRAWINGS, PROVIDE THE SPECIFIED FIXTURE WITH A BUILT-IN OR REMOTE EMERGENCY BATTERY PACK.
 PROVIDE ALL REQUIRED MOUNTING ACCESSORIES FOR LOCATIONS SHOWN.

		SCHED	ULE OF FINISHES			
FINISH DESIGNATION	DESCRIPTION	MANUFACTURER	COLOR / MODEL NO.	NOTES		
P-1	PAINT	BENJAMIN MOORE	OC - 149 DECORATOR WHITE	TYPICAL WALL PAINT COLOR WHERE NO OTHER COLOR IS INDICATED		
P-2	PAINT	BENJAMIN MOORE	2133 - 60 SIDEWALK GRAY	LIGHT GRAY - PUBLIC SPACES		
(SS-1)	SOLID SURFACE	KRION TERRAZZO SRIES	GRIGIO CLASSICO T904	WAINSCOT AND BACK WALLS SHEETS 1/2" x 30" x 145"		
\langle SS-2 \rangle	SOLID SURFACE	KRION ROYAL +	ROYAL LUX CRYSTAL WHITE 8101	UPPER WALLS SHEETS 1/2" X 30" X 145"		
SS-3	SOLID SURFACE	CORIAN	EVEREST	WHITE MATRIX -FOR SLOAN LAVATORIES		
VT-1	RESILIENT FLOOR TILES	TARKETT MESHWORK	WOODSMOKE	12" X 36" VINYL TILE PRE-PURCHASED VT-1, ABOUT 1,300 SQ.FT. TO BE PROVIDE BY THE COUNTY. CONTRACTOR VERIFY AND PROVIDE REST OF REQUIRED TILES.		
CT-1	CERAMIC TILE	DALTILE ASTRONOMY	NEBULA AT73	LOBBY FLOOR, 18" x 18" TILE OUTDOOR GRADE SLIP RESISTANCE		
CT-2	CERAMIC TILE	DALTILE REMINISCENT	RECLAIMED GRAY RM 23	RESTROOM FLOORS, 12" x 24" TILE OUTDOOR GRADE SLIP RESISTANCE		
CT-3	CERAMIC TILE	DALTILE FLORENTINE	CARRARA FL06	RESTROOM WALLS, 24" X 24" TILE		
C-1	CARPET	TARKETT 1138 OFFSET	SCREEN TINT (DK GRAY) FLASHPOINT (LIGHT GRAY)	BLEND TWO GRAY COLORS IN PATTERN MODULAR 18" x 36"		
$\langle VB-1 \rangle$	VINYL BASE	JOHNSONITE	TBD			
SB-1	METAL BASE			4"H FORMED ALUMINUM WITH POWDER COATED FINISH TO MATCH STOREFRONT GF-1		
(CB-1)	COVE BASE	SCHLUTER SYSTEMS	SCHLUTER-DILEX-AHK			

90-3					f & Lewe Architects L 61st Street, Jamaica 3-651-6200 F: 718	, LP	
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CONTRACTOR NAME:					NAME: SIGNATURE:		
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	BUILDING F 110 DR. I	RENOVATIO MARTIN LUT WHITE PL	HER KING, AINS, NEW	OVEMENTS - PHASE II	SCALE: DATE: 01-19-2024 DPW FILE NO.	OF 133 1/8" = 1'-0" Issue Date A-1865-0 REV NO.	




THESE PLANS ARE APPROVED ONLY FOR THE WORK INDICATED ON THE APPLICATION SPECIFICATION SHEET. ALL OTHER MATTERS SH ARE NOT TO BE RELIED UPON OR TO BE CONSIDERED AS EITHER E APPROVED OR IN ACCORDANCE WITH APPLICABLE CODES.

				IG-ISSUE I		NSE R
					2022.08.31 100% SUBMISSION	2023.02.15 RESPONSE TO WESCHESTER COMMENTS 2023.08.04 RESPONSE TO WESCHESTER COUNTY COMMENTS 2023.11.01 RESPONSE
Sheet # SP-010	1	et Title BOLS ABBREVI	ATIONS NOTES	SCHEDULES AND DETAIL		X X 2007
5P-030 5P-102 5P-103	.00 CON .00 SPR	IBINATION SPR		PPIPE RISER DIAGRAM ENTRAL WING		^ ^ X X X X X X
5P-104 5P-105	.00 SPR	INKLER PLAN -	2ND FLOOR C 2ND FLOOR N	ENTRAL WING	× × ×	x x x x x x
		S	PRINKL	ER HEAD S	SCHEDUI	LE
 бүмв <i>о</i>	L TYPE	STAND, PRESSL	ARD K	TEMPERATURE	NOMINAL ORIFICE SIZE	REMARKS
	CONCEAL	MODEL ED G4A		135°F COVERPLA 165°F SPRINKLER		UL LISTED - CATEGORY VNIV
	UPRIGHT	F1FR5	6 5.6	165°F SPRINKLER	1/2"	UL LISTED - CATEGORY VN
	PENDANT	F1FR				UL LISTED
	SIDEWALL	FIFK	5.6	155°F SPRINKLER	1/2"	- CATEGORY VN
	SPRI	NKLER	HEAD	SPACING	REQU	IREMENTS
		SPRINKLER S OOL FOR ARC		VIREMENTS BASED C	NN NFPA 13. THIS	5 TABLE SHALL BE
	PANCY HAZA	RD		JARE FOOT PER HEA	BE	XIMUM SPACING TWEEN SPRINKLERS
RELIG	OUS, INSTITU	FICE EDUCAT TIONAL, HOSP UBS, THEATER	ITALS, OBS	-200 SF PER HEAD STRUCTIONS AND FLO		FEET
REQUI	RED PRESSI	RE: 7 POUND	S PER SQUARE	EINCH MINIMUM MITH	A 5.6 K-FACTO	R.
EXTEN IN SOM COVEL INCRE DISTR	DED COVER 1E CIRCUMST RAGE. IN THE ASE THE SPA	ECEILING AND AGE SPRINKL ANCES, STAN SE CASES, EX ACING BETMEE	SHALL BE INS LER HEADS DARD DISTRIE (TENDED COV EN HEADS, EXT	ED, AND FLUSH SPR TALLED BASED ON BUTION SPRINKLER H ERAGE SPRINKLER H ENDED COVERAGE ET, SO THEY CAN BE	INKLERS MAY B THEIR LISTING. IEADS WILL NOT HEADS CAN BE I SPRINKLERS HA	T PROVIDE ENOUGH INSTALLED TO AVE A WATER
EXTEN IN SOM COVEL INCRE DISTR 20 FEI	DED COVER 1E CIRCUMST RAGE. IN THE ASE THE SPA BUTION RAD	ECEILING AND AGE SPRINKL ANCES, STAN SE CASES, EX ACING BETMEE	SHALL BE INS LER HEADS DARD DISTRIE (TENDED COV EN HEADS, EXT	TALLED BASED ON BUTION SPRINKLER H ERAGE SPRINKLER H ENDED COVERAGE ET, SO THEY CAN BE	INKLERS MAY B THEIR LISTING. HEADS WILL NOT HEADS CAN BE I SPRINKLERS HA SPACED APPRO	ROUNTED LESS
SPACING	DED COVER 1E CIRCUMST RAGE. IN THE ASE THE SPA BUTION RAD	CEILING AND RAGE SPRINKL CANCES, STAN SE CASES, EX ACING BETWEE DIUS OF LITTLE	SHALL BE INS ER HEADS DARD DISTRIE STENDED COVEN TO VER 10 FER COURT HOUSE QUARROPAS STR EY PLA	TALLED BASED ON BUTION SPRINKLER H ERAGE SPRINKLER H ENDED COVERAGE ET, SO THEY CAN BE	INKLERS MAY B THEIR LISTING. HEADS WILL NOT HEADS CAN BE I SPRINKLERS HA SPACED APPRO	BE MOUNTED LESS I PROVIDE ENOUGH INSTALLED TO AVE A WATER
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E	DIVISION OF ENGINEERING					NG	SHEET NO. 54	OF 133	
) P C REET	LOW RISE BUILDING RENOVATIONS AND HVAC IMPROVEMI 110 DR. MARTIN LUTHER KING, JR. BOULEVARD WHITE PLAINS, NEW YORK 10601 SYMBOLS, ABBREVIATIONS, NOTES AND SCH						SCALE: AS NOTED		
1 1 00							DATE: JAN 19, 2024		
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(1) COM FP.030 N.T.S.

COMBINATION SPRINKLER/STANDPIPE RISER DIAGRAM N.T.S.

THESE PLANS ARE APPI THE APPLICATION SPEC ARE NOT TO BE RELIED APPROVED OR IN ACCO

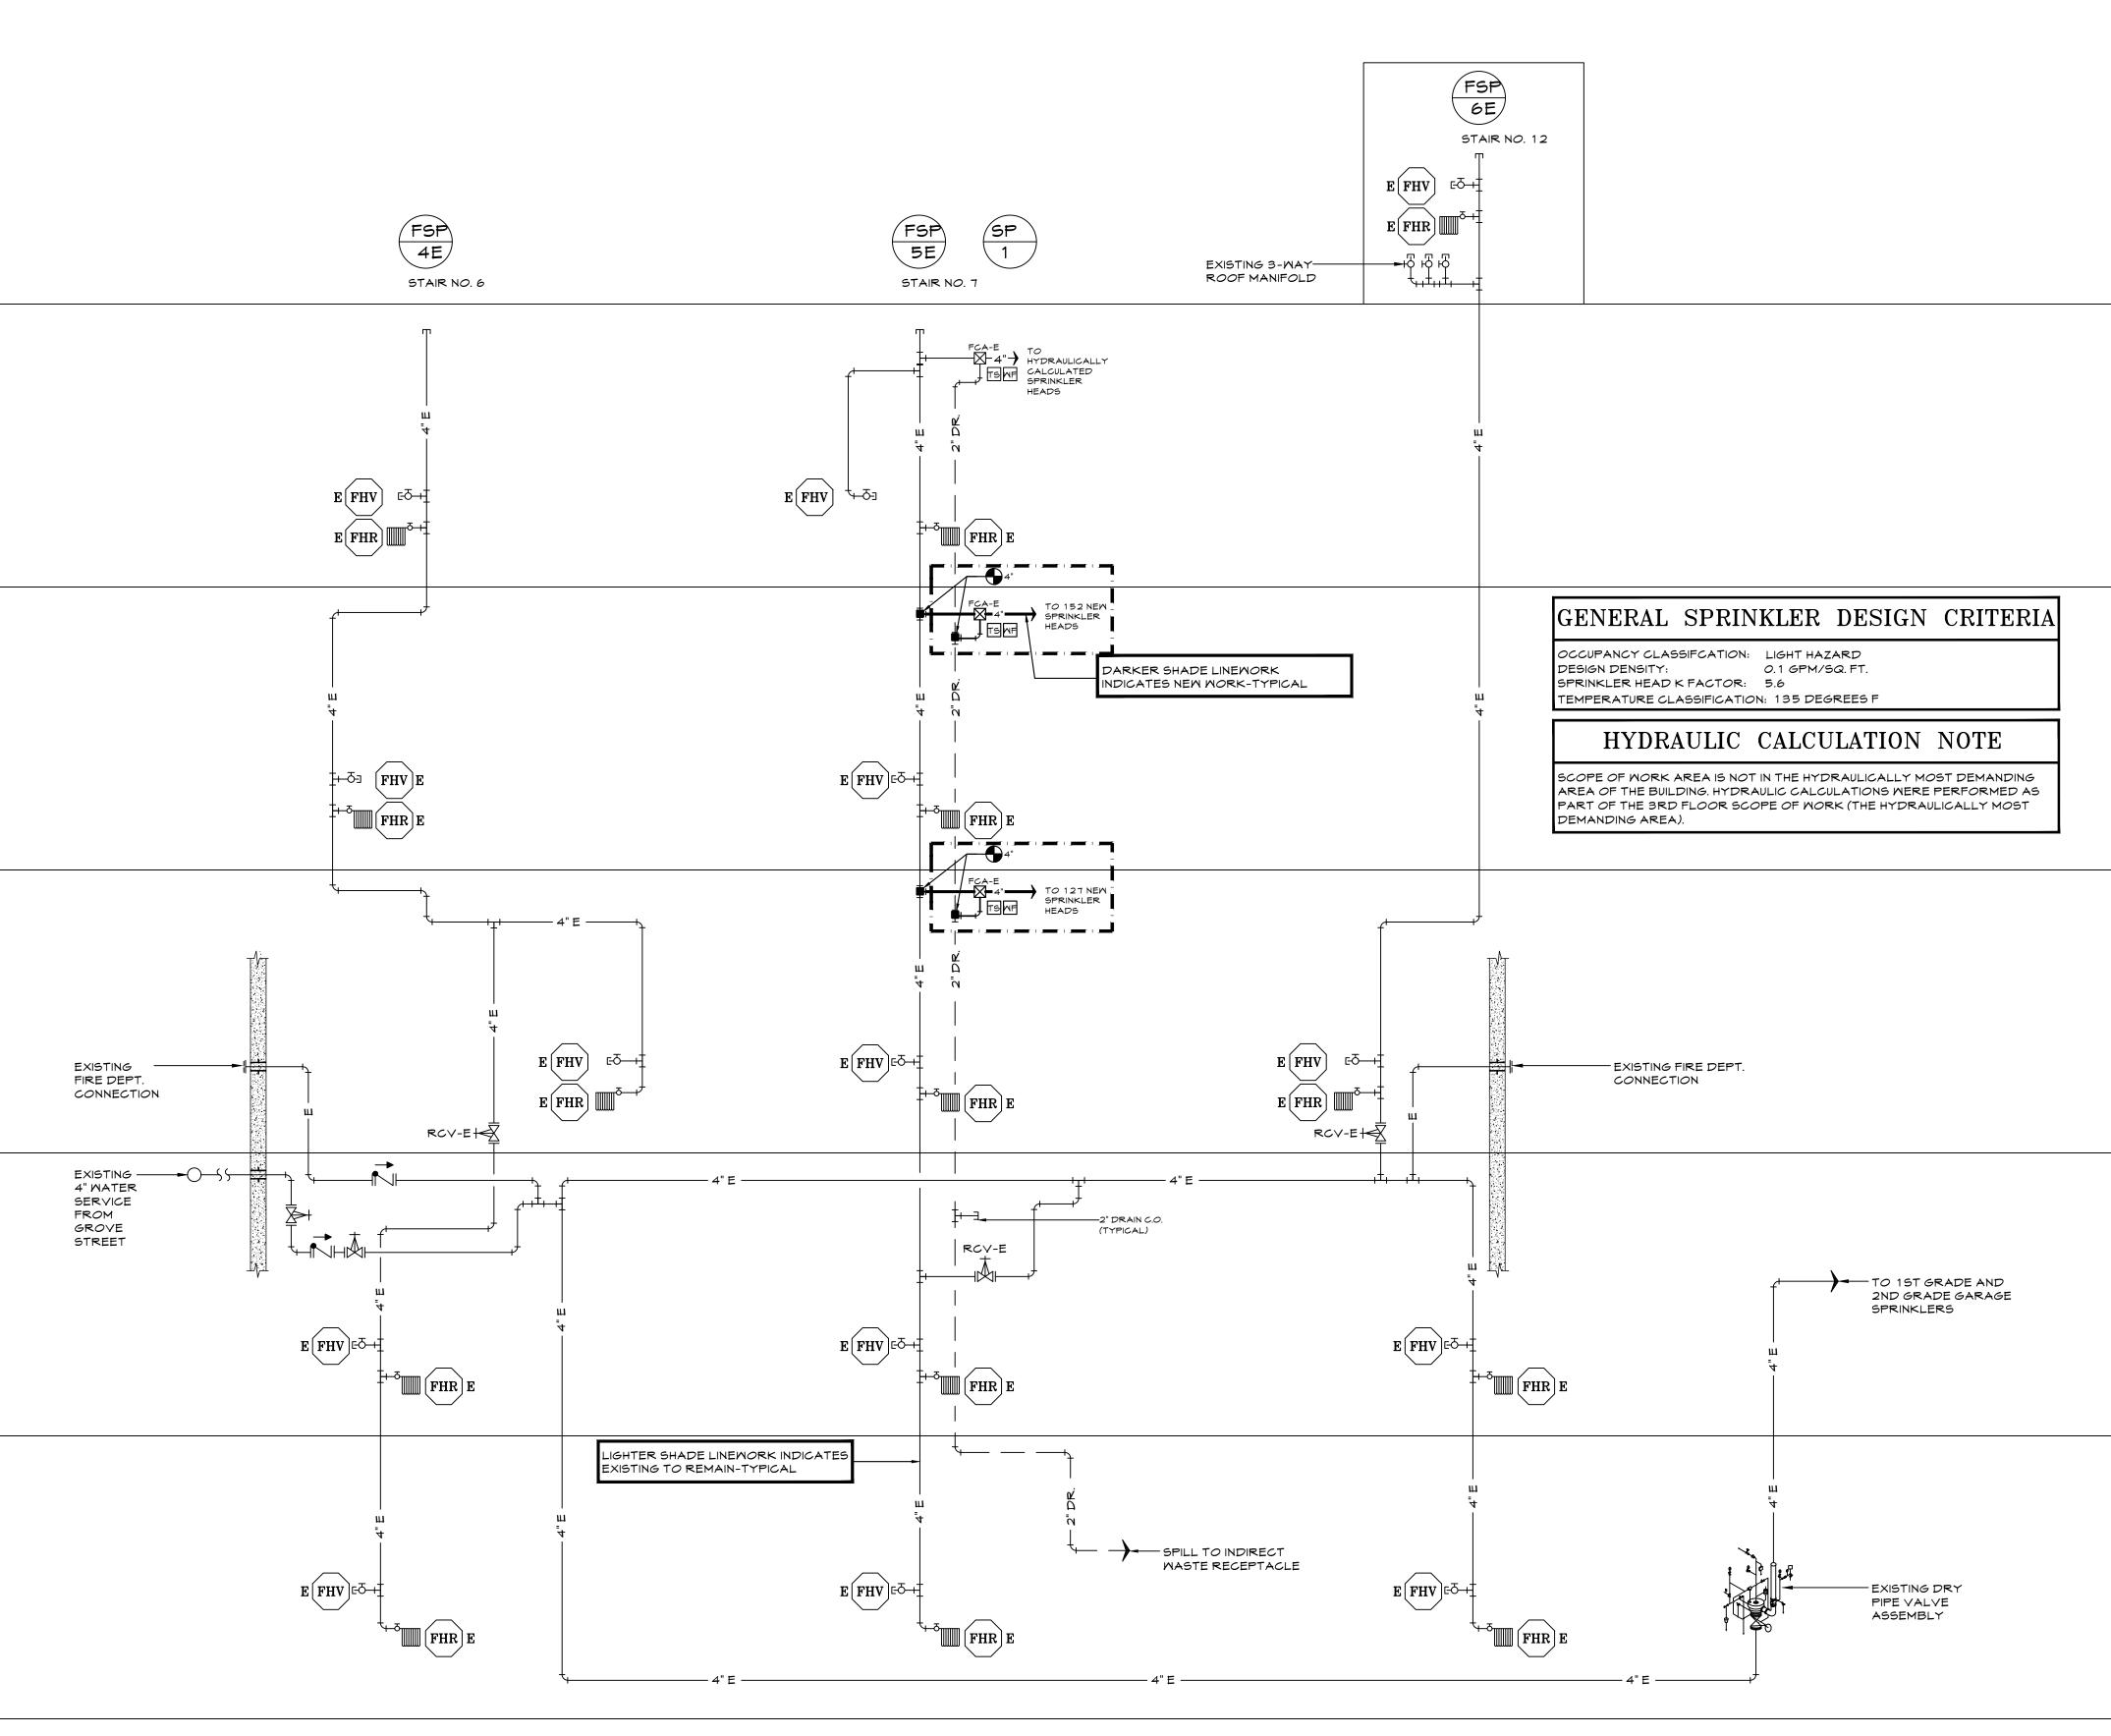



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SRD FLOOR ELEV: +27'-0"								
2ND FLOOR ELEV: +14'-6"								
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- - - - -								
1ST SUB-GRADE ELEV: -14'-10"	CONSULTANT SEAL		CONSULTANT	90-3	af & Lev Archited 0 161st Street, Ja 718-651-6200	cts LL] amaica, I	P 11432	
2ND SUB-GRADE	REVISION	DATE	MADE BY		VING CERTIFICATI	REVISIO	N	
ELEV: -0'-0"	NUMBER		1 \ _ \					
♥ ELEV: -0'-0"	NUMBER	T - NO CHAN CONTF	RACTOR				ACTOR	
D ONLY FOR THE WORK INDICATED ON TION SHEET. ALL OTHER MATTERS SHOWN N OR TO BE CONSIDERED AS EITHER BEING ICE WITH APPLICABLE CODES.	NUMBER	T - NO CHAN CONTF	NGES RACTOR		SIGNATURE: TITLE:			





	SPRINKLER HEAD COUNT
NO.	NOTE
68	NEW SPRINKLER HEADS
68	TOTAL


	BRANCH PIPE SIZE SCHEDULE						
1"	2 SPRINKLER HEADS						
1-1/4"	3 SPRINKLER HEADS						
1-1/2"	4 SPRINKLER HEADS						
2"	UP TO 6 SPRINKLER HEADS						

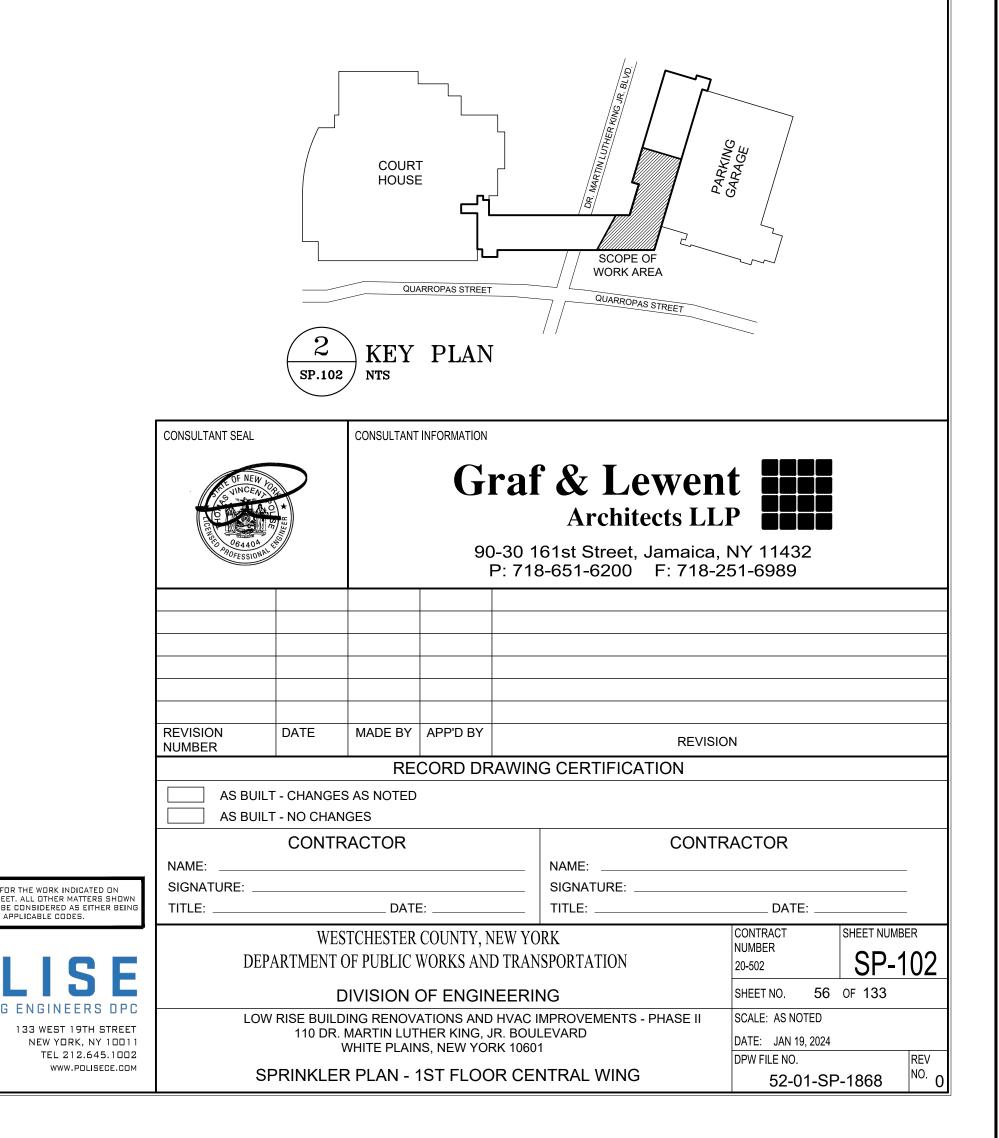


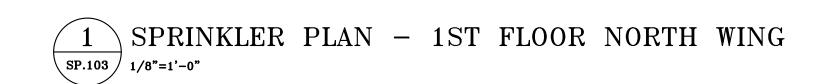

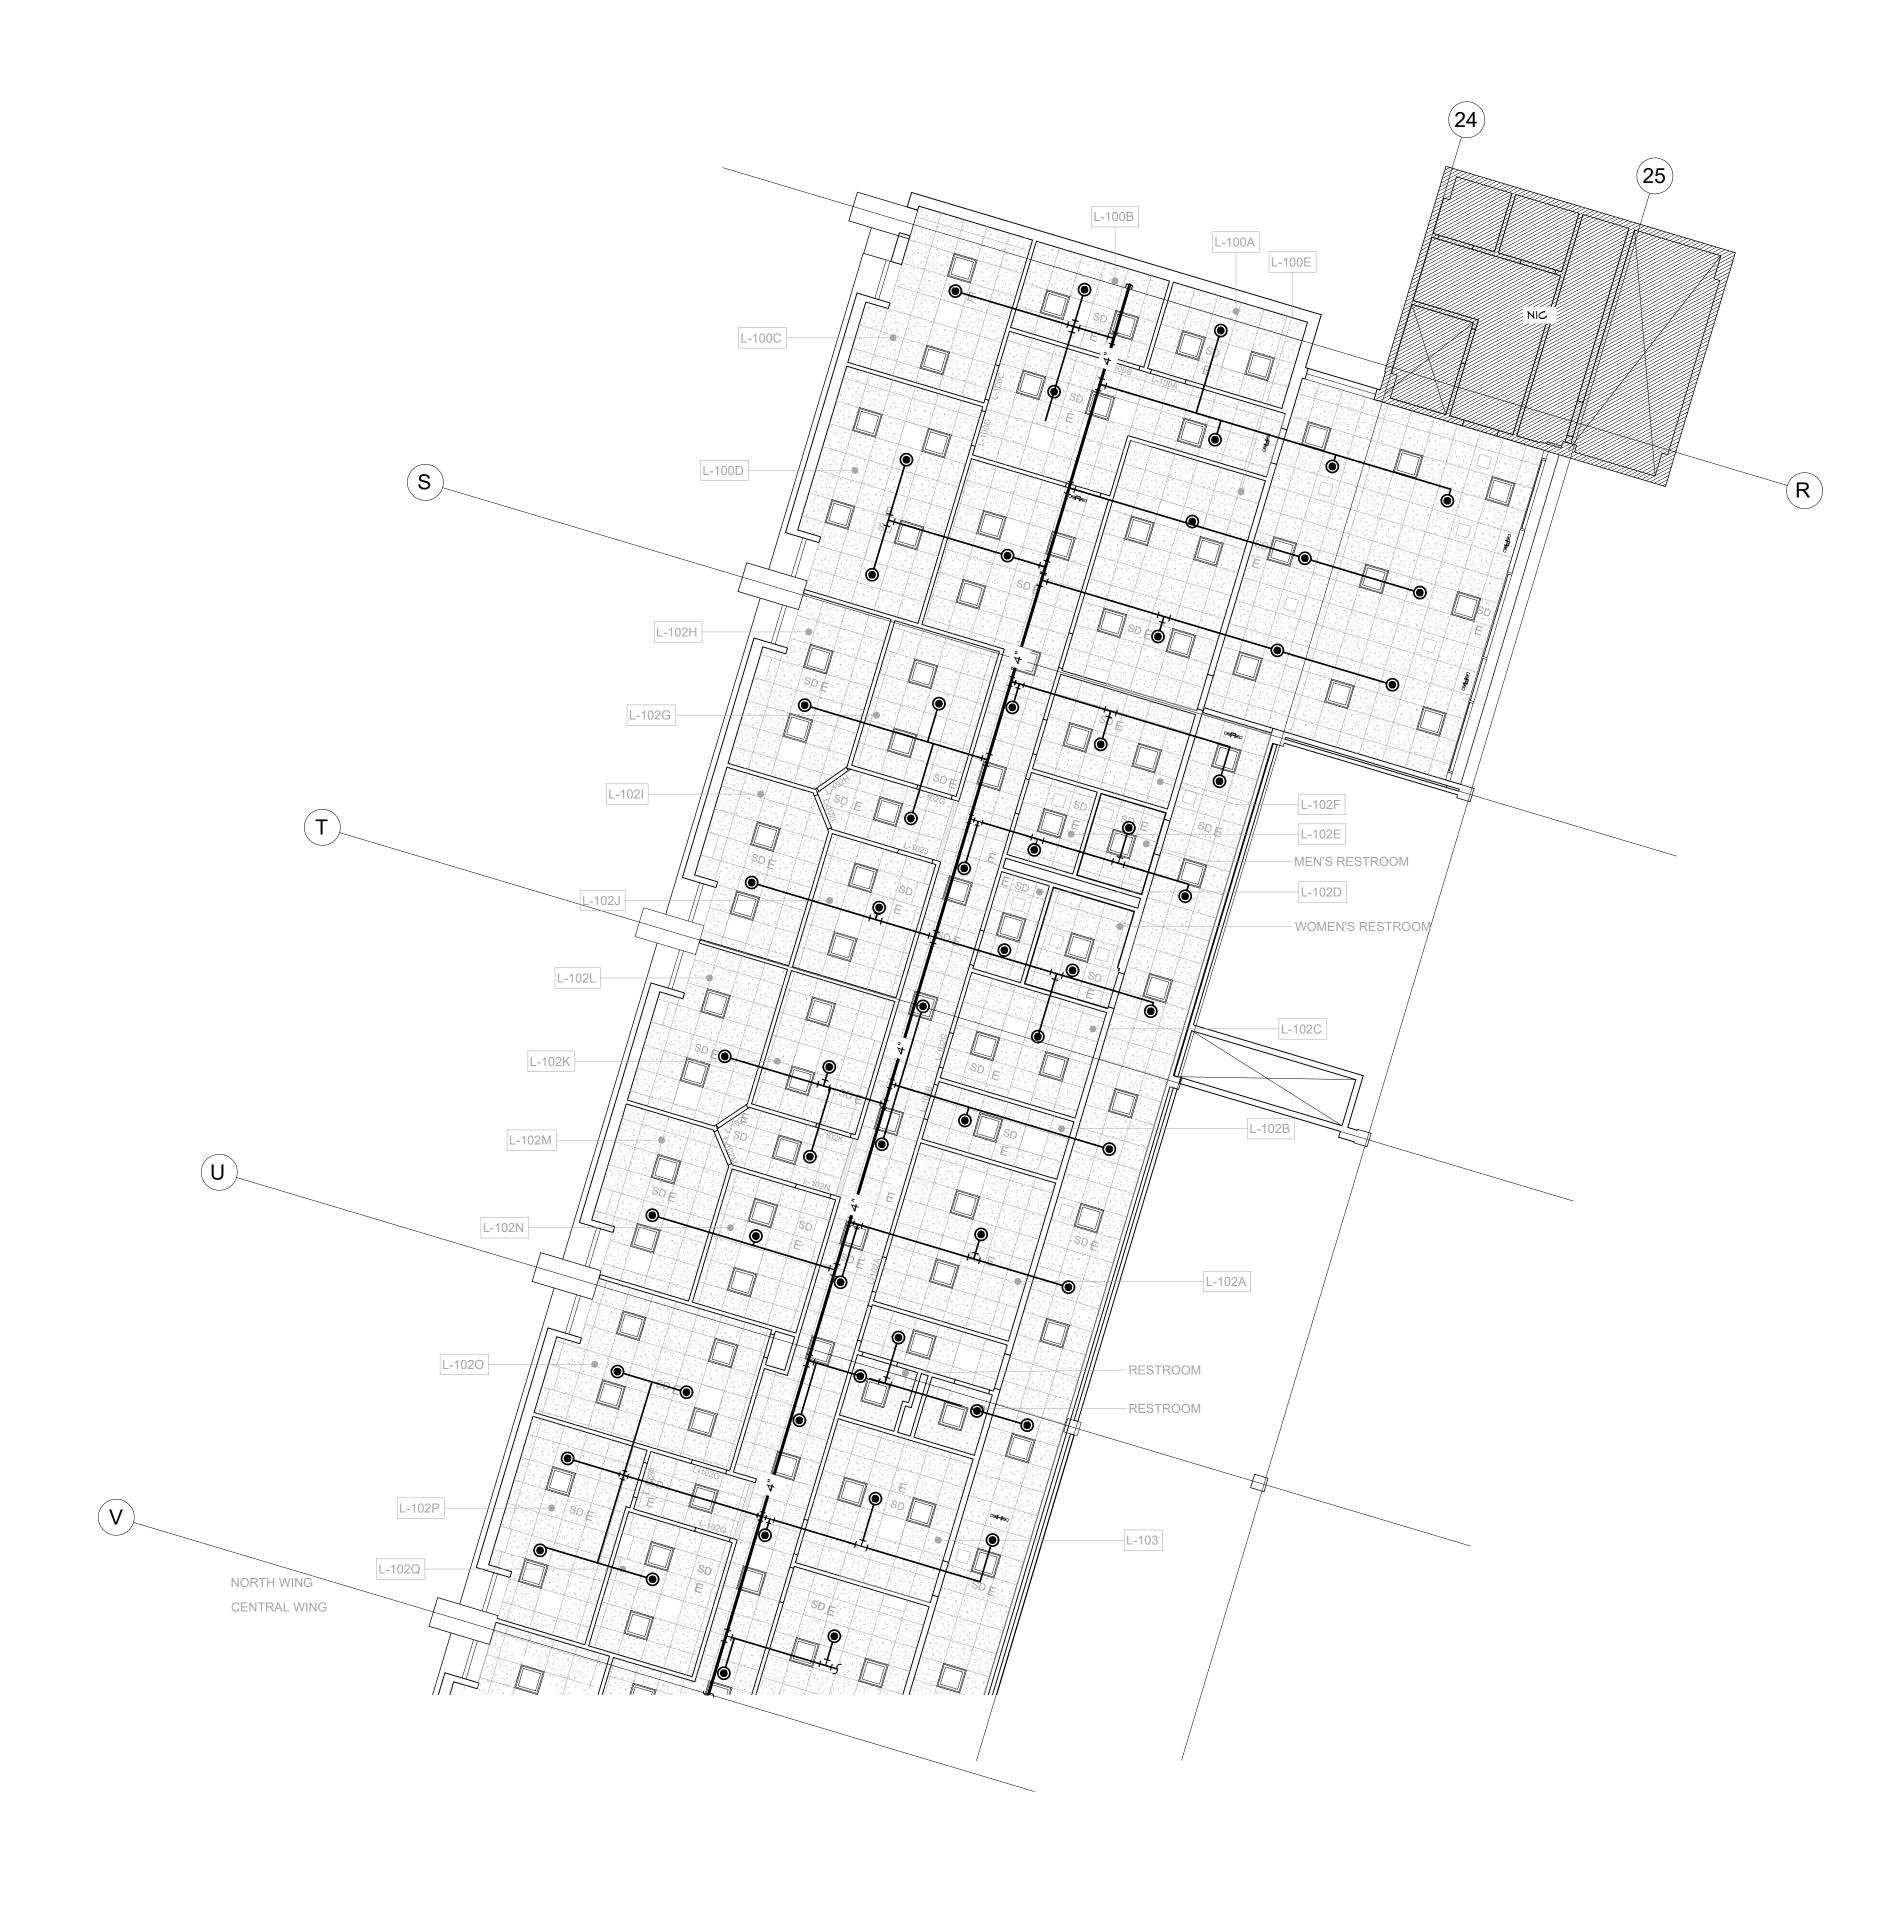

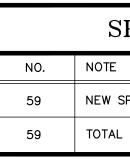

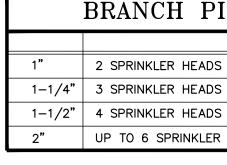

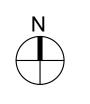



SPRINKLER HEAD COUNT

NEW SPRINKLER HEADS

BRANCH PIPE SIZE SCHEDULE


1" 2 SPRINKLER HEADS

1–1/2" 4 SPRINKLER HEADS

2" UP TO 6 SPRINKLER HEADS

			OURT DUSE		QUARROPAS STREET	
CONSULTANT SE	AL	CONSULTANT	90-30	0 1	C & Lewer Architects LI 61st Street, Jamaica, 3-651-6200 F: 718-2	L P 11432
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		RE	CORD DRAV	VIN	G CERTIFICATION	
	BUILT - CHANGE BUILT - NO CHAI					
NAME:	CONTRACTOR NAME:				NAME:	RACTOR
						DATE: CONTRACT SHEET NUMBER
	DEPARTMENT	OF PUBLIC		RAN	SPORTATION	NUMBER 20-502 SP-103
C	LOW RISE BUILI 110 DR	DING RENOV	OF ENGINEE ATIONS AND HV HER KING, JR. E IS, NEW YORK 1	AC I BOUI	MPROVEMENTS - PHASE II LEVARD	SHEET NO. 57 OF 133 SCALE: AS NOTED DATE: JAN 19, 2024
22 אנ			1ST FLOOR			DPW FILE NO. REV 52-01-SP-1869




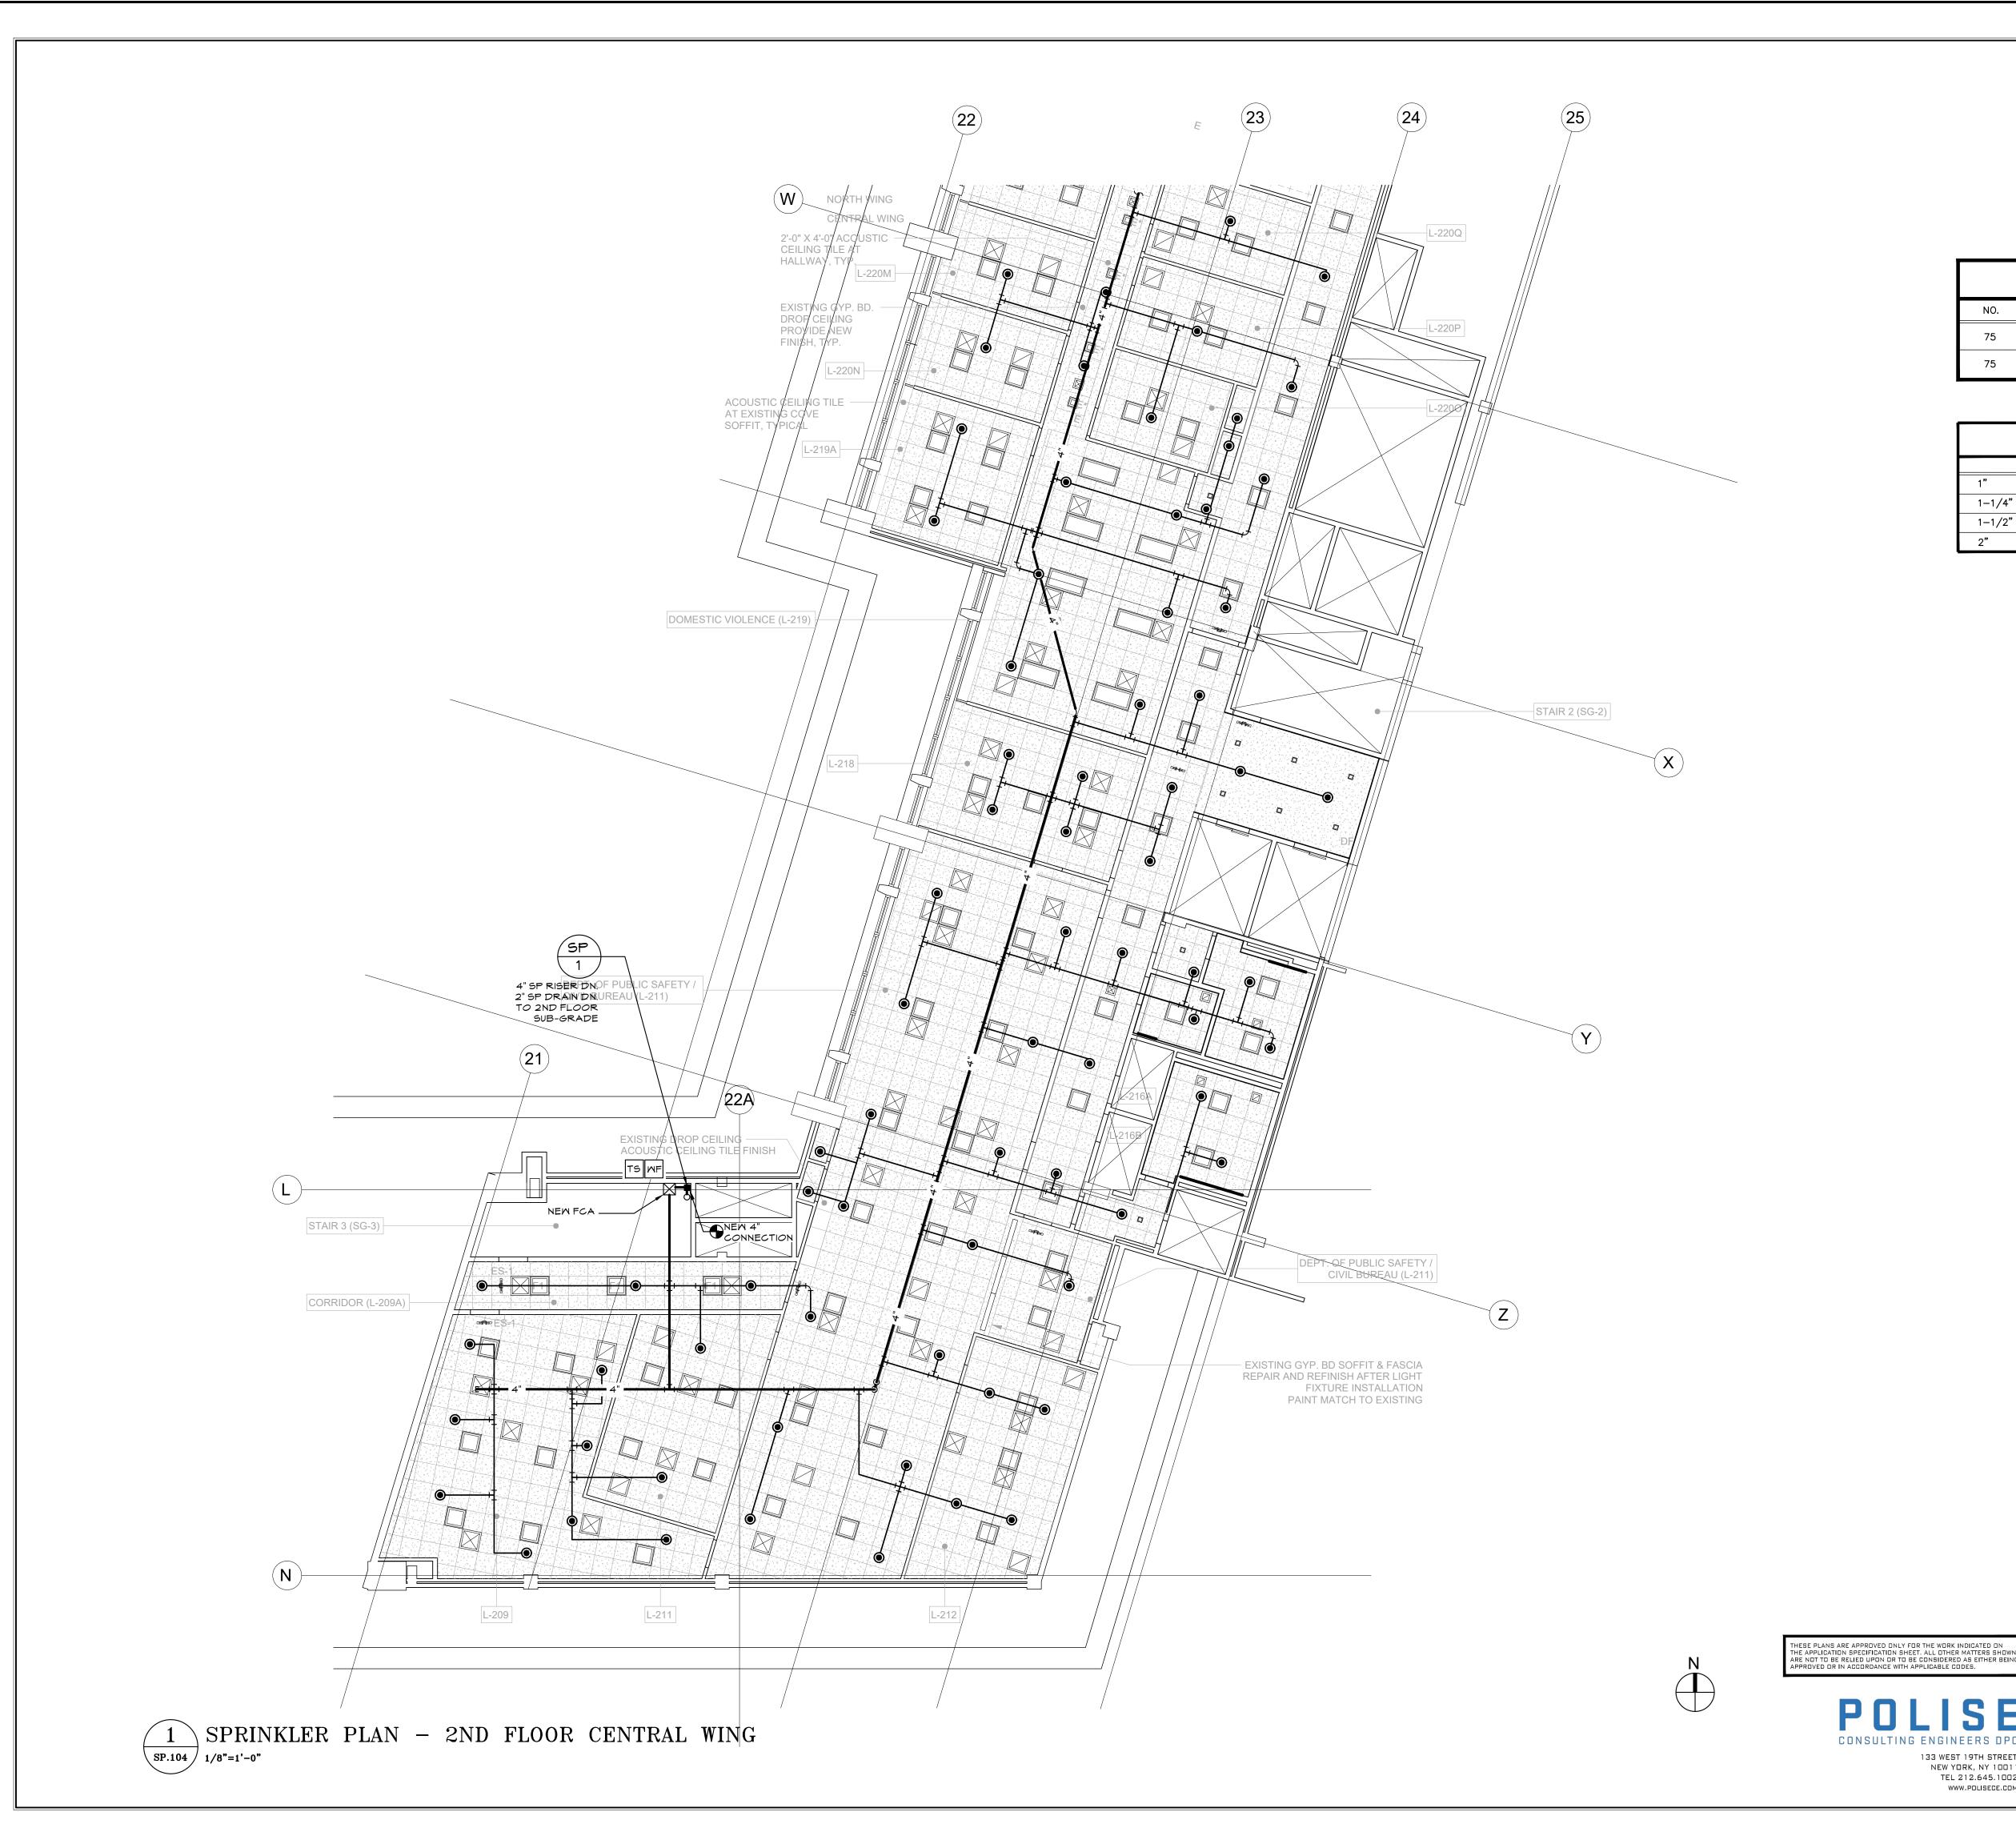


SPRINKLER HEAD COUNT

NO.	NOTE
75	NEW SPRINKLER HEADS
75	TOTAL

	BRANCH PIPE SIZE SCHEDULE
1"	2 SPRINKLER HEADS
1-1/4"	3 SPRINKLER HEADS
1-1/2"	4 SPRINKLER HEADS
2"	UP TO 6 SPRINKLER HEADS

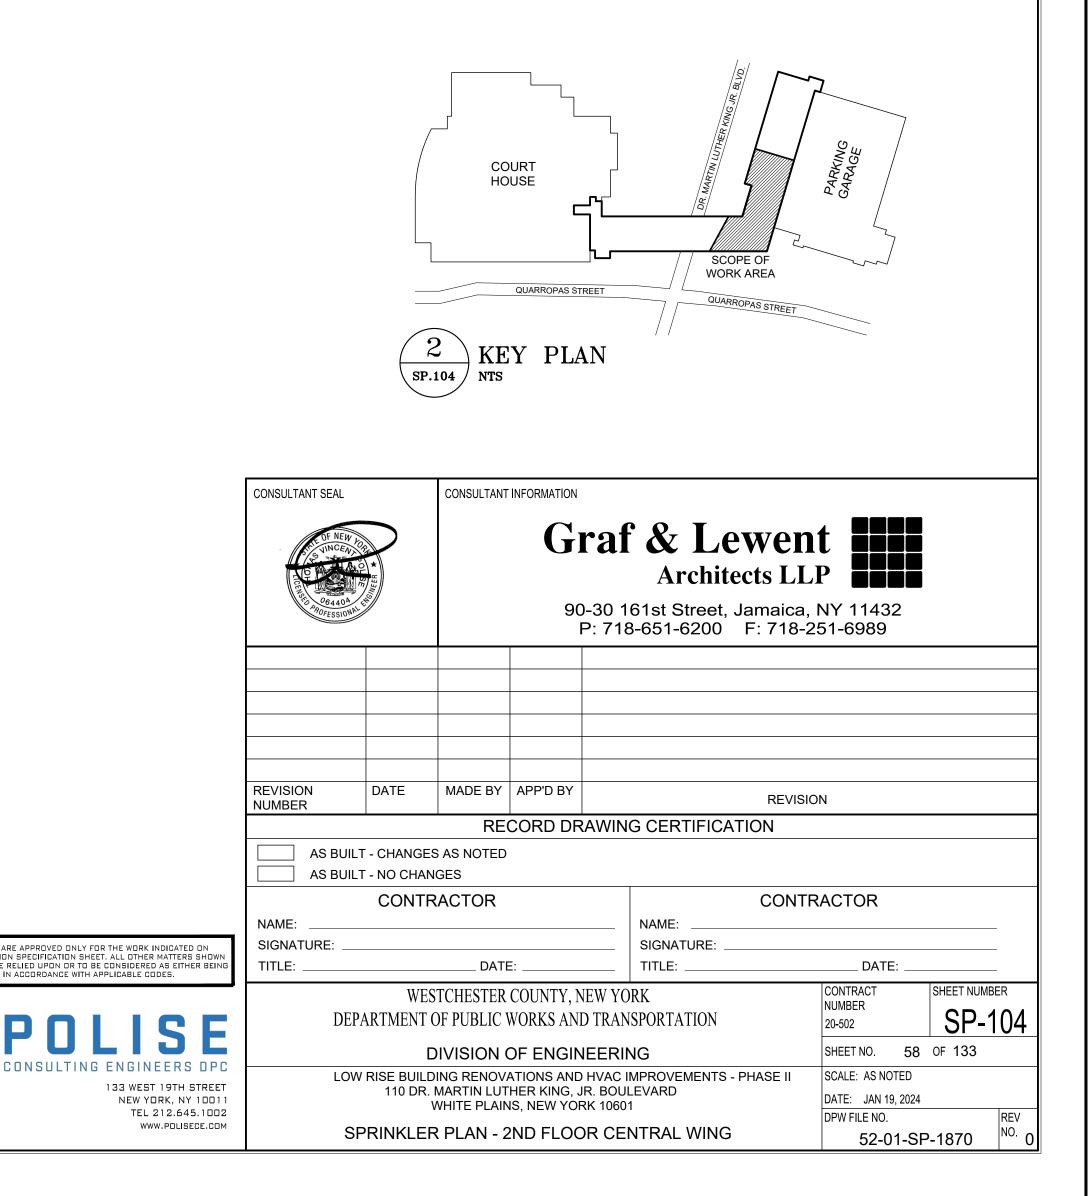

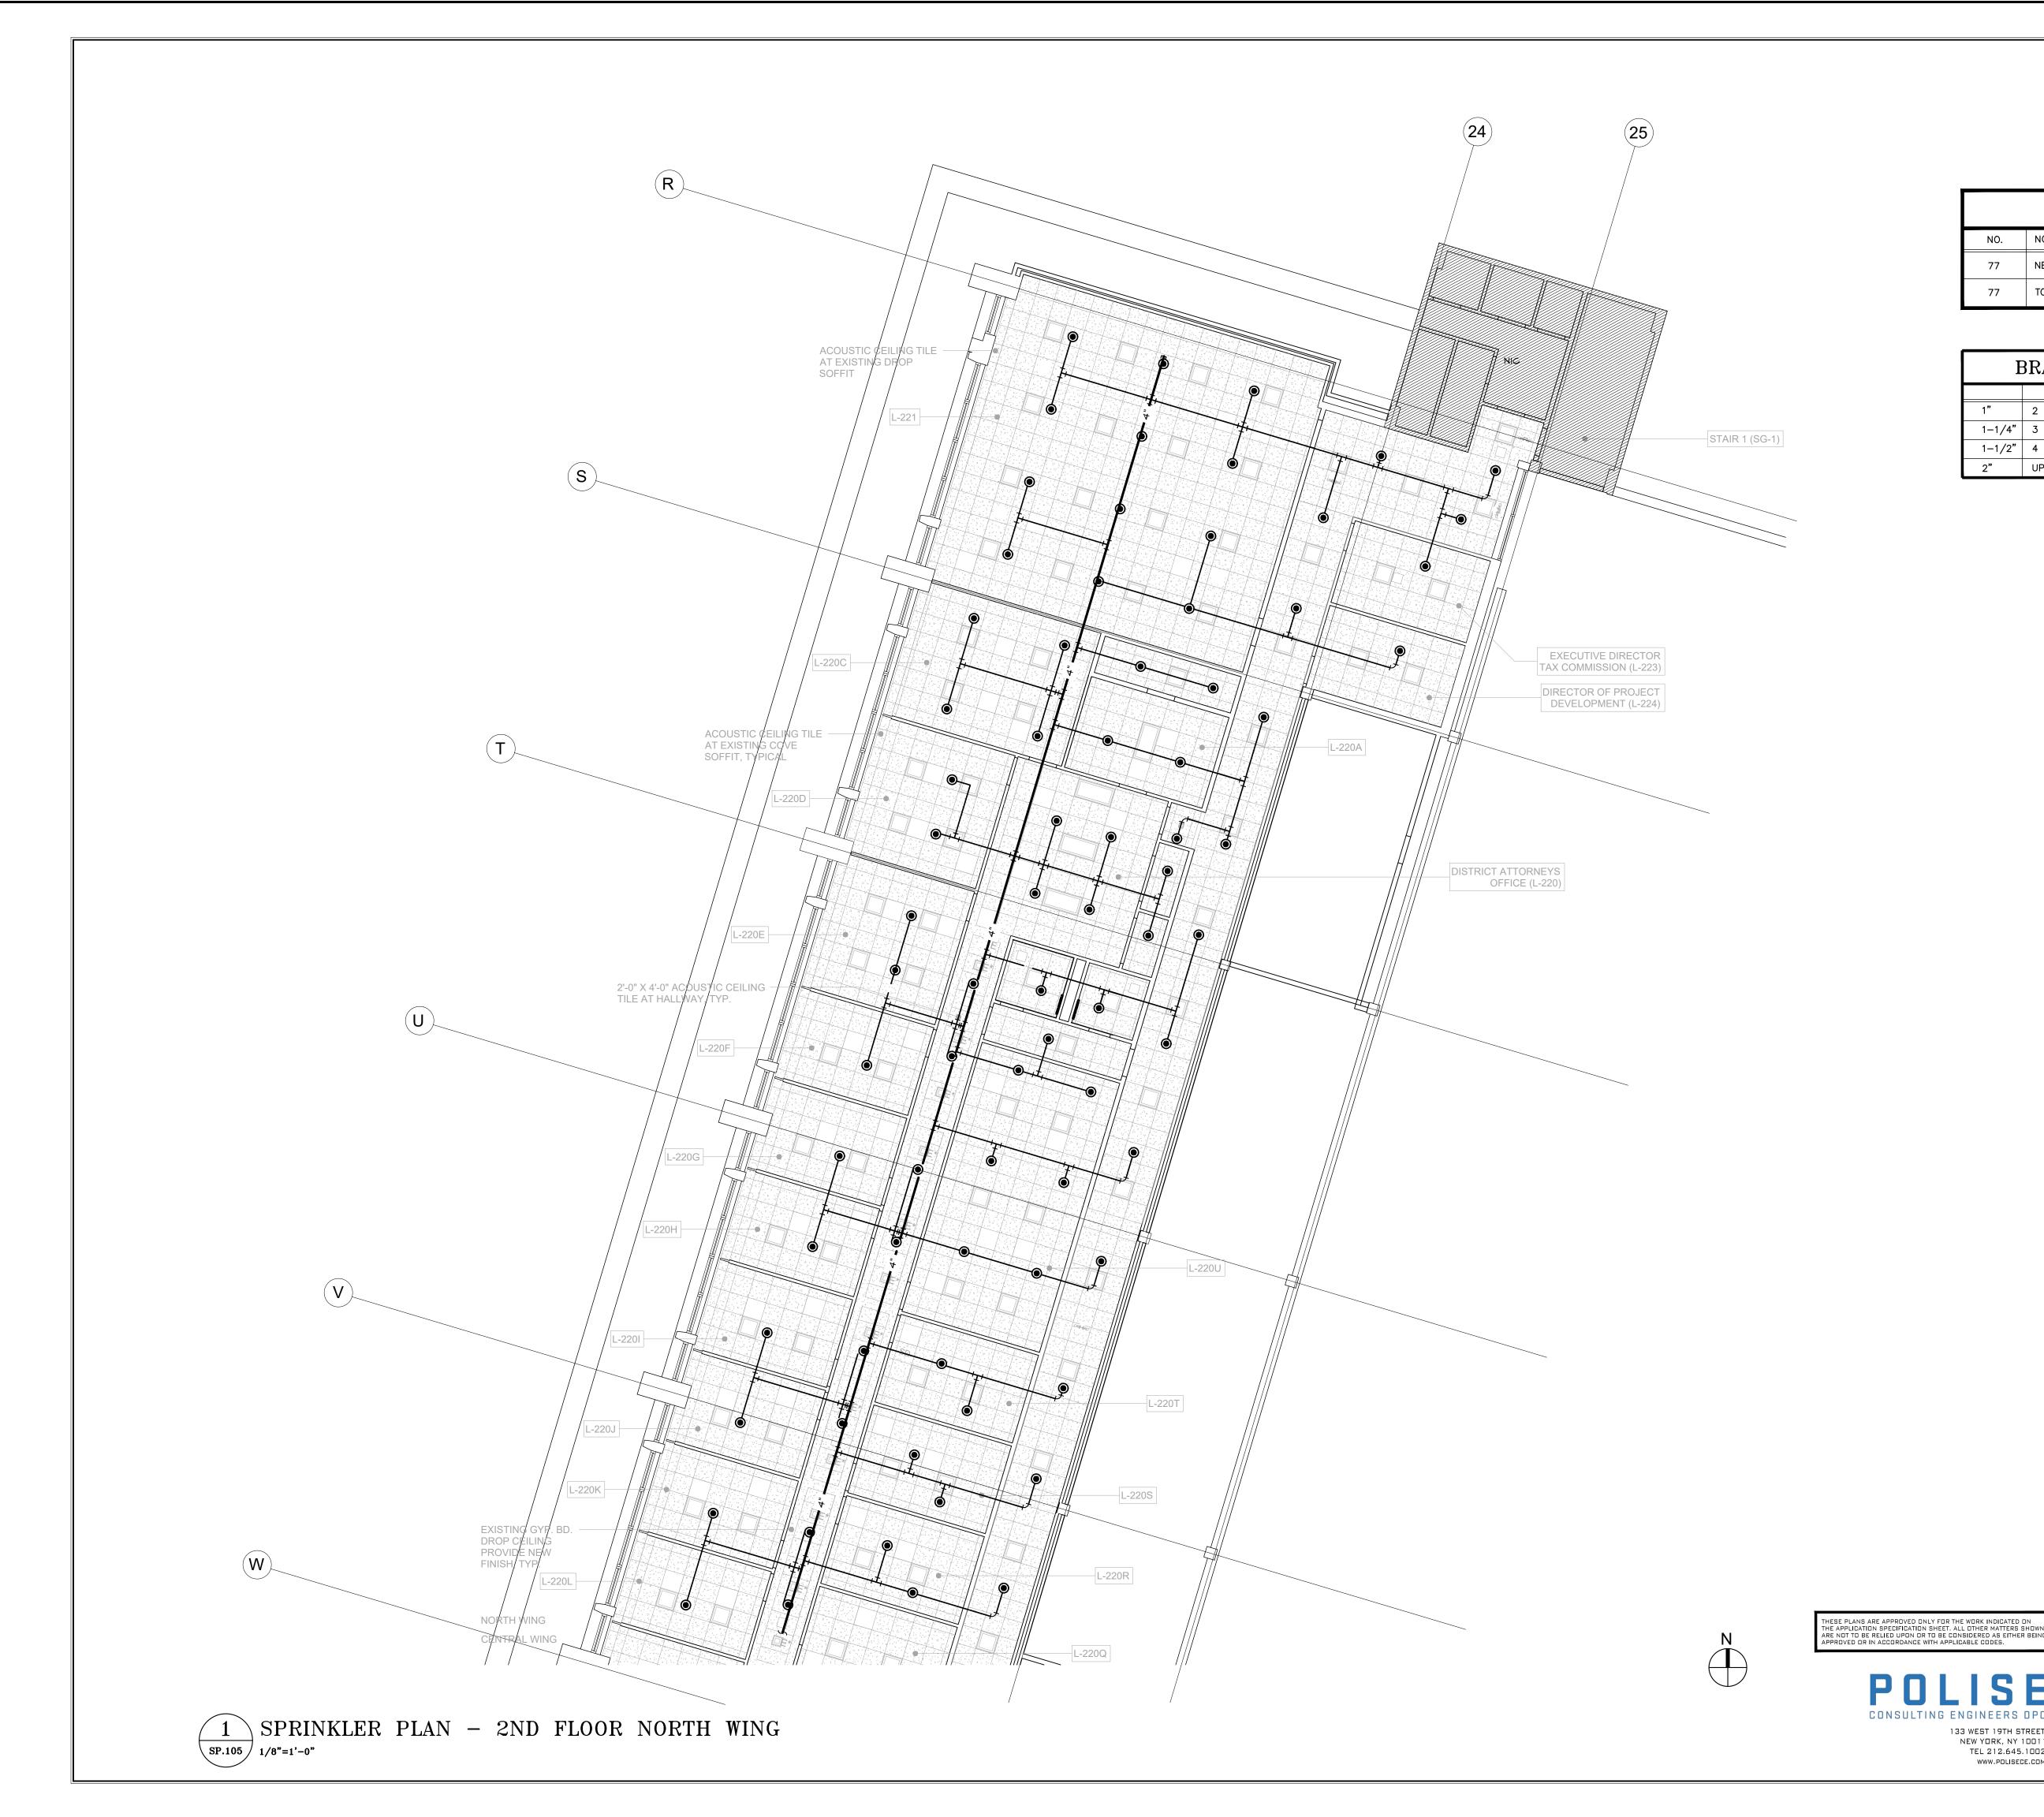


SPRINKLER HEAD COUNT

NO.NOTE77NEW SPRINKLER HEADS77TOTAL

BRANCH PIPE SIZE SCHEDULE

1"	2 SPRINKLER HEADS
1-1/4"	3 SPRINKLER HEADS
1-1/2"	4 SPRINKLER HEADS
2"	UP TO 6 SPRINKLER HEAD

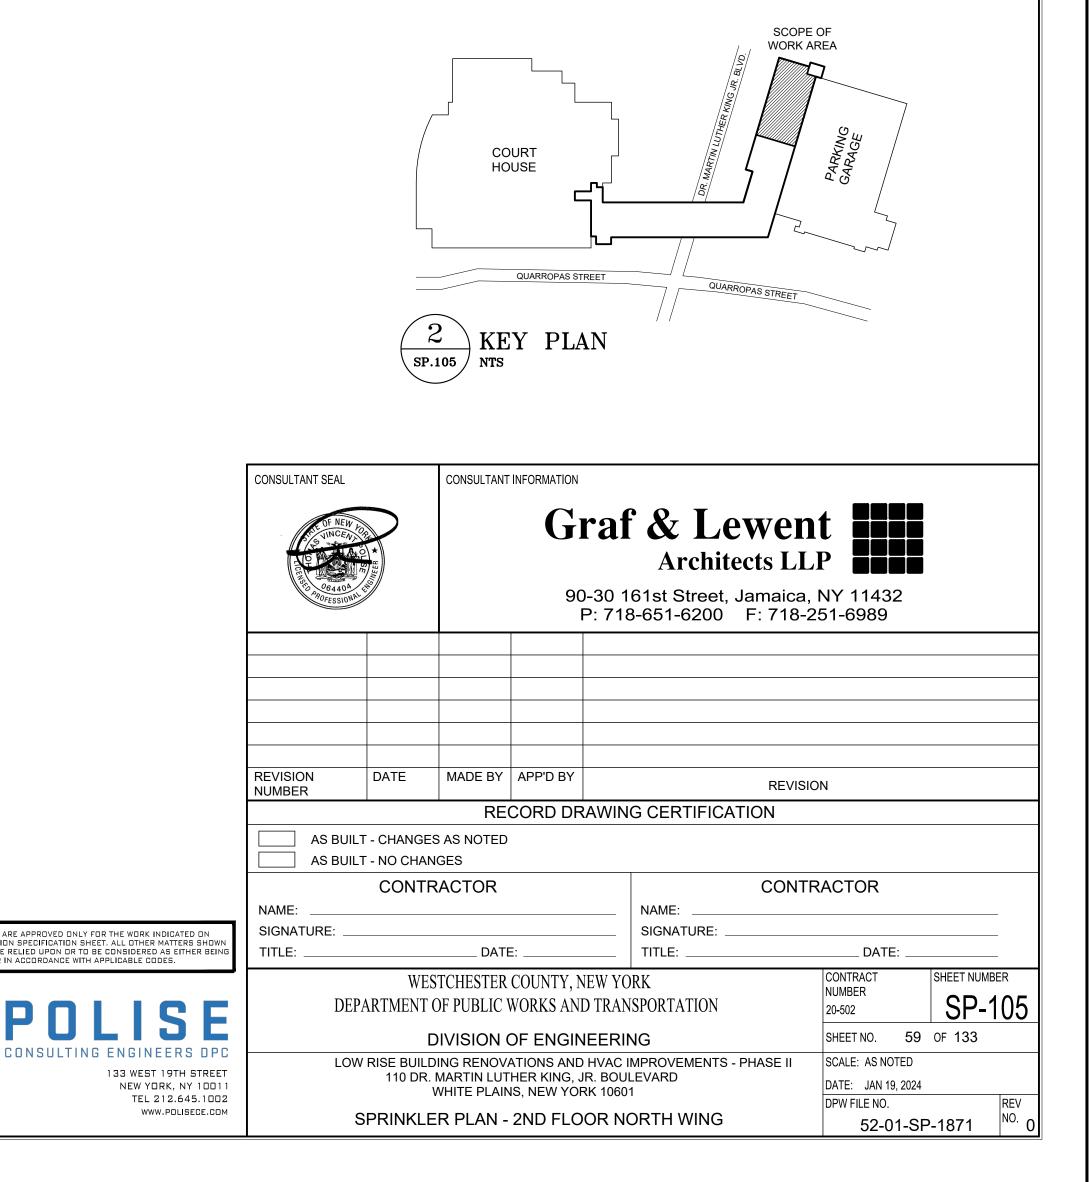

				P	IPE IN	SULAT	ION S	CHED	ULE				
		CODE REQUIREMENT											
					NON	MINAL PIPE SIZE	(IN.)			INSULATION			
TYPICAL APPLICATION	OPERATING RA	MEAN RATING TEMP. (°F)	CONDUCTIVIT Y BTU X IN. / (H X FT ² X °F)	.75	1.0 TO 1.25	1.5 TO 3.5	4.0 TO 7.0	≥ 8.0	$(H \times FT^2 \times F)$	CONDUCTIVIT	.75		
					INSL	JLATION THICKN	ESS		CODE MAX.	$(H \times FT^2 \times F)$			
DOMESTIC HOT WATER	141-200	125	0.25-0.2 9	1.5	1.5	2.0	2.0	2.0	0.29	0.29	1.5		
DOMESTIC HOT WATER	105-140	100	0.22-0.2 8	1.0	1.0	1.5	1.5	1.5	0.28	0.28	1.0		
DOMESTIC COLD WATER	40-65	58	0.22-0.2 8	-	-	-	-	-	0.28	0.28	0.5		
STORM WATER	40-65	58	0.22-0.2 8	-	-	-	-	-	0.28	0.28	0.5		

	DRAIN SCHEDULE							
TYPE	LOCATION	MODEL NUMBER	REMARKS					
FD	GENERAL PURPOSE	2005-Y-NB	8" DIAMETER STRAINER					
	WHERE "TP" IS INDICATED PROVIDE TRAP PRIMER IN ACCORDANCE WITH TRAP PRIMER SCHEDULE. DRAIN TRAP TO BE PROVIDED WITH REQUIRED TAPPING.							

PLUMBING FIXTURE CONNECTION SCHEDULE										
SYMBOL	TYPE	DESCRIPTION	MASTE	VENT	COLD WATER	HOT WATER	REMARKS			
	M.C.	MATER CLOSET	4"	2"	1"	-				
\mathbb{A}	LAV	LAVATORY	2"	1-1/2"	1/2" X 3/8"	1/2" X 3/8"				
	URIN.	URINAL	З"	1-1/2"	3/4" X 3/8"	-				

"-A" INDICATES ADA ACCESSIBLE "-P" INDICATES PUBLIC FIXTURES

* WHERE LAV WASTE IS USED AS WET VENT MINIMUM 2" WASTE SIZE REQUIRED.

NOTES: 1. REFER TO ARCHITECTS DRAWINGS AND SPECIFICATIONS FOR ALL FIXTURE SPECIFICATIONS, FIXTURE TRIM AND MOUNTING HEIGHTS. ALL EXPOSEI APPURTANCES, TRAPS, NIPPLES, SUPPLIES, RISERS AND EXPOSED TO VIEW FITTINGS AND ESCUTCHEONS FOR ALL AREAS SHALL MATCH ARCHITE ASSOCIATED FIXTURE TYPE. MCGUIRE PLUMBING PRODUCTS PROFESSIONAL LINE SERIES P TRAPS WITH BOX FLANGE AND TRAP CLEANOUT PLUG. MCGUIRE HEAVY PREMIER LINE SERIES WITH SET SCREW HANDLES, FINISH AS DIRECTED BY ARCHITECT


	PUMP SCHEDULE											
					PUM	PUMP DATA MOTOR DATA						
NO	SERVICE	LOCATION	NO OF PUMPS	MODEL NUMBER	GPM	HEAD IN FEET	RPM	HP	VOLTS	PHASE	CYCLE	REMARKS
	SIMPLEX OIL MINDER SYSTEM	ELEVATOR PITS	2	SE-500/M	74	37	3450	0.5	115	1	60	OIL MINDER. PROVIDE HWA-1 HIGH WA IN NEMA-1 ENCLOSURE WITH AUXILIAR WITH SEPARATE GUIDE RAILS.
PP 2	ELEVATOR SUMP PUMPS	ELEVATOR PITS	4	SE-50	74	37	3450	0.5	115	1	60	PROVIDE HWA-1 HIGH WATER CONTRO ENCLOSURE WITH AUXILIARY CONTRO SEPARATE GUIDE RAILS.

CIFIED INSULAT	ION			1
NOI	MINAL PIPE SIZE	(IN.)		AE
1.0 TO 1.25	1.5 TO 3.5	4.0 TO 7.0	≥ 8.0	A.D. A.F.F.
INSU	JLATION THICKN	ESS		B.F.F. B.S.
1.5	2.0	2.0	2.0	B.T. B.T.C. B.T.F.
1.0	1.5	1.5	1.5	BLM. C.F. CLG.
0.5	0.5	0.5	0.5	C.O. C.O.D.F CONN.
0.5	0.5	0.5	0.5	G.V. G.M. G.MF
				D.F. DN.
		J.R. SI AS ST	MITH ANDARD	D.N. DNG. E
				EL. EMERC ER
				ER-R
				E.M.C. F.A.I.
				F.C.O. FD. F.D.C.
				F.F. F.F.D.
				FL. F.S. F.U.
				FUN. DI G.
				G.₩. G.∀. H.B.
				н.с. н.м.т.
				Н. R . Н.Т.
				H.M. H.M.R. H.M.R.E
	N PLUMBING	TRIM &	FOR	I.M. I.M.
		LIES AND ST		K.S. LAV. L.D.
				L.S. N
		10DELS AS S R APPROVED		N.C. N.I.C.
				N.O. O.D. O.S.T.
				P.D. P.G.
-	TROL ALAI OLS. ORDE			P.O. P.R.V. P.S.
ROL ALARI	M IN NEMA-	1		P.T.R. R.C.V.
				R.D. R.P.Z.
				R.T.
				R.√. S SHOM.
				S.L.R.S SPK.
				5.P.O. 5.5.
				ST STR.
				TD T.P. T.S.
				T.S. TYP. UR.
				∨ ∨.B.
				V.O.


	ABBREVIATIONS
ABBREV.	DESCRIPTION
A.C.	AIR CHAMBER
A.D.	ACCESS DOOR
A.F.F.	ABOVE FINISHED FLOOR
B.F.F.	BELOW FINISHED FLOOR
B.S.	BAR SINK
B.T.	BATH TUB
B.T.C.	BRANCH TO CONNECTION
B.T.F.	BRANCH TO FIXTURE
BLW.	BELOM
C.F.	CONTROLLED FLOM
CLG.	CEILING
C.O.	CLEAN OUT
C.O.D.P.	CLEAN OUT DECK PLATE
CONN.	CONNECTION
C.∀.	CHECK VALVE
C.₩.	COLD WATER
C.WF	FILTERED COLD WATER
D.F.	DRINKING FOUNTAIN
DN.	DOWN
D.W.	DISH MASHER
DMG.	DRAWING
E	EXISTING FIXTURE OR EQUIPMENT TO REMAIN
EL.	ELEVATION
EMERG.	EMERGENCY OVERFLOW DRAINS
ER	EXISTING FIXTURE OR EQUIPMENT TO BE REMOVED
ER-R	EXISTING FIXTURE OR EQUIPMENT TO BE REMOVED AND REPLACED
E.M.C.	ELECTRIC WATER COOLER
F.A.I.	FRESH AIR INLET
F.C.O.	FLOOR CLEAN OUT
FD.	FLOOR DRAIN
F.D.C. F.F.	FIRE DEPARTMENT CONNECTION
F.F.D.	FUNNEL FLOOR DRAIN FLOOR
FL.	FLOOR SINK
F.S.	FIXTURE UNIT
F.U. FUN. DR.	FUNNEL DRAIN
G.	GAS
G.M.	GREASE WASTE
G.∨.	GATE VALVE
H.B.	HOSE BIBB
H.C.	HUNG CEILING
H.M.T.	DOMESTIC HOT WATER HEAT
H.R.	TRACED MAINTENANCE SYSTEM HOSE RACK
Н.Т.	HEAT TRACED PIPING
Н.М.	HOT WATER
H.M.R.	HOT WATER RETURN
H.M.R.B.	HOT WATER RETURN BASE BUILDING
I.M.	ICE MAKER
I.M.	INDIRECT WASTE
K.S.	KITCHEN SINK
LAV.	LAVAT <i>O</i> RY
L.D.	LEAK DETECTOR
L.S.	LOCAL SOIL
N	NEM FIXTURE OR EQUIPMENT
N.C.	NORMALLY CLOSED
N.I.C.	NOT IN CONTRACT
N.O.	NORMALLY OPEN
0.D.	OVERFLOW DRAIN
0.S.T.	OVERFLOW STORM
P.D.	PUMP DISCHARGE
P.G.	PRESSURE GAUGE
P.O.	PLUGGED OUTLET
P.R.V.	PRESSURE REDUCING VALVE
P.S.	PANTRY SINK
P.T.R.	PRESSURE TEMPERATURE RELIEF
R.C.V.	RISER CONTROL VALVE
R.D.	ROOF DRAIN
R.P.Z.	REDUCED PRESSURE
R.T. R.V.	BACKFLOW DEVICE RUNNING TRAP RELIEF VENT
SHOW.	SOIL SHOWER
S.L.R.S.	SPRING LOADED RUBBER SEAT
SPK.	SPRINKLER
S.P. <i>O.</i>	SOIL PLUGGED OUTLET
5.5.	SERVICE SINK
ST	STORM
STR.	STRAINER
TD	TRENCH DRAIN
T.P.	TRAP PRIMER
T.S.	TAMPER SWITCH
TYP.	TYPICAL
UR.	URINAL
∨	VENT
∨.B.	VACUUM BREAKER
V.O.	VALVED OUTLET
V.P.O.	VENT PLUGGED OUTLET
∨.T.R.	VENT THRU R <i>OO</i> F
M	WASTE
M.C.	WATER CLOSET
M.C.O.	WALL CLEAN OUT
M.H.A.	WATER HAMMER ARRESTOR
M.M.	WASHING MACHINE
M.M.L.B.	WASHING MACHINE LAUNDRY BOX
M.P.O.	WASTE PLUGGED OUTLET


	SYMBOL LIST
SYMBOL	DESCRIPTION
	BALL VALVE
	CHECK VALVE
	OS&Y VALVE WITH CHAIN OPERATOR
lð	PRESSURE REDUCING VALVE
Ш	INDICATES SLEEVE
	UNION
	STRAINER
	PRESSURE GUAGE WITH GAUGE COCK
	THERMOMETER
<u> </u>	CLEANOUT PLUG
1 DETAIL # P-100 DWG. #	DETAIL DESIGNATION
(P) (B)	STACK OR RISER DESIGNATION
(P-100)	REFERENCE DRAWING TAG IDENTIFICATION
•	INDICATES NEW CONNECTION TO EXISTING
	INDICATES CAPPED CONNECTION OFF EXISTING
н <u>т</u>	HOSE BIBB
C	RISER DOWN (ELBOW)
0	RISER UP (ELBOW)
+C+	DROP
	BRANCH - BOTTOM CONNECTION
+&+	BRANCH - TOP CONNECTION
, <u>+</u>,	BRANCH - SIDE CONNECTION
]	CAPPED OUTLET
	SOIL OR STORM BELOW FLOOR
	SOIL, WASTE, OR SANITARY PIPING
	VENT
ST	STORM PIPING
— IN —	INDIRECT WASTE PIPING
	COLD WATER PIPING
	HOT WATER PIPING
	HOT WATER RETURN PIPING
E	(LIGHTER SHADE)
HT	INDICATES HEAT TRACED PIPING
<u></u> ₩E-₩-E-₩-	INDICATES EXISTING PIPING TO BE REN INDICATES OPENING THROUGH
	STEEL
TP.	
<u>م</u> ر	E-INDICATES EXISTING FIXTURE, PIPING
E	REMAIN ER-INDICATES EXISTING FIXTURE OR E
ER-R N	REMOVED ER-R-INDICATES EXISTING FIXTURE OF
	REMOVED AND REPLACED N- INDICTAED NEW FIXTURE OR EQUIPS



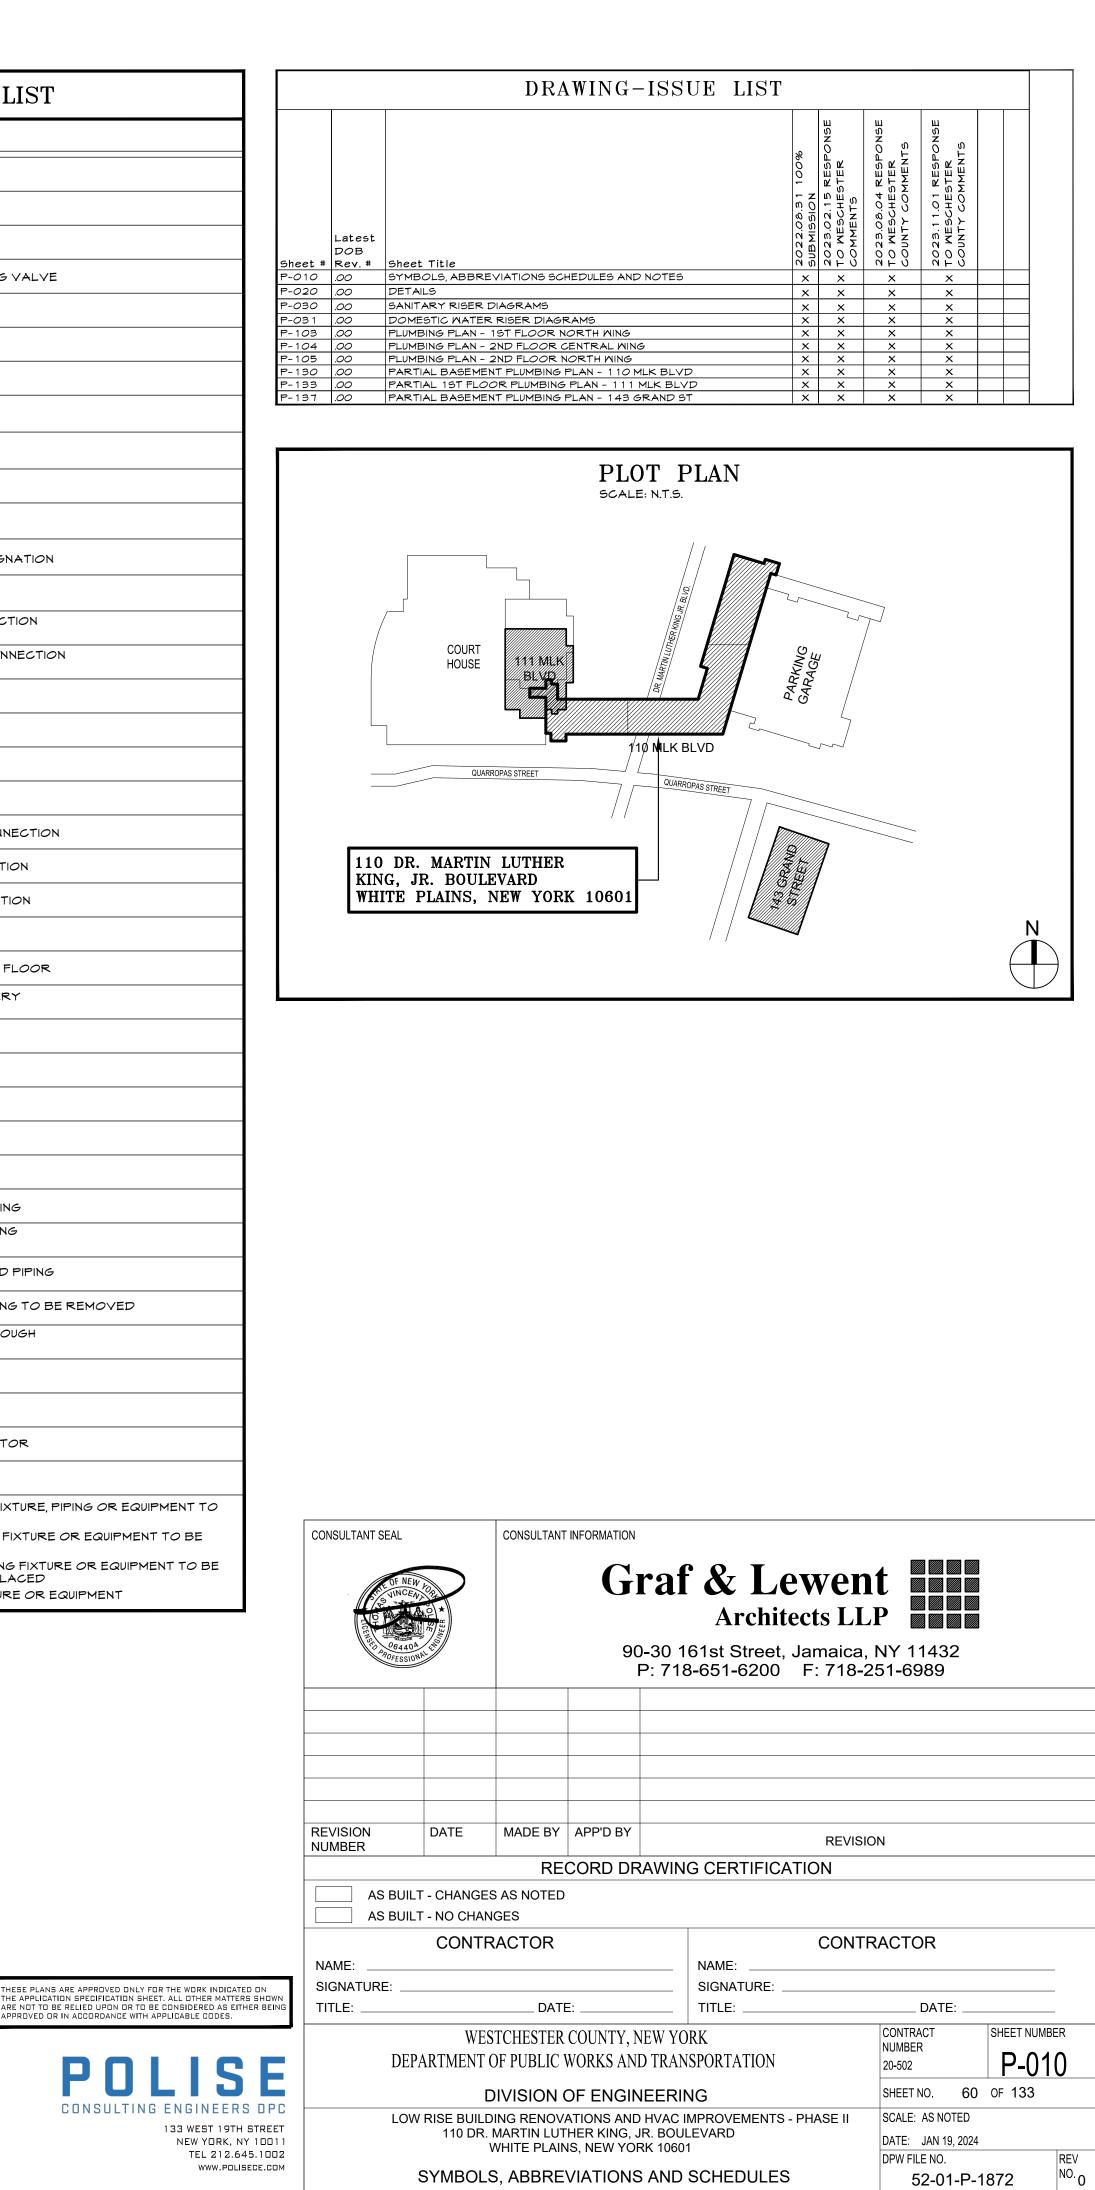


SYMBOLS, ABBREVIATIONS AND SCHEDULES

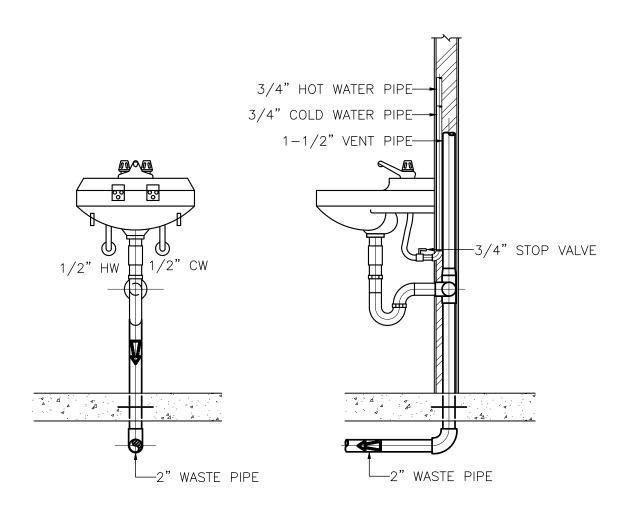

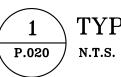



TYPICAL LAVATORY PLUMBING CONNECTION DETAIL

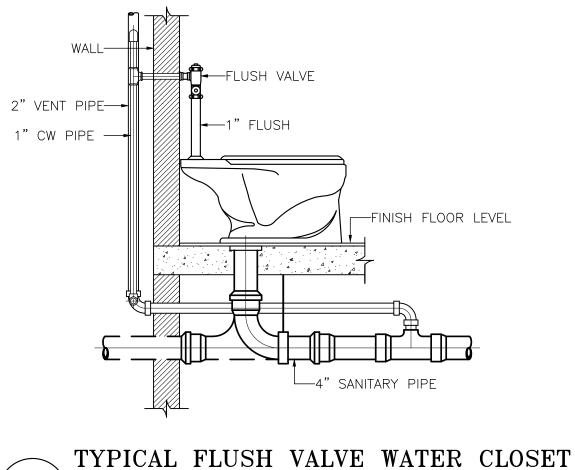





PLUMBING CONNECTION DETAIL N.T.S.

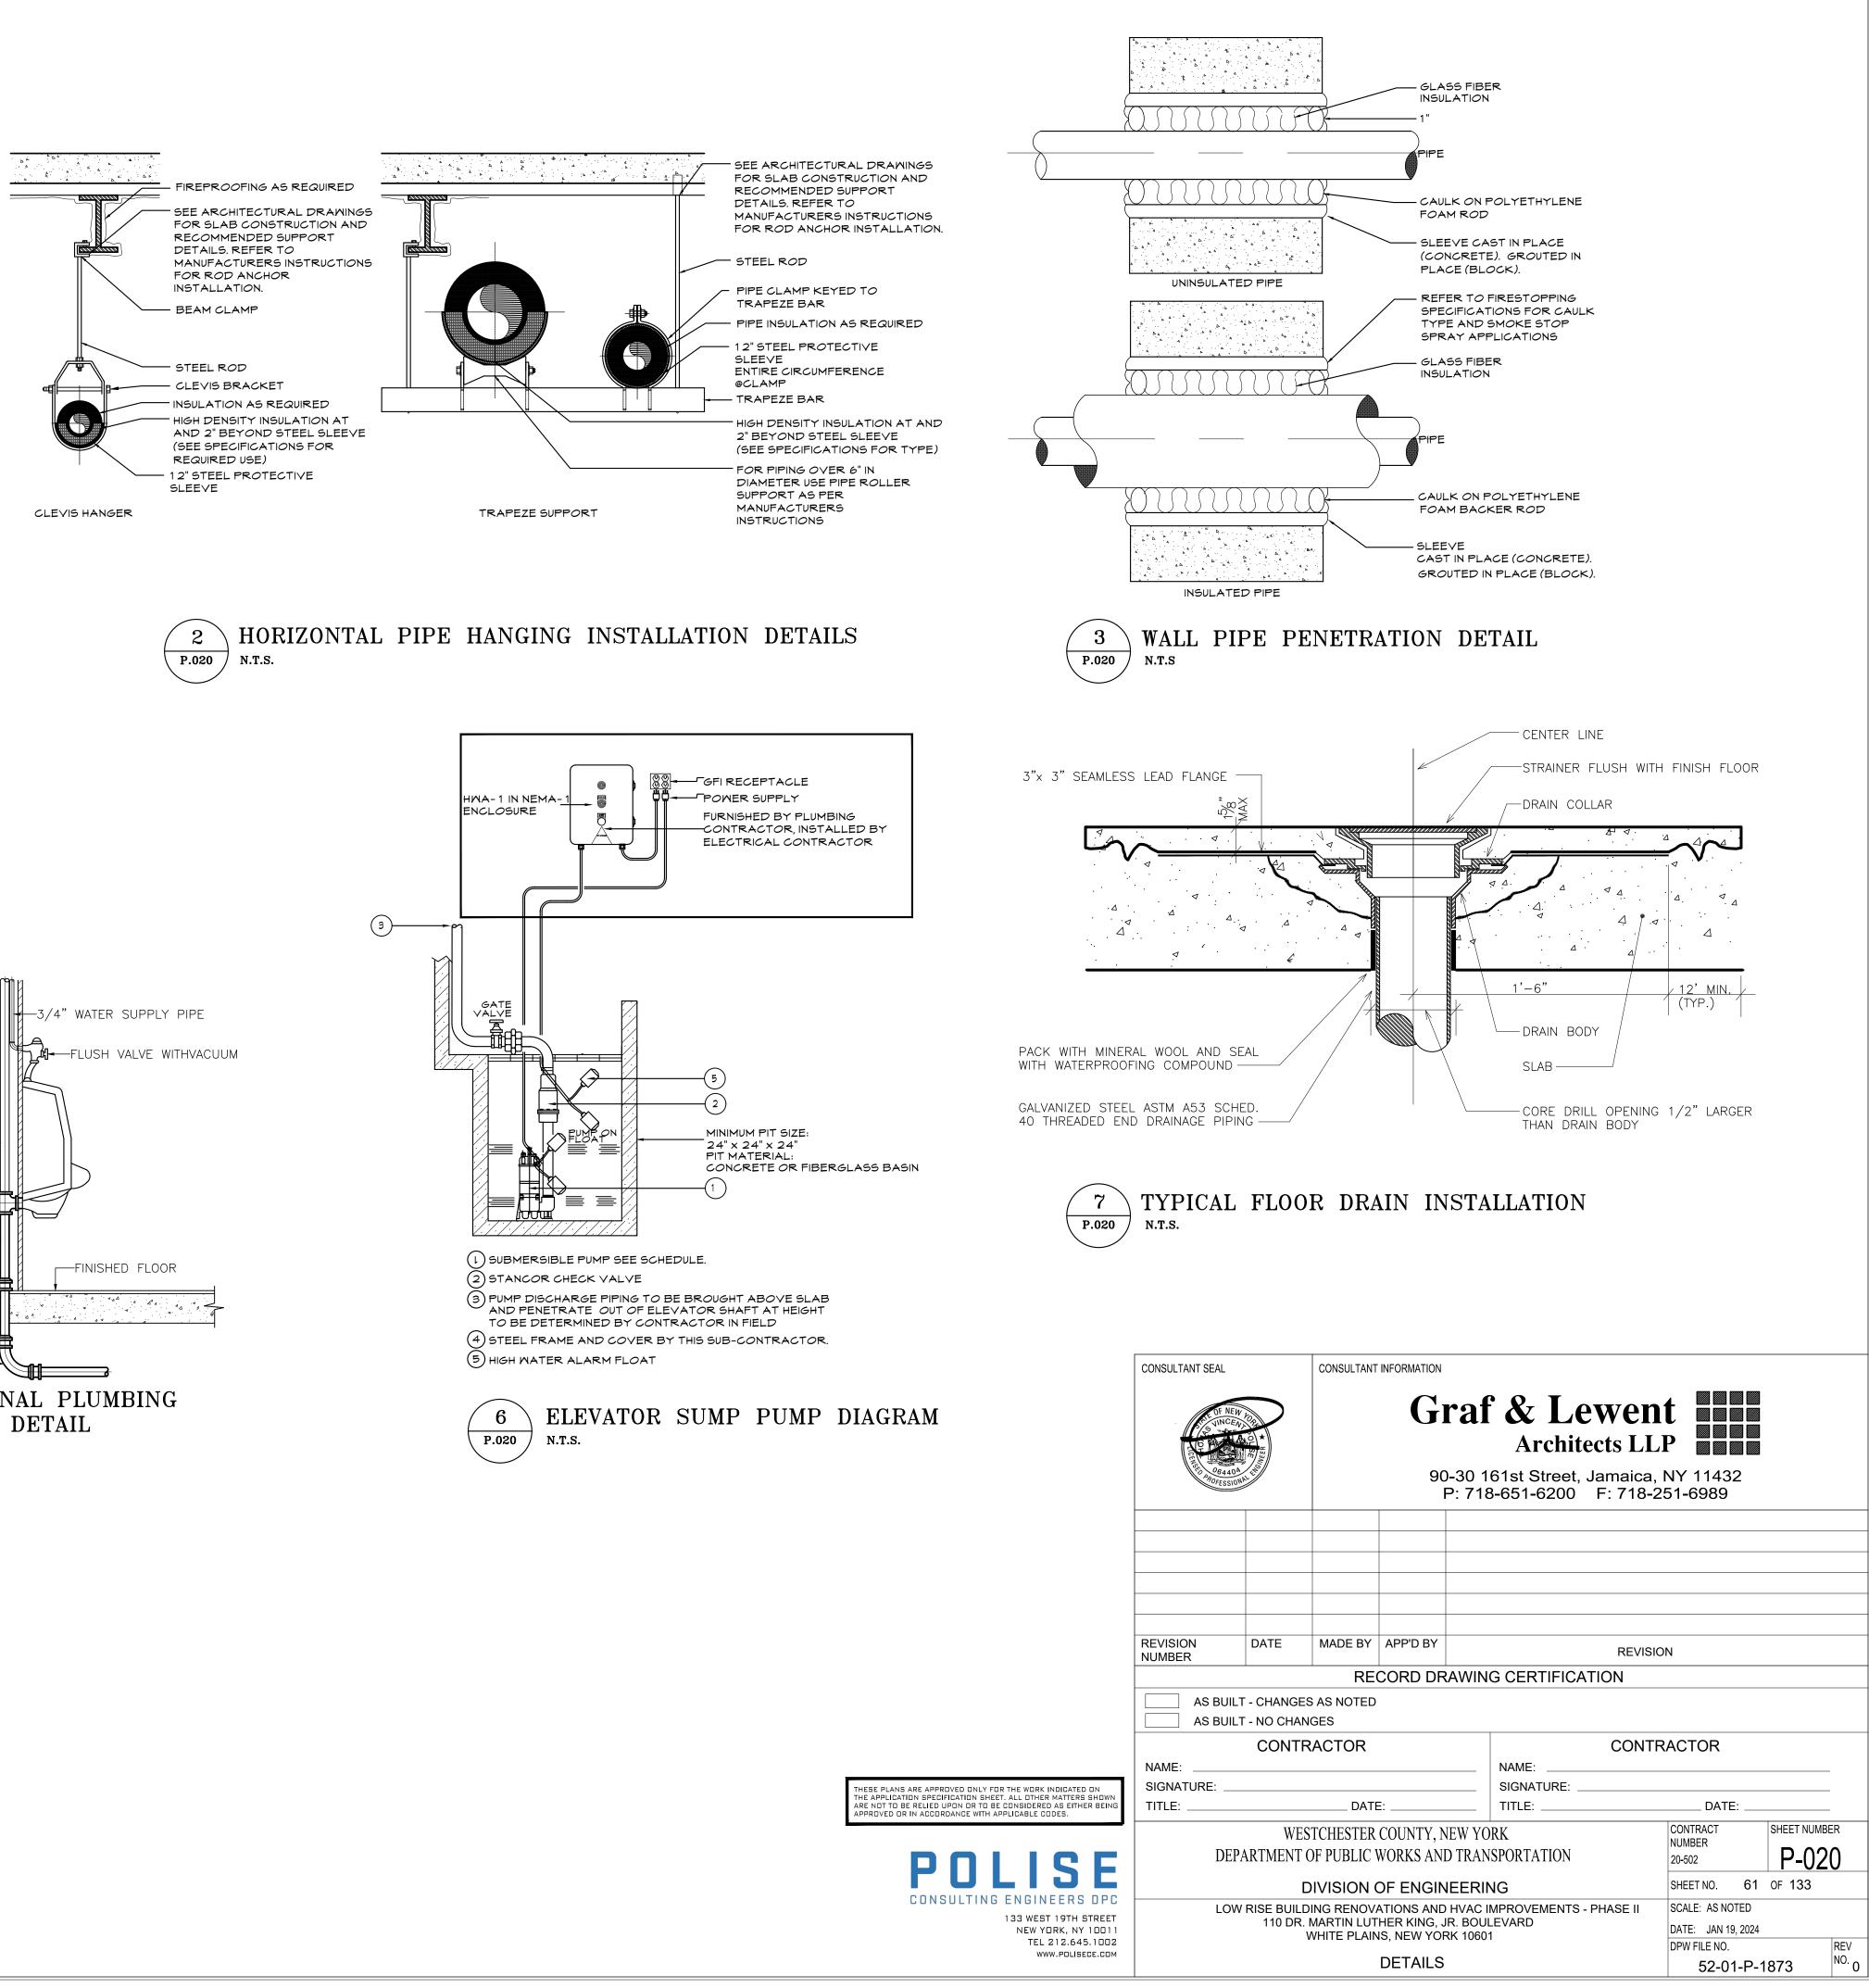


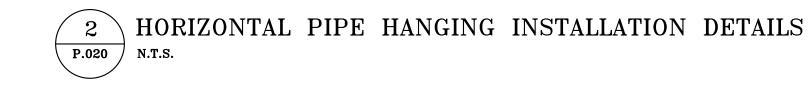

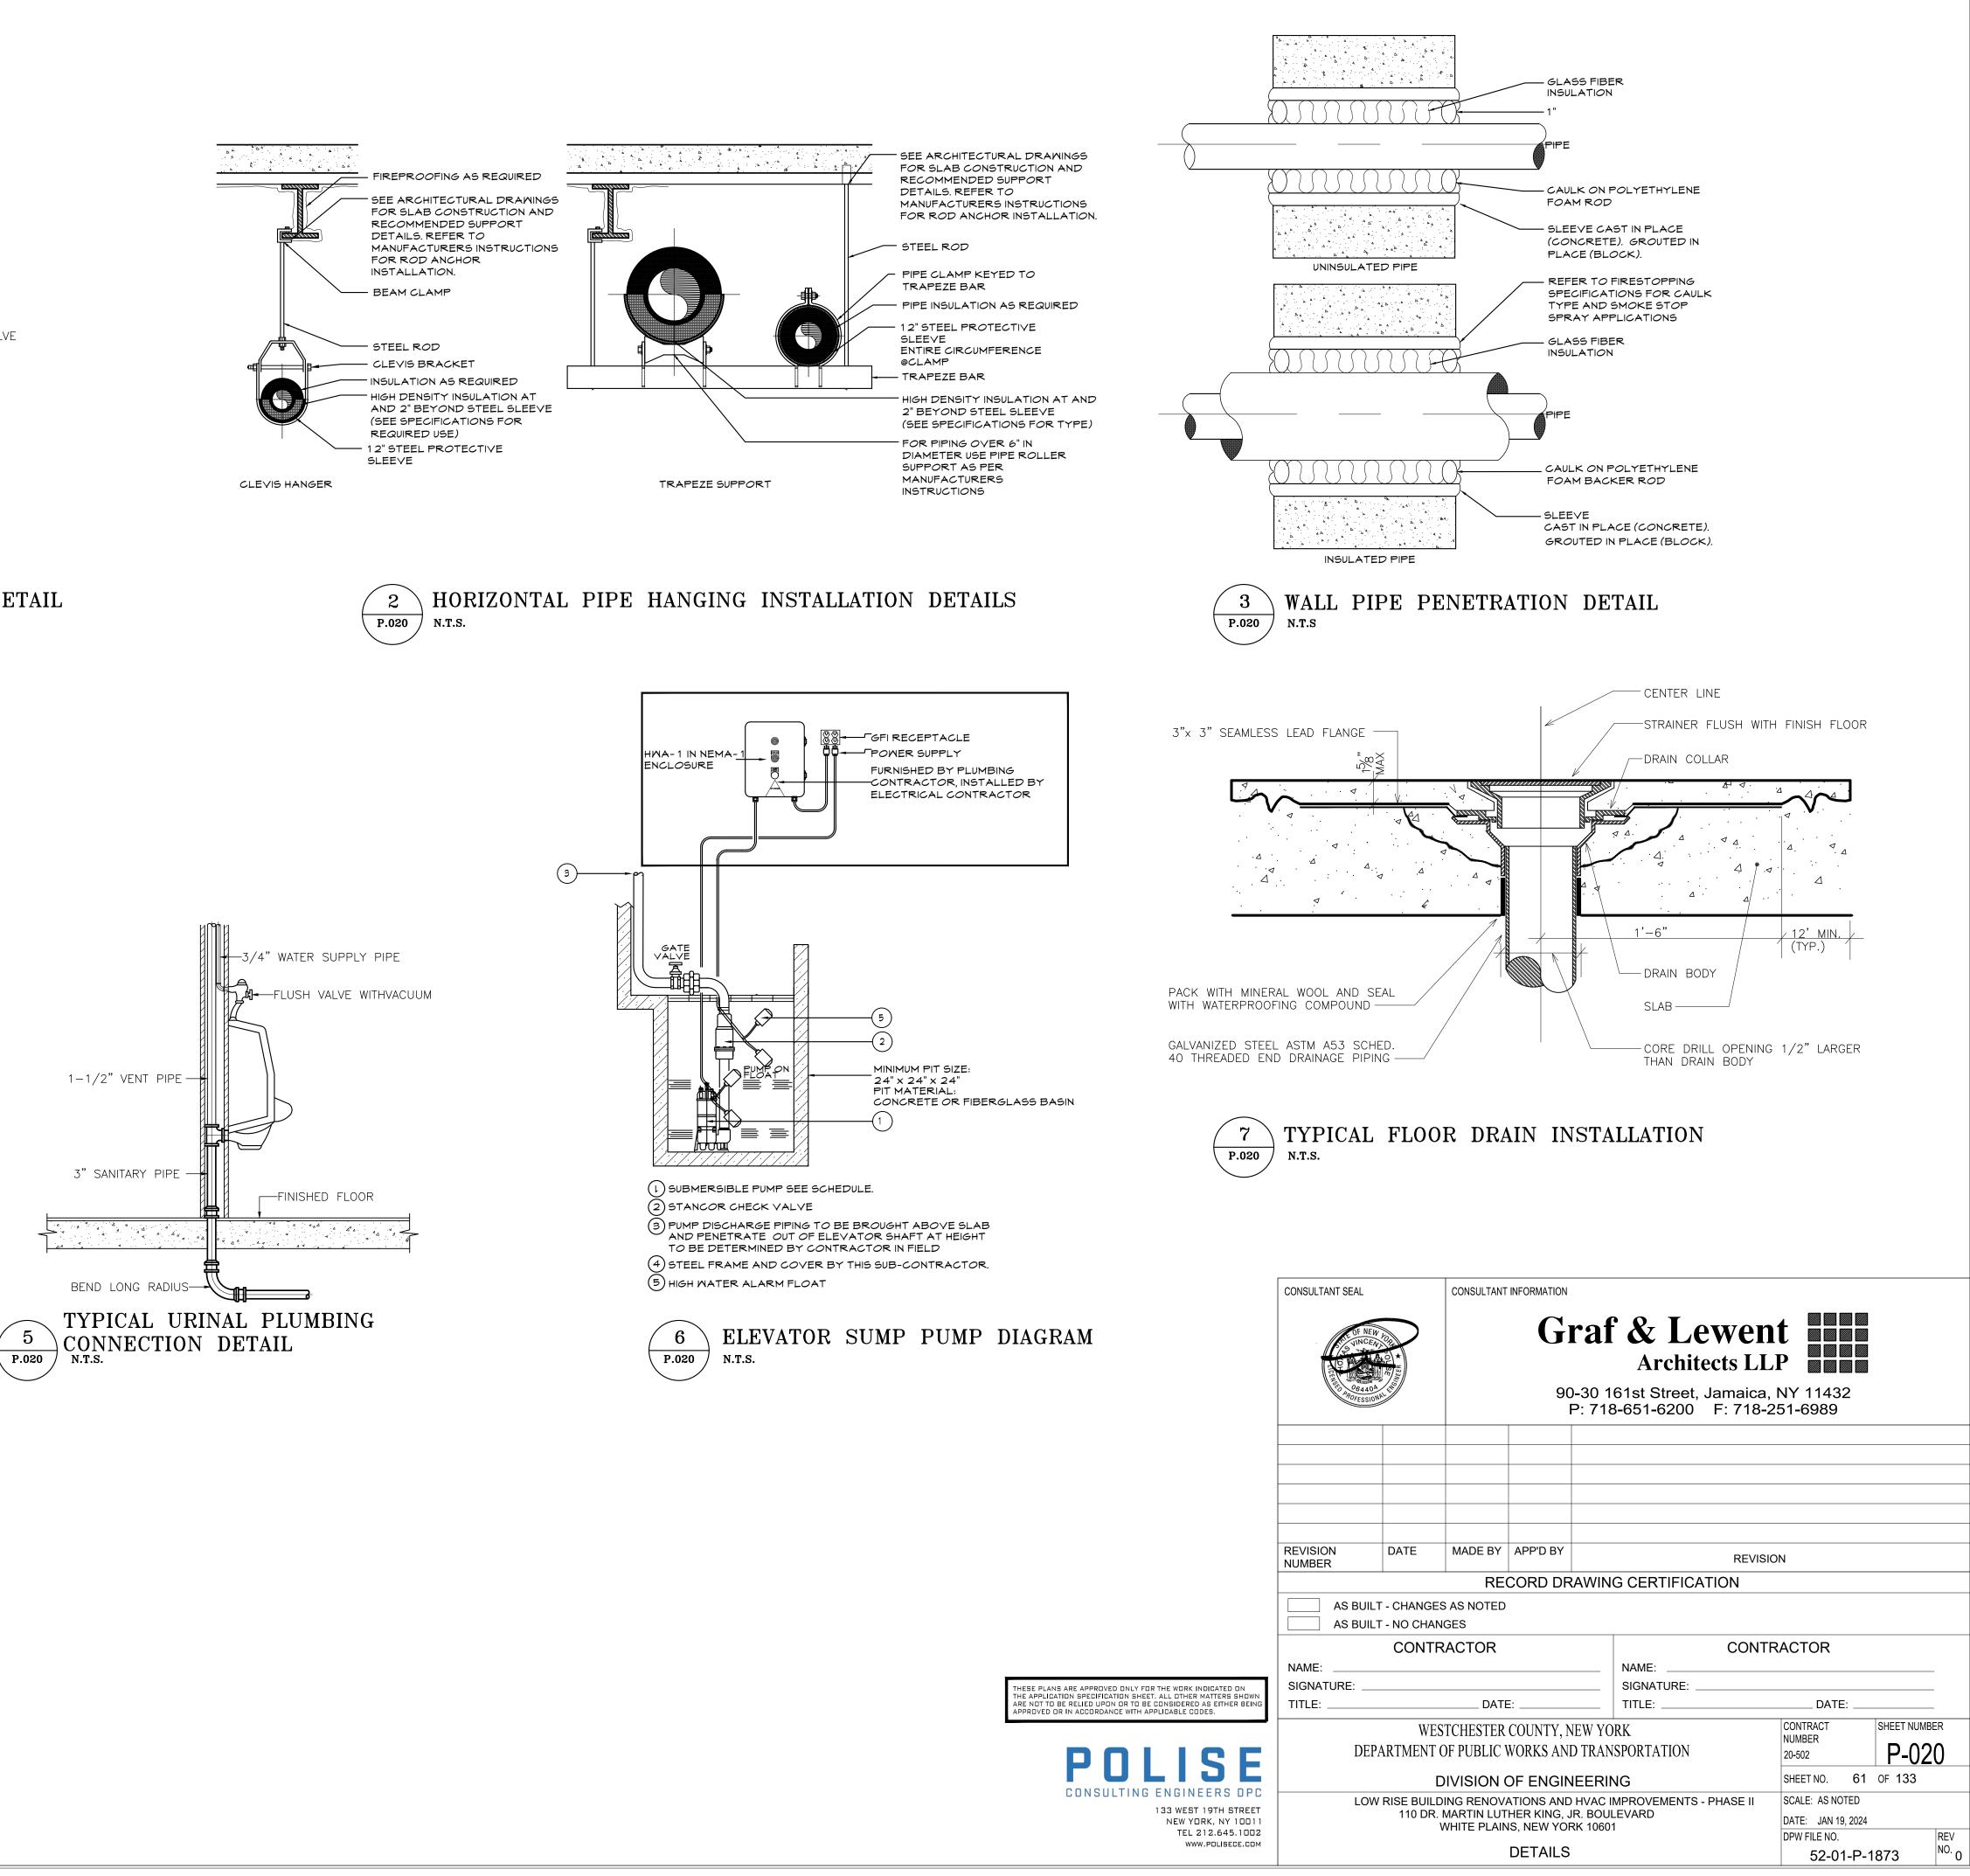


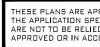





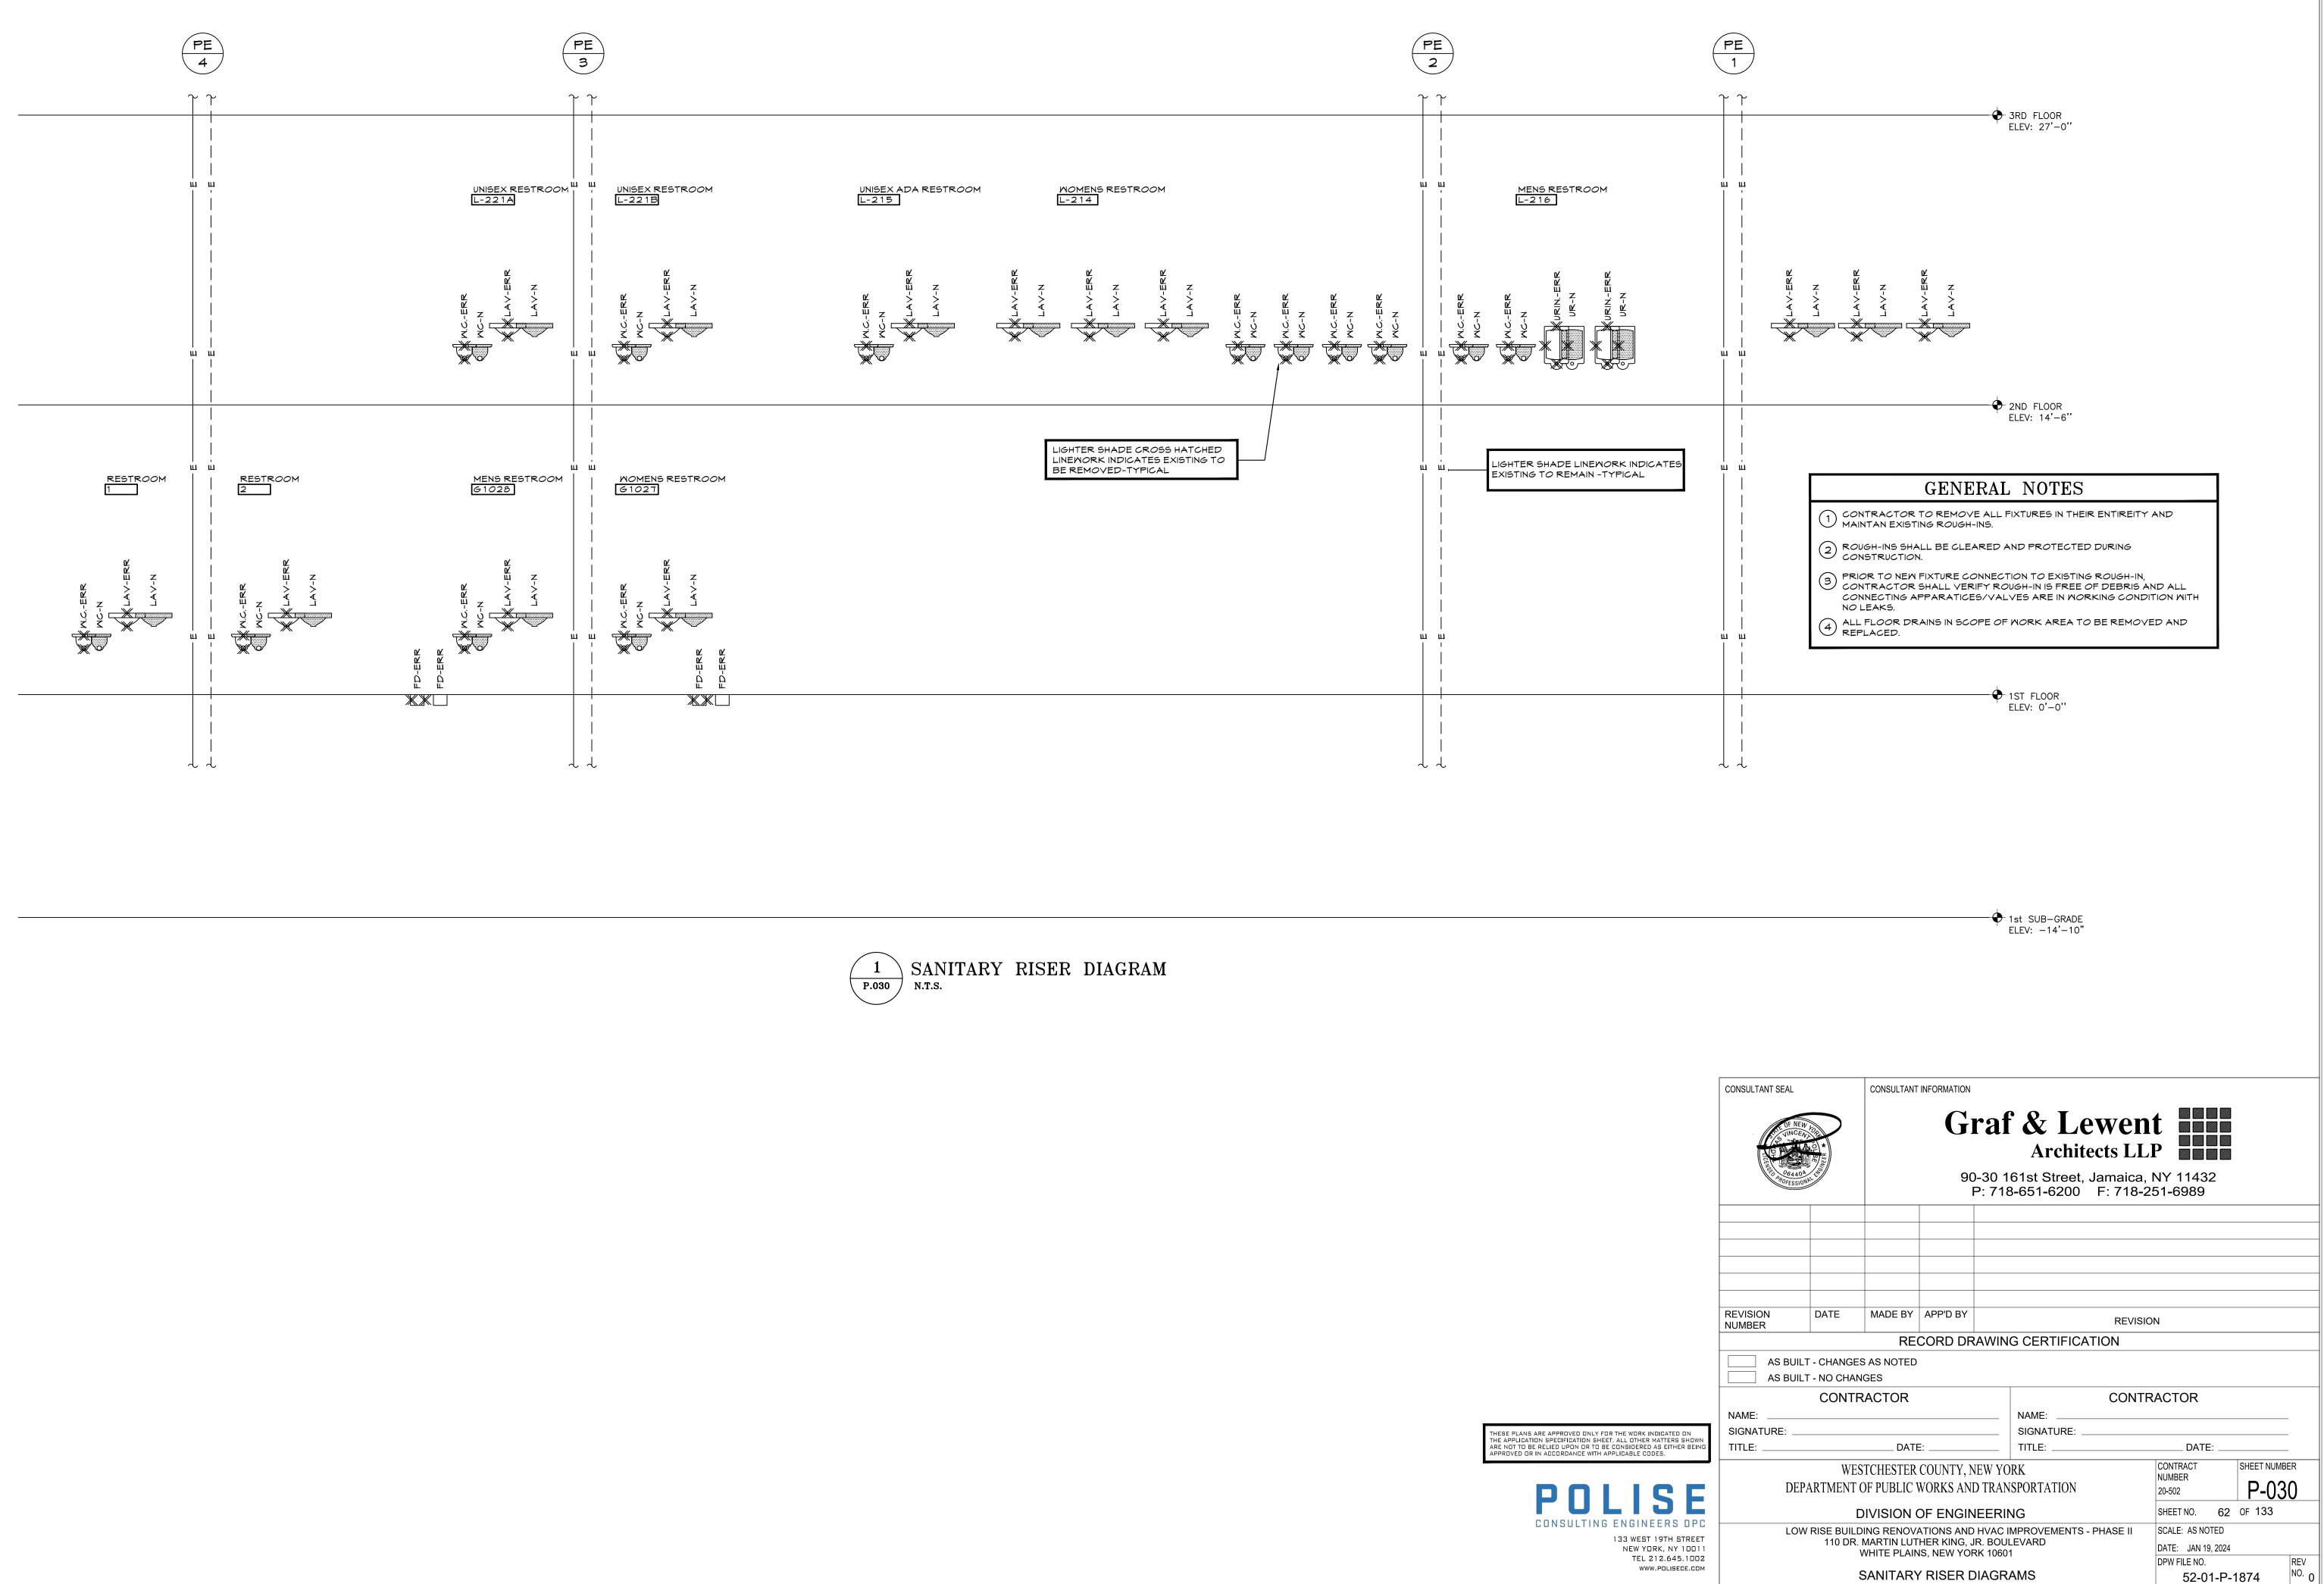




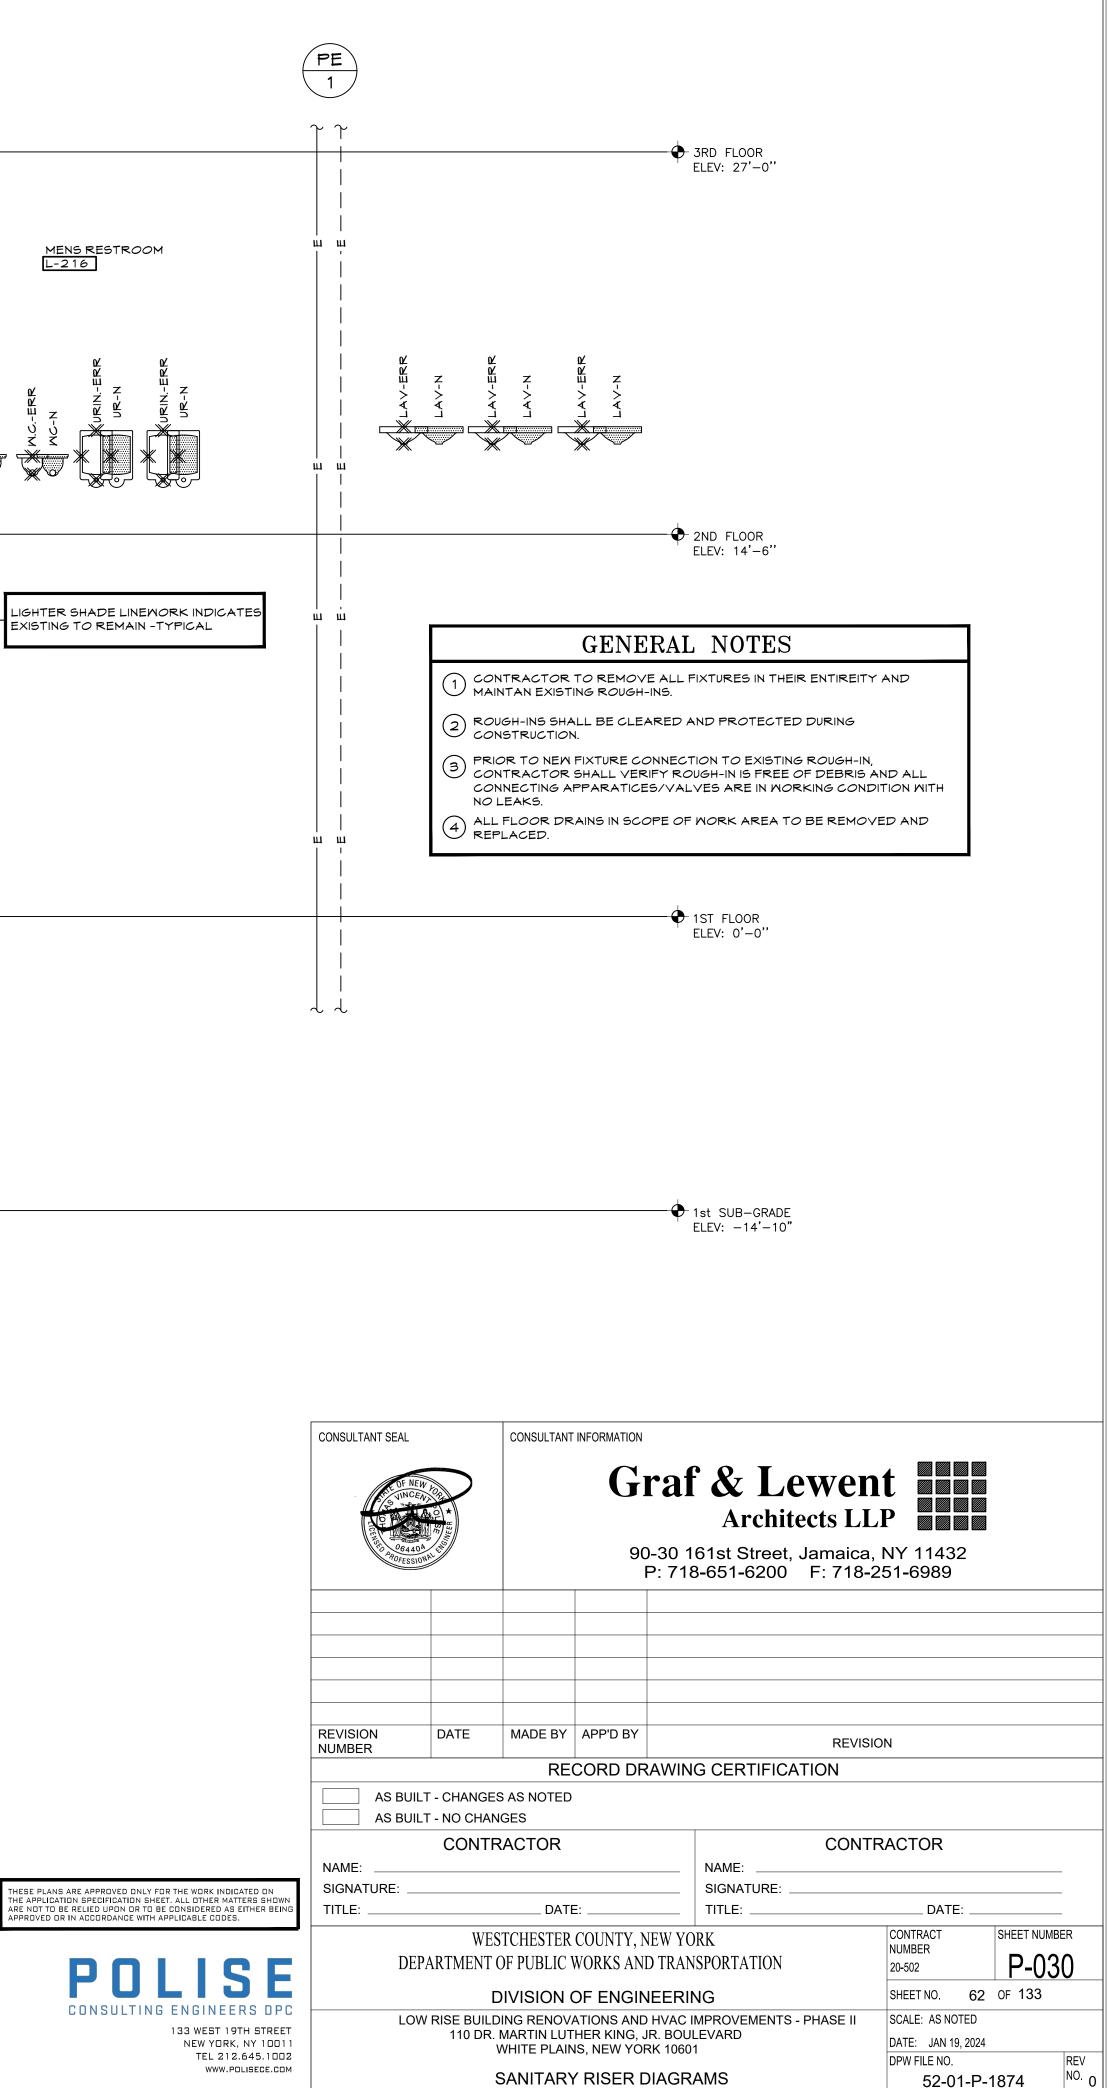


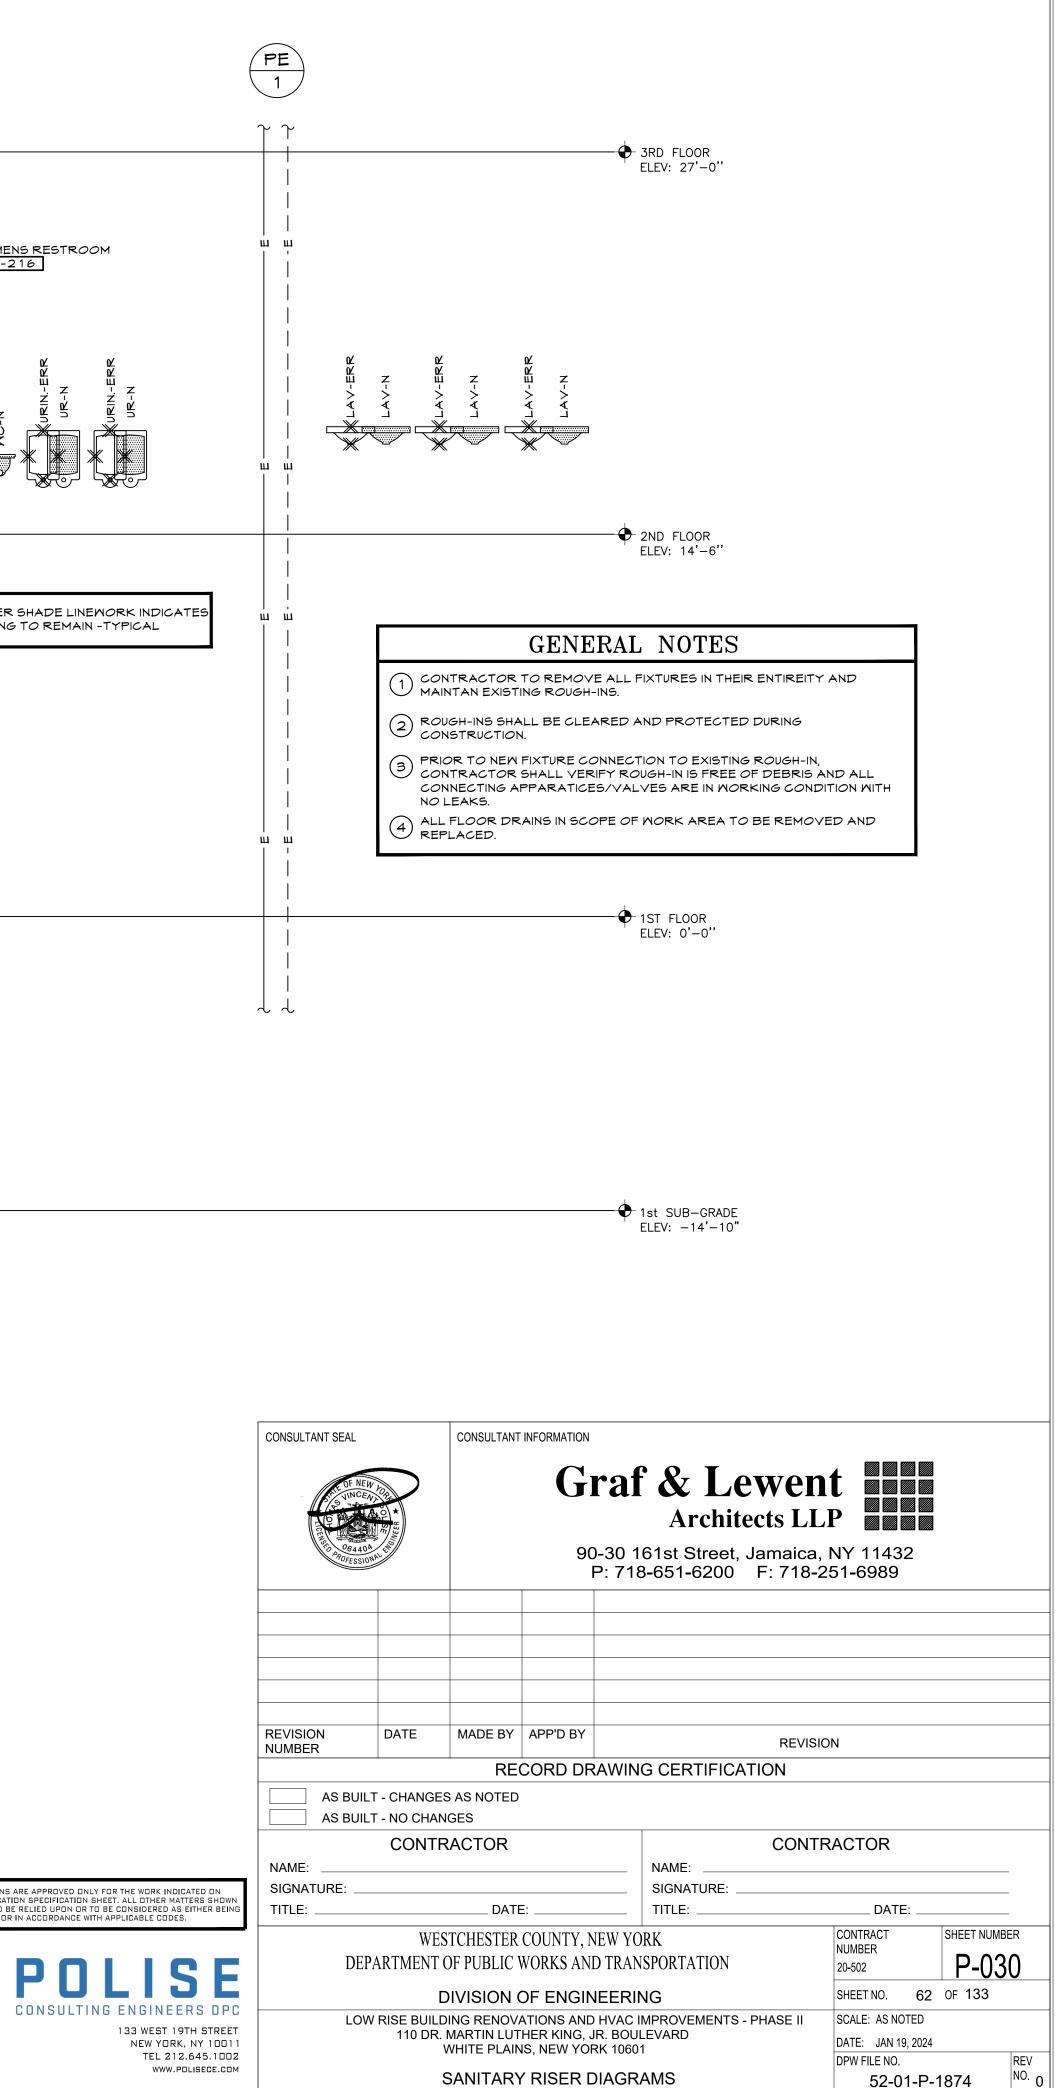


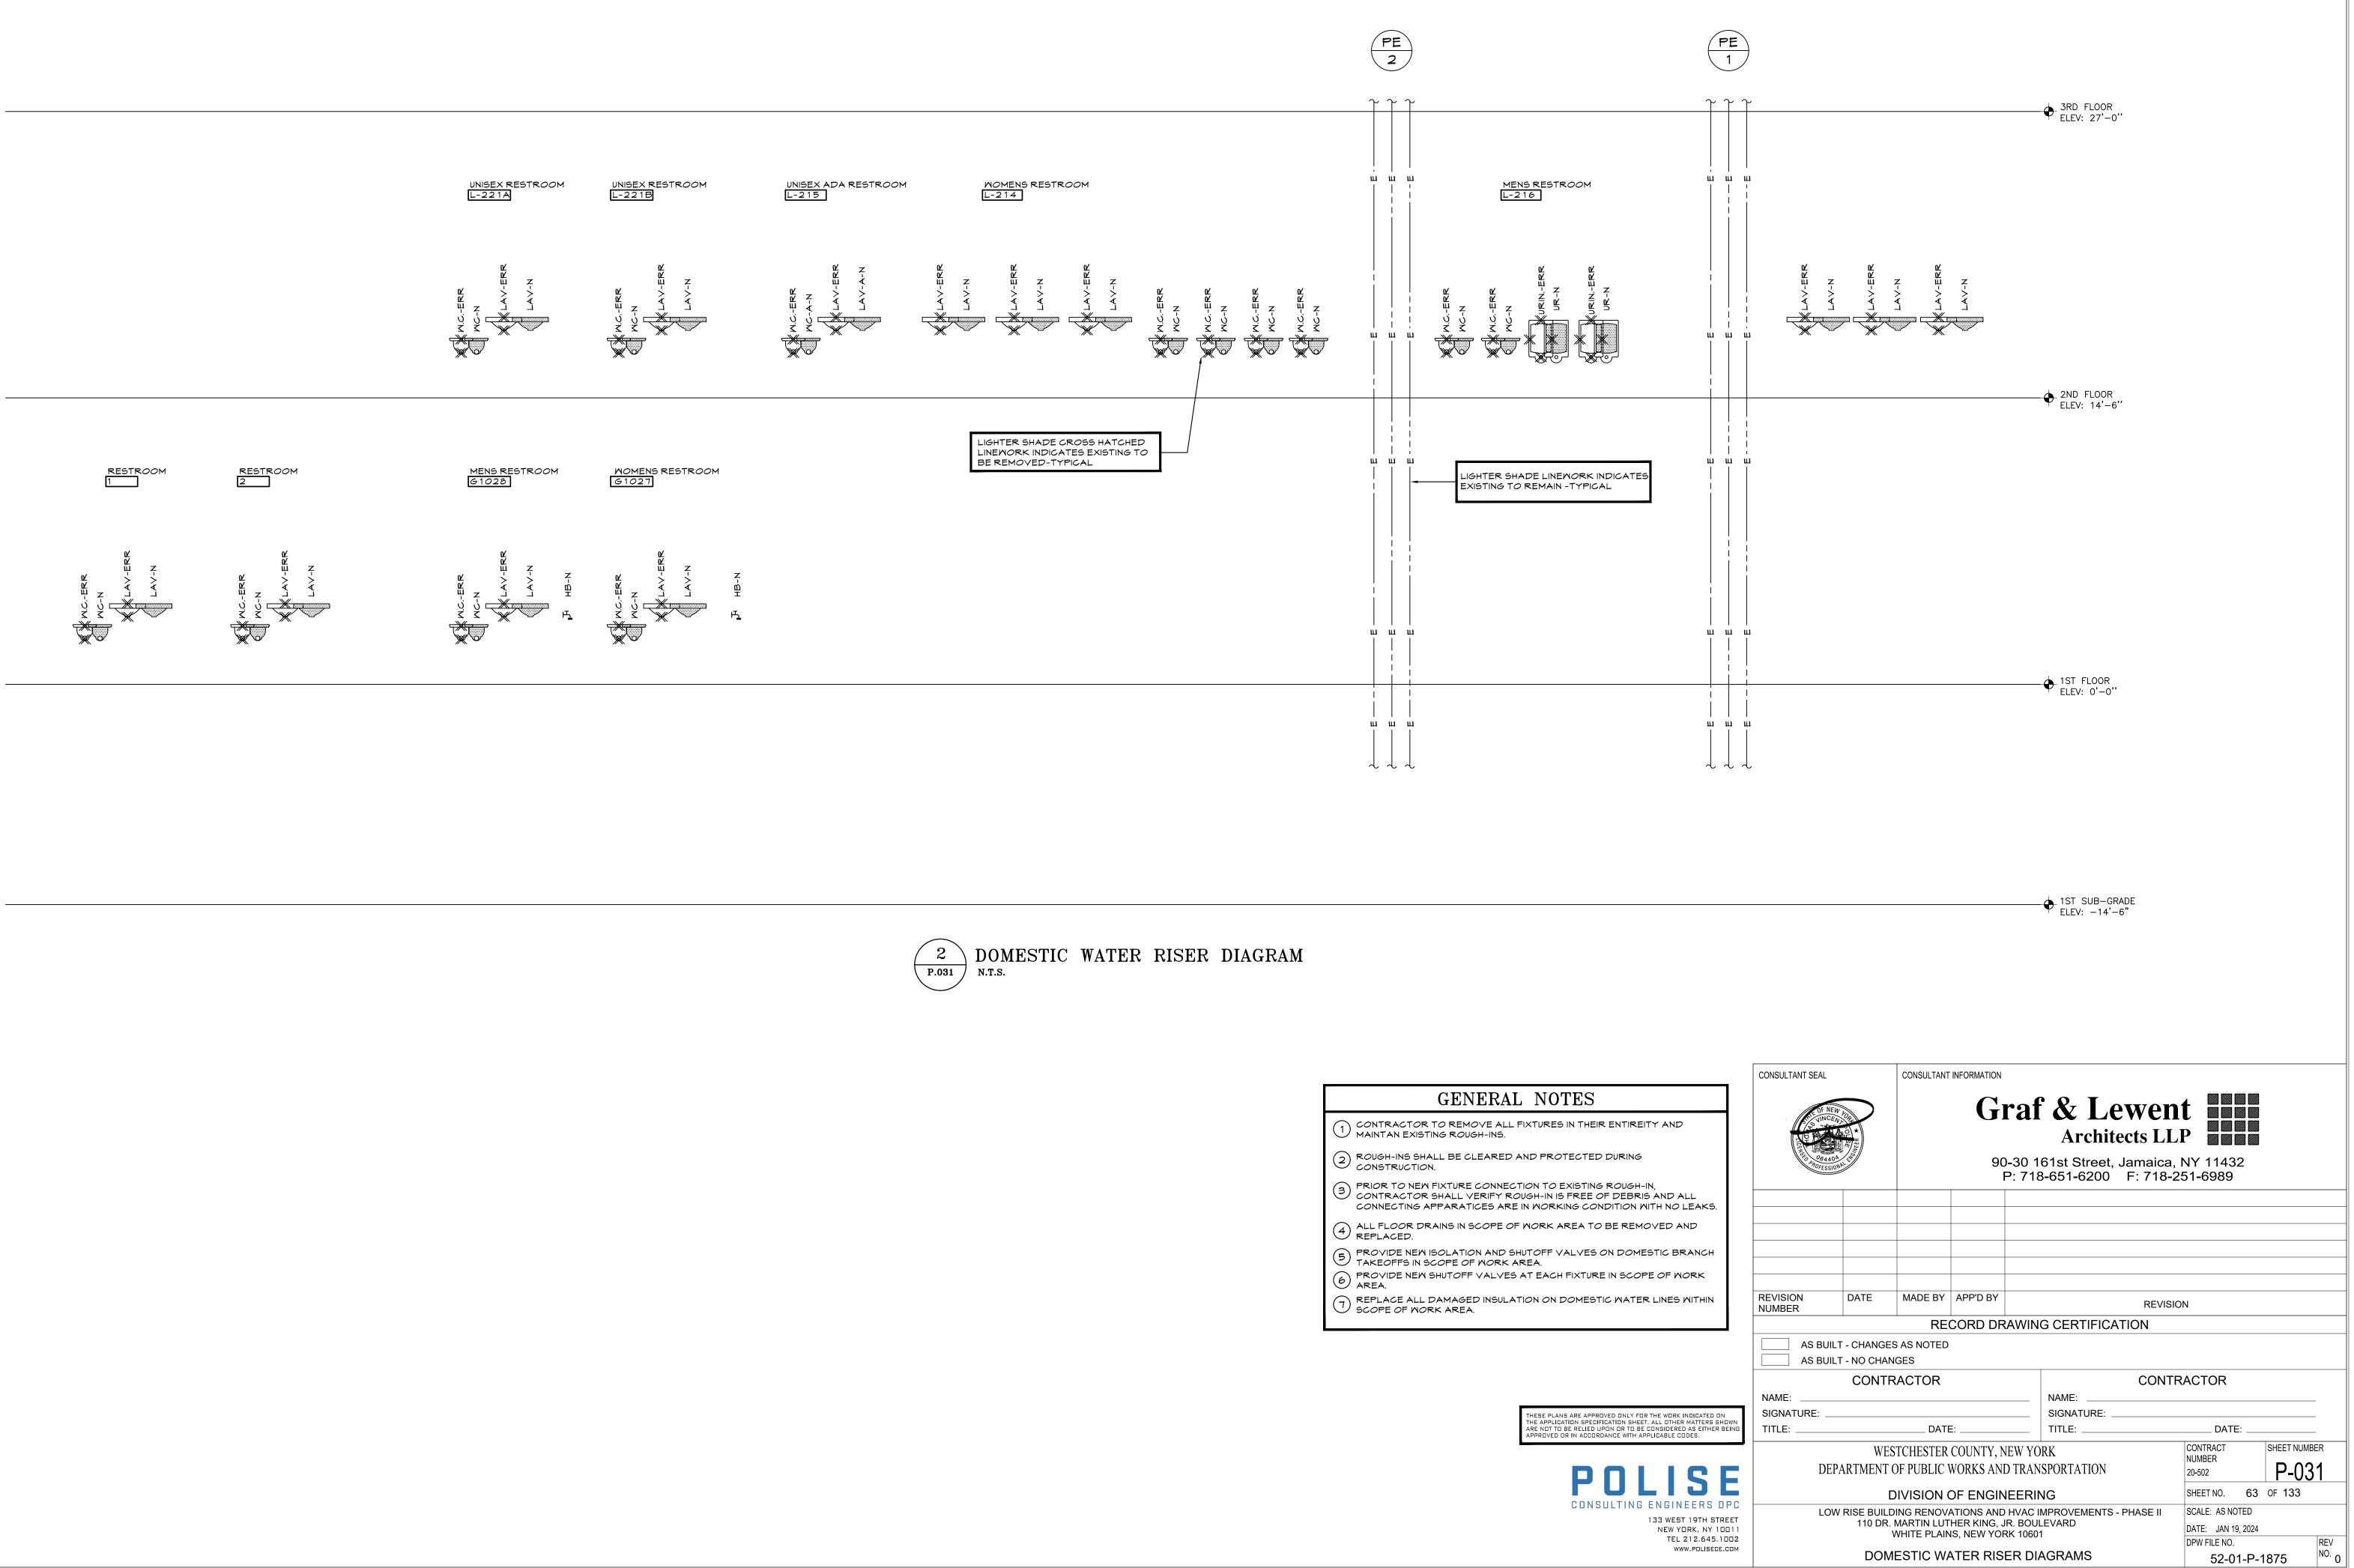



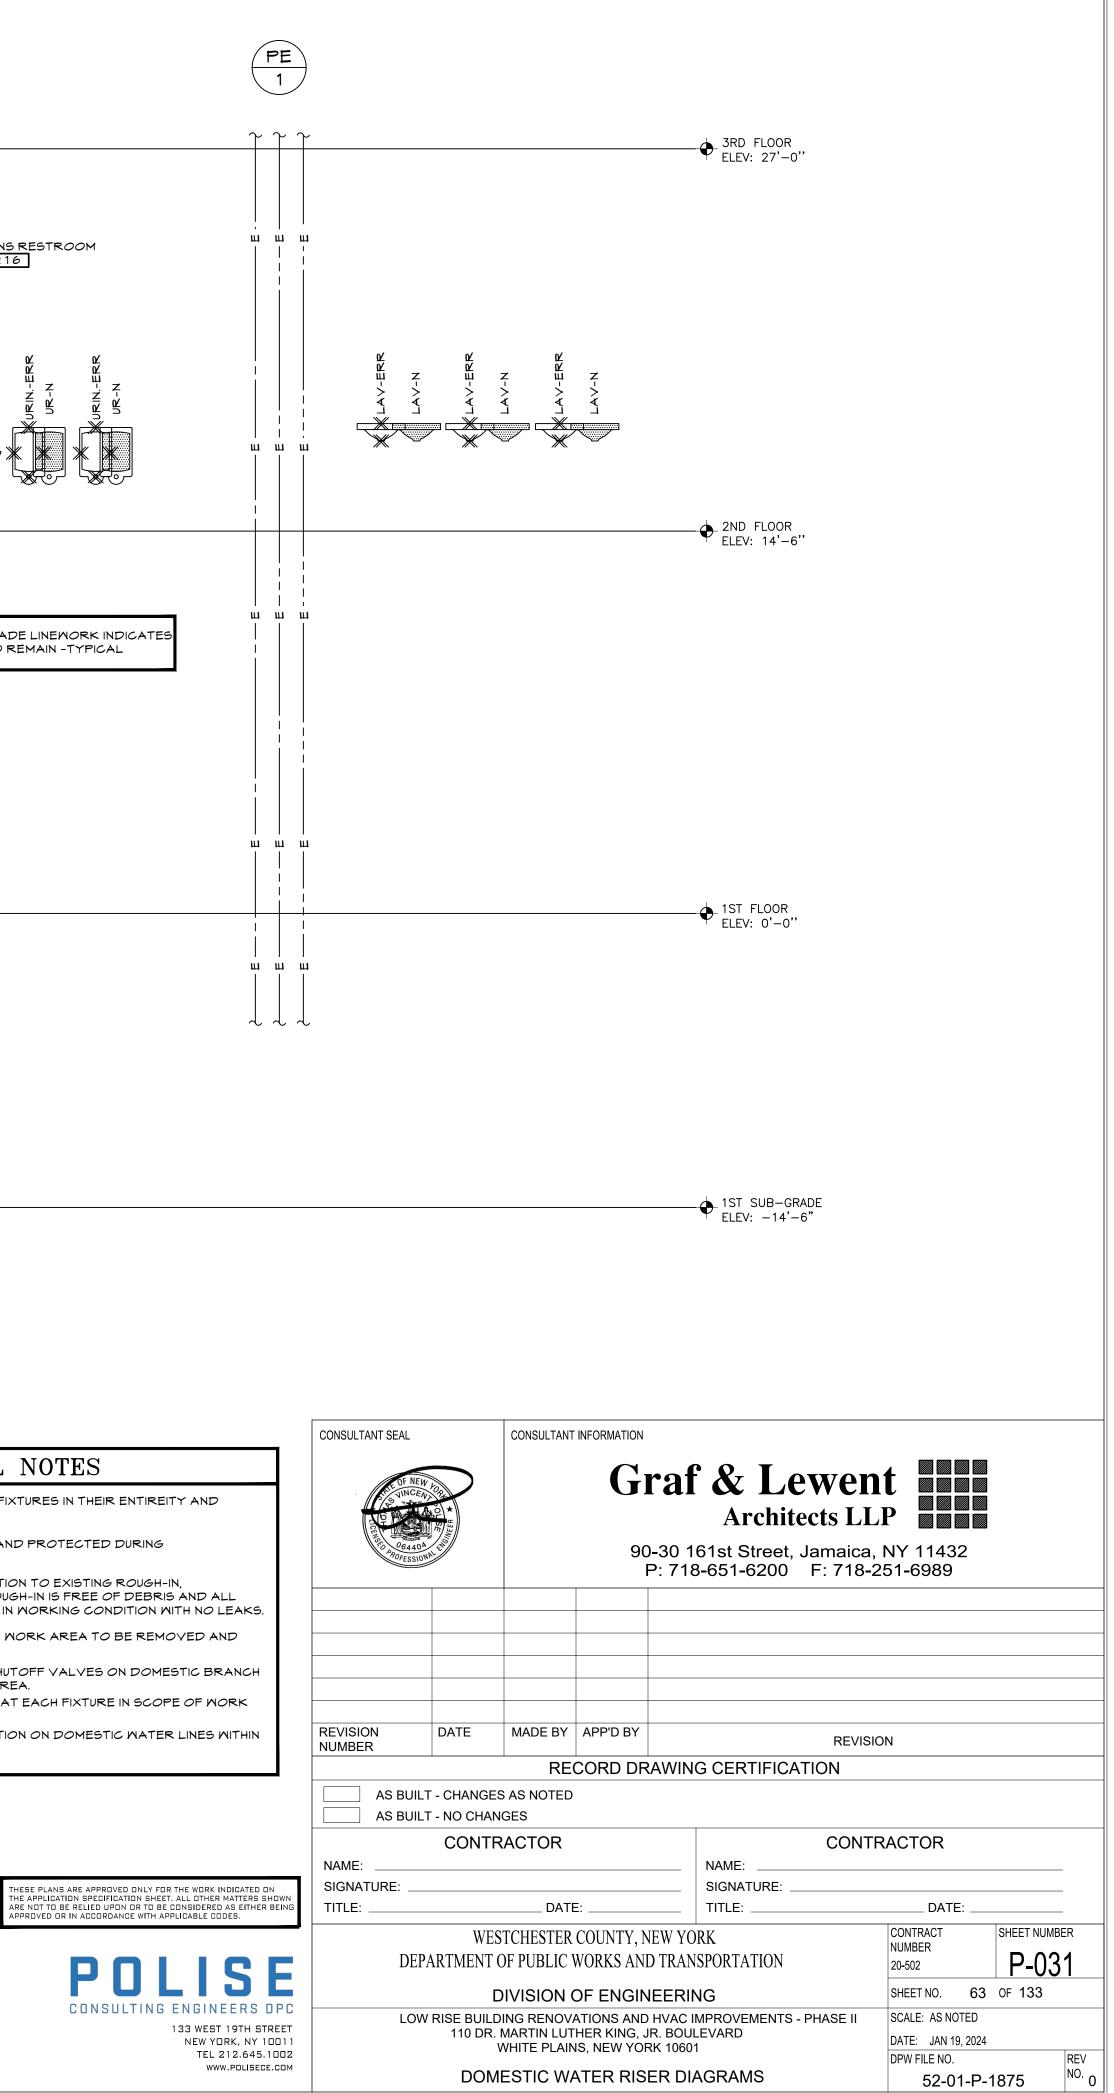

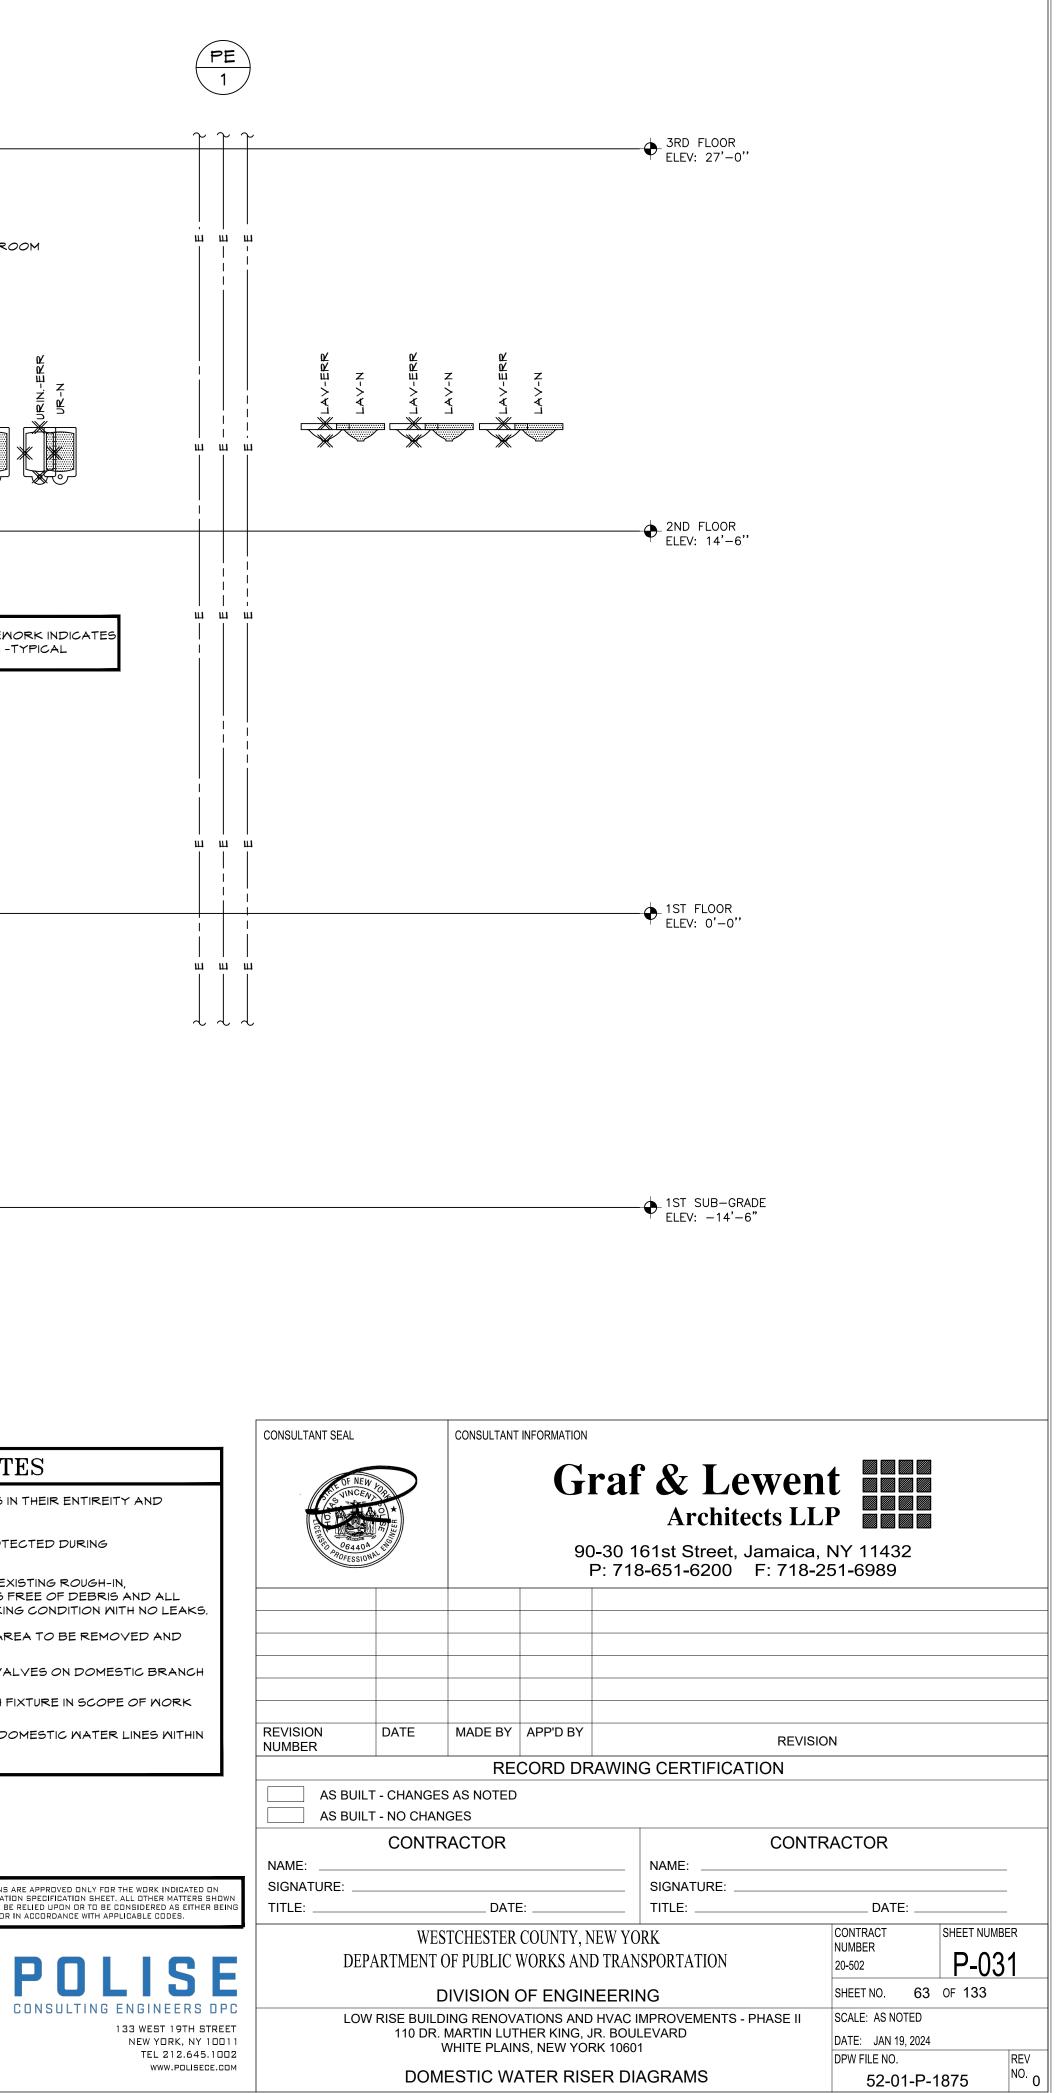

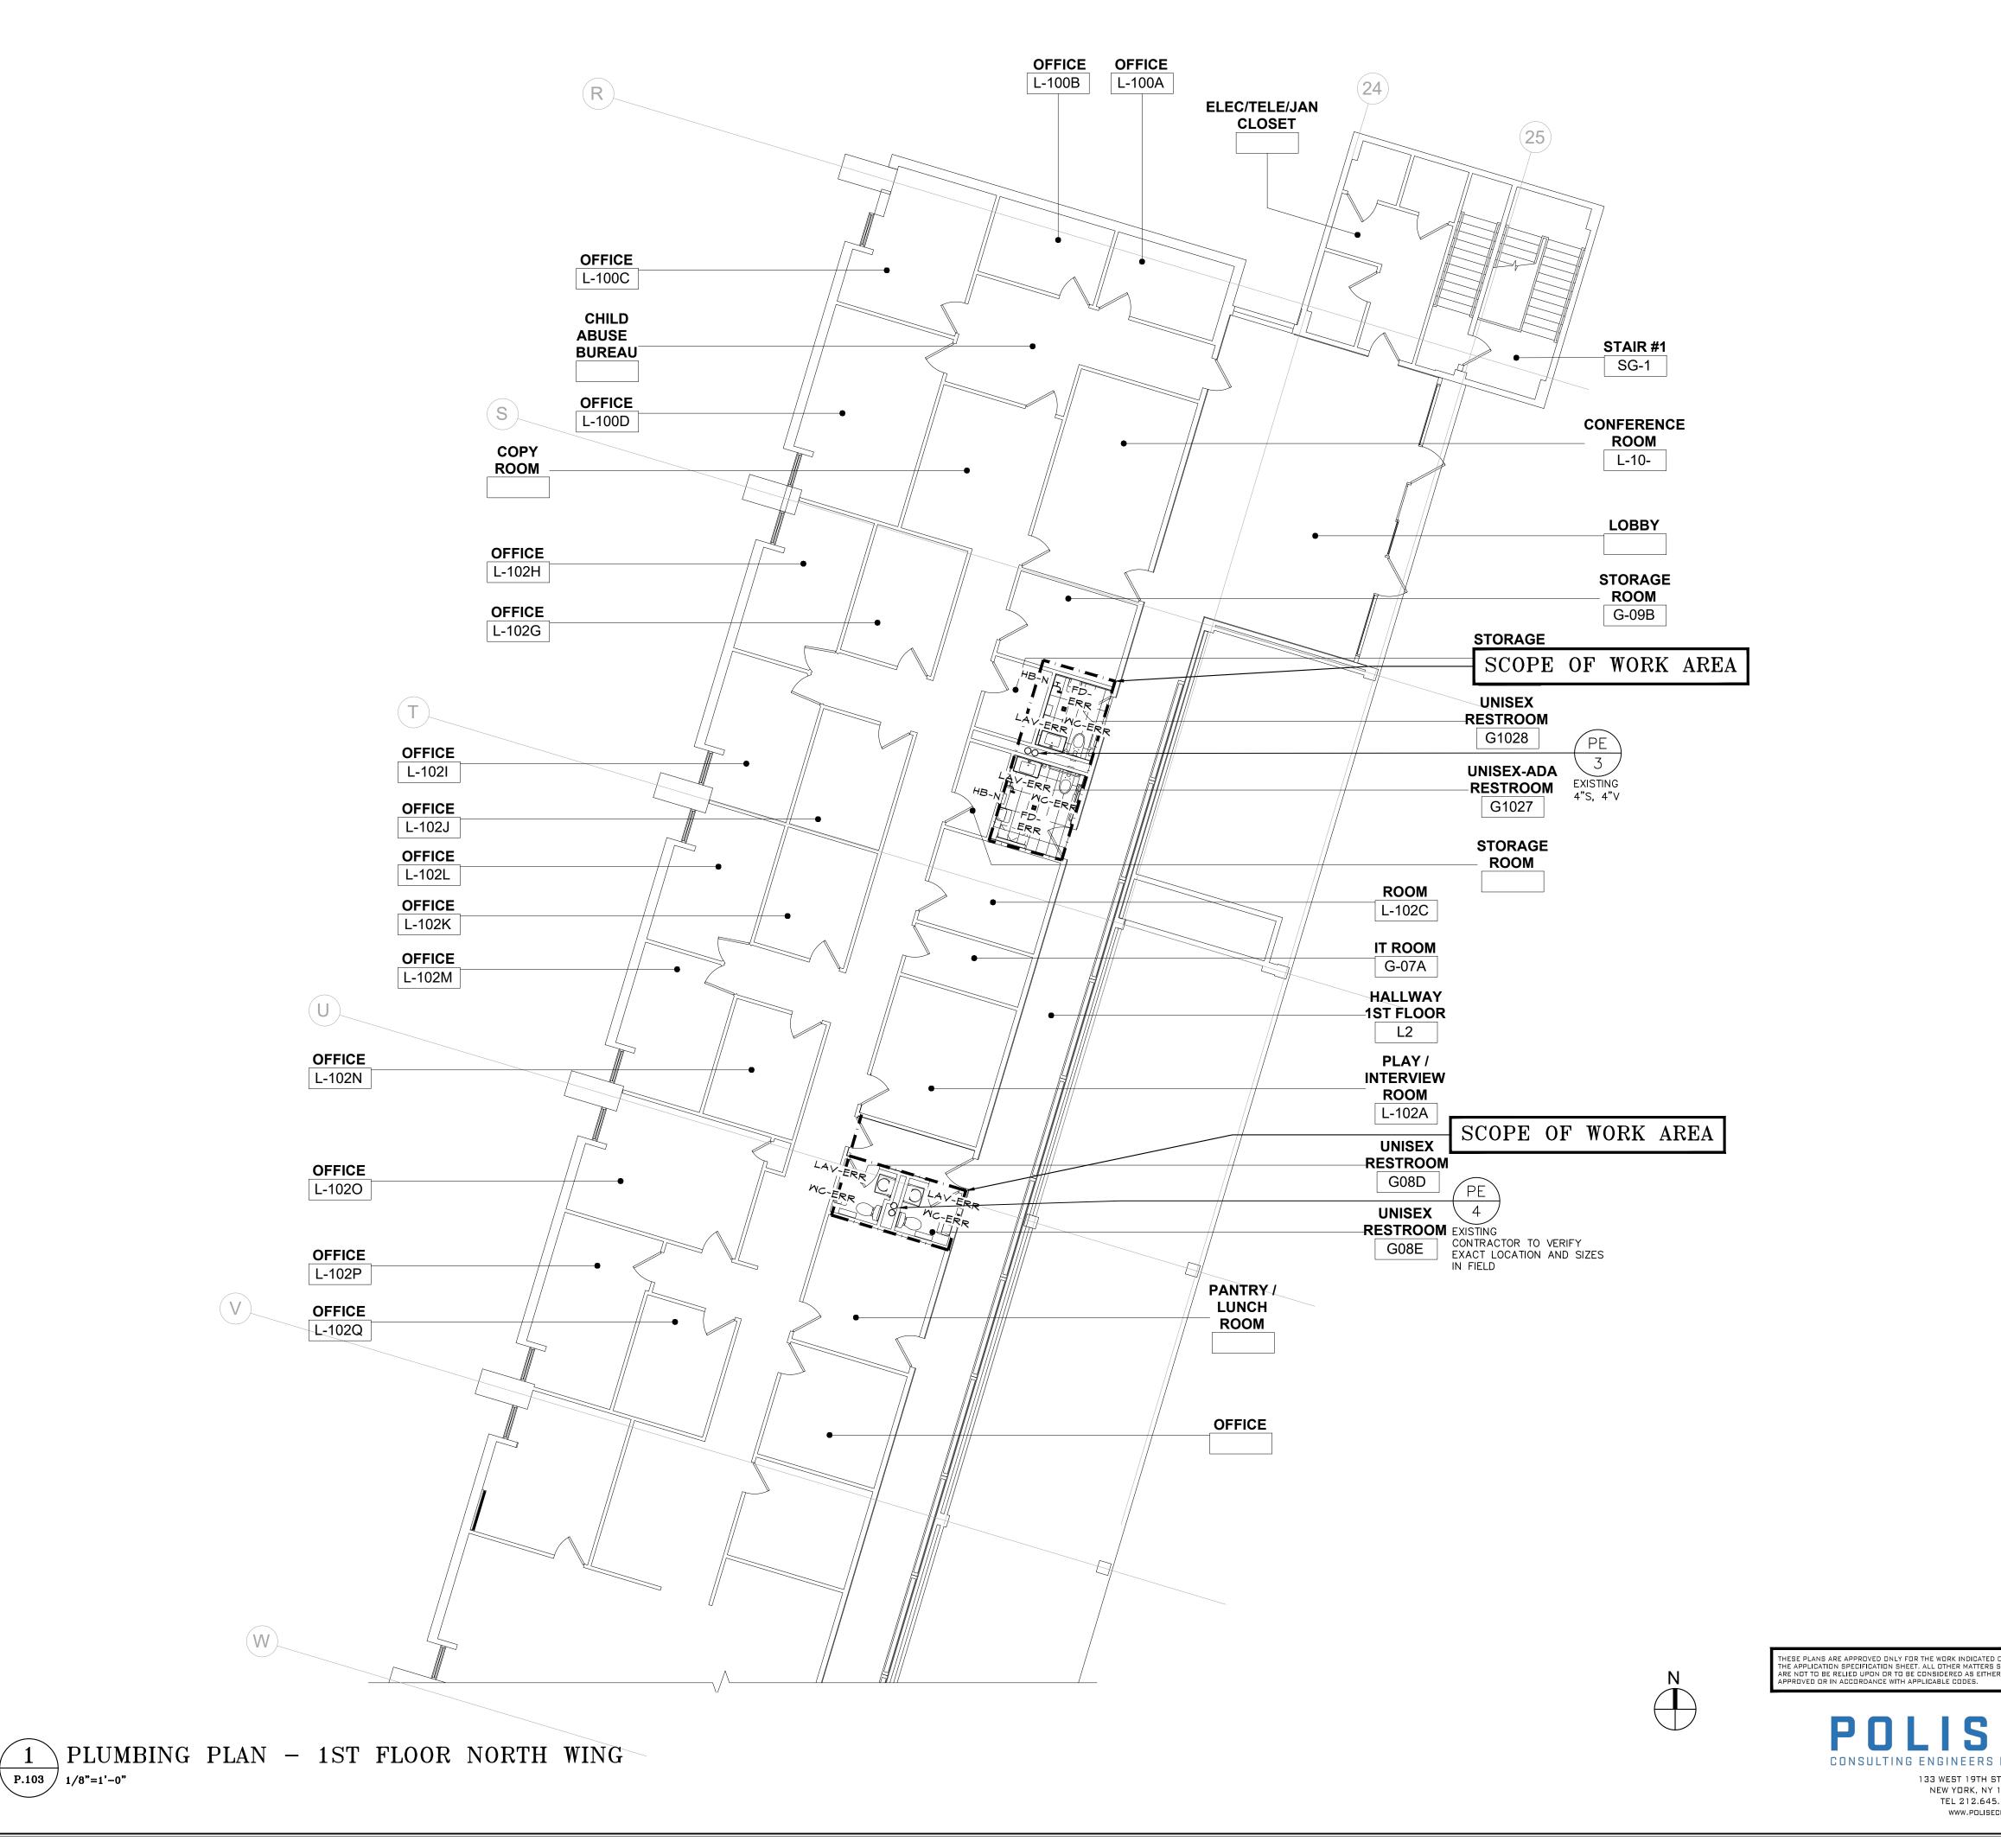



GENERAL NOTES

 \bigcirc Contractor to remove all fixtures in their entireity and maintan existing ROUGH-INS.

2 ROUGH-INS SHALL BE CLEARED AND PROTECTED DURING CONSTRUCTION.

3 PRIOR TO NEW FIXTURE CONNECTION TO EXISTING ROUGH-IN, CONTRACTOR SHALL VERIFY ROUGH-IN IS FREE OF DEBRIS AND ALL CONNECTING APPARATICES ARE IN WORKING CONDITION WITH NO LEAKS.

4 ALL FLOOR DRAINS IN SCOPE OF WORK AREA TO BE REMOVED AND REPLACED.

5 PROVIDE NEW ISOLATION AND SHUTOFF VALVES ON DOMESTIC BRANCH TAKEOFFS IN SCOPE OF WORK AREA.

6 PROVIDE NEW SHUTOFF VALVES AT EACH FIXTURE IN SCOPE OF WORK AREA.

REPLACE ALL DAMAGED INSULATION ON DOMESTIC WATER LINES WITHIN SCOPE OF WORK AREA.

8 RELOCATE OR EXTEND EXISTING PIPING AS REQUIRED.

	[110 MLK BLVD	143 GRAND STREET GARAGE GARAGE	7
CONSULTANT SEAL		CONSULTANT	INFORMATION		/ /	-	
CENTRAL CONTRAL CONTRA	OG440A Profession Profession Prof				Architects Ll 61st Street, Jamaica 8-651-6200 F: 718-	, NY 11432	
REVISION NUMBER	DATE	MADE BY			REVIS	SION	
				 WIN	IG CERTIFICATION		
	ILT - CHANGE						
SIGNATURE: _					NAME:		
Dl			COUNTY, NE WORKS AND		ORK NSPORTATION	CONTRACT NUMBER 20-502	SHEET NUMBER





GENERAL NOTES

1 Contractor to remove all fixtures in their entireity and maintan existing Rough-ins.

2 ROUGH-INS SHALL BE CLEARED AND PROTECTED DURING CONSTRUCTION.

PRIOR TO NEW FIXTURE CONNECTION TO EXISTING ROUGH-IN, CONTRACTOR SHALL VERIFY ROUGH-IN IS FREE OF DEBRIS AND ALL CONNECTING APPARATICES ARE IN WORKING CONDITION WITH NO LEAKS.

4 ALL FLOOR DRAINS IN SCOPE OF WORK AREA TO BE REMOVED AND REPLACED.


5 PROVIDE NEW ISOLATION AND SHUTOFF VALVES ON DOMESTIC BRANCH TAKEOFFS IN SCOPE OF WORK AREA.

6 PROVIDE NEW SHUTOFF VALVES AT EACH FIXTURE IN SCOPE OF WORK AREA.

REPLACE ALL DAMAGED INSULATION ON DOMESTIC WATER LINES WITHIN SCOPE OF WORK AREA.

8 RELOCATE OR EXTEND EXISTING PIPING AS REQUIRED.

		P.1				0 MLK BLVD	STREET STREET GARAGE	
	CONSULTANT SEAL		90-30 161st Street, Ja			Architects LL	P 11432	
	REVISION	DATE	MADE BY	APP'D BY		REVISIC)N	
	NUMBER		RE		WIN	G CERTIFICATION		
		C- CHANGE						
		CONTR				CONTR	ACTOR	
	NAME:					NAME:		
DR THE WORK INDICATED ON ET. ALL OTHER MATTERS SHOWN E CONSIDERED AS EITHER BEING	SIGNATURE: TITLE:					SIGNATURE: TITLE:		
PPLICABLE CODES.				COUNTY, NE			CONTRACT	SHEET NUMBER
LISE	DEP.	ARTMENT (OF PUBLIC V	WORKS AND	ΓRAN	SPORTATION	NUMBER 20-502 SHEET NO. 65	P-104
ENGINEERS DPC 133 WEST 19TH STREET NEW YORK, NY 10011	LOW	RISE BUILD 110 DR.	ING RENOV	OF ENGINE ATIONS AND H HER KING, JR. IS, NEW YORK	VAC II BOUL	MPROVEMENTS - PHASE II LEVARD	SCALE: AS NOTED DATE: JAN 19, 2024	
TEL 212.645.1002 www.polisece.com	P					ITRAL WING	DPW FILE NO. 52-11-P-	1877 REV NO. 0

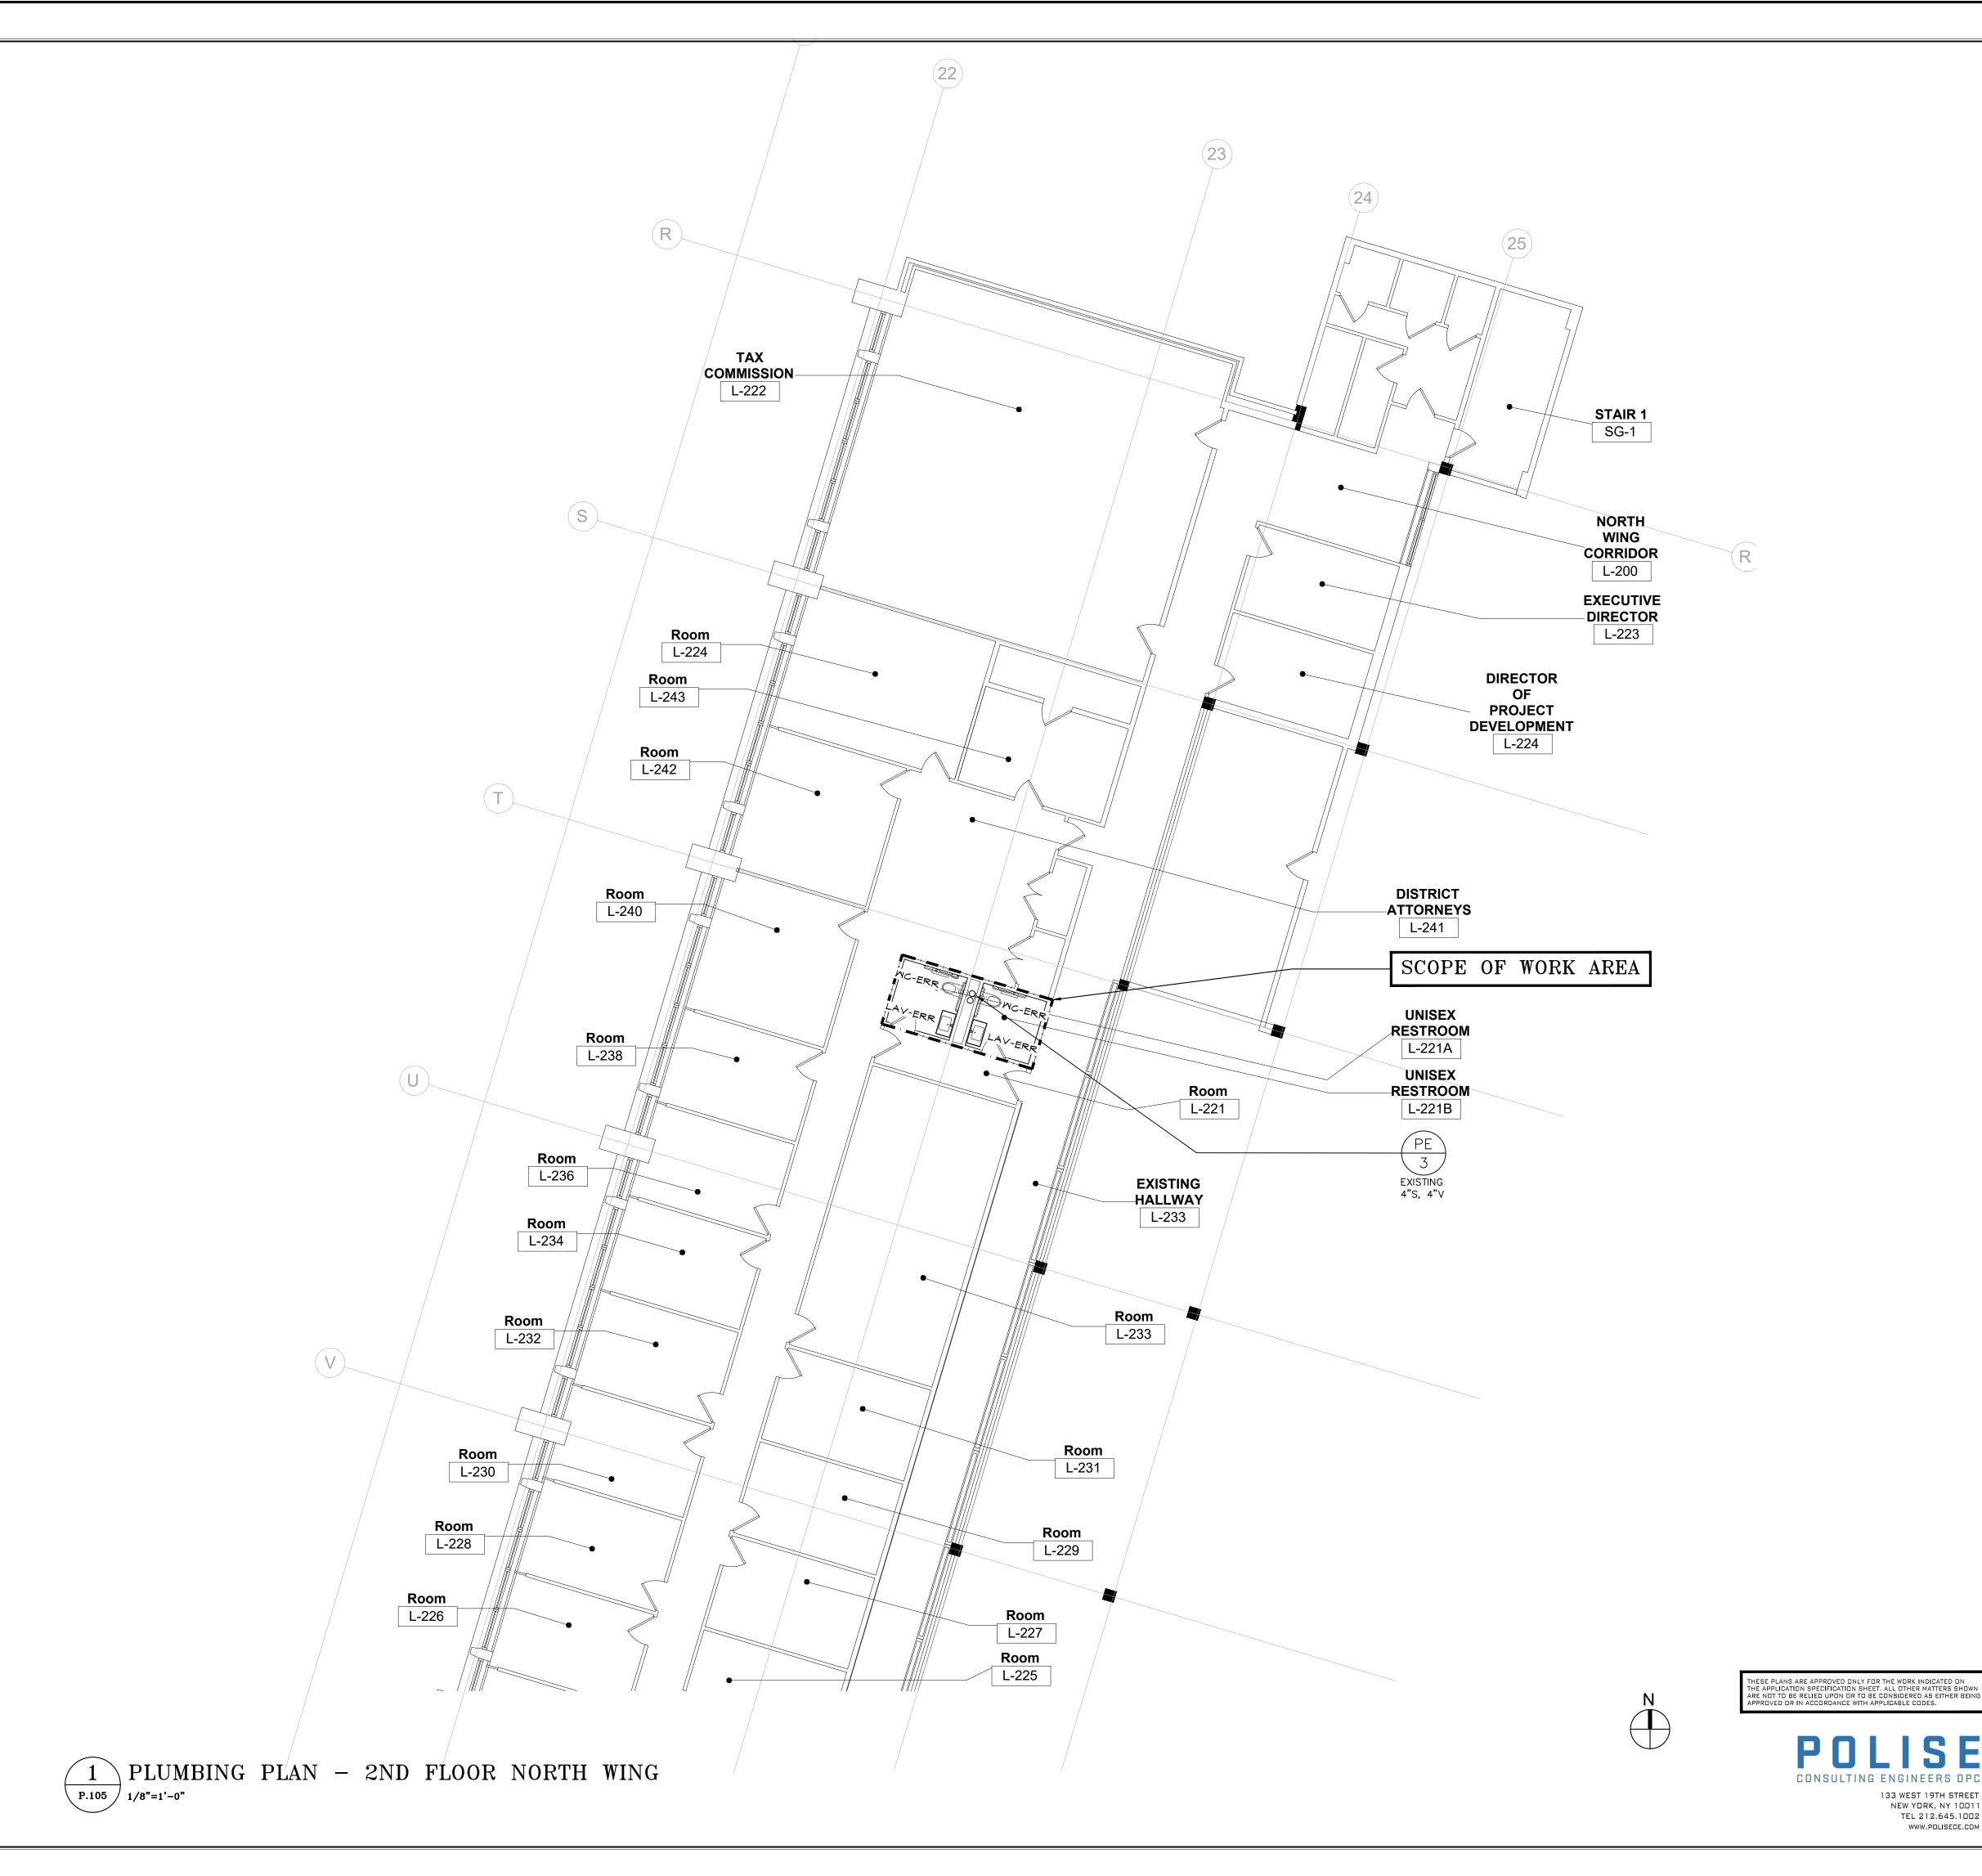

GENERAL NOTES

 \bigcirc Contractor to remove all fixtures in their entireity and maintan existing rough-ins.

2 ROUGH-INS SHALL BE CLEARED AND PROTECTED DURING CONSTRUCTION.

PRIOR TO NEW FIXTURE CONNECTION TO EXISTING ROUGH-IN, CONTRACTOR SHALL VERIFY ROUGH-IN IS FREE OF DEBRIS AND ALL CONNECTING APPARATICES ARE IN WORKING CONDITION WITH NO LEAKS.

4 ALL FLOOR DRAINS IN SCOPE OF WORK AREA TO BE REMOVED AND REPLACED.


5 PROVIDE NEW ISOLATION AND SHUTOFF VALVES ON DOMESTIC BRANCH TAKEOFFS IN SCOPE OF WORK AREA.


6 PROVIDE NEW SHUTOFF VALVES AT EACH FIXTURE IN SCOPE OF WORK AREA.

REPLACE ALL DAMAGED INSULATION ON DOMESTIC WATER LINES WITHIN SCOPE OF WORK AREA.

8 RELOCATE OR EXTEND EXISTING PIPING AS REQUIRED.

		P.1		JRT BL	<u>_</u>	0 MLK BLVD	143 GRAND STREET GARAGE GARAGE	7
	CONSULTANT SEAL	CONSULTANT						
	AND FESSION	A CONTRACTOR		90)-30 1	Architects LL 61st Street, Jamaica, 8-651-6200 F: 718-2	/ P 11432	
	REVISION NUMBER	DATE	MADE BY			REVISI	ON	
				CORD DR	AWIN	G CERTIFICATION		
		- CHANGES - NO CHAN						
ORK INDICATED DN	NAME: SIGNATURE:					CONT		
DTHER MATTERS SHOWN DERED AS EITHER BEING BLE CODES.								
ISE	DEP.	ARTMENT ()F PUBLIC V		D TRAN	SPORTATION	CONTRACT NUMBER 20-502 SHEET NO. 66	SHEET NUMBER P-105 OF 133
GINEERS DPC WEST 19TH STREET W YORK, NY 10011 TEL 212.645.1002	LOW	RISE BUILD 110 DR. I	ING RENOV	OF ENGIN ATIONS AND HER KING, J IS, NEW YOF	HVAC I	MPROVEMENTS - PHASE II EVARD	SCALE: AS NOTED DATE: JAN 19, 2024	
WWW.POLISECE.COM	F		G PLAN -	2ND FLO		RTH WING	DPW FILE NO. 52-11-P-	1878 REV

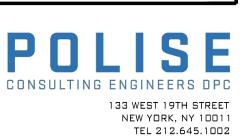

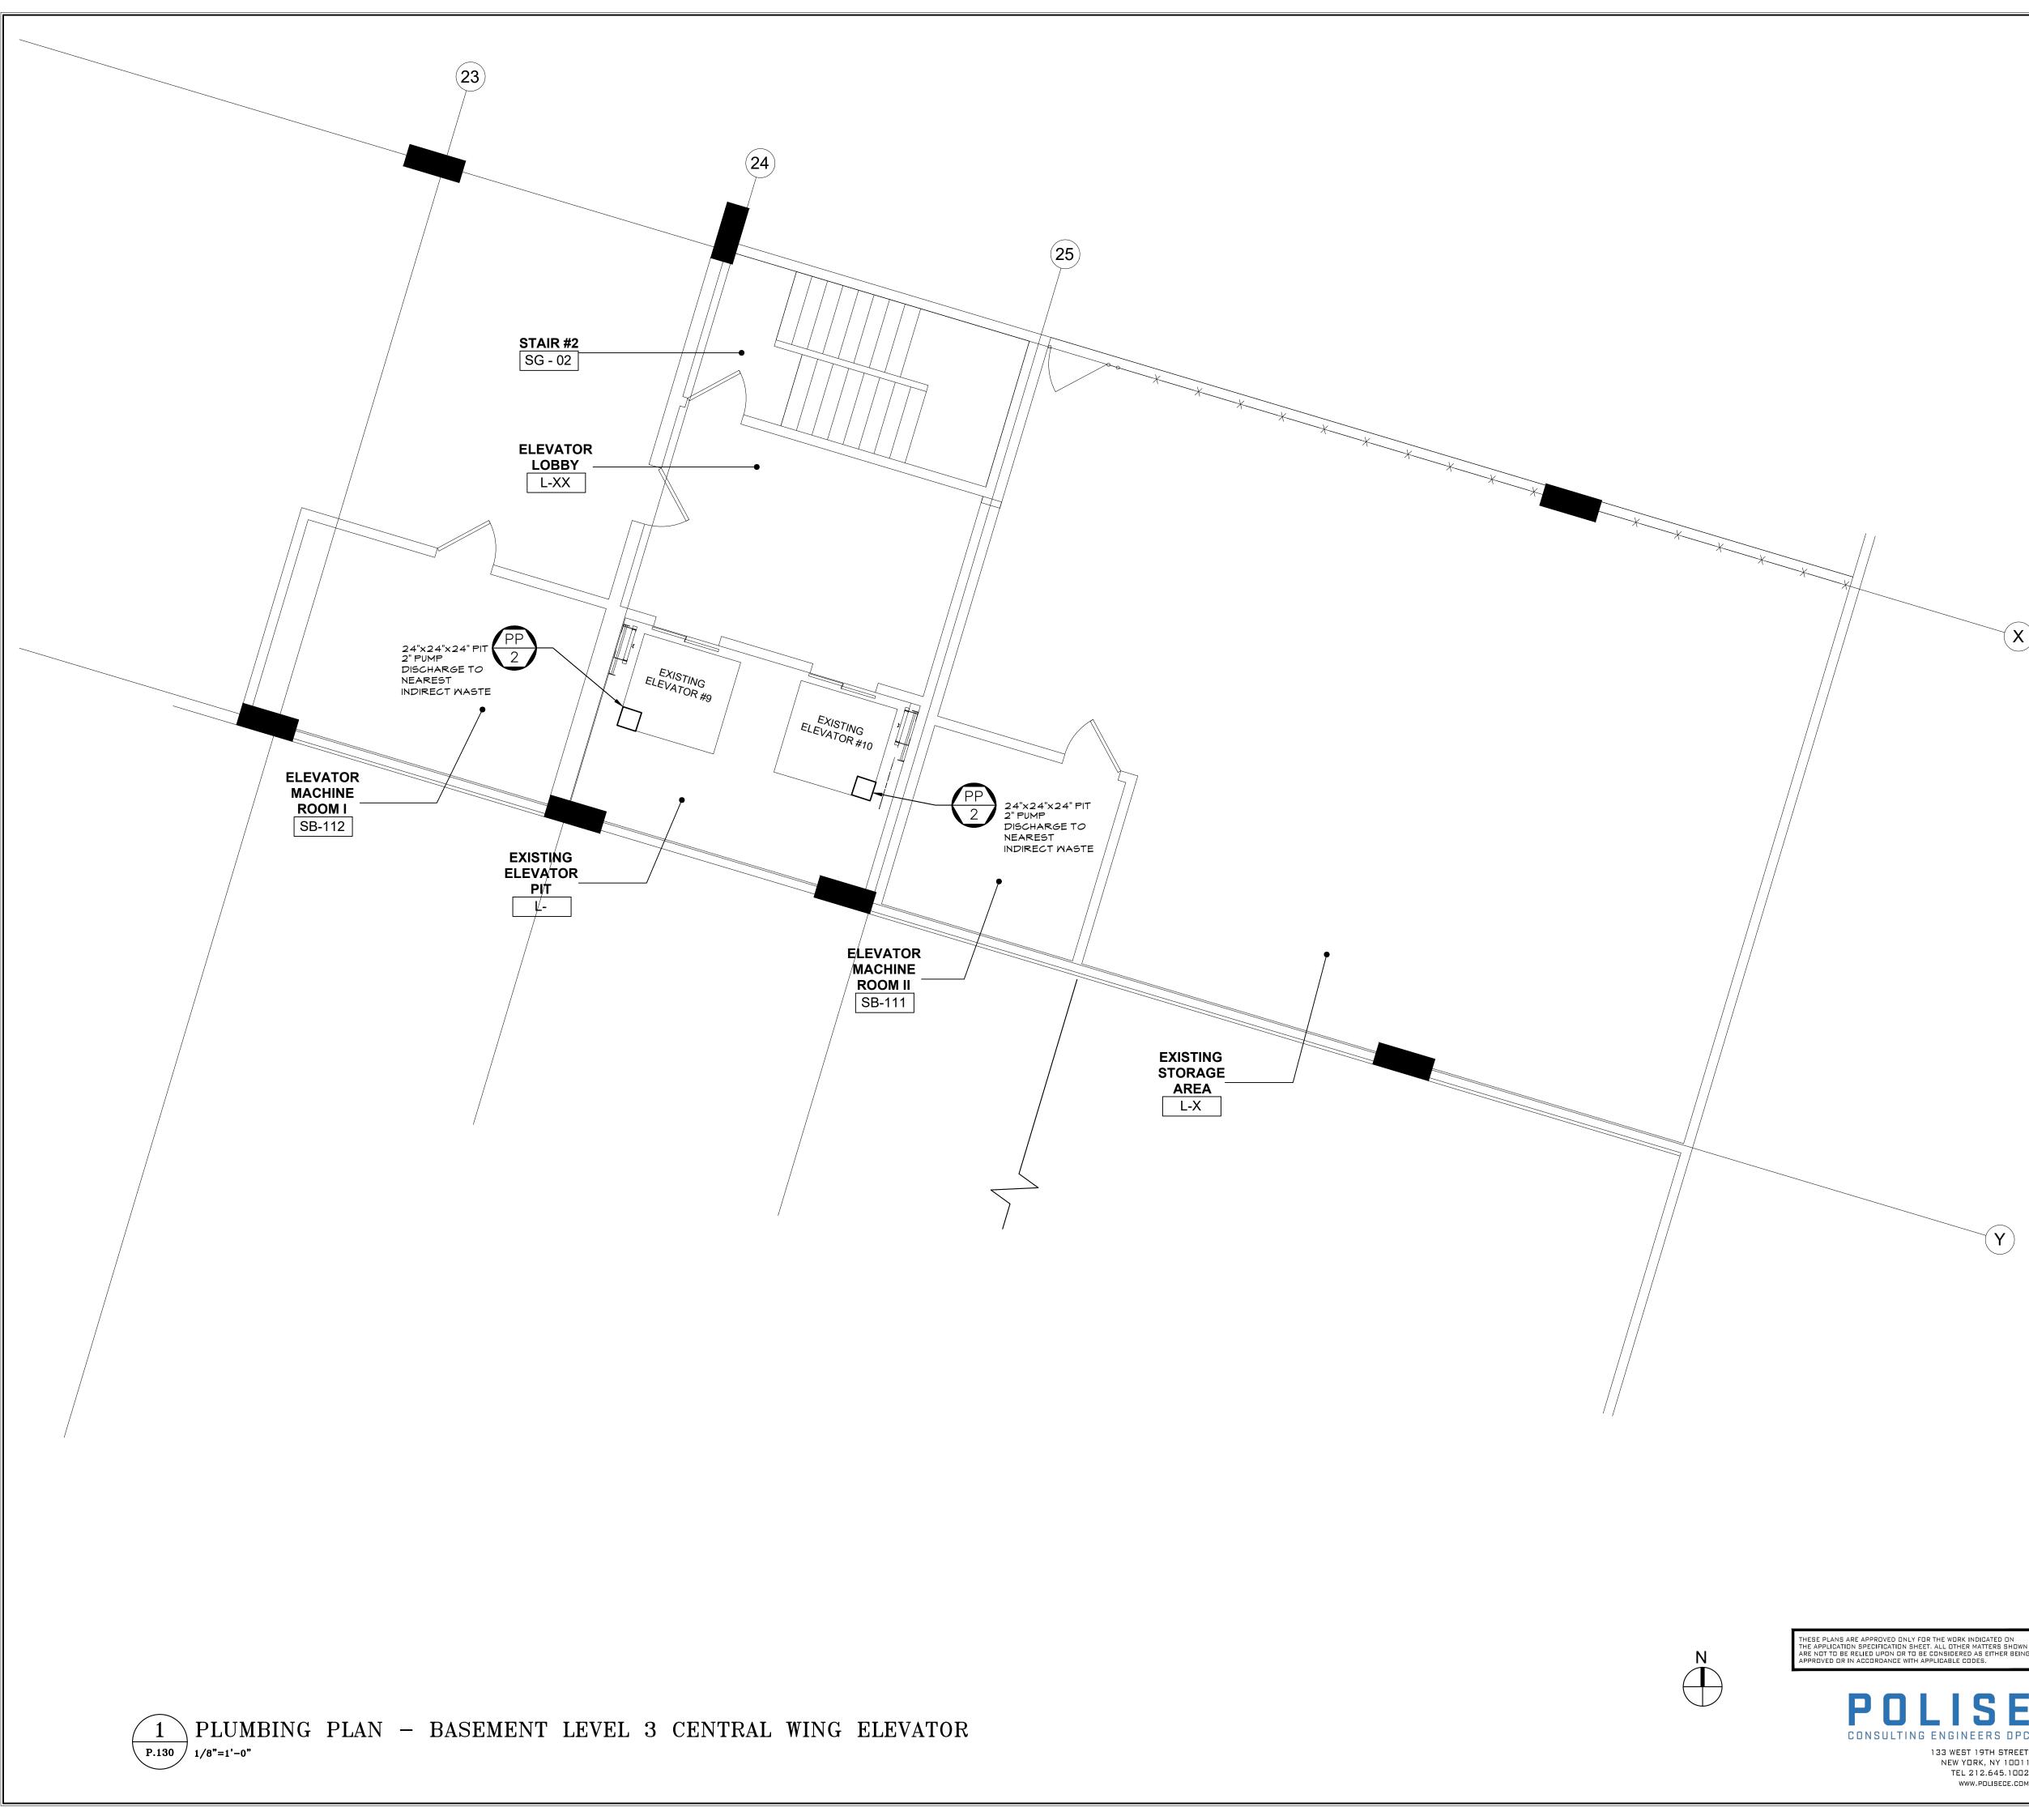

GENERAL NOTE

1 2" PUMP DISCHARGE TO BE BROUGHT HIGH TO NEAREST INDIRECT WASTE OR SANITARY HEADER (TO CONNECT BY WYE) AT SAME LEVEL. ALLOW FOR 200 FEET OF 2" PUMP DISCHARGE DRAIN PIPING (COMBINED PUMP DISCHARGE PIPING SIZE) FROM THE COMBINED ELEVATOR LOCATION. CONTRACTOR TO VERIFY IN FIELD EXACT CONNECTION POINT LOCATIONS AND PIPE ROUTING FOR ALL INDIRECT WASTE CONNECTIONS. () INSULATE ALL EXPOSED DRAIN PIPING.


		JRT BL		UIII VIONALIA IIIO MLK BLVD	STREET STREET GARAGE GARAGE	
CONSULTANT SEAL	CONSULTANT	INFORMATION				
COF NEW LOSS	Graf & Lewent Architects LLP 90-30 161st Street, Jamaica, NY 11432 P: 718-651-6200 F: 718-251-6989					
POFESSION N.						
APOFESSION A						
Potession Contraction Contraction						
POFESSION N. C.						
POG440Å						
REVISION DATE	MADE BY			8-651-6200 F: 718-2	51-6989	
REVISION DATE NUMBER		APP'D BY	⊃: 718	8-651-6200 F: 718-2 REVISIC	51-6989	
NUMBER	RE	APP'D BY	⊃: 718	8-651-6200 F: 718-2	51-6989	
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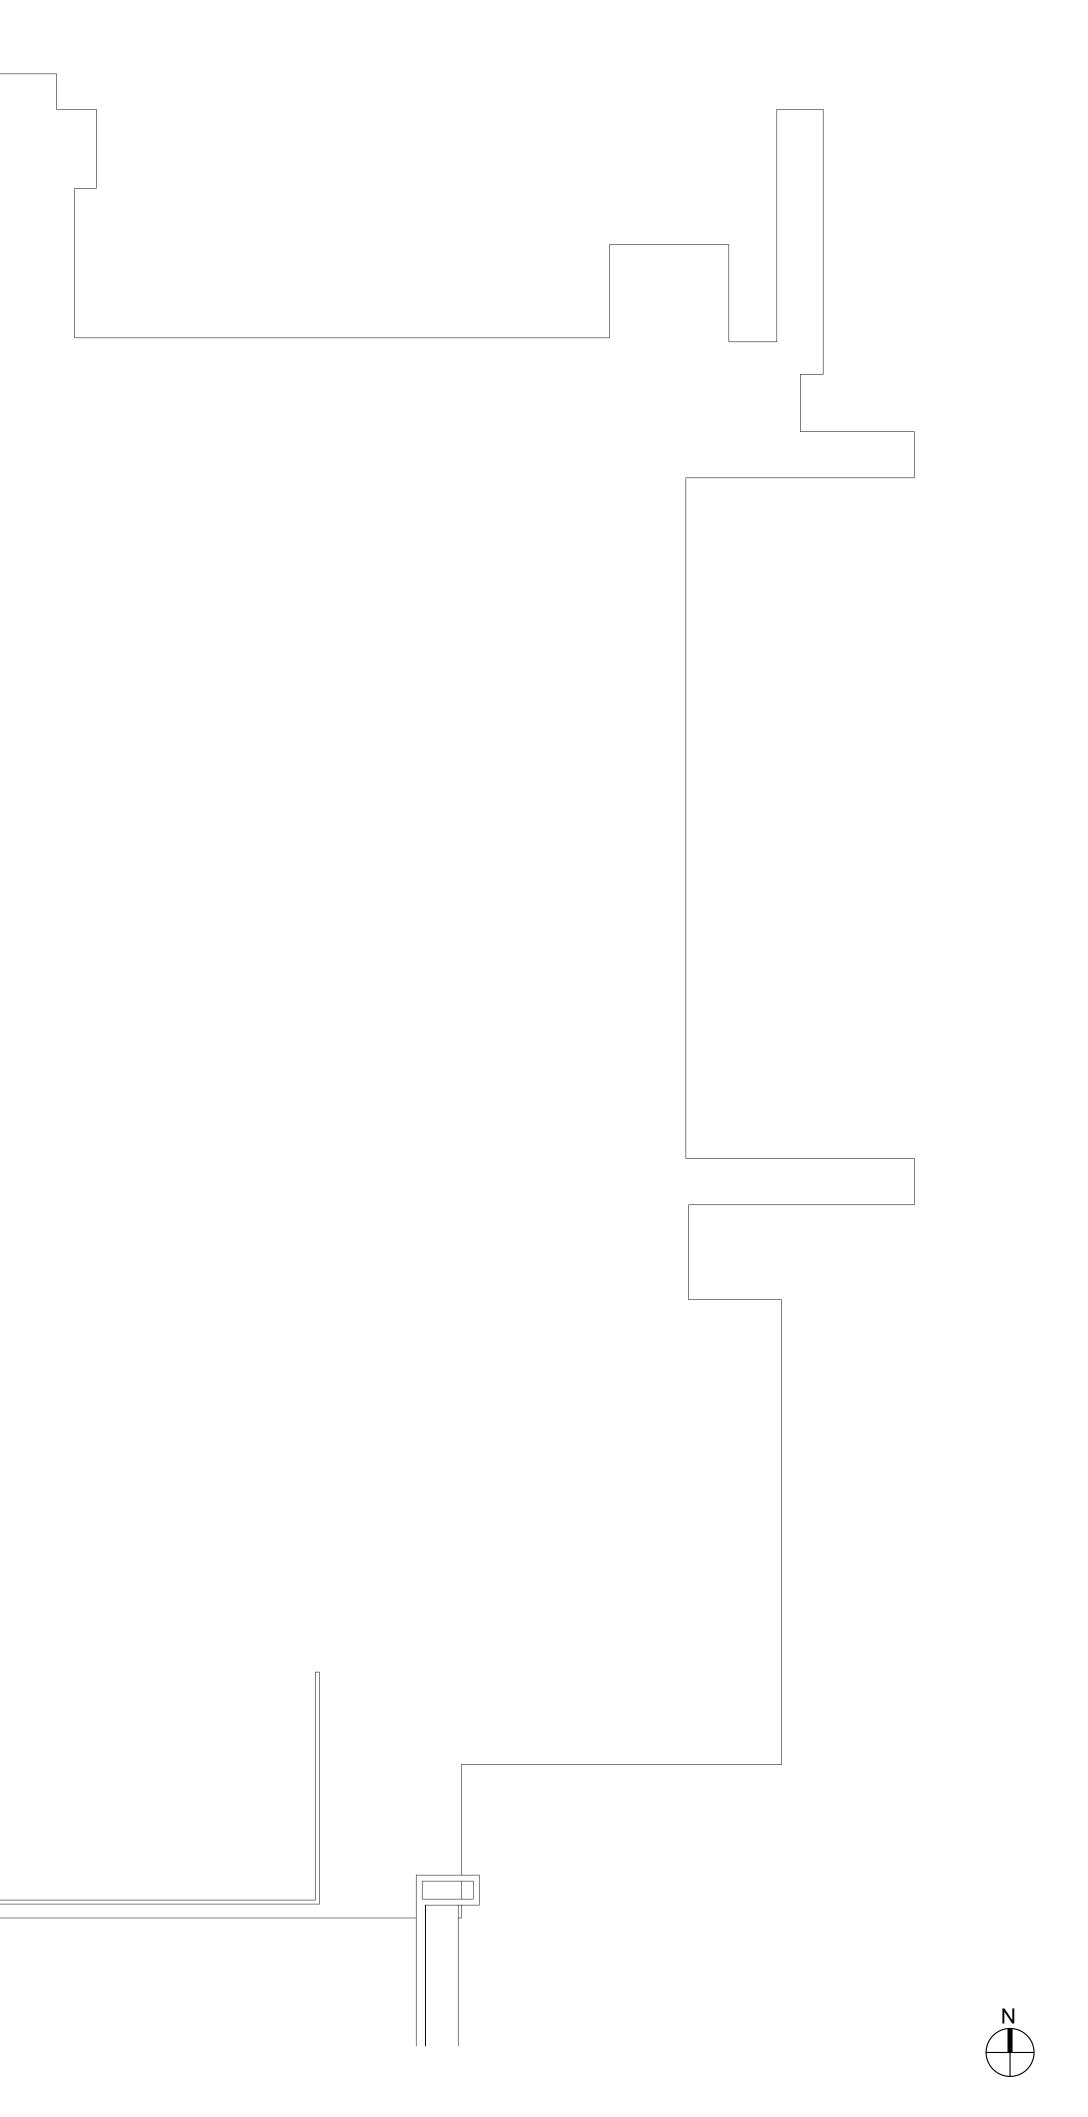
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SULTING	ENGINEERS DPC
	133 WEST 19TH STREET NEW YORK, NY 10011 TEL 212.645.1002 WWW.POLISECE.COM

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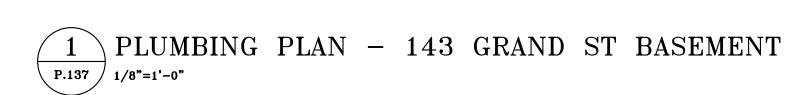





GENERAL NOTE

 2" PUMP DISCHARGE TO BE BROUGHT HIGH TO NEAREST INDIRECT WASTE OR SANITARY HEADER (TO CONNECT BY WYE) AT SAME LEVEL. ALLOW FOR 200 FEET OF 2" PUMP DISCHARGE DRAIN PIPING (COMBINED PUMP DISCHARGE PIPING SIZE) FROM THE COMBINED ELEVATOR LOCATION. CONTRACTOR TO VERIFY IN FIELD EXACT CONNECTION POINT LOCATIONS AND PIPE ROUTING FOR ALL INDIRECT WASTE CONNECTIONS.
 INSULATE ALL EXPOSED DRAIN PIPING.
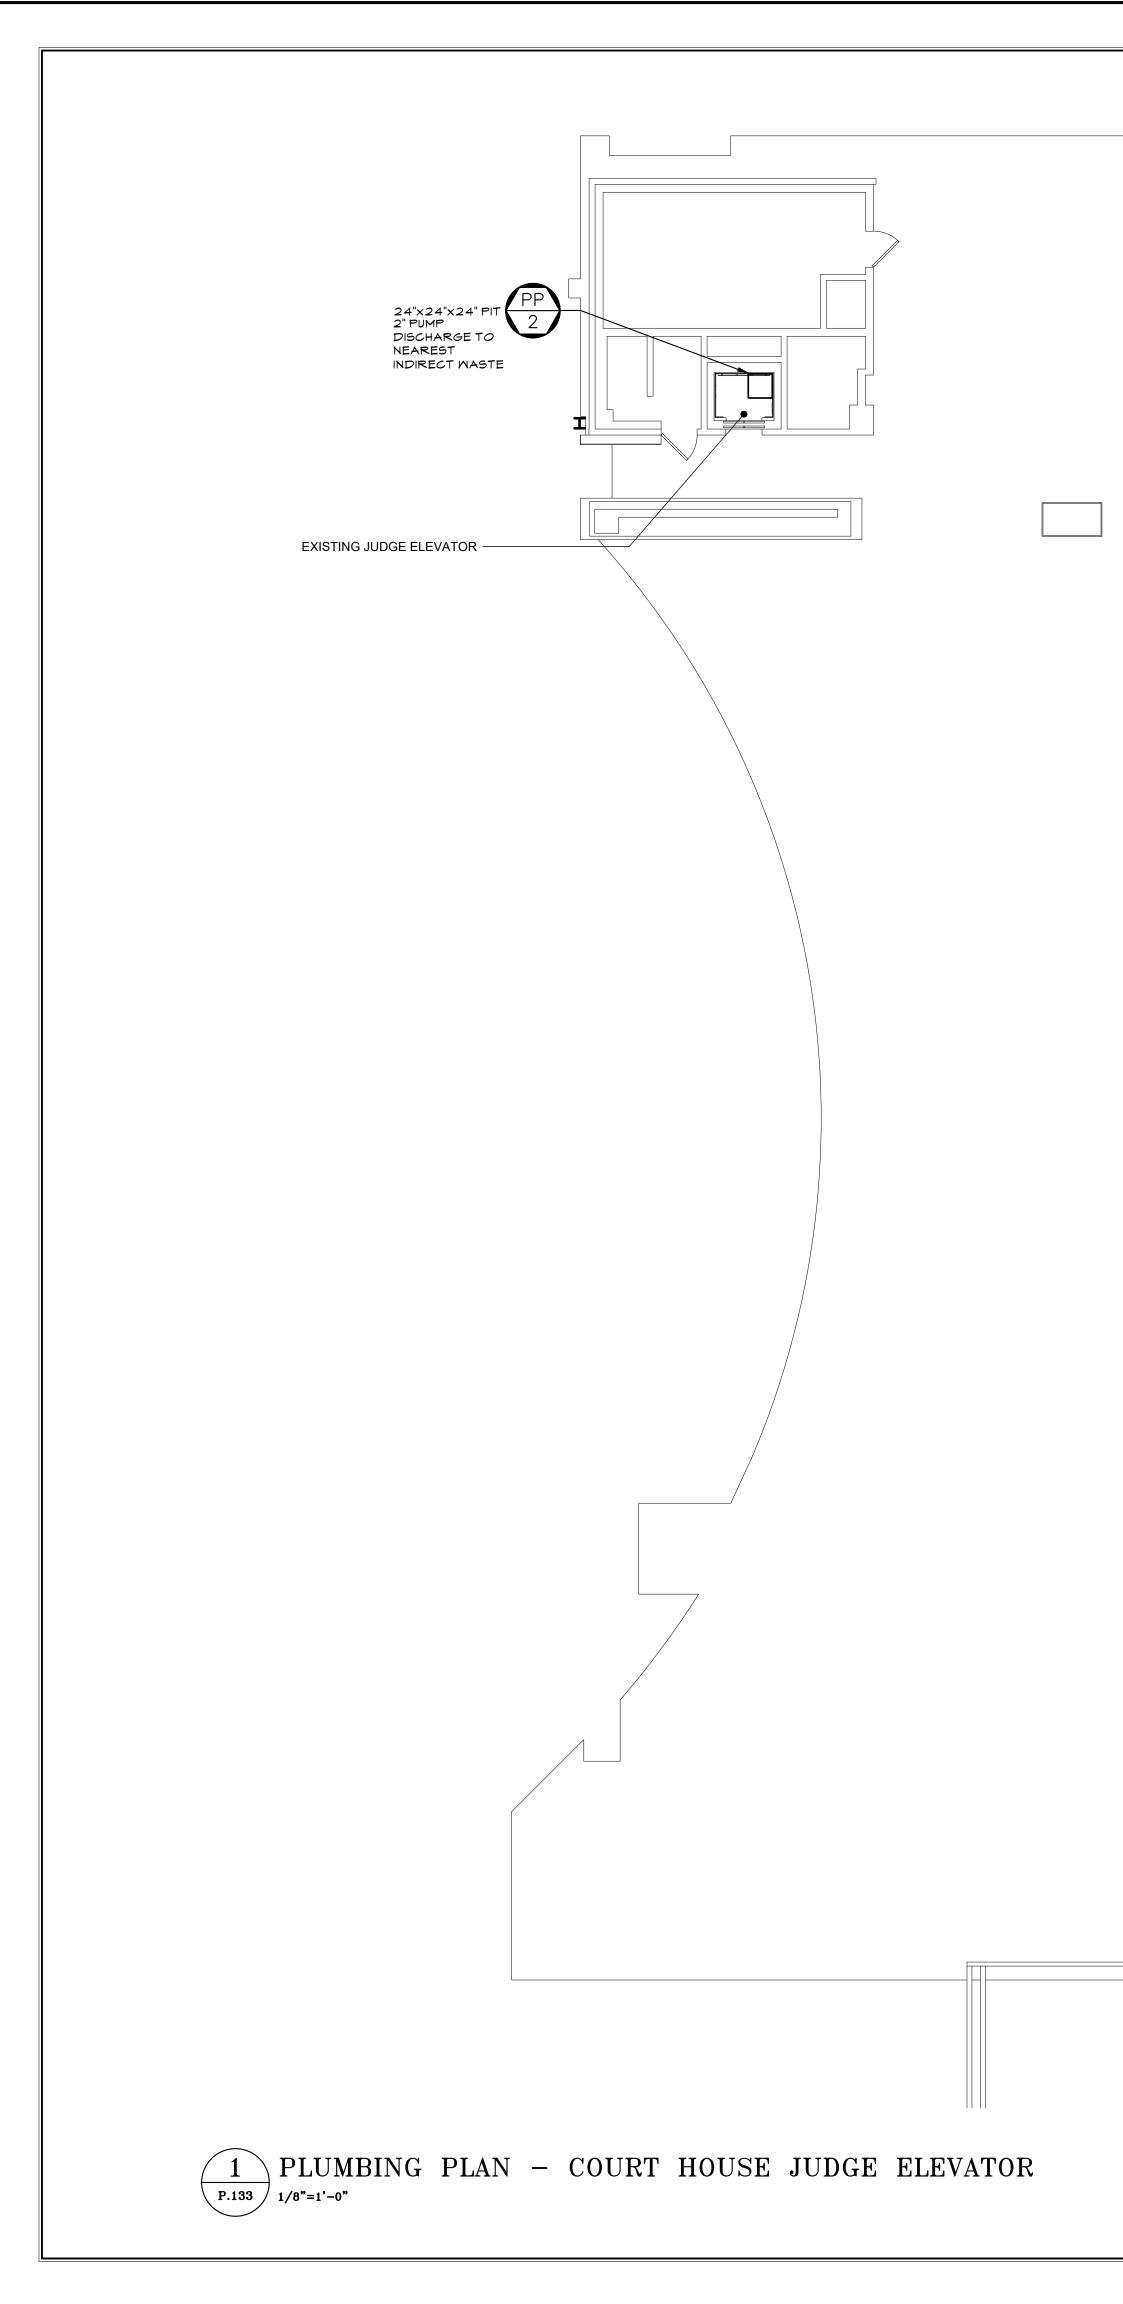
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133 WEST 19TH STREET NEW YORK, NY 10011 TEL 212.645.1002 WWW.POLISECE.COM		110 DR.	MARTIN LUT WHITE PLAIN OOR PLUI	HER KING, J IS, NEW YOF	R. BOUI K 1060 AN - J	EVARD	DATE: JAN 19, 2024 DPW FILE NO. 52-11-P	REV



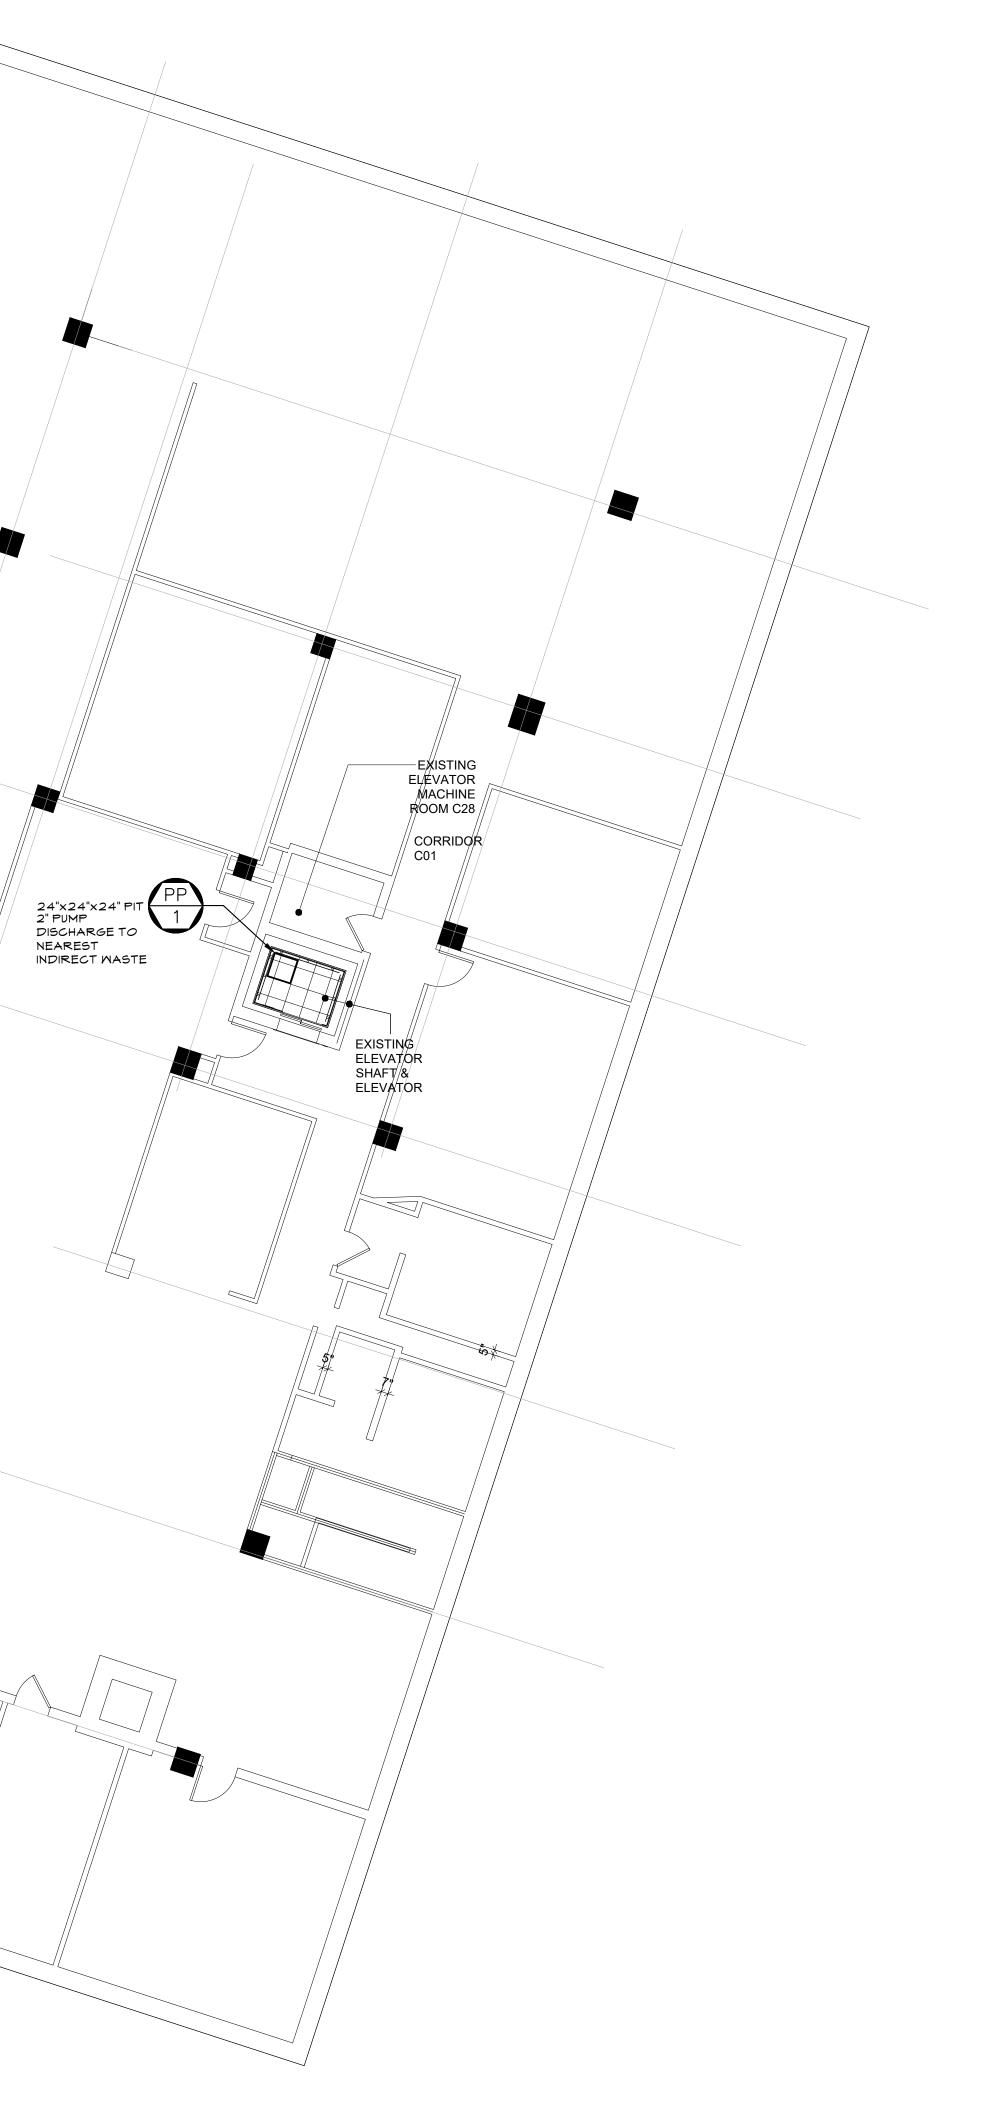






GENERAL NOTE

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 INSULATE ALL EXPOSED DRAIN PIPING.

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		REQUIRED	- FREQUENCY (MINIMUM)	REFERENCE STANDARD (SEE ECC CHAPTER	ECC OR OTHER CITATION	SPECIAL INSPECTION REQUIREMENTS	REQUIRED CODE/SECTION REFERENCES	TRADE			Project Information Energy Code: 90.1
		Y N		6) OR OTHER CRITERIA		SMOKE CONTROL SYSTEM TESTING	x BC 1705.18	м			Project Title: Location: White Climate Zone: 5a Project Type: Altera
В	MECHANICAL AND SERVICE WATER HEATING INSPECTIONS					MECHANICAL SYSTEMS FUEL STORAGE AND FUEL-PIPING SYSTEMS	x BC 1705.21	м			Construction Site: O 110 Dr Martin Luther King blvd White Plains, NY 10601
32	SHUTOFF DAMPERS: DAMPERS FOR STAIR AND ELEVATOR SHAFT VENTS AND OTHER OUTDOOR AIR INTAKES AND		AS REQUIRED DURING	APPROVED CONSTRUCTION DOCUMENTS; AMCA 500D	C402.5.5, C403.7.7; ASHRAE 90.1 -	HIGH-PRESSURE STEAM PIPING (WELDING)	x BC 1705.22	M			Mechanical Systems List Quantity System Type & Description 4 EMR Splits
	EXHAUST OPENINGS INTEGRAL TO THE BUILDING ENVELOPE MUST BE VISUALLY INSPECTED TO VERIFY THAT SUCH DAMPERS, EXCEPT WHERE PERMITTED TO BE GRAVITY		INSTALLATION	DOCUMENTS; AMCA SOUD	6.4.3.4	HIGH PRESSURE HOT WATER PIPING (WELDING) HIGH-PRESSURE FUEL GAS PIPING	x BC 1705.23	м			Cooling: 1 each - Split System, Capacity Proposed Efficiency = 17.50 SEER, F Fan System: None SYSTEM VERIFICATION REQUIRED.
	DAMPERS, COMPLY WITH APPROVED CONSTRUCTION DRAWINGS. MANUFACTURER'S LITERATURE MUST BE	×				HIGH-FRESSURE FUEL GAS FIFING HEATING SYSTEMS	x BC 1705.31	M			1 AHU-6 Heating: 1 each - Hydronic or Steam Co No minimum efficiency requirement a Cooling: 1 each - Hydronic Coil, Capaci
	REVIEWED TO VERIFY THAT THE PRODUCT HAS BEEN TESTED AND FOUND TO MEET THE STANDARD.					CHIMNEYS	x BC 1705.32	м			No minimum efficiency requirement a Fan System: None SYSTEM VERIFICATION REQUIRED.
3	HVAC-R COMMERCIAL KITCHEN EQUIPMENT, AND SERVICE WATER HEATING EQUIPMENT: EQUIPMENT SIZING, EFFICIENCIES, PIPE SIZING AND OTHER PERFORMANCE FACTORS OF ALL		PRIOR TO FINAL PLUMBING AND CONSTRUCTION	APPROVED CONSTRUCTION DOCUMENTS, ASHRAE 183, ASHRAE HVAC SYSTEMS AND	C403.1, C403.2, C403.3, C403.7.5, C404.2, C404.5,	EMERGENCY AND STANDBY POWER SYSTEMS (GENERATORS)	× BC 1705.36	M,FP M,P,FP			1 AHU-7 Heating: 1 each - Hydronic or Steam Cc No minimum efficiency requirement a Cooling: 1 each - Hydronic Coil, Capaci No minimum efficiency requirement a
	MAJOR EQUIPMENT UNITS, AS DETERMINED BY THE APPLICANT OF RECORD, AND NO LESS THAN 15% OF MINOR EQUIPMENT UNITS, MUST BE VERIFIED BY VISUAL INSPECTION AND, WHERE	×	INSPECTION	EQUIPMENT HANDBOOK	C404.9, C405.10, C406; ASHRAE 90.1 - 6.3, 6.4, 6.5, 6.7,	SEISMIC RESISTANCE IN PLUMBING, MECHANICAL, FUEL GAS, AND ELECTRICAL COMPONENTS	X BC 1705.12.3	M,P,FP			Fan System: None SYSTEM VERIFICATION REQUIRED.
	NECESSARY, REVIEW OF MANUFACTURER'S DATA. POOL HEATERS AND COVERS MUST BE VERIFIED BY VISUAL INSPECTION.				7.4, 7.5, 7.8, 10.4.6, APPENDIX 1	EXHAUST AND VENT SYSTEMS IN PLENUMS AND DUCTS	Х ВС 170539	м			Mechanical Compliance Statement Compliance Statement: The proposed mechai plans, specifications, and other calculations su designed to meet the 90.1 (2016) Standard re
4	HVAC-R AND SERVICE WATER HEATING SYSTEM		AFTER INSTALLATION	APPROVED CONSTRUCTION	C403, C404, C406;	PROGRESS INSPECTION CATEGORIES					mandatory requirements listed in the Inspection
	CONTROLS:NO LESS THAN 20% OF EACH TYPE OF REQUIRED CONTROLS MUST BE VERIFIED BY VISUAL INSPECTION AND TESTED FOR FUNCTIONALITY AND PROPER OPERATION, SUCH		AND PRIOR TO FINAL ELECTRICAL AND CONSTRUCTION	DOCUMENTS, INCLUDING CONTROL SYSTEM NARRATIVES; ASHRAE GUIDELINE 1: THE HVAC	ASHRAE 90.1 - 6.3, 6.4, 6.5, 6.6, 7.4, 7.5, APPENDIX 1	ENERGY CODE COMPLIANCE INSPECTIONS	x BC 110.3.5	M,P,FP			
	CONTROLS MUST INCLUDE, BUT ARE NOT LIMITED TO: THERMOSTATIC, OFF-HOUR, ZONES, FREEZE PROTECTION/SNOW AND ICE-MELT SYSTEM, VENTILATION		INSPECTION, EXCEPT THAT FOR CONTROLS WITH SEASONALLY	COMMISSIONING PROCESS WHERE APPLICABLE		PUBLIC ASSEMBLY EMERGENCY LIGHTING	x 28-116.2.2	M,P,FP			Proiect Title:
	SYSTEM AND FAN CONTROLS, ENERGY RECOVERY SYSTEMS, KITCHEN/LAB EXHAUST SYSTEMS, FAN SYSTEMS SERVING		DEPENDENT FUNCTIONALITY, SUCH TESTING MUST BE			FINAL	x 28-116.2.4.2, BC 110.5, DIRECTIVE 14 OF 1975, AND 1 RCNY	м			Data filename: F:\19XXX\19020.00 110 Dr. Ma
	SINGLE AND MULTIPLE ZONES, OUTDOOR HEATING SYSTEMS, HVAC CONTROL IN HOTEL/MOTEL GUEST ROOMS, AIR/WATER ECONOMIZERS AND CONTROLS, HYDRONIC SYSTEMS, HEAT		PERFORMED BEFORE SIGN OFF FOR				101-10				
	REJECTION SYSTEMS, HOT GAS BYPASS LIMITATION, REFRIGERATION SYSTEMS, DOOR SWITCHES, COMPUTER ROOM SYSTEMS, SERVICE WATER HEATING SYSTEMS, POOL		ISSUANCE OF A FINAL CERTIFICATE OF OCCUPANCY.								
	HEATER AND TIME SMITCHES. CONTROLS MITH SEASONALLY DEPENDENT FUNCTIONALITY: CONTROLS WHOSE COMPLETE OPERATION CANNOT BE						ING-ISSUE L	ST			
	DEMONSTRATED DUE TO PREVAILING WEATHER CONDITIONS TYPICAL OF THE SEASON DURING WHICH PROGRESS INSPECTIONS WILL BE PERFORMED SHALL BE PERMITTED TO										
	BE SIGNED OFF FOR THE PURPOSE OF A TEMPORARY CERTIFICATE OF OCCUPANCY WITH ONLY A VISUAL INSPECTION, PROVIDED, HOWEVER, THAT THE PROGRESS	×							ONSE	ONSE TS	ม ม ม ม ม ม ม ม
	INSPECTOR MUST PERFORM A SUPPLEMENTAL INSPECTION WHERE THE CONTROLS ARE VISUALLY INSPECTED AND TESTED FOR FUNCTIONALITY AND PROPER OPERATION								TER	I SI N II	
	DURING THE NEXT IMMEDIATE SEASON THEREAFTER. THE OWNER MUST PROVIDE FULL ACCESS TO THE PROGRESS								19 15 15 15 15 15 15 15 15 15 15 15 15 15	0.04 RI CHESTI COMM	0.0 10 10 10 10 10 10 10 10 10 10
	INSPECTOR WITHIN TWO WEEKS OF THE PROGRESS INSPECTOR'S REQUEST FOR SUCH ACCESS TO PERFORM THE PROGRESS INSPECTION.					Latest			22.08 MISSI 23.02 MESC	23.08. MESC	
	FOR SUCH SUPPLEMENTAL INSPECTIONS, THE DEPARTMENT MUST BE NOTIFIED BY THE APPROVED PROGRESS INSPECTION AGENCY OF ANY UNRESOLVED DEFICIENCIES IN					DOB Sheet # Rev. # Sheet Title EN-010 .00 ENERGY COMPLIANCE			X 200 C 10 C 10 C 10 C 10 C 10 C 10 C 10 C	000 0477 ×	
	THE INSTALLED WORK WITHIN 180 DAYS OF SUCH SUPPLEMENTAL INSPECTION.					ENCOTOENERGY COMPLIANCEEN-012.00ENERGY COMPLIANCE			× × × × × ×	× ×	
35	HVAC-R AND SERVICE WATER PIPING DESIGN AND INSULATION: INSTALLED PIPING INSULATION MUST BE VISUALLY		AFTER INSTALLATION	APPROVED CONSTRUCTION DOCUMENTS	C403.11, C404.4, C404.5, MC 603.9;						
	INSPECTED TO VERIFY PROPER INSULATION PLACEMENT AND	×	CLOSING SHAFTS, CEILINGS AND WALLS		ASHRAE 90.1 - 6.3, 6.4.4, 6.8.2, 6.8.3; 7.4.3						
6	INSPECTED TO VERIFY THE SUPPLY OF HEATED WATER.		AFTER INSTALLATION	APPROVED CONSTRUCTION	C403.11: ASHRAE						
	SYSTEMS DESIGNED TO OPERATE AT STATIC PRESSURES IN EXCESS OF 3 INCHES M.G. (746 PA), REPRESENTATIVE SECTIONS AS DETERMINED BY THE PROGRESS INSPECTOR		AND SEALING AND PRIOR TO CLOSING SHAFTS, CEILINGS AND	DOCUMENTS; SMACNA HVAC AIR DUCT LEAKAGE TEST MANUAL; SMACNA DUCT CONSTRUCTION	90.1 - 6.4.4.2.2,						
	TOTALING AT LEAST 25% OF THE DUCT AREA MUST BE TESTED TO VERIFY THAT ACTUAL AIR LEAKAGE IS BELOW ALLOWABLE AMOUNTS.	×	MALLS	STANDARDS, METAL AND FLEXIBLE							
	INSTALLED DUCT INSULATION MUST BE VISUALLY INSPECTED TO VERIFY PROPER INSULATION PLACEMENT AND VALUES. JOINTS, LONGITUDINAL AND TRANSVERSE SEAMS AND										
	CONNECTIONS IN DUCTWORK MUST BE VISUALLY INSPECTED FOR PROPER SEALING.										
;	ELECTRICAL POWER AND LIGHTING SYSTEMS										
51	METERING: THE PRESENCE AND OPERATION OF ALL REQUIRED METERS FOR MONITORING TOTAL ELECTRICAL ENERGY		PRIOR TO FINAL ELECTRICAL AND	APPROVED CONSTRUCTION DOCUMENTS	C405.5, C405.12; ASHRAE 90.1 - 8.4.3,						
	USAGE AND/OR TOTAL FUEL USE, SYSTEM ENERGY USAGE, TENANT ENERGY USAGE, OR ELECTRICAL ENERGY USAGE IN BUILDING, IN INDIVIDUAL DWELLING UNITS, OR IN TENANT	×	CONSTRUCTION		8.4.5, 8.4.6, 10.4.5						
	SPACES MUST BE VERIFIED BY VISUAL INSPECTION.		PRIOR TO FINAL	APPROVED CONCEPTION	C405.1; ASHRAE						
52	LIGHTING IN DWELLING UNITS: LAMPS IN PERMANENTLY INSTALLED LIGHTING FIXTURES MUST BE VISUALLY INSPECTED TO VERIFY COMPLIANCE WITH HIGH-EFFICACY REQUIREMENTS.	×	PRIOR TO FINAL ELECTRICAL AND CONSTRUCTION INSPECTION	APPROVED CONSTRUCTION DOCUMENTS	C405.1; ASHRAE 90.1 - 9.1.1						
23	INTERIOR LIGHTING POWER: INSTALLED LIGHTING MUST BE VERIFIED FOR COMPLIANCE WITH THE LIGHTING POWER		PRIOR TO FINAL ELECTRICAL AND	APPROVED CONSTRUCTION DOCUMENTS	C405.3, C406; ASHRAE 90.1 -9.1,						
	ALLOWANCE BY VISUAL INSPECTION OF FIXTURES, LAMPS, BALLASTS AND TRANSFORMERS.	×	CONSTRUCTION		9.2, 9.5, 9.6, 9.7; 1RCNY §101-07(c)(3)(v)(C)4						
24	EXTERIOR LIGHTING POWER: INSTALLED LIGHTING MUST BE		PRIOR TO FINAL	APPROVED CONSTRUCTION	APPENDIX 1 C405.4; ASHRAE						
	VERIFIED FOR COMPLIANCE WITH SOURCE EFFICACY AND/OR THE LIGHTING POWER ALLOWANCE BY VISUAL INSPECTION OF FIXTURES, LAMPS, BALLASTS AND RELEVANT	×	ELECTRICAL AND CONSTRUCTION INSPECTION	DOCUMENTS	90.1 - 9.4.2; 1RCNY §101-07(c)(3)(v)(C)4						
25	TRANSFORMERS. LIGHTING CONTROLS: EACH TYPE OF REQUIRED LIGHTING		PRIOR TO FINAL	APPROVED CONSTRUCTION	C405.2, C406;						
-	CONTROLS, INCLUDING: OCCUPANT SENSORS, MANUAL INTERIOR LIGHTING CONTROLS, LIGHT-REDUCTION CONTROLS, AUTOMATIC LIGHTING SHUT-OFF, DAYLIGHT ZONE CONTROLS,		ELECTRICAL AND CONSTRUCTION INSPECTION	DOCUMENTS, INCLUDING CONTROL SYSTEM NARRATIVES	ASHRAE 90.1 - 9.4.1, 9.4.3, 9.7, APPENDIX 1						
	SLEEPING UNIT CONTROLS, EXTERIOR LIGHTING CONTROLS AND EGRESS ILLUMINATION CONTROLS MUST BE VERIFIED BY	×									
	VISUAL INSPECTION AND TESTED FOR FUNCTIONALITY AND PROPER OPERATION.										
.6	ELECTRIC MOTORS AND ELEVATORS: WHERE REQUIRED BY THE CONSTRUCTION DOCUMENTS FOR ENERGY CODE COMPLIANCE, MOTOR LISTING OR LABELS MUST BE VISUALLY		PRIOR TO FINAL ELECTRICAL AND CONSTRUCTION	APPROVED CONSTRUCTION DOCUMENTS	C403.8, C405.6, C405.7, C405.8, C405.9; ASHRAE						
	INSPECTED TO VERIFY THAT THEY COMPLY WITH THE RESPECTIVE ENERGY REQUIREMENTS IN THE CONSTRUCTION DOCUMENTS, ELEVATORS AND ESCALATORS MUST BE	×	INSPECTION		90.1-8.4.4, 10.4, 10.8						-
	INSPECTED FOR COMPLIANCE WITH REGENERATIVE DRIVE REQUIREMENTS.										THE THE ARE APF
>	OTHER										
71	MAINTENANCE INFORMATION: MAINTENANCE MANUALS FOR MECHANICAL, SERVICE HOT WATER AND ELECTRICAL EQUIPMENT AND SYSTEMS REQUIRING PREVENTIVE		ISSUANCE OF CERTIFICATE OF	APPROVED CONSTRUCTION DOCUMENTS, INCLUDING ELECTRICAL DRAWINGS WHERE	C408.1.1, C408.2.5.2, C408.3.2; ASHRAE						
	MAINTENANCE MUST BE REVIEWED FOR APPLICABILITY TO INSTALLED EQUIPMENT AND SYSTEMS BEFORE SUCH MANUALS ARE PROVIDED TO THE OWNER. LABELS REQUIRED	×	OCCUPANCY	APPLICABLE; ASHRAE GUIDELINE 4: PREPARATION OF OPERATING AND MAINTENANCE	90.1 - 4.2.2.3, 6.7.2.2, 6.7.2.3.5.2, 8.7.2, 9.7.2.2,						
	FOR SUCH EQUIPMENT OR SYSTEMS MUST BE INSPECTED FOR ACCURACY AND COMPLETENESS.			DOCUMENTATION FOR BUILDING SYSTEMS	9.4.3.2.2						

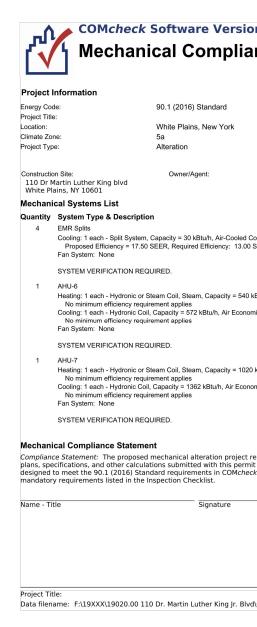

THESE PLANS ARE APPROVED ONLY FOR THE WORK INDICATED ON THE APPLICATION SPECIFICATION SHEET. ALL OTHER MATTERS SHOWN ARE NOT TO BE RELIED UPON OR TO BE CONSIDERED AS EITHER BEING APPROVED OR IN ACCORDANCE WITH APPLICABLE CODES.



sion 4.1.5.3	∩ى	COMcheck Softw		
iance Certificate	ſ	1 inspection		
	Requirem	Energy Code: 90.1 (20 nents: 100.0% were addressed (
	requireme	ent, the user certifies that a code re	equirement will be	e user in the COMcheck Requirements screen. For eacl met and how that is documented, or that an exception
	is being c	laimed. Where compliance is itemiz	zed in a separate t	able, a reference to that table is provided.
	& Req.ID	Plan Review	Complies?	Comments/Assumptions
	6.4.4.2.1, 6.7.2	with which compliance can be	□Complies □Does Not □Not Observable	Requirement will be met.
Designer/Contractor:		determined for the mechanical systems and equipment and document where exceptions to the		
		standard are claimed. Load calculations per acceptable engineering standards and		
led Condenser	4.2.2,	handbooks. Plans, specifications, and/or		Requirement will be met.
led Condenser 3.00 SEER	8.4.1.2,	calculations provide all information with which compliance can be determined for the electrical systems	Does Not	
	[PR6] ²	and equipment and document where exceptions are claimed. Feeder connectors sized in accordance with	⊔Not Applicable	
540 kBtu/h		approved plans and branch circuits sized for maximum drop of 3%.		
conomizer	[PR5] ¹	the plans or specifications for projects	Does Not	Exception: Requirement does not apply.
		>=50,000 ft2.	Not Observable	
	Additiona	al Comments/Assumptions:		
1020 kBtu/h				
conomizer				
ect represented in this document is consistent with the building				
ermit application. The proposed mechanical systems have been check Version 4.1.5.3 and to comply with any applicable				
Date				
	Project Title	1 High Impact (Tier 1)	2 Medium Impa	t (Tier 2) 3 Low Impact (Tier 3) Report date: 02/15/23
Report date: 02/15/23 Blvd\COMCHECK\20230215 Mech Comcheck. Page 1 of 12			Luther King Jr. Blvd	COMCHECK\20230215 Mech Comcheck. Page 2 of 12
	Sectio	n		
	# & Req.	Footing / Foundation Inspectio		Comments/Assumptions
	6.4.3.7 [FO9] ³	Freeze protection and snow/ice melting system sensors for future connection to controls.	Complies Does Not	Exception: Requirement does not apply.
			□Not Observab □Not Applicable	e
	Additic	onal Comments/Assumptions:		

	CONSULTANT SEAL		CONSULTANT	INFORMATION				
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		·	RE	CORD DR	AWIN	G CERTIFICATION		
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	NAME: SIGNATURE:					NAME:		
FOR THE WORK INDICATED ON HEET. ALL OTHER MATTERS SHOWN D BE CONSIDERED AS EITHER BEING H APPLICABLE CODES.								
LISE	DEPA			COUNTY, N WORKS ANI		RK ISPORTATION	CONTRACT NUMBER 20-502	SHEET NUMBER
		C	VISION	OF ENGIN	IEERII	NG	SHEET NO.	70 OF 133
IG ENGINEERS DPC 133 WEST 19TH STREET NEW YORK, NY 10011 TEL 212.645.1002	LOW	110 DR.	MARTIN LUT	ATIONS AND HER KING, J NS, NEW YOF	R. BOU		DATE: JAN 19, 2	2024
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 1 High Impact (Tier 1)
 2 Medium Impact (Tier 2)
 3 Low Impact (Tier 3)
 Project Title: Report date: 02/15/23
Data filename: F:\19XXX\19020.00 110 Dr. Martin Luther King Jr. Blvd\COMCHECK\20230215 Mech Comcheck. Page 3 of 12

Section # & Req.ID	Mechanical Rough-In Inspection	Plans Verified Value	Field Verified Value	Complies?	Comments/Assumptions
6.4.1.4, 6.4.1.5 [ME1] ²	HVAC equipment efficiency verified. Non-NAECA HVAC equipment labeled as meeting 90.1.	Efficiency:	Efficiency:	Complies Does Not Not Observable Not Applicable	See the Mechanical Systems list for values.
6.4.3.4.1 [ME3] ³	Stair and elevator shaft vents have motorized dampers that automatically close.			Complies Does Not Not Observable Not Applicable	Requirement will be met.
6.4.3.4.2, 6.4.3.4.3 [ME4] ³	Outdoor air and exhaust systems have motorized dampers that automatically shut when not in use and meet maximum leakage rates. Check gravity dampers where allowed.			Complies Does Not Not Observable Not Applicable	Requirement will be met.
6.4.3.4.5 [ME39] ³	Enclosed parking garage ventilation has automatic contaminant detection and capacity to stage or modulate fans to 50% or less of design capacity.			□Complies □Does Not □Not Observable □Not Applicable	Exception: Requirement does not apply.
6.4.3.4.4 [ME5] ³	Ventilation fans >0.75 hp have automatic controls to shut off fan when not required.			□Complies □Does Not □Not Observable □Not Applicable	Requirement will be met.
6.4.3.8 [ME6] ¹	Demand control ventilation provided for spaces >500 ft2 and >25 people/1000 ft2 occupant density and served by systems with air side economizer, auto modulating outside air damper control, or design airflow >3,000 cfm.			Complies Does Not Not Observable Not Applicable	Requirement will be met.
6.5.3.2.1 [ME40] ²	DX cooling systems >= 75 kBtu/h (>= 65 kBtu/h effective 1/2016) and chilled-water and evaporative cooling fan motor hp >= ¼ designed to vary supply fan airflow as a function of load and comply with operational requirements.			Complies Does Not Not Observable Not Applicable	Requirement will be met. See the Mechanical Systems list for values.
6.4.4.1.1 [ME7] ³	Insulation exposed to weather protected from damage. Insulation outside of the conditioned space and associated with cooling systems is vapor retardant.			Complies Does Not Not Observable Not Applicable	Requirement will be met.
6.4.4.1.2 [ME8] ²	HVAC ducts and plenums insulated per Table 6.8.2. Where ducts or plenums are installed in or under a slab, verification may need to occur during Foundation Inspection.	R	R	□Complies □Does Not □Not Observable □Not Applicable	Requirement will be met.
6.4.4.1.3 [ME9] ²	HVAC piping insulation thickness. Where piping is installed in or under a slab, verification may need to occur during Foundation Inspection.	in.	in.	□Complies □Does Not □Not Observable □Not Applicable	Requirement will be met.

Section # & Reg.ID	Mechanical Rough-In Inspection	Plans Verified Value	Field Verified Value	Complies?	Comments/Assumption
6.4.4.1.4 [ME41] ³	Thermally ineffective panel surfaces of sensible heating			□Complies □Does Not	Exception: Requirement does not apply.
	panels have insulation $>$ = R-3.5.			□Not Observable □Not Applicable	
6.4.4.2.1 [ME10] ²	Ducts and plenums having pressure class ratings are Seal Class A construction.			□Complies □Does Not □Not Observable	Requirement will be met.
C 0 1 15	Electrically operated DX-DOAS			Not Applicable	Exception: Requirement
6.8.1-15, 6.8.1-16 [ME110] ²	units meet requirements per Tables 6.8.1-15 or 6.8.1-16.			Does Not	does not apply.
6.4.4.2.2	Ductwork operating >3 in. water			□Not Applicable □Complies	Requirement will be met.
[ME11] ³	column requires air leakage testing.			Does Not	Requirement win be met.
6.4.4.2.2 [ME11] ³	Ductwork operating >3 in. water column requires air leakage			□Not Applicable □Complies □Does Not	Requirement will be met.
	testing.			□Not Observable □Not Applicable	
6.4.4.2.2 [ME11] ³	Ductwork operating >3 in. water column requires air leakage testing			□Complies □Does Not	Requirement will be met.
	testing.			□Not Observable □Not Applicable	
6.5.2.1 [ME17] ¹	Zone controls can limit reheating, recooling, simultaneous heating and cooling and sequence			□Complies □Does Not	Requirement will be met.
	heating and cooling to each zone.			□Not Observable □Not Applicable	
6.5.2.1 [ME17] ¹	Zone controls can limit reheating, recooling, simultaneous heating and cooling and sequence			□Complies □Does Not	Requirement will be met.
	heating and cooling to each zone.			□Not Observable □Not Applicable	
6.5.2.2.1 [ME50] ²	Three-pipe hydronic systems using a common return for hot and chilled water are not used.			Complies Does Not Not Observable	Requirement will be met.
6.5.2.2.1	Three-pipe hydronic systems			Not Applicable Complies	Requirement will be met.
[ME50] ²	using a common return for hot and chilled water are not used.			Does Not Not Observable	
6.5.2.3 [ME19] ³	Dehumidification controls provided to prevent reheating,			Complies	Requirement will be met.
	recooling, mixing of hot and cold airstreams or concurrent heating and cooling of the same airstream.			□Not Observable □Not Applicable	
6.5.2.4.1 [ME68] ³	Humidifiers with airstream mounted preheating jackets have			□Complies □Does Not	Exception: Requirement does not apply.
	preheat auto-shutoff value set to activate when humidification is not required.			□Not Observable □Not Applicable	
	1 High Impact (Tier	1) 2 Medium	Impact (Tier 2)	3 Low Impact (T	er 3)
Project Title					Report date: 02/15/23

 1 High Impact (Tier 1)
 2 Medium Impact (Tier 2)
 3 Low Impact (Tier 3)
 Project Title: Report date: 02/15/23
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	Pough-In Electrical Increation	Complian?	Commonts/Accumptions
# & Req.ID	Rough-In Electrical Inspection	Complies?	Comments/Assumptions
5.4.2 EL10] ²	At least 50% of all 125 volt 15- and 20-Amp receptacles are controlled by an automatic control device.	□Complies □Does Not □Not Observable □Not Applicable	Requirement will be met.
3.4.3 EL11] ²	New buildings have electrical energy use measurement devices installed. Where tenant spaces exist, each tenant is monitored separately. In buildings with a digital control system the energy use is transmitted to to control system and displayed graphically.	Complies Does Not Not Observable Not Applicable	Exception: Requirement does not apply.
L0.4.1 EL9] ²	Electric motors meet requirements where applicable.	□Complies □Does Not □Not Observable	Requirement will be met.
		□Not Applicable	
	1 High Impact (Tier 1)	2 Medium Imp	act (Tier 2) 3 Low Impact (Tier 3)

Section # & Req.ID	Final Inspection	Complies?	Comments/Assu
6.4.3.1.1 [FI2] ²	Heating and cooling to each zone is controlled by a thermostat control.	□Complies □Does Not □Not Observable □Not Applicable	Requirement will be met.
6.4.3.1.1 [FI2] ²	Heating and cooling to each zone is controlled by a thermostat control.	□Complies □Does Not □Not Observable □Not Applicable	Requirement will be met.
6.4.3.1.2 [FI3] ³	Thermostatic controls have a 5 °F deadband.	Complies Does Not Not Observable Not Applicable	Requirement will be met.
6.4.3.2 [FI20] ³	Temperature controls have setpoint overlap restrictions.	□Complies □Does Not □Not Observable □Not Applicable	Requirement will be met.
6.4.3.3.1 [FI21] ³	HVAC systems equipped with at least one automatic shutdown control.	□Complies □Does Not □Not Observable □Not Applicable	Requirement will be met.
6.4.3.3.2 [FI22] ³	Setback controls allow automatic restart and temporary operation as required for maintenance.	□Complies □Does Not □Not Observable □Not Applicable	Requirement will be met.
6.4.3.3.4 [FI23] ³	Zone isolation devices and controls.	□Complies □Does Not □Not Observable □Not Applicable	Requirement will be met.
6.4.3.3.4 [FI23] ³	Zone isolation devices and controls.	□Complies □Does Not □Not Observable □Not Applicable	Requirement will be met.
6.4.3.12 [FI200] ³	Air economizer has a fault detection and diagnostics (FDD) system (see details for configuration and operational requirements).	□Complies □Does Not □Not Observable □Not Applicable	Requirement will be met.
6.4.3.12 [FI200] ³	Air economizer has a fault detection and diagnostics (FDD) system (see details for configuration and operational requirements).	□Complies □Does Not □Not Observable □Not Applicable	Requirement will be met.
6.4.3.6 [FI6] ³	When humidification and dehumidification are provided to a zone, simultaneous operation is prohibited. Humidity control prohibits the use of fossil fuel or electricity to produce $RH > 30\%$ in the warmest zone humidified and $RH < 60\%$ in the coldest zone dehumidified.	Complies Does Not Not Observable Not Applicable	Requirement will be met.
6.7.2.1 [FI7] ³	Furnished HVAC as-built drawings submitted within 90 days of system acceptance.	□Complies □Does Not □Not Observable □Not Applicable	Requirement will be met.
	1 High Impact (Tier 1)	2 Medium Impa	act (Tier 2) 3 Low Impact (Tier

Section # & Req.ID	Mechanical Rough-In Inspection	Plans Verified Value	Field Verified Value	Complies?	Comments/Assumptions
6.5.2.4.2 [ME69] ³	Humidification system dispersion tube hot surfaces in the airstreams of ducts or air- handling units insulated >= R- 0.5.			Complies Does Not Not Observable Not Applicable	Exception: Requirement does not apply.
6.5.2.5 [ME70] ³	Preheat coils controlled to stop heat output whenever mechanical cooling, including economizer operation, is active.			Complies Does Not Not Observable Not Applicable	Requirement will be met.
6.5.2.6 [ME106] ³	Units that provide ventilation air to multiple zones and operate in conjunction with zone heating and cooling systems are prevented from using heating or heat recovery to warm supply air above 60°F when representative building loads or outdoor air temperature indicate that most zones demand cooling.			Complies Does Not Not Observable Not Applicable	Requirement will be met.
6.5.4.7 [ME107] ³	Chilled-water cooling coils provide a 15°F or higher temperature difference between leaving and entering water temperatures and a minimum of 57°F leaving water temperature at design conditions			□Complies □Does Not □Not Observable □Not Applicable	Requirement will be met.
6.5.3.1.1 [ME52] ³	HVAC fan systems at design conditions do not exceed allowable fan system motor nameplate hp or fan system bhp.			Complies Does Not Not Observable Not Applicable	Requirement will be met.
6.5.3.1.1 [ME52] ³	HVAC fan systems at design conditions do not exceed allowable fan system motor nameplate hp or fan system bhp.			Complies Does Not Not Observable	Requirement will be met.
6.5.3.3 [ME42] ³	Multiple zone VAV systems with DDC of individual zone boxes have static pressure setpoint reset controls.			Complies Does Not Not Observable	Requirement will be met. See the Mechanical Systems list for values.
6.5.3.3 [ME42] ³	Multiple zone VAV systems with DDC of individual zone boxes have static pressure setpoint reset controls.			Complies Does Not Not Observable	Requirement will be met. See the Mechanical Systems list for values.
6.5.3.3 [ME42] ³	Multiple zone VAV systems with DDC of individual zone boxes have static pressure setpoint reset controls.			Complies Does Not Not Observable Not Applicable	Requirement will be met. See the Mechanical Systems list for values.
6.5.3.5 [ME43] ³	Multiple zone HVAC systems have supply air temperature reset controls.			Complies Does Not Not Observable Not Applicable	Requirement will be met. See the Mechanical Systems list for values.
6.5.3.5 [ME43] ³	Multiple zone HVAC systems have supply air temperature reset controls.			Complies Does Not Not Observable	Requirement will be met. See the Mechanical Systems list for values.

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Section # Req.ID	Mechanical Rough-In Inspection	Plans Verified Value	Field Verified Value	Complies?	Comments/Assumptions	Section # & Req.ID	Mechanical Rough-In Inspection	Plans Verified Value	Field Verified Value	Complies?	Comments/Assumptions
.5.4.2 4E25] ³	HVAC pumping systems with >= 3 control values designed for variable fluid flow (see section details).			Complies Does Not Not Observable Not Applicable	Requirement will be met.	6.4.3.9 [ME63] ²	Heating for vestibules and air curtains with integral heating include automatic controls that shut off the heating system when outdoor air temperatures > 45F.			Complies Does Not Not Observable Not Applicable	Exception: Requirement does not apply.
	Fluid flow shutdown in pumping systems to multiple chillers or boilers when systems are shut down.			Complies Does Not Not Observable Not Applicable	Requirement will be met.		Vestibule heating and cooling systems controlled by a thermostat in the vestibule with heating setpoint <= 60F and cooling setpoint >= 80F.				
	Fluid flow shutdown in pumping systems to multiple chillers or boilers when systems are shut down.			□Complies □Does Not □Not Observable □Not Applicable	Requirement will be met.	6.5.10 [ME73] ³	Doors separating conditioned space from the outdoors have controls that disable/reset heating and cooling system when open.			Complies Does Not Not Observable Not Applicable	Requirement will be met.
.5.4.4 ME27] ³	Temperature reset by representative building loads in pumping systems >10 hp for chiller and boiler systems >300,000 Btu/h.			□Complies □Does Not □Not Observable □Not Applicable	Requirement will be met.	Addition	al Comments/Assumptions:				
.5.4.4 ME27] ³	Temperature reset by representative building loads in pumping systems >10 hp for chiller and boiler systems >300,000 Btu/h.			□Complies □Does Not □Not Observable □Not Applicable	Requirement will be met.						
.5.6.1 ME56] ¹	Exhaust air energy recovery on systems meeting Tables 6.5.6.1- 1, and 6.5.6.1-2.			Complies Does Not Not Observable Not Applicable	Exception: Requirement does not apply.						
.5.6.2 ME31] ³	Condenser heat recovery system that can heat water to 85 °F or provide 60% of peak heat rejection is installed for preheating of service hot water.			□Complies □Does Not □Not Observable □Not Applicable	Requirement will be met.						
.5.6.2 ME31] ³	Condenser heat recovery system that can heat water to 85 °F or provide 60% of peak heat rejection is installed for preheating of service hot water.			Complies Does Not Not Observable Not Applicable	Requirement will be met.						
.5.7.2.1 ME32] ²	Kitchen hoods >5,000 cfm have make up air >=50% of exhaust air volume.			Complies Does Not Not Observable Not Applicable	Exception: Requirement does not apply.						
.5.7.2.4 ME49] ³	Approved field test used to evaluate design air flow rates and demonstrate proper capture and containment of kitchen exhaust systems.			Complies Does Not Not Observable Not Applicable	Requirement will be met.						
.5.8.1 ME34] ²	Unenclosed spaces that are heated use only radiant heat.			Complies Does Not Not Observable Not Applicable	Exception: Requirement does not apply.						
.5.9 ME35] ¹	Hot gas bypass limited to: <=240 kBtu/h - 15% >240 kBtu/h - 10%			□Complies □Does Not □Not Observable □Not Applicable	Requirement will be met.						
	1 High Impact (Tier	1) 2 Medium	Impact (Tier 2)	3 Low Impact (T	ïer 3)		1 High Impact (Tier	1) 2 Medium	Impact (Tier 2)	3 Low Impact (T	ier 3)

Section # & Req.ID	Final Inspection	Complies?	Comments/Assumptions
6.4.3.1.1 [FI2] ²	Heating and cooling to each zone is controlled by a thermostat control.	Complies Does Not Not Observable	Requirement will be met.
6.4.3.1.1 [FI2] ²	Heating and cooling to each zone is controlled by a thermostat control.	□Not Applicable □Complies □Does Not □Not Observable □Not Applicable	Requirement will be met.
6.4.3.1.2 [FI3] ³	Thermostatic controls have a 5 °F deadband.	Complies Does Not Not Observable	Requirement will be met.
6.4.3.2 [FI20] ³	Temperature controls have setpoint overlap restrictions.	Complies Does Not Not Observable Not Applicable	Requirement will be met.
6.4.3.3.1 [FI21] ³	HVAC systems equipped with at least one automatic shutdown control.	Complies Does Not Not Observable Not Applicable	Requirement will be met.
6.4.3.3.2 [FI22] ³	Setback controls allow automatic restart and temporary operation as required for maintenance.	□Complies □Does Not □Not Observable □Not Applicable	Requirement will be met.
6.4.3.3.4 [FI23] ³	Zone isolation devices and controls.	□Complies □Does Not □Not Observable □Not Applicable	Requirement will be met.
6.4.3.3.4 [FI23] ³	Zone isolation devices and controls.	□Complies □Does Not □Not Observable □Not Applicable	Requirement will be met.
6.4.3.12 [FI200] ³	Air economizer has a fault detection and diagnostics (FDD) system (see details for configuration and operational requirements).	□Complies □Does Not □Not Observable □Not Applicable	Requirement will be met.
6.4.3.12 [FI200] ³	Air economizer has a fault detection and diagnostics (FDD) system (see details for configuration and operational requirements).	Complies Does Not Not Observable Not Applicable	Requirement will be met.
6.4.3.6 [FI6] ³	When humidification and dehumidification are provided to a zone, simultaneous operation is prohibited. Humidify control prohibits the use of fossil fuel or electricity to produce $RH > 30\%$ in the warmest zone humidified and $RH < 60\%$ in the coldest zone dehumidified.	Complies Does Not Not Observable Not Applicable	Requirement will be met.
6.7.2.1 [FI7] ³	Furnished HVAC as-built drawings submitted within 90 days of system acceptance.	□Complies □Does Not □Not Observable □Not Applicable	Requirement will be met.
	1 High Impact (Tier 1)	2 Medium Imp	act (Tier 2) 3 Low Impact (Tier 3)

C. Dow IP.	Final Inspection	Complies?	Comments/Assumptions
& Req.ID	Furnished O&M manuals for HVAC		Requirement will be met.
FI8] ³	systems within 90 days of system acceptance.	□Does Not □Not Observable	
		□Not Applicable	
5.7.2.3 FI9] ¹	An air and/or hydronic system balancing report is provided for HVAC	□Complies □Does Not	Requirement will be met.
	systems serving zones >5,000 ft2 of conditioned area.	Not Observable	
5.7.2.4	HVAC control systems have been	□Not Applicable □Complies	Requirement will be met.
FI10] ¹	tested to ensure proper operation, calibration and adjustment of controls.	□Does Not □Not Observable	
		□Not Applicable	
L0.4.3 FI24] ²	Elevators are designed with the proper lighting, ventilation power, and	□Complies □Does Not	Requirement will be met.
	standby mode.	□Not Observable	
ddition	al Comments/Assumptions:	□Not Applicable	i
	1 High Impact (Tier 1)	2 Medium Impa	act (Tier 2) 3 Low Impact (Tier 3)
roject Title		2 Medium Impa	act (Tier 2) <u>3</u> Low Impact (Tier 3) Report date: 02/15/



	CONSULTANT SEAL	CONSULTANT	INFORMATION				
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THESE PLANS ARE APPROVED ONLY FOR THE WORK INDICATED ON THE APPLICATION SPECIFICATION SHEET. ALL OTHER MATTERS SHOWN							
ARE NOT TO BE RELIED UPON OR TO BE CONSIDERED AS EITHER BEING APPROVED OR IN ACCORDANCE WITH APPLICABLE CODES.						TITLE:	
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Construction Site: 110 Dr. Martin Luther Kind E White Plains, NY 10601	Owner/Agent: Blvd	Designer/C	ontractor:				4.2.2, 8.4.1.1, 8.4.1.2, 8.7	Plans, specifica calculations pr with which cor determined for
Allowed Interior Lighting	Power						[PR6] ²	and equipmen exceptions are
	A Area Category	B Floor Area (ft2)	C Allowed Watts / ft2		D wed Watts (B X C)			connectors size approved plan sized for maxin
1-1st Floor Office Area (Office)		9575	0.79		7564		4.2.2, 9.4.3, 9.7	Plans, specifica calculations pr
2-2nd Floor Office Area (Office)		13372	0.79 tal Allowed W		10564 18128		[PR4] ¹	with which cor determined for
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Fixture ID : Desc	ription / Lamp / Wattage Per Lamp / Ballast	Lamps/ Fixture	# of Fixtures	Fixture Watt.	(C X D)			lighting power bulbs and ball
1st Floor Office Area (Office S	9575 sq.ft.)						Addition	control devices
F1: LED: Other: F2: LED: Other:		1	141 7	34 28	4794 196		Addition	ai comments
2nd Floor Office Area (Office	<u>13372 sq.ft.)</u>			20				
F1: LED: Other: F2: LED: Other:		1	146 8	34 28	4964 224			
F4-4': LED: Other:		1	1	27	27			
F4-7': LED: Other:		1	1 Total Propos	48 ed Watts =	48 : 10253	-		
Interior Lighting PASSES	5							
Interior Lighting Complia								
<i>Compliance Statement:</i> The building plans, specifications, systems have been designed	proposed interior lighting alteration project repr , and other calculations submitted with this per to meet the 90.1 (2016) Standard requirement quirements listed in the Inspection Checklist.	nit application. The	proposed in	terior ligh	iting			
Name - Title	Signature		Date					
								1
Project Title: Dr. Martin Lu	ther King Jr. Blvd	:HECK\2023.02.15 L		Report da Page	te: 02/15/23 e 1 of 5		Project Titl Data filena	e: Dr. Martin me: F:\19XXX\2

Section # & Req.ID	Final Inspection	Complies?	Comments/Assumptions
8.7.1 [FI16] ³	Furnished as-built drawings for electric power systems within 30 days of system acceptance.	□Complies □Does Not □Not Observable □Not Applicable	Requirement will be met.
8.7.2 [FI17] ³	Furnished O&M instructions for systems and equipment to the building owner or designated representative.	□Complies □Does Not □Not Observable □Not Applicable	Requirement will be met.
9.2.2.3 [FI18] ¹	Interior installed lamp and fixture lighting power is consistent with what is shown on the approved lighting plans, demonstrating proposed watts are less than or equal to allowed watts.	□Complies □Does Not □Not Observable □Not Applicable	See the Interior Lighting fixture schedule for values.
9.4.4 [FI20] ¹	At least 75% of all permanently installed lighting fixtures in dwelling units have >= 55 Im/W efficacy or a >= 45 Im/W total luminaire efficacy.	□Complies □Does Not □Not Observable □Not Applicable	Exception: Requirement does not apply.

Additional Comments/Assumptions:

1 High Impact (Tier 1)	2	Medium Impact (Tier 2)	3	Low Impact (Tier 3)

COM*check* **Software Version 4.1.5.5** Inspection Checklist

Energy Code: 90.1 (2016) Standard

: 100.0% were addressed directly in the COM*check* software


ments/Assumptions" column is provided by the user in the COMcheck Requirements screen. For each e user certifies that a code requirement will be met and how that is documented, or that an exception . Where compliance is itemized in a separate table, a reference to that table is provided.

Plan Review	Complies?	Comments/Assumptions
, specifications, and/or lations provide all information which compliance can be mined for the electrical systems quipment and document where otions are claimed. Feeder ectors sized in accordance with wed plans and branch circuits for maximum drop of 3%.	□Complies □Does Not □Not Observable □Not Applicable	Requirement will be met.
, specifications, and/or lations provide all information which compliance can be mined for the interior lighting lectrical systems and equipment ocument where exceptions to andard are claimed. Information ded should include interior ng power calculations, wattage of and ballasts, transformers and ol devices.	□Complies □Does Not □Not Observable □Not Applicable	Requirement will be met.
mments/Assumptions:		
1 High Impact (Tier 1)	2 Medium Impa	act (Tier 2) 3 Low Impact (Tier 3)
r. Martin Luther King Jr. Blvd :\19XXX\19020.00 110 Dr. Martin omcheck.cck	Luther King Jr. Blvc	Report date: 02/15/23 COMCHECK\2023.02.15 Lighting Page 2 of 5

Section # & Req.ID	Rough-In Electrical Inspection	Complies?	Comme
8.4.2 [EL10] ²	At least 50% of all 125 volt 15- and 20-Amp receptacles are controlled by an automatic control device.	□Complies □Does Not □Not Observable □Not Applicable	Exception: Requirement
8.4.3 [EL11] ²	New buildings have electrical energy use measurement devices installed. Where tenant spaces exist, each tenant is monitored separately. In buildings with a digital control system the energy use is transmitted to to control system and displayed graphically.	Complies Does Not Not Observable Not Applicable	Exception: Requirement
9.4.1.1 [EL1] ²	Automatic control requirements prescribed in Table 9.6.1, for the appropriate space type, are installed. Mandatory lighting controls (labeled as 'REQ') and optional choice controls (labeled as 'ADD1' and 'ADD2') are implemented.	□Complies □Does Not □Not Observable □Not Applicable	Requirement will be met.
9.4.1.1 [EL2] ²	Independent lighting controls installed per approved lighting plans and all manual controls readily accessible and visible to occupants.	□Complies □Does Not □Not Observable □Not Applicable	Requirement will be met.
9.4.1.1f [EL13] ¹	Daylight areas under skylights and roof monitors that have more than 150 W combined input power for general lighting are controlled by photocontrols.	□Complies □Does Not □Not Observable □Not Applicable	Requirement will be met.
9.4.1.3 [EL4] ¹	Separate lighting control devices for specific uses installed per approved lighting plans.	□Complies □Does Not □Not Observable □Not Applicable	Requirement will be met.
9.6.2 [EL8] ¹	Additional interior lighting power allowed for special functions per the approved lighting plans and is automatically controlled and separated from general lighting.	□Complies □Does Not □Not Observable □Not Applicable	Requirement will be met.

Additional Comments/Assumptions:

 1
 High Impact (Tier 1)
 2
 Medium Impact (Tier 2)
 3
 Low Im
 Project Title: Dr. Martin Luther King Jr. Blvd Data filename: F:\19XXX\19020.00 110 Dr. Martin Luther King Jr. Blvd\COMCHECK\2023.02.15 Lig Comcheck.cck

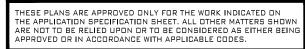



ents/Assumptions
does not apply.
does not apply.
npact (Tier 3)
Report date: 02/15/23
ighting Page 3 of 5

	CONSULTANT SEAL		CONSULTANT	INFORMATION					
	C OF NEW JOY			Graf & Lewent Architects LLP 90-30 161st Street, Jamaica, NY 11432 P: 718-651-6200 F: 718-251-6989					
	REVISION NUMBER	DATE	MADE BY			REVIS	SION		
		- CHANGES	S AS NOTED		(AVVIN)	G CERTIFICATION			
	NAME:					NAME:			
FOR THE WORK INDICATED ON EET. ALL OTHER MATTERS SHOWN BE CONSIDERED AS EITHER BEING APPLICABLE CODES.	SIGNATURE: TITLE:					SIGNATURE:	DATE:		
IISE					VEW YO D TRAN		CONTRACT NUMBER 20-502	SHEET NUMBER	
G ENGINEERS DPC 133 WEST 19TH STREET NEW YORK, NY 10011	LOW	RISE BUILD 110 DR. I	NVISION (ING RENOV/ MARTIN LUT WHITE PLAIN	ATIONS AND HER KING, J) HVAC II IR. BOUL	MPROVEMENTS - PHASE II LEVARD	SCALE: AS NOTED DATE: JAN 19, 2024	2 OF 133	
TEL 212.645.1002 www.polisece.com			NERGY C				DPW FILE NO. 52-11-EI	N-1884 NO. 0	

							VA	AV I	30X	WITH 1	RO	W HYI	DRONI	C COIL	ANEMOSTAT AS S
	PRIM	IARY AIR V	ALVE	НС	OT MATE	R COIL				PHYSICAL SIZE					
мвоц			MIN	NT H20 NO	GPM	AIR TEMP RISE	AIR	INLE	T SIZE	DUCT DISCHARE	ΞE	BOX DIMENS	BION	MANUFACTURER MODEL	REMARKS:
	MIN CFM	MAX CFM	S.P. IN.W.G.	LVG ROV	NS Ho P.I FT.W			DIAI	METER	М×Н	(INC	L X W X	H Rol Box)	NUMBER	
VAV 1	60	300		20 100 1	1	-/	0.07		5Φ	1 <i>0</i> " × 1 <i>0</i> "		215/8" × 161/2	"× 1 <i>0</i> "	EZTS	PROVIDE THE FOLLOWING FACTORY OPTIONS (TYPICAL FOR ALL SIZES)
VAV 2	90	450	0.23	20 100	1	2 -	0.23		6Ф	1 <i>0</i> " × 1 <i>0</i> "		21 ⁵ ⁄8" x 16 ¹ ⁄2	"× 1 <i>0</i> "	EZTS	1. FACTORY MOUNTED DDC CONTROLS
VAV 3	160	700	0.25	20 100	2	- 9 -	0.24		8 Φ	12" x 1 <i>0</i> "		215/×181/2	"× 1 <i>0</i> "	EZTS	(PROVIDED BY BMS) 2. 1 ROW HOT WATER COIL
VAV 4	270	1,000	0.24	20 100 1	2	- q -	0.23	1	ΟΦ	14" × 12 ¹ ⁄2"		235/ 201/ ×	12 ¹ /2"	EZTS	3. INSULATED HINGED BOTTOM ACCESS DOOR 4. 1" DUAL DENSITY MATTE FACED FIBERGLASS INSULATION
VAV 5	360	1,400	0.25	20 100	3	5 -	0.23	1	2Φ	16" × 15"		275/ 225	x 15"	EZTS	5. 24V ACTUATORS - ACTUATORS WIRED BY BMS
	1									FAN SC	HED	ULE		1	GREENHECK AS STD.
NO	SEF	RVICE	LOCATION	TOTAL AIR CFM	FAN SPEED RPM	EXT. STATIC PRESS		HP	SPEED RPM	MODEL NO.	WEIGHT LBS.	DIMENSIONS (LXWXH)	DRIVE	ELECTRIC DATA VOLTS / PHASE	REMARKS:
RF		0 # 3RD 00R5	MECH ROOM	11000	793	1.25	3.58	5	800	5Q-30-07- 0700-VG	478	43.00"X 43.00"X 43.00"	DIRECT		DE DITCH, NEMA-3R, TOGGLE SHIPPED WITH UNIT /FD NTEGRAL DISCONNECT
6		, 2ND ∉ FLOORS	MECH ROOM	27300	1338	1.75	14.76	15	1725	TBI-FS-5H54 -150	990	38.75"X 31.88"X 64.63"	BELT		GWITCH, NEMA-3R, TOGGLE SHIPPED WITH UNIT /FD NTEGRAL DISCONNECT
	3RD			980	1725	1.0	0.29	1/4	1725	G-100-VG	40	24.40"X 24.40"X	DIRECT	2.	SWITCH, NEMA- 1, TOGGLE, SHIPPED WITH UNIT. VARI-GREEN DIAL INTEGRAL ISOLATION DAMPER 5. INTEGRAL
6 RF	1 5T \$ 2	ND FLOOR HROOMS	ROOF	980								23.70"		4.1	MANUFACTURER'S ROOF CURB DISCONNECT

							VA	AV I	30X	WITH 1	RO	W HYI	ORONI	C COIL	ANEMOSTAT AS S
	PRIM	ARY AIR VA	LVE	НС	OT WATER	R COIL				PHYSICAL SIZE					
тмвоц			MIN	ENT H20 NO	GPM	AIR TEMP RISE	AIR	INLE	T SIZE	DUCT DISCHARG	E	BOX DIMENS	BION	MANUFACTURER MODEL	REMARKS:
	MIN CFM	MAX CFM	S.P. IN.W.G.	LVG ROV			P.D.	DIAN	METER	M×H	(INC)	L X W X UDING CONTI	H Rol Box)	NUMBER	
/A∨ 1	60	300	0.27	120 100 1	1	2 -	0.07	!	5Φ	1 <i>0</i> " × 1 <i>0</i> "		21 ⁵ ⁄8" x 16 ¹ ⁄2'	'× 1 <i>0</i> "	EZTS	PROVIDE THE FOLLOWING FACTORY OPTIONS (TYPICAL FOR ALL SIZES)
√A∨ 2	90	450	0.23	120 100 1	1	2 -	0.23	ł	6Ф	1 <i>0</i> " × 1 <i>0</i> "		21 ⁵ ⁄8" x 16 ¹ ⁄2	'× 1 <i>0</i> "	EZTS	1. FACTORY MOUNTED DDC CONTROLS
VAV 3	160	700	0.25	120 100 1	2		0.24	ä	вΦ	1 <i>2</i> " × 1 <i>0</i> "		21 ⁵ ⁄8" x 18 ¹ ⁄2'	'× 1 <i>0</i> "	EZTS	(PROVIDED BY BMS) 2. 1 ROW HOT WATER COIL
VAV 4	270	1,000	0.24	120 100 1	2		0.23	1	<i>Ο</i> Φ	14" x 12 ¹ ⁄2"		235g" 2012" x	12 ¹ /2"	EZTS	3. INSULATED HINGED BOTTOM ACCESS DOOR 4. 1" DUAL DENSITY MATTE FACED FIBERGLASS INSULATION
VAV 5	360	1,400	0.25	120 100 1	3	5 -	0.23	1	2Φ	16" x 15"		275/2222	x 15"	EZTS	5. 24V ACTUATORS - ACTUATORS WIRED BY BMS
			=	AN DATA				MOTOR		FAN SCI	HED	ULE			GREENHECK AS STD.
NO	SER	RVICE	LOCATION	TOTAL	FAN SPEED RPM	EXT. STATIC PRESS	внр	HP	SPEED RPM	MODEL NO.	NEIGHT LBS.	DIMENSIONS (LXMXH)	DRIVE	ELECTRIC DATA VOLTS / PHASE	REMARKS:
										5Q-30-07-		43.00"X	DDECE		WITCH, NEMA-3R, TOGGLE SHIPPED WITH UNIT
RF 6		0 & 3RD OORS	MECH R <i>OO</i> M	11000	793	1.25	3.58	5	800	0700-VG	478	43.00"X 43.00"	DIRECT	3 3. IN	
	FLo 1ST			1 1 <i>000</i> 273 <i>00</i>			3.58 14.76	5	800 1725	0700-VG	478 990		BELT	3 3. IN 460 1. S	
6 RF	FL 15T 3RD 15T # 2	00RS , 2ND \$	ROOM MECH							0700-VG TBI-FS-5H54		43.00" 38.75"X 31.88"X		3 3. IN 460 1. 5 2. V 3 3. IN 1 15 1. 5 2. V 3. IN 1 15 2. V 3. IN 1 3. IN	/FD NTEGRAL DISCONNECT WITCH, NEMA-3R, TOGGLE SHIPPED WITH UNIT

							RA	DIAT	OR	SCHEDULE		
N	0	DESCRIPTION	BTU PER LIN. FT. OF ELEMENT	ENT H20 LVG H20	FINNED LENGTH	FIN SIZE H × W	NORMAL TUBE DIA.	NO. OF ROWS	FIN THICK FINS PER FT.	ENCLOSURE H x W	MODEL NO.	REMARKS:
BI 1,	<u>- </u>	JLCAN NOVECTOR II	1060	180 160	36"	2–1/2X 2–3/4	3/4"	1	0.01 60	_	VR02	BARE ELEMENT


							SP	LIT	SYS	ГЕМ	SCHEDU	JLE								D	AIKIN AS STD
					IND00	R EVAPOR	ATOF	R UNIT DA	ATA					OUTD	OORCO	NDENSING	UNIT DA	ATA			
EVAP No.	LOCATION & SERVICE	TYPE	EVAPORATOR MODEL NUMBER	SUPPLY CFM H/L	HEATING CAPACITY MBTU	COOLING CAPACITY MBTU	ESP	VOLTS PHASE	MAX	WEIGHT (LBS)	DIMENSIONS (LXMXH)	COND UNIT NO.	CONDENSER MODEL NUMBER	CAPACIT		VOLTS M		COMP. RLA	ARI SEER	WEIGHT (LBS)	DIMENSIONS (LXWXH)
EVAP 30	ELEVATOR MACHINE ROOMS	WALL MOUNTED	FTX30NVJU	890/ 572	34.8	31.4	-	208		38	47-1/4x 10-3/16x 13-3/8	CU 30	RX30NMVJU	31.4	34.8	208 1	9.8 20	18.25	17.50	133	34-1/4x 12-5/8x 28-15/16


ALL UNITS PROVIDED WITH R-410A REFRIGERANT. ALL REFRIGERANT PIPE SIZING AND ROUTING TO BE PER MANUFACTURER BASED ON FINAL FIELD CONDITIONS AND ROUTING. -MANUFACTURER'S STANDALONE CONTROLS WITH BMS INTERFACE FOR MONITORING. -INTEGRAL DISCONNECT -INTEGRAL CONDENSATE PUMP

		DRAWING-ISSUE LIST					
Sheet #	Latest DOB Rev #	Sheet Title	2022.08.31 100% SUBMISSION	2023.02.15 RESPONSE TO MESCHESTER COMMENTS	2023.08.04 RESPONSE TO MESCHESTER COUNTY COMMENTS	2023.11.01 RESPONSE TO MESCHESTER COUNTY COMMENTS	
M-010		SYMBOLS, ABBREVIATIONS, SCHEDULES AND NOTES	×	×	×	×	_
M-011		SCHEDULES	×	X	×	×	
M-020		DETAILS	×	×	×	×	-
M-021		DETAILS	×	X	×	X	
M-039	.00	CHILLER ROOM MECHANICAL DEMOLITION PLAN	×	×	×	X	
M-042	.00	1ST FLOOR CENTRAL WING MECHANICAL DEMOLITION PLAN	×	×	×	X	
M-043	.00	1ST FLOOR NORTH WING MECHANICAL DEMOLITION PLAN	×	×	×	X	
M-044	.00	2ND FLOOR CENTRAL WING MECHANICAL DEMOLITION PLAN	×	×	×	×	
M-045	.00	2ND FLOOR NORTH WING MECHANICAL DEMOLITION PLAN	×	×	×	×	
M-052	.00	1ST FLOOR CENTRAL WING MECHANICAL PIPING DEMOLITION PLAN	×	×	×	×	
M-053	.00	1ST FLOOR NORTH WING MECHANICAL PIPING DEMOLITION PLAN	×	×	×	×	
M-054	.00	2ND FLOOR CENTRAL WING MECHANICAL PIPING DEMOLITION PLAN	×	×	×	X	
M-055	.00	2ND FLOOR NORTH WING MECHANICAL PIPING DEMOLITION PLAN	×	×	×	X	
M-098		BOILER ROOM MECHANICAL PLAN	×	×	×	X	
M-099		CHILLER ROOM MECHANICAL PLAN	×	×	×	X	
M-101		2ND SUBGRADE GARAGE MECHANICAL PLAN	×	×	×	X	
M-102		1ST FLOOR CENTRAL WING MECHANICAL PLAN	×	×	×	×	
M-103		1ST FLOOR NORTH WING MECHANICAL PLAN	×	X	×	X	
M-104		2ND FLOOR CENTRAL WING MECHANICAL PLAN	×	X	X	X	
M-105		2ND FLOOR NORTH WING MECHANICAL PLAN	X	X	X	X	_
M-106		3RD FLOOR & ROOF MECHANICAL PART PLAN	X	X	X	X	_
M-130		PARTIAL BASEMENT MECHANICAL PLAN - 110 MLK BLVD	×	×	×	×	+
M-131		PARTIAL ROOF MECHANICAL PLAN - ELEVATOR HOISTWAY - 110 MLK BLVD	×	×	×	×	+
M-135 M-137		ROOF MECHANICAL PLAN - ELEVATOR MACHINE ROOM - 111 MLK BLVD	×	×	×	×	_
M-137 M-138		BASEMENT MECHANICAL PLAN - ELEVATOR - 143 GRAND STREET 3RD FLOOR & ROOF MECHANICAL PLAN - 143 GRAND STREET	×	× ×	× ×	× ×	+
M-150 M-202		1ST FLOOR & ROOF MECHANICAL FLAN - 145 GRAND STREET	×				+
M-202 M-203		1ST FLOOR VORTH WING MECHANICAL PIPING PLAN		×	×	×	_
M-205 M-204		2ND FLOOR CENTRAL WING MECHANICAL FIFING FLAN	×	×	×	×	+
M-204 M-205		2ND FLOOR CENTRAL MING MECHANICAL FIFING FLAN 2ND FLOOR NORTH WING MECHANICAL PIPING PLAN	×	× ×	X X	X X	+

	ABBREVIATI	ONS			SYMBO	L LIST	
				SYMBOL	DESCRIPTION	SYMBOL	DESCRIPTION
BBREV. 	DESCRIPTION AIR CONDITIONING CONTRACTOR	ABBRE	P.DESCRIPTION FEET		NEW DUCTWORK- REFER TO SPECIFICATIONS FOR INSULATION	—	INDICATES REMOTE DAMPER WITH CABLE OPERATOR
A.D. AFF	ACCESS DOOR ABOVE FINISH FLOOR	GA. G.C.	GAUGE GENERAL CONTRACTOR		NEW DUCTWORK MADE WITH		FUSIBLE LINK DAMPER
AL	ALUMINUM DUCTWORK	G.I.	GALVANIZED IRON		ALUMINUM OR STAINLESS STEEL		COMBINATION MOTORIZED SMC
ALD A.L.W.S.M.S	AUTOMATIC LOUVER DAMPER ALUMINUM LOUVER AND	GPM H.C.	GALLONS PER MINUTE HEATING COIL				AND FIRE DAMPER AUTOMATIC LOUVER DAMPER
A.P.	MIRE MESH SCREEN ACCESS PANEL	H.CLG. H.E.	HUNG CEILING HEAT EXCHANGER	$\frac{1}{2}$ - $\frac{1}{2}$	ROUND DUCTWORK	ALD	VOLUME DAMPER
ATC	AUTOMATIC TEMPERATURE CONTROLS	H.P.	HORSE POWER			I	
B.B. B.F.	BASE BOARD RADIATION BLIND FLANGE	H.P.R. H.P.S.	HIGH PRESSURE STEAM RETURN HIGH PRESSURE STEAM SUPPLY		EXISTING DUCTWORK	S- CHWS -S	CHILLED/HOT WATER SUPPLY
B.G.	BOTTOM GRILLE	HT.	HEIGHT	<u> </u>		S- CHWR -	CHILLED/HOT WATER RETURN
B.I. BLDG.	BLACK IRON BUILDING	HVAC	HEATING VENTILATING AND AIR		EXISTING DUCTWORK TO REMAIN	, → HWS →	HOT WATER SUPPLY
BMS	BUILDING MANAGEMENT SYSTEM	HMR	HOT WATER RETURN			∽— HWR —→	HOT WATER RETURN
В. <i>О.</i> С.С.	BLANK OFF COOLING COIL	HMS HTHMR	HOT WATER SUPPLY HIGH-TEMP HOT WATER RETURN			۶−−− HTHWS −−−−۶	HIGH-TEMP HOT WATER SUPPLY
CD	CEILING DIFFUSER	HTHMS			FLEXIBLE DUCTMORK	5	HIGH-TEMP HOT WATER RETURN
C.F.M. CH	CUBIC FEET PER MINUTE CABINET HEATER	I.B. IN.	INTERNAL BOOT INCHES			ςγς	VENT ON RELIEF LINE
CHMR	CHILLED/HOT WATER RETURN CHILLED/HOT WATER SUPPLY	KE	KITCHEN EXHAUST		DUCT UP	, , , , , , , , , , , , , , , , , , ,	
CHMS CLG	CEILING	LB. LPR	POUND LOW PRESSURE STEAM RETURN				
C.L.O. C.O.	CLEAN OUT CAPPED OUTLET	LPS M.B.H.	LON PRESSURE STEAM SUPPLY	X	DUCT DOWN	∽ D →	
C.O.D.	CLEAN OUT DOOR	M.D.H. M.C.C.	MOTOR CONTROL CENTER			∽ cw →	CITY WATER
CP CR	CONDENSATE PUMP CEILING REGISTER	MD M.P.R.	MOTORIZED DAMPER MEDIUM PRESSURE STEAM RETURN		SUPPLY AIR DUCT	0 	PIPE UP
CT	COOLING TOWER	0.A.	OUTLET AIR		SUPPLI AIR DUCT	C +	PIPE DOWN
CM CMR	CITY COLD WATER CONDENSER WATER RETURN	0.A.I. 0.V.	OUTSIDE AIR INTAKE			×	PIPE STUB UP
CMS	CONDENSER WATER SUPPLY	P.C.	PLUMBING CONTRACTOR		RETURN OR EXHAUST DUCT	· · ·	FLOW DIRECTIONS
D DIA.	DRAIN DIAMETER	PD P.H.C.	PUMP DISCHARGE PRE-HEAT COIL				PITCH PIPE UP OR DOWN
DN	DOWN	P.O.	PLUGGED OUTLET		SUPPLY DIFFUSER	+	
DNG EF	DRAWING EXHAUST FAN	P.R.∨. P.S.I.	PRESSURE REDUCING VALVE POUNDS PER SQUARE INCH			·	FULL PORT BALL VALVE
EH	ELECTRICAL HEATER	P.T.	PITOT TUBE		RETURN REGISTER	∕ √	GATE VALVE
ELEC. ELEC.CONTR	ELECTRICAL ELECTRIC CONTRACTOR	R.A. R.A.G.	RETURN AIR RETURN AIR GRILLE			∽	GLOBE VALVE
ELEV.	ELEVATION	R.H.C.	RE-HEAT COIL		SIDE WALL SUPPLY GRILLE	∽₋−Ι∇⊢−−⊰	LUBRICATED PLUG COCK
EQUIP. EXH.	EQUIPMENT EXHAUST	S.A. S.P.	SUPPLY AIR STATIC PRESSURE		SIDE MALL SUIT ET GRIELE	∽_ °\ ≾	CHECK VALVE
EXIST F	EXISTING FILTER		SPRINKLER CONTRACTOR	T [\] T_		∽ ∽ ∧	RELIEF VALVE
F.A.I.	FRESH AIR INTAKE	SQ.FT. T.C.	SQUARE FEET TOP CONNECTION		SIDE WALL EXHAUST GRILLE	· 수 ·	AIR VENT (H= HI-CAPACITY)
F.B.O.	FURNISH BY OTHERS	T.D.	TRANSFER DUCT			, <u>, , , , , , , , , , , , , , , , , , </u>	
FC FD	FLEXIBLE CONNECTION FLOOR DRAIN	T.G. T.R.	TOP GRILLE TOP REGISTER	T	BMS THERMOSTAT	· · · · · · · · · · · · · · · · · · ·	UNION FITTING
FFD	FUNNEL DRAIN FLOOR	TR.GR.					
FL F.L.	FLOOR FINNED LENGTH	U.A. U.H.	UNDERWRITER'S APPROVED UNIT HEATER	5	BMS TEMPERATURE SENSOR	└ ,`\$,	COMBINATION FULL PORT BALL
FLD F.L.T.G.	FUSIBLE LINK DAMPER FUSIBLE LINK TOP GRILLE	V.D. V.F.D.	VOLUME DAMPER (MANUAL) VARIABLE FREQUENCY DRIVE				VALVE WITH P&T PLUGS
F.L.T.R.	FUSIBLE LINK TOP REGISTER	V.F.D. V.O.	VARIABLE FREQUENCE DRIVE VALVED OUTLET		COMBINATION THERMOSTAT,	0	2-WAY AUTOMATIC
FSD	COMBINATION MOTORIZED FIRE & SMOKE DAMPER	M.M.S. M.U.	MIRE MESH SCREEN MINDOM UNIT	Ū	HUMIDITY SENSOR, AND CO2 SENSOR	\rightarrow	CONTROL VALVE
		7 1.0.			SELF CONTAINED	<u>.</u> नि.	3-WAY AUTOMATIC
				\mathbb{T}_{S}	PROGRAMMABLE THERMOSTAT	└ └── ╲	CONTROL VALVE
						~~~~	
				$(\mathbb{T})$	TEMPERATURE SENSOR		STRAINER WITH BLOWDOWN VALVE
						*	VALVE
				Ē	COMBINATION TEMPERATURE	¢v	CONTROL VALVE STATION
					AND HUMIDITY SENSOR		SEE RESPECTIVE DETAIL
					COMBINATION TEMPERATURE		OUTDOOR SOLAR AND
					CO2 SENSOR	ST	TEMPERATURE SENSOR
				θ	HUMIDISTAT	E B	CEILING MOUNTED BMS OCCUPANCY SENSOR
				(H)	HUMIDITY SENSOR	(T	OUTDOOR SOLAR AND TEMPERATURE SENSOR
				SP	STATIC PRESSURE TRANSMITTER	CO	CO2 SENSOR
				(Ţ)	EXISTING THERMOSTAT		BEAM CUT

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CONSULTANT SEAL		CONSULTANT	INFORMATION				
COF NEL CUNCE COF NEL CUNCE Soft Office Content Content Conten			90	)-30 1	<b>C &amp; Lewen</b> Architects LL 61st Street, Jamaica, 3-651-6200 F: 718-2	2 <b>P</b>	
REVISION NUMBER	DATE	MADE BY	APP'D BY		REVISI	ON	
		RE	CORD DR	AWIN	G CERTIFICATION		
	_T - CHANGE						
	CONTF	RACTOR			CONT	RACTOR	
NAME:					NAME:		
SIGNATURE:					SIGNATURE:		
					TITLE:		
DE		STCHESTER OF PUBLIC V	,		RK SPORTATION	CONTRACT NUMBER 20-502	sheet number <b>M-010</b>
	C		OF ENGIN	IEERII	NG	SHEET NO. 73	OF 133
LO	110 DR.	DING RENOV MARTIN LUT WHITE PLAIN	HER KING, J	IR. BOUI		SCALE: AS NOTED DATE: JAN 19, 2024	
SYM					LES AND NOTES	DPW FILE NO. 52-11-M-	1885 REV NO. 0

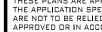INDICATES NEW CONNECTION TO EXISTING

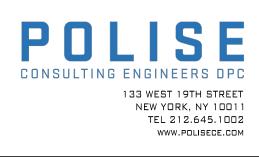INDICATES CAPPED CONNECTION OFF EXISTING

AREA OPEN REQUIRED FOR RETURN AIR IN SQUARE FEET FREE AREA.

(XX)

THESE PLANS ARE APPROVED ONLY FOR THE WORK INDICATED ON THE APPLICATION SPECIFICATION SHEET. ALL OTHER MATTERS SHOWN ARE NOT TO BE RELIED UPON OR TO BE CONSIDERED AS EITHER BEING APPROVED OR IN ACCORDANCE WITH APPLICABLE CODES.

					DUCT INSULATION	SCHEI	DULE							
					SPECIFIED INSULATION							CODE REQUIR ASHRAE 90.1		
DUCT LOCATION			PLY AIR DUCTWO				RETURN AIR DUCTWO	RK			HTG SUPPLY SUPPLY	CLG SUPPLY	HTG / CLG	RETURN
		TYPE (SEE SPECS FOR ADD'L DETAILS)	THICKNESS (INCH)	R - VALUE	REMARKS		TYPE (SEE SPECS FOR ADD'L DETAILS)	THICKNESS (INCH)	R - VALUE	REMARKS				
CONDITIONED SPACE	D-1	MINERAL FIBER BLANKET	1.5	4.5	REQUIRED WHERE DUCT IS NOT INTERNALLY LINED	-	-	1.5	4.5	NOT REQUIRED	NR	NR	NR	NR
UNCONDITIONED SPACE [A]	D-1	MINERAL FIBER BLANKET	2	6.0		D-1	MINERAL FIBER BLANKET	2	6.0		NR	R-1.9	R-3.5	NR

DUCTWORK CONVEYING OUTDOOR AIR TO BE INSULATED WITH TYPE D-1 MINERAL FIBER BLANKET INSULATION MINIMUM 2" THICK PROVIDING VALUE OF R-6 2. PLENUMS FOR OUTDOOR AIR INTAKE OR RELIEF/EXHAUST AIR WHICH ARE EXPOSED TO OUTDOOR AIR TO BE INSULATED WITH TYPE D-1 MINERAL FIBER BLANKET 2" THICK W/ R-VALUE OF 6 OR D-2 MINERAL FIBER BOARD 1.5" THICK W/ R-VALUE OF 6.5. PROVIDE WATER PROOF FOIL SCRIM AND INSURE EXTERIOR FACING IS WATER PROOF AFTER INSTALLATION.

									PII	PE INSULATION SCHED	ULE								
			CODE REQUIREMENT	(ASHRA	E 90.1-201	3)						SPECIFIED INS	BULATIO	N					
	FLUID		INSULATION		NOMINAL	. PIPE SIZE (I	INCHES)			INS	BULATION					NOMINA	AL PIPE SIZE (INC	HES)	
APPLICATION	OPERATING TEMP	MEAN RATING TEMP	CONDUCTIVITY BTU.IN /(H.FT2.°F)	0.75	1.0 to 1.25	1.5 to 3.5	4.0 to 7.0	≥8.0			Jacket Type (Interior	Jacket Type (Exterior			0.75	1.0 to 1.25	1.5 to 3.5	4.0 to 7.0	≥8.0
	(°F)	(°F)	BTU.IN /(H.FT2.F)		INSULATION	1 THICKNESS	S (INCHES)				Installation)	Installation)				INSULATIO	ON THICKNESS (II	NCHES)	
CHILLED WATER	40-60	75	0.21-0.27	0.5	0.5	1.0	1.0	1.0	P-1	MINERAL-FIBER	LEA	0.16" Aluminum	75	0.23	0.5	1.0	1.0	1.0	1.0
HEATING HOT WATER	105-140	1 <i>00</i>	0.22-0.28	1.0	1.0	1.5	1.5	1.5	P-1	MINERAL-FIBER	LEA	O.16" Aluminum	1 <i>00</i>	0.24	1.0	1.0	1.5	1.5	1.5
HEATING HOT WATER	141-200	125	0.25-0.29	1.5	1.5	2.0	2.0	2.0	P-1	MINERAL-FIBER	LSA	O.16" Aluminum	125	0.25	1.5	1.5	2.0	2.0	2.0
CONDENSATE DRAIN	40-60	-	NR	NR	NR	NR	NR	NR	P-3	CLOSED CELL FLEXIBLE ELASTOMERIC	NOT REQUIRED	0.16" Aluminum	75	0.245	0.5	0.5	0.5	0.5	0.5
STEAM	201-250	150	0.27-0.30	2.5	2.5	2.5	3.0	3.0	P-1	MINERAL-FIBER	LCA	0.16" Aluminum	150	0.26	2.0	2.0	2.5	2.5	2.5

NOTES:

NR - NOT REQUIRED BY CODE

1. TYPE P-1: MINERAL FIBER, PREFORMED PIPE INSULATION:

EXPOSED STAPLES WILL BE ALLOWED. FIBERGLASS INSULATION SHALL BE INSTALLED IN ALL AREAS WHERE THE PIPING SYSTEM IS EXPOSED WITHIN DUCTS OR IN RETURN AND SUPPLY AIR PLENUMS. PROVIDE ONE OF THE FOLLOWING: FIBREX INSULATIONS INC.; COREPLUS 1200., JOHNS MANVILLE; MICRO-LOK HP TYPE I, 850 DEG F MATERIALS: MINERAL OR GLASS FIBERS BONDED WITH A THERMOSETTING RESIN. COMPLY WITH ASTM C 547, TYPE I, GRADE A. TYPE II, 1200 DEG F MATERIALS: MINERAL OR GLASS FIBERS BONDED WITH A THERMOSETTING RESIN. COMPLY WITH ASTM C 547, TYPE II, GRADE A.

B. PRODUCTS: SUBJECT TO COMPLIANCE WITH REQUIREMENTS, TRYMER 2000 XP BY ITW INSULATION, POLYISOCYANURATE FOAM PIPE INSULATION WITH THERMAL CONDUCTIVITY (K FACTOR) NOT EXCEEDING 0.19 (BTU X IN) / (HR X FT 2 X DEG F) AT 75 DEG F MEAN TEMPERATURE. INSULATION SHALL BE JACKETED WITH SARAN, 560 OR 520 PVDC VAPOR RETARDER TAPE AND FILM WITH SELF SEALING TAPE. ASJ PAPER IS NOT ACCEPTABLE. EACH 36"LONG PIPE INSULATION SECTION SHALL BE ADDITIONALLY SECURED WITH FILAMENT TAPE OR 2" SARAN TAPE DOUBLE-WRAPPED CENTERED ON 15". VAPOR BARRIER MASTIC SHALL BE FOSTER 85-20 OR CHILDERS CP-35. ADHESIVE FOR LAPS SHALL BE FOSTER 85-75 OR CHILDERS CP-82. PUMPS, VALVES AND FITTINGS SHALL BE THE FABRICATED TRYMER WITH 20 X 20 GLASS FABRIC SEALED WITH FOSTER 80-20 VAPOR BARRIER MASTIC. TYPE B POLYISOCYANURATE FOAM INSULATION SHALL BE INSTALLED ONLY ON CHILLED AND HEATING HOT WATER PIPING (NOT EXCEEDING 300 DEG F) OR EQUAL. COMPARABLE PRODUCTS SUBJECT TO COMPLIANCE WITH THE REQUIREMENTS BY ONE OF THE FOLLOWING: APACHE PRODUCTS COMPANY, DUNA USA INC, DUPONT, ELLIOT COMPANY

IL COMPLY WITH ASTM C 591, TYPE I OR TYPE IV, EXCEPT THERMAL CONDUCTIVITY (K-VALUE) SHALL NOT EXCEED 0.19 BTU X IN./H X SQ. FT. X DEG F AT 75 DEG F AFTER 180 DAYS OF AGING. FLAME-SPREAD INDEX SHALL BE 25 OR LESS AND SMOKE-DEVELOPED INDEX SHALL BE 50 OR LESS FOR THICKNESS UP TO 1-1/2 INCHES AS TESTED BY ASTM E 84. IV. FABRICATE SHAPES ACCORDING TO ASTM C450 AND ASTM 585

3. TYPE P-3: FLEXIBLE ELASTOMERIC: CLOSED-CELL, SPONGE- OR EXPANDED-RUBBER MATERIALS. COMPLY WITH ASTM C 534, TYPE I FOR TUBULAR MATERIALS AND TYPE II FOR SHEET MATERIALS. PRODUCTS: SUBJECT TO COMPLIANCE WITH REQUIREMENTS, ARMSTRONG TYPE AP ARMAFLEX OR RUBATEX R 180-FS 25/50 RATED FLEXIBLE ELASTOMER PIPE INSULATION. INSULATION SHALL HAVE A THERMAL CONDUCTIVITY (K FACTOR) OF NOT MORE THAN 0.245 (BTU X IN) / (HR X FT2 X DEG F) AT 75 DEG F MEAN TEMPERATURE WHEN TESTED BY ASTM C177 AND A WATER VAPOR PERMEABILITY OF 0.20 OR LESS WHEN TESTED BY ASTM C355 WATER METHOD. ADHESIVE SHALL BE ARMAFLEX 520 BVL. COMPARABLE PRODUCTS SUBJECT TO COMPLIANCE WITH THE REQUIREMENTS BY ONE OF THE FOLLOWING: AEROFLEX USA INC. , AEROCEL ; RBX CORP. , INSUL-SHEET 1800 & INSUL-TUBE 180

	DUC	T CONSTRUCTION,	SEALI	NG AN	ID LEAK	KAGE	TESTING	G SCH	IEDULE					
							INDOOR	DUCTMOR	ĸ		OUTDOOR	DUCTMO	RK	
	DUCTMORK			OP. PRESS (INCH	DUCT SEAL. CLASS	-	T LEAKAGE CLASS (CL)		EAKAGE LLOMED (F)		T LEAKAGE CLASS (CL)		EAKAGE LLOMED (F)	REMARKS
FUNCTION	CONNECTED TO	MATERIAL	PRESS DIFF	M.G.)		RECT.	ROUND FLAT OVAL	RECT.	ROUND FLAT OVAL	RECT.	ROUND FLAT OVAL	RECT.	ROUND FLAT OVAL	
SUPPLY	AIR HANDLING UNITS, VAVS	GALVANIZED SHEET	+	1	A	16	8	16.0	8.0	4	4	4.0	4.0	
	OTHER EQUIPMENT	GALVANIZED SHEET	+	2	A	16	8	25.1	12.6	4	4	6.5	6.5	
RETURN	AIR HANDLING UNITS, VAVS	GALVANIZED SHEET	+/-	2	A	16	8	16.0	8.0	4	4	4.0	4.0	
	OTHER EQUIPMENT	GALVANIZED SHEET	+/-	2	A	16	8	25.1	12.6	4	4	6.5	6.5	
EXHAUST	TOILET EXHAUST	GALVANIZED SHEET	+/-	2	A	16	8	16.0	8.0	4	4	4.0	4.0	

LEAKAGE ALLOWED CALCULATED AS FOLLOWS: F = (CL)(P0.65)

MHERE: F = ALLOWABLE LEAKAGE RATE IN CFM/100 SF OF DUCT SURFACE

CL = LEAKAGE CLASS

P = TEST STATIC PRESSURE

THE FOLLOWING SYSTEMS SHALL BE REQUIRED TO BE FIELD LEAK TESTED:

1. SUPPLY AND RETURN DUCTWORK FROM AIR HANDLING EQUIPMENT TO INLET SIDE OF AIR TERMINAL UNIT (VAV BOXES, AIR VALVES ETC)

SUPPLY AND RETURN DUCTWORK RISERS IN VERTICAL ENCLOSED SHAFTS.

CONSTANT VOLUME SUPPLY AND REUTRN DUCTWORK ON SYSTEMS OVER 2" W.G. STATIC PRESSURE FROM AIR HANDLER TO BRANCH TAKE-OFFS. DUCTWORK LOCATED OUTDOORS REGARDLESS OF PRESSURE CLASSIFICATION.

4 5. TOILET EXHAUST RISERS RISERS IN SHAFTS

						CA	ABIN	ET H	IEATEF	R SC	HED	ULE			
			ESP	мс	TOR DA	TA	н	EATING C	OIL DATA			PHYSICAL SIZE			
UNIT NO	TYPE	NOM CFM	CFM	RPM N BHP	PHASE	WATTS	ENT H2O LVG H2O	NO. OF ROMS	CAPACITY MBH		GPM P.D. FT H20	LXDXH	WEIGHT (LBS)	FILTER TYPE	MODEL NUMBER
CAB 1	VERTICAL	240	- 240	626 0.13	230 1	15	180 160	2	1 <i>0.8</i>	72	1.1 5.1	28-1/16 X 27-3/16 X 10-1/16	81	1" THROM	TRANE FFHB020


						PUMP SC	CHED	ULE					
						PUMP DATA			мото	R DATA			
NO	SERVICE	LOCATION	MODEL NUMBER	GPM	HEAD IN FEET	MFG. CURVE NUMBER	RPM	ВНР	VOLTS	PHASE	HERTZ	VIBRISOL TYPE DEF- LECTION	REMARKS:
P 1,2	3RD FLOOR FCUS	CHILLER ROOM	E-80 1.5X1.5X7C	120	150	_	3320	7.1	208	3	_		PROVIDE WITH VFD

AIR	HANDLING
-----	----------

		AIR HANDLING UNIT	SCHEDULE	TRANE AS STD.
SYSTEM DATA	SUPPLY FAN DATA	COOLING COIL DATA	STEAM COIL DATA	FILTER DATA
NO. SERVICE LOCATION MODEL NUMBER	TOTAL AIR CAP. CFM CFM CFM (IN. SPG.) FAN RPM MOTOR DATA BHP VOLTS BHP VOLTS TTL. WHEEL MIN. DIA. H.P. PHA	MBH OF AIR TOTAL DB DB	FLUID     FACE AREA SQ.FT.     MIN ROWS     AIR VEL F.P.M.     LOAD     AIR TEMP.     STEAM       FLUID     MIN MIN FIN. IN     # OF SECT.     AIR PD     TOTAL MBH     LVG. DEG.F     PRESSURE PSIG     COIL CONDENSATE     P.D. FT. H ₂ 0	MERV RATING (L × W × H) TOTAL UNIT WEIGHT REMARKS:
AHU 62ND AND 3RD FLOORGROUND FLOOR MECH ROOMCSAA025	12700         3200         2.56         2338         16.4         460           5.10         -         -         -         3	CHILLED WATER         24.08         6         527         408.8         80.2         50.96         112           WATER         -         1         0.949         571.8         66.1         50.86         112	STEAM         22.67         1         560         -         45         5.0         561.4         6.84	MERV 13 139.7 X 80 X 67 3480 -PROVIDE WITH VFD -MERV 13 FILTERS
AHU 71ST, 2ND AND 3RD FLOORSGROUND FLOOR MECH ROOMCSAA066	30300         7600         2.89         2015         38.42         460           5.21         -         -         -         3		STEAM         60.38         1         502         -         45         5.0         1061         5.98	MERV 13 157.4 X 140.5 X 94.5 8968

# I. PRODUCTS: SUBJECT TO COMPLIANCE WITH REQUIREMENTS, ASTM C547 GLASS FIBER PIPE INSULATION WITH THERMAL CONDUCTIVITY (K FACTOR) NOT EXCEEDING 0.23 (BTU X IN) / (HR X FT 2 X DEG F) AT 75 DEG F MEAN TEMPERATURE. INSULATION SHALL BE JACKETED WITH WHITE REINFORCED ALL SERVICE VAPOR RETARDING JACKETING. VAPOR BARRIER MASTIC SHALL BE FOSTER 30-80 OR CHILDERS CP-35. ADHESIVE SHALL BE CHILDERS CP-82. AT THE SUBCONTRACTOR'S OPTION, SELF SEALING LAP JACKETING WITH ADHESIVE RELEASE STRIPS ON BOTH THE LAP AND THE JACKET MAY BE USED. NO

	SERVI
	CHILLED, HO AND RISERS 300 PSIG), V RELIEFS
	CONDENSAT PIPING
	VENTS AND
•	
1. M	IATERIALS FO
1.1.	ALL STEEL P SHALL BE OF AND RUST FR MAY BE REQ
1.2.	ALL STEEL P MHEATLAND.
1.3.	ALL COPPER CO., CHASE E CONTINUOUS
1.4.	PIPING SPECI
1.5.	PROVIDE DIE

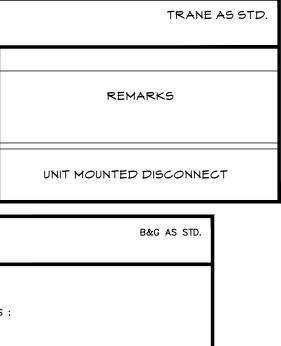



		DII	FUSER	SCHEI	OULE		ANEMOSTAT AS STD.
					CFM F	RANGE	
SYMBOL	DESCRIPTION	MODEL NUMBER	FRAME SIZE	NECK SIZE	FROM (MIN)	TO (MAX)	REMARKS
			12" x 12" OR	6Ф	0	200	360° HORIZONTAL PATTERN
			24" x 24"	δΦ	201	325	- 24"x 24" FRAME - 18" PLAQUE
CD	PLAQUE SUPPLY	PARAGON PG	24" x 24"	1 <i>ΟΦ</i>	326	450	1/8" DROP FACE
	DIFFUSER		24 X 24	12Φ	451	600	
				14Φ	601	750	
CR	CEILING RETURN PERFORATED	3P SERIES LAY IN 3PRD	24" x 24"	22" x 22"	_	_	3PRD FOR DUCTED RETURNS 3PL FOR OPEN TO H.C. APP.

### MATERIALS FOR PIPING UNDER 10"

#### PIPING AND FITTINGS SCHEDULE

VICE	SIZE	PIPE	FITTINGS
OT WATER,	2-1/2" AND UNDER	COPPER TYPE K, HARD DRAWN	150 PSI AND UNDER MALLEABLE IRON 150 LB., SCREWED 151 PSIG-300PSI: MALLEABLE IRON300 LB. SCREWED
VENTS AND	3"-1 <i>0</i> "	SCHEDULE 40, ASTM-A53, GRADE B, SEAMLESS TYPE "S"	SCHEDULE 40 WELD END
ATE	4" AND UNDER	COPPER TYPE L HARD DRAWN	WROUGHT OR COPPER WITH LEAD FREE 95/5 SOLDER OR BRAZED
O RELIEFS		SAME MATERIALS AS PIPE SYSTEMS THEY SERVE	SAME MATERIAL AND FITTINGS AS SYSTEMS THEY SERVE

OR PIPE & FITTINGS

PIPING SHALL BE TYPE ASTM-A-53 GRADE B SEAMLESS UNLESS NOTED OTHERWISE. FURNACE BUTT WELD PIPE IS NOT ACCEPTABLE. ALL PIPE OF THE DOMESTIC MANUFACTURER, DELIVERED TO THE JOB PROPERLY PRIMED AND MARKED AND SUPPLIED WITH THE INTERIOR SURFACES CLEAN FREE. EACH END SHALL BE CAPPED TO AVOID THE RUSTING OF THE INTERIOR SURFACE. PIPING FOUND TO BE IN VIOLATION OF THIS SPECIFICATION QUIRED TO BE REMOVED FROM THE JOB SITE WHETHER OR NOT ALREADY INSTALLED.


PIPE SHALL BE MANUFACTURED IN THE UNITED STATES BY LACLEDE, LTV, MAVERICK, NEWPORT, SAMHILL, TUBULARS, TEX-TUBE, US STEEL, OR . SUBMIT MILL CERTIFICATIONS FROM THE PIPE MANUFACTURER REFER TO SECTION 15010 FOR REQUIREMENTS.

TUBING SHALL BE NOT LESS THAN 99.9 PERCENT PURE COPPER, AS MANUFACTURED IN THE UNITED STATES BY REVERE COPPER AND BRASS BRASS AND COPPER CO., INC. BRIDGEPORT BRASS CO., HALSTEAD, MUELLER OR WOLVERINE WHEREVER POSSIBLE, TUBING SHALL BE 5 WITH COUPLINGS UP TO 20 FEET IN LENGTH. TUBING SHALL CONFORM TO ASTM B88.


CIFICATIONS SHALL BE SUBMITTED WITH SHOP DRAWINGS.

IELECTRIC FITTING FOR ALL CONNECTIONS OF DISSIMILAR METALS. BRASS FITTINGS ARE NOT ACCEPTABLE.


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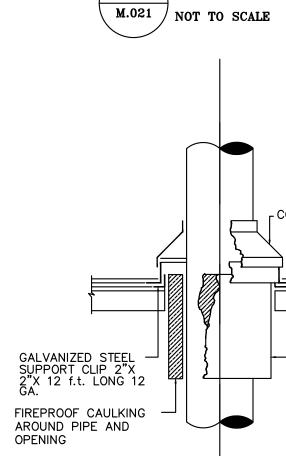


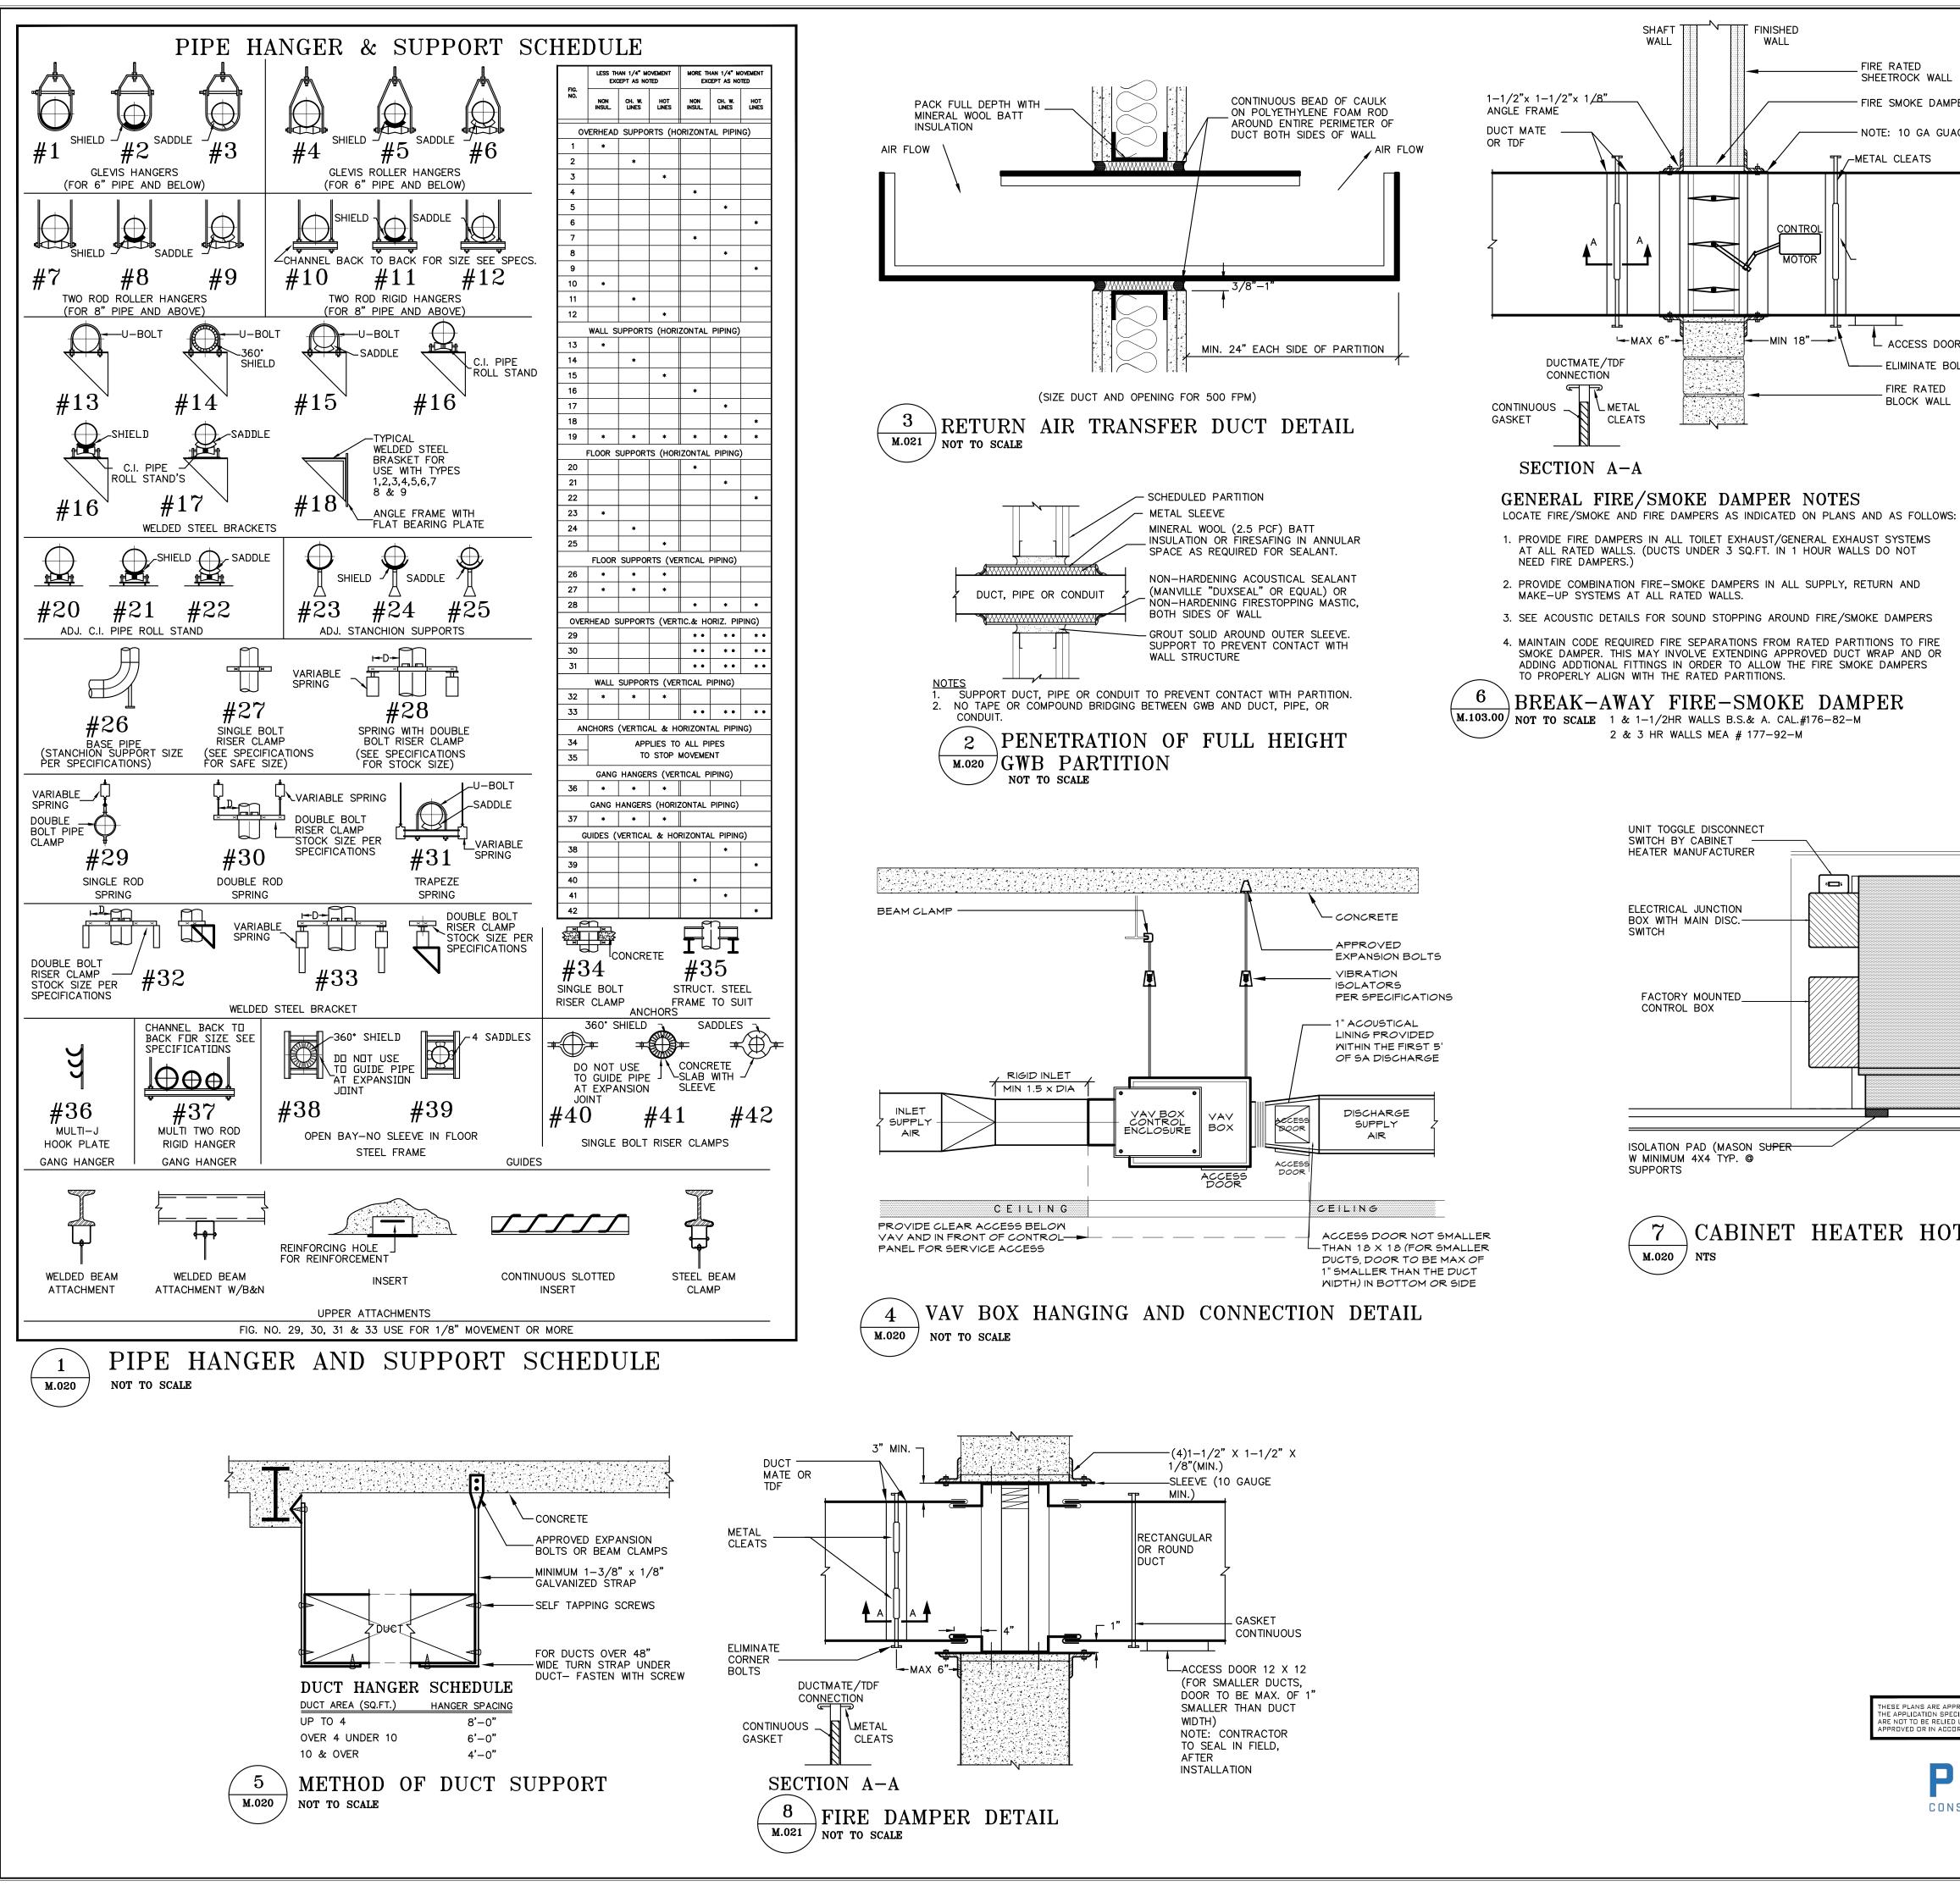	OPERATOR. US OPERATED DA BEHIND DIFFUS	PER WITH LOCAL 5E REMOTE CABL AMPER LOCATED 5ER IN AREAS WIT 3LE CEILINGS. (TY)	н				MANUAL VOLUME DAMPER WITH "OPEN" - "CLOSE" POSITION	
PER AGE SLEEVE	AIRFLOW					2		
2	THROAT RADIUS RADIL 3/4 DIA.		7" HE RA	OPE 1" PER EL Adius		THRO RADIL		HEEL RADIUS
R			SLO	OPE 1" PER				
	2 🖪	IRFLOW		2	• 7	2	AIRFLOW	
	SHEETMETAL BOOT		LO RE LO DIF NO	DLUME DAMP CAL OPERA MOTE CABL PERATED DA CATED BEN FUSER IN AN DN ACCESSIE	ATOR. USE LE AMPER HIND REAS WITH 3LE	SHEE" BOOT		SLOPE 1" PER 7" MANUAL VOLUME DAMPER WITH "OPEN" "CLOSE" INDICATOR
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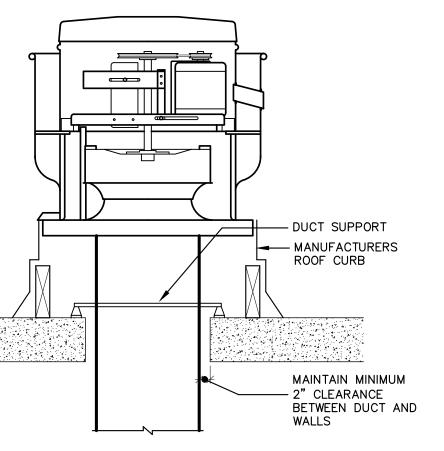




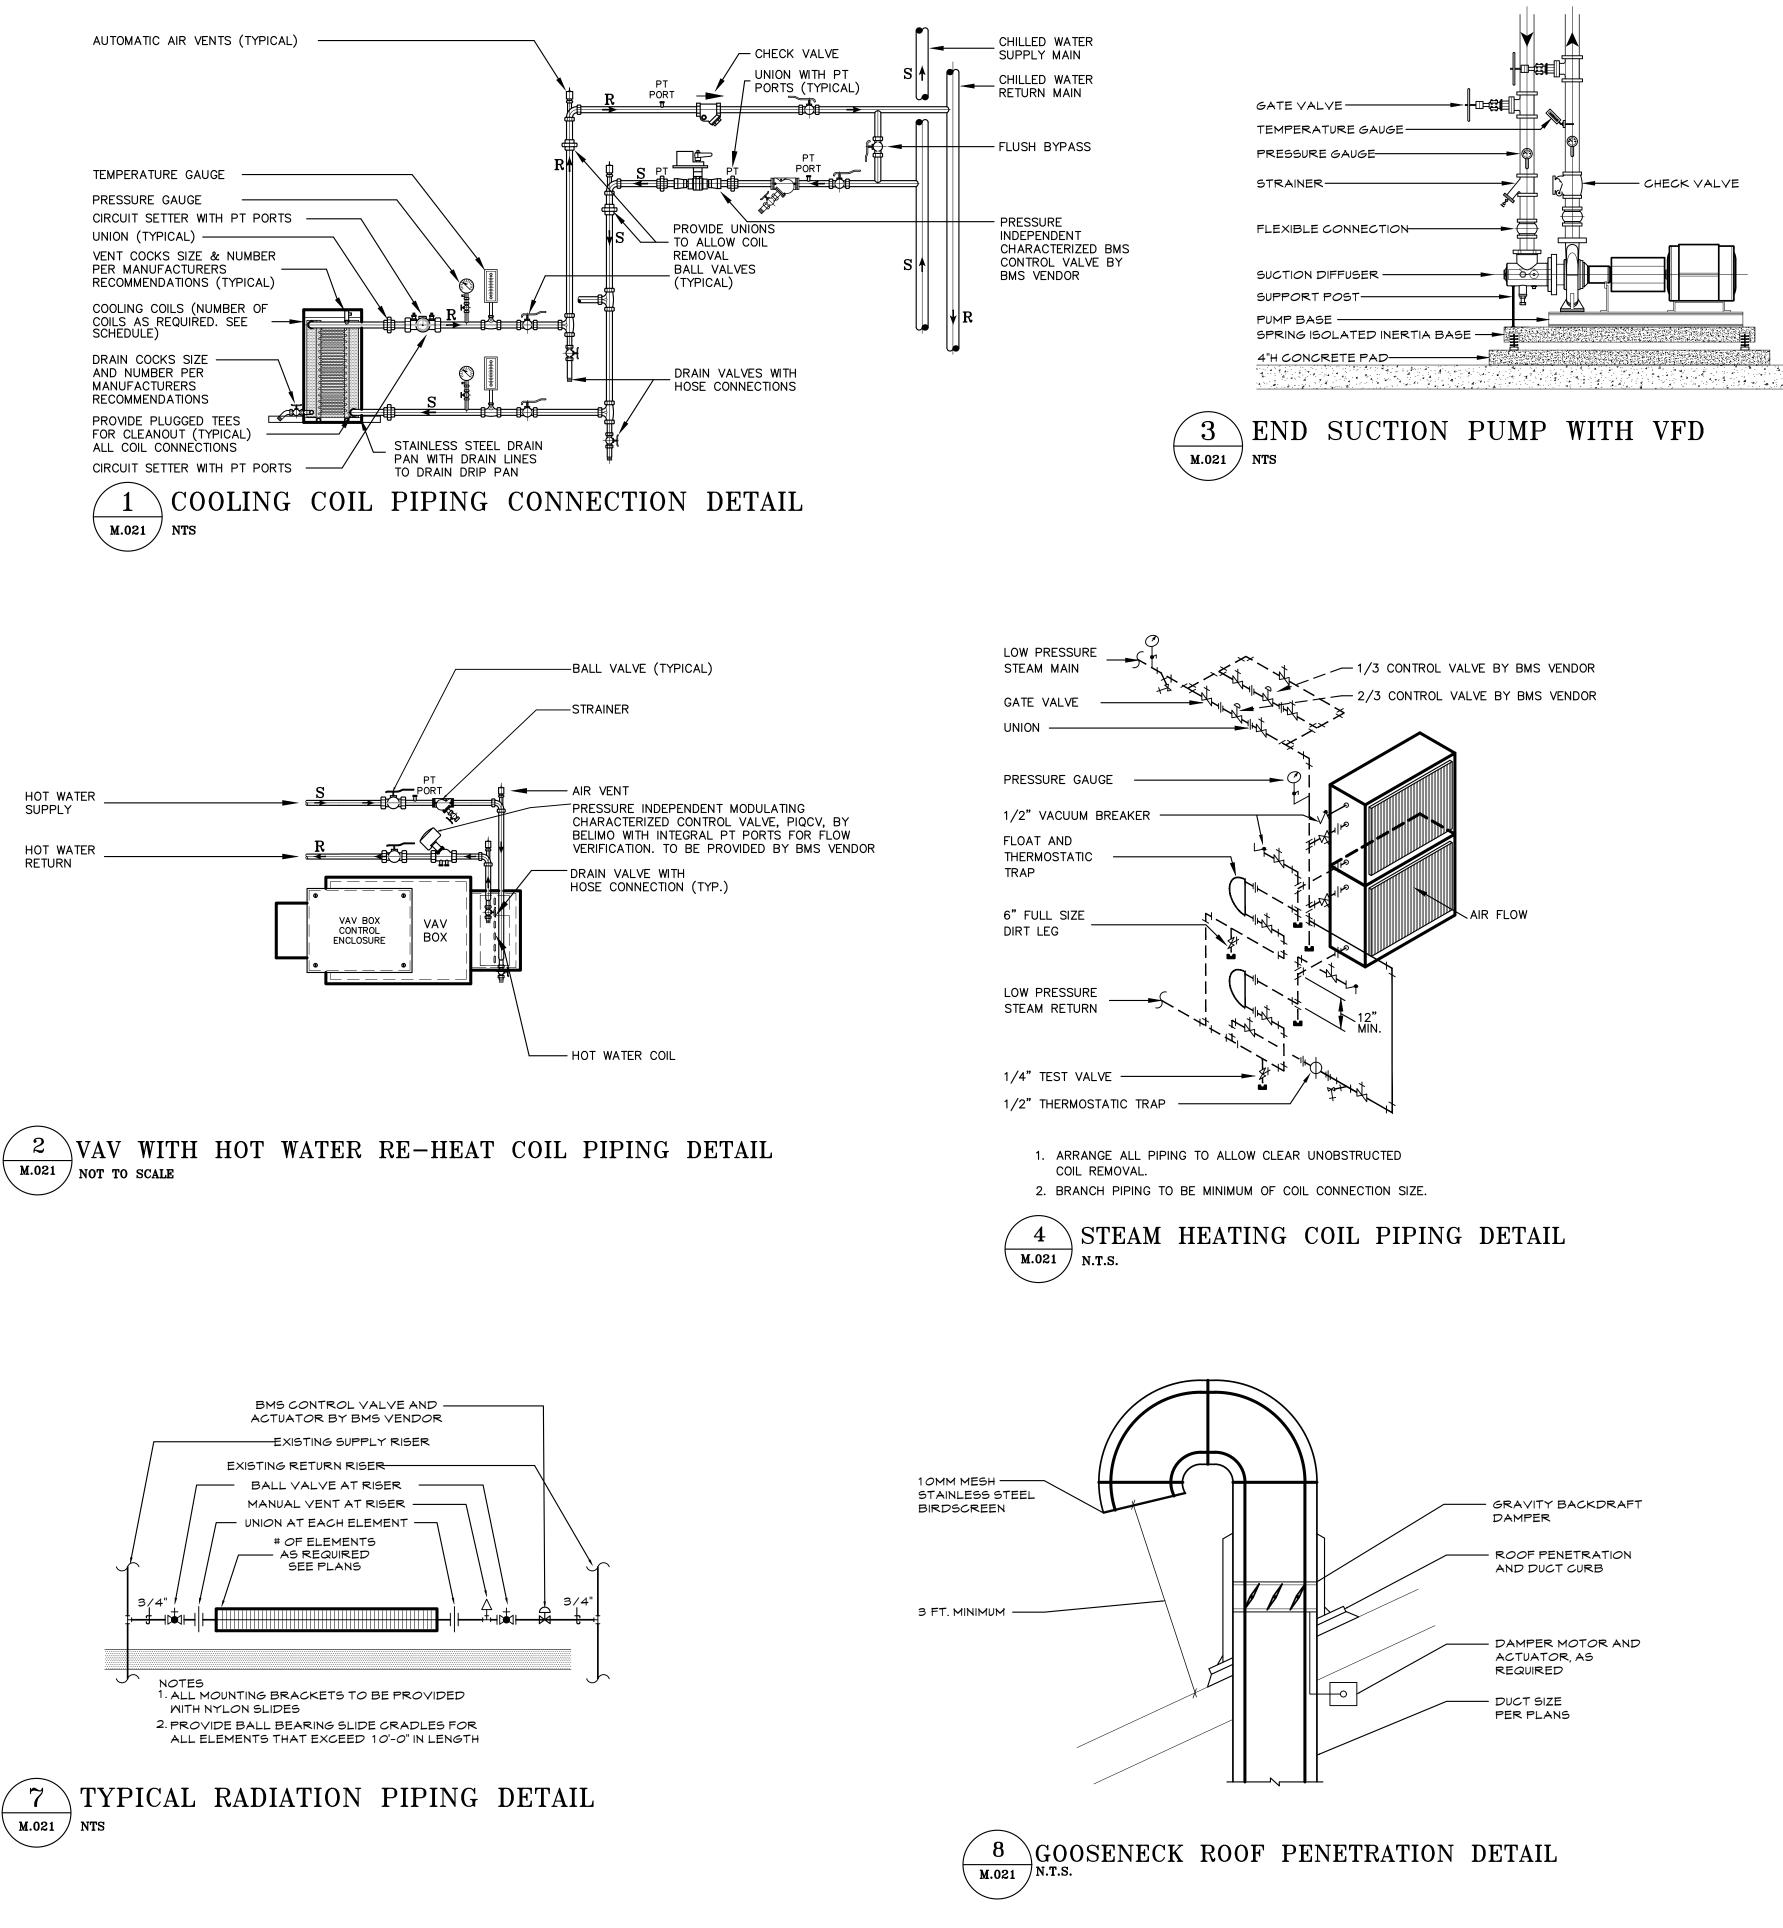

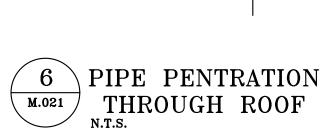

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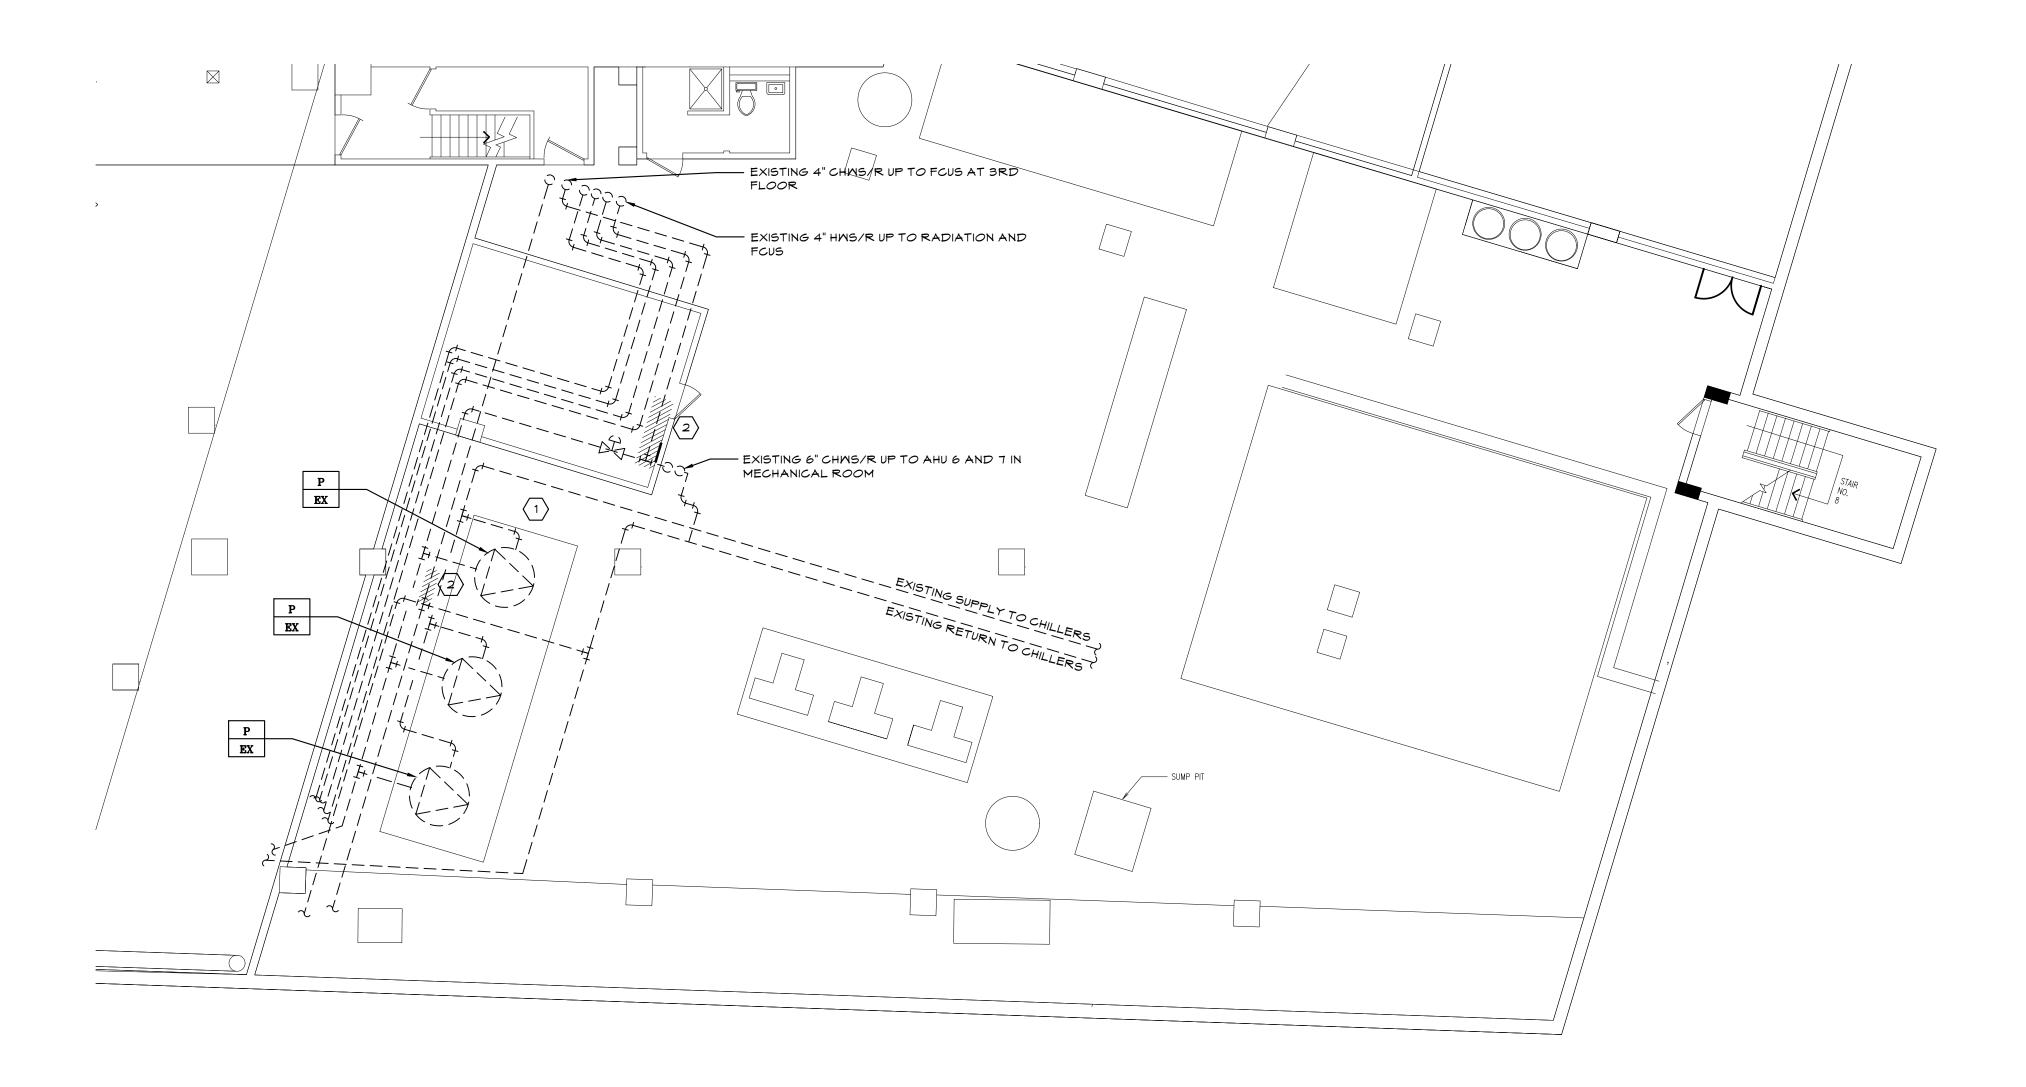


**ROOF MOUNTED EXHAUST FAN ISOLATION DETAIL** 


COUNTER FLASHING

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133 WEST 19TH STREET NEW YORK, NY 10011 TEL 212.645.1002	LOW	110 DR.	MARTIN LUT	ATIONS AND F HER KING, JR JS, NEW YORF	R. BOULE	IPROVEMENTS - PHASE II EVARD	SCALE: AS NOTE DATE: JAN 19, 2		
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1 MECHANICAL DEMOLITION PLAN – 2ND SUBGRADE CHILLER PLANT 1/8"=1'-0"





KEY	NOTES

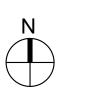1 EXISTING STARTERS FOR (3) EXISTING 150HP CHILLED WATER DISTRIBUTION PUMPS TO BE REMOVED AND REPLACED MITH NEM VFDS.

2 CUT BACK AND CAP EXISTING CHILLED/HOT WATER SUPPLY BRANCHES TO RADIATION AND FCUS FROM MAINS AS SHOWN.

			HOL	UUARROPAS STREET	11	0 MLK BLVD	143 GRAND STREET GARAGE GARAGE	7
	CONSULTANT SEAL		CONSULTANT	90-30	) 1)	<b>Architects LI</b> 61st Street, Jamaica, 6-651-6200 F: 718-2	<b>P 1</b> 1432	
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## KEY NOTES 1 EXISTING AHU TO BE REMOVED AND REPLACED WITH NEW. CUT DUCTWORK, PIPING, AND WIRING AS REQUIRED. 2 PROVIDE NEW ALD'S FOR ALL FRESH AIR DAMPERS SERVING AHU 6, 7, \$ 8. DAMPERS TO BE SIMILAR TO GREENHECK VCD SERIES. ALL ACTUATOR TO BE BY BELIMO AND TIED INTO THE NEW BMS. 3 EXISTING CONSTANT VOLUME REHEAT COIL TO BE REMOVED AND REPLACED WITH NEW VAV BOX. 4 EXISTING RETURN FAN TO BE REMOVED AND REPLACED WITH NEW. 5 EXISTING THERMOSTAT TO BE REMOVED AND REPLACED WITH NEW. CUTBACK WIRING AND EXTEND AS REQUIRED DURING NEM MORK. 6 EXISTING DIFFUSER TO BE REMOVED AND REPLACED WITH NEW. PRE DEMO READINGS $\langle A \rangle$ RECORD DIFFUSER CFM AT THIS LOCATION. $\langle \mathsf{PT} \rangle$ RECORD AIR FLOW AND STATIC PRESSURE AT THIS LOCATION. GENERAL NOTE PROVIDE TEMPORARY COOLING AND HEATING AS REQUIRED TO CONDITION SPACES INTENDED TO BE OCCUPIED PRIOR TO COMPLETION OF SYSTEM TIE INS. 2. ANY INSULATION DAMAGES BY NEW WORK SHALL BE REPLACED. ///111 MLK COURT HOUSE BLVD /₹/ 110 MLK BLVD QUARROPAS STRE $\begin{pmatrix} 2 \\ M.042 \end{pmatrix}$ KEY PLAN NTS CONSULTANT INFORMATION CONSULTANT SEAL Graf & Lewent Architects LLP 90-30 161st Street, Jamaica, NY 11432 P: 718-651-6200 F: 718-251-6989 MADE BY APP'D BY REVISION DATE REVISION NUMBER RECORD DRAWING CERTIFICATION AS BUILT - CHANGES AS NOTED AS BUILT - NO CHANGES CONTRACTOR CONTRACTOR NAME: NAME: SIGNATURE: SIGNATURE: TITLE: DATE: TITLE: _ DATE: CONTRACT SHEET NUMBER WESTCHESTER COUNTY, NEW YORK NUMBER M-042 DEPARTMENT OF PUBLIC WORKS AND TRANSPORTATION 20-502 SHEET NO. 78 OF 133 DIVISION OF ENGINEERING LOW RISE BUILDING RENOVATIONS AND HVAC IMPROVEMENTS - PHASE II 110 DR. MARTIN LUTHER KING, JR. BOULEVARD

WHITE PLAINS, NEW YORK 10601

1ST FLOOR CENTRAL WING MECHANICAL DEMOLITION PLAN

SCALE: AS NOTED

DPW FILE NO.

DATE: JAN 19, 2024

52-11-M-1890


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	KEY NOTES
$\langle 1 \rangle$	EXISTING CONSTANT VOLUME REHEAT COIL TO BE REMOVED AND REPLACED WITH NEW VAV BOX.
2	EXISTING SUPPLEMENTAL AC UNIT TO BE REMOVED. REMOVE ALL ASSOCIATED CONTROLS, PIPING AND WIRING. CUT ELECTRICAL LINES BACK TO SOURCE AND SEAL PENETRATIONS IN WALL PANELS AND MASONRY WALL.
$\langle 3 \rangle$	EXISTING TOILET EXHAUST FAN TO BE REMOVED AND REPLACED WITH NEW.
4	EXISTING THERMOSTAT TO BE REMOVED AND REPLACED WITH NEW. CUTBACK WIRING AND EXTEND AS REQUIRED DURING NEW WORK.
5	EXISTING THERMOSTAT SERVING SUPPLEMENTAL AC TO BE REMOVED.
	PRE DEMO READINGS
$\langle A \rangle$	RECORD DIFFUSER CFM AT THIS LOCATION.
A	
	RECORD DIFFUSER CFM AT THIS LOCATION.

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#### KEY NOTES


- EXISTING CONSTANT VOLUME REHEAT COIL TO BE REMOVED AND REPLACED WITH NEW VAV BOX.
- 2 EXISTING CABINET HEATER TO BE REMOVED AND REPLACED WITH NEW.
- 3 EXISTING THERMOSTAT TO BE REMOVED AND REPLACED WITH NEW. CUTBACK WIRING AND EXTEND AS REQUIRED DURING NEW WORK.
- 4 EXISTING TOILET EXHAUST FAN TO BE REMOVED AND REPLACED WITH NEW.

#### PRE DEMO READINGS

 $\langle A \rangle$  RECORD DIFFUSER CFM AT THIS LOCATION.
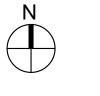
#### GENERAL NOTE

- 1. PROVIDE TEMPORARY COOLING AND HEATING AS REQUIRED TO CONDITION SPACES INTENDED TO BE OCCUPIED PRIOR TO COMPLETION OF SYSTEM TIE INS.
- ANY INSULATION DAMAGES BY NEW WORK SHALL BE REPLACED.

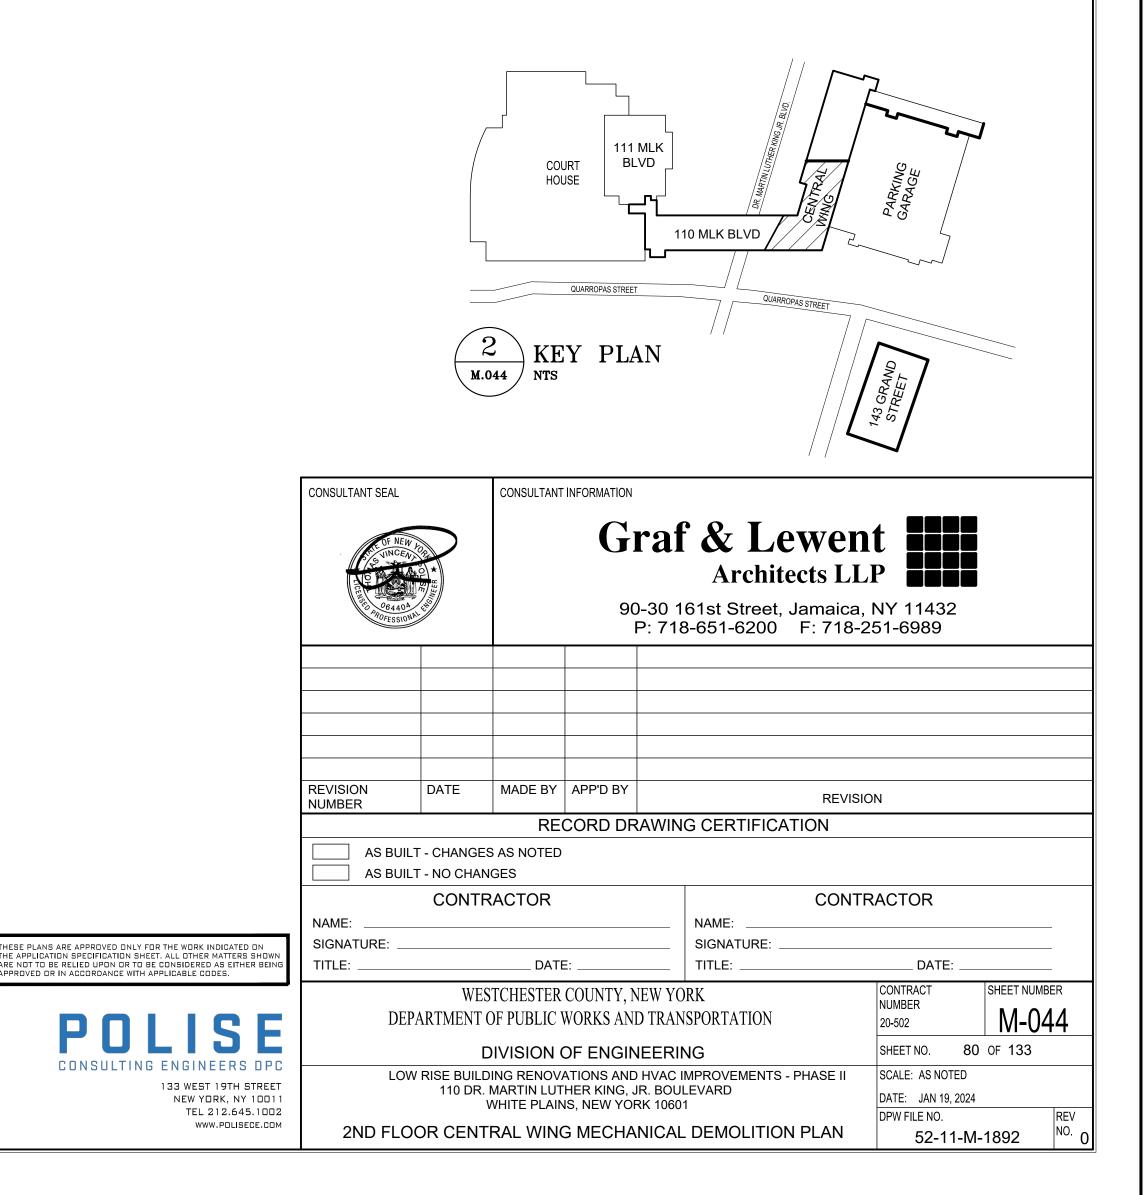







		Г		KEY	NOTES		7		
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			HEATIN SPACES	G AS RE S INTEN	PORARY COOLIN EQUIRED TO CON DED TO BE OCC MPLETION OF SYS	NDITION UPIED	1		
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DIVISION OF ENGINEERING

2ND FLOOR NORTH WING MECHANICAL DEMOLITION PLAN

LOW RISE BUILDING RENOVATIONS AND HVAC IMPROVEMENTS - PHASE II 110 DR. MARTIN LUTHER KING, JR. BOULEVARD WHITE PLAINS, NEW YORK 10601

SCALE: AS NOTED


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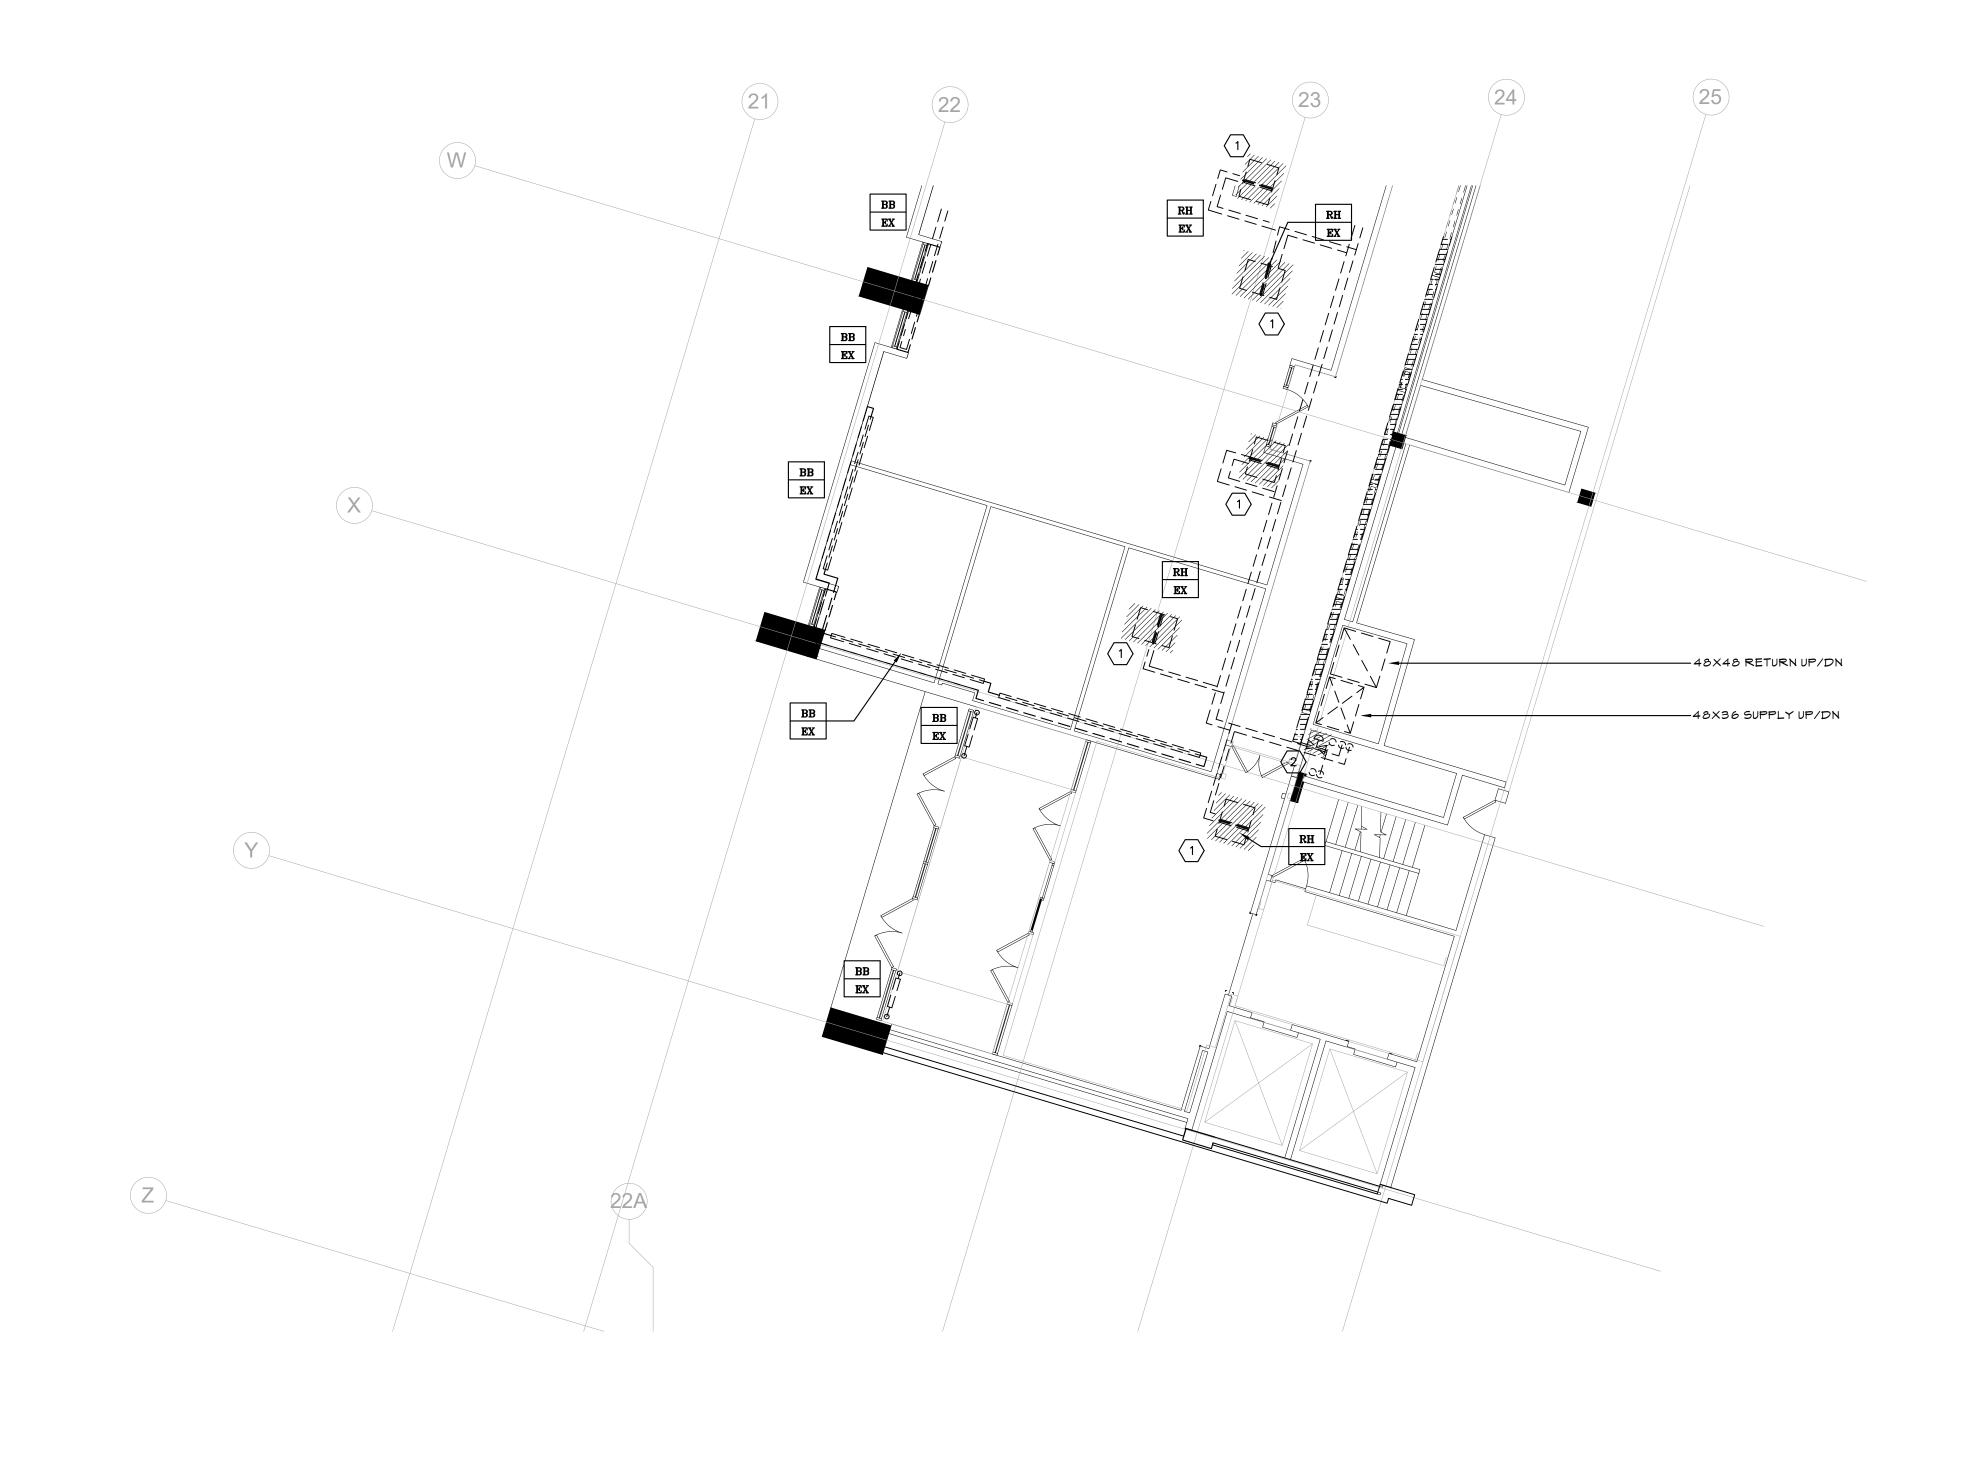
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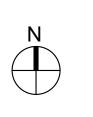
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1 MECHANICAL PIPING DEMOLITION PLAN – 1ST FLOOR CENTRAL WING






### KEY NOTES

- EXISTING CONSTANT VOLUME REHEAT COIL TO BE REMOVED AND REPLACED WITH NEW VAV BOX. CUT BACK AND EXTEND PIPING AS REQUIRED TO ACCOMMODATE NEW UNIT.
- 2 EXISTING PNEUMATIC CONTROL VALVE SERVING CORRIDOR RADIATION TO BE REMOVED AND REPLACED WITH BMS CONTROL VALVE.

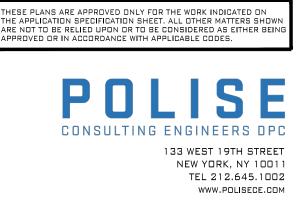
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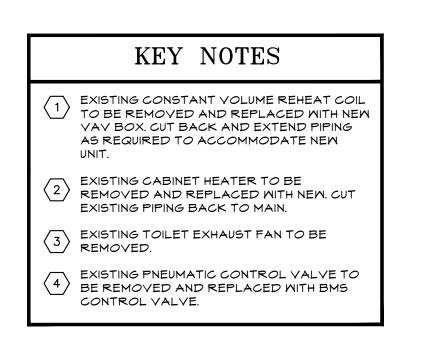





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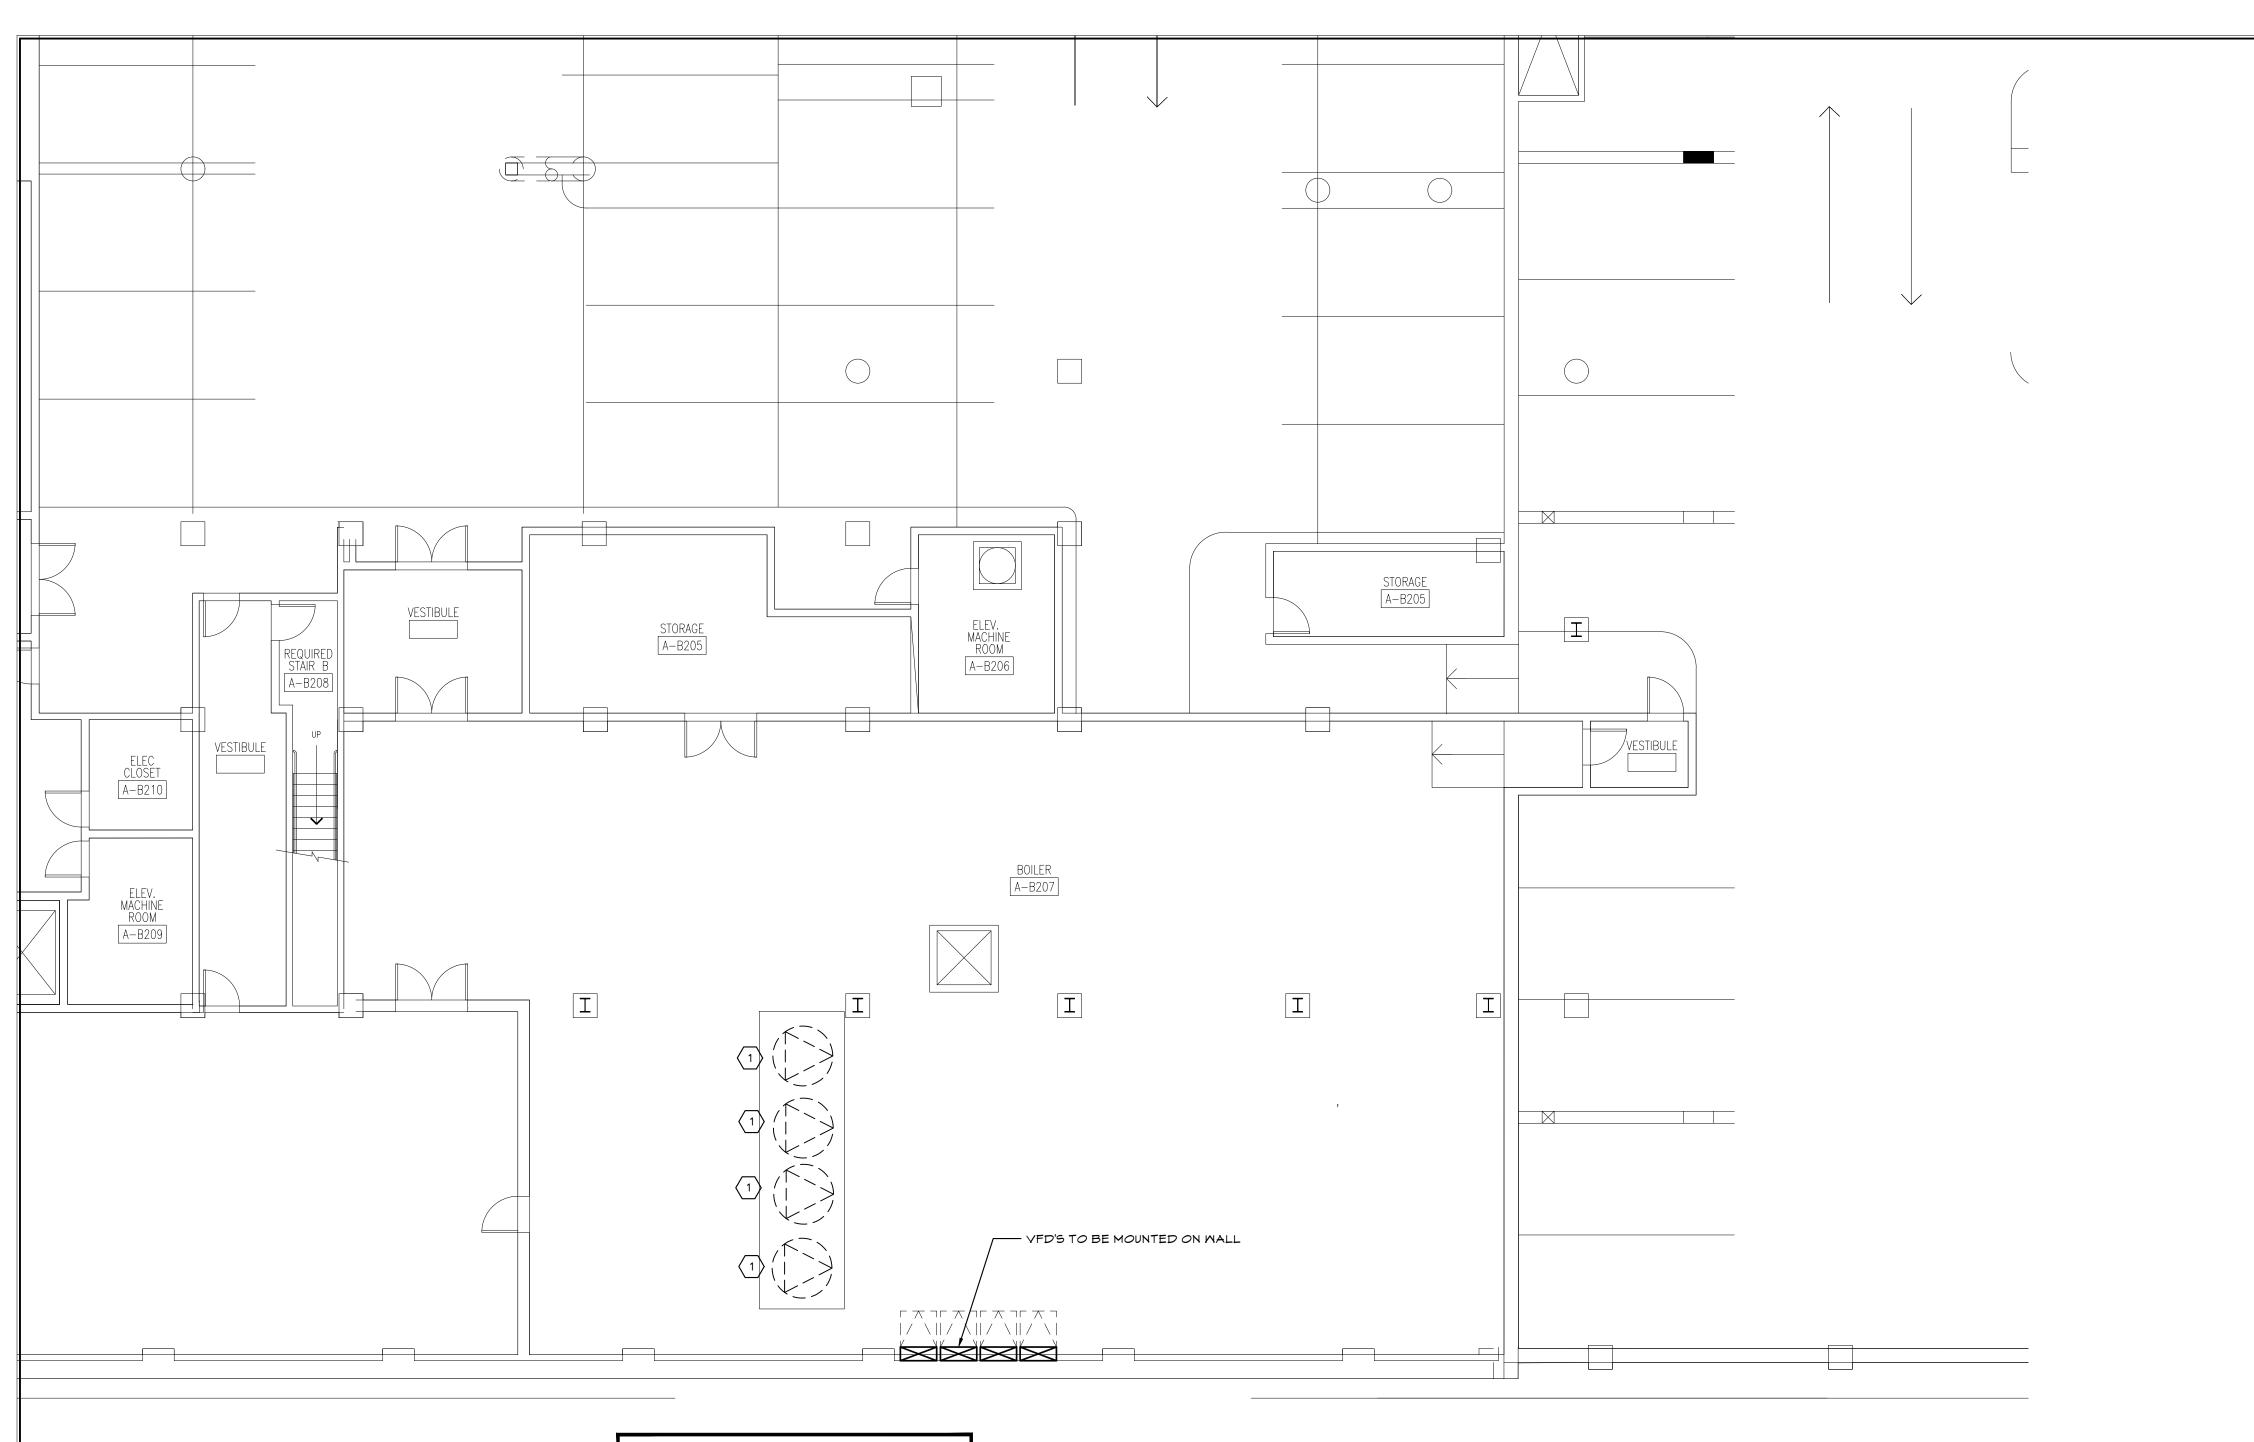


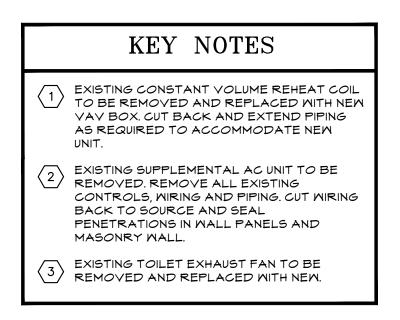


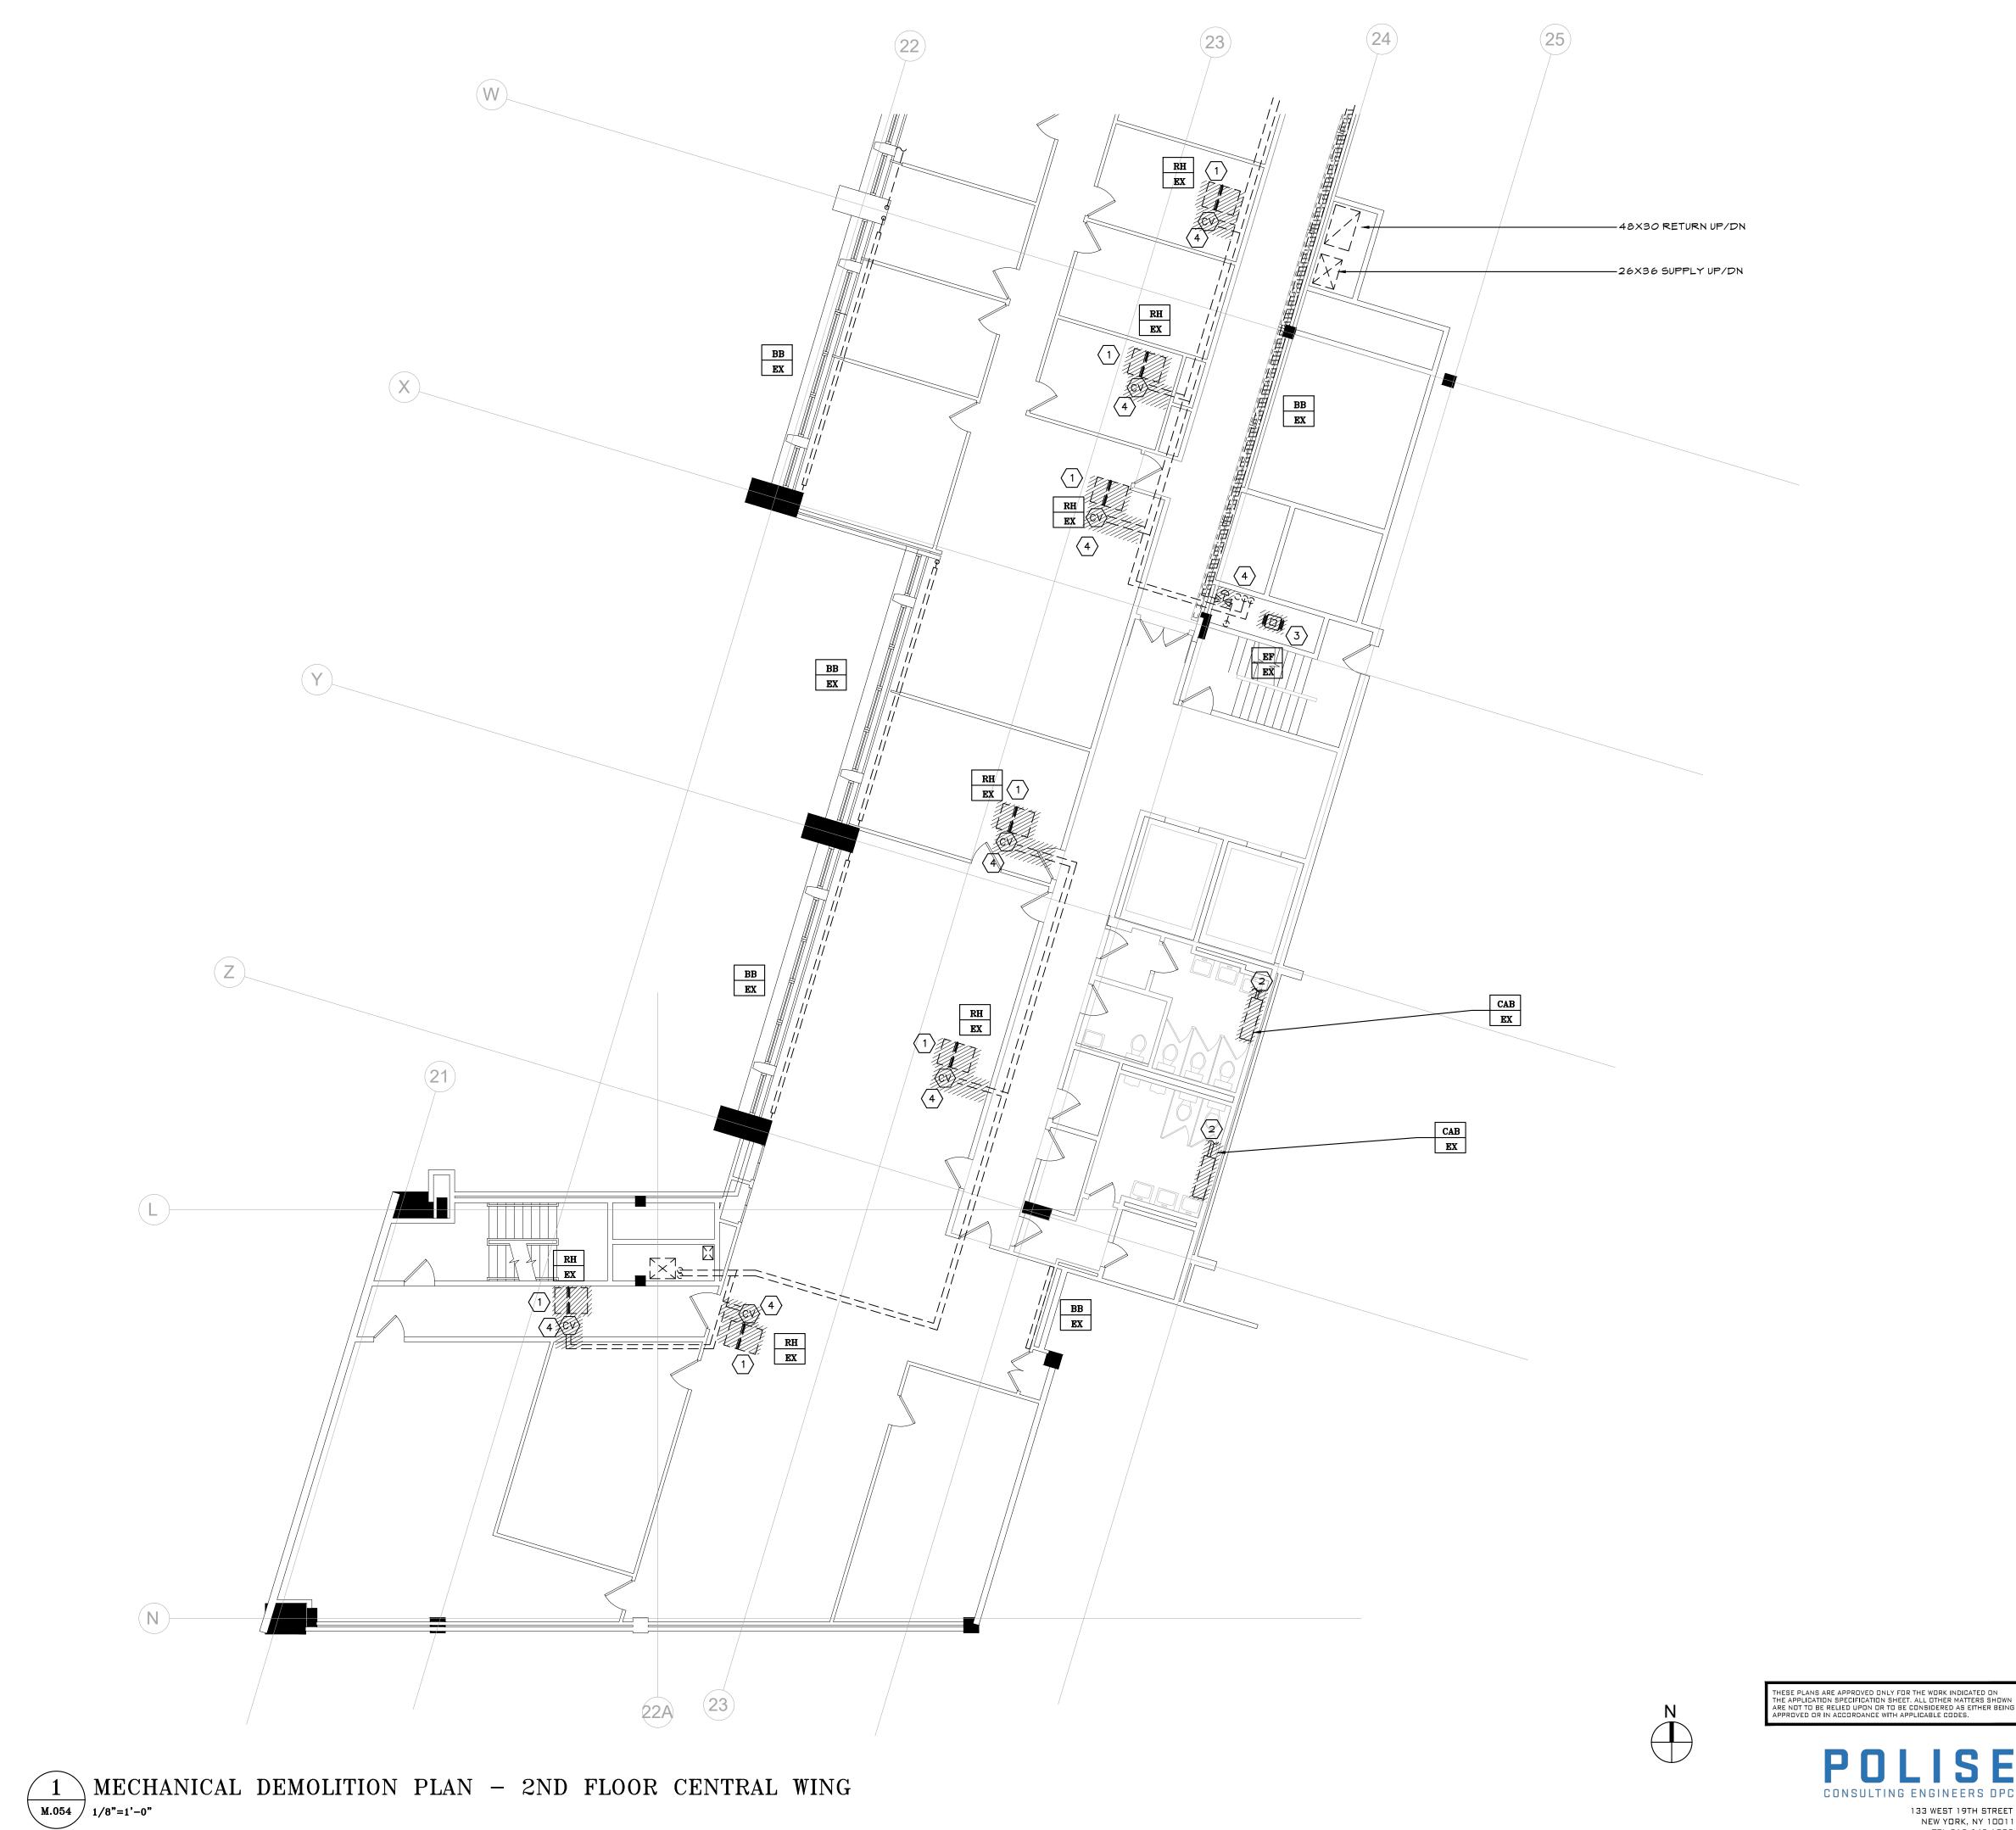

#### KEY NOTES EXISTING CONSTANT VOLUME REHEAT COIL TO BE REMOVED AND REPLACED WITH NEW VAV BOX. CUT BACK AND EXTEND PIPING AS REQUIRED TO ACCOMMODATE NEW UNIT. EXISTING EXHAUST FAN AND ASSOCIATED EXHAUST DUCTWORK TO BE REMOVED. EXISTING PNEUMATIC CONTROL VALVE TO BE REMOVED AND REPLACED WITH BMS CONTROL VALVE.


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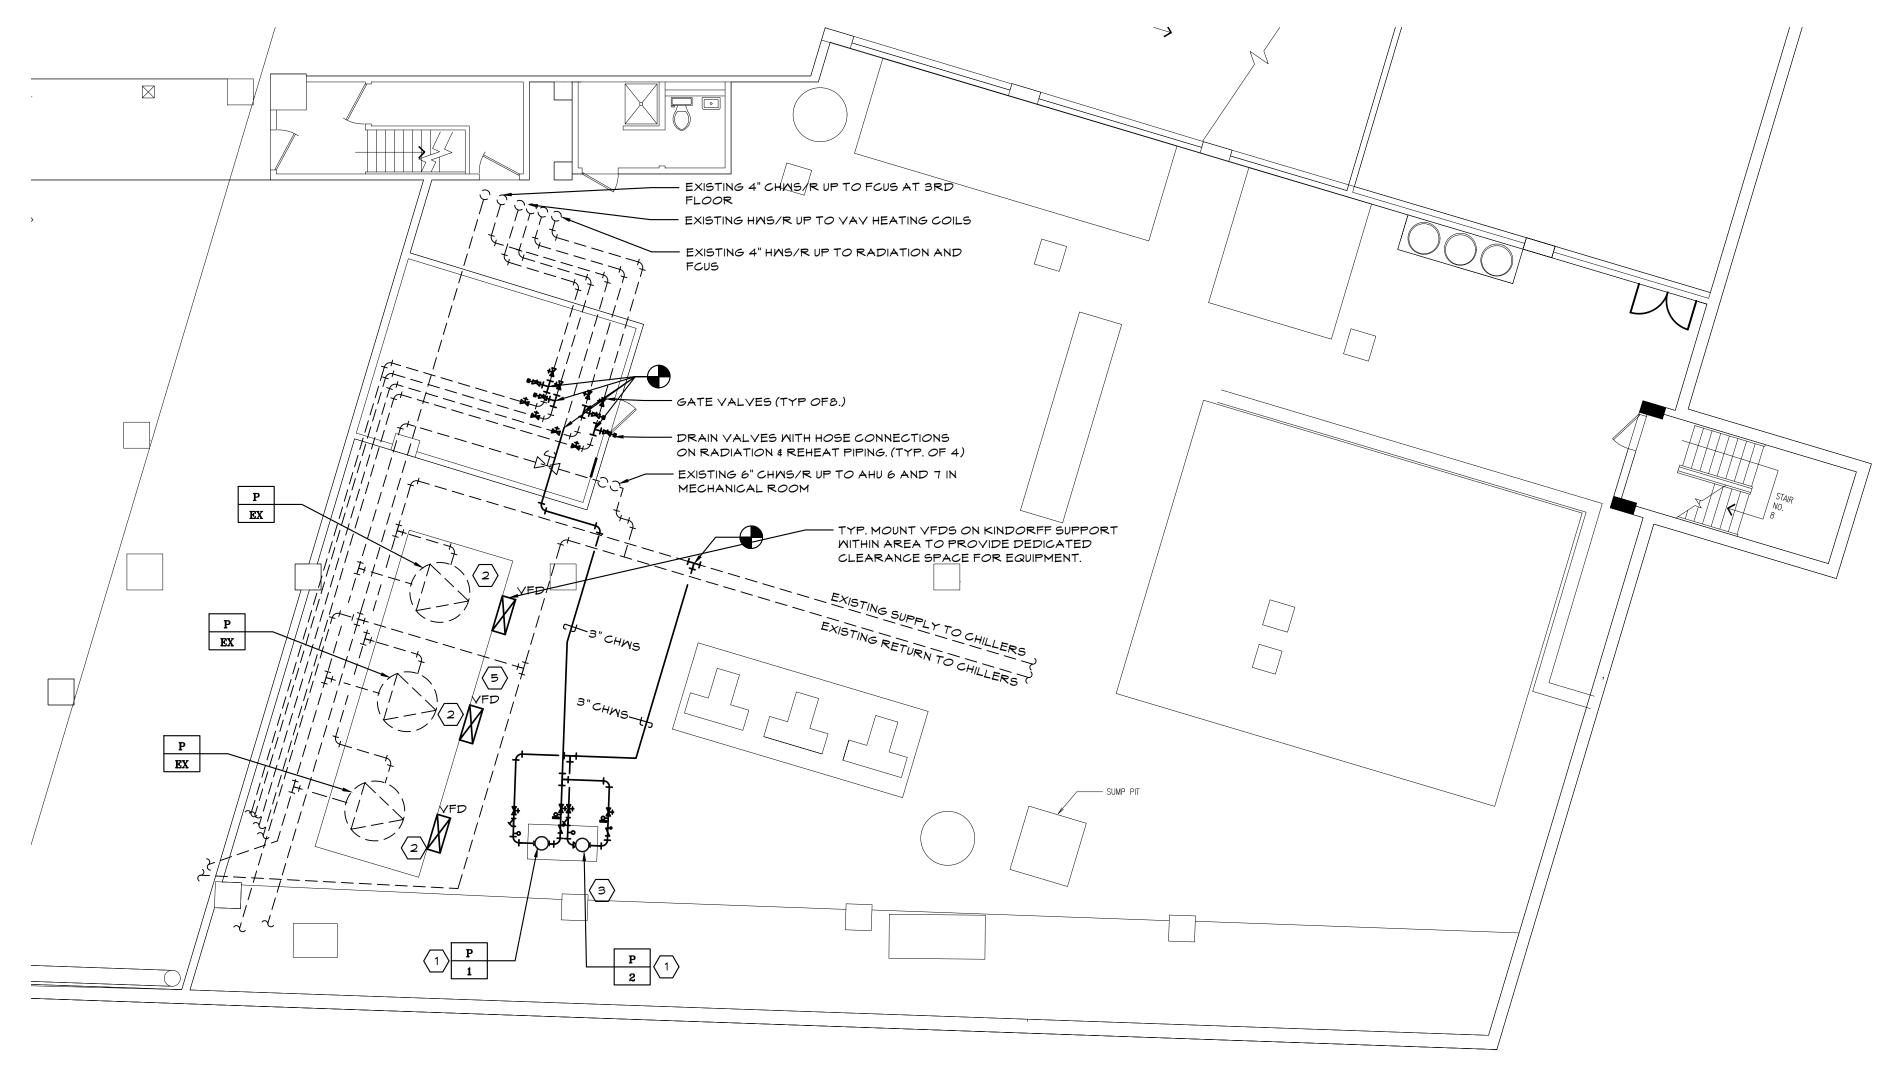


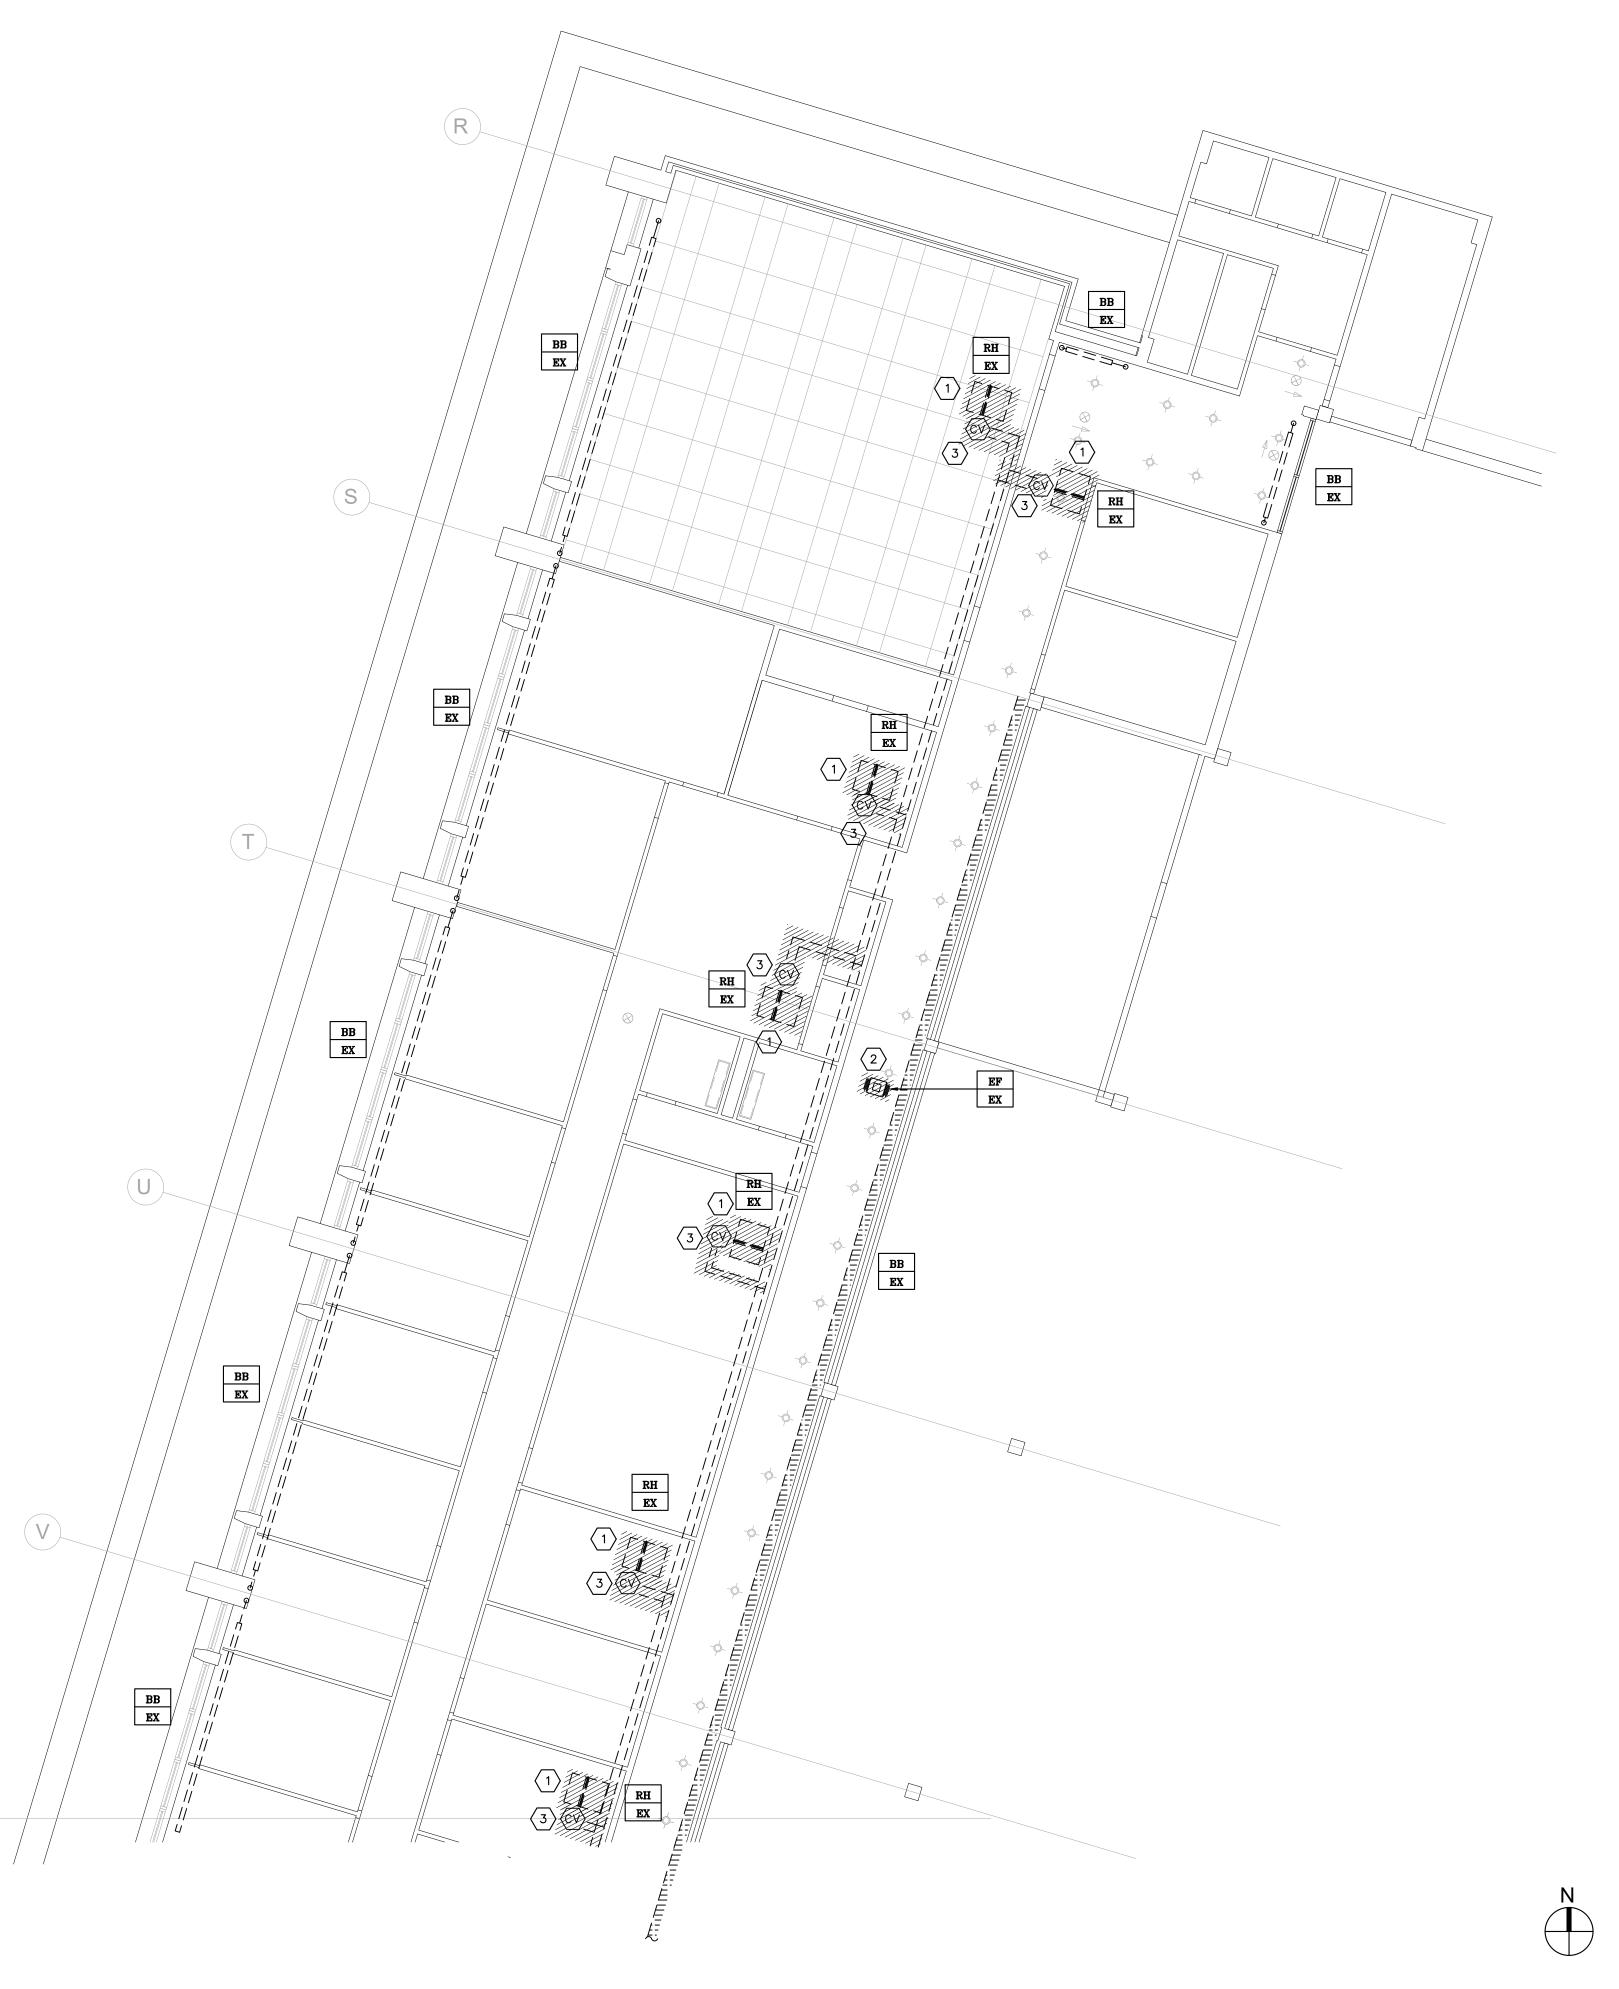

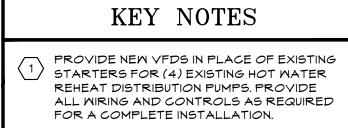



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MECHANICAL PLAN - 2ND SUBGRADE CHILLER PLANT 1 M.099 1/8"=1'-0"

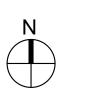





#### KEY NOTES

- PROVIDE (2) NEW INLINE CHILLED WATER PUMPS TO SERVE LOW RISE BUILDING. CUT BACK EXISTING PIPING SERVING THE LOW RISE AND EXTEND NEW PIPING AS REQUIRED TO CONNECT THE EXISTING LOW RISE LOOP AND NEW CHILLED WATER PUMPS TO THE CAMPUS CHILLED WATER MAINS. SEE DETAIL 3 ON DWG M-021 FOR PIPING CONNECTION DETAIL.
- 2 PROVIDE NEW VFDS IN PLACE OF EXISTING STARTERS FOR (3) EXISTING 150HP CHILLED WATER DISTRIBUTION PUMPS. PROVIDE ALL WIRING AND CONTROLS AS REQUIRED FOR A COMPLETE INSTALLATION.
- (3) MOUNT NEW PUMPS ON 4"H CONCRETE EQUIPMENT PAD WITH NEOPRENE VIBRATION ISOLATORS.
- 4 PROVIDE NEW ISOLATION VALVES WITH HOSE CONNECTIONS IN EXISTING RADIATION/HOT WATER PIPING LOOP TO FACILITATE DRAIN DOWNS.
- 5 EXISTING FLOOR LEAK DETECTORS TO BE CONNECTED AND TIED INTO BMS.

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K KEY PLAN - B2 LEVEL



## ADD ALTERNATE

REPLACE ALL EXISTING DUCT MAINS IN KIND WITH NEM.

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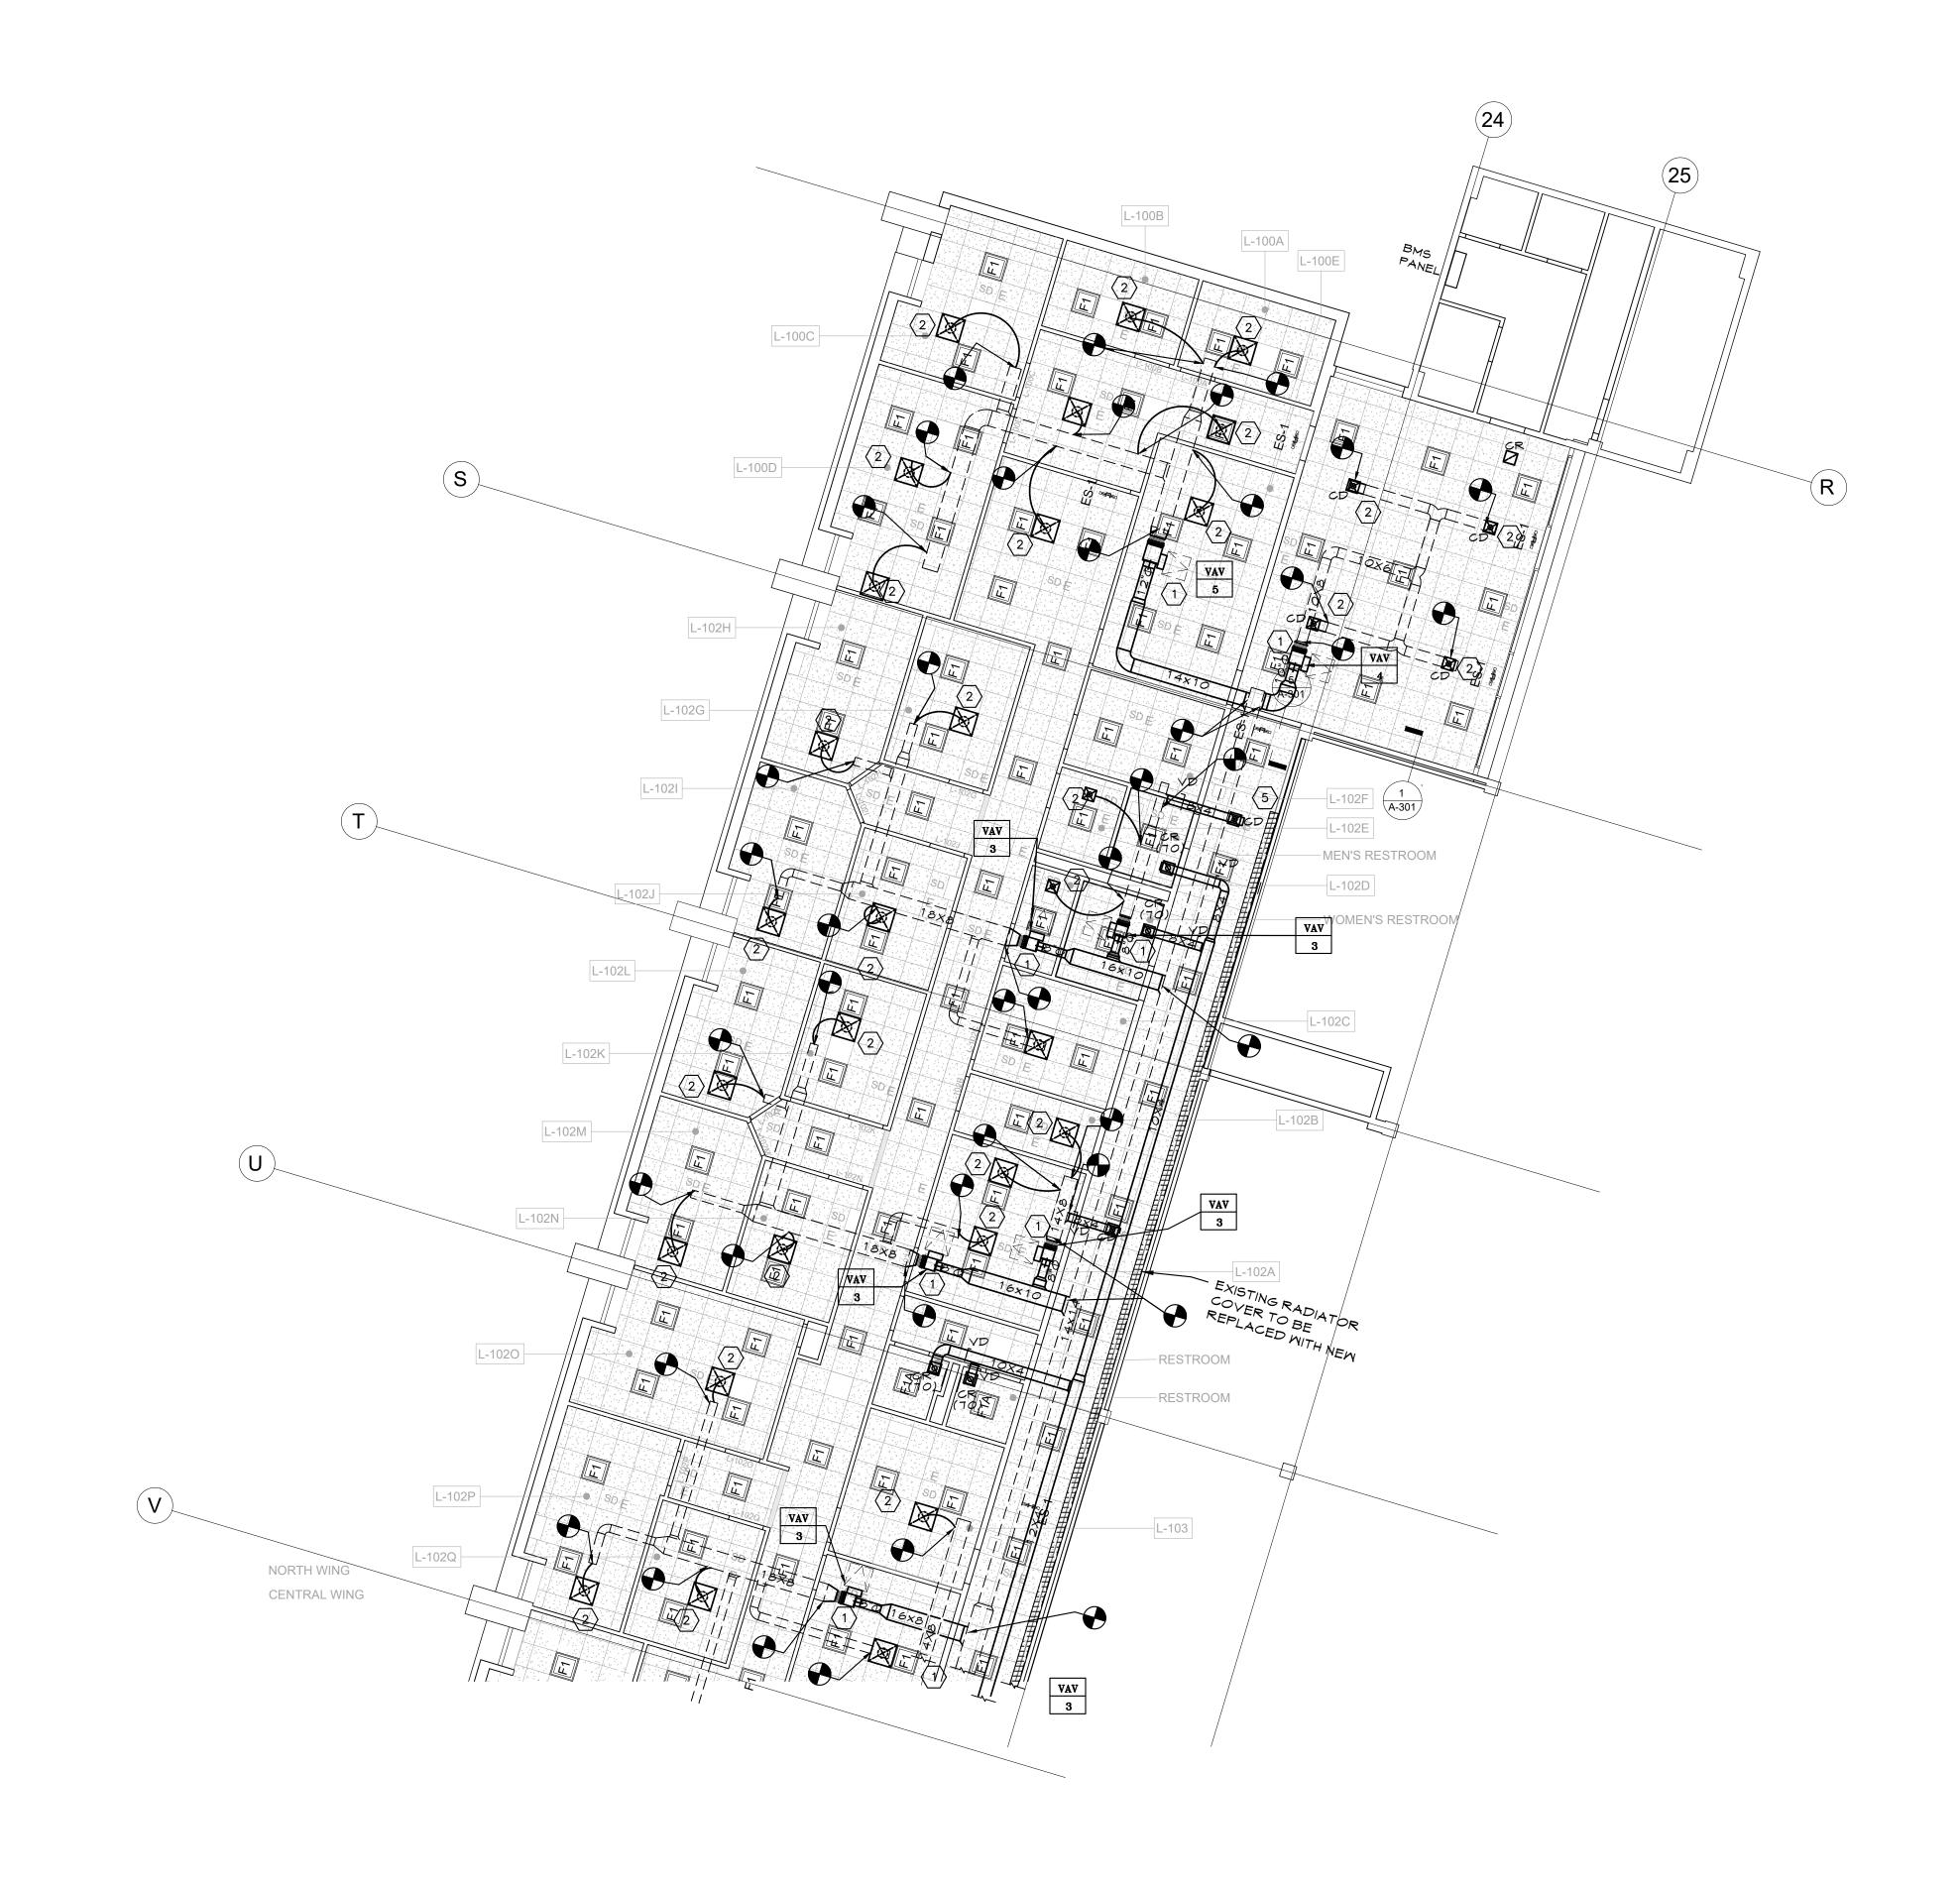



	KEY NOTES
$\langle 1 \rangle$	NEW RETURN FAN IN PLACE OF EXISTING. RECONNECT TO EXISTING DUCTWORK.
2	NEW AHU IN PLACE OF EXISTING. RECONNECT TO EXISTING DUCTWORK AND PIPING WITH NEW FLEXIBLE CONNECTIONS.
$\langle 3 \rangle$	MODIFY EXISTING EQUIPMENT PAD AS REQUIRED TO ACCOMMODATE NEW AHU. MOUNT ON SPRING VIBRATION ISOLATORS SIMILAR TO VCM GROUP MODEL AMSR-1C-520N
4	PROVIDE NEW ALD'S FOR ALL FRESH AIR DAMPERS SERVING AHU 6, 7, 4 8. DAMPERS TO BE SIMILAR TO GREENHECK VCD SERIES. ALL ACTUATORS TO BE BY BELIMO AND TIED INTO THE NEW BMS.
5	NEW VAV IN PLACE OF EXISTING CONSTANT VOLUME REHEAT COIL. CUT BACK AND EXTEND EXISTING PIPING AND DUCTWORK AS REQUIRED TO INSTALL NEW VAV BOX.
6	NEW BMS ENABLED THERMOSTAT IN PLACE OF EXISTING.
$\langle 7 \rangle$	NEW DIFFUSER IN PLACE OF EXISTING. PROVIDE NEW VOLUME DAMPER AT ALL NEW TAPS. BALANCE TO CFM VALUE TAKEN FROM PRE-DEMOLITION AIR CONDITIONS.
<u>&lt;</u> 8>	CONNECT NEW DIFFUSER TO EXISTING BRANCH DUCTWORK. BALANCE TO CFM TAKEN FROM PRE DEMOLITION AIR READINGS.
<u>(</u> 9)	PROVIDE NEW TEMPERATURE SENSOR FOR SPACE AVERAGING.
(10)	EXISTING FLOOR LEAK DETECTORS TO BE CONNECTED AND TIED INTO BMS.


ADD ALTERNATE

REPLACE ALL EXISTING DUCT MAINS IN KIND WITH NEW.


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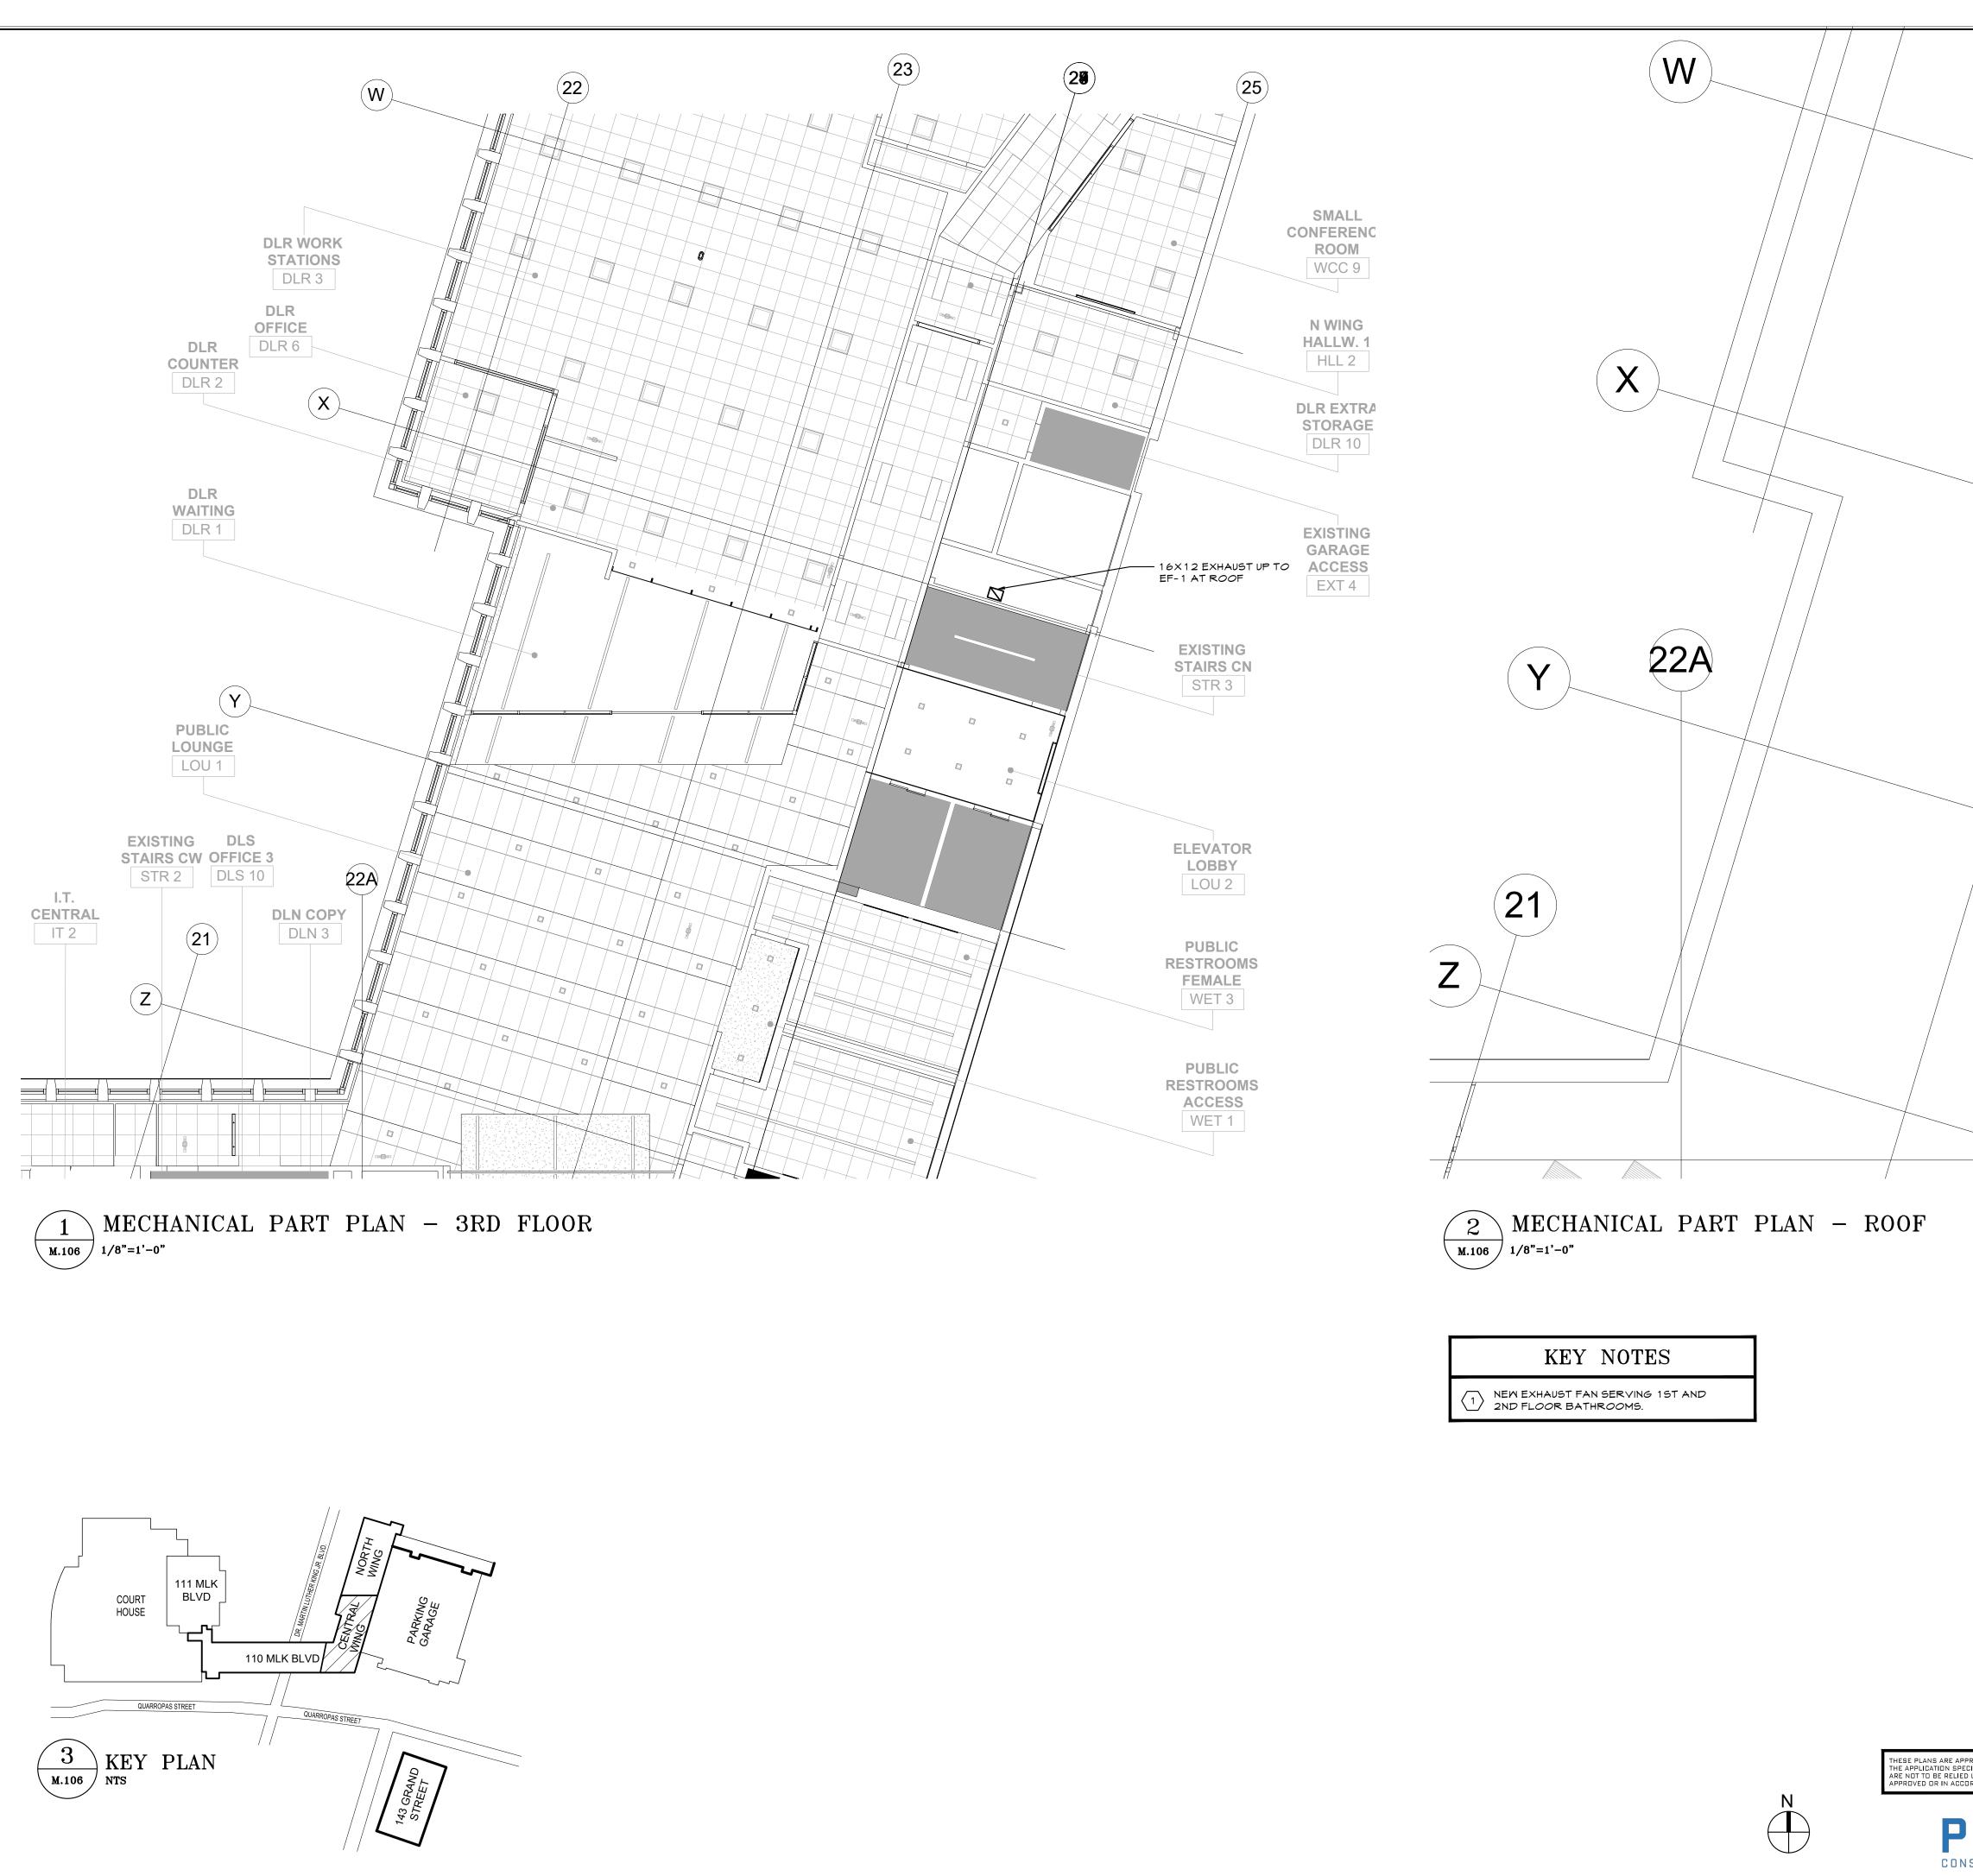
2ND FLOOR CENTRAL WING MECHANICAL PLAN

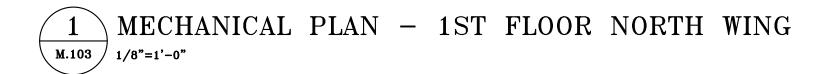

	KEY NOTES
	NEW CABINET HEATER IN PLACE OF EXISTING. RECONNECT TO EXISTING HOT WATER PIPING.
2	NEW VAV IN PLACE OF EXISTING CONSTANT VOLUME REHEAT COIL. CUT BACK AND EXTEND EXISTING PIPING AND DUCTWORK AS REQUIRED TO INSTALL NEW VAV BOX.
(٤	NEM CEILING RETURN GRILLE
$\langle 4 \rangle$	REBALANCE EXISTING DIFFUSER TO CFM TAKEN FROM PRE DEMO AIR READINGS.
(5	PROVIDE NEW TEMPERATURE SENSOR FOR SPACE AVERAGING.
6	CONNECT NEW DIFFUSER TO EXISTING BRANCH DUCTWORK. PROVIDE NEW VOLUME DAMPER AT EACH TAP. BALANCE TO CFM TAKEN FROM PRE DEMOLITION AIR READINGS.
(7)	NEW DIFFUSER IN PLACE OF EXISTING. BALANCE TO CFM VALUE TAKEN FROM PRE-DEMOLITION AIR READINGS.
	ADD ALTERNATE

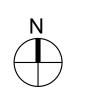
REPLACE ALL EXISTING DUCT MAINS IN KIND WITH NEW.

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KEY NOTES	
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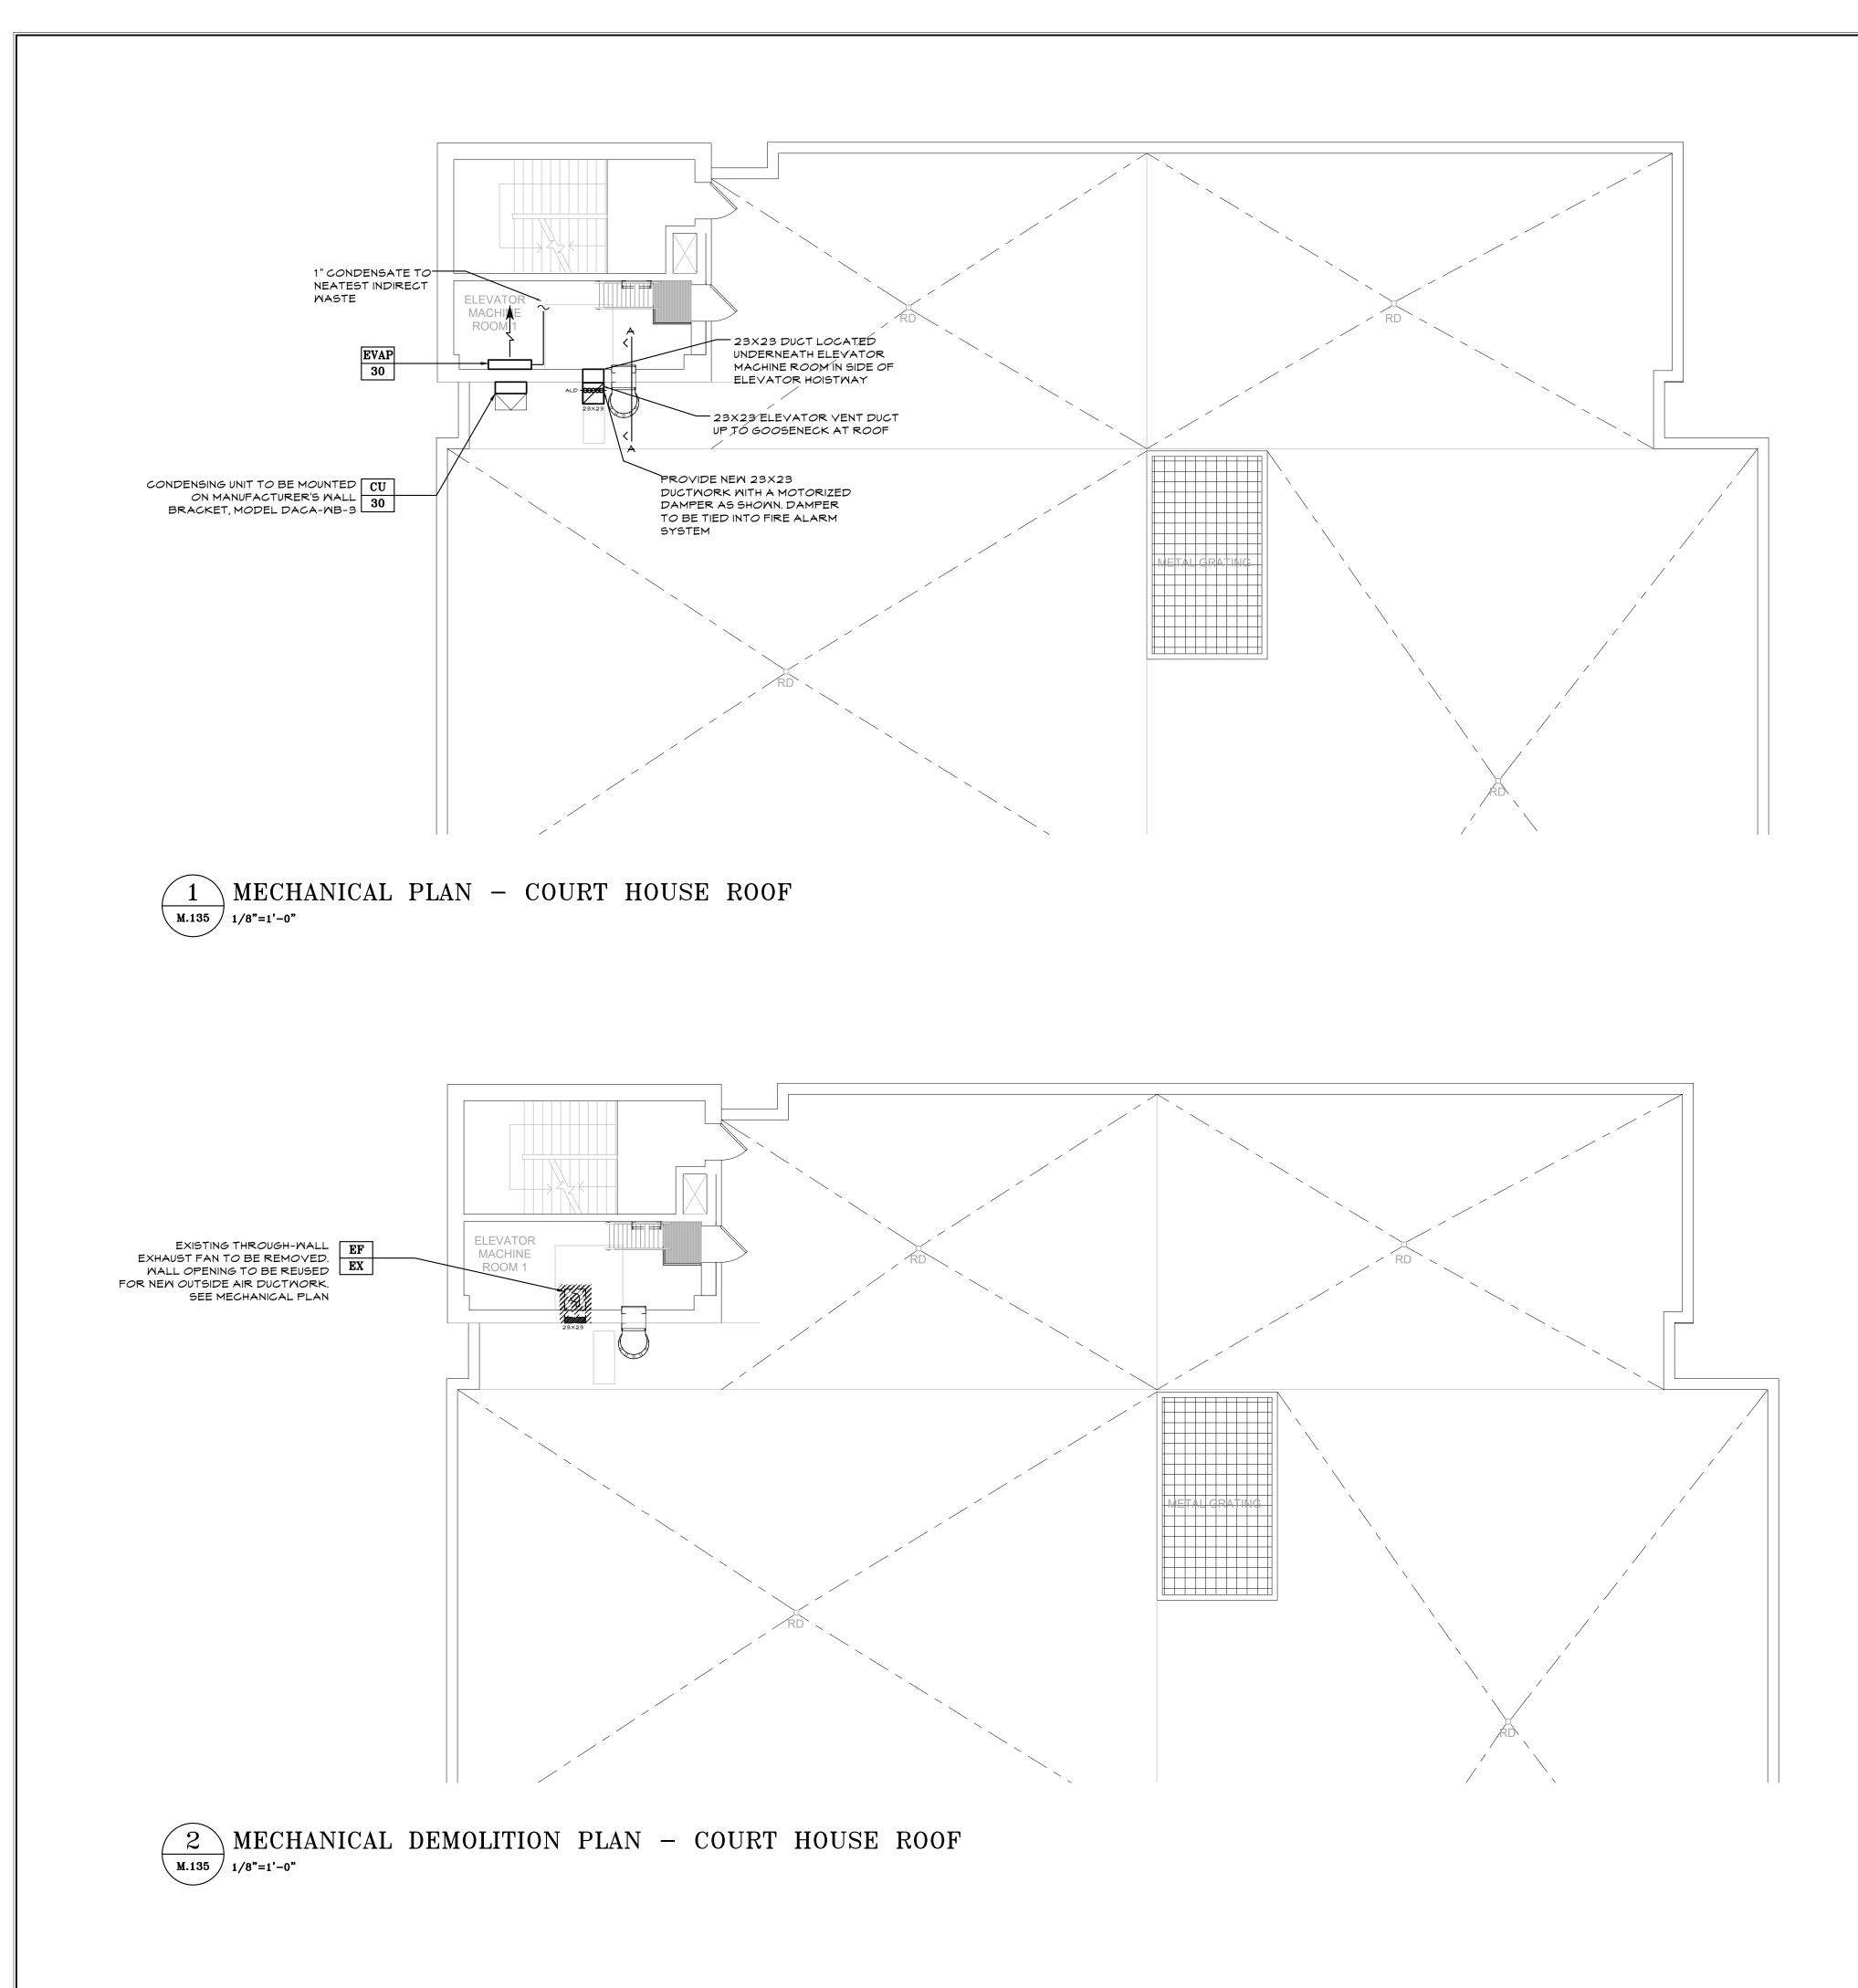
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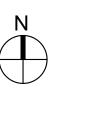

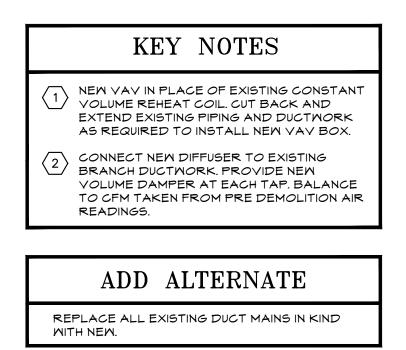
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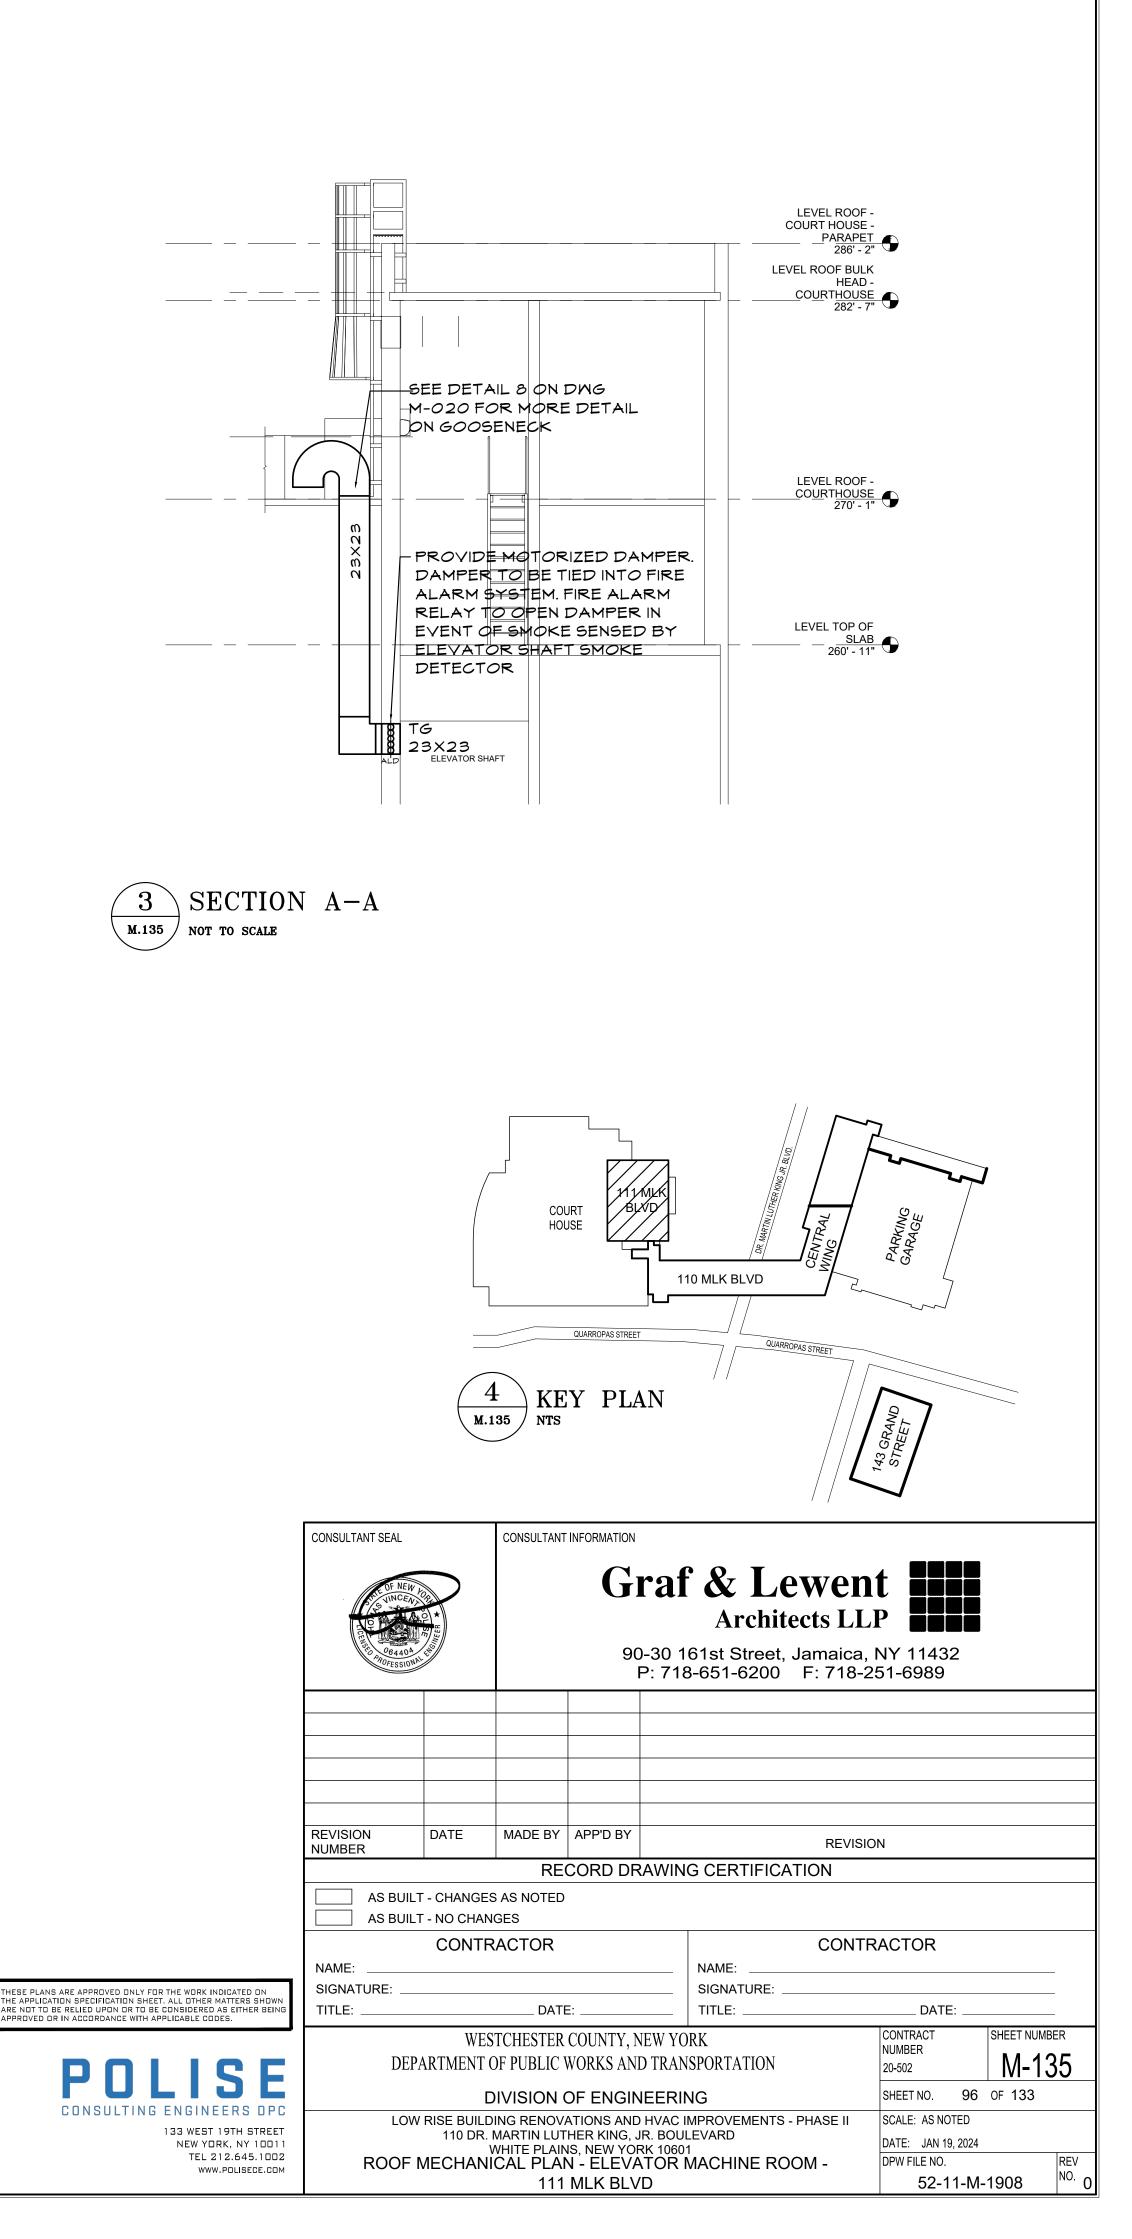


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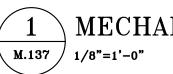




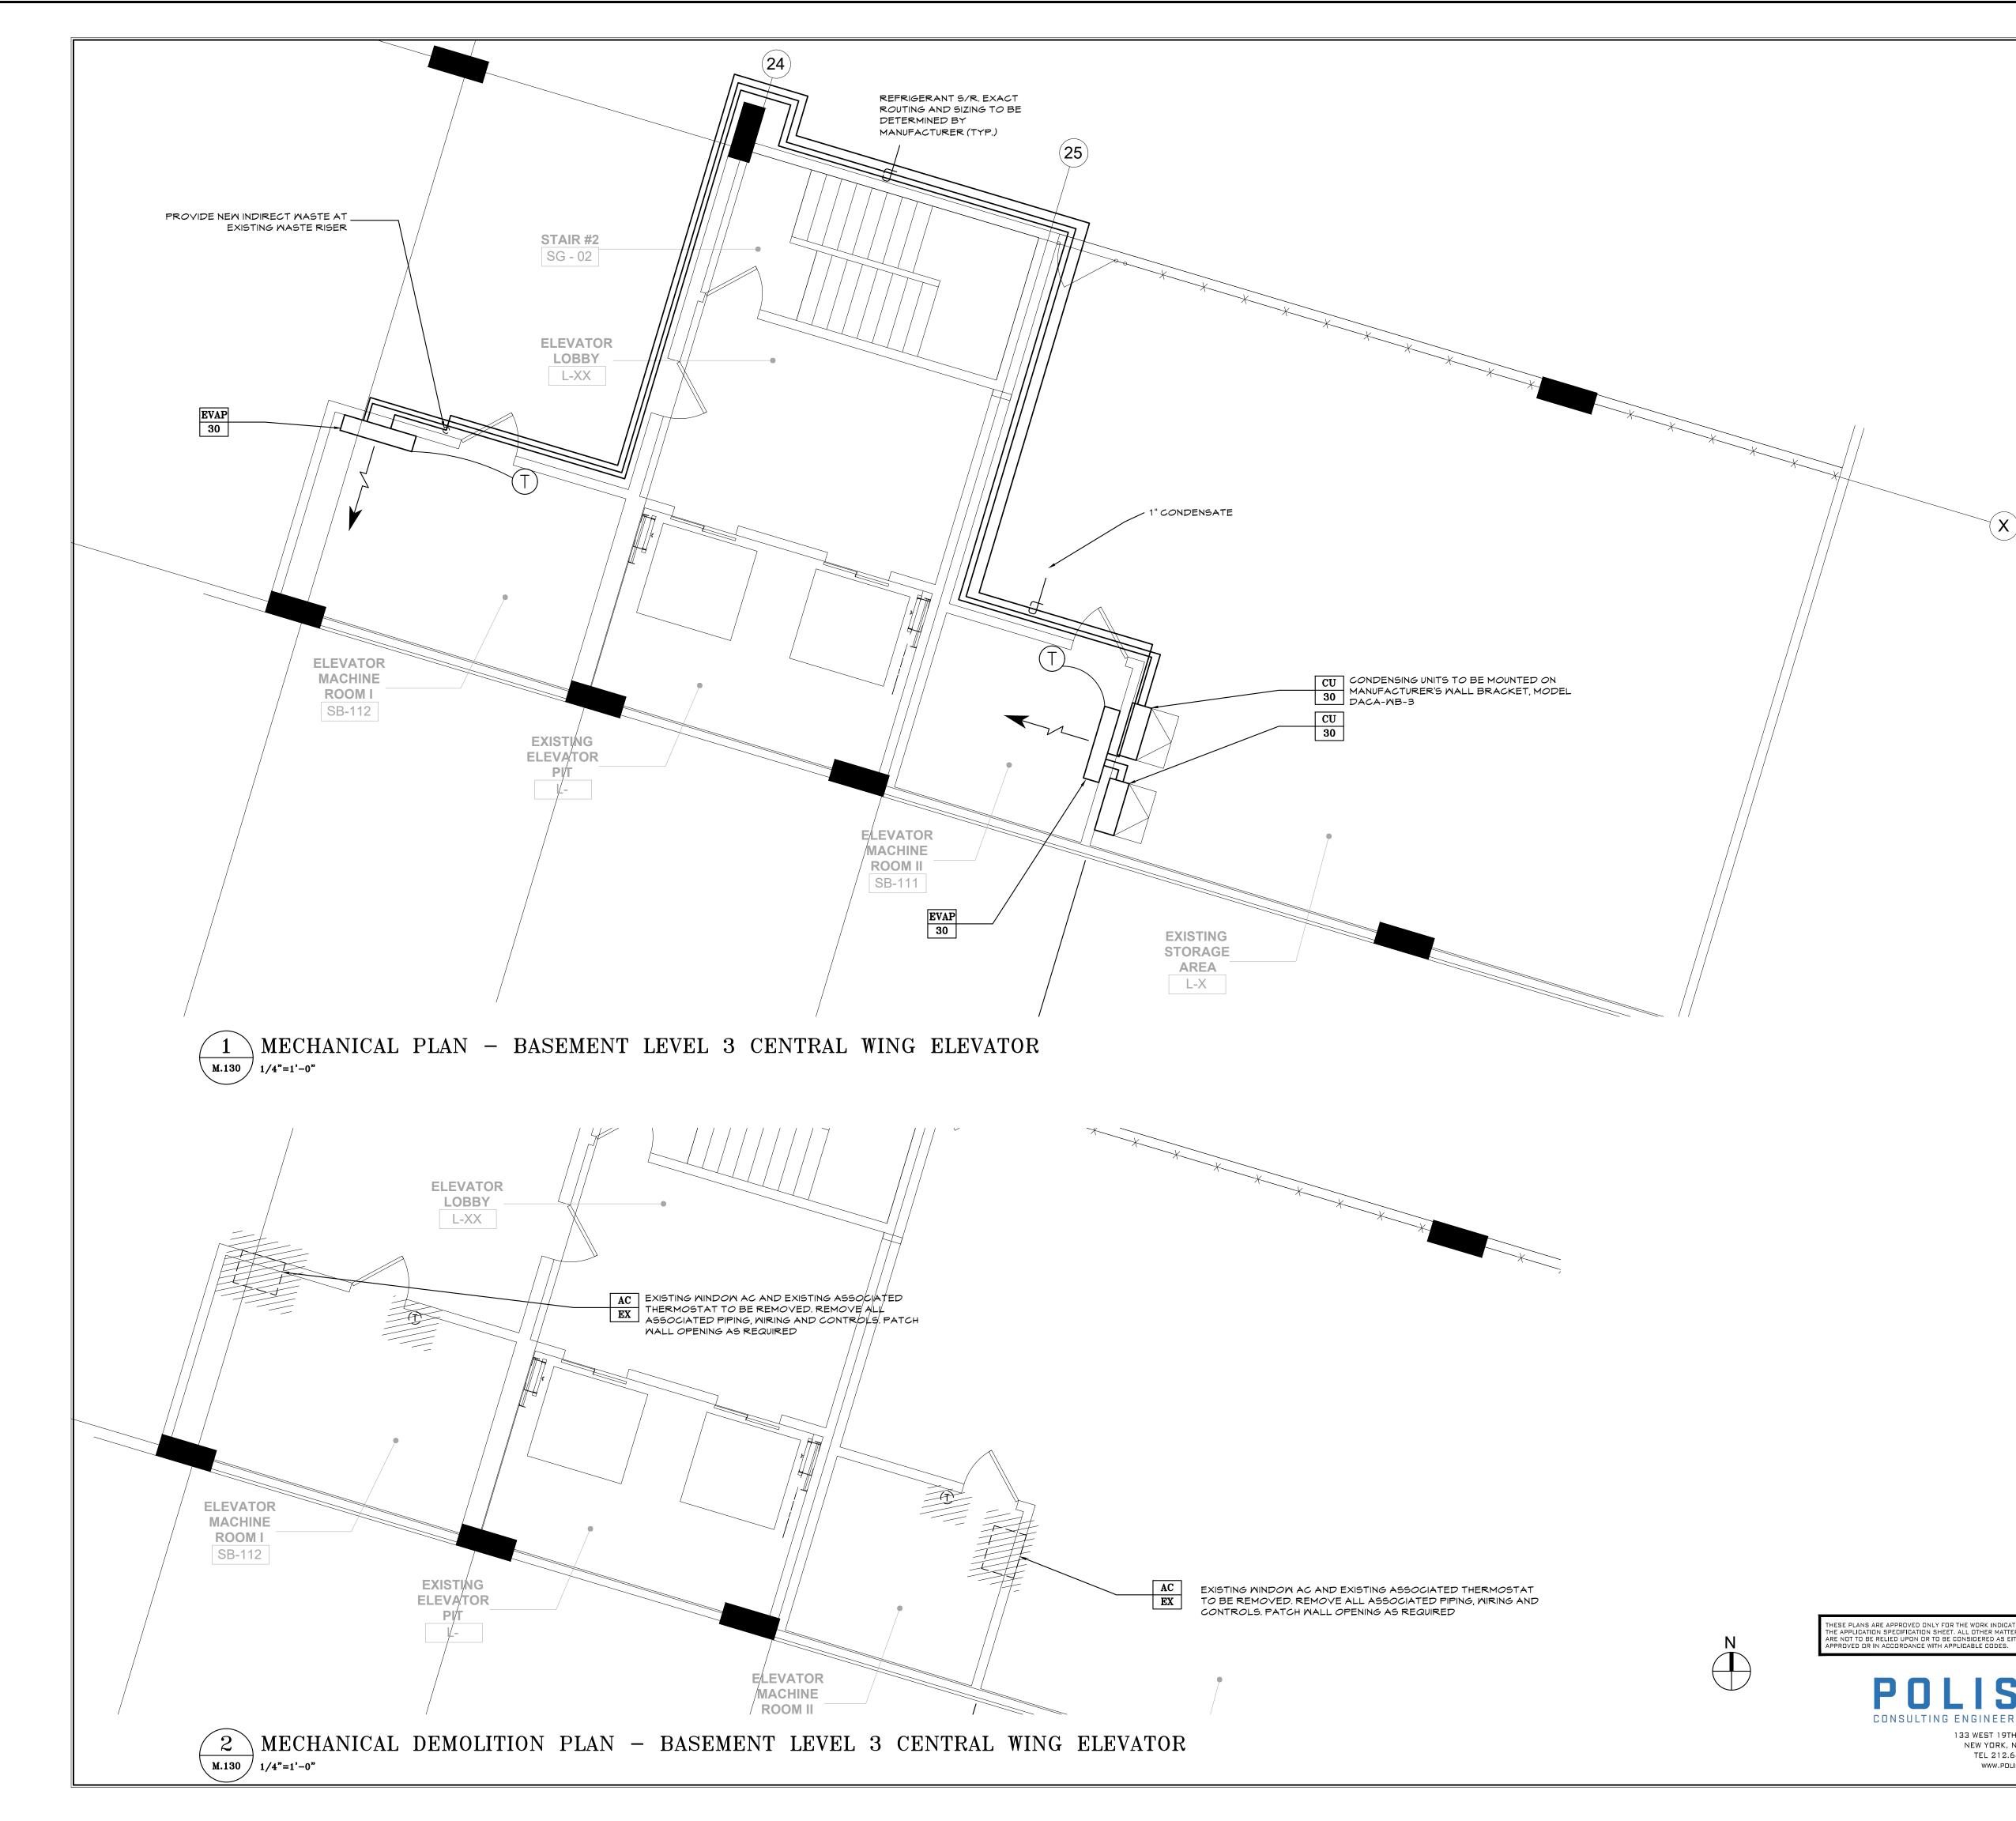













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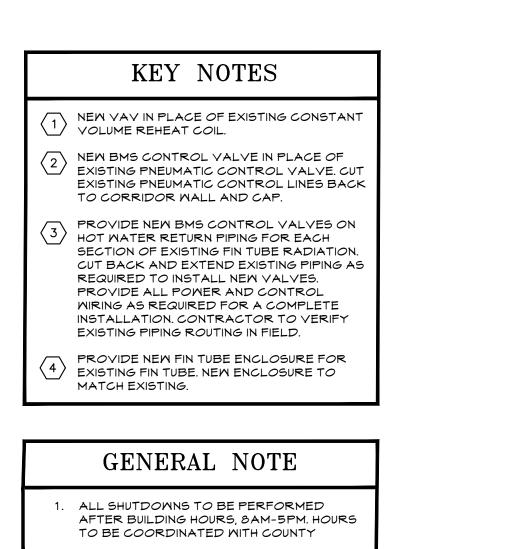
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	(3) REQUIRED TO MOUNT ON SPR	ING EQUIPMENT PAD AS ACCOMMODATE NEW AHU. RING VIBRATION ISOLATORS CM GROUP MODEL ON	
	(4) DAMPERS SER TO BE SIMILAR SERIES. ALL AC	ALD'S FOR ALL FRESH AIR RVING AHU 6, 7, \$ 8. DAMPERS R TO GREENHECK VCD CTUATOR TO BE BY BELIMO D THE NEW BMS.	
	5 NEW VAV IN PL VOLUME REHE	ACE OF EXISTING CONSTANT AT COIL.	
		TROL VALVE IN PLACE OF IMATIC CONTROL VALVE. ALL VALVES SHALL BE TYPE.	
	(7) HOT WATER RE SECTION OF EX CUT BACK AND REQUIRED TO PROVIDE ALL WIRING AS REC INSTALLATION	BMS CONTROL VALVES ON ETURN PIPING FOR EACH XISTING FIN TUBE RADIATION. DEXTEND EXISTING PIPING AS INSTALL NEW VALVES. POWER AND CONTROL RUIRED FOR A COMPLETE . CONTRACTOR TO VERIFY G ROUTING IN FIELD.	
	(8) WATER/STEAN NEW AHU. PROV	XISTING CHILLED M SUPPLY & RETURN PIPING TO VIDE SHUT-OFF VALVES AT JTION. SEE DETAIL ON 20.	
		R IN PLACE OF EXISTING. ENCLOSURE TO MATCH	
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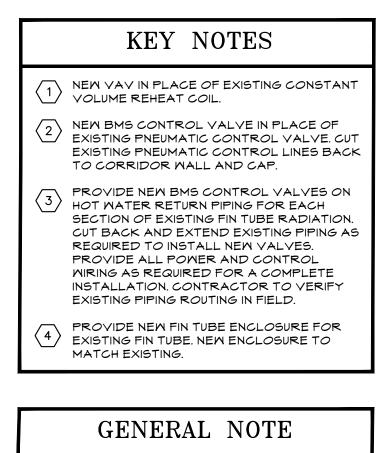




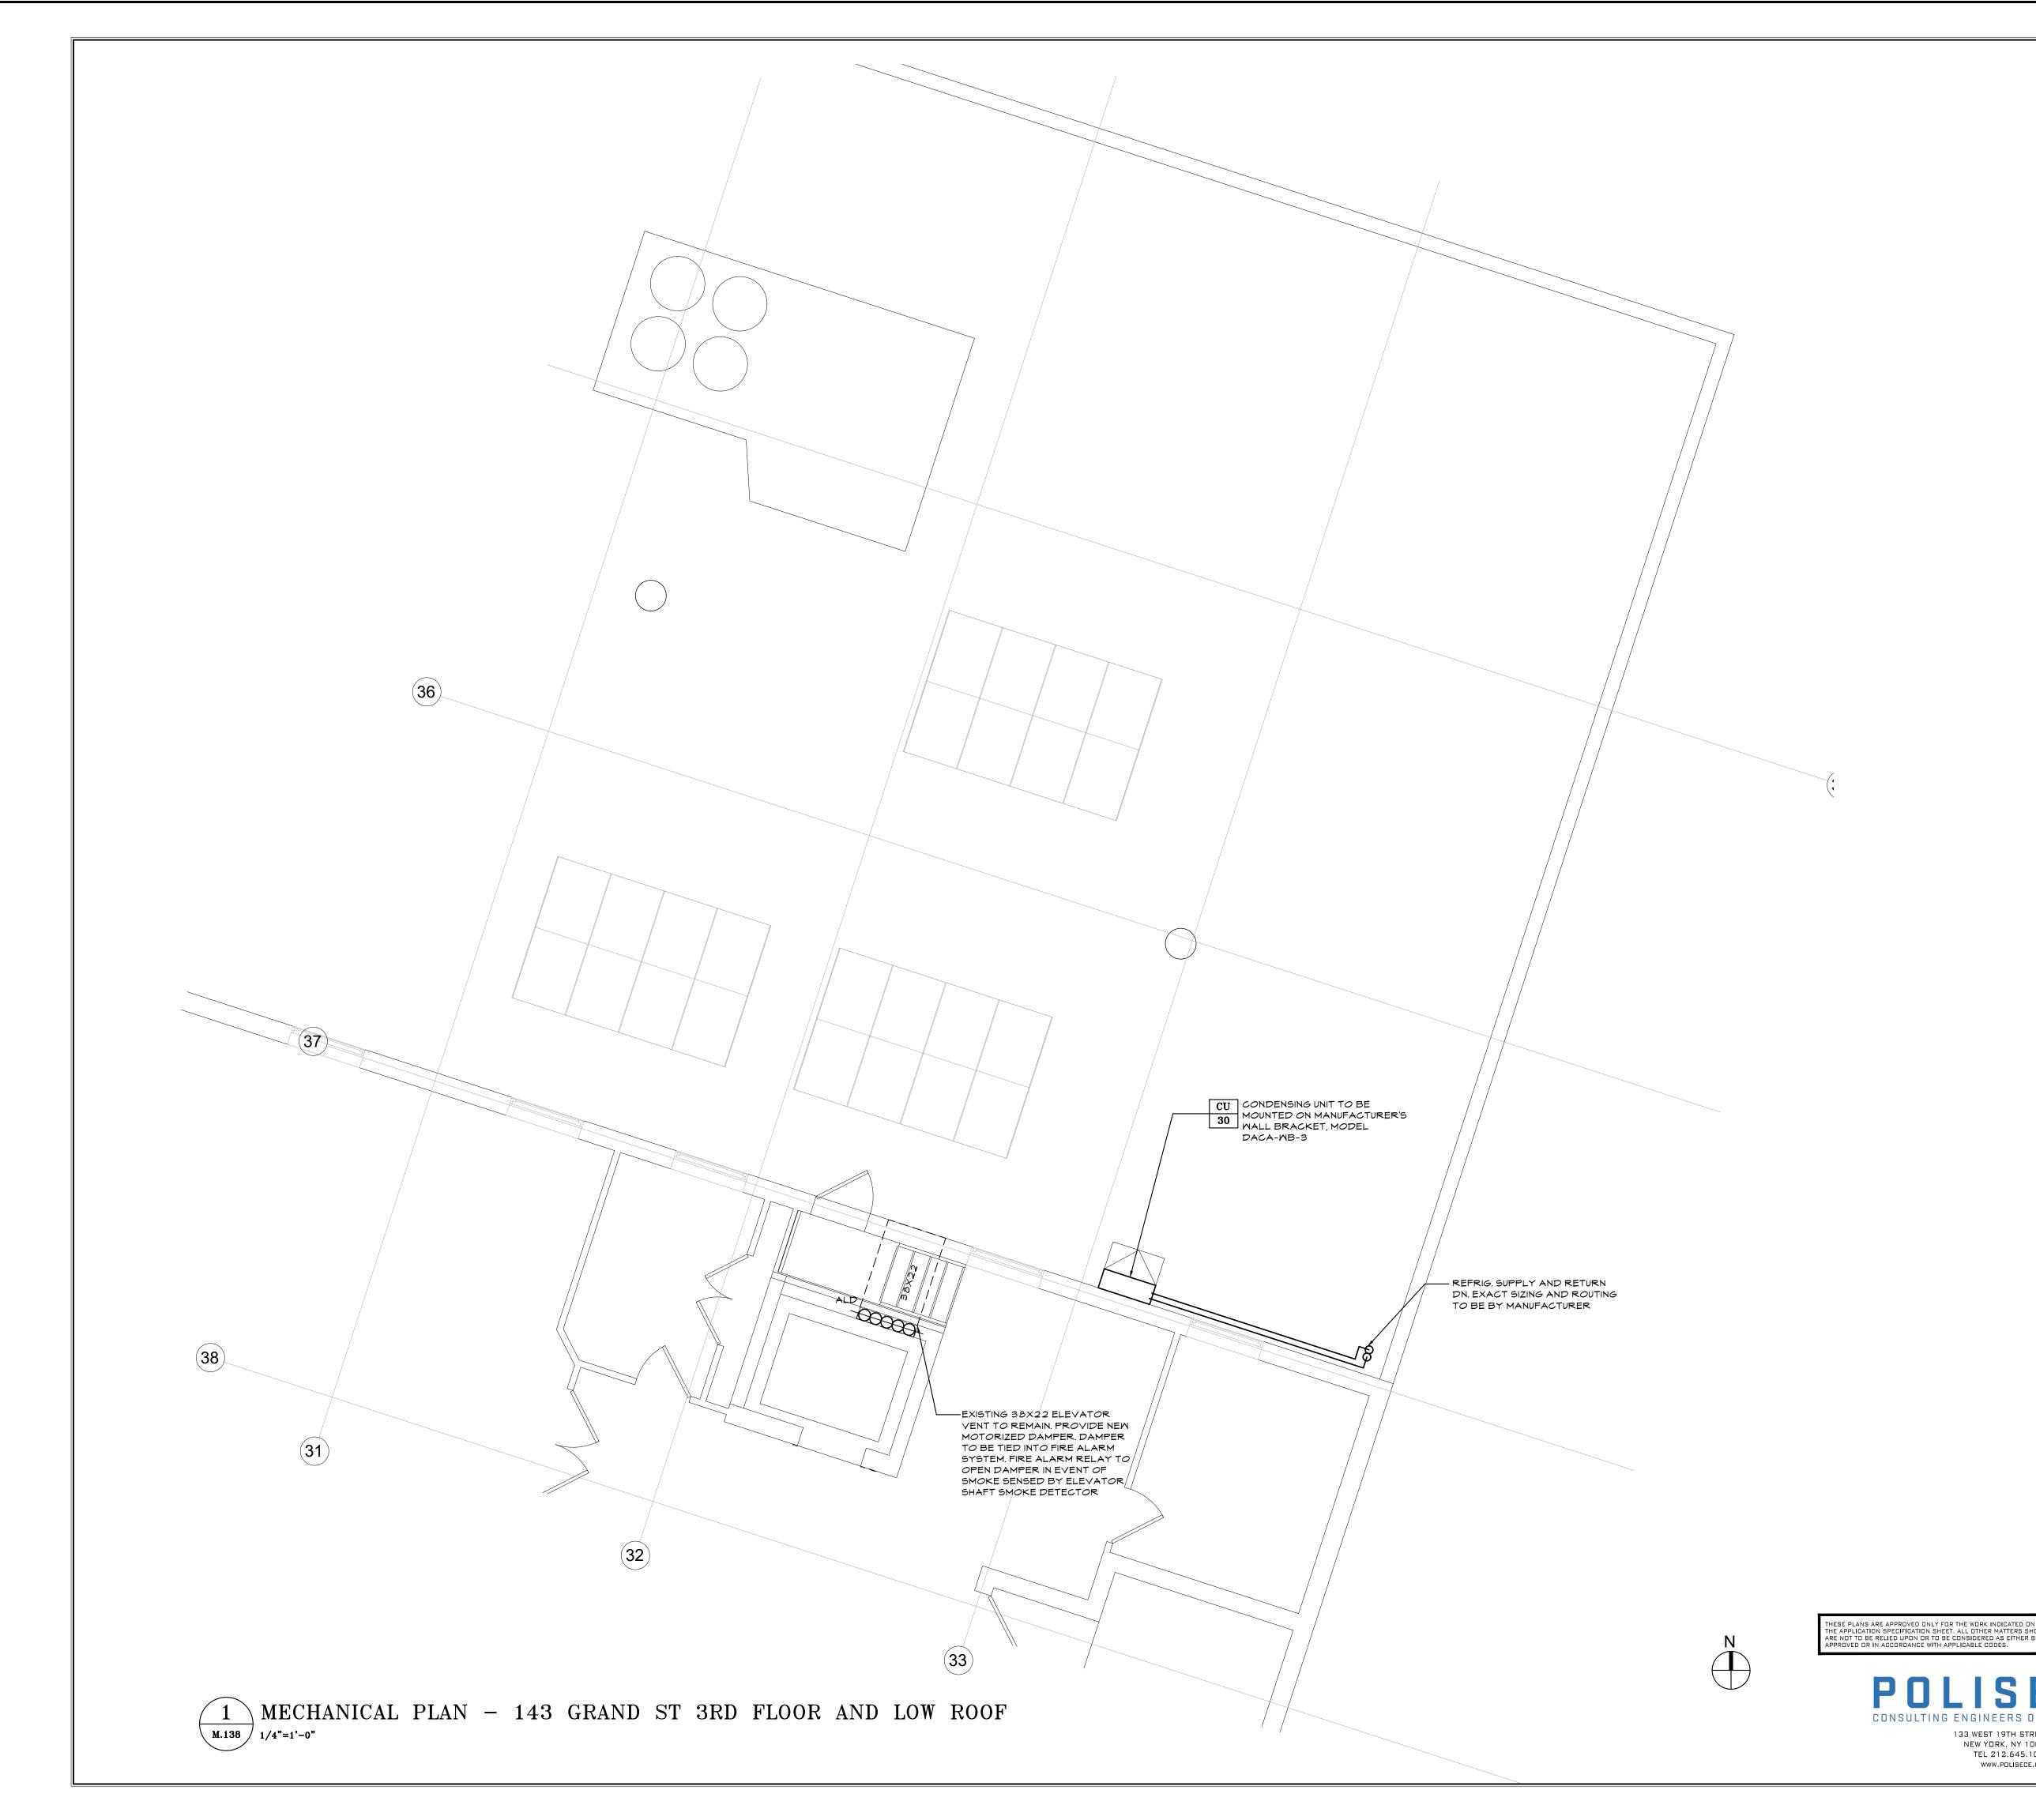

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ENGINEERS DPC 133 WEST 19TH STREET NEW YORK, NY 10011 TEL 212.645.1002	LOV	110 DR.	MARTIN LUT	ATIONS AND HVA HER KING, JR. B NS, NEW YORK 10	OULEV	ROVEMENTS - PHASE II ARD	SCALE: AS NOTED DATE: JAN 19, 2024	
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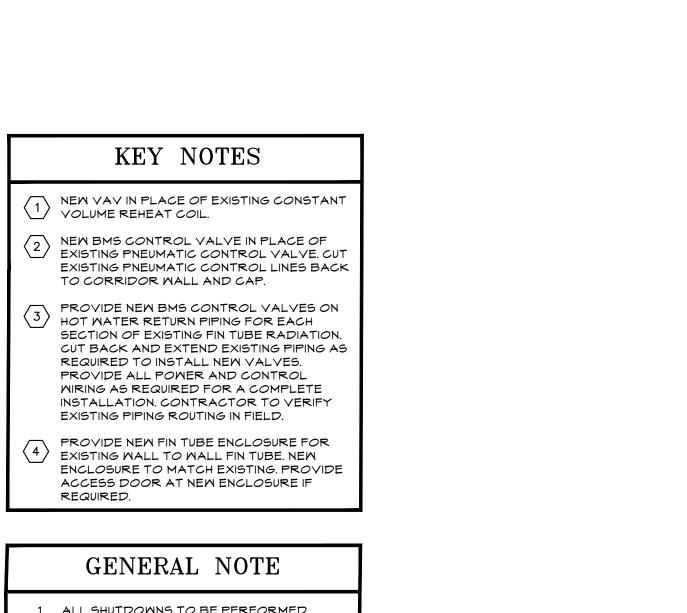


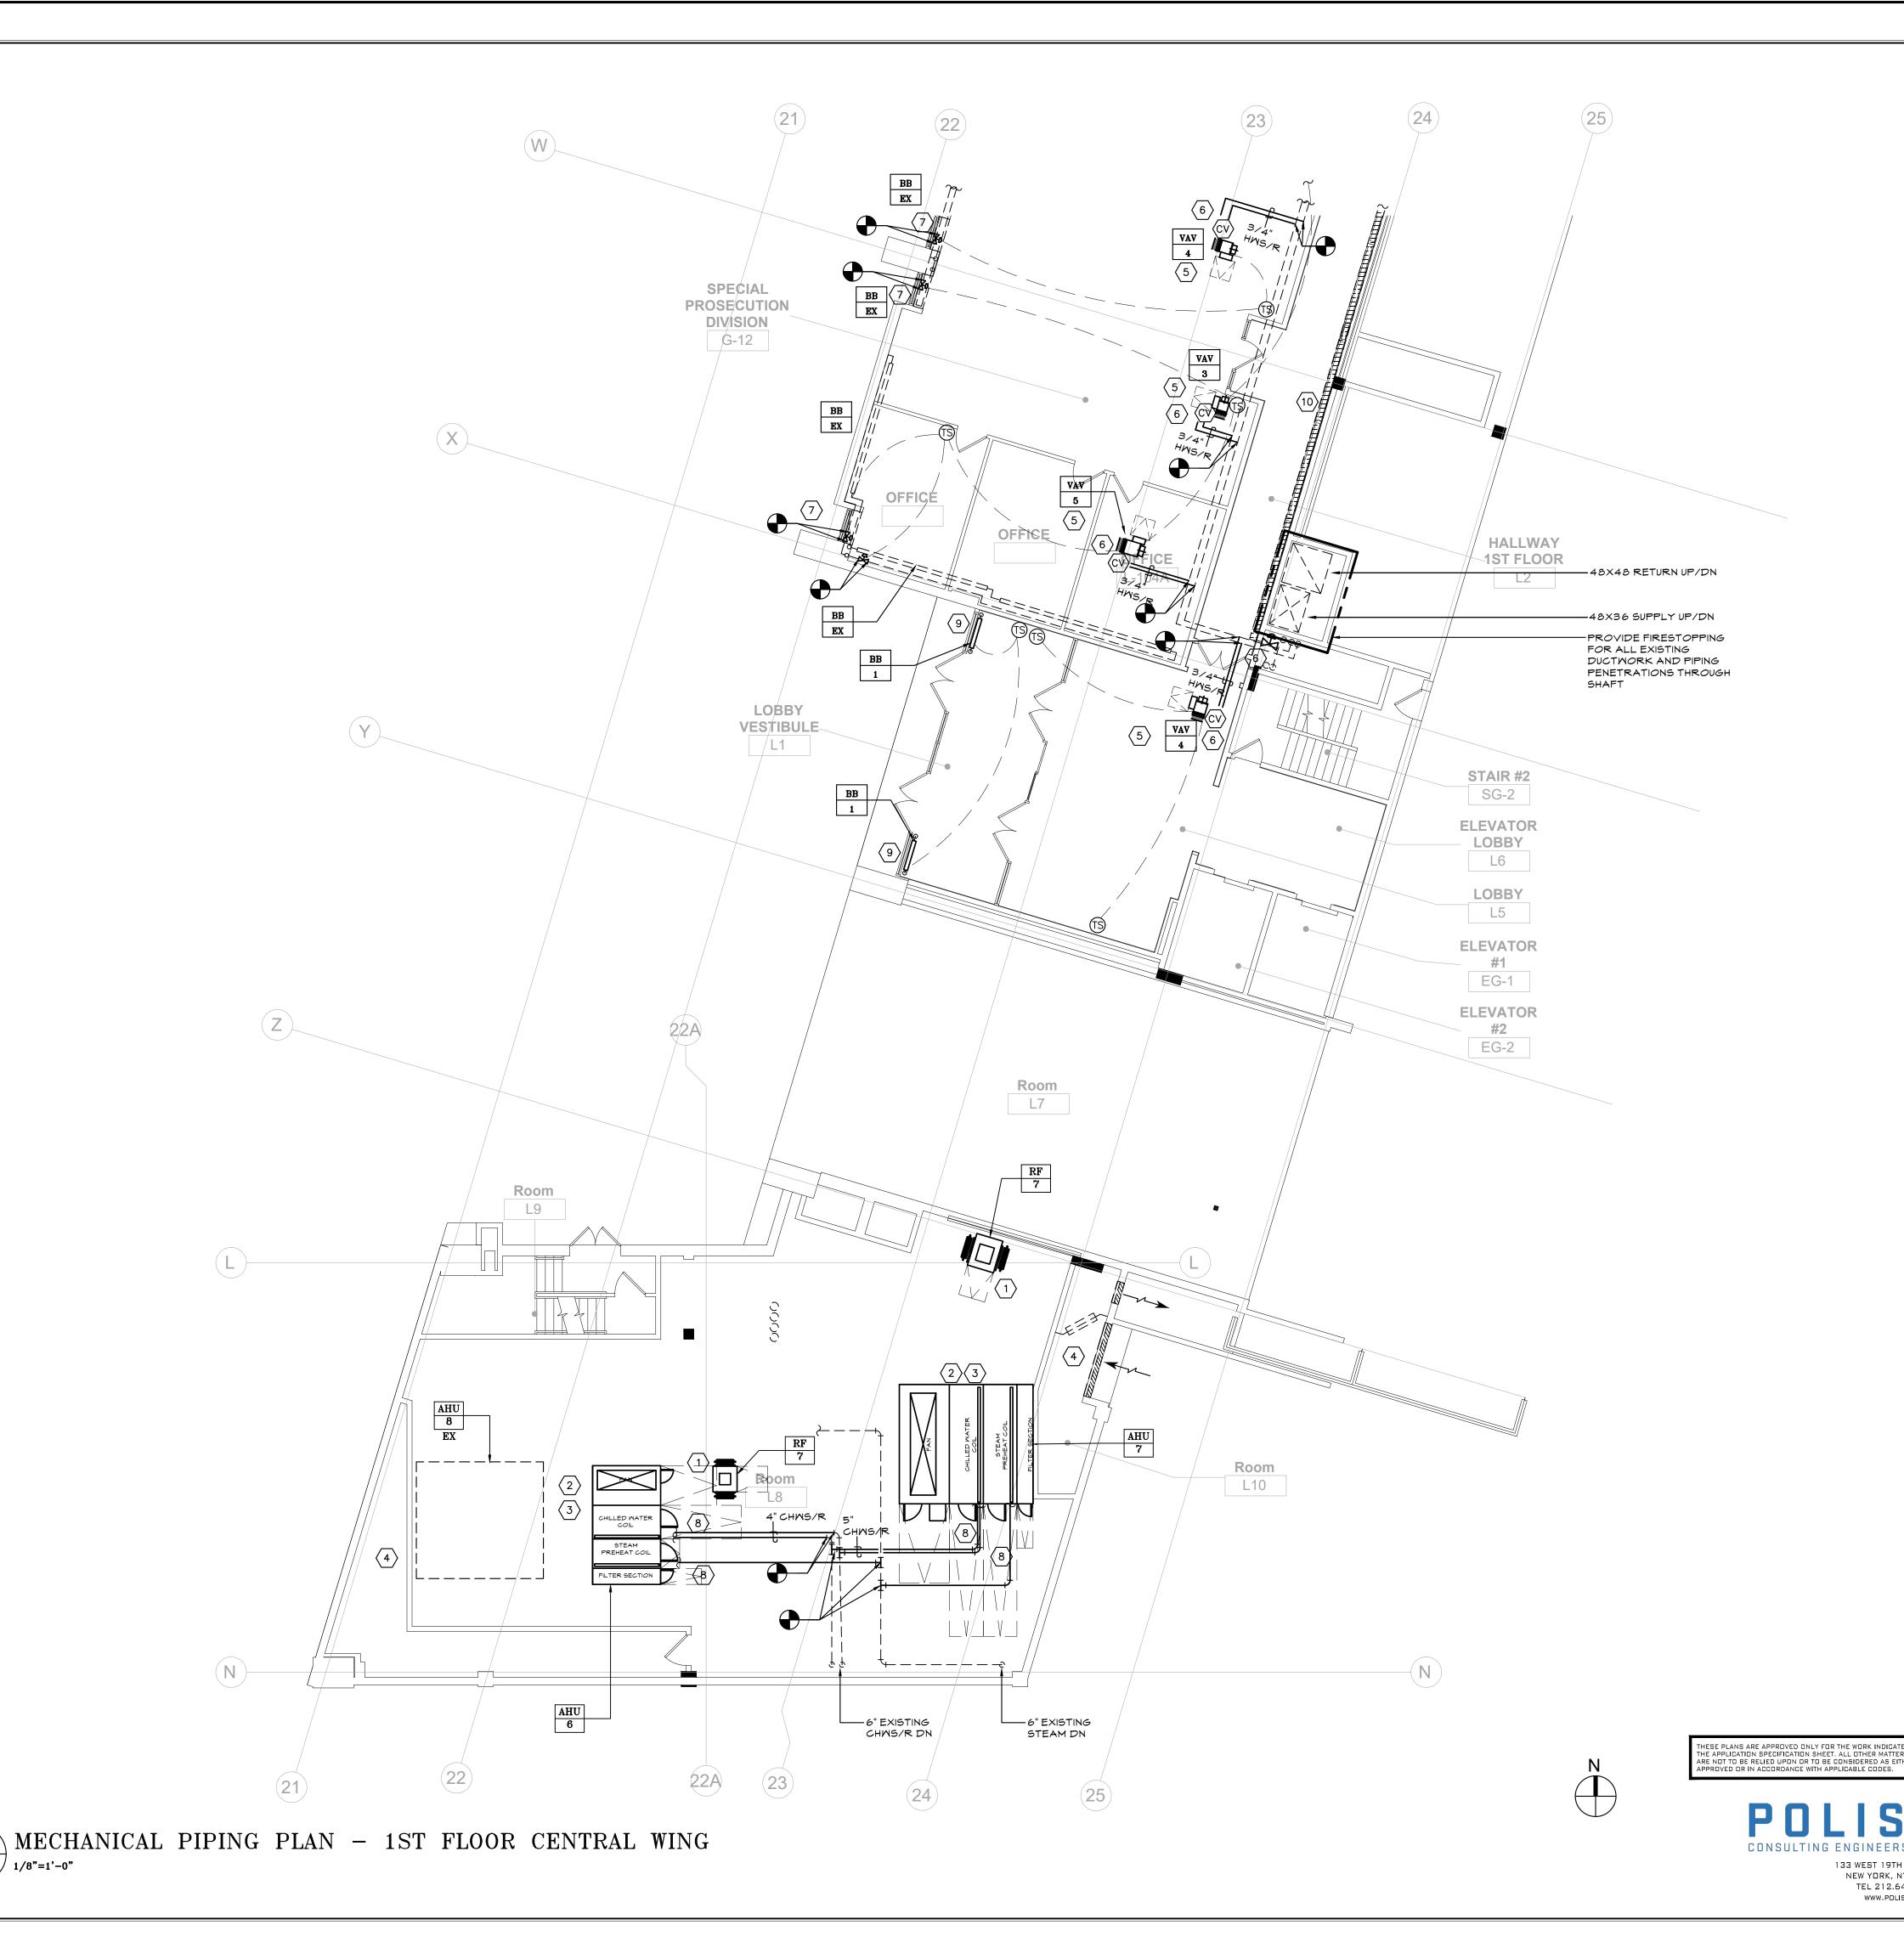

 ALL SHUTDOWNS TO BE PERFORMED AFTER BUILDING HOURS, 8AM-5PM. HOURS TO BE COORDINATED WITH COUNTY

					_ <b>b</b>	10 MLK BLVD	143 GRAND STREET GARAGE GARAGE	
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WESTCHESTER COUNTY, NEW YORK DEPARTMENT OF PUBLIC WORKS AND TRANSPORTATION							CONTRACT NUMBER 20-502	SHEET NUMBER
ENGINEERS DPC 133 WEST 19TH STREET	LOW	RISE BUILD	ING RENOV	OF ENGIN ATIONS AND HER KING, JI	HVAC I	MPROVEMENTS - PHASE II	SHEET NO. 10 SCALE: AS NOTED	
NEW YORK, NY 10011 TEL 212.645.1002 WWW.POLISECE.COM	2ND F	١	WHITE PLAIN	IS, NEW YOR	K 1060		DATE: JAN 19, 202 DPW FILE NO. 52-11-N	REV
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 ALL SHUTDOWNS TO BE PERFORMED AFTER BUILDING HOURS, 8AM-5PM. HOURS TO BE COORDINATED WITH COUNTY

						110 MLK BLVD	143 GRAND STREET GARAGE GARAGE	
	CONSULTANT SEAL		CONSULTANT	INFORMATION		/ /		
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LISE							20-502 SHEET NO. 102	
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133 WEST 19TH STREET NEW YORK, NY 10011 TEL 212.645.1002		110 DR	. MARTIN LUT	HER KING, JR. IS, NEW YORK	BOUL	EVARD	DATE: JAN 19, 2024	
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	$\operatorname{SYMBO}$ (see specifications for ma	NUFACTURER/MODEL # U.O.N.)						
OUTLETS								
DEVICE	DESCRIPTION	NOTES/ CONDUIT ROUTING						
$\bigcirc$	WALL DUPLEX RECEPTACLE	"R" INDICATES RELOCATED DEVICE TO BE REPLACED WITH NEW DEVICE AND WALL PLATE (BACKBOX/WIRING RELOCATED)						
	GFI TYPE RECEPTACLE	"F" INDICATES DEVICE IS INSTALLED IN FURNITURE SYSTEM						
$\oplus$	MALL QUAD RECEPTACLE	"M" INDICATES DEVICE IS INSTALLED IN MILLWORK						
φ	WALL SIMPLEX RECEPTACLE	NEMA 5-20R UNLESS OTHERWISE NOTED						
$\square$	FURNITURE MOUNTED DUPLEX RECEPTACLE	FURNITURE SYSTEM DEVICES TO BE FURNISHED BY SYSTEM MANUFACTURER						
$\bigoplus$	FURNITURE MOUNTED QUAD RECEPTACLE							
	DUPLEX RECEPTACLE CEILING MOUNTED							
Ţ	FURNITURE MOUNTED VOICE/DATA OUTLET	DO NOT RUN LINE VOLTAGE WIRING PARALLEL TO LOW VOLTAGE						
	DATA/VOICE OUTLET	FURNITURE SYSTEM DEVICES TO BE FURNISHED BY SYSTEM MANUFACTURER						
	DATA FLOOR OUTLET	COORDINATE WITH IT/SECURITY VENDOR FOR ANY SPECIAL REQUIREMENTS.						
	DATA OUTLET	$4 - \frac{11}{16}$ " X $4 - \frac{11}{16}$ " X $2 - \frac{1}{2}$ " DEEP BACK BOX WITH SINGLE GANG COVER PLATE. NO BACK BOX						
₽	FLUSH MOUNTED WALL PHONE	IF INDICATED AS INSTALLED IN WIREWAY OF FURNITURE SYSTEM.						
₩	SURFACE MOUNTED SINGLE PORT TV OUTLET	PROVIDE ALLOWANCE FOR RUNNING EMPTY IT CONDUIT FROM IT CLOSETS TO WORKSTATIONS AND DATA OUTLETS IN SPACE. IT REQUIREMENTS SHALL BE PROVIDED IN FUTURE BY IT CONSULTANT.						
V	SURFACE MOUNTED FLOOR BOX QUAD RECEPTACLE WITH POWER AND COMMUNICATION DEVICES	1" CONDUIT FOR POWER. 1-1/4"" CONDUIT FOR LOW VOLTAGE. 1-1/4" CONDUIT FOR A.V. PC/CONV: INDICATES QUAD RECEPTACLE WITH (1) DUPLEX PC RECEPTACLE AND (1) DUPLEX CONVENIENCE RECEPTACLE.						
$\bigcirc \bullet$	POWER FEEDS SERVING FURNITURE AND WHIP TO FURNITURE SYSTEM	1" CONDUIT FOR POWER 1-1/4" CONDUIT FOR LOW VOLTAGE PROVIDE FLEXIBLE METAL CONDUIT FOR						
۵	POWER POLE (PROVIDED BY OTHERS)	FURNITURE FEED WHIP						
CR	CARD READER	EXTEND 1-1/4" EC FROM DEVICE TO IT ROOM SERVING SPACE. (SPECIFIED BY OTHERS). PROVIDE JUNCTION BOX FOR						
C	CAMERA	CAMERA, WIRE TO NEAREST IT CLOSET COORDINATE WITH IT/SECURITY VENDOR FOR ANY SPECIAL REQUIREMENTS						

## ABBREVIATIONS

ABBREV.	DESCRIPTION	ABBREV.
A	AMPS	KVA
AC		
	AIR CONDITIONING	KΜ
AD	ACCESS DOOR	KMH
AFF	ABOVE FINISHED FLOOR	LTG
ALD	AUTOMATIC LOUVER DAMPER	LN
AUTO	AUTOMATIC	LV
в	WITH BYPASS	MCB
BLDG	BUILDING	мсс
BMS	BUILDING MANAGEMENT SYSTEM	MCM
BPS	BOLTED PRESSURE SWITCH	MECH
C C	CONDUIT	MISC
CKT	CIRCUIT	M.L.O.
	CLOCK	N.L.O.
CLK CM	CLOCK CIRCULAR MIL	N/C
CLG	CEILING	NEC
<i>CO</i>	COMPANY	NEMA
CONV	CONVENIENCE	
CR	CARD READER	N.I.C
CT	CURRENT TRANSFORMER	NL/EMB
CU	CUBIC	
DB	DISTRIBUTION BOARD	NL/EM
DF	DRINKING FOUNTAIN	
DIA	DIAMETER	NL
DP	DISTRIBUTION PANEL	N/0
DS	PROPRIETARY TO DIMMING	P
20	SYSTEM	PB
DMG	DRAWING	PC
EA	EACH	PH
EC	EMPTY CONDUIT	PL
ELEC	ELECTRICAL	PLBG
ELEV	ELEVATOR	PNL
	FIXTURE WIRED TO	PT
EM		R
	EMERGENCY POWER	RC
EMB	FIXTURE WITH 90 MIN.	
	BATTERY PACK	RD
EP	EXPLOSION PROOF	RF
EX	EXISTING	SPECS
F	INDICATES INTEGRAL FURNITURE	SPKLR
	SYSTEM	SPK
FA	FIRE ALARM	STD
FB	FLOOR BOX	SM
FCC	FIRE COMMAND CENTER	SMBD
FT	FEET	TEMR.
GFI	GROUND FAULT	TV
<b>-</b>	INTERUPTING	TYP
G	GROUND	
HC HC	HUNG CEILING	
HP	HORSEPOWER	
HP HTG		U.O.N
	HEATING	
HVAC	HEATING, VENTILATING	
	& AIR CONDITIONING	M
IG	ISOLATED GROUND	MP
IN	INCHES	MT
JB	JUNCTION BOX	ΦM

S	
DESCRIPTION	
KILOVOLT-AMPERES KILOWATT KILOWATT-HOURS	
LIGHTING LINE VOLTAGE LOW VOLTAGE	
MAIN CIRCUIT BREAKER MOTOR CONTROL CENTER THOUSAND CIRCULAR MILLS	
MECHANICAL MISCELLANEOUS MAIN LUGS ONLY	
NEUTRAL NORMALLY CLOSED NATIONAL ELECTRIC CODE	
NATIONAL ELECTRICAL MANUFACTURERS ASSOC. NOT IN CONTRACT	
FIXTURE WITH BATTERY PACK ON NIGHT LIGHTING CIRCUIT NIGHT LIGHT FIXTURE	
WIRED TO EMERGENCY POWER ON NIGHT LIGHTING CIRC. NORMALLY OPEN	
POLES PULL BOX	
PERSONAL COMPUTER PHASE PILOT LIGHT	
PLUMBING PANEL POKE THRU	
RELOCATED REMOTE CONTROL ROLL UP DOOR	
RAISED FLOOR SPECIFICATIONS SPRINKLER	
SPEAKER STANDARD SWITCH	NC
SWITCHBOARD TRANSFORMER	1. 0
TELEVISION TYPICAL UNDERFLOOR DUCT	2.7 3.0
UNFUSED UNLESS OTHERWISE NOTED VOLTS	4.7 5.0 6.0
VAPOR PROOF MIRE MEATHER PROOF	7А.: 7В.:
WIRE TROUGH WIRELESS	: 

BOXES,	EQUIPMENT, a	& RAC
DEVICE	DESCRIPTION	NOT
	SURFACE MOUNTED WIREWAY	ALUMINUM SEPARATI VOLTAGE
⊂ ^(#) ×	"#" INDICATES NUMBER OF EMPTY CONDUITS "X" INDICATES SIZE OF EMPTY CONDUITS.	
	PULL BOX	
0 <u>+</u>	JUNCTION BOX	
	DISCONNECT SWITCH INDICATES SWITCH SIZE (AMPS) INDICATES FUSE SIZE OR UNFUSED (U) SPECIAL (W.P., ETC.) NO. OF POLES	
	NEW PANEL BOARDS	
	SOLID LINEWORK INDICATES NEW DEVICE/ITEM	
	DASHED LINEWORK INDICATES EXISTING DEVICE/ITEM	
	DASHED LINEWORK WITH HATCH INDICATES EXISTING DEVICE/ITEM TO BE DEMOLISHED	
<u>c</u>	COPPER GROUND BAR	
T	TRANSFORMER	
TVSS	TRANSIENT VOLTAGE SURGE SUPPRESSION	
	STARTER/CONTROLLER	FOR MOUN ELECTRICA FURNISHED
	VARIABLE-FREQUENCY DRIVE	FOR MOUN ELECTRICA FURNISHED
X,Y	CIRCUIT HOMERUN TO PANEL INDICATED. NUMBER OF ARROW HEADS INDICATES NUMBER OF BRANCH POLES REQUIRED IN PANEL. 3 WIRE PER CIRCUIT UNLESS OTHER WISE NOTED (1H, 1N, 1G).	ASSOCIATI WIREWAY ( SINGLE AR WIRED TO )
$\bigotimes$	MOTOR - NUMBER INDICATES HORSE POWER. LETTER INDICATES SHADE MOTOR TYPE	
<b>/</b> ->	WIRE TO DEVICE/ EQUIPMENT	
~·/	CONDUIT CHOPPED IN FLOOR	
·	CONDUIT RUN AT FLOOR BELOW	
	POINT OF UTILITY ENTRY	

SYMBOL LIST

## BRANCH CIRCUITING SIZ

BREAKER	NO. OF POLES						
	1-POLE	2- POLE					
15A	2 # 12 +#12 G-3/4"C	3 # 12 +#12 G-3/4"C					
20A	2 # 12 +#12 G-3/4"C	3 # 12 +#12 <i>G</i> -3/4"C					
3 <i>0</i> A	2 # 10 +# 10 6-3/4"C	3 # 10 +#10 G-3/4"C					
40A	2 # 8 +#10 G-1"C	3 # 8 +#10 G-1"C					
5 <i>0</i> A	2 # 8 +#10 G-1"C	3 # 8 +# 1 <i>0 G</i> - 1"C					
60A	2 # 6+#10 G-1"C	3 # 6 +# 10 6- 1"C					
NOTES: 1. CIRCUIT SIZES BASED ON 75'-0" LENGTH FROM LOAD TO PANEL							

CIRCUIT SIZES BASED ON 15-0 LENGTH FROM LOAD TO PANEL BOARD, FOR LONGER CIRCUITING LENGTH APPLY 2% VOLTAGE DROP FACTOR FROM FEEDERS, AND 3% FOR BRANCH CIRCUITS.
 ALL SIZES BASED ON COPPER CONDUCTORS.
 CIRCUITS TO HAVE FULL SIZE GROUND CONDUCTOR.
 ALL CIRCUITS TO BE INSTALLED IN 3/4"C. UNLESS OTHERWISE NOTED.

4. ALL CIRCUITS TO BE INSTALLED IN 374°C. UNLESS OTHERWISE NOTED.
5. COMBINING OF NEUTRALS NOT PERMITTED.
6. GROUNDS MAY ONLY BE COMBINED ON GENERAL CONVENIENCE CIRCUITS.
7A. 2#X INDICATES 1H IN FOR 1 POLE CIRCUITS 2#X INDICATES 2H ON FOR 2 POLE CIRCUITS
7B.3#X INDICATES 2H IN FOR 2 POLE CIRCUITS 3#X INDICATES 3H ON FOR 3 POLE CIRCUITS
7C.4#X INDICATES 3H IN FOR 3 POLE CIRCUITS

				SYMBOL LIST						GENER
RAC	EWAYS			LIGHTING CONTROL D		VOL		ECURITY DRAM 1PTY CONDUIT		
NOTES/ CONDUIT ROUTING		DE	EVICE	DESCRIPTION	NOTES		2. SEE SEN	MECHAN SORS, PI	ICAL DRAWING RESSURE SENS	BORS ETC. PR
	WIREWAY WITH		\$ _a	2 BUTTON MANUAL CONTROL SWITCH WITH ON/OFF					HUNG CEILING	
	ELOW AND LIVE SECTIONS		\$ _{Da}	2 BUTTON MANUAL CONTROL DIMMER SMITCH WITH ON/OFF	LOWER CASE SUBSCRIPTS DENOT	ES	4.1.	TIGHTEN	E ON EQUIPME NALL BOLTS	
			\$ _{05,V5}	COMBINATION SENSOR SWITCH	LIGHTING CONTROL ZONE "OS" INDICATES OCCUPANCY SENS "VS" INDICATES VACANCY SENSOR		4.3.	REPLAC	NSIDE OF ALL SE ALL FUSES/ R TEST COPPE	CIRCUIT BREA
		\$	DOS,DVS	COMBINATION SENSOR SWITCH WITH DIMMER	OR 2	ELECTRICAL CA				
			VS	CEILING MOUNTED VACANCY SENSOR			LOC	CATIONS.	GE WIRING TO E	
			OS	CEILING MOUNTED OCCUPANCY SENSOR			ARE 3. EXC	EAS T <i>O</i> B CEPT F <i>O</i> R	E INSTALLED I NON POMER I E RUN AS "MC"	N "EMT" TYPE ( LIMITED FIRE A
			DS	CEILING MOUNTED DAYLIGHT SENSOR				355 2 ANI 355 1 MIR	D CLASS 3 MIR RING.	ING MAY NOT
			HUB	LIGHTING CONTROL SYSTEM HUB FOR TIME CLOCK CONTROL						
			os) ab,c	CORNER MOUNTED OCCUPANCY SENSOR						
			vsj.	CORNER MOUNTED VACANCY SENSOR						
			RC	ROOM CONTROLLER / LOAD CONTROLLER 0-10V DIMMING	FOR ZONES WITH 0-10V DIMMABL	.E				
			ALCR	UL-924 LISTED AUTOMATIC LOAD CONTROL RELAY	PROVIDE (1) FOR EACH EM ZONE BYPASS CONTROLS	го				
RNISHED "INDICAT SOCIATE REMAY C IGLE ARF RED TO A RCUIT BR	L CONTRACTOR BY OTHERS TES CIRCUIT WIRED TO ED RECEPTACLE IN OR FURNITURE SYSTEM. ROM CIRCUIT TO BE A SINGLE POLE 20A EAKER WITH 2#12+G HERWISE NOTED.	- F C F L I F F C S S S S S S S S S S S S S S S S S	LIGHTING C CONTRACT REQUIRED LIGHTING C DRAWINGS FIXTURES I AUTOMATIC NO LOWER BINGLE LIGI CONTROLL	N DWG E-020 FOR ADDITIONAL INFORMATION. ONTROLS SHALL COMPLY WITH NYCECC 2020. CKS AND LOAD CONTROLLERS ARE NOT SHOP OR SHALL PROVIDE POWER PACKS OR LOAD TO MEET CONTROL INTENT. COORDINATE BILL ONTROL SYSTEM VENDOR PRIOR TO BID AND FOR APPROVAL PRIOR TO INSTALLATION. DENOTED WITH SUBSCRIPT "EM" SHALL BE WIREL CLOAD CONTROL RELAYS UNLESS OTHERWISE CASE SUBSCRIPTS ARE PROVIDED FOR ROOM HTING CONTROL ZONES. EXTEND WIRING FROM .ER TO ALL LIGHTS WITHIN THE ROOM OR AREA ED DEVICES TO BE PROVIDED WITH ONE CONTIL	NN ON LIGHTING PLANS. CONTROLLERS AS OF MATERIALS WITH SUBMIT SHOP O VIA UL-924 LISTED NOTED. IS OR AREAS WITH POWER PACK OR LOAD					
				DRAWING	G-ISSUE LIST					
	7		Latest			122.08.31 100% BMISSION	2023.02.15 RESPONSE TO MESCHESTER COMMENTS	023.08.04 RESPONSE O MESCHESTER OUNTY COMMENTS	023.11.01 RESPONSE O MESCHESTER OUNTY COMMENTS	
SIZES	5	Sheet # E-010	DOB Rev. # .00	Sheet Title SYMBOLS, ABBREVIATIONS, SCHEDULES AN		20 SUE		9 H V		<u> </u>
		E-010 E-020 E-030	.00 .00	DETAILS PANEL SCHEDULE AND RISER DIAGRAM		× × ×	× × ×	X X X	× ×	+
	3- POLE	E-098 E-099	.00	ELECTRICAL PLAN - BOILER ROOM ELECTRICAL PLAN - CHILLER PLANT		× × ×	× × ×		× × ×	+
-3/4"C	4 # 12 +#12 G-3/4"C	E-102 E-103	.00	ELECTRICAL PLAN - CHILLER PLANT ELECTRICAL PLAN - 1ST FLOOR CENTRAL WING ELECTRICAL PLAN - 1ST FLOOR NORTH WING		× ×	× ×	× ×	× × ×	+
-3/4"C	4 # 12 +#12 G-3/4"C	E-104 E-105	.00	ELECTRICAL PLAN - 151 FLOOR NORTH WING ELECTRICAL PLAN - 2ND FLOOR CENTRAL WING ELECTRICAL PLAN - 2ND FLOOR NORTH WING		X X	× ×	× ×	× × ×	+
-3/4"C	4 # 10 +# 10 G-3/4"C	E-106 E-130	.00	ELECTRICAL PLAN - 2ND FLOOR NORTH AN ELECTRICAL PART PLAN - ROOF ELECTRICAL PLAN - BASEMENT LEVEL 3 CE			× × ×	× ×	× × ×	<u>+  </u>
"C		E-133 E-135	.00	ELECTRICAL PLAN - COURT HOUSE JUDGE'S ELECTRICAL PLAN - COURT HOUSE ROOF -	ELEVATOR - 111 MLK BLVD	× ×	× × ×	× ×	× × ×	
	4 # 8+#10 G-1"C	E-135 E-137 E-138	.00	ELECTRICAL PLAN - 143 GRAND STREET B	ASEMENT	×	× × ×	×	× × ×	
"C	4 # 8+#10 G-1"C	E-202	.00	ELECTRICAL PLAN - 143 GRAND STREET 3 ELECTRICAL LIGHTING PLAN - 1ST FLOOR C	ENTRAL WING	× ×	×	X X	×	
"C	4 # 6+#10 G-1"C	E-203 E-204	.00 .00	ELECTRICAL LIGHTING PLAN - 1ST FLOOR N ELECTRICAL LIGHTING PLAN - 2ND FLOOR (	CENTRAL WING	×	× ×	X X	× × ×	
		E-205	.00	ELECTRICAL LIGHTING PLAN - 2ND FLOOR	NORTH WING	×	×	×	×	
O PANEL	BOARD, FOR LONGER	I								


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ERAL NOTES	DEMOLITION NOTES
D/OR DOCUMENTATION FOR POWER, LOW 5, AND CABLE TRAY REQUIREMENTS AS	1. ALL WIRING, CIRCUITRY, BACK BOXES, AND CONDUIT WITHIN SCOPE OF WORK AREA THAT EXCLUSIVELY SERVES PROJECT SCOPE IS TO BE DEMOLISHED. WIRING IS TO BE REMOVED BACK TO RESPECTIVE CIRCUIT BREAKERS. NO WIRING (POWER, LOW VOLTAGE, ETC.) SHALL BE ABANDONED.
OCATIONS OF THERMOSTATS, TEMPERATURE C. PROVIDE I "EC FROM EACH DEVICE TO	2. PROVIDE TEMPORARY LIGHTING IN SCOPE OF WORK AREA. PROVIDE NEW BRANCH CIRCUITS FROM EXISTING PANELBOARDS AS REQUIRED TO MAINTAIN CONTINUITY OF LIGHTING.
D BEING MAINTAINED. PERFORM PREVENTATIVE DLLOWS: NT	3. TAG AND TRACE ALL EXISTING CIRCUITS WHICH SERVE ADJACENT OCCUPIED SPACES. LABEL ALL CIRCUITS AND MAINTAIN CONTINUITY AS REQUIRED.
3REAKERS S	4. CONTRACTOR SHALL FIELD SURVEY AND BE FAMILIARIZED WITH EXISTING CONDITIONS PRIOR TO BID SUBMISSION.
CABLE SCHEDULE	5. REFER TO ARCHITECTURAL, MECHANICAL, AND PLUMBING DEMOLITION DRAWINGS FOR OTHER DEMOLITION REQUIREMENTS AND COORDINATE WITH TRADES ACCORDINGLY.
AND THWN TYPE OR THWN-2 IN MET/DAMP	6. REMOVE ALL TEMPORARY FEEDERS AND ELECTRICAL DEVICES USED FOR LIGHTING, HEATING, SECURING SPACE ETC.
FIRE ALARM WIRING, ALL WIRING IN EXPOSED YPE CONDUIT RACEWAY.	7. PROVIDE TEMPORARY POWER, AS REQUIRED FOR ALL "EXISTING TO REMAIN" CIRCUITS DURING THE COURSE OF DEMOLITION. RESTORE PERMANENT POWER UPON COMPLETION OF DEMOLITION PHASE.
TRE ALARM WIRING, ALL WIRING IN ALL OTHER BLING. NOT BE RUN IN SAME RACEWAY AS POWER OR	8. EXISTING FIRE ALARM SYSTEM TO REMAIN IN OPERATION THROUGH-OUT DEMOLITION AND CONSTRUCTION. DO NOT REMOVE ANY EXISTING FIRE ALARM DEVICES UNTIL NEW FIRE ALARM DEVICES ARE INSTALLED AND FULLY OPERATIONAL.
	9. ALL TELEPHONE CABLES AND STRIP CABINETS TO BE REMOVED FROM THE SITE BY THE ELECTRICAL CONTRACTOR.
	10. DISCONNECT AND REMOVE ALL EXISTING FLOOR ELECTRIC AND TELEPHONE OUTLETS AND CAP WITH PLATE. MAINTAIN CONTINUITY AND PROTECT ALL CONDUIT AND CABLING FEEDING ANY ACTIVE FLOOR DEVICES ON THE FLOOR ABOVE VIA POKE-THRUS, FLOOR BOXES OR CONDUIT STUBS.
	1 1. ALL LIFE SAFETY WIRING AND PANELS, INCLUDING SPEAKERS, ALARMS AND EMERGENCY LIGHTS, ARE TO REMAIN AS INSTALLED AND OPERATING. PROVIDE TEMPORARY SUPPORTS AS REQUIRED.

12	2. ALL WIRING, CIRCUITING, BACK BOXES, AND CONDUIT WITHIN SCOPE OF WORK AREA
	SERVING OTHER TENANT SPACES, BUILDING COMMON AREAS, OR OTHER PLACES
	ARE TO BE MAINTAINED. CUT BACK AND EXTEND THESE CIRCUITS AS REQUIRED TO
	MAINTAIN POWER CONTINUITY AS REQUIRED TO SUIT NEW SPACE LAYOUT AND
	CEILING HEIGHTS.

	CONSULTANT SEAL		CONSULTANT INFORMATION							
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	AS BUILT - CHANGES AS NOTED AS BUILT - NO CHANGES									
		CONTF	RACTOR			CONTRACTOR				
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OR THE WORK INDICATED ON EET. ALL OTHER MATTERS SHOWN BE CONSIDERED AS EITHER BEING APPLICABLE CODES.	SIGNATURE: TITLE:				SIGNATURE: TITLE:					
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G ENGINEERS DPC 133 WEST 19TH STREET NEW YORK, NY 10011 TEL 212.645.1002	LOW RISE BUILDING RENOVATIONS AND HVAC IN 110 DR. MARTIN LUTHER KING, JR. BOUL WHITE PLAINS, NEW YORK 10601					EVARD	SCALE: AS NOTED DATE: JAN 19, 2024			
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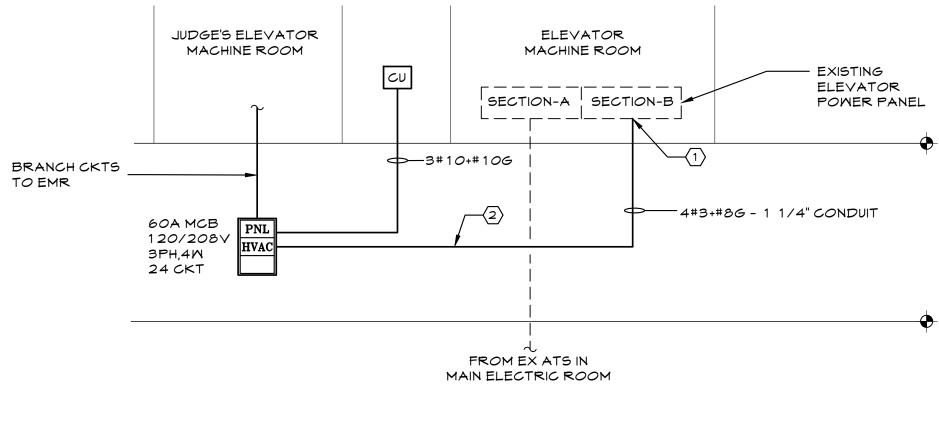
 TYPICAL
 MANUAL
 IN
 DIMMING
 VACANCY
 4-RIIM
 CINTRIL

 Scale: NTS
 Stand Aldre Controller or Networked

10 TYPICAL MANUAL IN DIMMING VACANCY 3-ZINE CLASS RIDM CONTROL scale: NTS stand aldre controller or networked

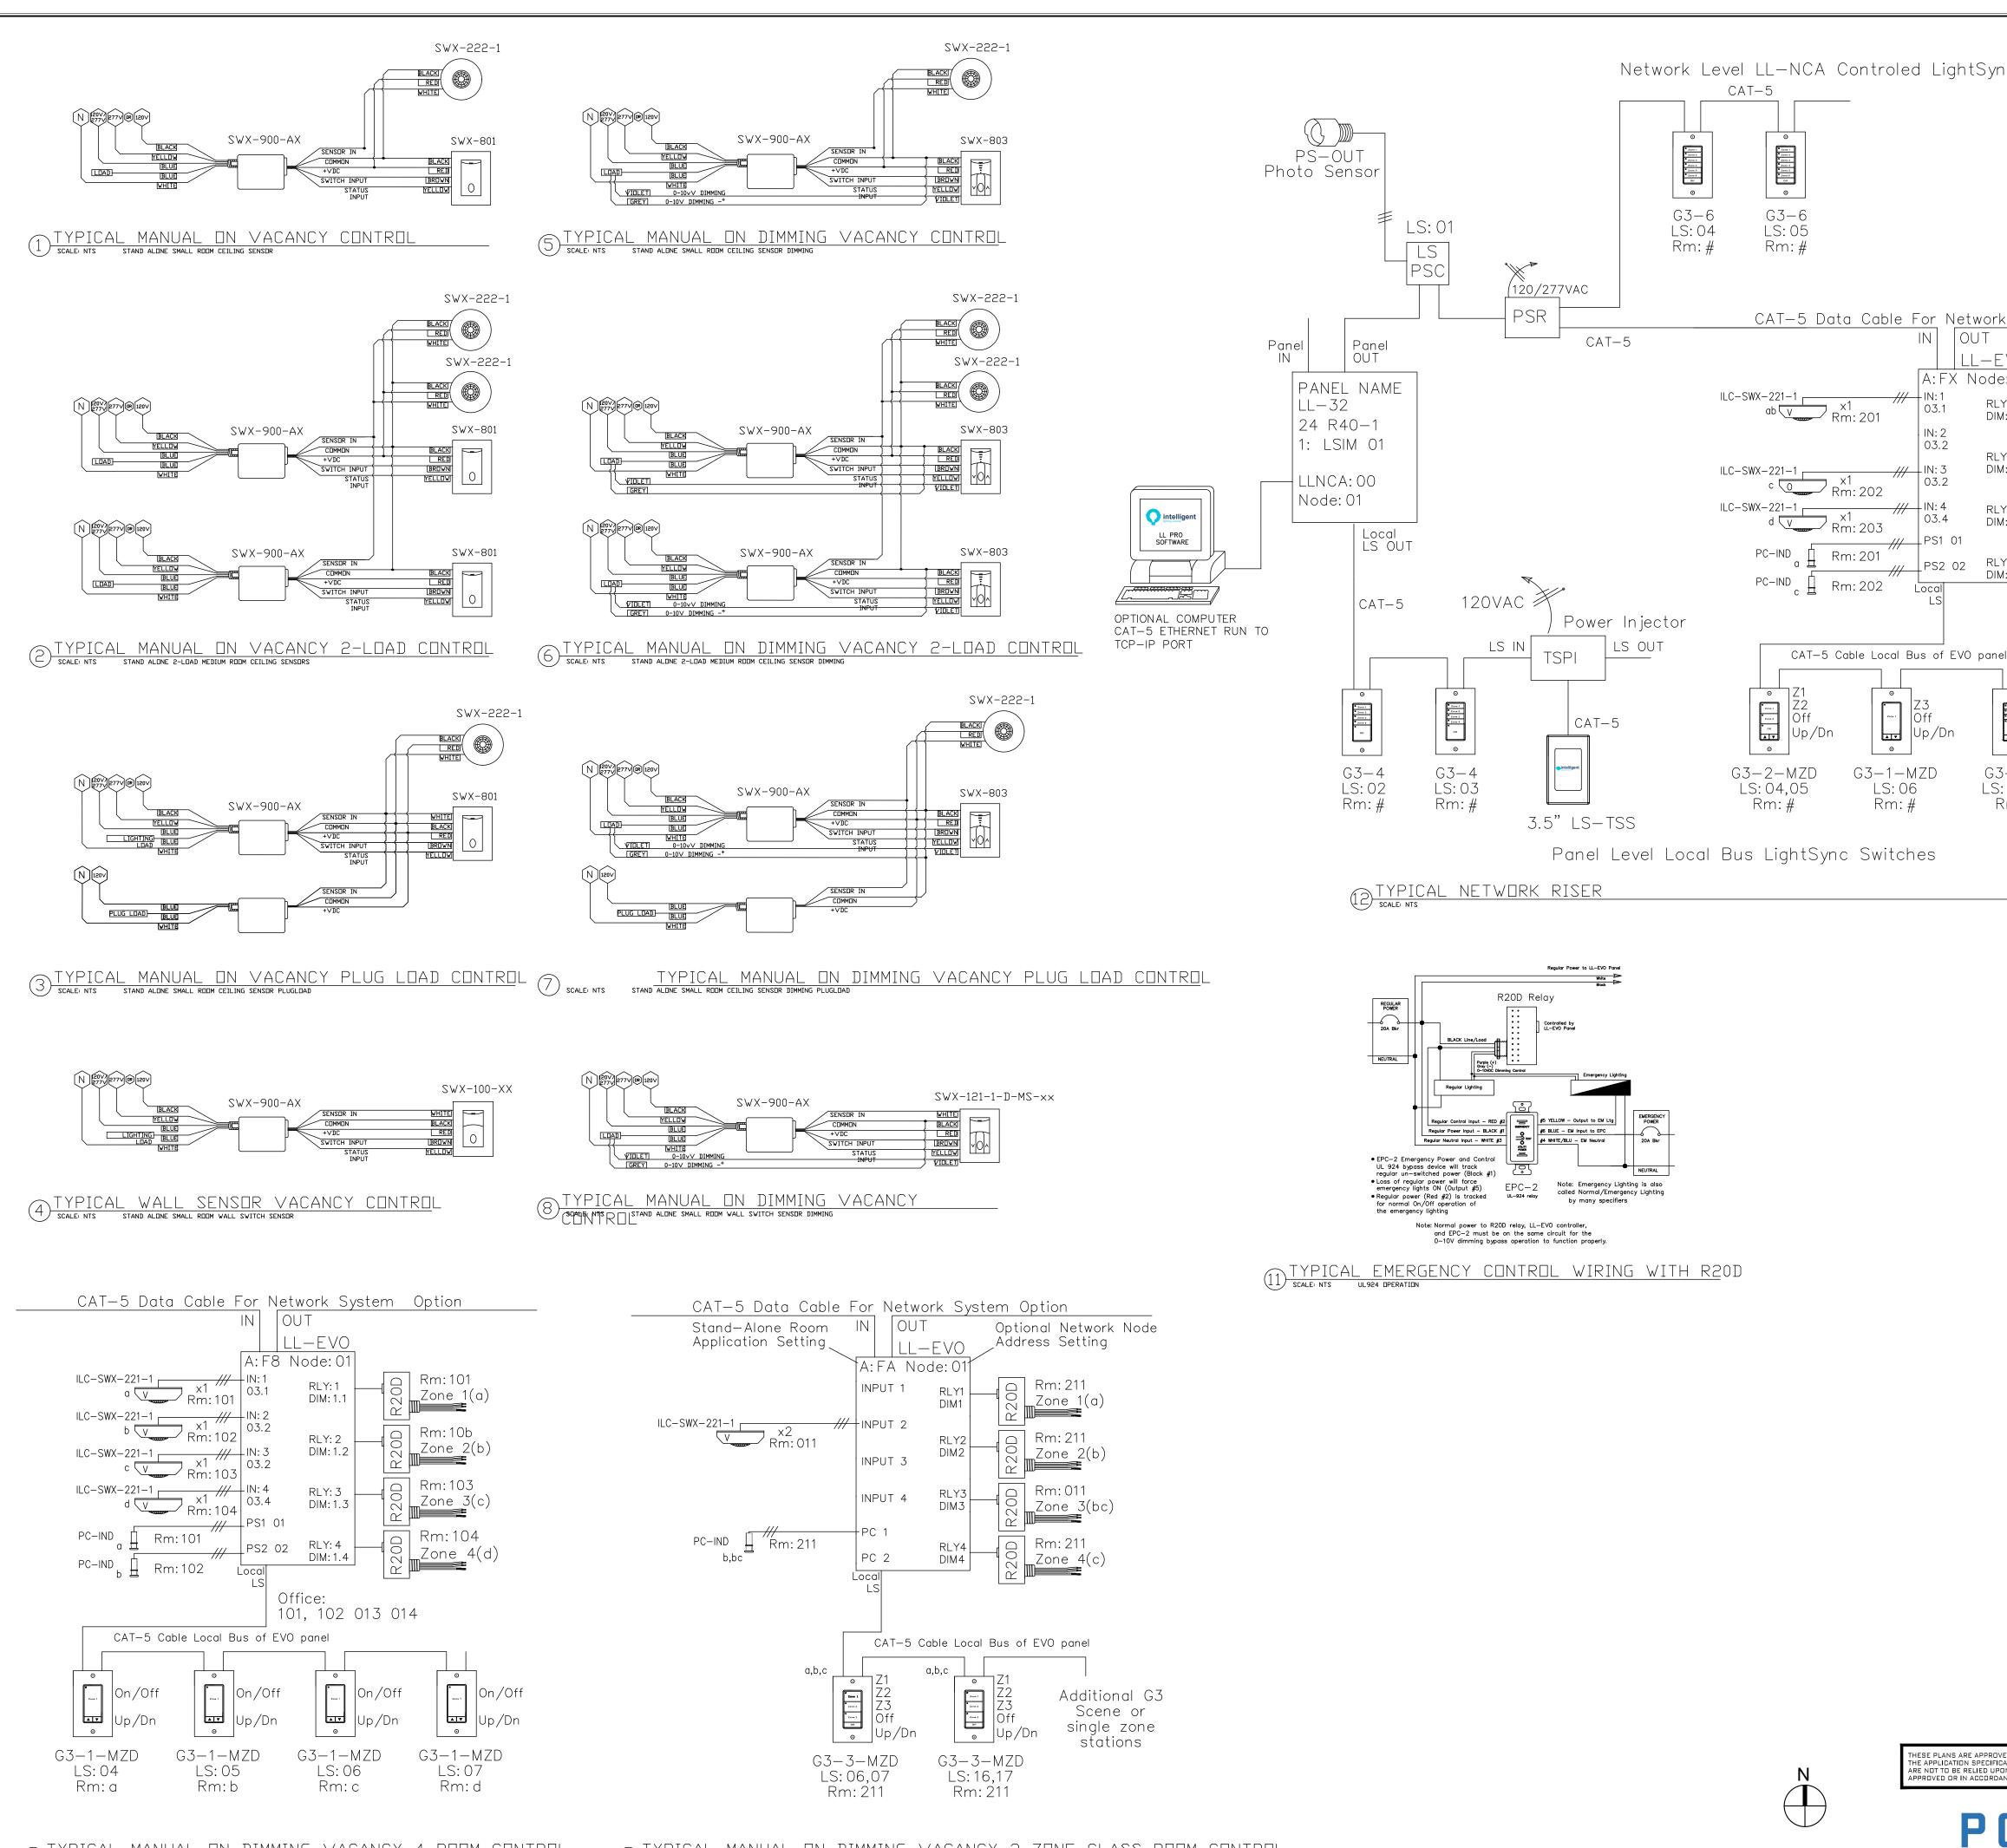htSync Switches	З	/4" TO 1"		MINERAL WOOL (2.5 I	PCF) BATT SAFING
	_			SLEEVE, IF REQUIRED DUCT, PIPE, OR CONE PENETRATIONSTEEL	DUIT
				NON-HARDENING AC (MANVILLE "DUXSEAL NON-HARDENING FIR MASTIC, BOTH SIDES FINISH CEILING	" OR EQUAL) OR ESTOPPING
etwork System Option				EVENT CONTACT WITH PAR NEEN GWB AND DUCT, PIPE,	
$\frac{LL - EVO}{C Node: 02}$	1 E.020 PART		OF ]	FULL HEIGHT	ГGWB
RLY: 2 DIM: 1.2				SCHEDULED PARTITION MINERAL MOOL (2.5 PC INSULATION OR FIRESAT STEEL SLEEVE	F) BATT
RLY: 3 DIM: 1.3 DIM: 1.3					
DIM: 1.4 DIM: 1.4 DIM: 1.4 C C C C C C C C C C C C C	F			<ul> <li>NON-HARDENING ACOU</li> <li>(MANVILLE "DUXSEAL" C</li> <li>NON-HARDENING FIRES</li> <li>MASTIC, BOTH SIDES OF</li> <li>GROUT SOLID AROUND</li> <li>SUPPORT TO PREVENT</li> </ul>	DR EQUAL) OR TOPPING = WALL OUTER SLEEVE
VO panel		SUPPORT DUCT, PIPE		WALL STRUCTURE DUIT TO PREVENT CONTAC ⁻ EEN CMU AND DUCT,PIPE, OR	
SI S2 S3 Off Up/Dn	_	TRATION BRICK P.		FULL HEIGH' TION	Г
G3-3-S LS: 07,08 Rm: #	E.020 NTS				
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		DRECEPTACLE TYPE		HI O HI ED DECORA STYLE SIMILAR	
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POLISE CONSULTING ENGINEERS DPC 133 WEST 19TH STREET NEW YORK, NY 10011 TEL 212.645.1002 WWW.POLISECE.COM	LOW RISE BUILD 110 DR.	DF PUBLIC WORKS A DIVISION OF ENG ING RENOVATIONS AI MARTIN LUTHER KING WHITE PLAINS, NEW Y DETAILS	ND HVAC IN D HVAC IN G, JR. BOUL ORK 10601	IG MPROVEMENTS - PHASE II EVARD	NOMBER         E-020           20-502         E-020           SHEET NO.         104         0F         133           SCALE:         AS NOTED         DATE:         JAN 19, 2024           DPW FILE NO.         52-11-E-1916         REV NO.         0
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FEED	FEEDER: SEE RISER				WIRE	: 4				Mounting: Surf.									
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NUM.	POLE	AMPS	CON.	TYPE	SIZE	A	В	С		NUM.	POLE	AMPS	SIZE	А	В	С		CON.	TYPE
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1). Ll(	GHTIN	IG					0		100		0								
2). RE	CEPT	TACLES	5				$>\sim$	$\sim$	>				ACTUAL CONNECTED LOAD			4304	VA		
a. Fir	st 10,0	000 Wa	itts @ 1	00%			>><	$\langle \rangle$	100		560		TOTAL ESTIMATED DEMAND LOAD			4304	VA		
b. Lo	ad gre	eater th	an 10,0	00 Watt	s @ 50%	$\langle \rangle$	>	$\langle \rangle$	50		0			ACTUA	AL CON	NECTE	DLOAD	11.95	AMP
Rece	ptacle	e total l	oad				560		>		560								
3). M	SCEL	LANEC	US				0		100		0			TOTAL	. ESTIN	IATED [	EMAND LOAD	11.95	AMP
4). HE	EAT						0		100		0								
5). KI	TCHE	N					0		100		0		SPARE BREAKER CAPACITY			PACITY	22.62%	6	
6). MOTORS							>		>>	<									
a. Largest motor load @ 125%						125		0		NOTE:									
b. Additional loads at @ 100%					$\langle$	100	0			ALL LOAD CALCULAT	ION ARE	BASED	ON CUR	RENT NEC VERSION A	ND				
Total	Moto	r load					0		>		0		ASSOCIATED LOCAL AMENDMENTS.						
7). H\	/AC						3744		100		3744		*' NEXT TO CIRCUIT I	NUMBER	INDICA	TES GFC	TYPE CIRCUIT BREA	KER	





 $\begin{array}{c} 1 \\ \hline E.030 \end{array} \begin{array}{c} PARTIAL RISER DIAGRAM \\ 1/8" = 1'-0" \end{array}$ 

- COURT HOUSE ROOF

## KEY NOTES


PROVIDE 60A/3P CIRCUIT BREAKER TO FEED PNL-HVAC. PNL-HVAC WILL SERVE AS A SOURCE FOR ALL EQUIPMENT/DEVICES LOCATED IN COURT HOUSE ROOF ELEVATOR MACHINE ROOM.
 EXACT CONDUIT ROUTE TO BE FIELD VERIFIED BY CONTRACTOR.

- HECHANICAL ROOM






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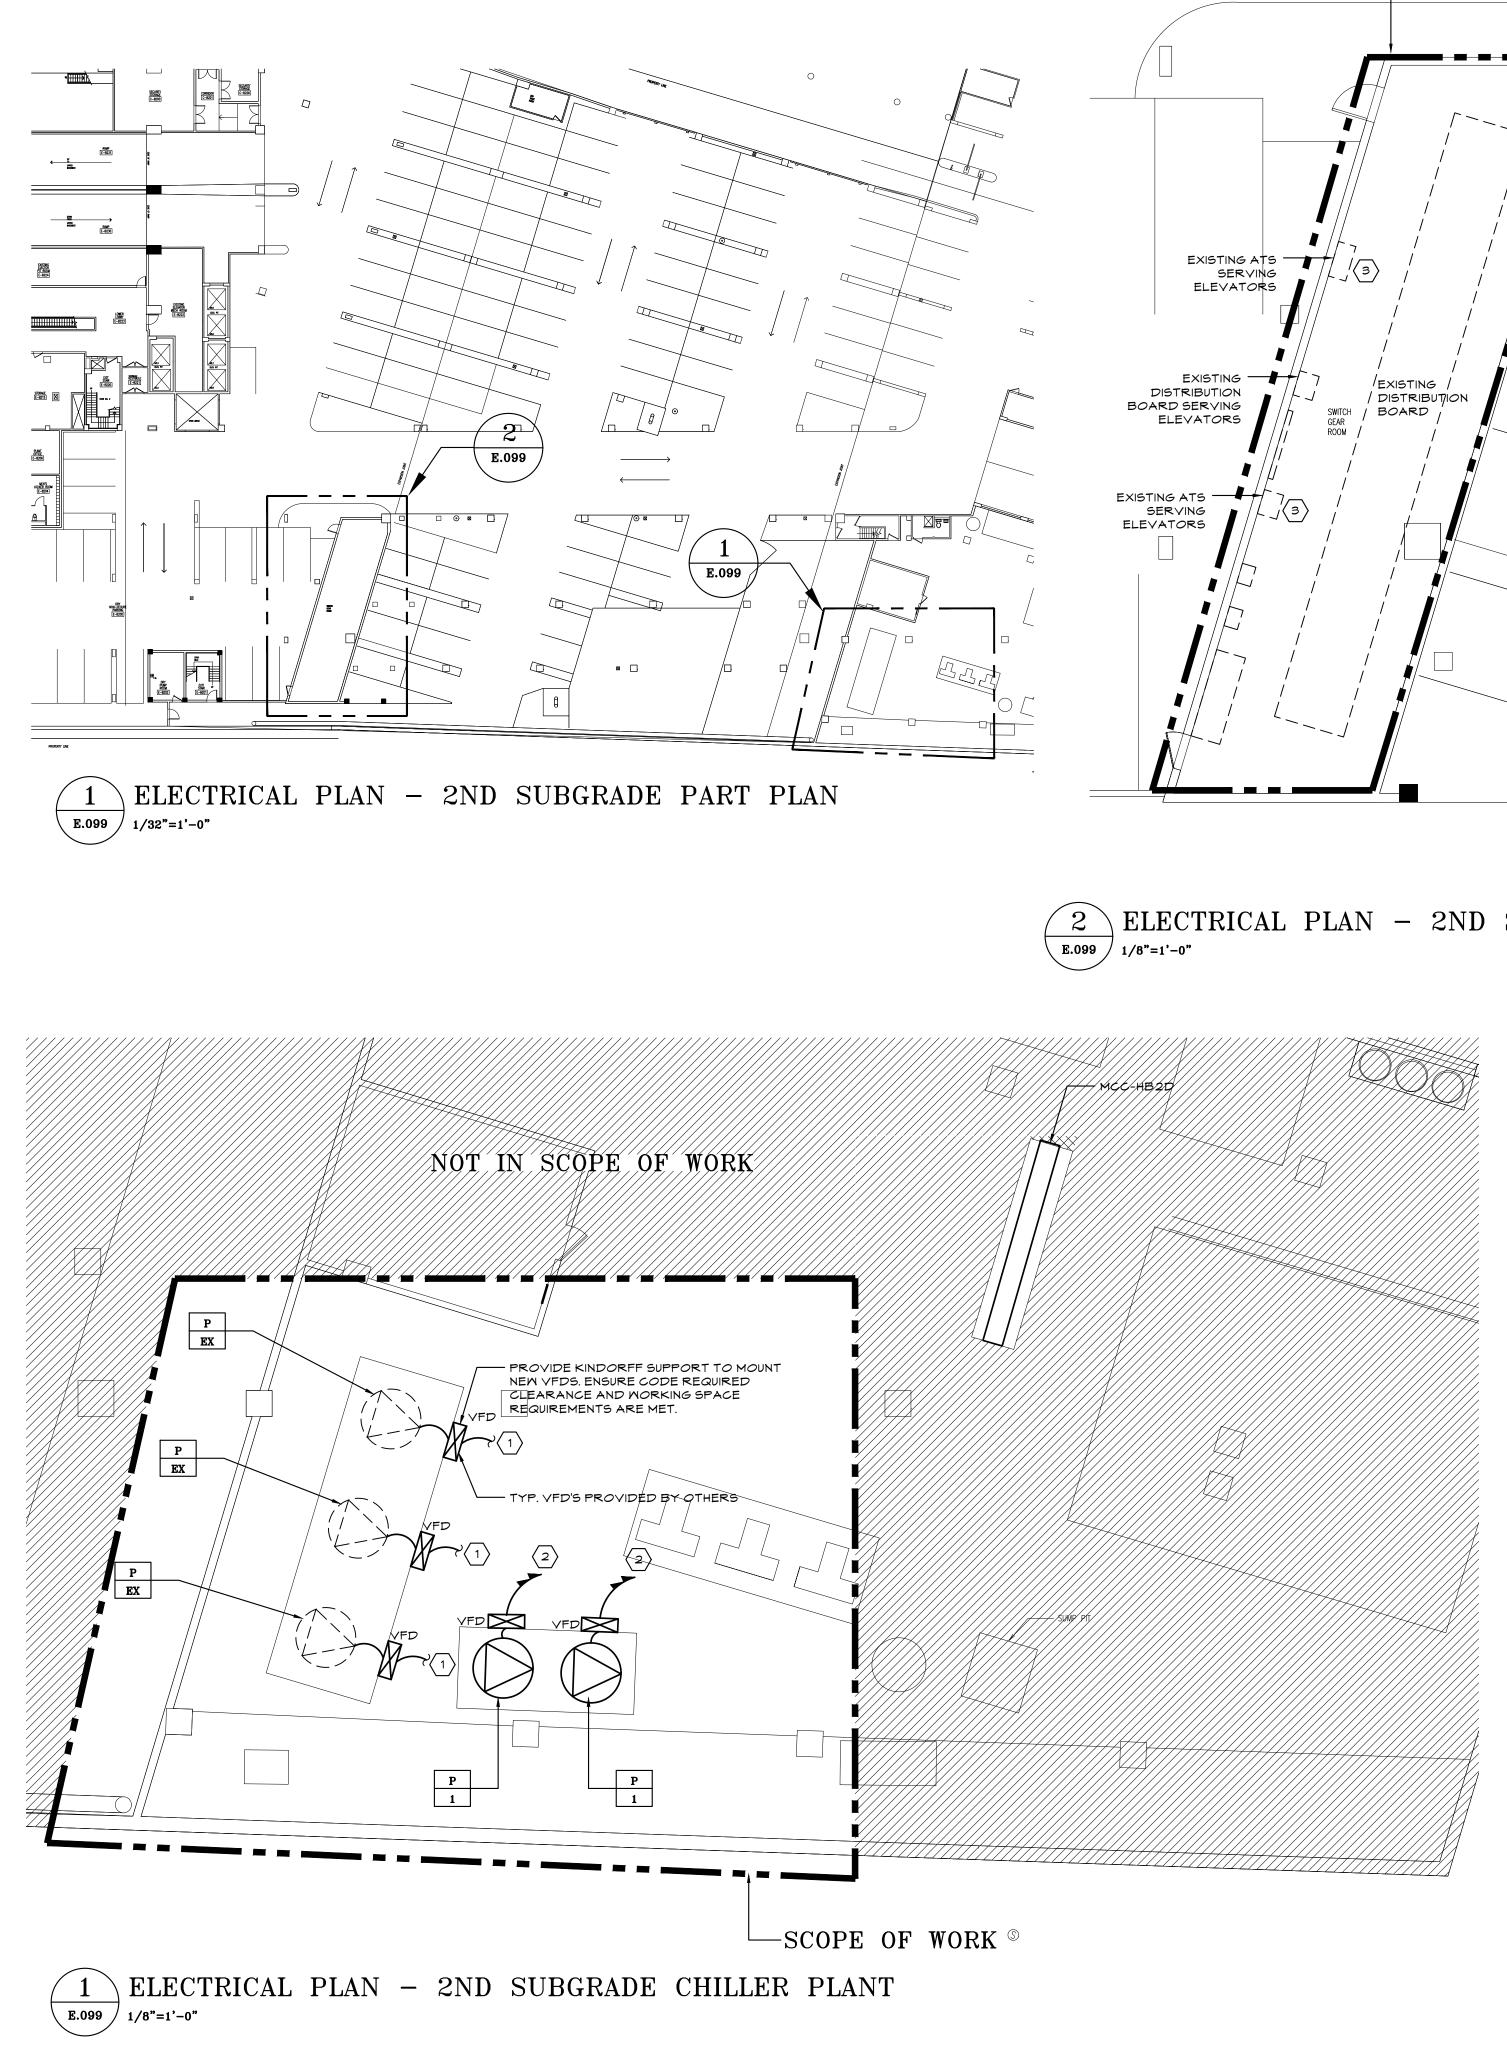


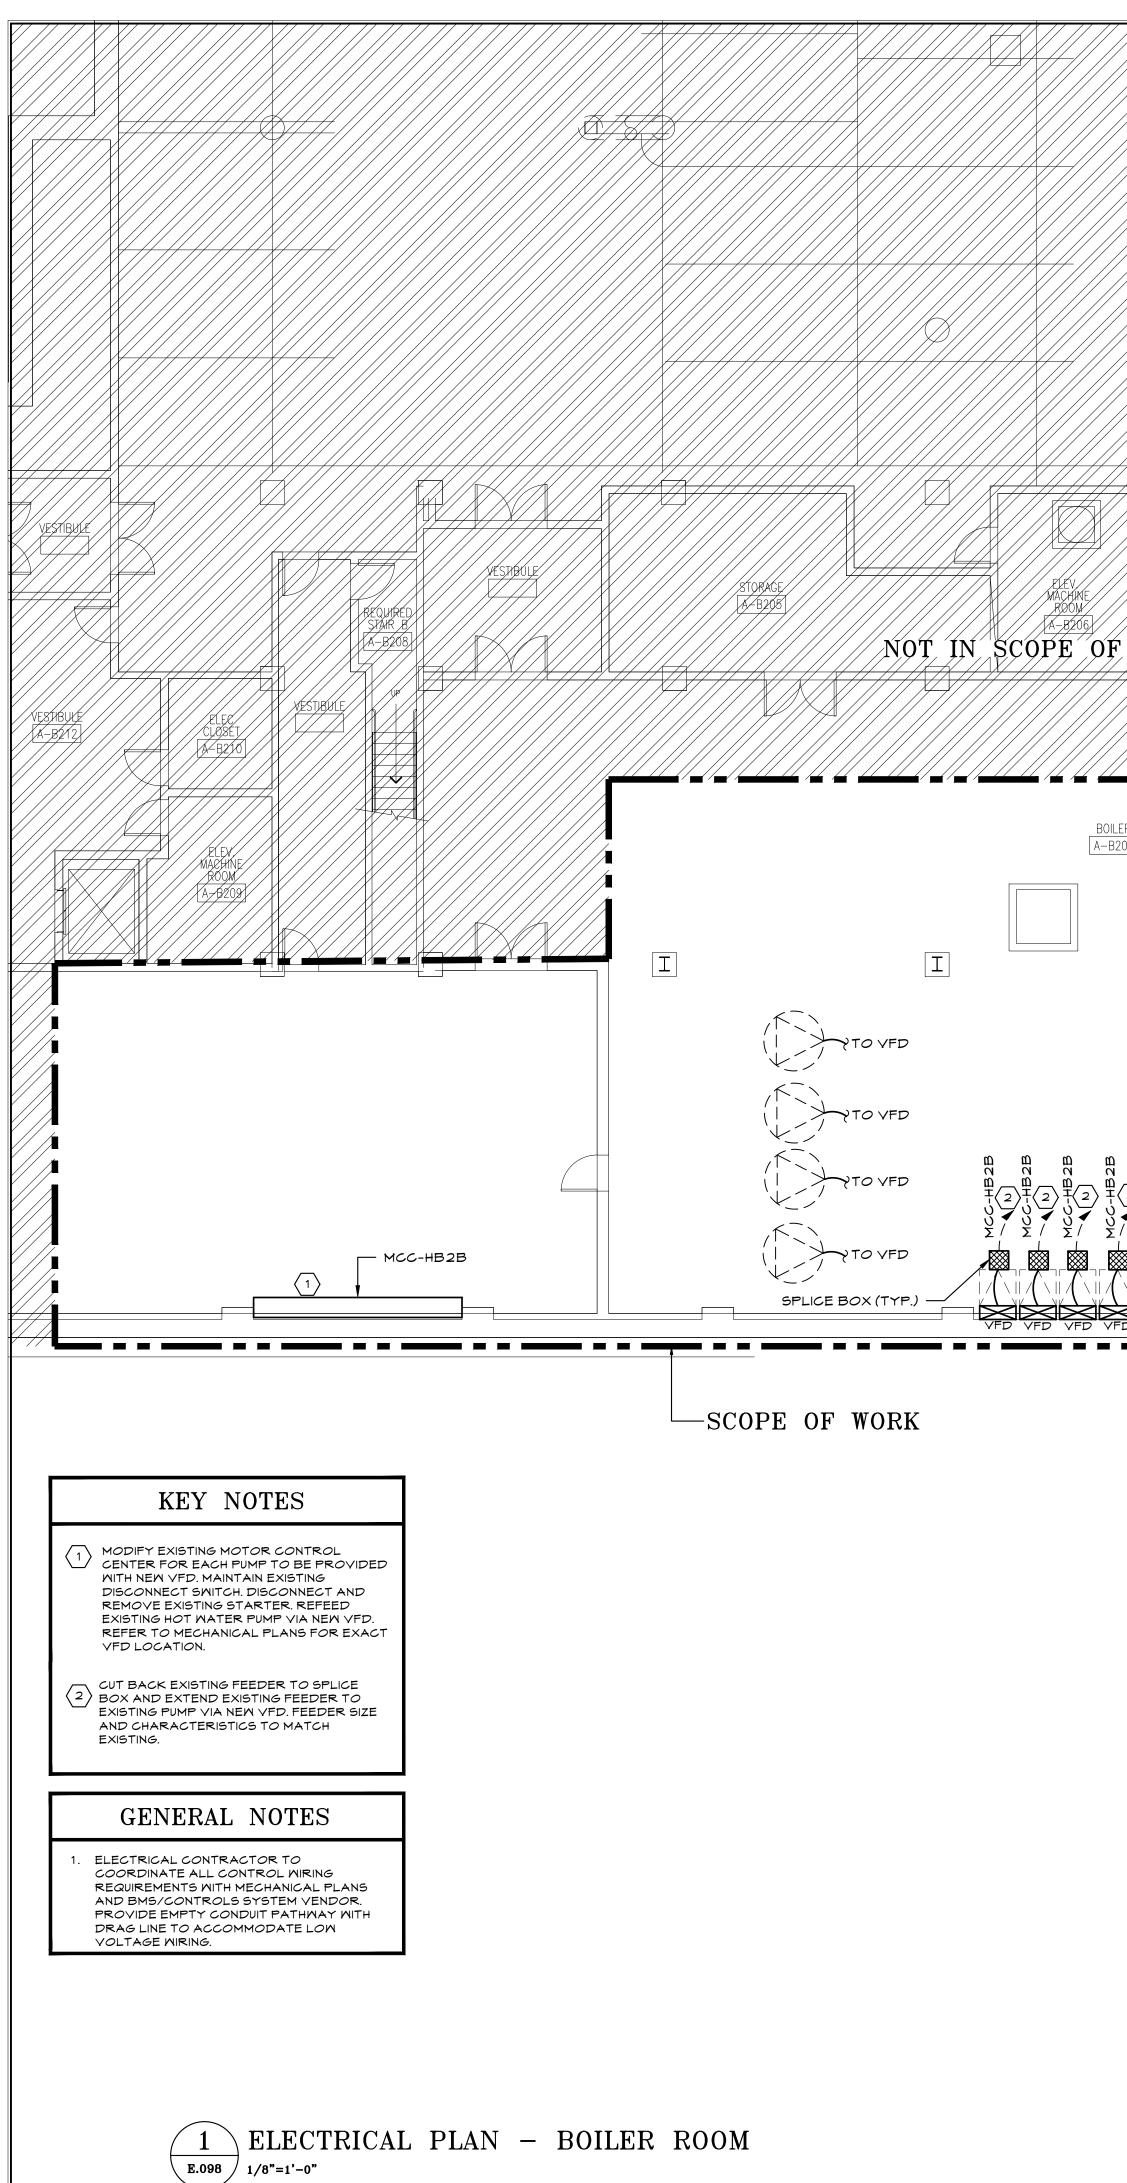
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					K	KEY PLAN - B3	LEVEL
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POLISE	DEPA	ARTMENT (	OF PUBLIC V	COUNTY, NE WORKS AND OF ENGINE	TRANS	SPORTATION	CONTRACT SHEET NUMBER 20-502 E-098 SHEET NO. 106 OF 133
CONSULTING ENGINEERS DPC 133 WEST 19TH STREET NEW YORK, NY 10011 TEL 212.645.1002 WWW.POLISECE.COM	LOW	RISE BUILD 110 DR.	DING RENOVA MARTIN LUT WHITE PLAIN		MPROVEMENTS - PHASE II SCALE: AS NOTED LEVARD DATE: JAN 19, 2024		



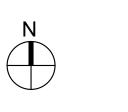

2 ELECTRICAL PLAN - 2ND SUBGRADE SWITCHGEAR ROOM


### KEY NOTES MODIFY EXISTING MOTOR CONTROL CENTER FOR EACH PUMP TO BE PROVIDED WITH NEW VFD. MAINTAIN EXISTING DISCONNECT SWITCH. DISCONNECT AND REMOVE EXISTING STARTER. REFEED EXISTING HOT WATER PUMP VIA NEW VFD. REFER TO MECHANICAL PLANS FOR EXACT VFD LOCATION. 2 UTILIZE EXISTING SPARE BUCKETS IN "MCC-HB2D" TO PROVIDE NEW 100AF/30AT CIRCUIT BREAKERS FOR FEEDERS TO NEW CHILLED WATER PUMPS. EXTEND 3#10+#10G IN 3/4" C FROM MOTOR CONTROL CENTER TO NEW PUMPS VIA NEW VFDS. (3) CONTRACTOR TO IDENTIFY SOURCE OF ELEVATOR DISTRIBUTION PANEL LOCATION IN PENTHOUSE EMR AND TO METER THE FEEDER FOR A PERIOD OF 30 DAYS IN ACCORDANCE WITH NEC TO DETERMINE EXISTING LOAD.

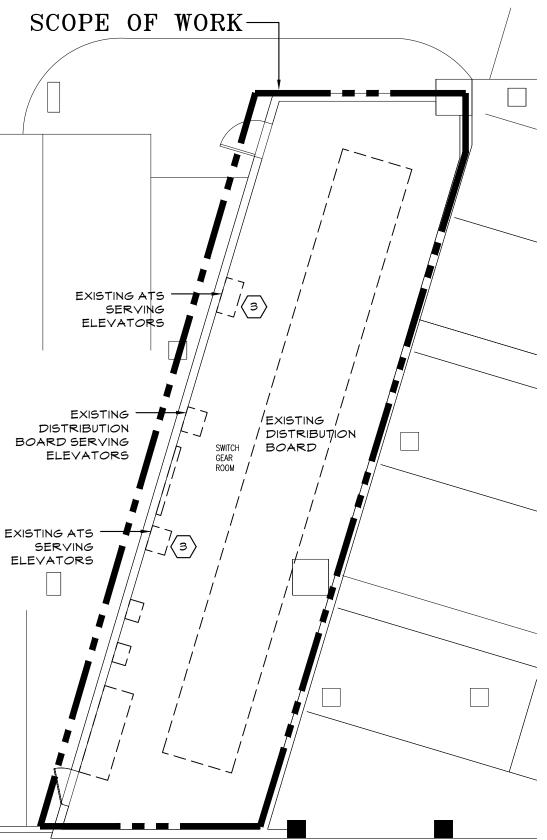



133 WEST

	KEY PLAN - B2 LEVEL NTS.								
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133 WEST 19TH STREET NEW YORK, NY 10011 TEL 212.645.1002 WWW.POLISECE.COM		110 DR. ۱	MARTIN LUT WHITE PLAIN	HER KING, JR. E NS, NEW YORK 1	BOUL 1060 <i>1</i>	EVARD	DATE: JAN 19, 2024		
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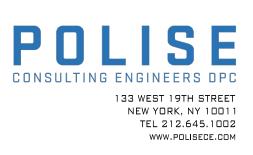
E.103 1/8"=1'-0"

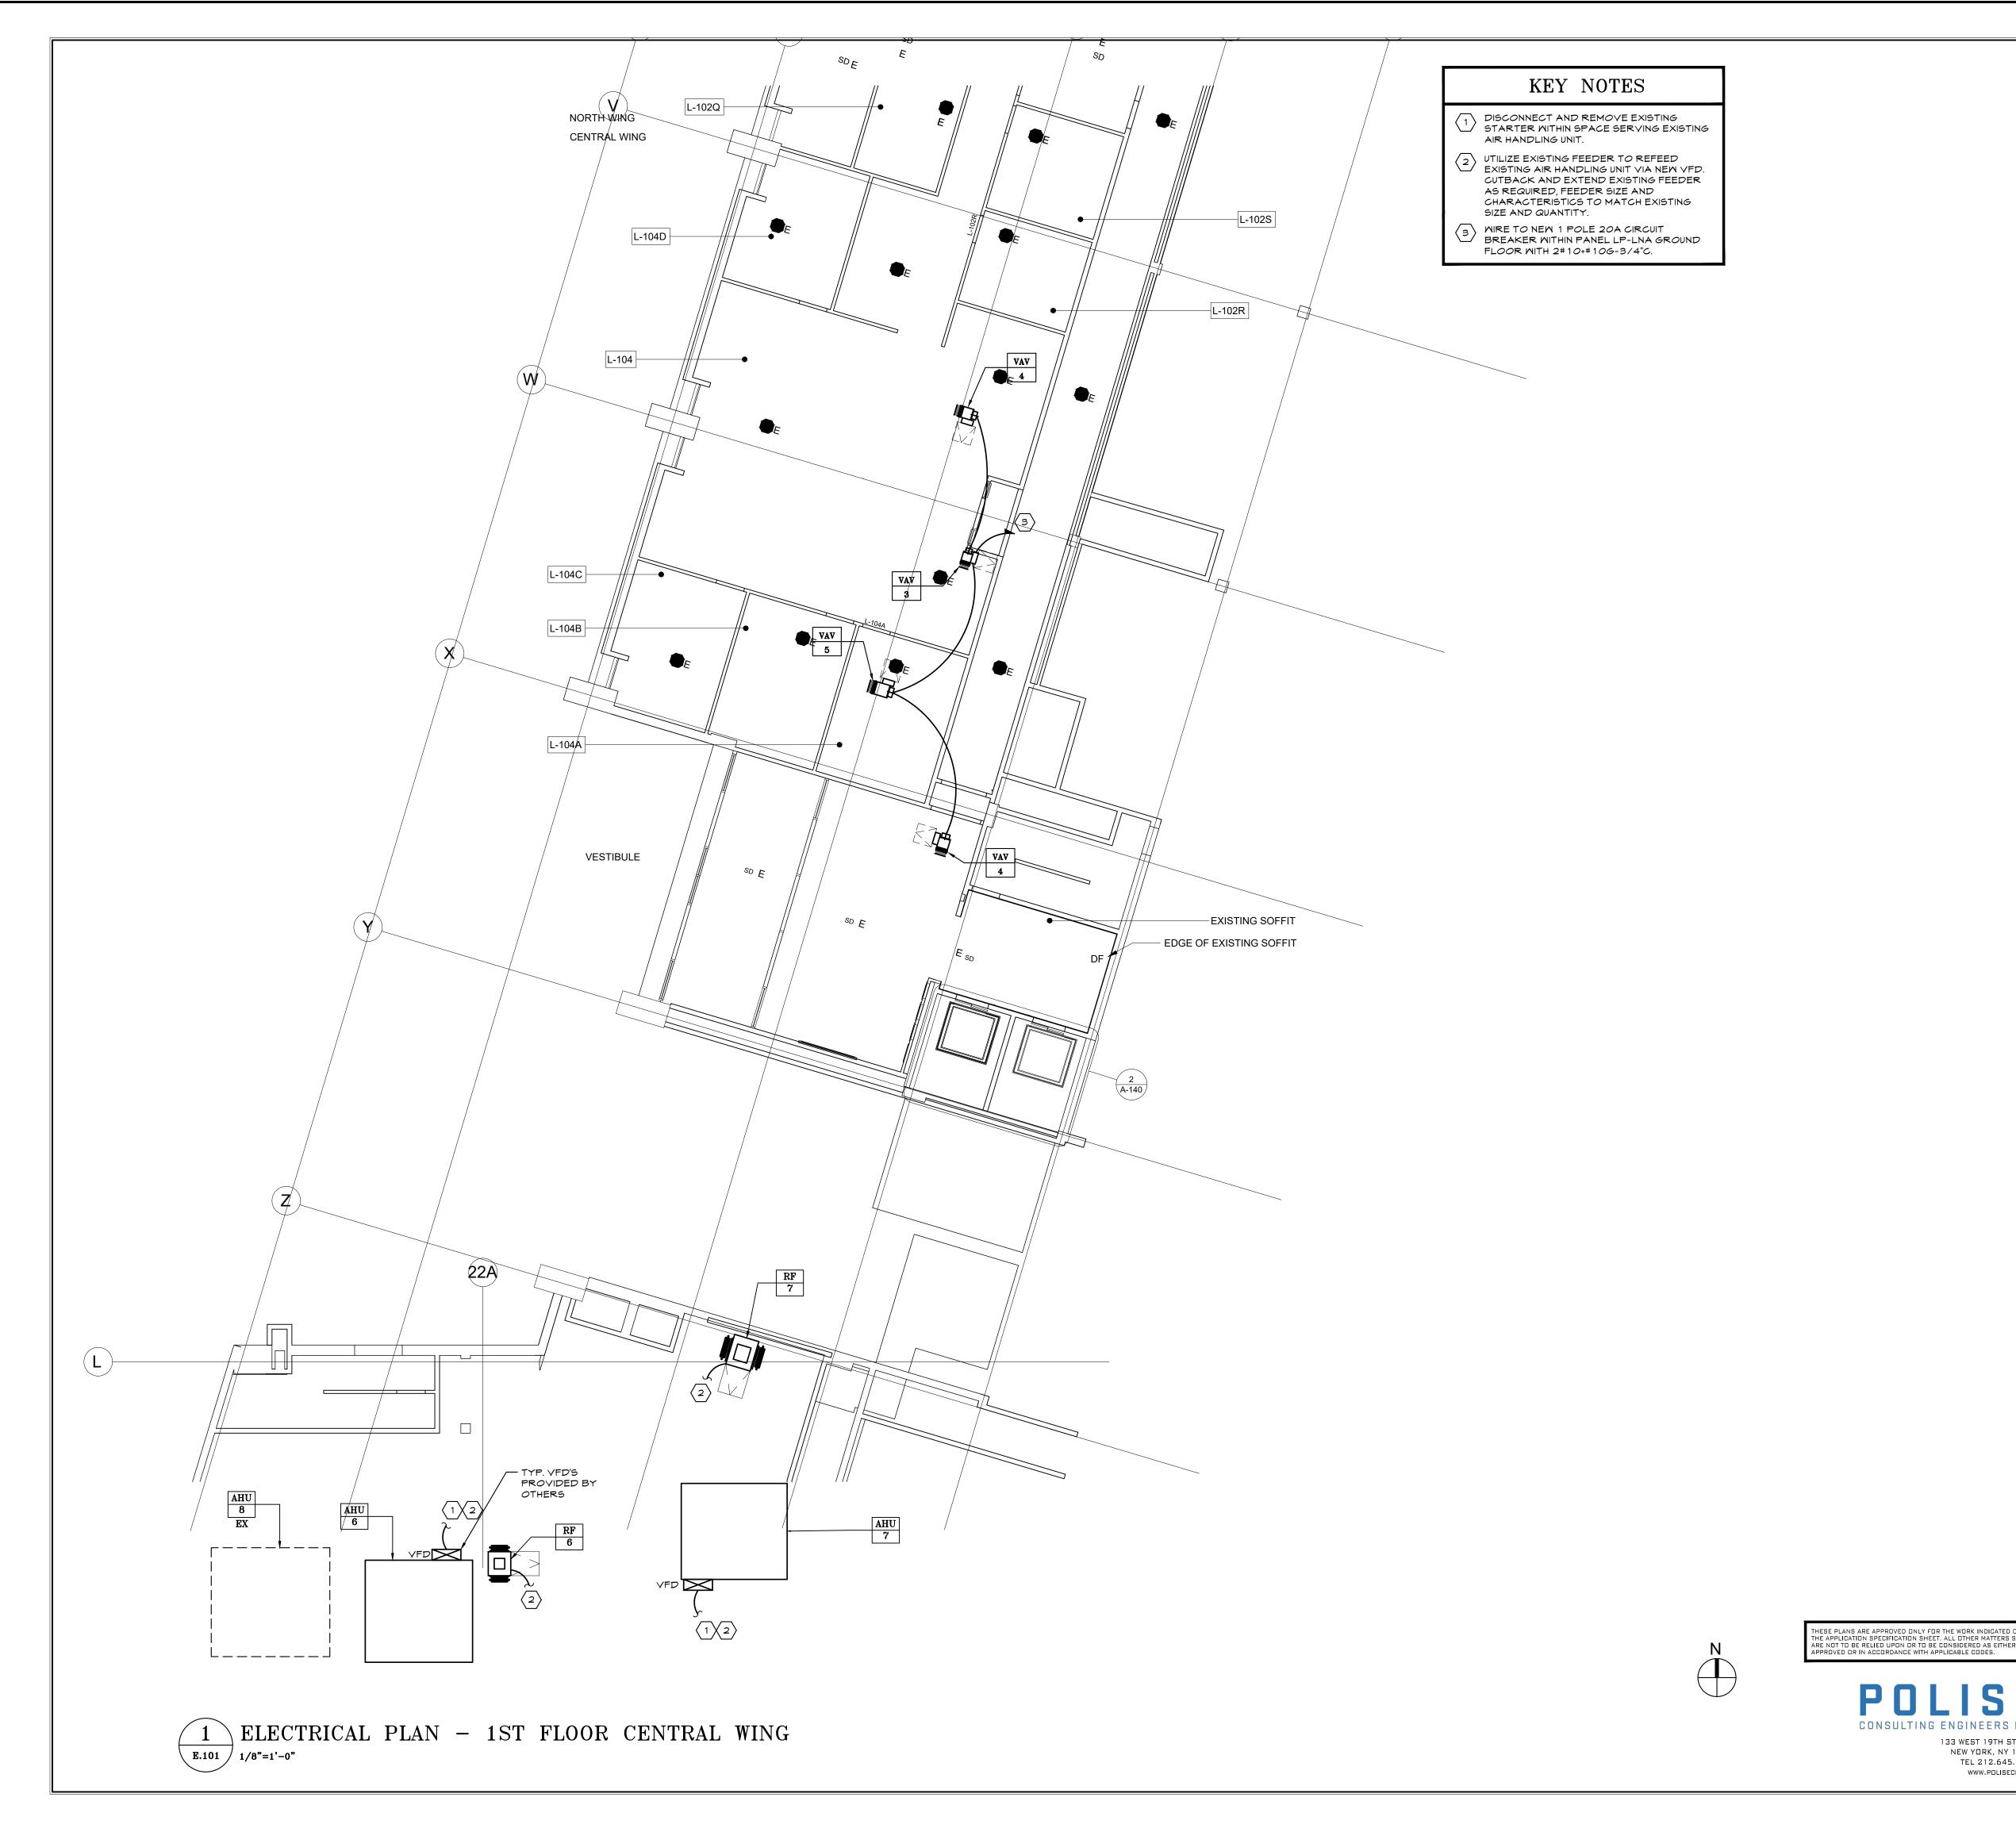
KEY	NOTES
<ul> <li>PANEL LP-LNA GR 2#12+#12G-3/4"C</li> <li>WIRE HAND DRYEF GFCI CIRCUIT WITHI GROUND FLOOR C 2#12+#12G-3/4"C</li> <li>WIRE FAUCETS, FLU RECEPTACLES TO PRESENTLY SERVI 2#12+#12G-3/4"C SUBSCRIPT "U" TO E MOUNTED UNDER S PROVIDE POWER F DISPENSER.</li> <li>WIRE BMS TO NEW WITHIN PANEL LP-L</li> </ul>	2. R TO NEW 1 POLE 20A N PANEL LP-LNB DR WITHIN LN-BL WITH 2. ISHOMETERS, AND
GENERA	L NOTES
EXACT LOCATION OF EQUIPMENT. 2. REFER TO ARCHITEC RECEPTACLE MOUNT	TURAL DRAWINGS FOR RECEPTACLES AND TURAL DRAWINGS FOR TING HEIGHTS. TO BE RECESSED IN WALL

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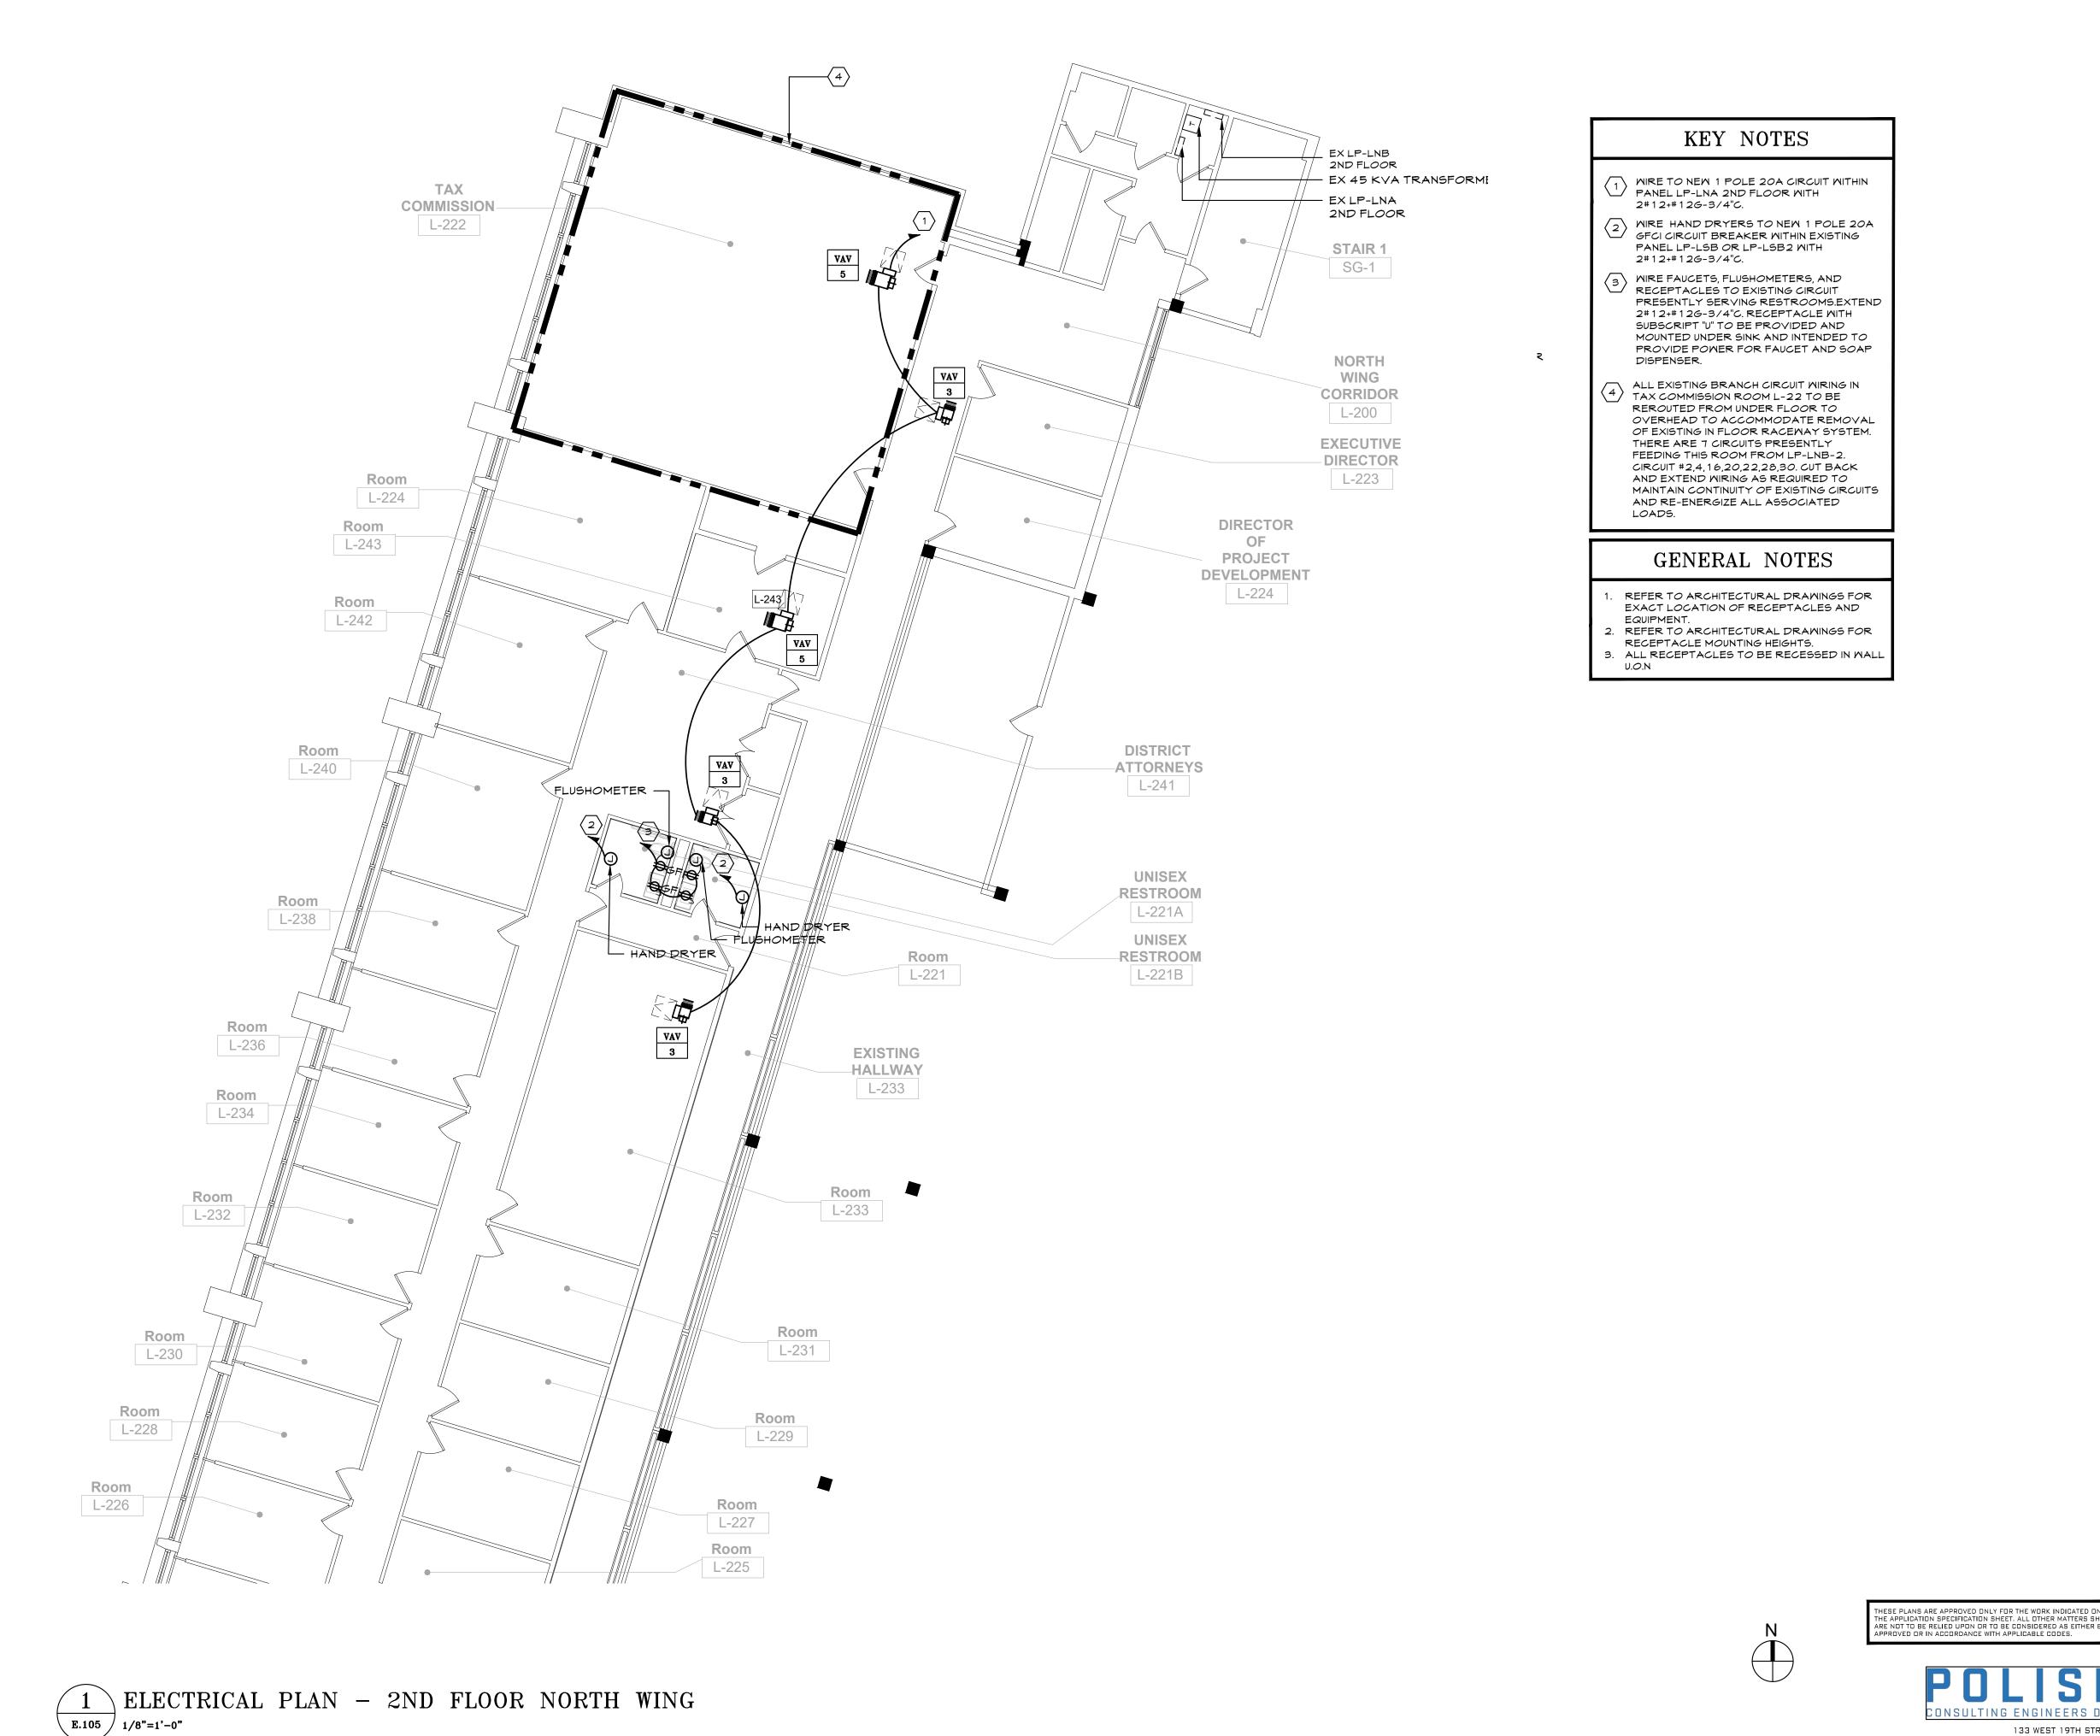
	KEY NOTES
1	WIRE TO NEW 1 POLE 20A CIRCUIT BREAKER WITHIN PANEL LP-LNA 2ND FLOOR WITH 2#10+#10G-3/4"C.
2	MIRE TO NEM 2 POLE 15A CIRCUIT BREAKER MITHIN PANEL LP-LNB 2ND FLOOR MITH 2#12+#12G-3/4"C.
З	WIRE HAND DRYERS TO NEW 1 POLE 20A GFCI CIRCUIT BREAKER WITHIN EXISTING PANEL LP-LSB OR LP-LSB2 WITH 2#12+#12G-3/4"C.
4	WIRE FAUCETS, FLUSHOMETERS AND RECEPTACLES TO EXISTING CIRCUIT PRESENTLY SERVING RESTROOMS.EXTEND 2#12+#12G-3/4"C. RECEPTACLE WITH SUBSCRIPT "U" ARE TO BE PROVIDED AND MOUNTED UNDER SINK AND INTENDED TO PROVIDE POWER FOR FAUCET AND SOAP DISPENSER.
5	WIRE FLUSHOMETERS TO NEW 1 POLE 20A GFCI CIRCUIT BREAKER WITHIN EXISTING PANEL LP-LSB OR LP-LSB2 WITH 2#12+#12G-3/4"C.
	GENERAL NOTES
E: E: 2. R 8. A	EFER TO ARCHITECTURAL DRAWINGS FOR XACT LOCATION OF RECEPTACLES AND QUIPMENT. EFER TO ARCHITECTURAL DRAWINGS FOR ECEPTACLE MOUNTING HEIGHTS. LL RECEPTACLES TO BE RECESSED IN WALL O.N





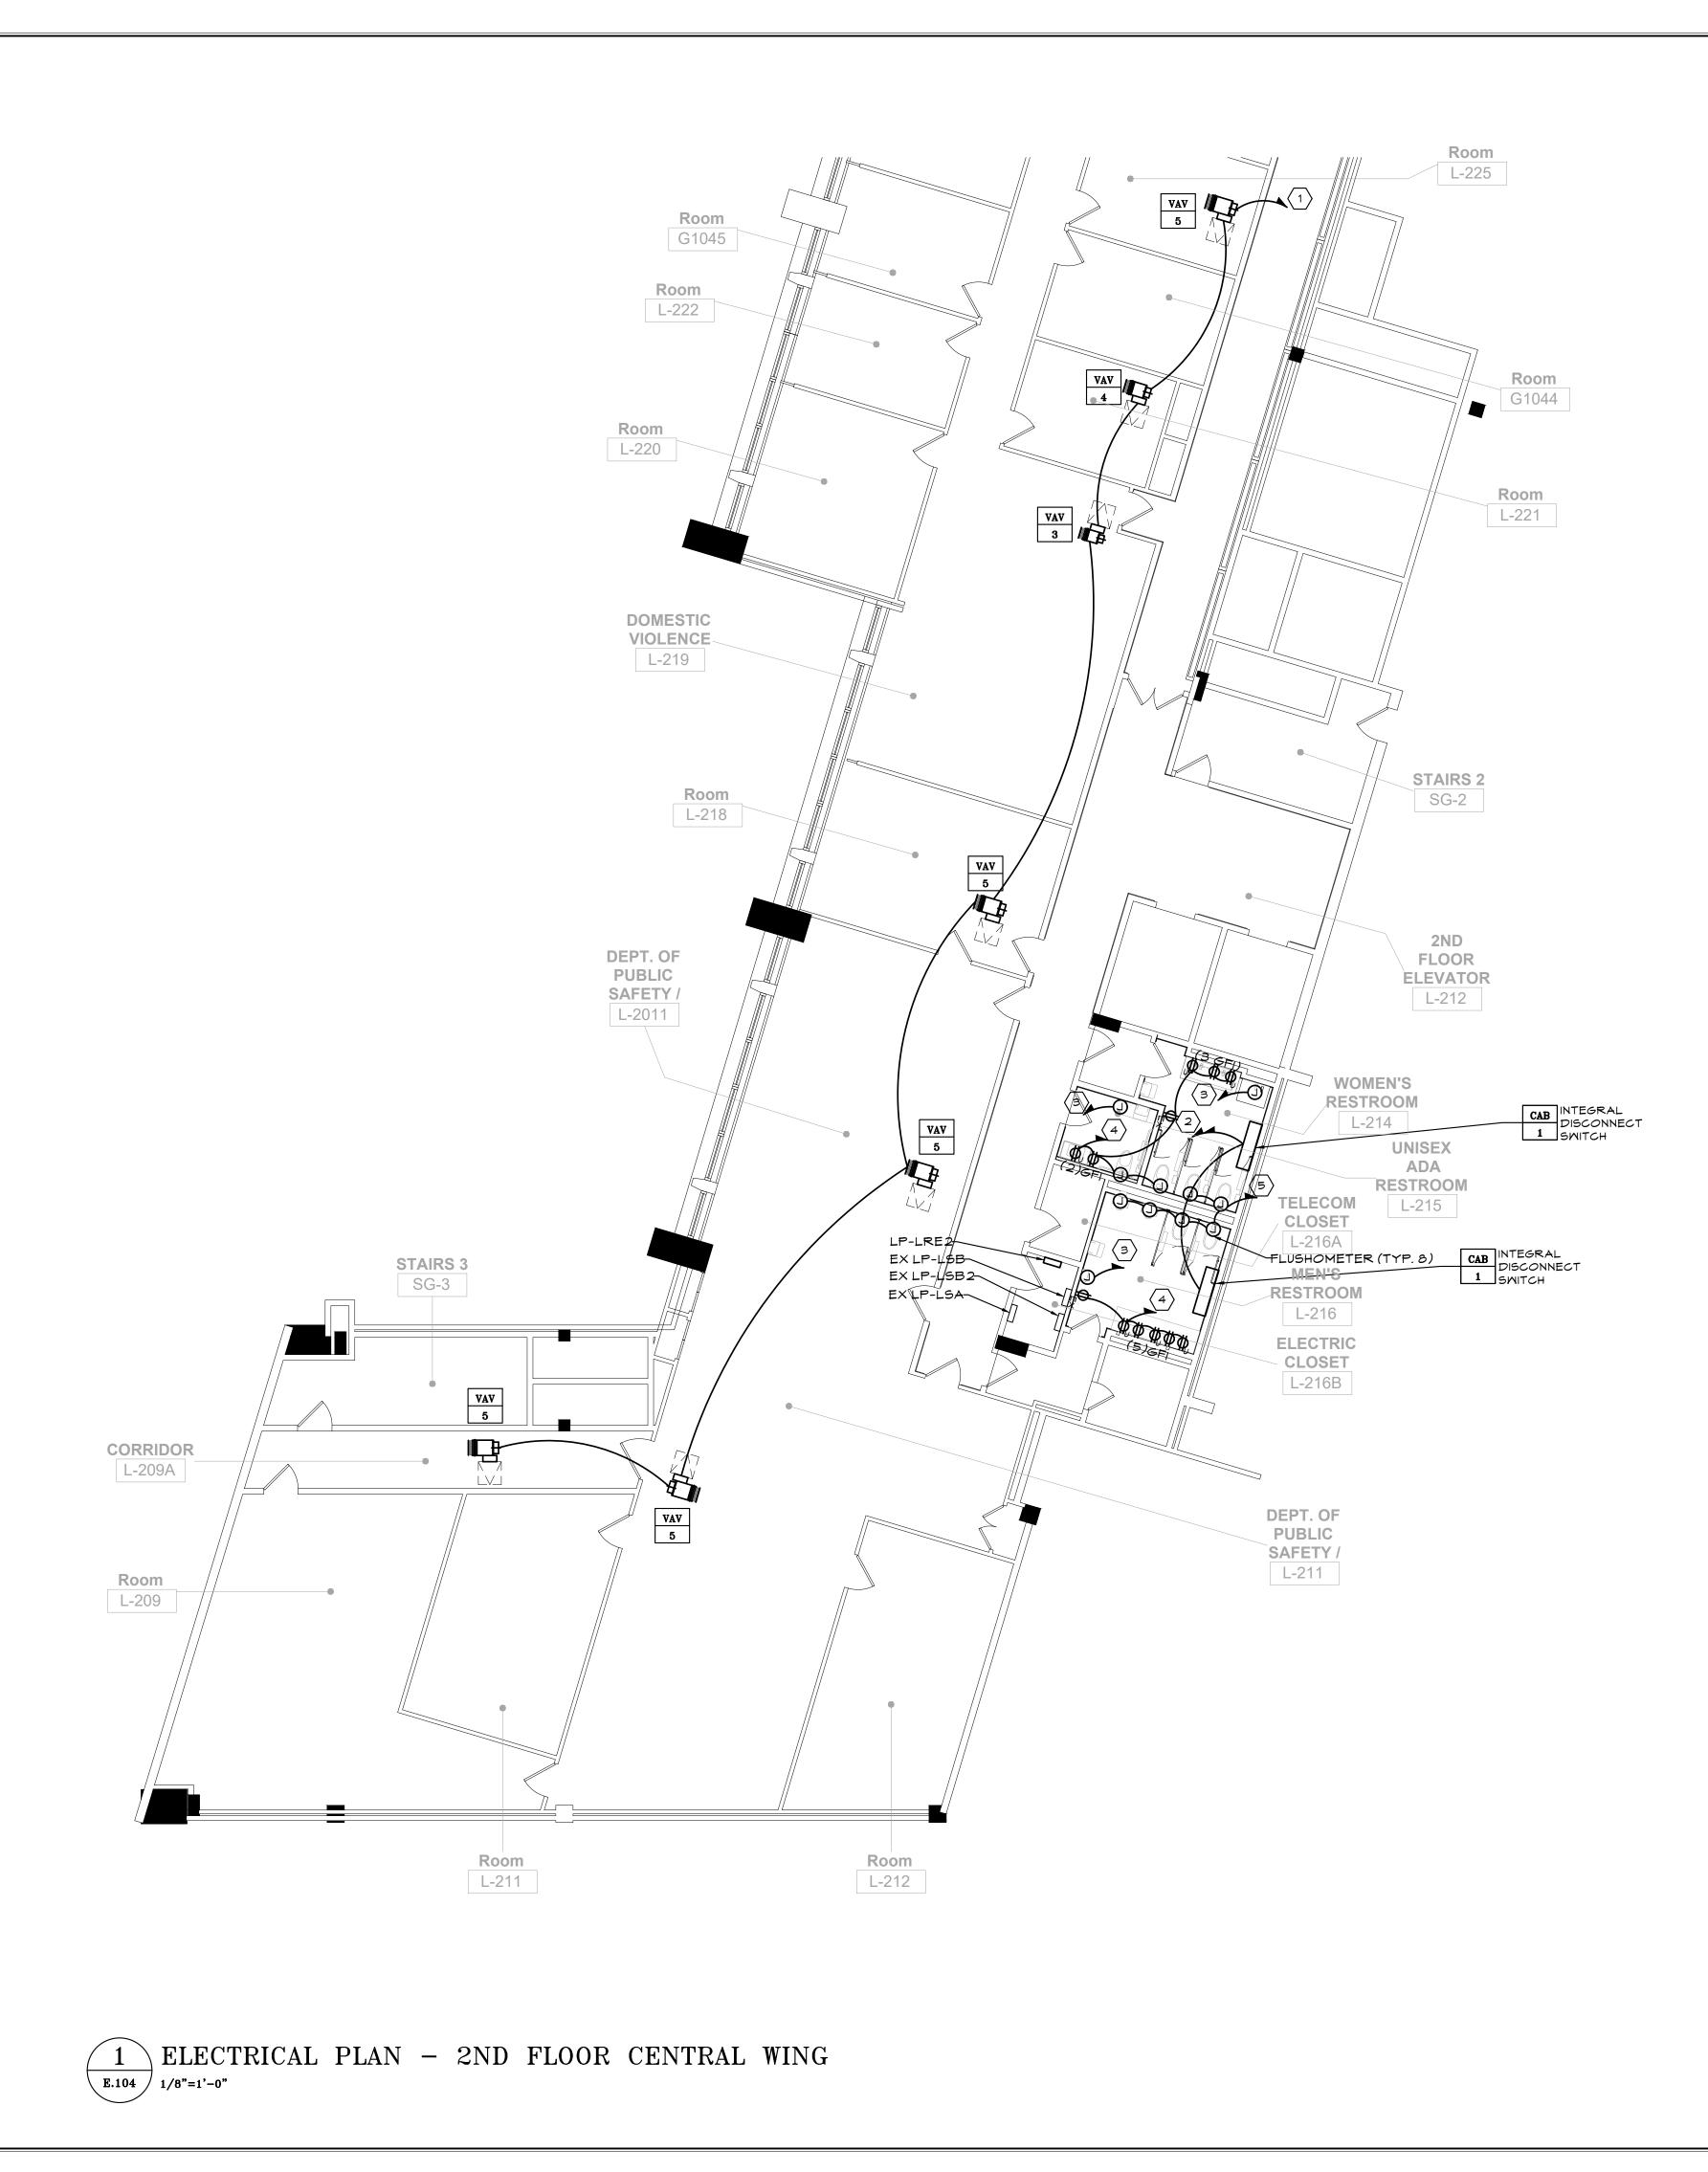



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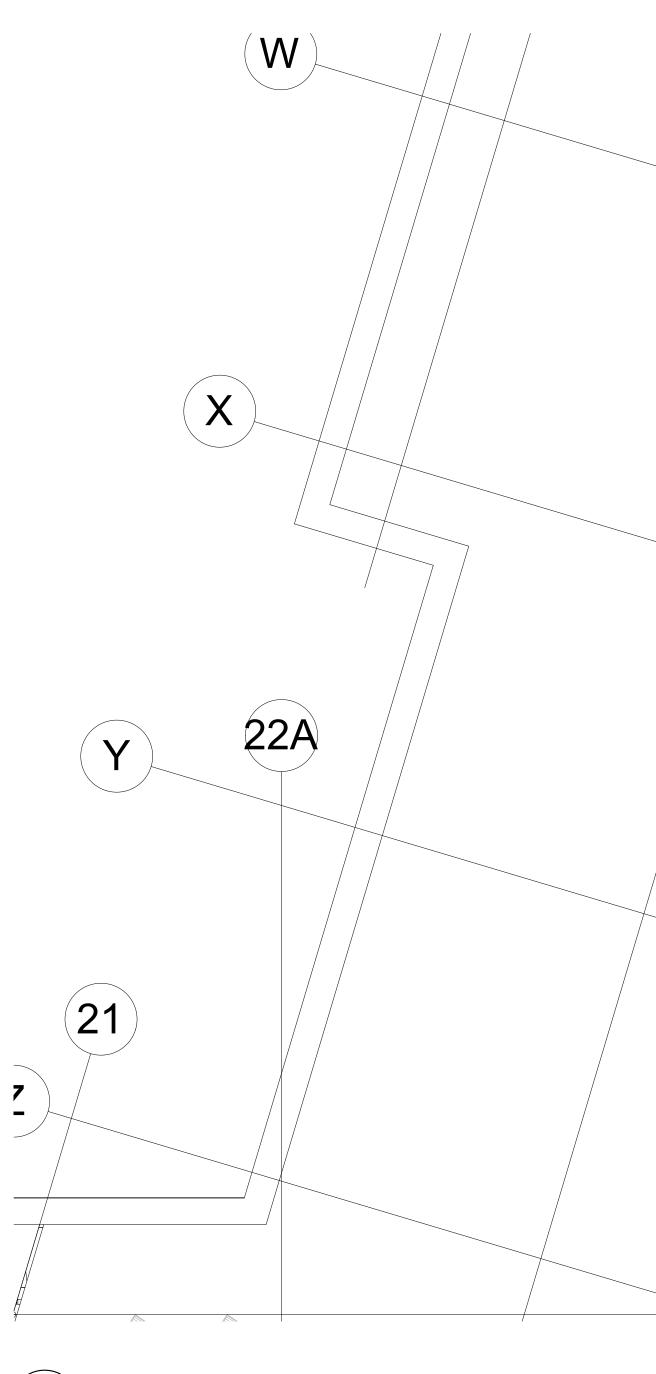




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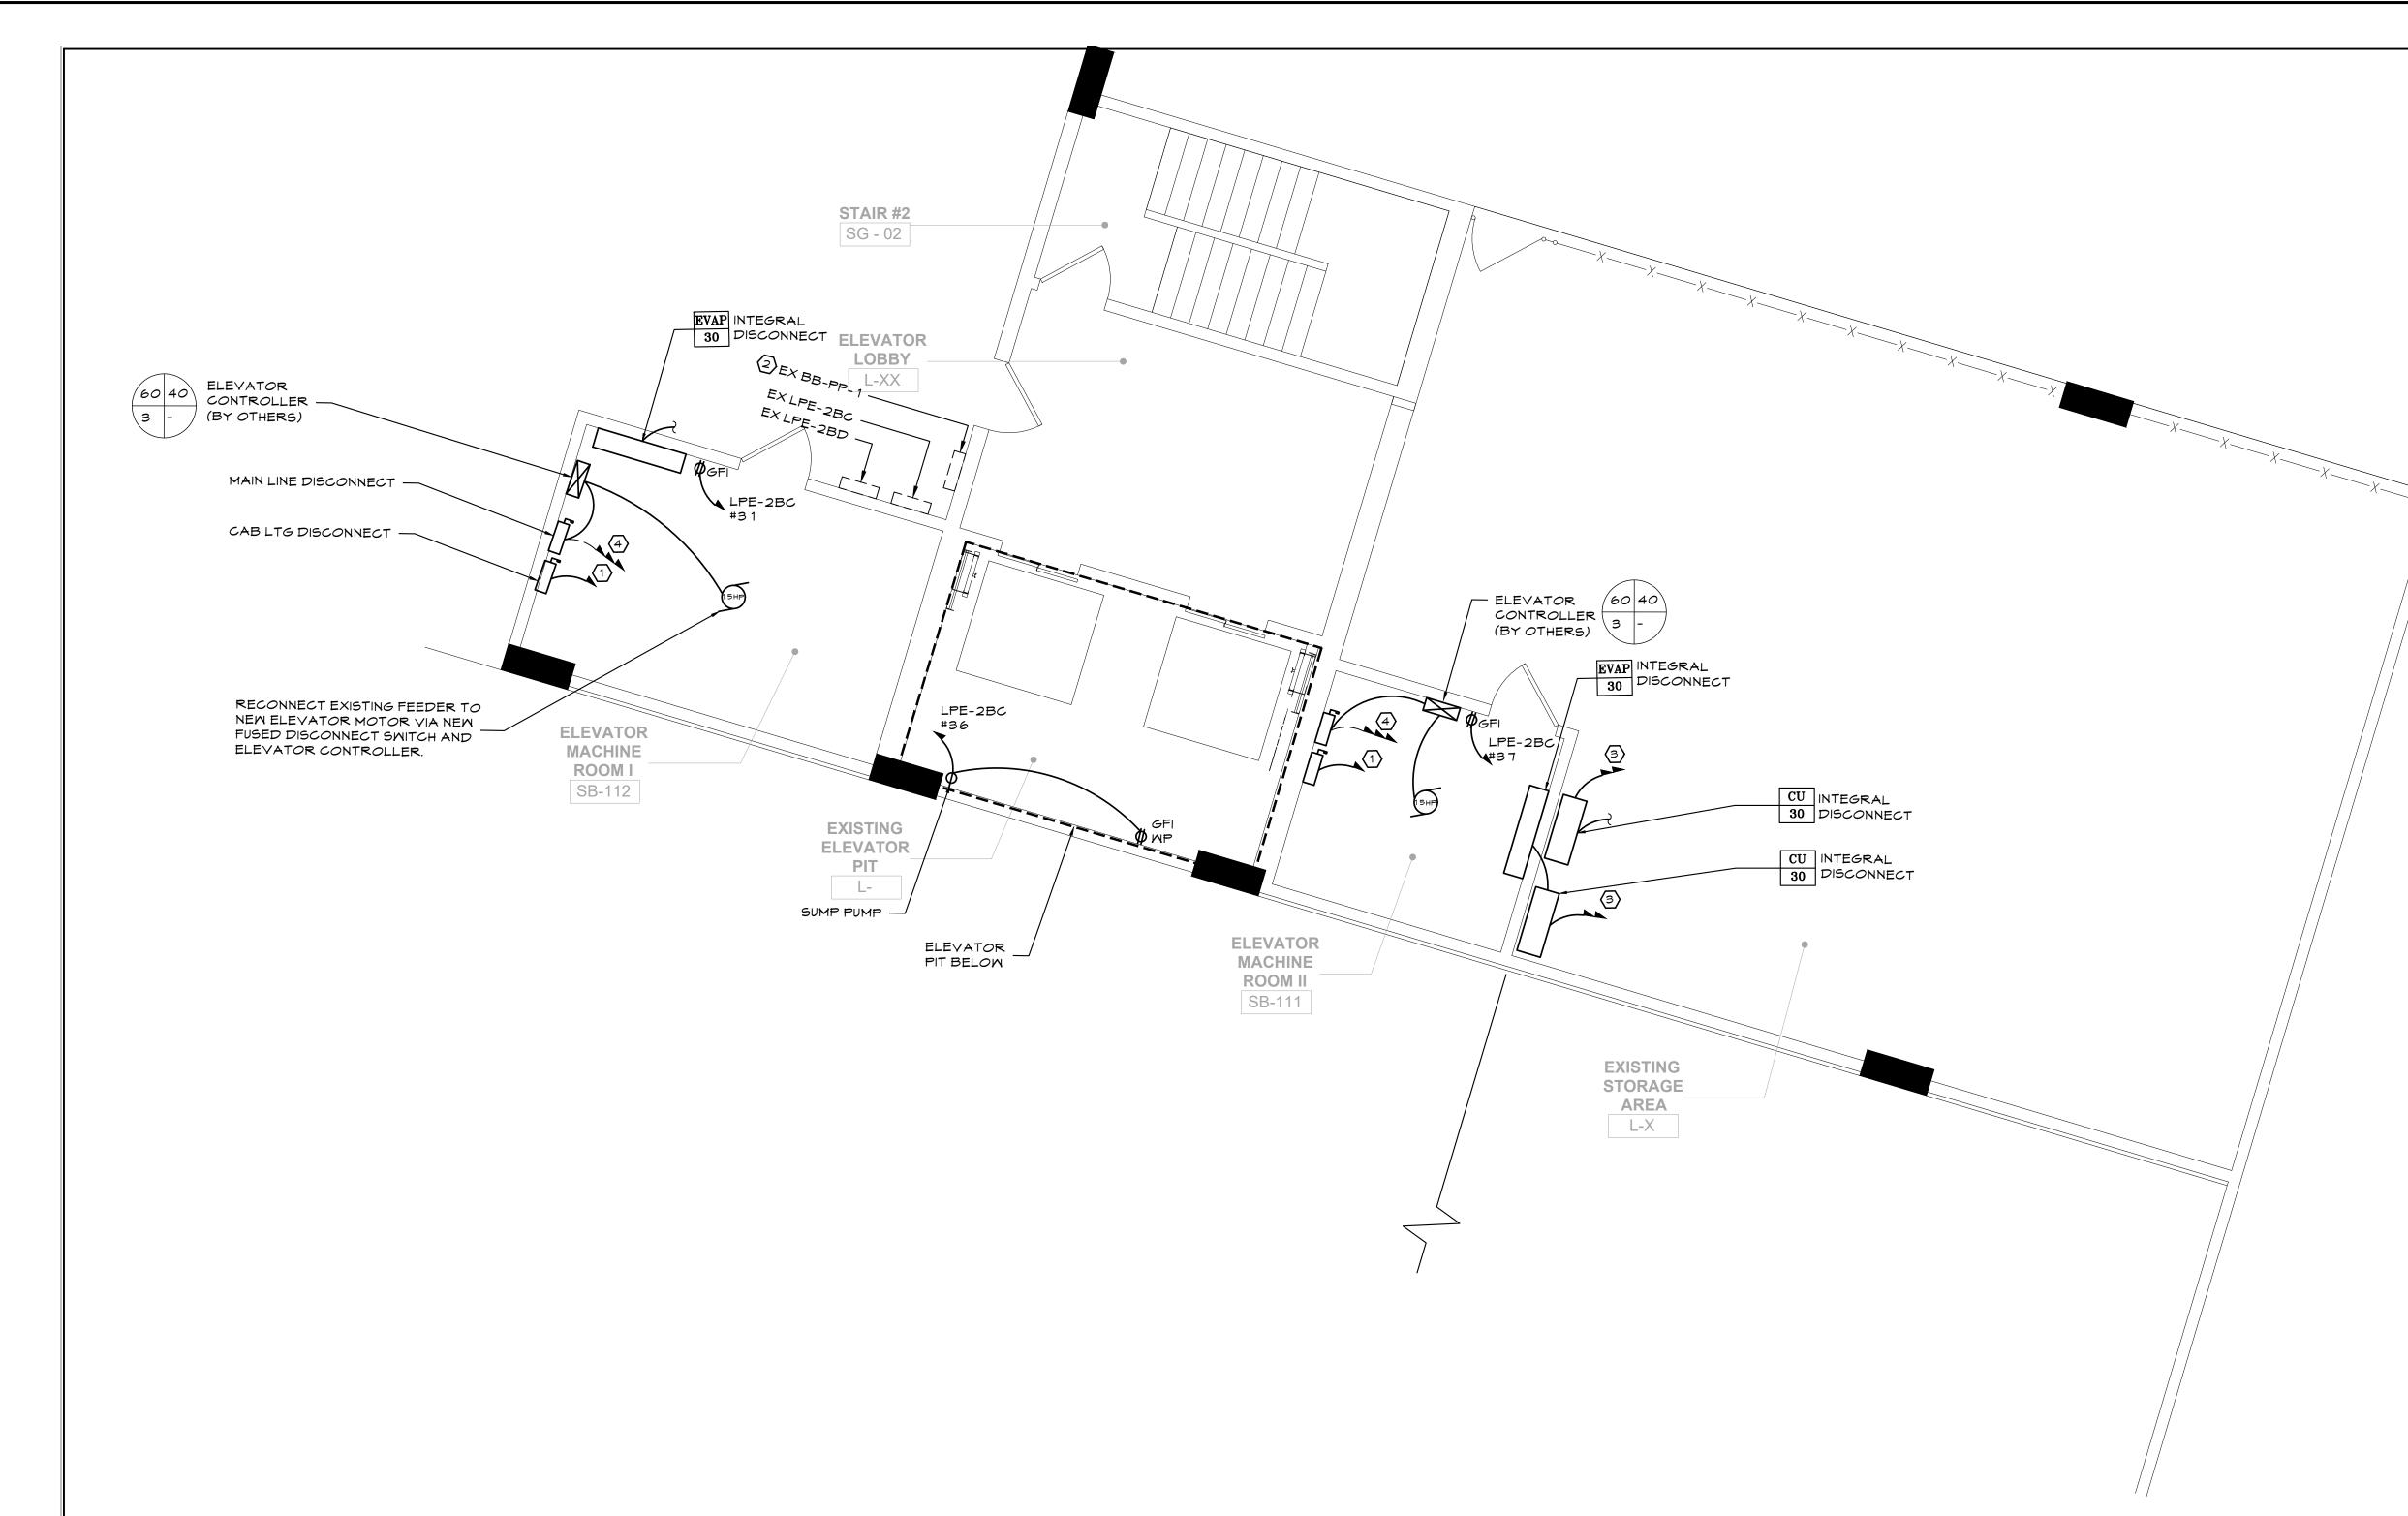
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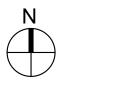


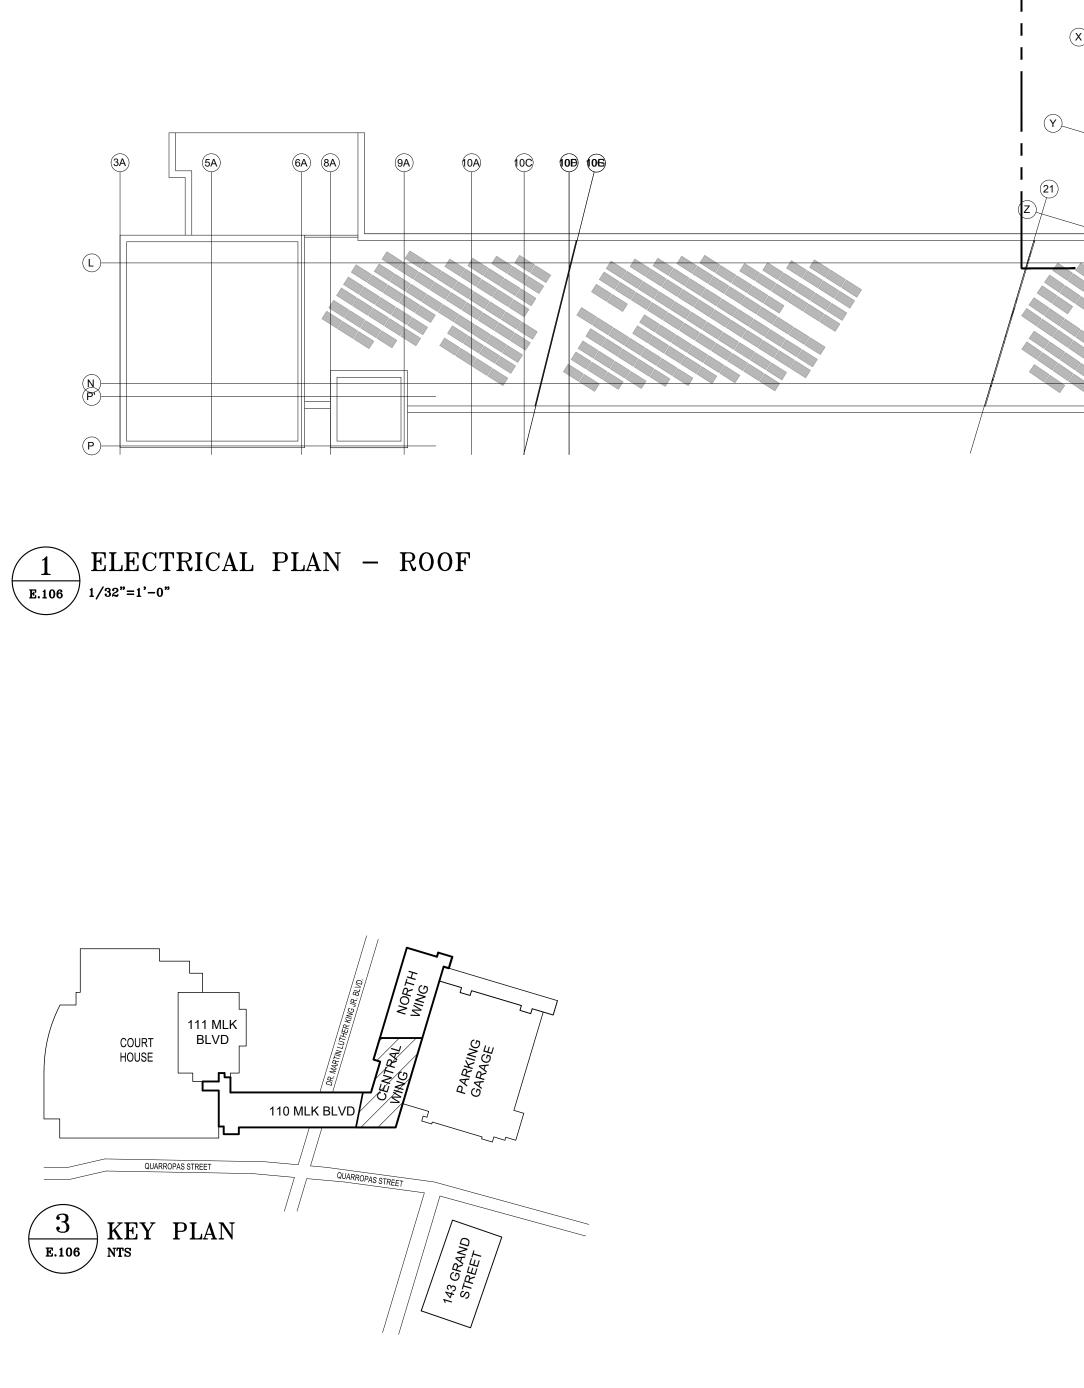

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#### KEY NOTES

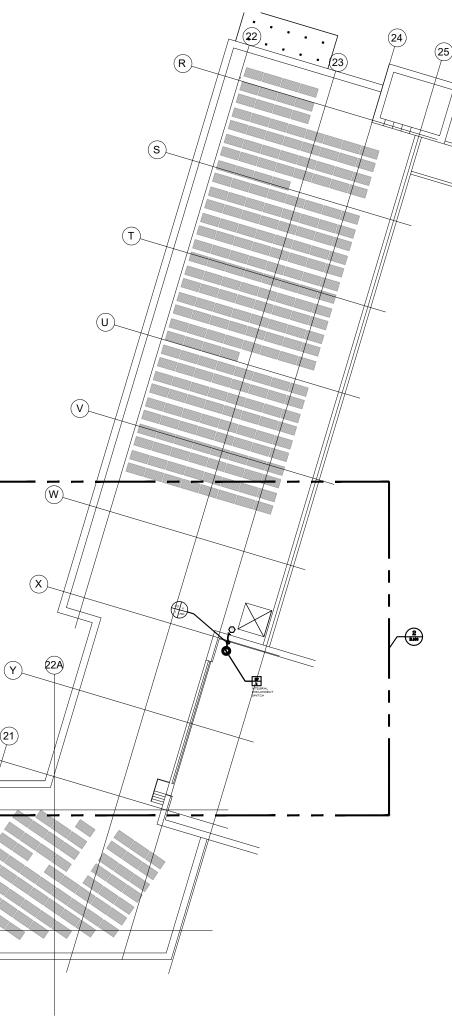
- WIRE CAB LTG TO EXISTING 20A/1P CIRCUIT BREAKER SERVING ELEVATOR LTG IN PANEL LPE-2BC. EXTEND 2#12+#12G AS REQUIRED.PROVIDE UL-924 LISTED EMERGENCY LIGHTING INVERTER.
- MODIFY BB-PP-1 AS REQUIRED TO ACCOMMODATE (2) 30A/2P CIRCUIT BREAKERS TO FEED NEW SPLIT SYSTEMS IN ELEVATOR CONTROL ROOMS.

³WIRE NEW SPLIT SYSTEM TO PANEL BB-PP-1 AFTER MODIFICATION. EXTEND 3#10+#10G AS REQUIRED.

 $\langle 4 \rangle$ EXISTING FEEDER TO MDB TO REMAIN.


#### GENERAL NOTES

CONTRACTOR SHALL COORDINATE ALL ELEVATOR RELATED WORK WITH ELEVATOR CONSULTANT SPECIFICATIONS. CONTRACTOR TO REVIEW ALL ELECTRICAL REQUIREMENTS WITH ELEVATOR SYSTEM VENDOR AND TO REPORT ANY DISCREPANCIES IN DESIGN DOCUMENTS TO ENGINEER PRIOR TO BID. 2. CONTRACTOR TO REUSE EXISTING CIRCUITS WHERE FEASIBLE.

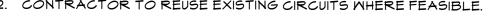

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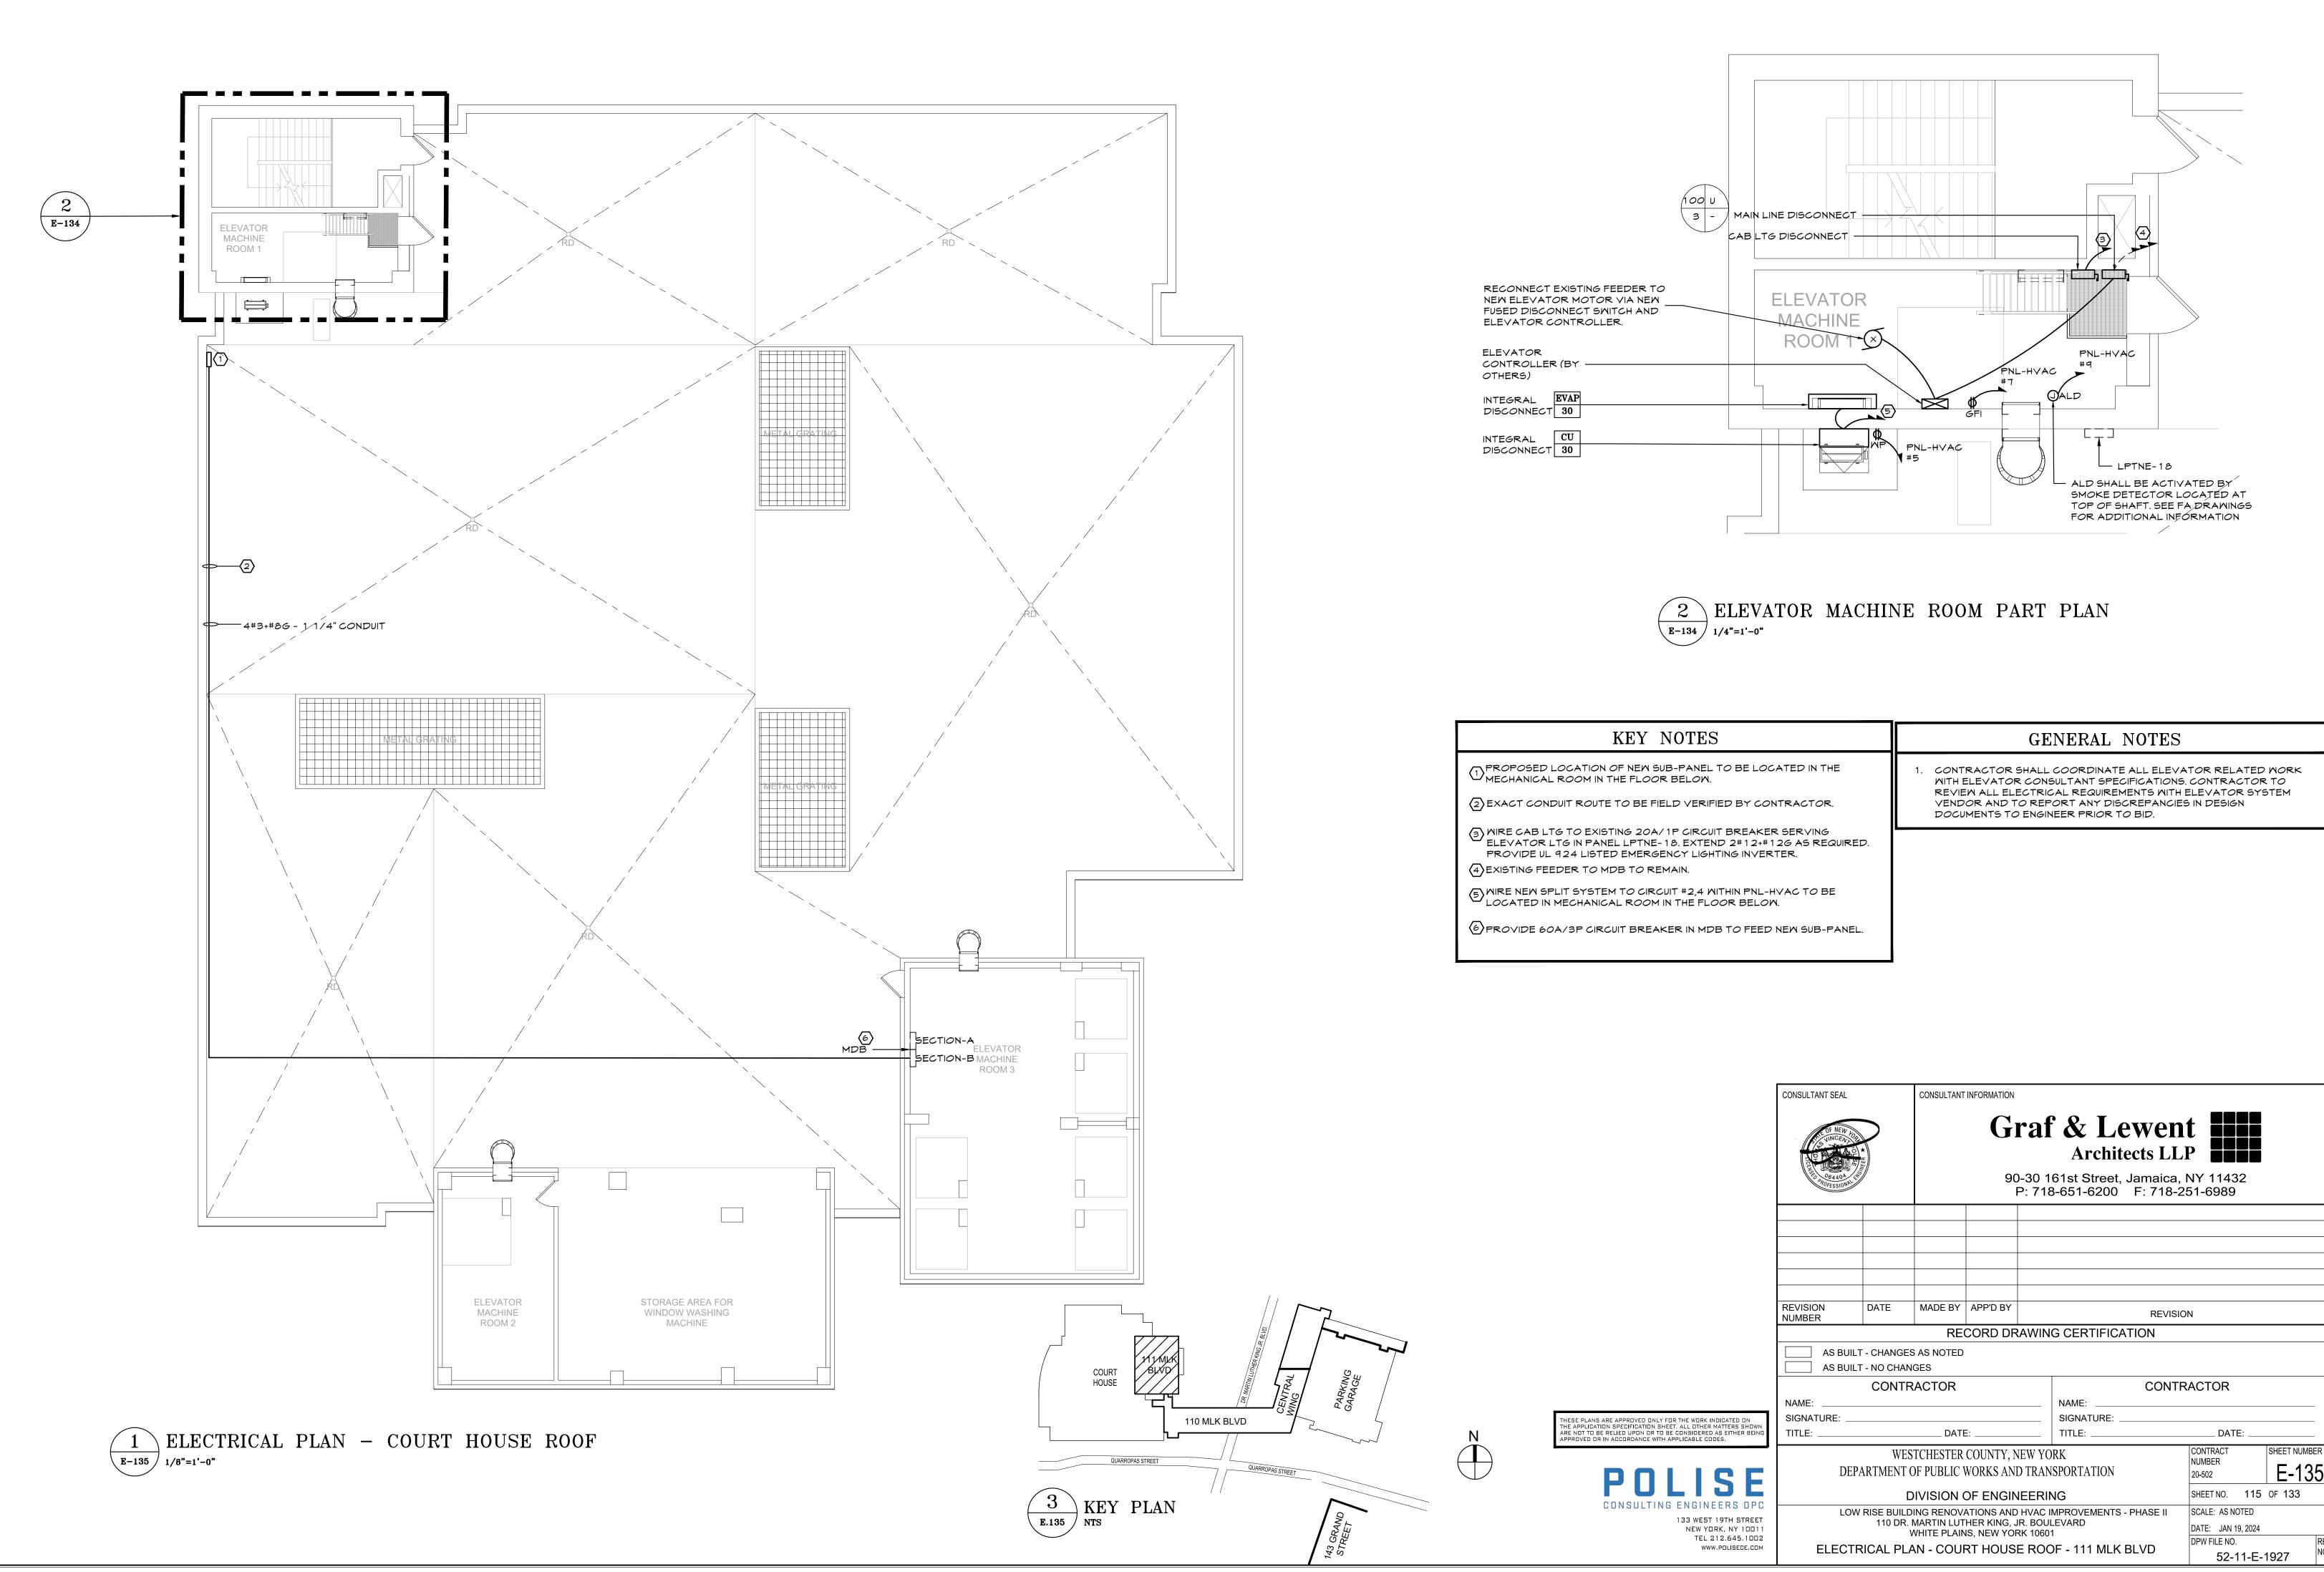


DWIRE CIRCUIT TO NEAREST AVAILABLE 120V SOURCE. ALLOW FOR 100' OF 2#12+#12G IN 3/4" CDT.
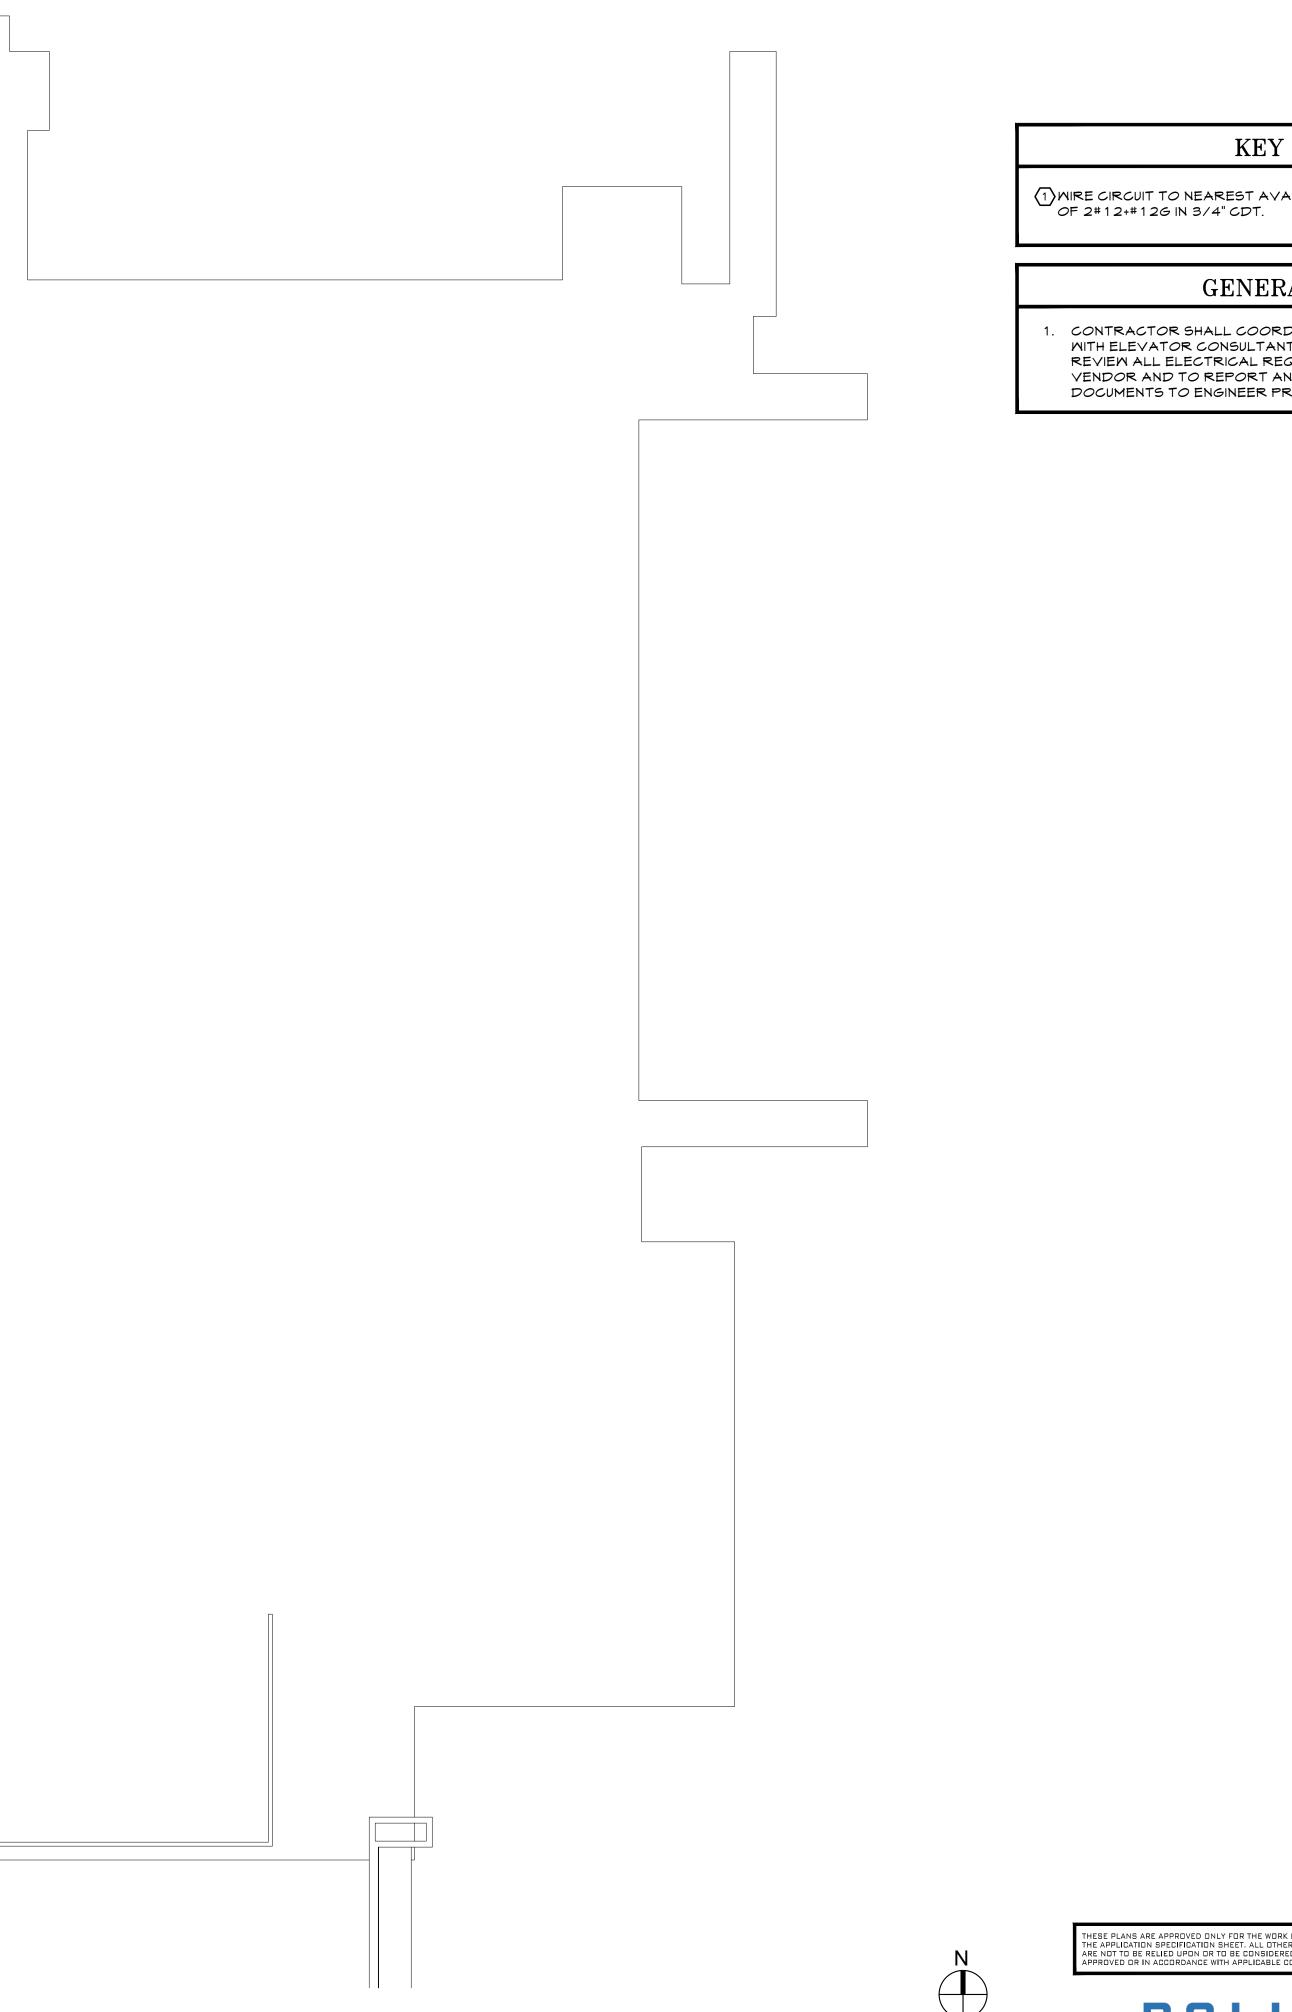
#### GENERAL NOTES


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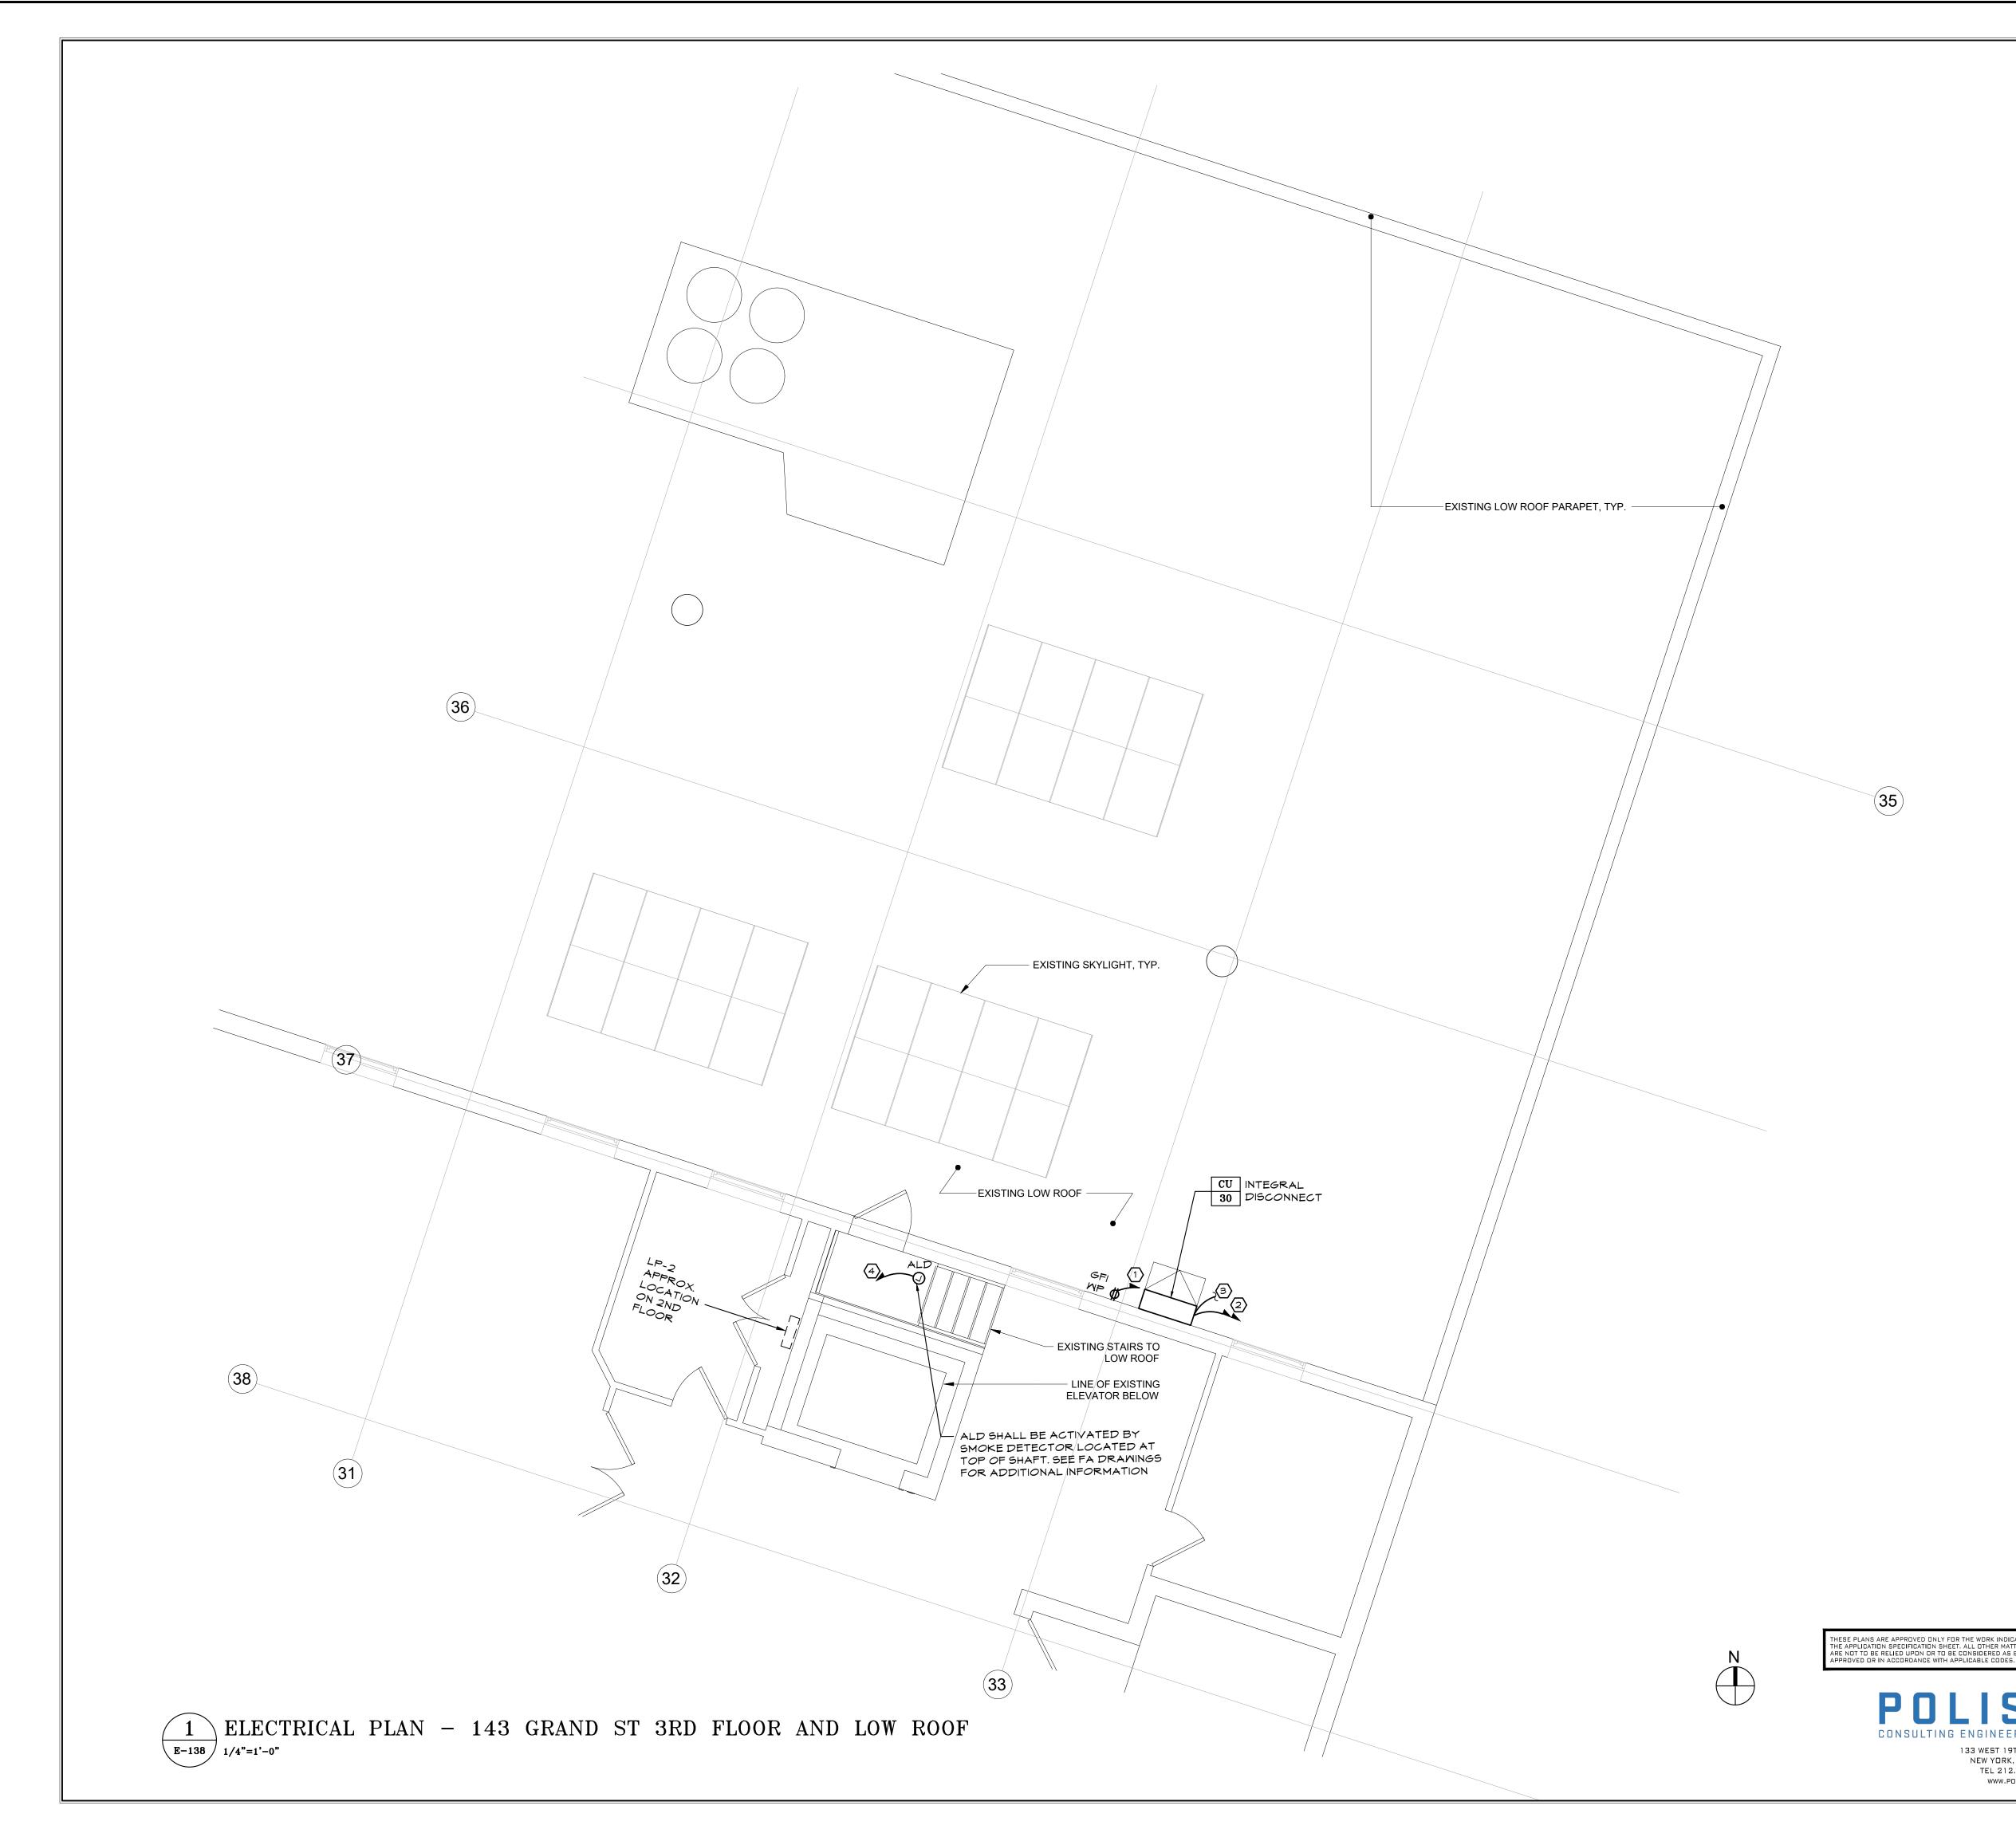
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KEY NOTES	GENERAL NOTES
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NG 20A/1P CIRCUIT BREAKER SERVING L LPTNE-18. EXTEND 2#12+#12G AS REQUIRED. EMERGENCY LIGHTING INVERTER	DOCUMENTS TO ENGINEER PRIOR TO BID.

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2 WIRE NEW SPLIT SYSTEM TO CIRCUIT #1,3 IN PANEL PNL-HVAC WITH 3#12+#12G-3/4"C.

3 CONNECT TO EVAPORATOR CIRCUIT ORIGINATING FROM FLOOR BELOW.

PROVIDE 20A/1P CIRCUIT BREAKER FOR ALD.

#### GENERAL NOTES

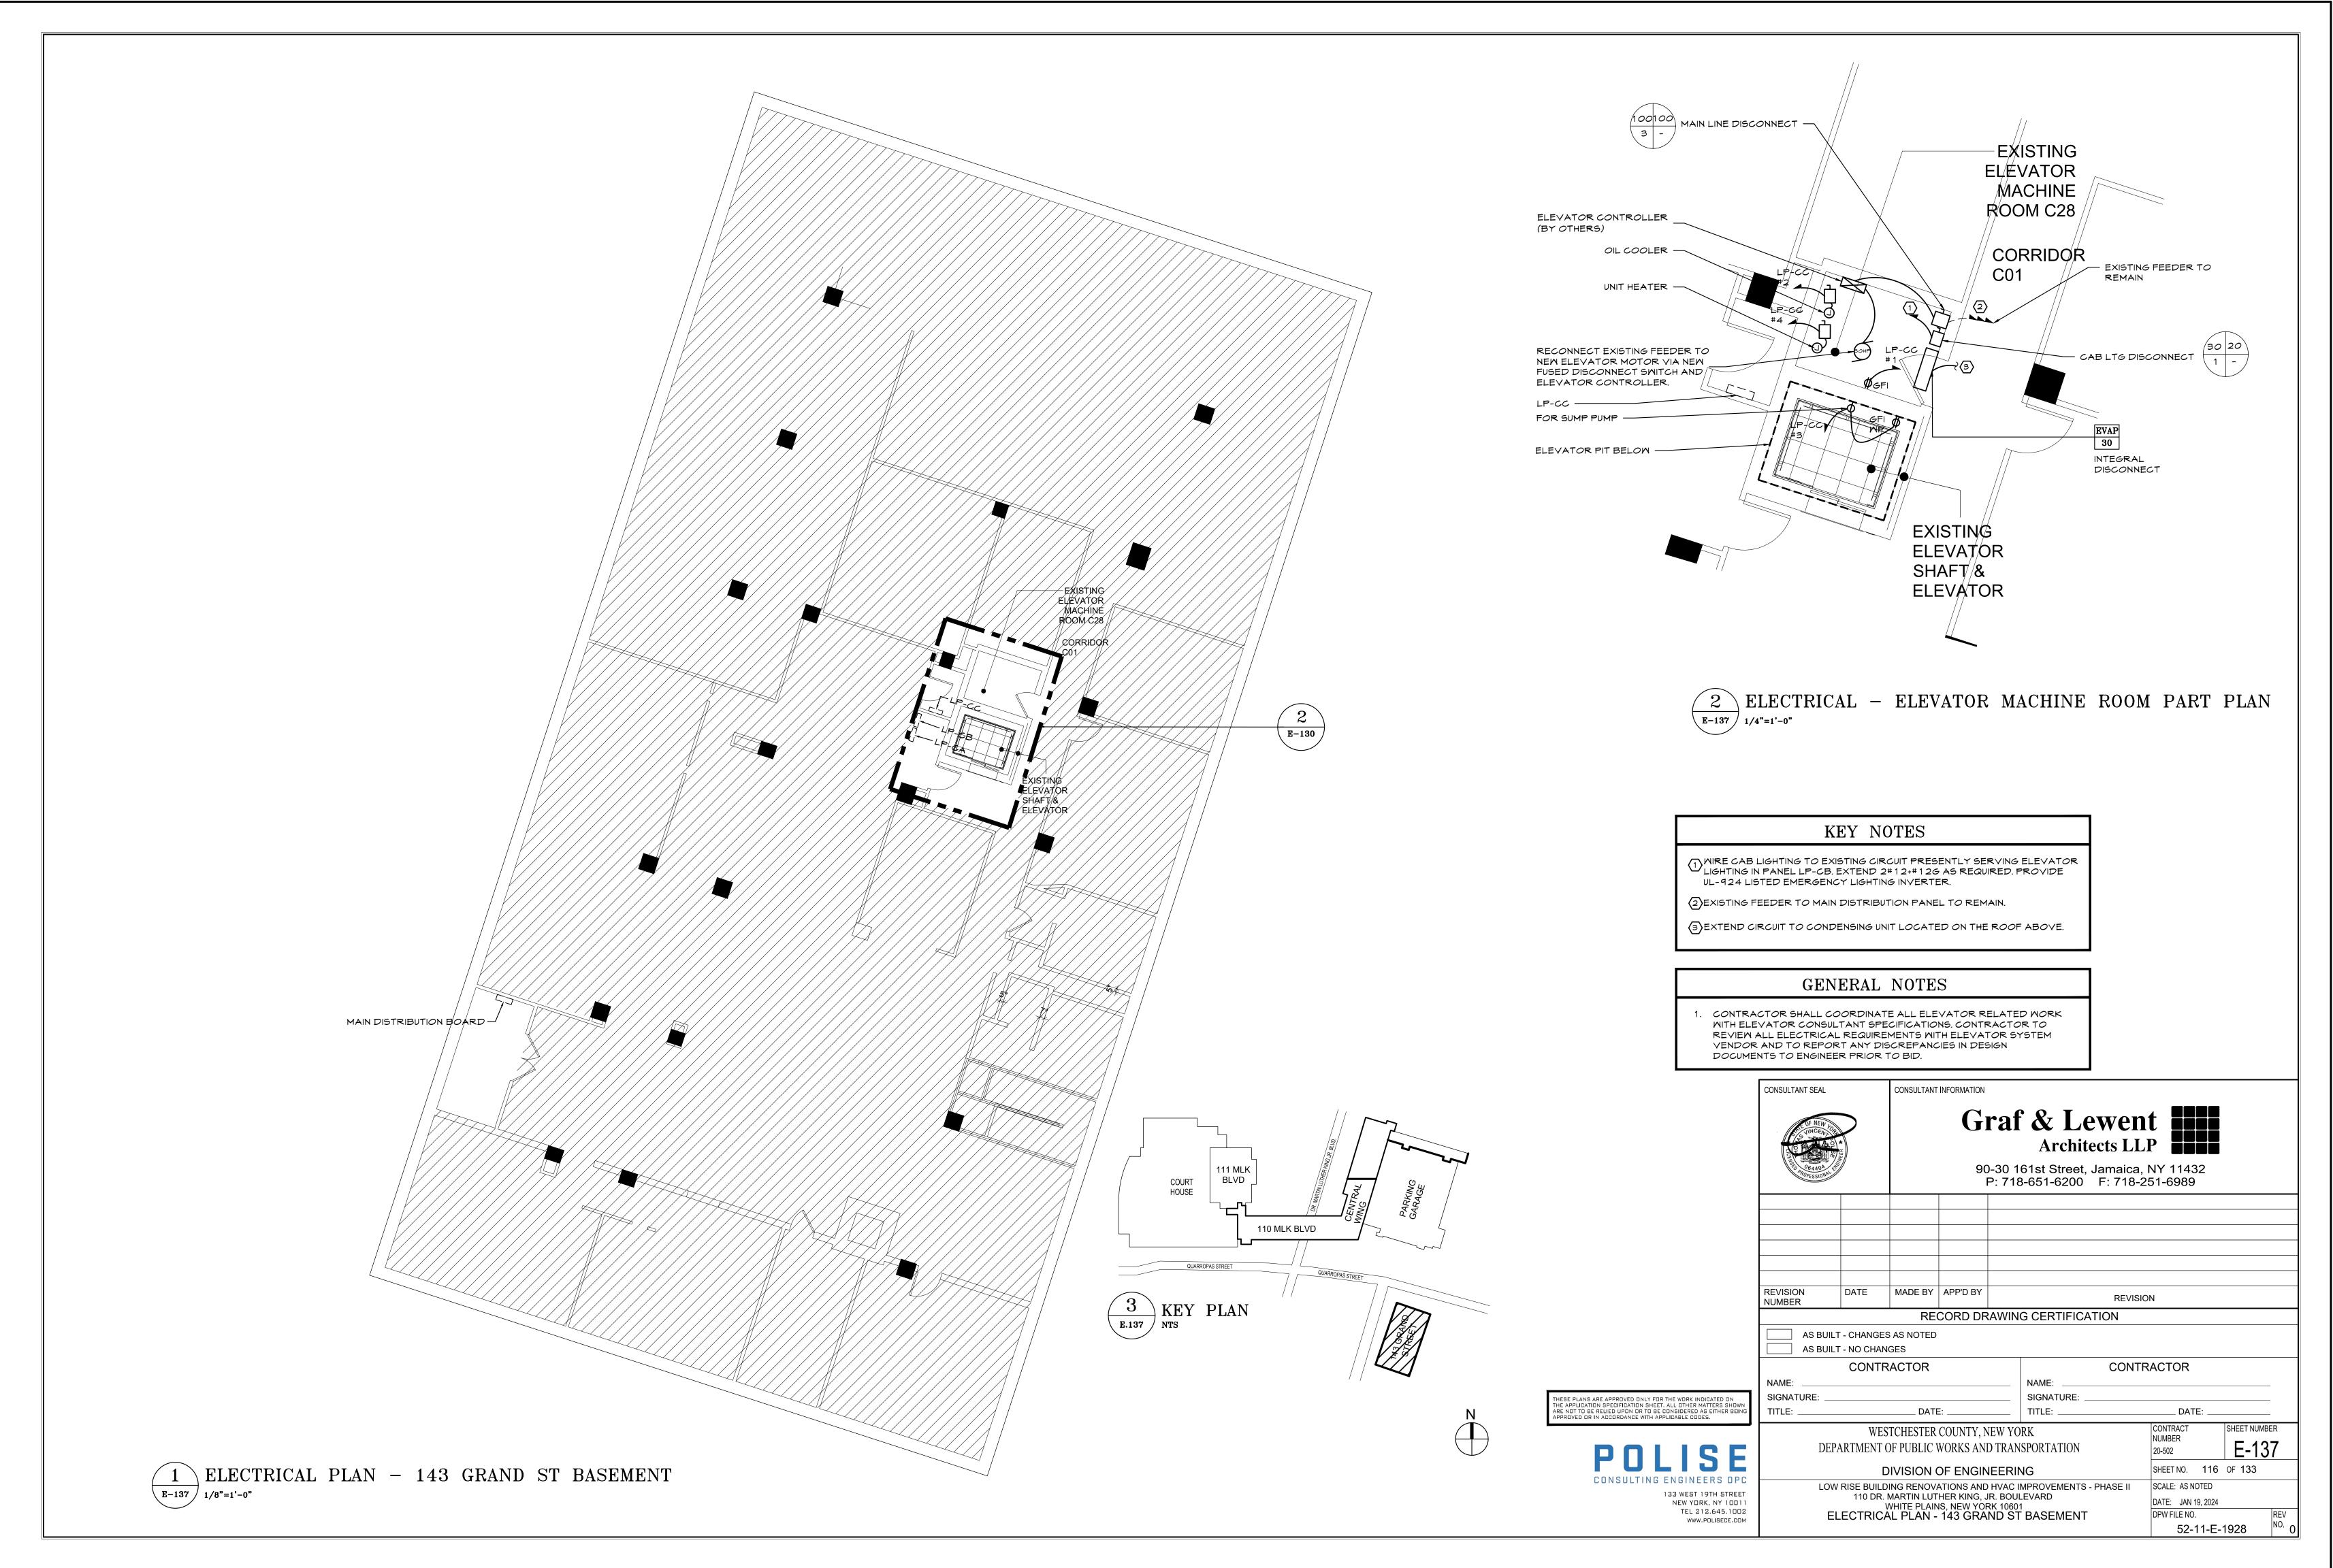. CONTRACTOR SHALL COORDINATE ALL ELEVATOR RELATED WORK WITH ELEVATOR CONSULTANT SPECIFICATIONS. CONTRACTOR TO REVIEW ALL ELECTRICAL REQUIREMENTS WITH ELEVATOR SYSTEM VENDOR AND TO REPORT ANY DISCREPANCIES IN DESIGN DOCUMENTS TO ENGINEER PRIOR TO BID.

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RECONNECT NEW LIGHTING FIXTURES AND LIGHTING FIXTURE CONTROLS TO EXISTING CIRCUIT PRESENTLY SERVING THE AREA. EXTEND 2#12+#12G-3/4"C AS REQUIRED.


#### GENERAL NOTES

- REFER TO ARCHITECTURAL PLANS FOR ALL LIGHTING FIXTURE LOCATIONS AND LIGHTING FIXTURE SWITCHES.
   REFER TO E-020 FOR TYPICAL LIGHTING DETAILS.
- 3. LIGHTING FIXTURES ARE TO BE TAKEN AT 277V U.O.N.
- 4. WIRE ALL EXIT SIGN TO EXISTING CIRCUIT SERVING EXISTING EXIT SIGNS.
- 5. FIXTURES DENOTED WITH SUBSCRIPT "EM" SHALL BE PROVIDED WITH EMERGENCY POWER VIA EMERGENCY LIGHTING PANEL DE PROVIDED WITH EMERGENCY POWER VIA EMERGENCY LIGHTING PANEL LP-LRE2 AND WIRE FOR FULL-ON OPERATION UPON LOSS OF NORMAL POWER. PROVIDE IL 924 LISTED BYPASS RELAY FOR EACH NORMAL/EM ZONE. EXTEND WIRING FOR NORMAL POWER, EMERGENCY POWER, NORMAL POWER SENSING, AND LOW VOLTAGE AS REQUIRED.
- WIRE ALL EMERGENCY FIXTURES SERVING THIS FLOOR TO CKT#1 IN EMERGENCY LIGHTING PNL LP-LRE2 LOCATED ON THE FLOOR ABOVE.

			UARROPAS STREET	UNIT WILLIAM ACTION OF A STREET	143 GRAND STREET GARAGE GARAGE
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RECONNECT NEW LIGHTING FIXTURES AND LIGHTING FIXTURE CONTROLS TO EXISTING CIRCUIT PRESENTLY SERVING THE AREA. EXTEND 2#12+#12G-3/4"C AS REQUIRED.

#### GENERAL NOTES

- REFER TO ARCHITECTURAL PLANS FOR ALL LIGHTING FIXTURE LOCATIONS AND LIGHTING FIXTURE SWITCHES.
   REFER TO E-020 FOR TYPICAL LIGHTING DETAILS.
- 3. LIGHTING FIXTURES ARE TO BE TAKEN AT 277V U.O.N.
- 4. WIRE ALL EXIT SIGN TO EXISTING CIRCUIT SERVING EXISTING EXIT SIGNS.
- 5. FIXTURES DENOTED WITH SUBSCRIPT "EM" SHALL BE PROVIDED WITH EMERGENCY POWER VIA EMERGENCY LIGHTING PANEL LP-LRE2 AND WIRE FOR FULL-ON OPERATION UPON LOSS OF NORMAL POWER. PROVIDE IL 924 LISTED BYPASS RELAY FOR EACH NORMAL/EM ZONE. EXTEND WIRING FOR NORMAL POWER, EMERGENCY POWER, NORMAL POWER SENSING, AND LOW VOLTAGE AS REQUIRED.
- B. WIRE ALL EMERGENCY FIXTURES SERVING THIS FLOOR TO CKT#3 IN EMERGENCY LIGHTING PNL LP-LRE2 LOCATED ON THE FLOOR ABOVE.

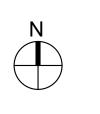					110 MLK BLVD	143 GRAND STREET
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RECONNECT NEW LIGHTING FIXTURES AND LIGHTING FIXTURE CONTROLS TO EXISTING CIRCUIT PRESENTLY SERVING THE AREA. EXTEND 2#12+#12G-3/4"C AS REQUIRED.

#### GENERAL NOTES

- REFER TO ARCHITECTURAL PLANS FOR ALL LIGHTING FIXTURE LOCATIONS AND LIGHTING FIXTURE SWITCHES. 2. REFER TO E-020 FOR TYPICAL LIGHTING DETAILS.
- 3. LIGHTING FIXTURES ARE TO BE TAKEN AT 277V U.O.N.

4. WIRE ALL EXIT SIGN TO EXISTING CIRCUIT SERVING EXISTING EXIT SIGNS.

5. FIXTURES DENOTED WITH SUBSCRIPT "EM" SHALL BE PROVIDED WITH EMERGENCY POWER VIA EMERGENCY LIGHTING PANEL LP-LRE2 AND WIRE FOR FULL-ON OPERATION UPON LOSS OF NORMAL POWER. PROVIDE IL 924 LISTED BYPASS RELAY FOR EACH NORMAL/EM ZONE. EXTEND WIRING FOR NORMAL POWER, EMERGENCY POWER, NORMAL POWER SENSING, AND LOW VOLTAGE AS REQUIRED.

WIRE ALL EMERGENCY FIXTURES SERVING THIS FLOOR TO CKT#5 IN EMERGENCY LIGHTING PNL LP-LRE2.

				QUARROPAS STREET		10 MLK BLVD	143 GRAND STREET GARAGE GARAGE	7
	CONSULTANT SEAL		CONSULTANT	90-30	0 1	<b>&amp; Lewen</b> Architects LL 61st Street, Jamaica, 6-651-6200 F: 718-2	P 11432	
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RECONNECT NEW LIGHTING FIXTURES AND LIGHTING FIXTURE CONTROLS TO EXISTING CIRCUIT PRESENTLY SERVING THE AREA. EXTEND 2#12+#12G-3/4"C AS REQUIRED.

#### GENERAL NOTES

- REFER TO ARCHITECTURAL PLANS FOR ALL LIGHTING FIXTURE LOCATIONS AND LIGHTING FIXTURE SWITCHES.
   REFER TO E-020 FOR TYPICAL LIGHTING DETAILS.
- 3. LIGHTING FIXTURES ARE TO BE TAKEN AT 277 V.O.N.
- 4. WIRE ALL EXIT SIGN TO EXISTING CIRCUIT SERVING EXISTING EXIT SIGNS.
- 5. FIXTURES DENOTED WITH SUBSCRIPT "EM" SHALL BE PROVIDED WITH EMERGENCY POWER VIA EMERGENCY LIGHTING PANEL LP-LRE2 AND WIRE FOR FULL-ON OPERATION UPON LOSS OF NORMAL POWER. PROVIDE IL 924 LISTED BYPASS RELAY FOR EACH NORMAL/EM ZONE. EXTEND WIRING FOR NORMAL POWER, EMERGENCY POWER, NORMAL POWER SENSING, AND LOW VOLTAGE AS REQUIRED.
  6. WIRE ALL EMERGENCY FIXTURES SERVING THIS FLOOR TO CKT#7 IN EMERGENCY LIGHTING PNL LP-LRE2.

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FIRE ALARM SYSTEM G
<ol> <li>NO CONDUITS ARE TO ENTER THE TOP OF A FIRE ALARM CONTROL</li> <li>CEILING MOUNTED SMOKE DETECTORS MUST BE MOUNTED AT LEAS THAT CONTAIN A SHOWER OR BATHTUB.</li> </ol>
3) ALL CEILING MOUNTED DEVICES MUST BE SECURELY FASTENED TO WALL-MOUNTED DEVICES SHALL BE SECURELY MOUNTED IN PLACE.
<ul> <li>4) ALL FIRE ALARM PANELS, JUNCTION BOX COVERS, ETC. SHALL BE P</li> <li>5) DEVICE LOCATIONS MUST BE READILY ACCESSIBLE TO ALLOW FOR</li> </ul>
<ul> <li>6) MANUAL STATIONS SHALL BE MOUNTED 48 INCHES ABOVE THE FINIS</li> <li>7) MANUAL PULL STATIONS SHALL BE PAINTED "FIRE DEPARTMENT REI UN-OBSTRUCTED AT ALL TIME.</li> </ul>
<ul> <li>8) THE LOCAL FIRE DEPARTMENT SHALL APPROVE THE PLANS PRIOR</li> <li>9) DO NOT RUN FIRE ALARM CABLE IN THE SAME RACEWAY WITH NON I</li> </ul>
10) AVOID INSTALLING FIRE ALARM CABLES NEAR SOURCES OF ALTER 11) OBSERVE ALL POLARITY ON ALL FIRE ALARM CIRCUITS. NO TEE TA
ETC.) 12) ALL FIRE ALARM WIRE SHALL BE CLEARLY LABELED IN JUNCTION B
SO THAT THEY DROP OFF DIRECTLY OPPOSITE TO ITS TERMINAL CONNE 13) ANY REQUIREMENTS FOR SHIELDING CERTAIN CONDUCTORS OR RU
MANUFACTURERS DOCUMENTATION. 14) ALL WIRING TO BE CHECKED TO INSURE THAT THEY ARE FREE OF AI 15) ALL FIRE ALARM CONTROL PANEL(S), CABINETS, DATA GATHERING
CUTOUT PANELS ETC. SHALL BE CLEARLY LABELED USING A RED LAMINA THE LABEL SHALL STATE THE SPECIFIC PURPOSE OF THE PANEL AND WH
FIRE PUMP CONTROLLER POWERED WITH 120VAC OR GREATER SHALL H 16) LOCATIONS OF ALL FIRE ALARM EQUIPMENT SHALL BE SUBJECT TO
TO THE SYSTEM OR PLANS SHALL BE PERMITTED WITHOUT WRITTEN APP TO THE DRAWINGS PRIOR TO OR DURING INSTALLATION, AS BUILT PLANS AGENCIES FOR FINAL ACCEPTANCE.
17) ALL FAN SHUTDOWN, DOOR RELEASE, DAMPER CONTROL OR ANY C LOCATED WITHIN THREE (3) FEET OF THE CONTROLLED CIRCUIT OR THE
THE CONTROL UNIT. THE INSTALLATION AND WIRING BETWEEN THE FIRE A SHALL OPERATE ON LOSS OF POWER OR A FAIL SAFE MANNER AS REQU
18) A LOCK SHALL BE PROVIDED ON EACH DISCONNECT MAINTAINING IT THE KEY TO THE LOCK IS LOCATED.
19) TAMPER SWITCHES SHALL BE PROVIDED ON THE DOOR TO EACH D 20) A SMOKE DETECTOR SHALL BE PROVIDED ABOVE EACH FIRE ALAF 21) OUTDOOR NOTIFICATION DEVICES TO BE PROVIDED WITH WEATHER
<ul> <li>22) ALL STROBE CIRCUITS ARE TO BE SUPERVISED.</li> <li>23) ALL SMOKE DETECTORS INDICATED ARE TO BE PHOTO-ELECTRIC.</li> </ul>
24) TEST HEAT DETECTORS WITH HEAT GUN. PROVIDE WRITTEN VERIFIC 25) FIRE ALARM SYSTEM TO BE CAPABLE OF MULTI CHANNEL AUDIO.
26) LOCATE KEYS TO ALL LOCKED DISCONNECT SWITCHES AT THE FIRM 27) PAINT ALL TROUGH, JUNCTION BOXES, CONDUIT COVERS AND FIRE A

T ALL TROUGH, JUNCTION BOXES, CONDUIT COVERS AND FIRE ALARM AUTOMATIC TRANSFER SWITCH THROUGHOUT THE BUILDING FIRE DEPT. RED 28) PROPERLY PROTECT ALL FIRE ALARM DEVICES DURING CONSTRUCTION. 29) PROVIDE REMOTE INDICATOR LAMPS FOR DUCT SMOKE DETECTORS WHETHER SHOWN ON THE PLANS OR NOT. 30) DOOR RELEASE RELAYS TO OPERATE IN A SIMILAR MANNER TO DOOR RELEASE RELAYS IN THE EXISTING SYSTEM. THERE SHOULD BE NO CHANGE IN PROGRAMMING AND MUST WORK WITH CODE ADAM.

31) THE PROPOSED DESCRIPTION OF EACH DEVICE IN THE SYSTEM SHOULD BE PROVIDED BY THE CONTRACTOR TO THE ENGINEER AND OWNER FOR REVIEW AND APPROVAL PRIOR TO PROGRAMMING THE SYSTEM.

32) COORDINATE TIE-INS TO SYSTEMS PROVIDED BY OTHERS WITH ASSOCIATED SYSTEM VENDOR, TIE HOOD FIRE PROTECTION SYSTEM RELAYS WITH ASSOCIATED SYSTEM VENDORS. 33) FOR PROJECTS THAT ARE UPGRADING TO A TEMPORAL 3 PATTERN: REMOVE ALL EXISTING CODE CARDS.

34) ALL FIRE ALARM DEVICES TO BE INSTALLED IN ACCESSIBLE LOCATIONS. COORDINATE ACCESS AND LOCATIONS WITH OTHER TRADES. 35) SYSTEM MUST BE TESTED, NEW DEVICES TO BE PROGRAMMED AND VERIFIED THAT THEY WORK WITH CODE ADAM. NOTE: SYSTEM MUST BE TIED INTO I-STAR PANEL.

LOW RISE TEMPORAL 3 FIRE ALARM SYSTEM FEATURING MANUAL ALARM, SELECTIVE SMOKE DETECTION, SPRINKLER ALARM, CO ALARM, AND COC.

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	ACTUATE COMMON ALARM SIGNAL	ACTUATE AUDIBLE ALARM SIGNAL	ACTUATE COMMON SUPERVISORY SIGNAL INDICATOR	ACTUATE AUDIBLE SUPERVISORY SIGNAL	ACTUATE COMMON TROUBLE SIGNAL INDICATOR	ACTUATE AUDIBLE COMMON TROUBLE SIGNAL	ACTIVATE VISUAL/AUDIO DEVICES	: DISPLAY/PRINT CHANGE OF STATUS	TRANSMIT AUTOMATIC ALARM SIGNAL TO SUPERVISING STATION	TRANSMIT MANUAL SIGNAL TO SUPERVISING STATION	TRANSMIT WATERFLOW SIGNAL TO SUPERVISING STATION	TRANSMIT SUPERVISORY SIGNAL TO SUPERVISING STATION	TRANSMIT PUMP RUNNING SIGNAL TO SUPERVISING STATION	TRANSMIT TROUBLE SIGNAL TO SUPERVISING STATION	ACTIVATE A TEMPORAL 4 SIGNAL ON ACTIVATED CO SOUNDER BASES AND SHUT DOWN CO PRODUCING EQUIPMENT	RELEASE MAGNETICALLY HELD DOORS	RECALL ELEVATORS TO GROUND FLOOR, OPEN CAB DOOR	RECALL ELEVATORS TO ALTERNATE FLOOR	I CLOSE SMOKE/FIRE DAMPERS IN RATED WALLS	UNLOCK NECESSARY EXITS	OPEN APPROPRIATE SMOKE HATCH / AUTOMATIC LOUVER DAMPER ASSOCIATED WITH SMOKE VENT SYSTEM	ACTIVATE FIRE RECALL ANNUNCIATION (FIRE HAT)	SHUT DOWN ALL FANS OVER 2000 CFM	CLOSE ASSOCIATED SMOKE DAMPER	I NOT USED	NOT USED	NOT USED
SYSTEM INPUTS	A	В	C	D	E	F	G	Н		J	K	L	M	0	P	Q	R	S	Т	U	V	W	Х	Y	Z	AA	BB
1 ELEVATOR LOBBY, TOP OF SHAFT & MACHINE RM SMOKE DETECTORS	Х	Х					X	Х	X							Х	Х		Х	Х	X	X	X	Х	ļ	<u> </u>	
2 ELEVATOR LOBBY ON PRIMARY RECALL FLOOR	Х	Х					Х	X	X							Х		Х	Х	Х	X	X	X	X	L		
3 OPEN CIRCUIT					X	X		X						Х										·'	L		
4 GROUND FAULT					X	X		Х						X													
5 ON FAN SHUTDOWN BY FAS																							Х				
	Α	В	C	D	E	F	G	Н	1	J	K		М	0	P	Q	R	S	Т	U	V	W	Х	Y	7	AA	BB

NOTE: SEQUENCE OF OPERATION TO MATCH EXISTING



#### GENERAL AND INSTALLATION NOTES

L REGARDLESS OF SYSTEM TYPE OR SIZE. THEY MUST FOLLOW EXISTING INSTALLATION. ST 3 FEET FROM SUPPLY AIR REGISTERS, AIR DIFFUSERS AND DOORS OF BATHROOMS

THE BUILDING STRUCTURE AND NOT TO THE CEILING GRID. FURTHERMORE ALL

PAINTED "FIRE DEPARTMENT RED".

OR MAINTENANCE AND REPAIR. ISHED FLOOR TO THE CENTER OF THE HANDLE.

ED". ALL MANUAL PULL STATIONS SHALL BE INSTALLED SO THAT THEY KEPT

R TO START OF ANY WORK.

N FIRE ALARM CABLE. RNATING CURRENT (LIGHTING, POWER, ETC.)

APPING IS PERMITTED ON ALARM INDICATING CIRCUITS (HORNS, STROBES, SPEAKERS, BOXES AND CABINETS. FURTHERMORE CONDUCTORS IN CABINETS SHALL BE FORMED NECTION. ALL TERMINALS SHALL BE NUMBERED AND LABELED IN EVERY CABINET. UNNING THEM IN SEPARATE RACEWAYS SHALL BE AS RECOMMENDED BY THE

ANY OPENS, SHORTS OR GROUNDS.

S PANELS, JUNCTION BOXES, BOOSTER POWER SUPPLIES, FUSE DISCONNECTS, FUSE NATE TYPE ENGRAVED LABEL WITH MINIMUM 1 INCH HIGH ENGRAVED WHITE LETTERS. HAT FLOORS IT SERVES. ALL MAIN PANELS, CENTRAL STATION TRANSMITTERS AND HAVE A LABEL INDICATING WHERE THE MAIN DISCONNECT IS LOCATED. O LOCAL BUILDING AND FIRE DEPARTMENT APPROVAL. NO CHANGE OR MODIFICATION PROVAL FROM THE ENGINEER OF RECORD. IF ANY SUBSTANTIAL CHANGES ARE MADE IS SHALL BE PREPARED BY THE ENGINEER AND FILED WITH THE APPROPRIATE

OTHER AUXILIARY RELAYS CONNECTED TO THE FIRE ALARM SYSTEM SHALL BE E AUXILIARY RELAY SHALL FUNCTION WITHIN THE VOLTAGE AND CURRENT LIMITATION OF ALARM SYSTEM AND THE AUXILIARY RELAY SHALL BE PROPERLY SUPERVISED OR QUIRED BY NFPA72.

IT IN THE CLOSED AND ENERGIZED POSITION AND BE PROVIDED WITH A LABEL WHERE

DATA GATHERING PANEL WHETHER SHOWN ON THE PLANS OR NOT. ARM CONTROL PANEL/CONTROL EQUIPMENT WHETHER SHOWN ON THE PLANS OR NOT. ER PROOF COVERS WITH SILICON ON TOP AND SIDES.

TYPE. IONIZATION TYPE NOT PERMITTED. CATION THAT TEST HAS BEEN CONDUCTED.

RE COMMAND STATION.

#### FIRE ALARM WIRING

THE DESIGN INTENT IS FOR DEVICES MOUNTED ON BLOCK WALLS IN UNFINISHED SPACES TO BE SURFACE MOUNTED WITH CONDUIT STUB-UPS TO HUNG CEILINGS. DEVICES MOUNTED ON SHEETROCK WALLS TO BE FLUSH MOUNTED WITH CONDUIT STUB UPS BEHIND WALLS TO HUNG CEILINGS. DEVICES MOUNTED ON BLOCK WALLS IN FINISHED AREAS TO BE FLUSH MOUNTED, CHOPT CHASE BLOCK WALLS AS REQUIRED PER INSTALLATION OF CONDUIT AND BACKBOX. CONDUIT FOR FIRE ALARM WIRING TO BE MINIMUM 3/4". ALL WIRING TO BE 150" PLENUM RATED AND TEFLON CABLE.

#### FIRE ALARM TEST INSPECTION FILING NOTES

THE CONTRACTOR IS REQUIRED TO SCHEDULE ALL INSPECTIONS WITH THE LOCAL FIRE CODE OFFICIAL FOR WESTCHESTER COUNTY IN ORDER TO OBTAIN THE FINAL LETTER OF APPROVAL FOR THE WORK PERFORMED AND SIGN-OFF THE BUILDING DEPARTMENT APPLICATION AS PART OF THE SCOPE OF THEIR SERVICES.

THE CONTRACTOR TO PREPARE AND PROVIDE THE AS-BUILT MATRIX, RISER DIAGRAM AND FUNCTIONALITY STATEMENT AND THE MATRIX, RISER DIAGRAM AND FUNCTIONALITY STATEMENTS IS TO BE SIGNED AND SEALED BY APPLICANT OF RECORD AFTER APPLICANT OF RECORD HAS VERIFIED "AS-BUILT" CONDITION OF FIRE ALARM SYSTEM.

THE CONTRACTOR IS TO ARRANGE (WITHIN ADEQUATE TIME PRIOR TO FIRE DEPARTMENT INSPECTIONS) TO A FIELD VISIT WITH THE APPLICANT OF OF RECORD TO VERIFY ALL DEVICES ARE INSTALLED AND OPERATIONAL. PROVIDE ALL REQUIRED FIELD LABOR TO LOCATE, UNCOVER, AND MAKE APPARENT, ALL DEVICES FOR APPLICANT OF RECORD.

IF THE FIRE DEPARTMENT OR BUILDING DEPARTMENT DEEMS A POST APPROVAL AMENDMENT IS REQUIRED FOR PROJECT SIGN OFF FIRE ALARM VENDOR IS TO SEND AUTOCAD DRAWINGS OF AS-BUILT RISER DIAGRAMS, AS-BUILT FLOOR PLANS. AND AS-BUILT SYSTEM FUNCTION MATRIX FOR ENGINEER TO INCLUDE IN POST APPROVAL AMENDMENT FILING DOCUMENTATION. POST APPROVAL AMENDMENT FILING COST AND RE-INSPECTION FEES TO BE PAID FOR UNDER THIS CONTRACT.

#### FIRE ALARM BASIS OF DESIGN

CONTACT BUILDING FIRE ALARM VENDOR JOHNSON CONTROLS. FOR ALL DEVICES AND PROGRAMMING: SHERRY PIESCO (845)774-4120. ALL PRODUCTS SHALL BE MANUFACTURED BY JCI/SIMPLEX GRINNELL. ALL WORK SHALL BE COORDINATED WITH BASE BUILDING FIRE ALARM SYSTEM VENDOR AND COORDINATED WITH ONGOING FIRE ALARM SYSTEM UPGRADES BEING PERFORMED IN THE BUILDING.

#### SURVIVABILITY

CLASS: B LEVEL: 2

#### GENERAL NOTES

COORDINATE FINAL LOCATION OF ALL DEVICES WITH ARCHITECTURAL DRAWINGS.


#### NFPA OPERATIONS MATRIX

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#### **PARTIAL SEQUENCE OF OPERATION**

## DRAWING-ISSUE LIST

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eet #	Latest DOB Rev. #	Sheet Title	2022.08.31 100% SUBMISSION	2023.02.15 RESPONSE TO MESCHESTER COMMENTS	2023.08.04 RESPONSE TO WESCHESTER COUNTY COMMENTS	2023.11.01 RESPONSE TO WESCHESTER COUNTY COMMENTS	
-010	.00	FIRE ALARM SYMBOLS, ABBREVIATIONS SCHEDULES AND NOTES	×	×	×	×	
-102	.00	FIRE ALARM PLAN - 1ST FLOOR CENTRAL WING	×	×	×	×	
-104	.00	FIRE ALARM PLAN - 2ND FLOOR CENTRAL WING	×	×	×	×	
-105	.00	FIRE ALARM PLAN - 2ND FLOOR NORTH WING	X	×	×	X	
-130	.00	FIRE ALARM PLAN - BASEMENT L3 CENTRAL WING ELEVATOR	X	X	×	×	
-131	.00	FIRE ALARM PLAN - ROOF PLAN - 110 MLK BLVD	X	×	×	×	
-135	.00	FIRE ALARM PLAN - COURT HOUSE ROOF PLAN - 111 MLK BLVD	×	×	×	×	
-137	.00	FIRE ALARM PLAN - 143 GRAND STREET BASEMENT	X	X	×	×	
-138	.00	FIRE ALARM PLAN - 143 GRAND STREET 3RD FLOOR AND LOW ROOF	×	X	X	X	



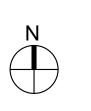

FIRE	ALARM ABBREVIATIONS
ABBREV.	DESCRIPTION
ABBREV. A AC ADJF G ALDC'S O C C C C C C C C C C C C C C C C C C	AUDIBLE BASE AIR CONDITIONING ADJACENT ABOVE FINISHED FLOOR ABOVE FINISHED GRADE AUTOMATIC LOUVER DAMPER ARCHITECTURAL AUXILIARY RADIO COMMUNICATION SYSTEM AUTOMATIC BUILDING BUILDING MANAGEMENT SYSTEM BOOSTER POWER SUPPLY CONDUIT CABINET CANDELA CIRCUIT INTEGRITY CONTROL MODULE CARBON MONOXIDE CONCRETE CARBON MONOXIDE / HEAT CARBON MONOXIDE / SMOKE DOOR HOLDER DATA GATHERING PANEL DETAIL DATA GATHERING PANEL DETAIL DATA GATHERING PANEL DETAIL DETAIL DRAWING EACH EMPTY CONDUIT ELECTRICAL ELEVATOR RECALL EXISTING FLOOR FIRE ALARM CONTROL PANEL FIRE COMMAND STATION FAN SHUTDOWN FEET FUSED GROUND HEAT HEATING, VENTILATING & AIR CONDITIONING JUNCTION BOX MONITOR MODULE NOT IN CONTRACT PULL BOX PLUMBING PANEL RETURN DUCT (FOR DUCT SMOKE DETECTORS) SPRINKLER SMOKE PURGE PANEL SECURITY TIE-IN RELAY TYPICAL UNLESS OTHERWISE NOTED WITH GUARD

ΓA	WIRING	TYPES	


LTR	DESCRIPTION	TYPE
А	DLC CIRCUIT	16ga UTP
В	NAC CIRCUIT (VISUAL & AUDIO)	14ga UTP
С	SPEAKER CIRCUIT	14ga UTP
D	TELEPHONE CIRCUIT	16ga UTP
Е	FMT RISER	16ga STP
F	NETWORK	18ga UTP
G	CONVENTIONAL ZONE OR TRI-S/D	16ga UTP
н	CONTROL CKT (RELAY OUTPUT)	14ga UTP
J	24Vdc POWER	14ga UTP
к	120Vac POWER	2–10ga 1–10ga gnd.
L	PRINTER	RS-485
	CABLE EXAMPLE: 	RES


	FIRE ALARM SYMBOLS	
SYMBOL	DESCRIPTION	MOUNTING UNLESS INDICATED OTHERWISE
FACP	FIRE ALARM CONTROL PANEL	WALL
FWS	FIRE WARDEN STATION	WALL
Ρ	FIRE PULL STATION	WALL
	SPEAKER WITH STROBE LIGHT	WALL
Ē	STROBE LIGHT ONLY	WALL
BOO	ALERT STROBE LIGHT AND SPEAKER	WALL
ÞX	ALERT STROBE LIGHT ONLY	WALL
S	SMOKE DETECTOR	CEILING
(S) _{AC}	SMOKE DETECTOR MOUNTED ABOVE DROP CEILING	CEILING
$\bigcirc$	CARBON MONOXIDE DETECTOR	CEILING
(H) (H)	HEAT DETECTOR	CEILING
603	COMBINATION SMOKE/CARBON MONOXIDE DETECTOR	CEILING
TS	RELAY FOR TAMPER SWITCH (PROVIDED BY SPRINKLER CONTRACTOR)	
FS	RELAY FOR FLOW SWITCH (PROVIDED BY SPRINKLER CONTRACTOR)	
$\bigcirc$	DUCT MOUNTED SMOKE DETECTOR.	
<b>N</b> -0	RELAY FOR MOTORIZED COMBINATION FIRE AND SMOKE DAMPER	
$\nabla$	DATA OUTLET	
	RELAY MODULE (SEE ABBREVIATION LIST FOR TYPE)	
SI	SINGLE INPUT MODULE	
	ARROW INDICATES # OF CIRCUITS	
	MOTORIZED COMBINATION FIRE & SMOKE DAMPER CONNECTED TO DUCT SMOKE DETECTOR THRU RELAY MODULE	
	INDICATES EXISTING DEVICE / EQUIPMENT	
Ē	INDICATES EXISTING DEVICE / EQUIPMENT TO BE REMOVED	
	INDICATES EXISTING DEVICE / EQUIPMENT TO BE RELOCATED	
	DISCONNECT SWITCH INDICATES SWITCH SIZE (AMPS) INDICATES FUSE SIZE OR UNFUSED (U) SPECIAL (W.P., ETC.) NO. OF POLES	WALL

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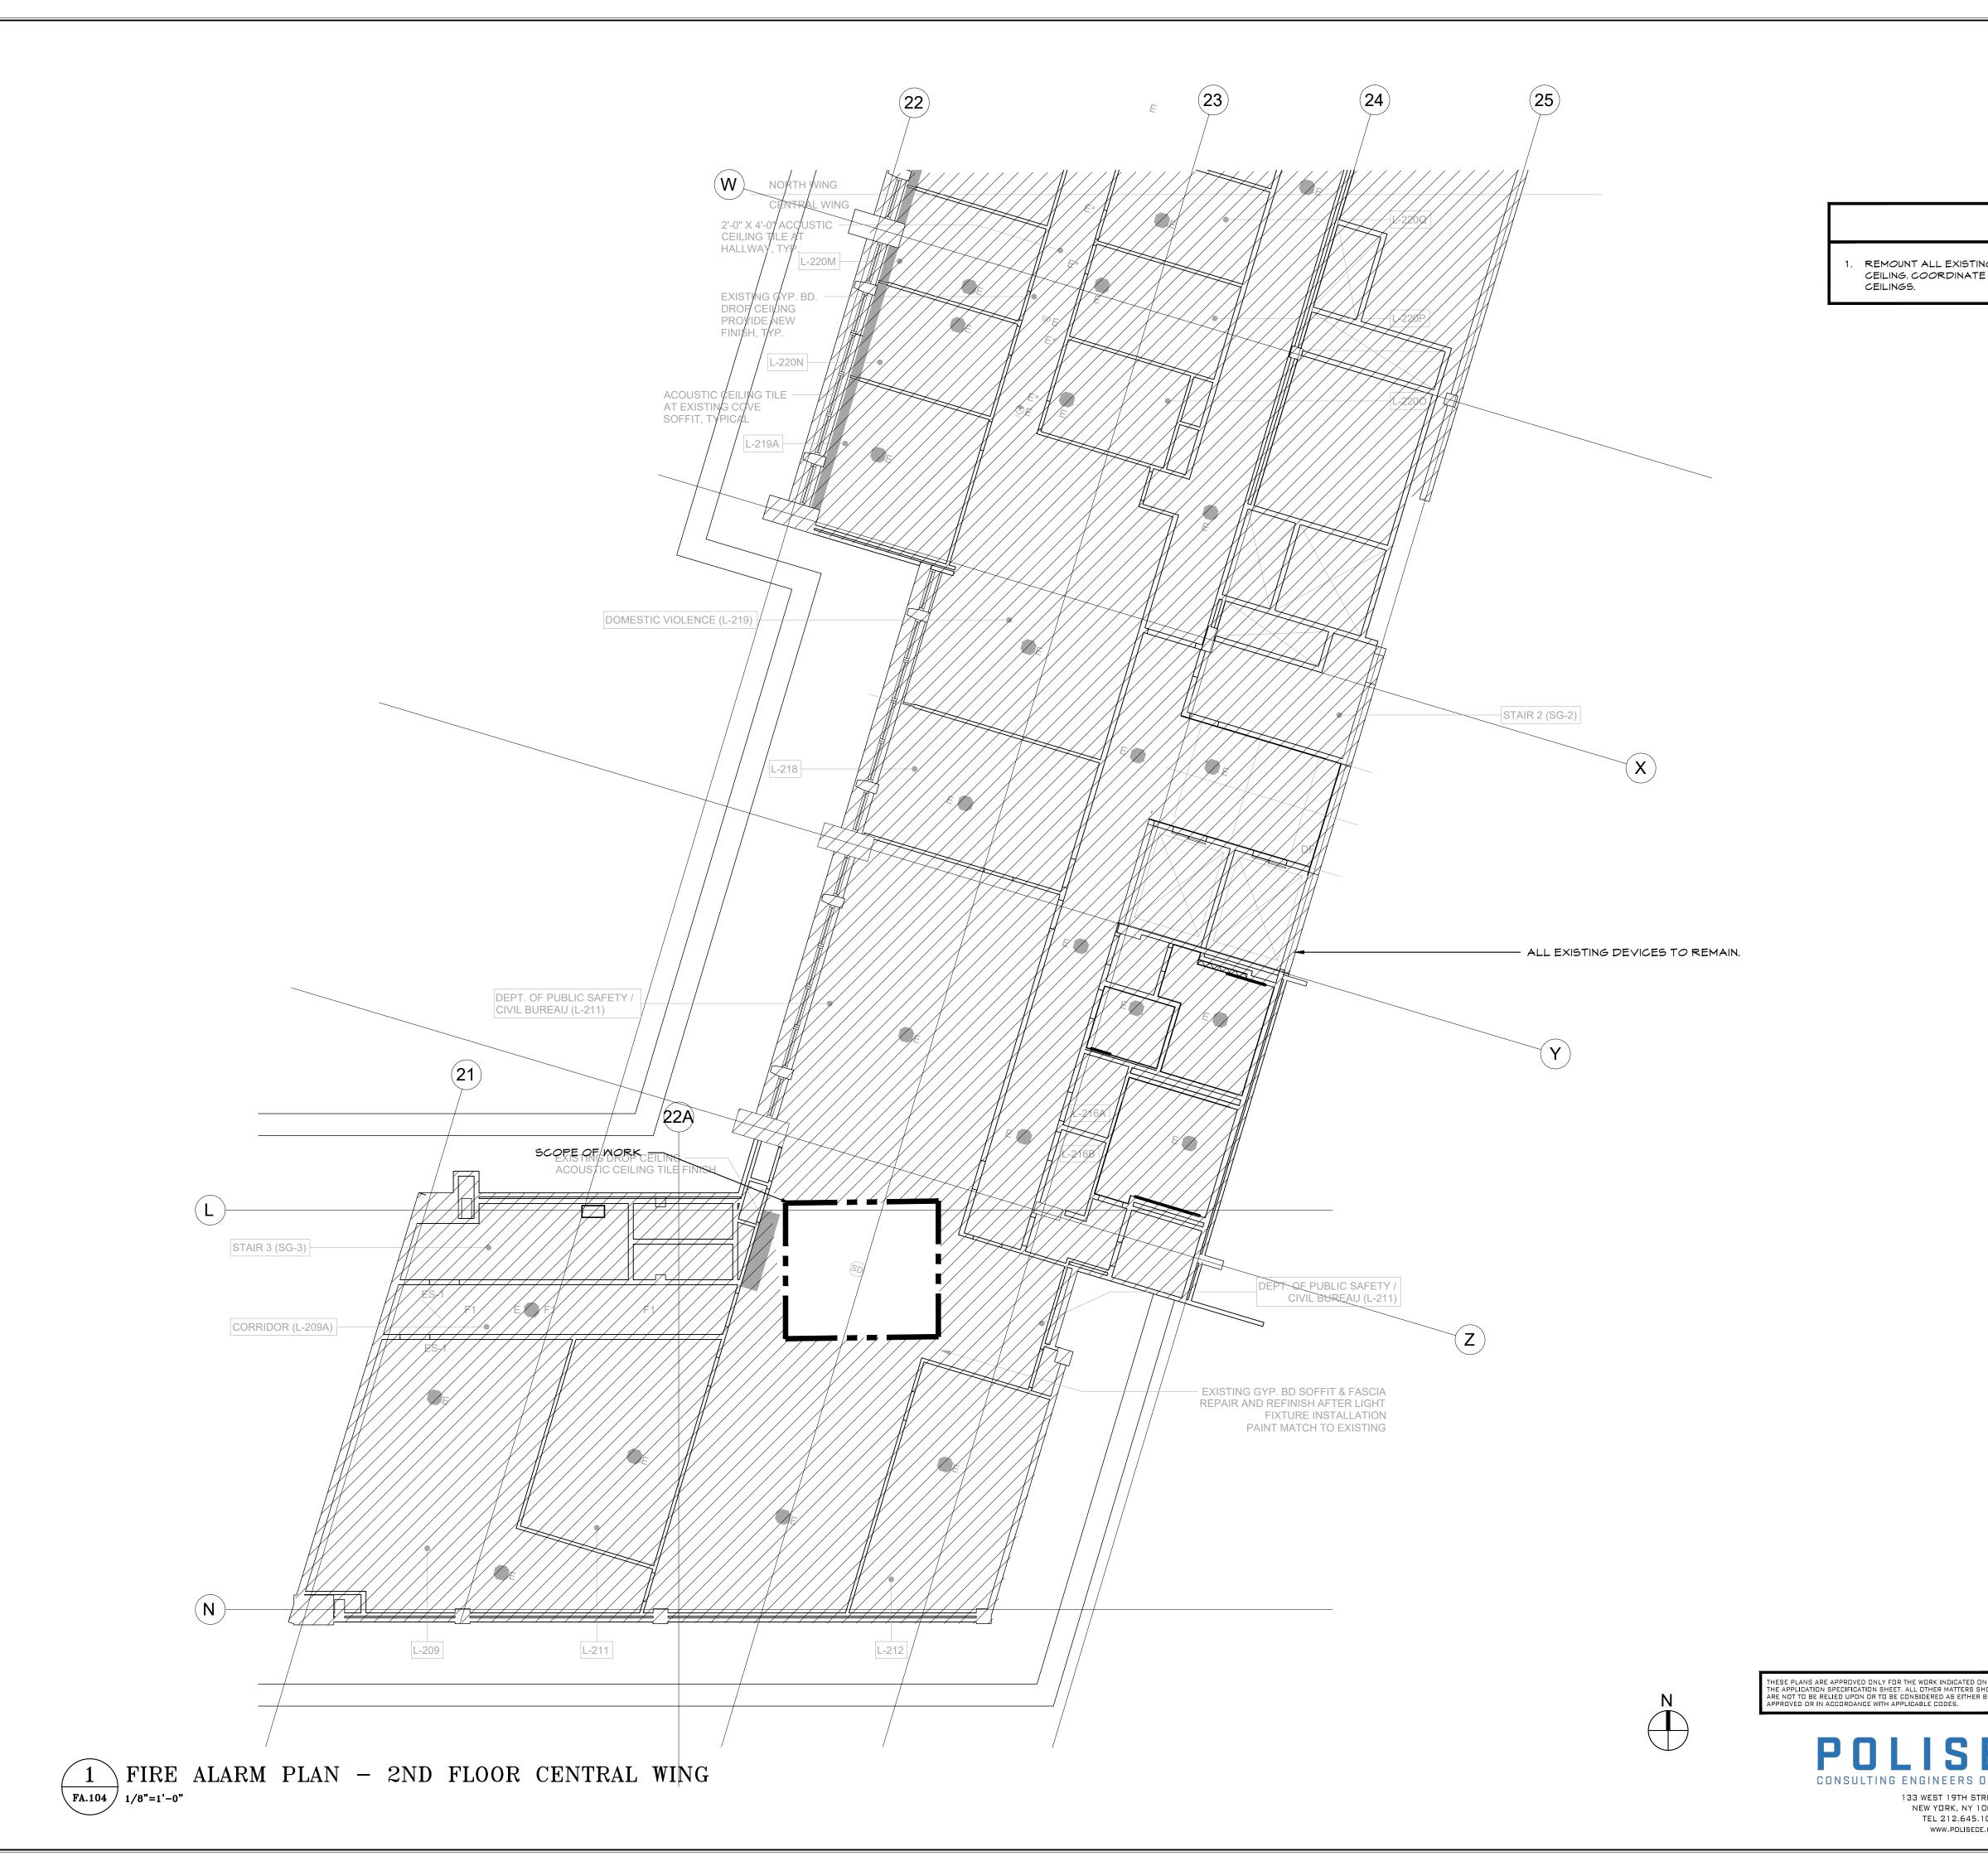
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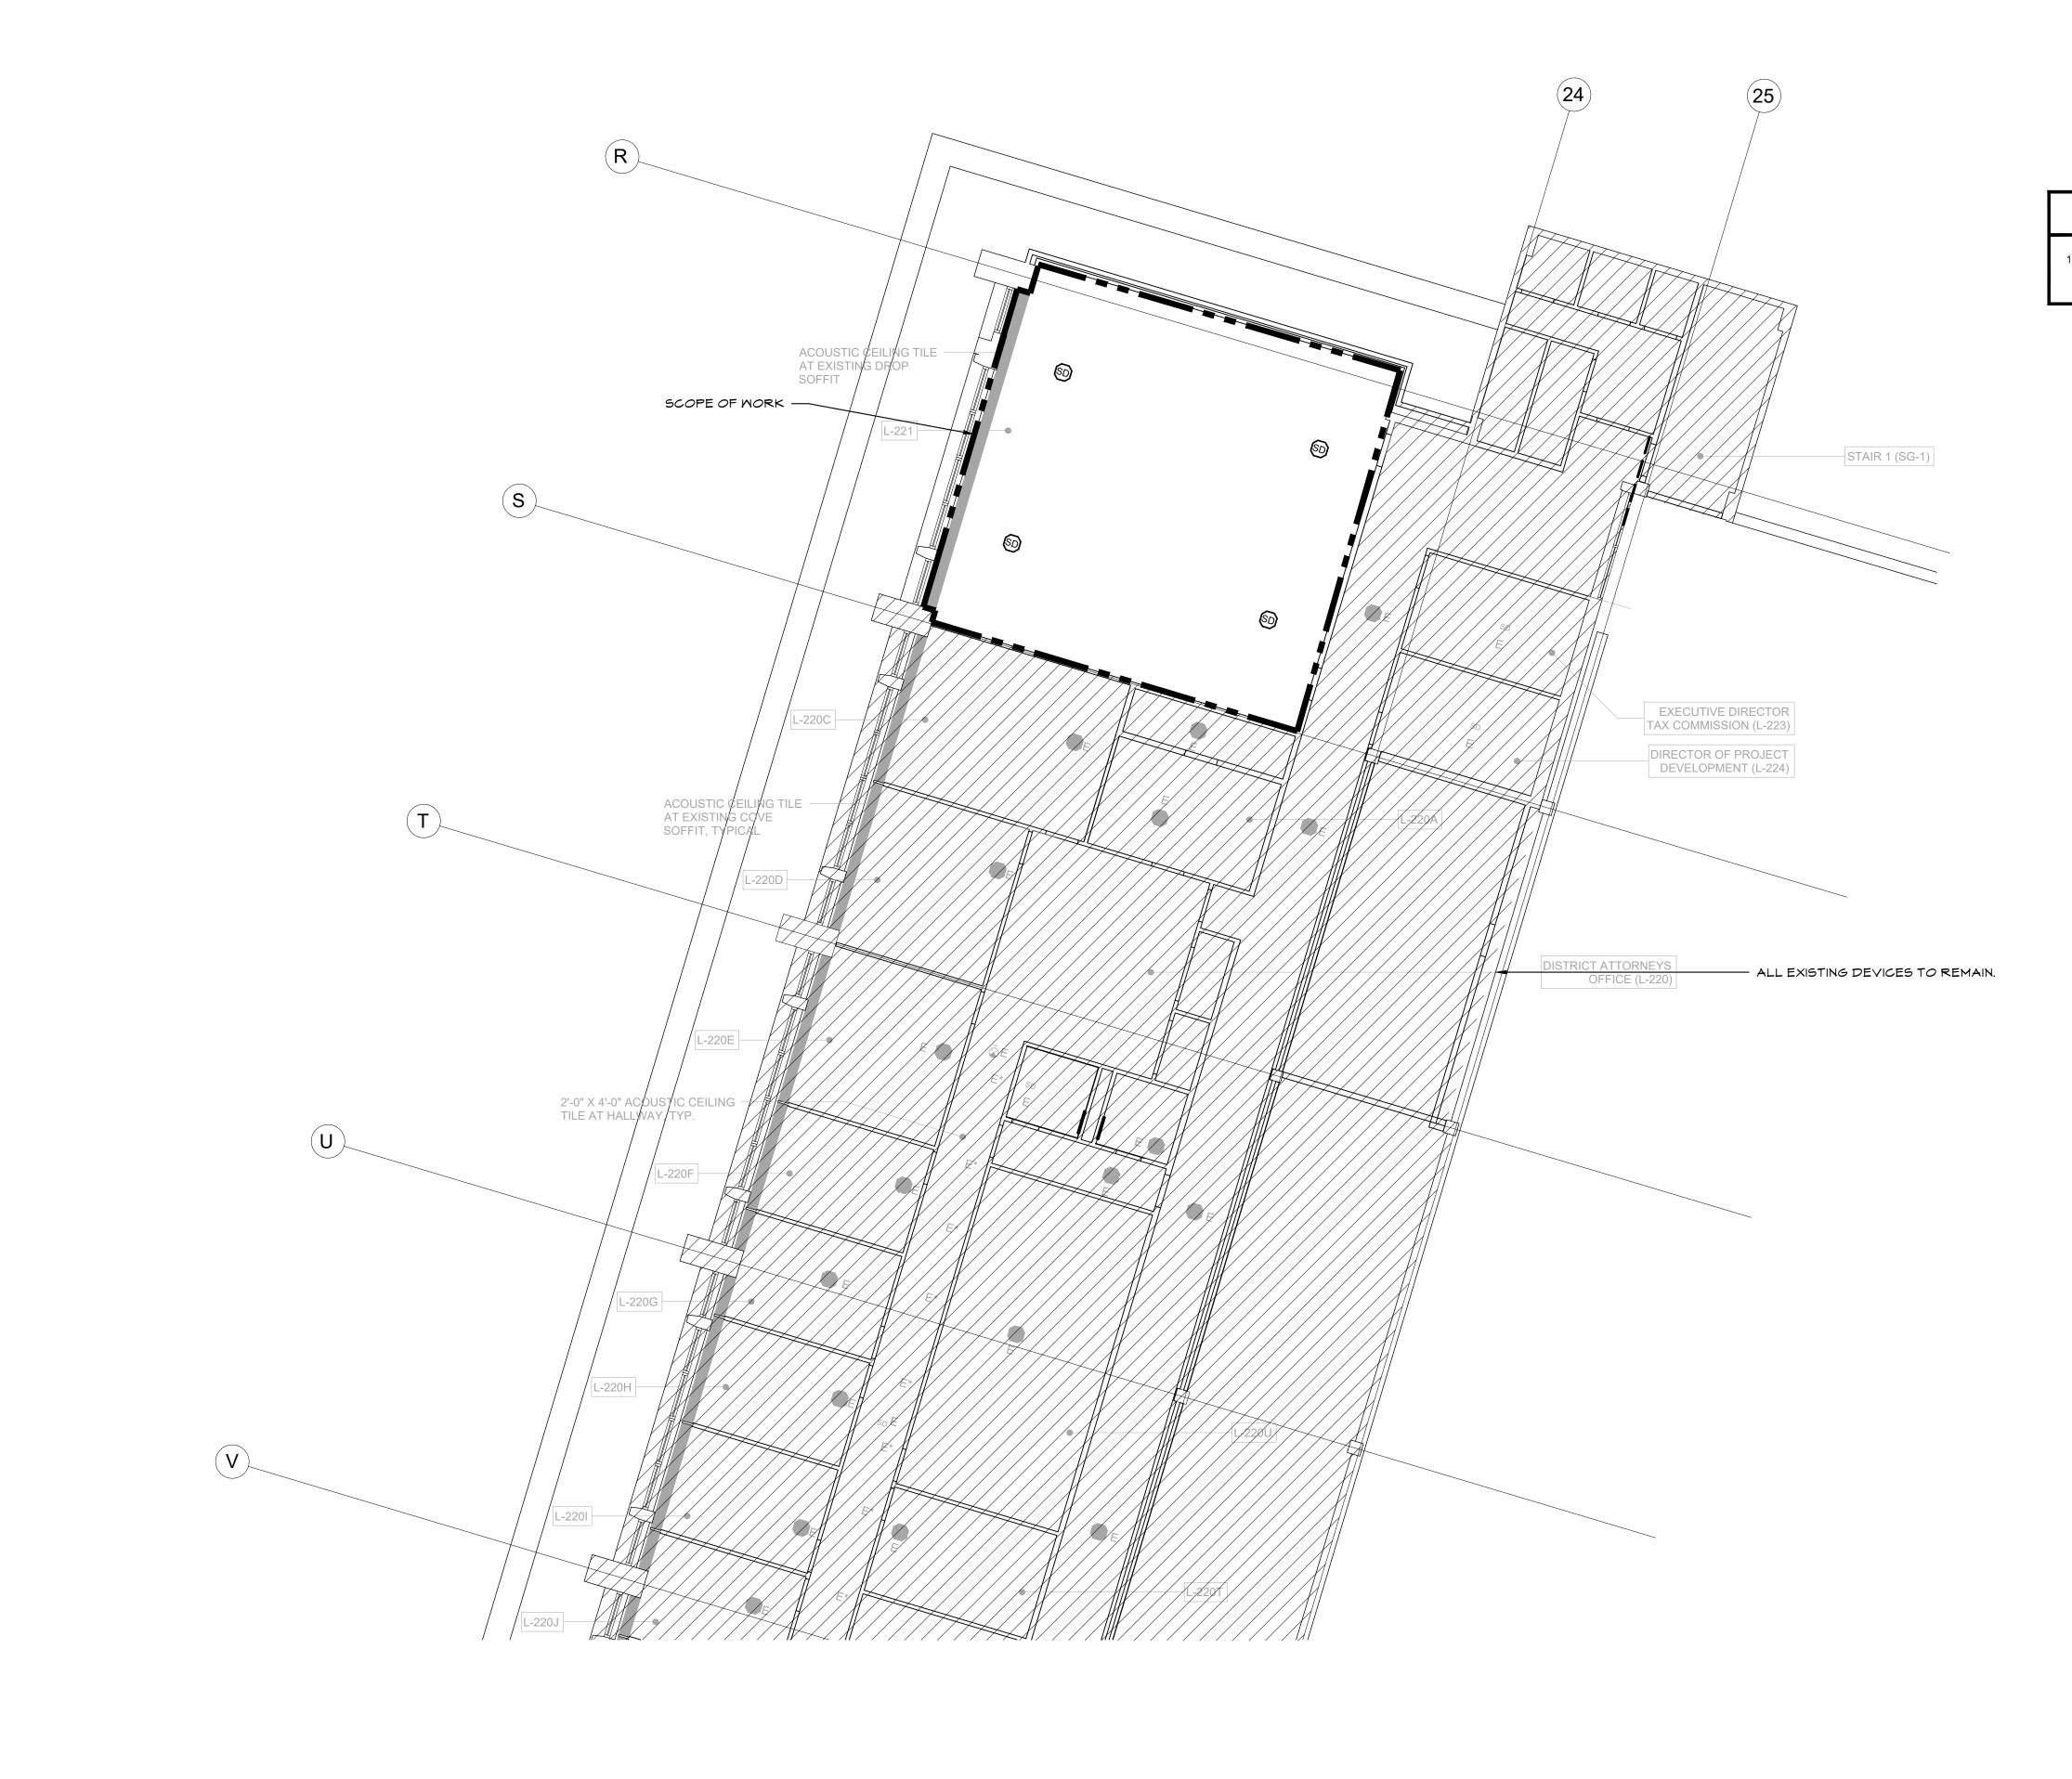



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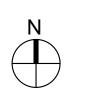


 REMOUNT ALL EXISTING SMOKE DETECTORS WITHIN SAME LOCATION OF NEW CEILING. COORDINATE FINAL LOCATION WITH INFIELD CONDITIONS OF NEW CEILINGS.
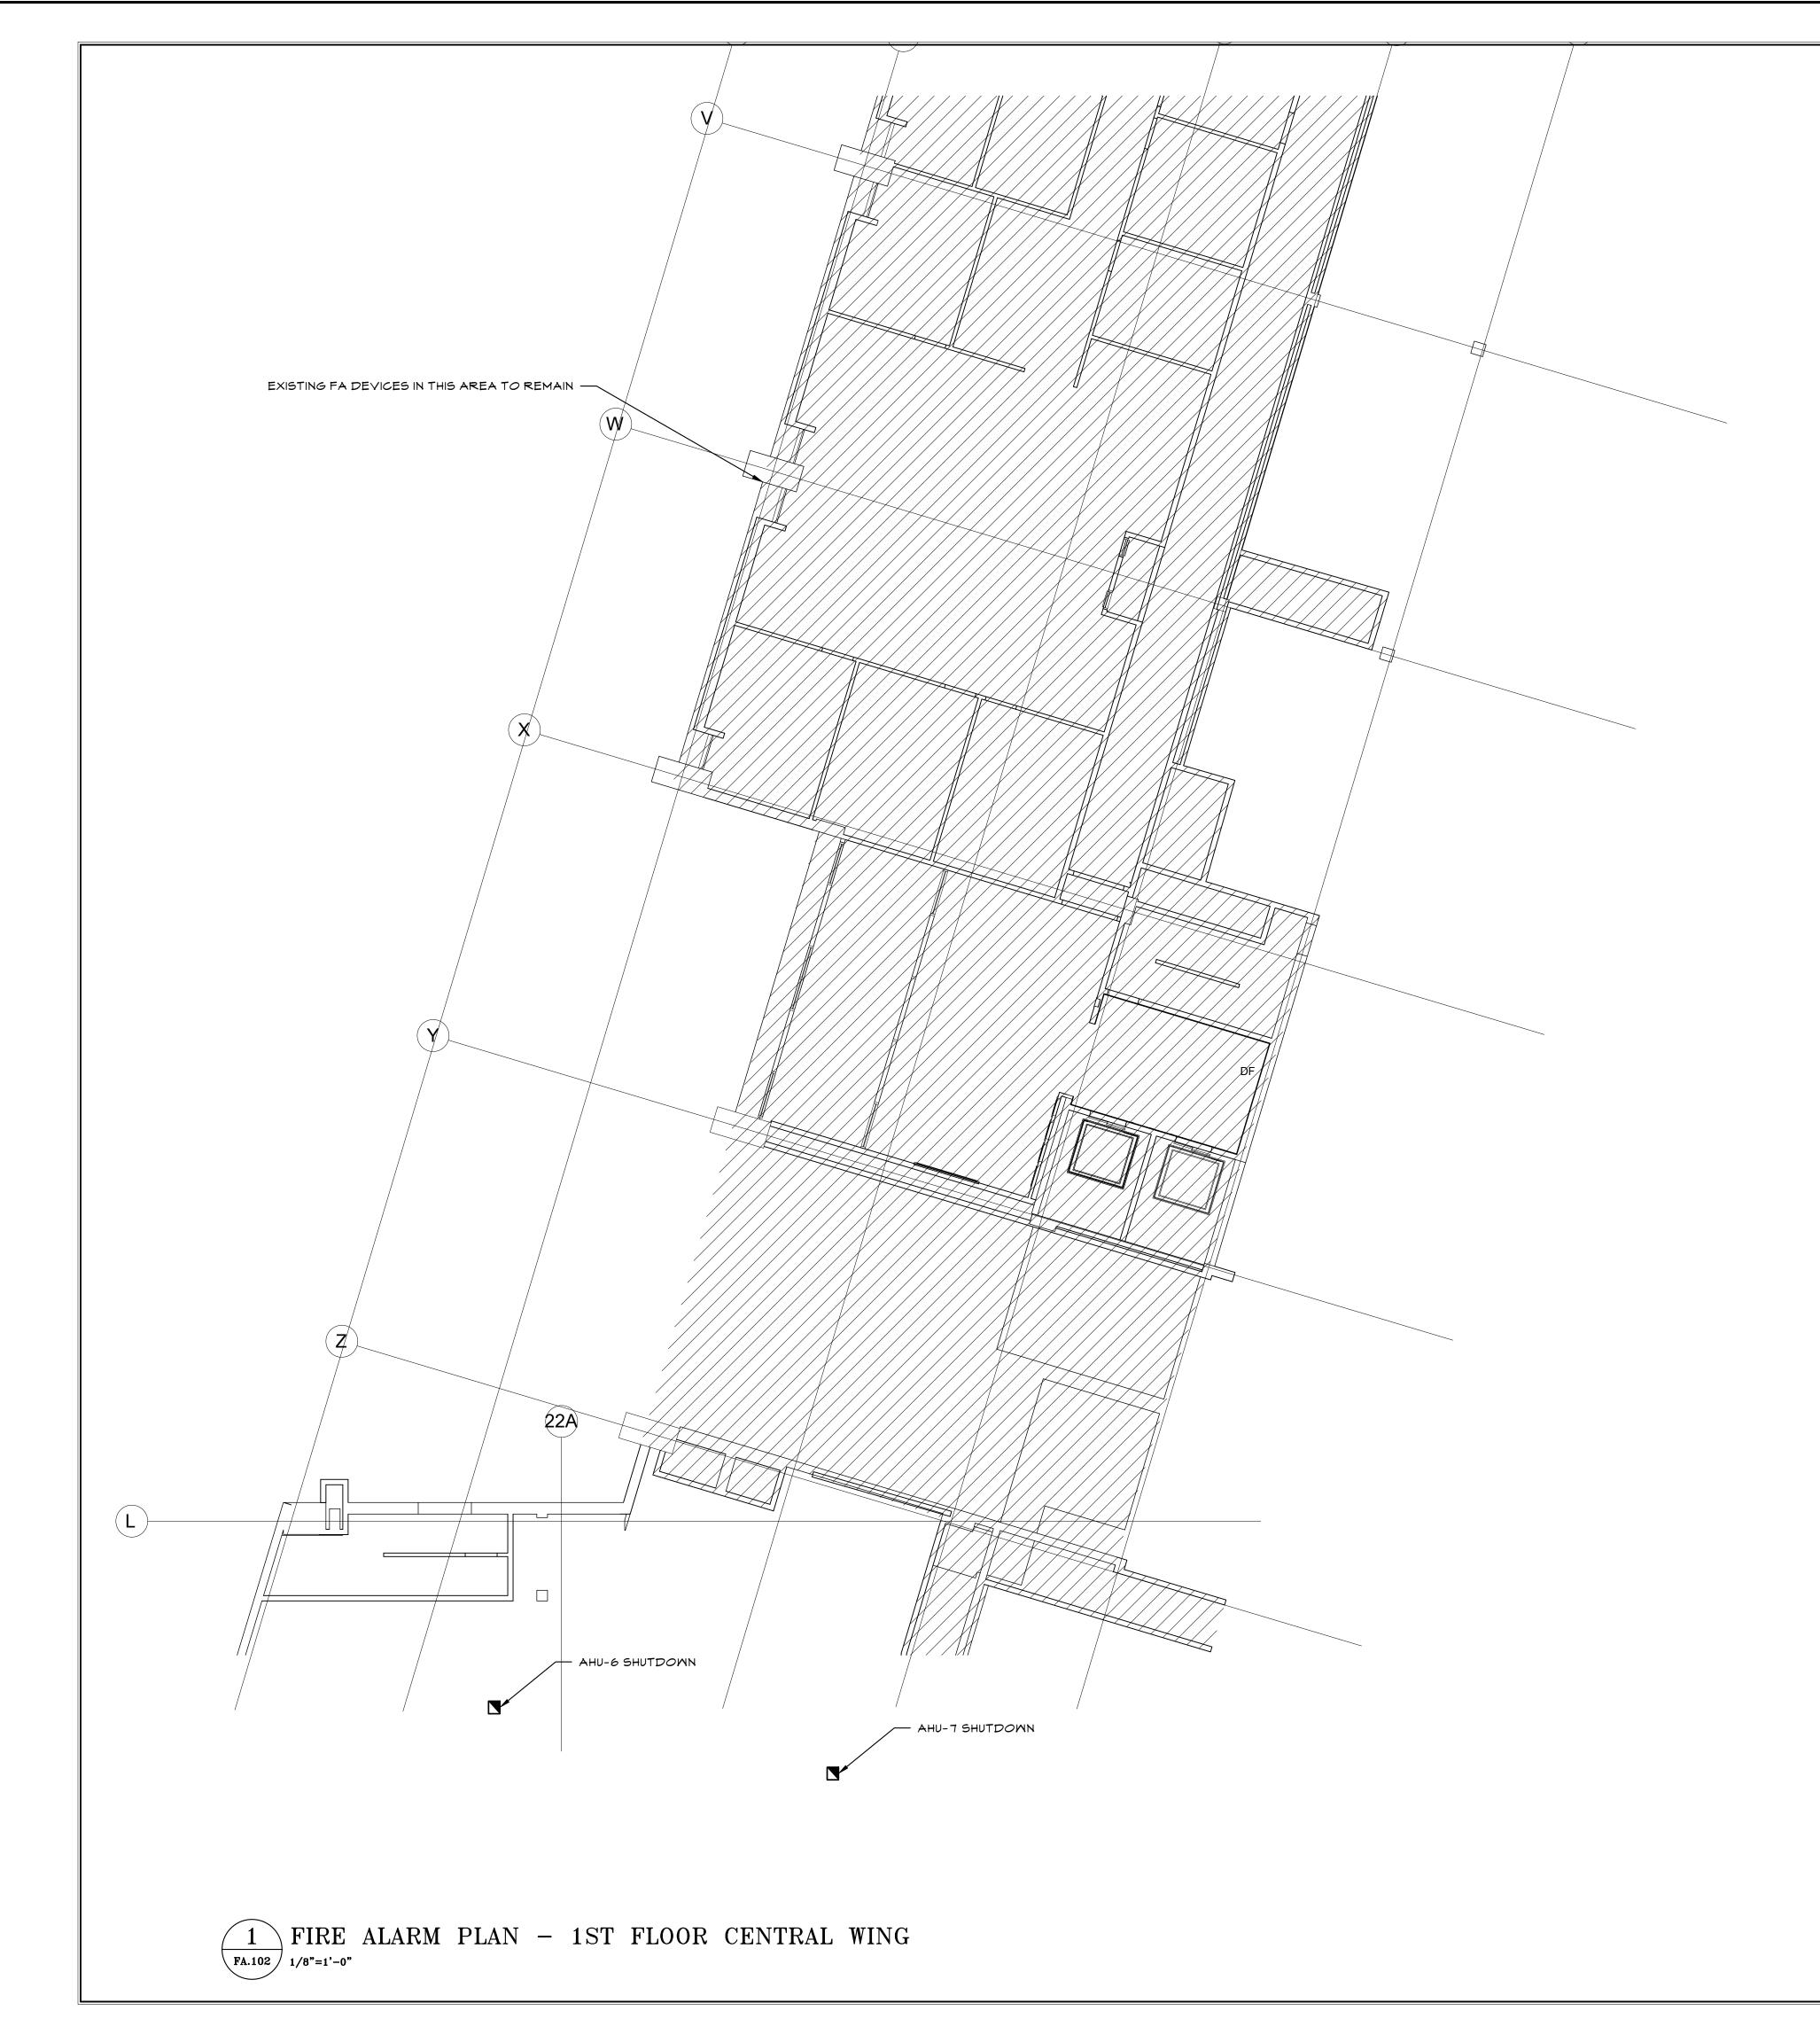
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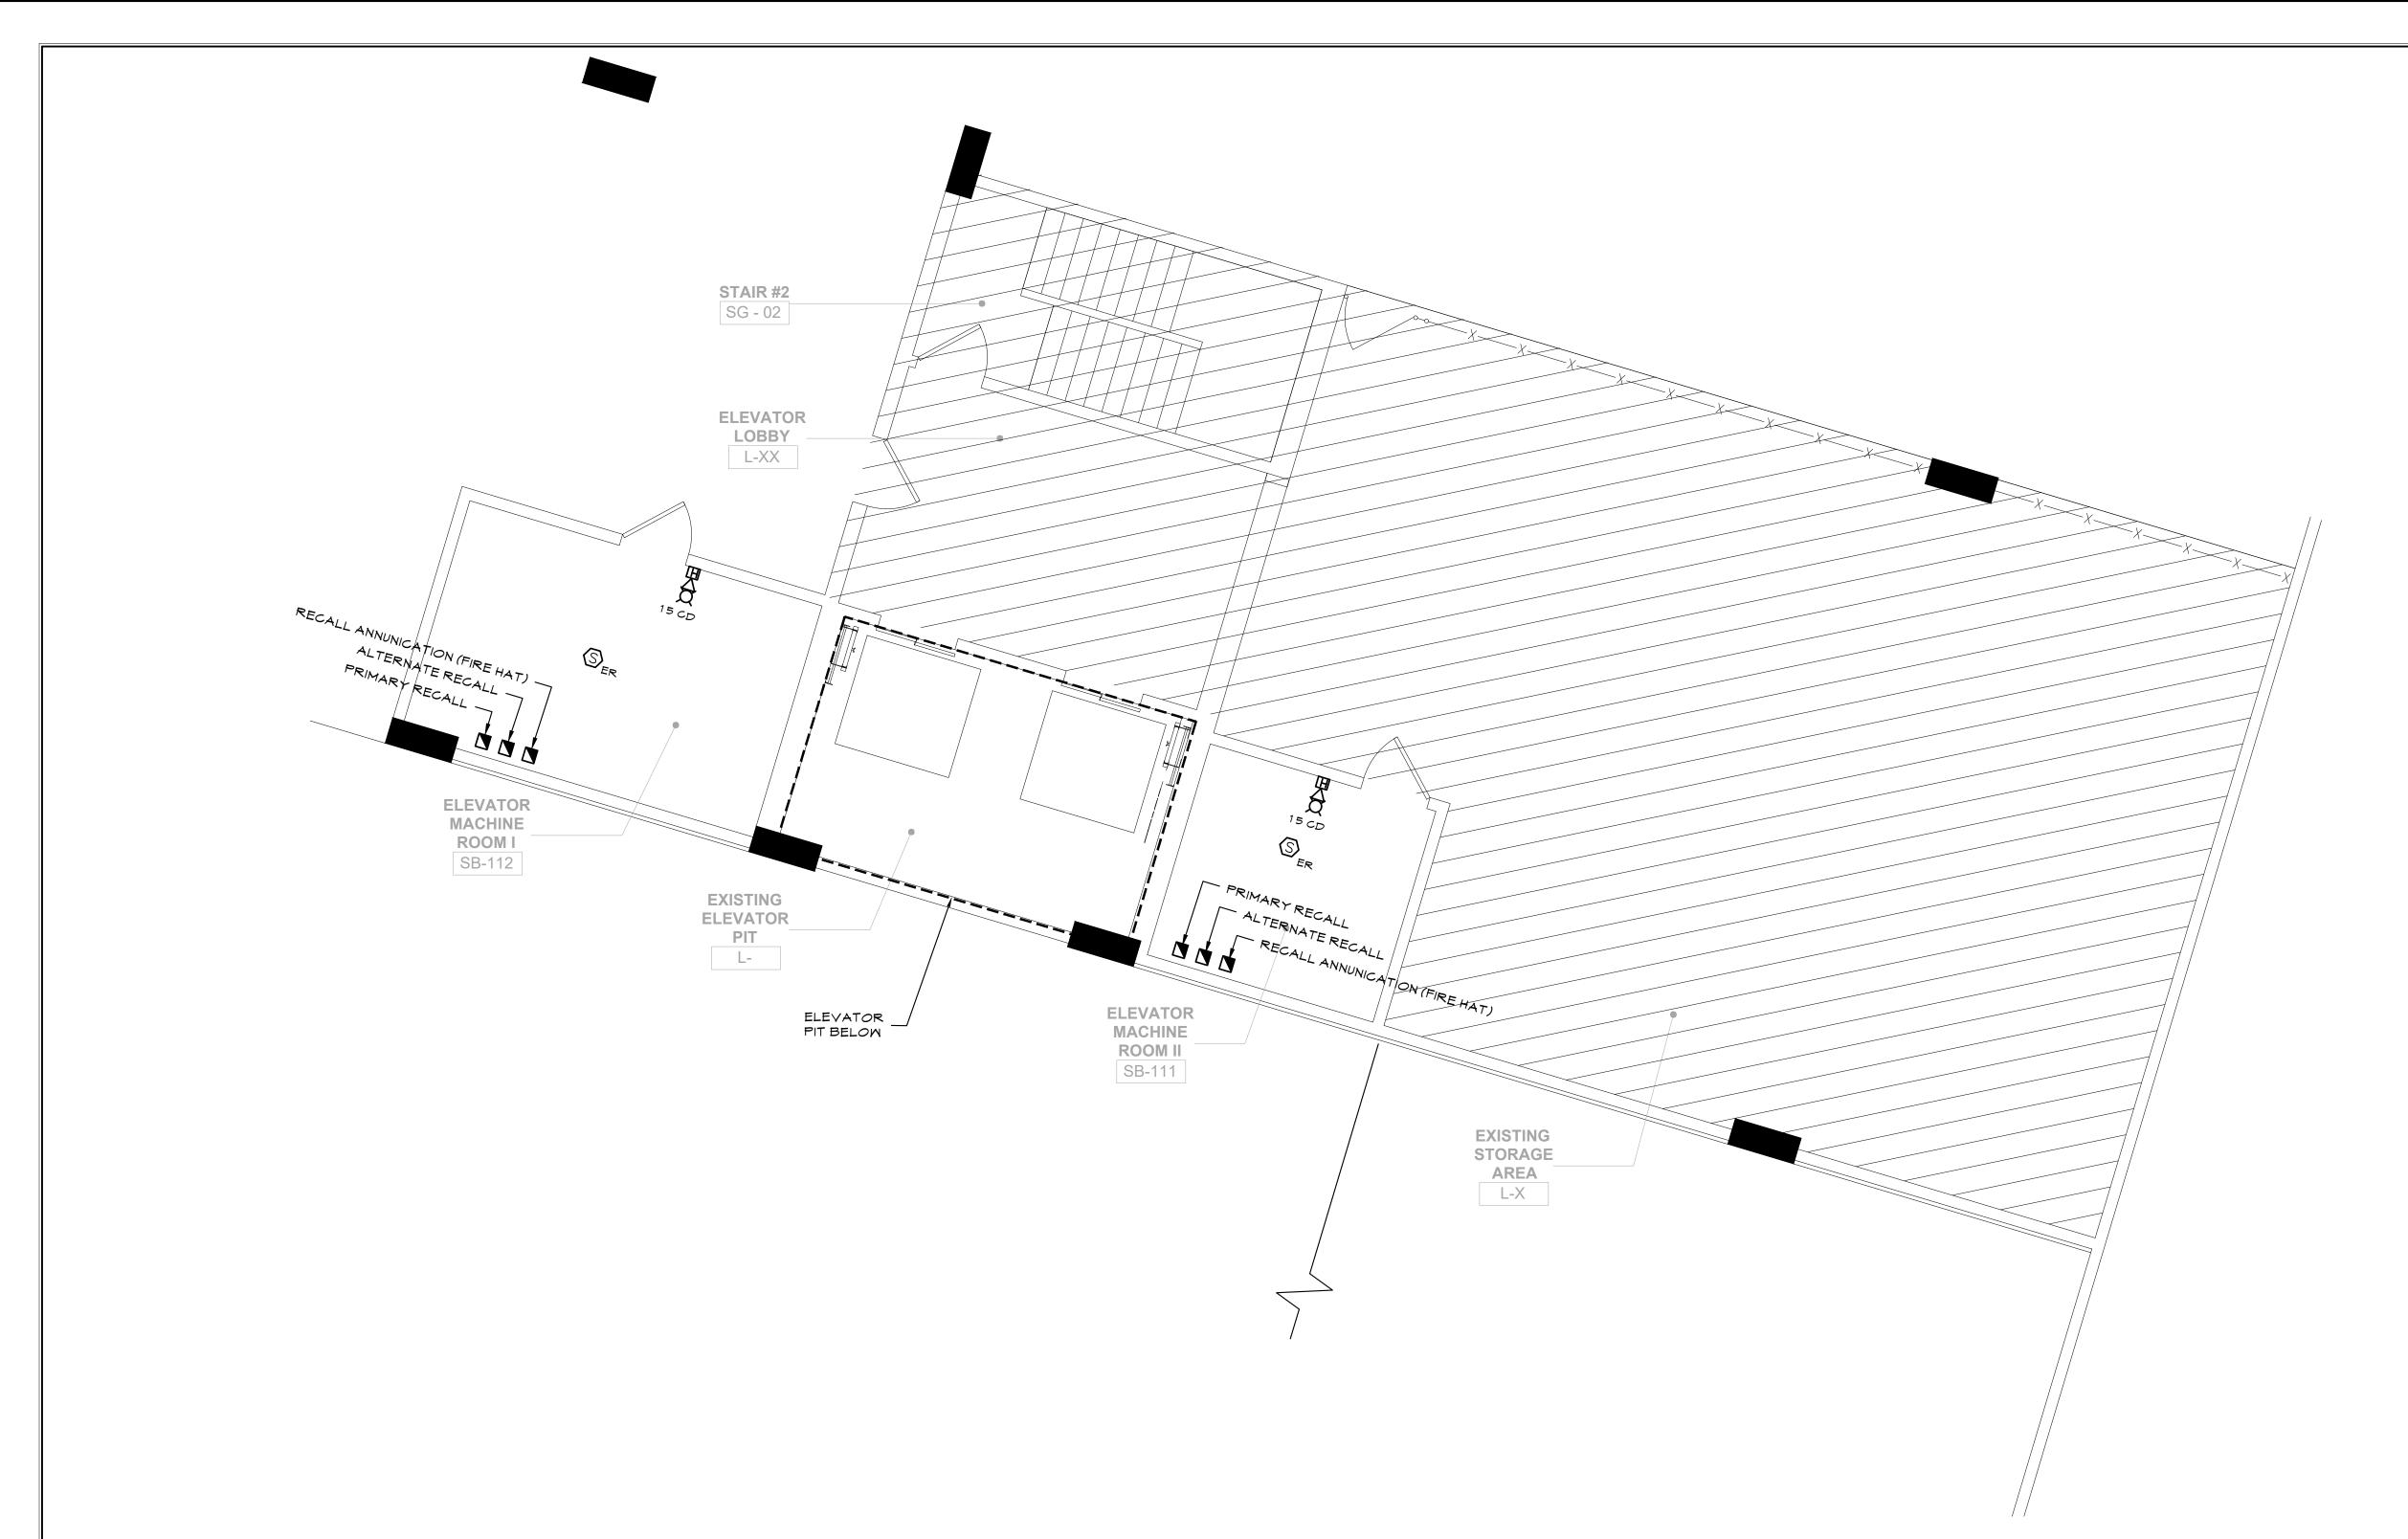


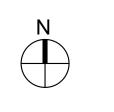

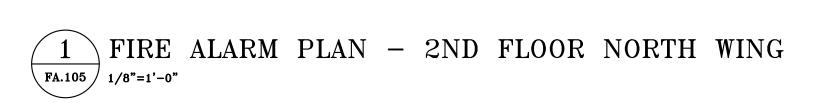


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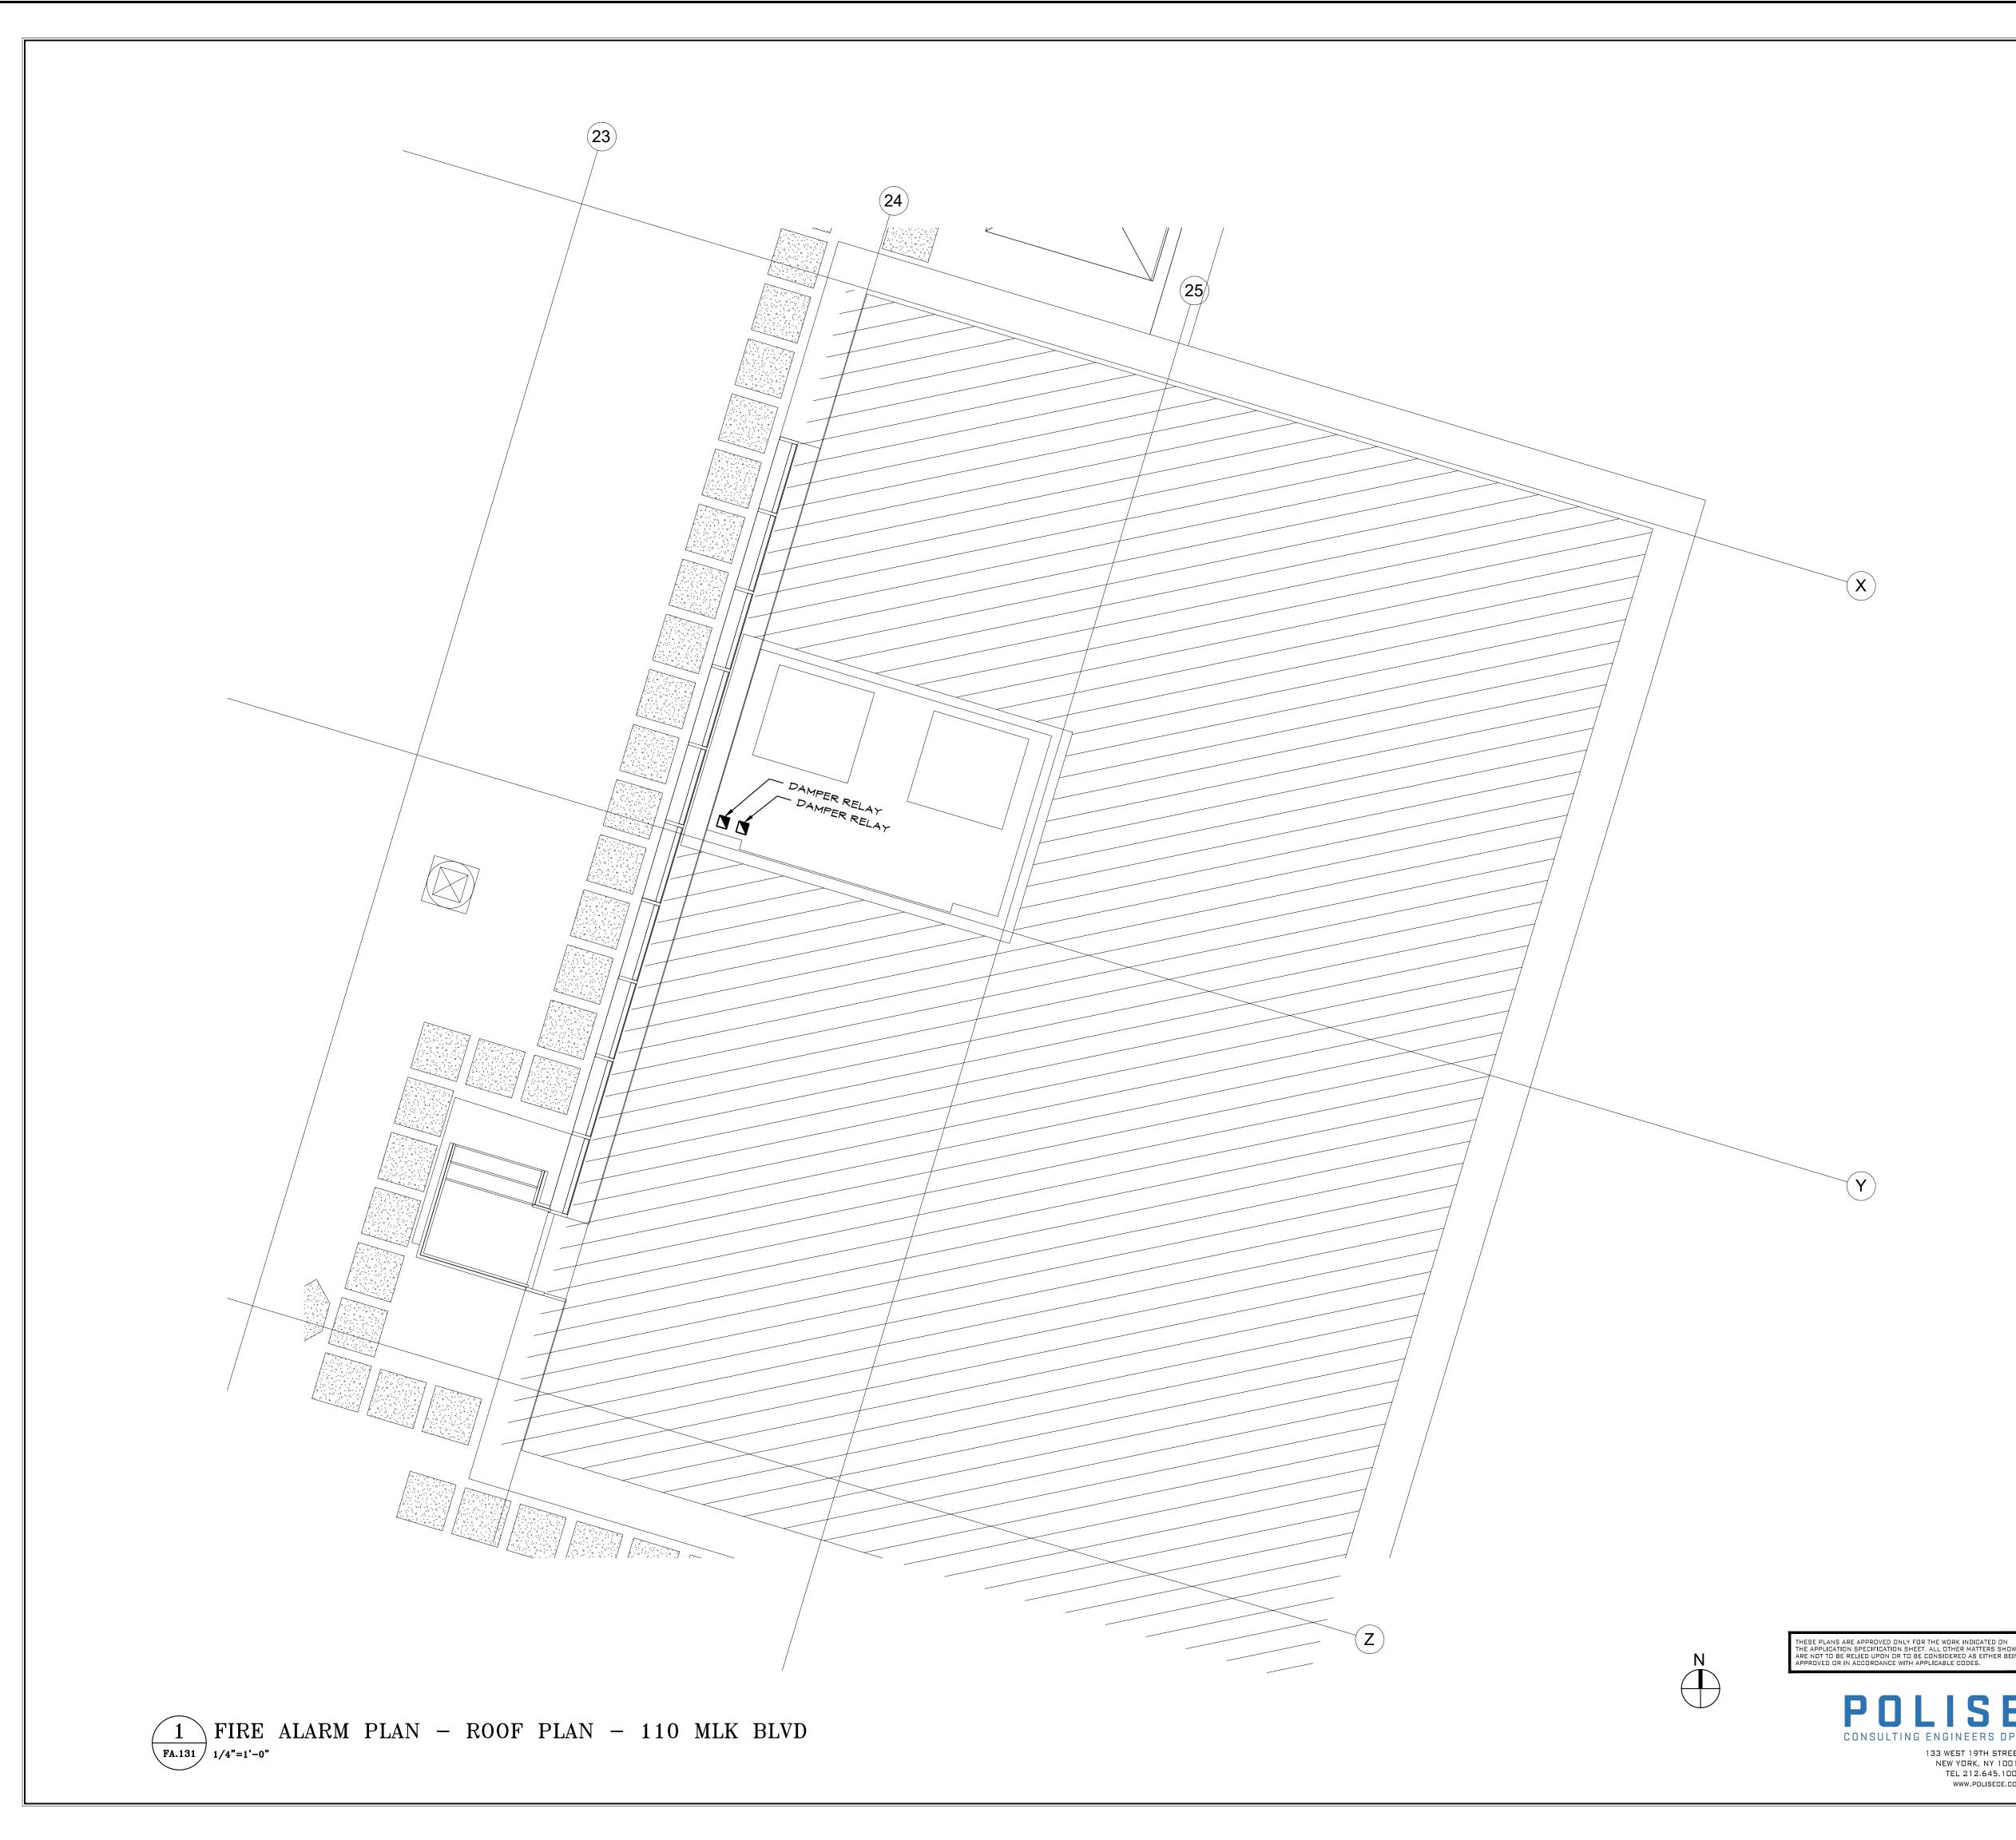







NEW FIRE ALARM DEVICES SHALL BE CONNECTED TO EXISTING FIRE ALARM SYSTEM INITIATING DEVICE CIRCUITS.

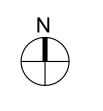
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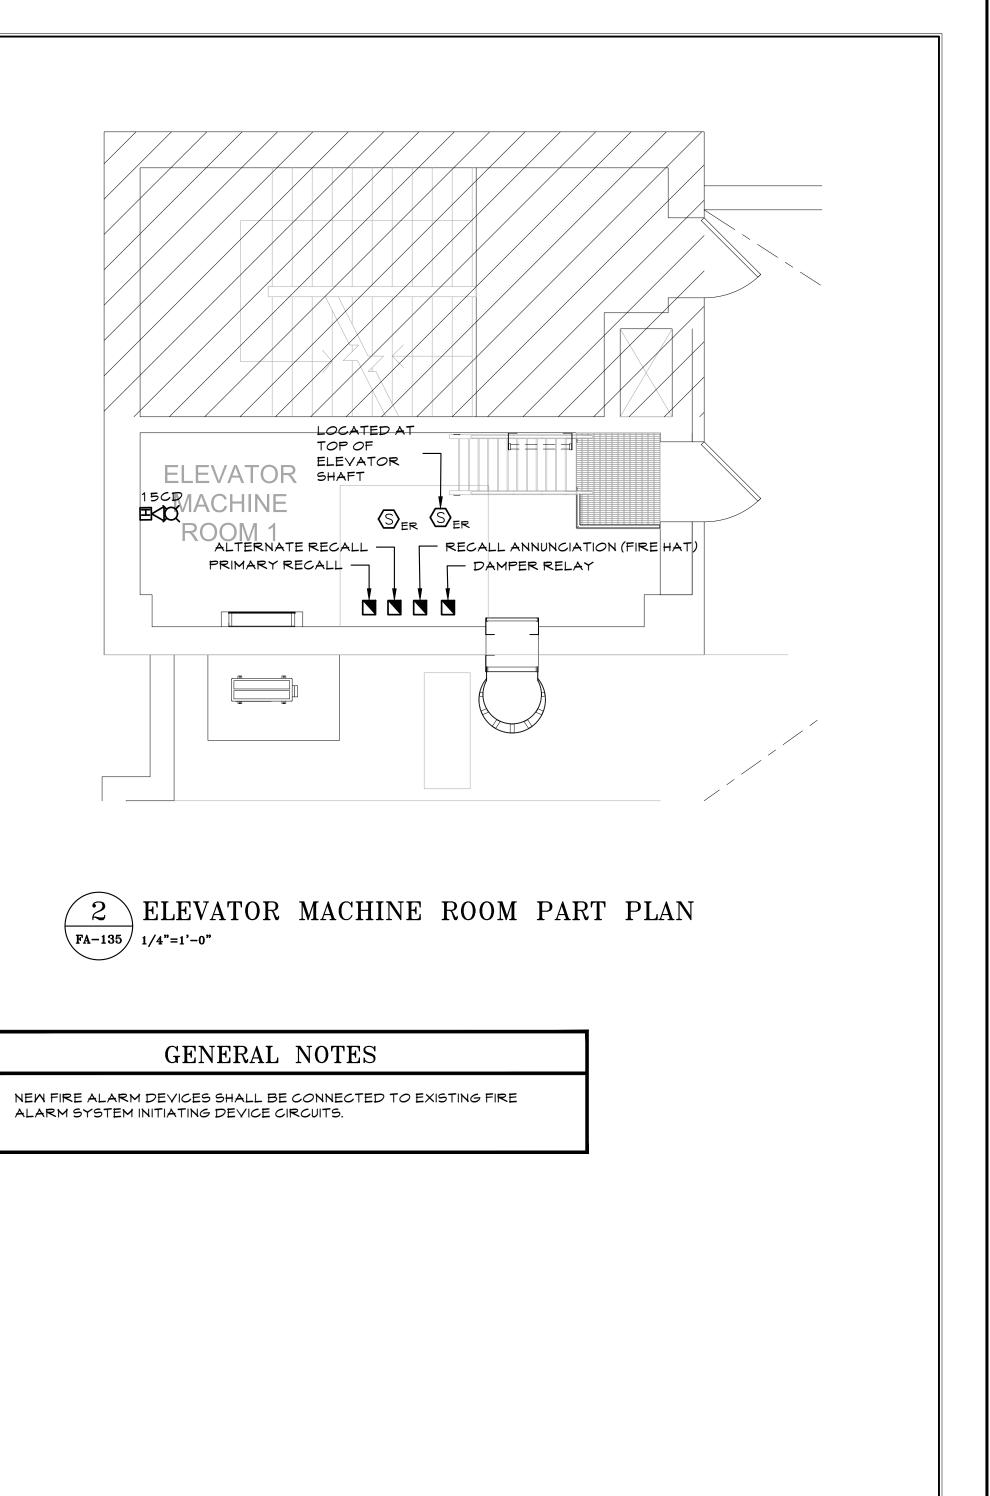
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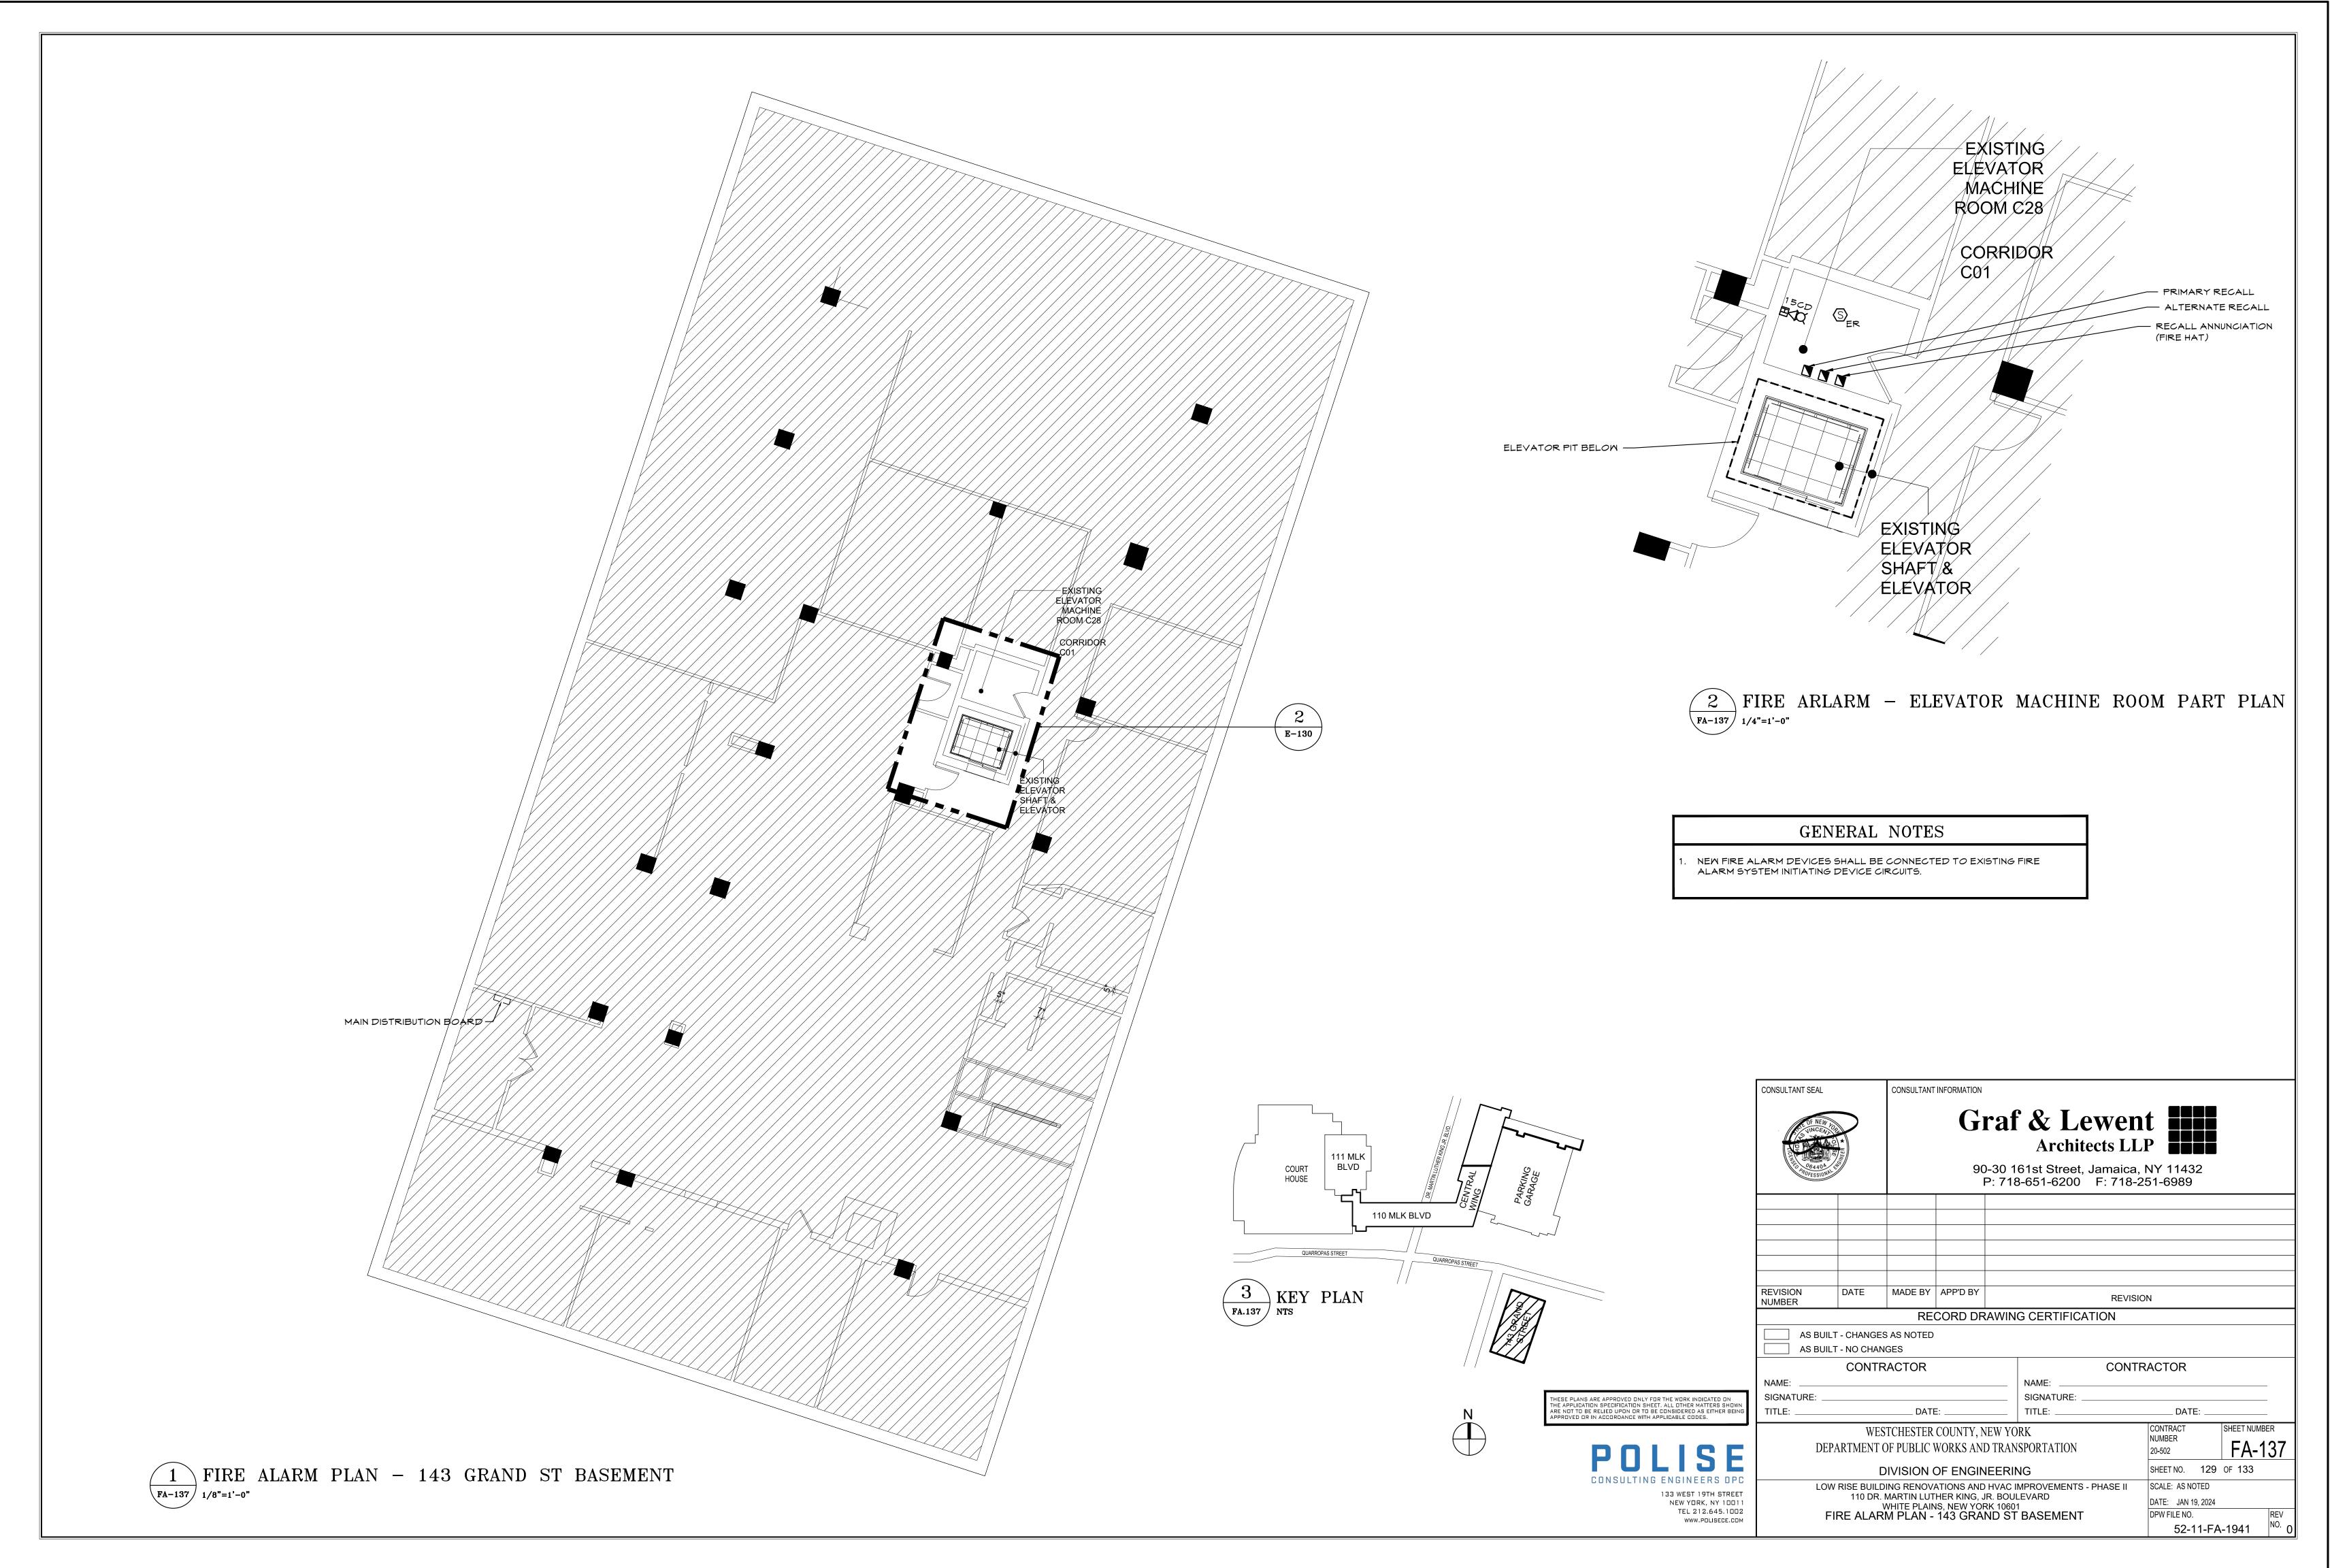






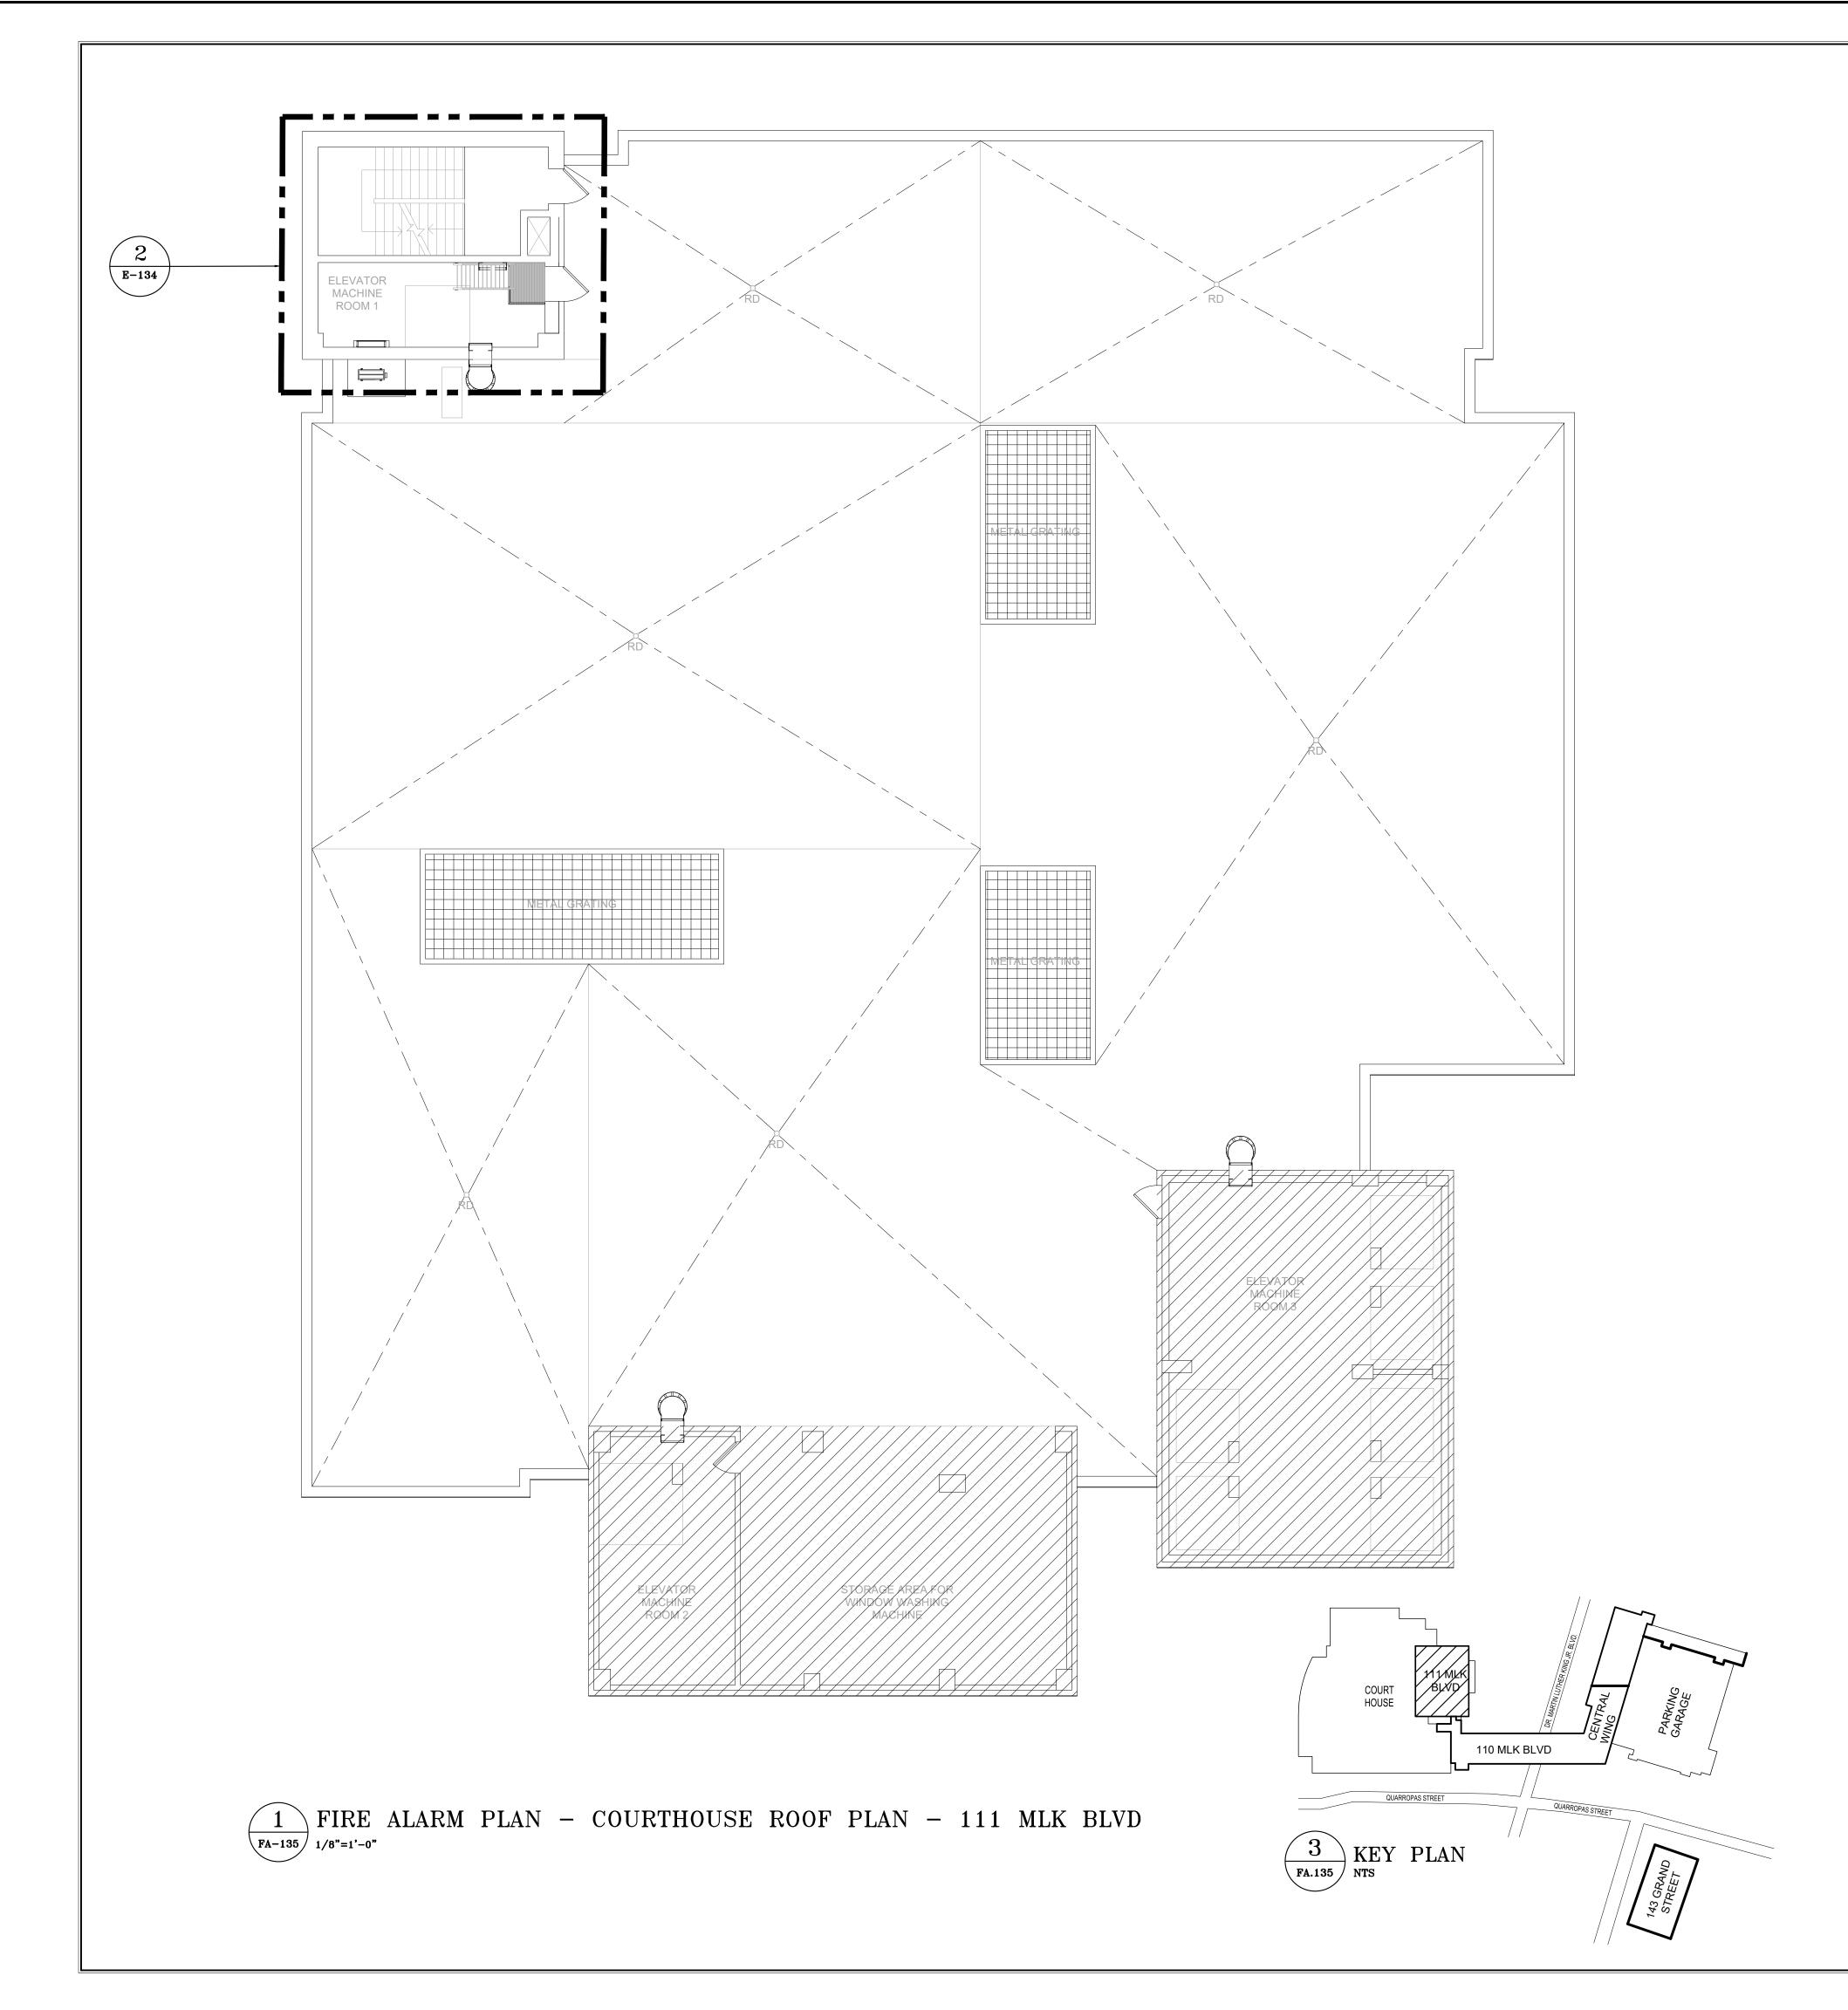

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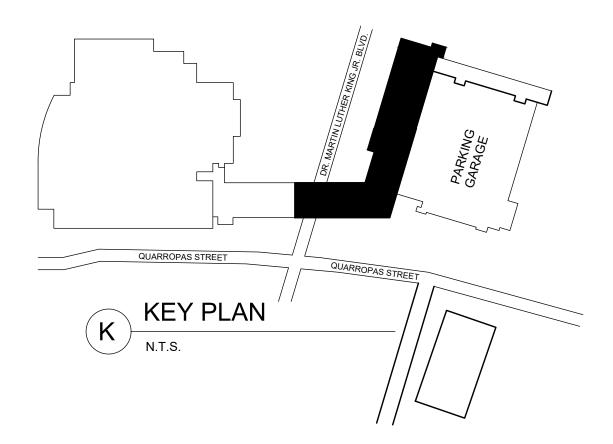


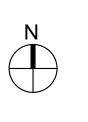



 NEW FIRE ALARM DEVICES SHALL BE CONNECTED TO EXISTING FIRE ALARM SYSTEM INITIATING DEVICE CIRCUITS.

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#### WORK PROCEDURES FOR REMOVAL OF ASBESTOS-CONTAINING FLOOR TILES & MASTIC AND COVE BASE & MASTIC

- REFER TO THE ARCHITECTURAL DRAWINGS FOR THE PHASING OF THE WORK. THESE DRAWINGS ARE DIAGRAMMATIC FOR THE SOLE PURPOSE OF INDICATING ACM TO BE REMOVED. COORDINATE WITH THE OWNER THE LOCATION OF EMERGENCY EXITS, NEGATIVE AIR EXHAUST AND WASTE ROUTES. CONTRACTOR SHALL PERFORM ALL WORK IN ACCORDANCE WITH NYSDOL INDUSTRIAL CODE RULE 56-11.7. "NON-FRIABLE FLOORING AND/OR MASTIC REMOVAL".
- INSTALL A WORKER AND WASTE DECONTAMINATION FACILITY (DECON), WHICH MUST BE ATTACHED TO THE 2. WORK AREA AND MAINTAIN AS PER NYSDOL INDUSTRIAL CODE RULE 56. THE DECON SHALL BE UTILIZED AS THE ENTRANCE AND EXIT FOR EACH WORK AREA. COORDINATE THE LOCATION OF EACH DECONTAMINATION UNIT WITH THE OWNER PRIOR TO INSTALLATION
- NYSDOL CERTIFIED ASBESTOS HANDLERS AND SUPERVISORS WEARING DUAL HEPA CARTRIDGE NEGATIVE PRESSURE RESPIRATORS AND TWO (2) FULL BODY TYVEK COVERALLS WILL PERFORM ALL WORK PROCEDURES AS DESCRIBED HEREIN. THE RESPIRATOR SHALL MEET ALL OSHA, NIOSH, AND MSHA STANDARDS FOR ASBESTOS DUST. ALL PERSONNEL ENTERING THE WORK AREA SHALL WEAR RESPIRATORY PROTECTION. ALL ABATEMENT WORK SHALL BE CONDUCTED UNDER THE DIRECT SUPERVISION OF A NYSDOL CERTIFIED ASBESTOS SUPERVISOR, WHO SHALL BE PRESENT ON-SITE DURING ALL WORK PROCEDURES.
- 4. POST APPROVED ASBESTOS WARNING SIGNS (BILINGUAL) AND DEMARCATE THE AREA TO PREVENT ENTRY BY UNAUTHORIZED PERSONNEL.
- ESTABLISH AND MAINTAIN A "NOTIFICATION BOARD" POSTING (IN PLAIN VIEW ON THE EXTERIOR OF THE DECON) THE REQUIRED CERTIFICATIONS, PANYNJ PLACARD, LICENSES, AND DOCUMENTATION IN ACCORDANCE WITH APPLICABLE REGULATIONS.
- 6. ASBESTOS CONTAINING MATERIALS TO BE REMOVED SHALL NOT BE DISTURBED UNTIL ALL ENGINEERING CONTROLS ARE ESTABLISHED.
- 7. RESTRICT ACCESS TO THE WORK SITE USING WARNING TAPE AND CRITICAL BARRIER TO DESIGNATE THE WORK AREA AS OFF LIMITS TO UNAUTHORIZED PERSONNEL.
- 8. SHUT DOWN AND LOCKOUT ELECTRICAL AND HVAC SERVICE IN THE WORK AREA.
- 9. PROVIDE TEMPORARY LIGHTING AND POWER TO THE WORK AREA IN ACCORDANCE WITH OSHA REQUIREMENTS FOR WORK AREA SAFETY. ALL ELECTRIC WORK SHALL BE PERFORMED IN ACCORDANCE WITH APPLICABLE CODES.
- 10. HEPA VACUUM AND WET CLEAN ALL SURFACES WITHIN THE WORK AREA.
- 11. INSTALL NEGATIVE AIR MACHINES (MICROTRAPS) TO ESTABLISH A NEGATIVE PRESSURE IN THE WORK AREA EQUAL TO 0.02 INCHES OF WATER COLUMN OR GREATER. EXHAUST ALL WORK AREA AIR OUTDOORS WITH NECESSARY CONNECTIONS, FASTENERS, FLEXIBLE DUCTS, MANIFOLDS, SUPPORTS ETC. EXHAUST DUCT LOCATION SHALL BE FIELD DETERMINED.
- 12. SECURE WITH DUCT TAPE AND SPRAY ADHESIVE TWO SEPARATE LAYERS OF SIX MIL POLY ON ALL OPENINGS (I.E. WINDOWS, DOORS, VENTS) AS CRITICAL BARRIERS.
- 13. SECURE WITH DUCT TAPE AND SPRAY ADHESIVE TWO SEPARATE LAYERS OF SIX MIL POLY ON ALL LIGHT FIXTURES, NON-MOVABLE OBJECTS, ETC. BEING CAREFUL NOT TO COVER THE FLOOR.
- 14. NOTIFY ATC TO INSPECT THE WORK AREA FOR COMPLIANCE WITH ALL APPLICABLE REGULATIONS PRIOR TO THE START OF ACM REMOVAL. UPON APPROVAL OF ATC, THE CONTRACTOR SHALL BEGIN REMOVAL PROCEDURES.
- 15. ALL ASBESTOS CONTAINING MATERIALS TO BE REMOVED ARE TO BE KEPT WET BY CONSTANTLY MISTING WITH AMENDED WATER. ONCE THE ASBESTOS CONTAINING MATERIAL IS REMOVED, IT MUST BE IMMEDIATELY PLACED DIRECTLY INTO 6-MIL POLYETHYLENE DISPOSAL BAGS. DO NOT ALLOW LOOSE MATERIAL OR VISIBLE DEBRIS TO REMAIN ON THE FLOOR.
- 16. BAGS CONTAINING ASBESTOS WASTE SHALL BE MISTED WITH AMENDED WATER, TWIST SHUT IN A GOOSE NECK FASHION, AND SEALED WITH DUCT TAPE, PLACE DISPOSAL BAGS INTO A SECOND 6-MIL POLYETHYLENE DISPOSAL BAG, TWIST SHUT IN A GOOSE NECK FASHION, AND SEAL WITH DUCT TAPE. THE SECOND DISPOSAL BAG SHALL BE PROPERLY MARKED WITH OSHA, USEPA, USDOT AND NESHAP LABELS.

	17.	BAGGED AND LABELED WASTE SHALL BE TRANSPORTED IN COVERED CARTS FROM THE WORK AREA TO AN
		ENCLOSED AND LOCKABLE WASTE CONTAINER LOCATED IN THE BUILDING DRIVEWAY ON MARTINE AVENUE
		FOR SUBSEQUENT TRANSPORT BY A LICENSED ASBESTOS WASTE HAULER AND DISPOSAL AT A CERTIFIED
		ASBESTOS WASTE LANDFILL. NO ASBESTOS WASTE SHALL BE TRANSPORTED FROM THE FACILITY WITHOUT
		PRIOR APPROVAL BY ATC AND THE COMPLETION OF ALL WASTE MANIFEST FORMS.
	18.	ONCE REMOVAL IS COMPLETE, FINE CLEAN THE WORK AREA WITH HEPA VACUUMS AND WET WIPING
R		TECHNIQUES. AFTER THE WORK AREA IS ALLOWED TO DRY COMPLETELY, IT WILL BE INSPECTED BY ATC.

- UPON APPROVAL, ATC SHALL PERFORM CLEARANCE AIR MONITORING IN ACCORDANCE WITH NYSDOL INDUSTRIAL CODE 56 AND EPA AHERA REGULATIONS.
- 19. RECLEAN ALL SURFACES IN THE WORK AREA IF THE INSPECTION OR THE CLEARANCE AIR TESTS FAIL.
- 20. FOLLOWING RECEIPT OF ACCEPTABLE AIR CLEARANCE RESULTS AND APPROVAL BY ATC, CONTRACTOR SHALL REMOVE ISOLATION BARRIERS AND WORK AREA COMPONENTS AND DEMOBILIZE FROM THE SITE. ALL POLYETHYLENE SHEETING, DUCT TAPE, SUITS, ETC. SHALL BE DISPOSED OF AS ASBESTOS CONTAINING WASTE.
- 21. UPON COMPLETION OF THE FINAL BREAKDOWN PROCEDURES, THE CONTRACTOR SHALL REQUEST A FINAL VISUAL INSPECTION FROM ATC. UPON APPROVAL BY ATC, THE ASBESTOS ABATEMENT WORK AREA SHALL BE AUTHORIZED FOR REOCCUPANCY.


ACM ABATEMENT SCHEDULE

		APPROXIMATE QUANTITY			
FLOOR	MATERIAL DESCRIPTION	SQUARE FEET (SF)	LINEAR FEET (LF)		
	ASBESTOS CONTAINING MASTIC UNDER FLOOR TILE	600	-		
1	ASBESTOS CONTAINING VINYL FLOOR TILE AND MASTIC	930	-		
I	ASBESTOS CONTAINING VINYL COVE BASE MASTIC	200	-		
	PRESUMED ASBESTOS CONTAINING PIPE INSULATION	-	80		
	ASBESTOS CONTAINING VINYL FLOOR TILE AND MASTIC	3,000	-		
2	ASBESTOS CONTAINING VINYL COVE BASE MASTIC	365	-		
	PRESUMED ASBESTOS CONTAINING PIPE INSULATION	-	80		


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LOW RISE BUILDING RENOVATIONS AND HVAC					MPROVEMENT	S	SCALE:	N/A		
PHASE II 110 DR. MARTIN LUTHER KING, JR. BOU					LEVARD		DATE: 01-19-2024	Issue Date		
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#### **DECONTAMINATION FACILITY FLOOR PLAN - TYPICAL** N.T.S.




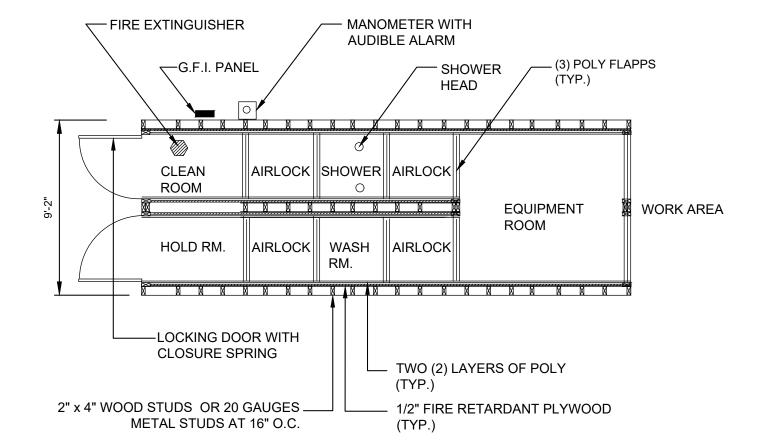

PARKIN GARAGE QUARROPAS STREET QUARROPAS STREE K KEY PLAN



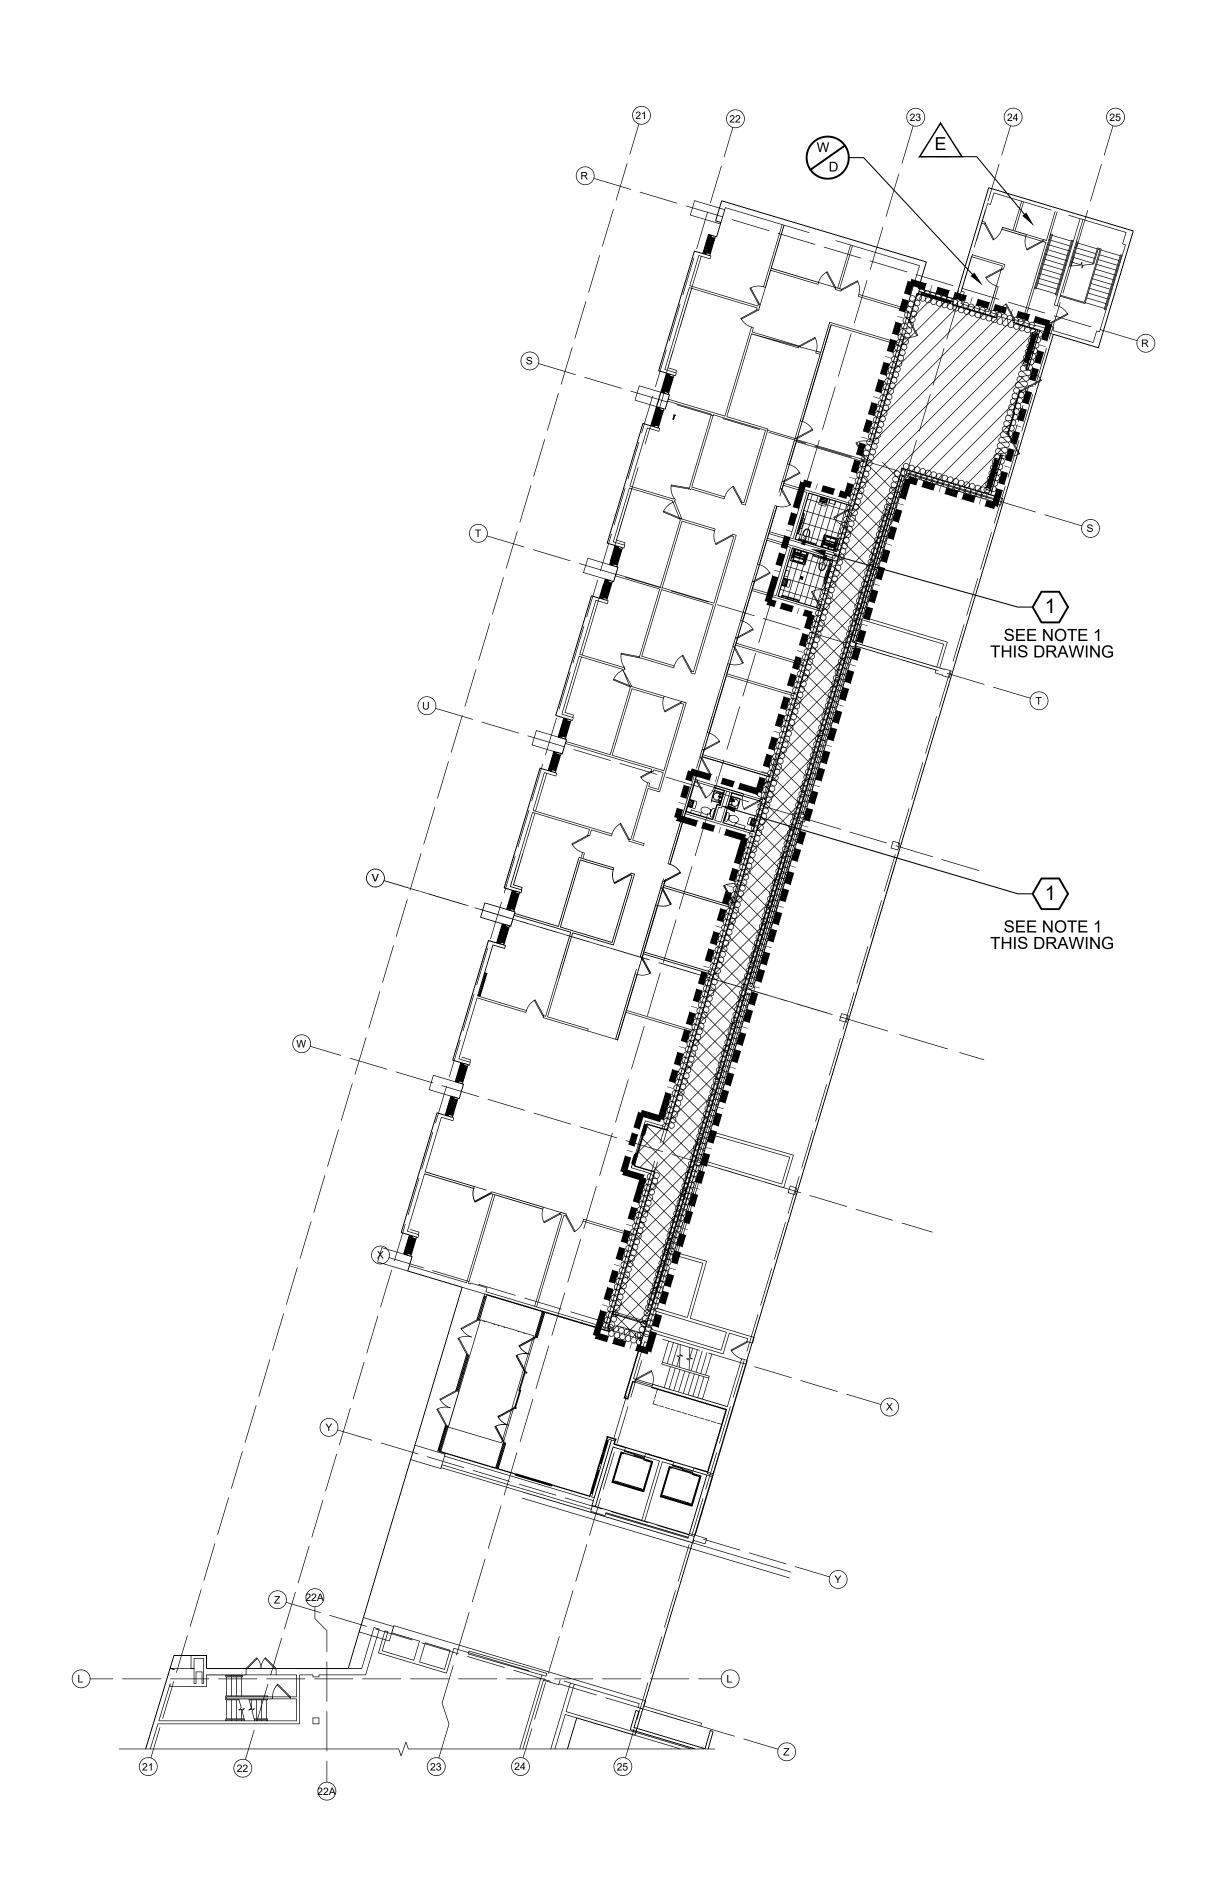

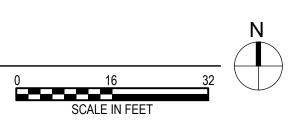



# LEGEND


SYMBOL	DESCRIPTION
	ASBESTOS CONTAINING MASTIC UNDER FLOOR TILE
	ASBESTOS CONTAINING VINYL FLOOR TILE AND MASTIC
100000000000000000000000000000000000000	ASBESTOS CONTAINING VINYL COVE BASE MASTIC
	PRESUMED ASBESTOS CONTAINING PIPE INSULATION IN RESTROOM PIPE CHASE
	WORK AREA LIMIT
	WATER/DRAIN SUPPLY (V.I.F.)
E	ELECTRICAL POWER SUPPLY (V.I.F.)

#### SITE SPECIFIC NOTES


1. ASBESTOS CONTAINING PIPE INSULATION IS PRESUMED TO EXIST IN THE RESTROOM PIPE CHASE. IF IMPACTED BY THIS WORK, REMOVE AND DISPOSE OF IN ACCORDANCE WITH NYS ICR 56-8.4(a) "GLOVEBAG PROCEDURES".

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QUARROPAS STREET QUARROPAS STRF K KEY PLAN //



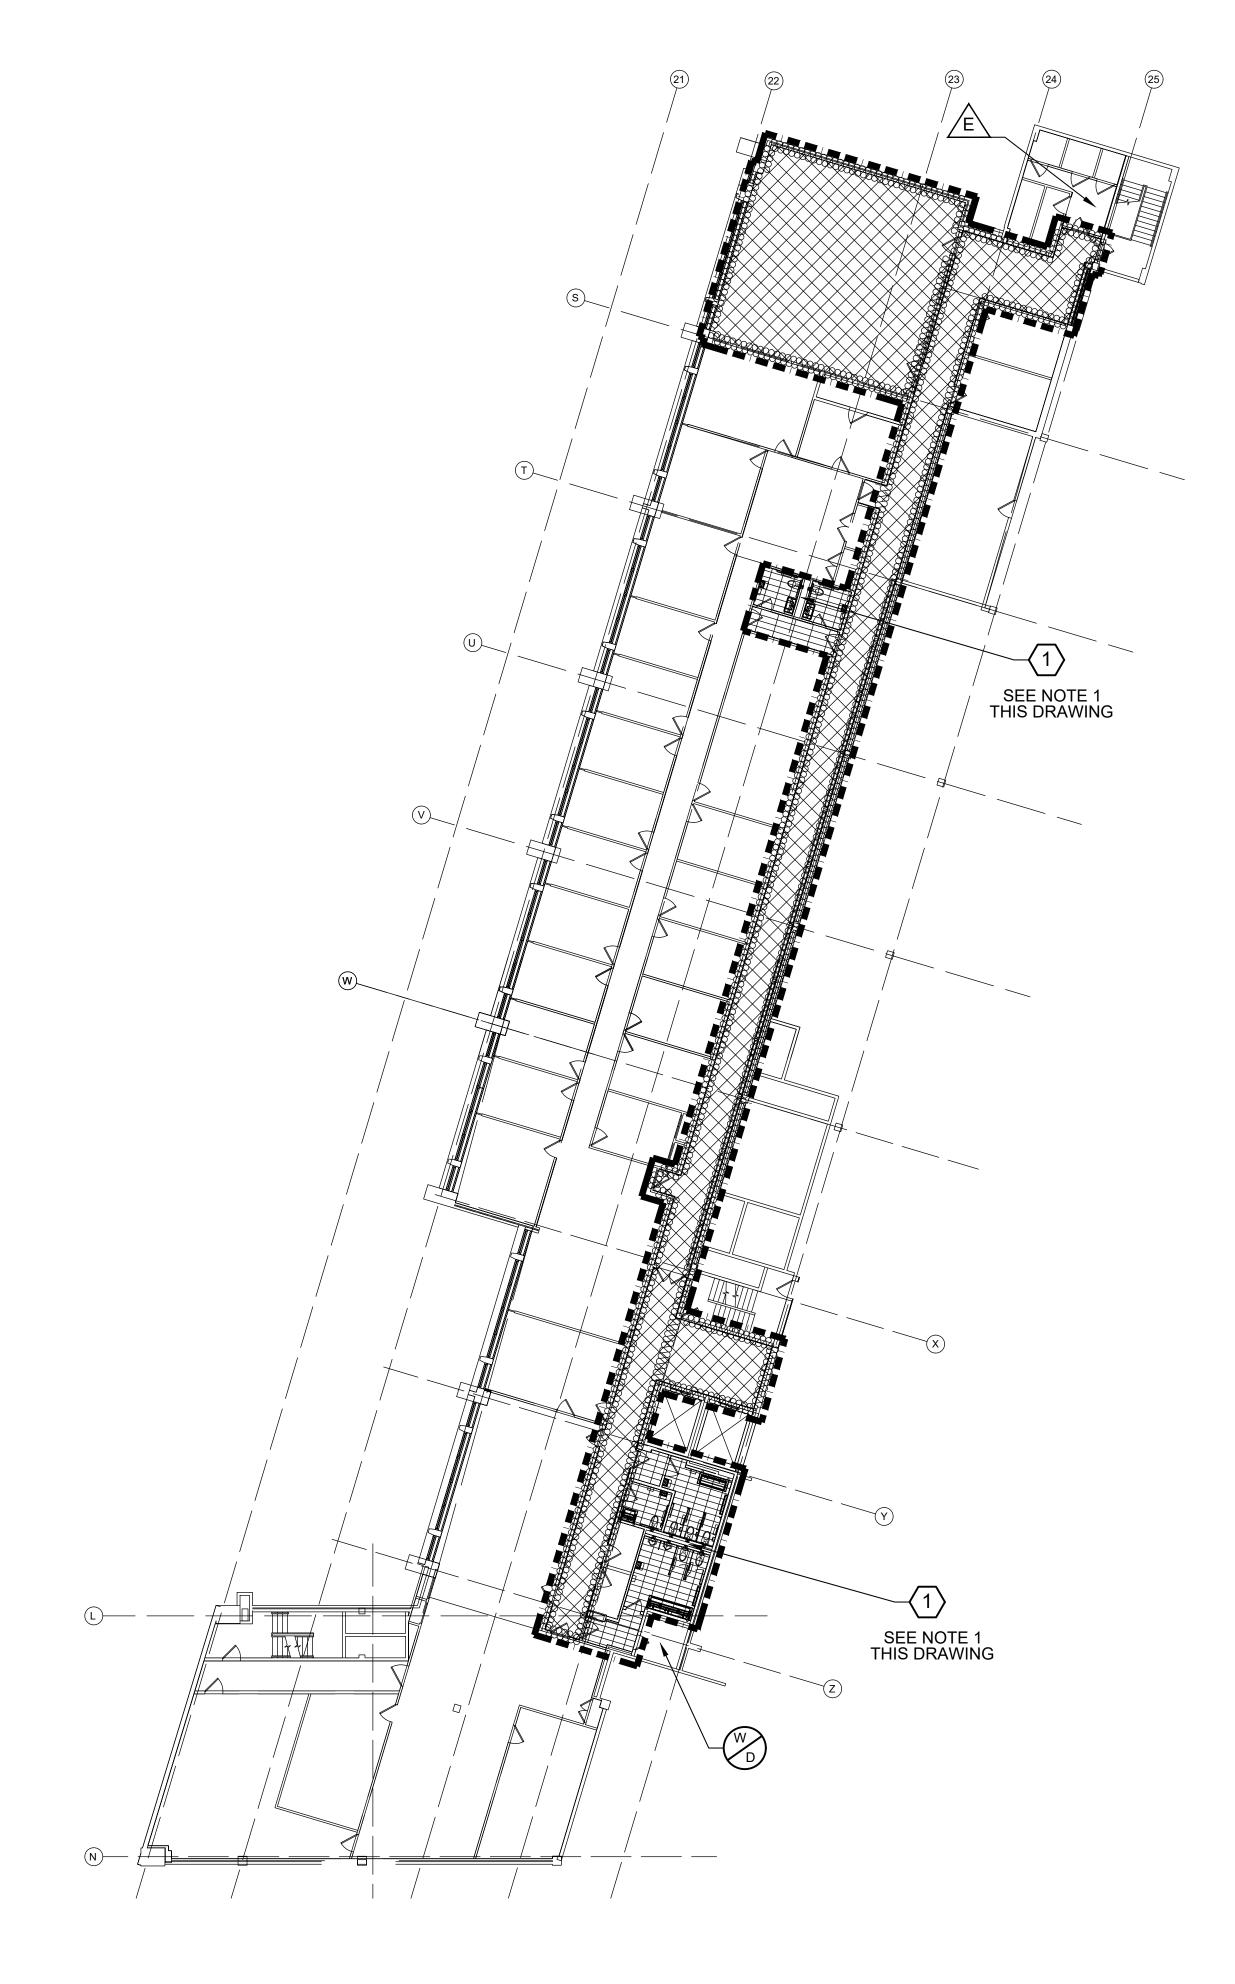

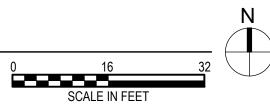

# LEGEND

SYMBOL	DESCRIPTION
	ASBESTOS CONTAINING VINYL FLOOR TILE AND MASTIC
100000000000000000000000000000000000000	ASBESTOS CONTAINING VINYL COVE BASE MASTIC
	PRESUMED ASBESTOS CONTAINING PIPE INSULATION IN RESTROOM PIPE CHASE
	WORK AREA LIMIT
	WATER/DRAIN SUPPLY (V.I.F.)
E	ELECTRICAL POWER SUPPLY (V.I.F.)

## SITE SPECIFIC NOTES

1. ASESTOS CONTAINING PIPE INSULATION IS PRESUMED TO EXISTB IN THE RESTROOM PIPE CHASE. IF IMPACTED BY THIS WORK, REMOVE AND DISPOSE OF IN ACCORDANCE WITH NYS ICR 56-8.4(a) "GLOVEBAG PROCEDURES".

2. PROTECT THE FLOOR BELOW AS REQUIRED TO PREVENT ANY POTENTIAL WATER LEAKAGE.

CONSULTANT SEAL		CONSULTANT INFORMATION Graf & Lewent Architects LLP 90-30 161st Street, Jamaica, NY 11432 P: 718-651-6200 F: 718-251-6989									
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